

	SIDEWALK REMOVAL
LT STA. 9+97.2 TO STA. 11+34.6	2,012 SQ. FT.
SHEET TOTAL =	2,012 SQ. FT.

	PORTLAND CEMENT CONCRETE SIDEWALK 4 INCH
LT STA. 9+97.2 TO STA. 11+34.6	1,761 SQ. FT.
SHEET TOTAL =	1,761 SQ. FT.

	COMBINATION CONCRETE CURB AND GUTTER, TYP. B-6.24 (SPECIAL)
LT STA. 9+97.2 TO STA. 11+34.6	150.0 FOOT
SHEET TOTAL =	150.0 FOOT

	DOMESTIC WATER SERVICE PERIMETER OF POWER POLES, LIGHT BASES, AND TRAFFIC CONTROLLERS AND AT ALL LOCATIONS WHERE NEW SIDEWALK IS ADJACENT TO NEW CURB AND GUTTER.
21.1 LT STA. 10+65.49	1 EACH
21.5 LT STA. 10+67.77	1 EACH
SHEET TOTAL =	2 EACH

	PAVEMENT REMOVAL
LT STA. 9+97.2 TO STA. 11+34.6	20.3 SQ. YD.
SHEET TOTAL =	20.3 SQ. YD.



	DETECTABLE WARNINGS
STA. 11+32 TO STA. 11+34	18 SQ. FT.
SHEET TOTAL =	18 SQ. FT.

	THERMOPLASTIC PAVEMENT MARKING - LINE 4"
LT STA. 10+24.9	5 FOOT
LT STA. 10+48.9	6 FOOT
LT STA. 10+72.9	6 FOOT
LT STA. 10+96.9	6 FOOT
LT STA. 11+20.9	5 FOOT
SHEET TOTAL =	28 FOOT

	POROUS GRANULAR BACKFILL
LT STA. 9+97.2 TO STA. 11+34.6	20.0 CU. YD.
SHEET TOTAL =	20.0 CU. YD.

PROVIDE 1/2" P.J.F. AROUND PERIMETER OF POWER POLES, LIGHT BASES, AND TRAFFIC CONTROLLERS AND AT ALL LOCATIONS WHERE NEW SIDEWALK IS ADJACENT TO NEW CURB AND GUTTER.

LEGEND	
xxx.xx	EXISTING SPOT ELEV.
xxx.xxt	EXISTING TOP OF CURB ELEV.
xxx.xxg	EXISTING GUTTER ELEV.
xxx.xx	EXISTING SPOT ELEV. TO MATCH
xxx.xx	PROPOSED SPOT ELEV.
xxx.xxt	PROPOSED TOP OF CURB ELEV.

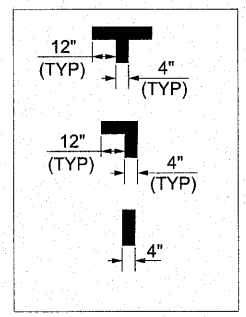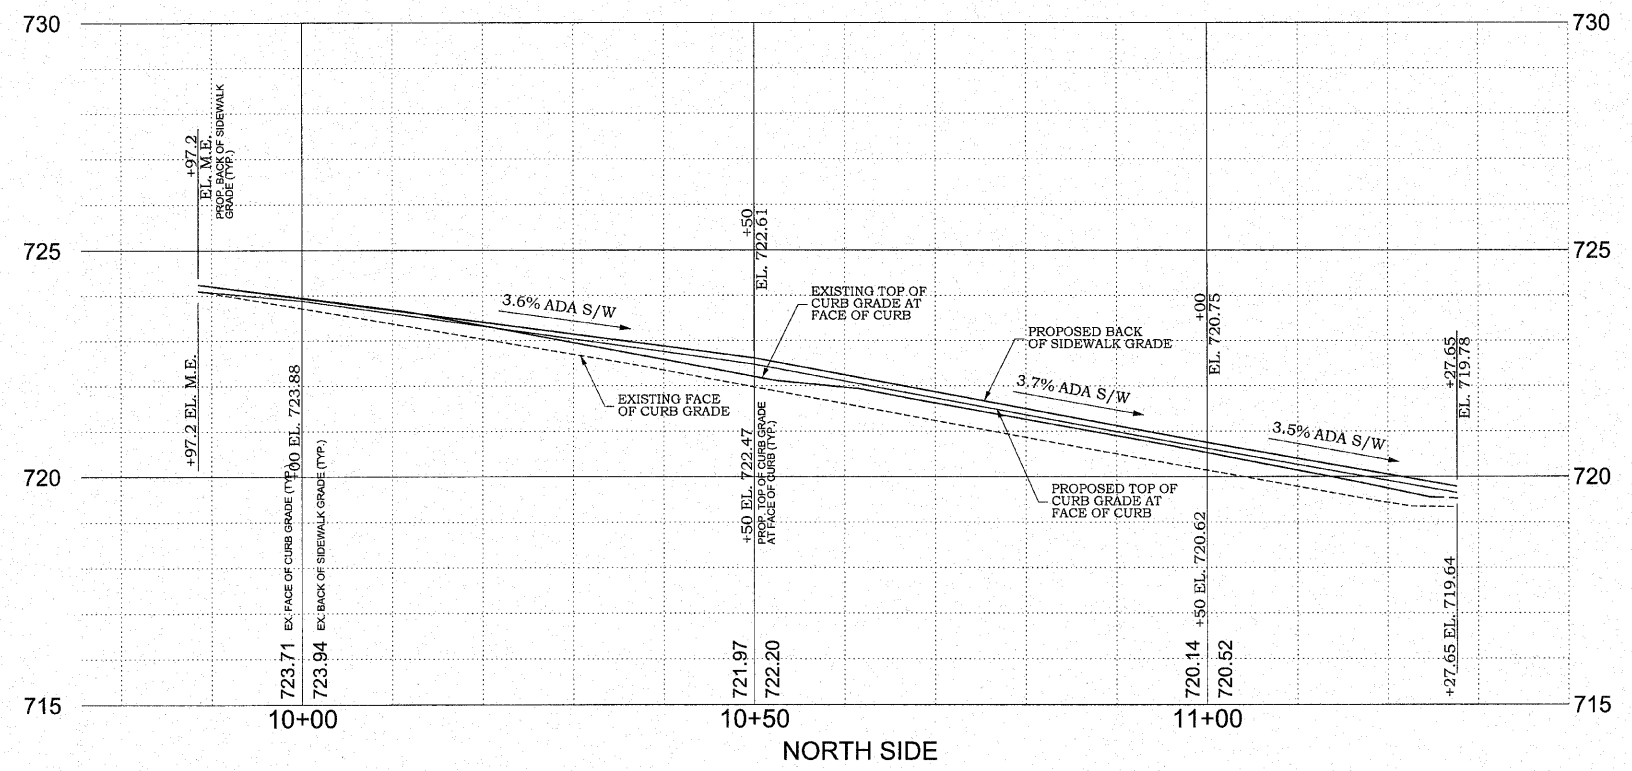

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PROFESSIONAL DESIGN FIRM #184-001406

SCALE	HOR. 1"=10' VERT. 1"=5'
REVISIONS	DATE
DATE	DATE

FRANCIS ASSOC.
FILE NO.
P-414

PLAN AND PROFILE - WOOD STREET (NORTH SIDE)
DOWNTOWN SIDEWALK IMPROVEMENTS - PHASE 2
CITY OF PARIS, ILLINOIS, EDGAR COUNTY

SHEET NO.
6
OF 7 SHEETS