FOR INDEX OF SHEETS, SEE SHEET NO. 2

FOR INDEX OF HIGHWAY STANDARDS, SEE SHEET NO. 2

PROJECT LOCATED IN THE VILLAGE OF BULL VALLEY AND NUNDA TOWNSHIP

01-21-2022 LETTING ITEM 071

TRAFFIC DATA

MASON HILL ROAD POSTED SPEED LIMIT: SO MPH 2017 ADT = 3,100

FUNCTIONAL CLASSIFICATION

MINOR COLLECTOR

ENGINEERING SCALES, REDUCED SIZED PLANS WILL NOT CONFORM TO STANDARD SCALES, IN MAKING MEASUREMENTS ON REDUCED PLANS, THE ABOVE SCALES MAY BE USED.

J.U.L.I.E. DESIGN STAGE REQUEST DIG. No. _A3111244



CONTACT JULIE AT 811 OR 800-892-0123 WITH THE FOLLOWING:

COUNTY = MCHENRY

CITY-TWNSHP. = BULL VALLEY - NUNDA SEC. & 1/4 SEC. NO. = S12 T44N RTE. ST.8 T44N R8E

48 HOURS (2 working days) BEFORE YOU DIG

CONTRACT NO. 61H53


STATE OF ILLINOIS **DEPARTMENT OF TRANSPORTATION**

PLANS FOR PROPOSED FEDERAL AID HIGHWAY

TR 143 (MASON HILL ROAD) VILLAGE LIMITS (650 FT WEST OF CHERRY VALLEY ROAD) TO CRYSTAL LAKE ROAD **RESURFACING** SECTION: 20-00008-00-RS **PROJECT: S49M(189)**

> VILLAGE OF BULL VALLEY MCHENRY COUNTY


> > C-91-031-22

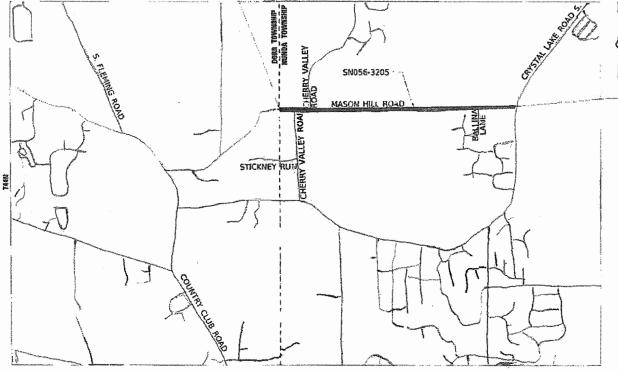


LOCATION MAP

GROSS LENGTH = 10,530 FT. = 2.0 MILE NET LENGTH = 10,530 FT. = 2.0 MILE



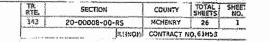


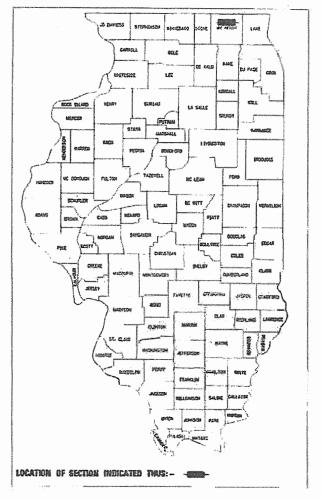



MASON HILL ROAD

END IMPROVEMENTS STA 115+30

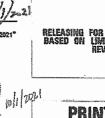

STATE OF ILLINOIS DEPARTMENT OF TRANSPORTATION Znuky Buendt EMILY BERENAT PRESIDENT PASSED 40V 4 707)

C 4 201

DISTRICT 1 ENGINEER OF LOCAL ROADS AND STREETS RELEASING FOR BID BASED ON LIMITED ADVEMBER 8, 2021

appende Ris (003

PRINTED BY THE AUTHORITY OF THE STATE OF ILLINOIS

B&W PROJECT NO.: 191518

DATE: 09-27-2021

FULL SIZE PLANS HAVE BEEN PREPARED USING STANDARD

MASON HILL ROAD

STA 10+00

BEGIN IMPROVEMENTS

INDEX OF SHEETS

1	COVER
2	INDEX OF SHEETS AND HIGHWAY STANDARDS
3	GENERAL NOTES
4 - 6	SUMMARY OF QUANTITIES
7	TYPICAL SECTIONS, EXISTING PAVEMENT THICKNESS TABLE AND HOT-MIX ASPHALT MIXTURE REQUIREMENTS
8	SCHEDULE OF QUANTITIES
9 - 18	PLAN
19	MISCELLANEOUS DETAILS
20	PAVEMENT PATCHING FOR HMA SURFACE PAVEMENT (BD-22)
21	BUTT JOINT AND HMA TAPER DETAILS (BD-32)
22	TRAFFIC CONTROL AND PROTECTION FOR SIDE ROADS, INTERSECTIONS, AND DRIVEWAYS (TC-10)
23	RAISED REFLECTIVE PAVEMENT MARKERS (SNOW PLOW RESISTANT) (TC-11)
24	DISTRICT 1 TYPICAL PAVEMENT MARKINGS (TC-13)
25	TRAFFIC CONTROL AND PROTECTION AT TURN BAYS (TO REMAIN OPEN TO TRAFFIC) (TC-14)
26	ARTERIAL ROAD INFORMATION SIGN (TC-22)

HIGHWAY STANDARDS

000001-08	STANDARD SYMBOLS, ABBREVIATIONS AND PATTERNS
442201-03	CLASS C AND D PATCHES
542401-04	METAL FLARED END SECTION FOR PIPE CULVERTS
701006-05	OFF-RD OPERATIONS, 2L, 2W, 15' (4.5 m) TO 24" (600 mm) FROM PAVEMENT EDGE
701011-04	OFF-RD MOVING OPERATIONS, 2L, 2W, DAY ONLY
701201-05	LANE CLOSURE, 2L, 2W, DAY ONLY, FOR SPEEDS ≥ 45 MPH
701301-04	LANE CLOSURE, 2L, 2W, SHORT TIME OPERATIONS
701306-04	LANE CLOSURE, 2L, 2W, SLOW MOVING OPERATIONS DAY ONLY, FOR SPEEDS ≥ 45 MPH
701311-03	LANE CLOSURE 2L, 2W MOVING OPERATIONS - DAY ONLY
701336-07	LANE CLOSURE, 2L, 2W, WORK AREAS IN SERIES, FOR SPEEDS ≥ 45 MPH
701501-06	URBAN LANE CLOSURE, 2L, 2W, UNDIVIDED
701901-08	TRAFFIC CONTROL DEVICES
720001-01	SIGN PANEL MOUNTING DETAILS
720006-04	SIGN PANEL ERECTION DETAILS
725001-01	OBJECT AND TERMINAL MARKERS
728001-01	TELESCOPING STEEL SIGN SUPPORT
780001-05	TYPICAL PAVEMENT MARKINGS
781001-04	TYPICAL APPLICATIONS RAISED REFLECTIVE PAVEMENT MARKERS
B.L.R. 24-2	MAILBOX TURNOUT FOR LOCAL ROADS

DISTRICT DETAILS

BD-22	PAVEMENT PATCHING FOR HMA SURFACE PAVEMENT
BD-32	BUTT JOINT AND HMA TAPER DETAILS
TC-10	TRAFFIC CONTROL & PROTECTION FOR SIDE ROADS, INTERSECTIONS, & DRIVEWAYS
TC-11	RAISED REFLECTIVE PAVEMENT MARKERS (SNOW PLOW RESISTANT)
TC-13	DISTRICT 1 TYPICAL PAVEMENT MARKINGS
TC-14	TRAFFIC CONTROL AND PROTECTION AT TURN BAYS (TO REMAIN OPEN TO TRAFFIC)
TC-22	ARTERIAL ROAD INFORMATION SIGN

COMMITMENTS

THERE ARE NO COMMITMENTS ON THIS PROJECT

	USER NAME = jharris	DES
BAXTER WOODMAN		DRA
Consulting Engineers	PLOT SCALE = 40.0000 ' / in.	СНЕ
_	PLOT DATE = 11/3/2021	DAT

USER NAME = jharris	DESIGNED	SAM	REVISED -	
	DRAWN	MJO	REVISED -	
PLOT SCALE = 40.0000 ' / in.	CHECKED	DJS	REVISED -	
PLOT DATE = 11/3/2021	DATE	- 09-27-2021	FILE - 191518SHT-GenNotes.dgn	

STATE OF ILLINOIS DEPARTMENT OF TRANSPORTATION

INDI	X OF	SHEET	S AI	ND HI	GHWAY	STANDARDS
SCALE: NONE	SHEET	1 OF	2	SHEETS	STA.	TO STA.

COUNTY TOTAL SHEET NO.

MCHENRY 26 2 SECTION 20-00008-00-RS CONTRACT NO. 61H53 ILLINOIS FED. AID PROJECT

THE CONTRACTOR SHALL NOTIFY THE VILLAGE CLERK (TELEPHONE NO. 815-459-4833) AT LEAST 48 HOURS IN ADVANCE OF BEGINNING WORK TO OBTAIN VILLAGE UTILITY LOCATIONS AND SHALL COORDINATE ALL CONSTRUCTION OPERATIONS WITH THE ENGINEER AND THE VILLAGE ADMINISTRATOR.

4. THE INDISCRIMINATE USE OF FIRE HYDRANTS IS STRICTLY PROHIBITED. WATER FOR CONSTRUCTION SHALL BE METERED OR OTHERWISE ACCOUNTED FOR AND A DAILY LOG MAINTAINED. THE CONTRACTOR SHALL PROVIDE THE WATER TRUCK AND DRIVER REQUIRED TO OBTAIN AND TRANSPORT THIS WATER. THE VILLAGE RESERVES THE RIGHT TO RESTRICT OR REFUSE THE USE OF VILLAGE WATER IF DEEMED NECESSARY.

5. ACCESS TO PRIVATE DRIVEWAYS SHALL BE PROVIDED AT ALL TIMES EXCEPT DURING ACTUAL CONSTRUCTION ADJACENT THERE TO. TEMPORARY RAMPS SHALL BE CONSTRUCTED AS NEEDED TO PROVIDE SUCH ACCESS, UTILIZING CRUSHED STONE OR CRUSHED GRAVEL AS TEMPORARY ACCESS.

6. THE CONTRACTOR SHALL CONTACT THE LOCAL AGENCY MATERIAL INSPECTOR AT LEAST 48 HOURS PRIOR TO ANY CONCRETE OR HOT-MIX ASPHALT MATERIAL DELIVERIES.

7. ALL POSTS, RAILROAD TIES, AND DECORATIVE TIMBER IN CONFLICT WITH THE PROPOSED IMPROVEMENTS SHALL BE REMOVED AND RELOCATED AS DETERMINED BY THE ENGINEER AT THE TIME OF CONSTRUCTION. EVERY EFFORT SHALL BE MADE BY THE CONTRACTOR WHEN REMOVING THESE ITEMS TO PRESERVE THEM FROM HARM. ITEMS NOT RELOCATED SHALL BE PROPERLY DISPOSED OF BY THE CONTRACTOR.

8. A PORTABLE BATHROOM(S) SHALL BE PLACED ON THE JOB SITE(S) AND RELOCATED WHEN NECESSARY SO IT IS ACCESSIBLE TO WORKERS. IF WORK IS OCCURRING AT SEVERAL LOCATIONS, ONE PORTABLE BATHROOM SHALL BE PLACED AT EACH LOCATION WITHIN A REASONABLE DISTANCE FROM THE WORK AS DETERMINED BY THE ENGINEER

ALL CULVERTS AND FLARED END SECTIONS SHALL BE METAL

10. TRENCH BACKFILL FOR THIS PROJECT SHALL CONSIST OF CRUSHED MATERIAL AND SHALL BE COMPACTED BY METHOD 1 ONLY.

11. ON RURAL PAVEMENTS BEING RESURFACED THAT DO NOT HAVE A PAVED SHOULDER, MAILBOX TURNOUTS SHALL BE PROVIDED AT EACH EXISTING MAILBOX FOR THE FULL WIDTH OF THE SHOULDER UP TO 6 INCHES FROM THE FACE OF THE EXISTING MAILBOX. MAILBOX TURNOUTS SHALL BE AT LEAST 2 INCHES THICK.

12. WHEN MILLED PAVEMENT IS OPEN TO TRAFFIC. THE MAXIMUM GRADE DIFFERENTIAL BETWEEN PASSES OF THE MILLING MACHINE SHALL NOT EXCEED 1 $\frac{1}{2}$ INCHES WHERE THE SPEED LIMIT IS 45 MPH OR LESS, AND SHALL NOT EXCEED 1 INCH WHERE THE SPEED LIMIT IS OVER 45 MPH. A MAXIMUM GRADE DIFFERENCE OF 3 INCHES MAY BE ALLOWED IF THE EDGE OF THE MILLING IS SLOPED A MINIMUM OF 1:3 (V: H). AS DETERMINED BY THE ENGINEER.

13. ALL EXISTING SIGNS TO BE REMOVED SHALL BE DELIVERED TO VILLAGE HALL (1904 S CHERRY VALLEY ROAD BULL VALLEY, IL). ALL DROP OFFS SHALL BE COORDINATED WITH THE ENGINEER AND VILLAGE PRIOR TO DELIVERY.

14. THE TIME THAT THE AGGREGATE BASE COURSE IS EXPOSED SHALL BE LIMITED TO 24 HOURS.

15. DELINEATORS SHALL BE USED TO MARK THE LOCATION OF FLARED END SECTIONS.

16. PRIOR TO ORDERING ANY MATERIALS, THE CONTRACTOR SHALL FIELD VERIFY PIPE CULVERT LENGTHS.

MAINTENANCE OF TRAFFIC NOTES

THE CONTRACTOR SHALL SUBMIT A PREPLANNED SEQUENCE OF WORK AT THE PRECONSTRUCTION CONFERENCE FOR REVIEW AND APPROVAL. WORK SHALL BE SCHEDULED TO MINIMIZE INCONVENIENCE TO RESIDENTS AND BUSINESSES AND TO MAINTAIN A REASONABLE LEVEL OF CONSTRUCTION EFFICIENCY. THE ENGINEER RESERVES THE RIGHT TO RESTRICT WORK ON ANY ROADWAY SEGMENT IF CONSTRUCTION OPERATIONS ON A PREVIOUS SEGMENT ARE UNACCEPTABLE; TRAFFIC CONTROL OPERATIONS BECOME UNACCEPTABLE; OR AN EROSION CONTROL DEFICIENCY EXISTS.

2. THE ENGINEER SHALL BE NOTIFIED 48 HOURS IN ADVANCE OF ANY CHANGES TO CONSTRUCTION STAGING. ALL CHANGES TO CONSTRUCTION STAGING MUST BE APPROVED BY THE ENGINEER PRIOR TO IMPLEMENTATION.

ACCESS FOR MASON HILL ROAD LOCAL TRAFFIC, MAIL SERVICE, GARBAGE SERVICE AND EMERGENCY VEHICLES SHALL BE MAINTAINED AT ALL TIMES.

BAXTER WOODMAN

DESIGNED SAM REVISED USER NAME = jharris DRAWN MJO REVISED PLOT SCALE = 40.0000 ' / in. CHECKED DJS REVISED DATE - 09-27-2021 PLOT DATE = 11/3/2021FILE - 191518SHT-GenNotes.dgn

STATE OF ILLINOIS DEPARTMENT OF TRANSPORTATION

SCALE: NONE

TOTAL SHEET NO. TR RTE. SECTION COUNTY **GENERAL NOTES** MCHENRY 26 3 20-00008-00-RS CONTRACT NO. 61H53 SHEET 2 OF 2 SHEETS STA. TO STA. | ILLINOIS | FED. AID PROJECT

TATE OF ILLINOIS - PROFESSIONAL DESIGN FIRM ICENSE NO. - 184-001121 - EXPIRES 4/30/2021 narris 11/3/2021 9:44:49 AM

CONSTRUCTION
CODE
80% FED

					20% LOCAL
Γ					ROADWAY
1	CODE	ITEM	UNIT	TOTAL	0005
	NO.			QUANTITY	URBAN
Ì	20201200	REMOVAL AND DISPOSAL OF UNSUITABLE MATERIAL	CU YD	785	785
ŀ					
-	20800150	TRENCH BACKFILL	CU YD	46	46
-	21001000	GEOTECHNICAL FABRIC FOR GROUND STABILIZATION	SQ YD	1,205	1,205
ł					
	21101505	TOPSOIL EXCAVATION AND PLACEMENT	CU YD	60	60
-	21400100	GRADING AND SHAPING DITCHES	FOOT	800	800
-	25000312	SEEDING, CLASS 4A	ACRE	0.25	0.25
-	25100630	EROSION CONTROL BLANKET	SQ YD	1,210	1,210
ŀ					
	25000400	NITROGEN FERTILIZER NUTRIENT	POUND	9	9
-	25000500	PHOSPHORUS FERTILIZER NUTRIENT	POUND	9	9
	25000600	POTASSIUM FERTILIZER NUTRIENT	POUND	9	9
	25200200	SUPPLEMENTAL WATERING	UNIT	8	8
	28000250	TEMPORARY EROSION CONTROL SEEDING	POUND	25	25
<i>‡</i>	30300001	AGGREGATE SUBGRADE IMPROVEMENT	CU YD	785	785
<i>‡</i>	35800100	PREPARATION OF BASE	SQ YD	9,349	9,349
	35800200	AGGREGATE BASE REPAIR	TON	515	515
١					

INDICATES SPECIALTY ITEM
INDICATES SPECIAL PROVISION
S INDICATES CONSTRUCTION CODE 0042 TRAINEES

SUMMARY OF QUANTITIES

				CONSTRUCTION CODE
				80% FED 20% LOCAL
CODE NO.	ITEM	UNIT	TOTAL QUANTITY	ROADWAY 0005 URBAN
40600290	BITUMINOUS MATERIALS (TACK COAT)	POUND	9,843	9,843
40600370	LONGITUDINAL JOINT SEALANT	FOOT	10,530	10,530
40600400	MIXTURE FOR CRACKS, JOINTS, AND FLANGEWAYS	TON	1	1
40600982	HOT-MIX ASPHALT SURFACE REMOVAL - BUTT JOINT	SQ YD	543	543
40603080	HOT-MIX ASPHALT BINDER COURSE, IL-19.0, N50	TON	3,939	3,939
40604060	HOT-MIX ASPHALT SURFACE COURSE, IL-9.5, MIX "D", N50	TON	2,567	2,567
40800050	INCIDENTAL HOT-MIX ASPHALT SURFACING	TON	45	45
44000157	HOT-MIX ASPHALT SURFACE REMOVAL, 2"	SQ YD	17,197	17,197
44000165	HOT-MIX ASPHALT SURFACE REMOVAL, 4"	SQ YD	9,349	9,349
44201701	CLASS D PATCHES, TYPE I, 5 INCH	SQ YD	104	104
44201705	CLASS D PATCHES, TYPE II, 5 INCH	SQ YD	155	155
44201709	CLASS D PATCHES, TYPE III, 5 INCH	SQ YD	258	258
44201711	CLASS D PATCHES, TYPE IV, 5 INCH	SQ YD	516	516
44201725	CLASS D PATCHES, TYPE I, 7 INCH	SQ YD	138	138
1				

SCALE:

BAXTER WOODMAN

USER NAME = jharris	DESIGNED SAM	REVISED -
	DRAWN MJO	REVISED -
PLOT SCALE = 40.0000 ' / in.	CHECKED DJS	REVISED -
PLOT DATE = 11/16/2021	DATE - 09-27-2021	FILE - 191518SHT-SOQ.dgn

STATE OF ILLINOIS DEPARTMENT OF TRANSPORTATION

	SUI	ИМАР	łΥ	OF Q.L	JANTIT	IES	
SHEET	1	OF	3	SHEETS	STA.	Т	O.

TR RTE. SECTION 20-00008-00-RS

STATE OF ILLINOIS - PROFESSIONAL DESIGN FIRM ...,Plotdrv,pdf-BW_Default.plt LICENSE NO. - 184-001121 - EXPIRES 4/30/2021 ...,CAD\Plots\191518_Pen.tbl jharris 11/16/2021 9:21:54 AM I:Crystal Lake\BULLV\191518-Mason Hill Road

[#] INDICATES SPECIAL PROVISION

^{\$} INDICATES CONSTRUCTION CODE 0042 TRAINEES

CONSTRUCTION CODE 80% FED 20% LOCAL

_					2070 2007 (2
ſ	CODE	ITEM		TOTAL	ROADWAY
	NO.			QUANTITY	0005
L	140.			4 0	URBAN
	44201733	4201733 CLASS D PATCHES, TYPE III, 7 INCH		344	344
Ī					
Ī	44201735	CLASS D PATCHES, TYPE IV, 7 INCH	SQ YD	688	688
	48102100	AGGREGATE WEDGE SHOULDER, TYPE B	TON	447	447
ſ					
ſ	50105220	PIPE CULVERT REMOVAL	FOOT	171	171
ı					
	542D0220	PIPE CULVERTS, CLASS D, TYPE 1 15"	FOOT	126	126
Ī					
İ	542D0223	PIPE CULVERTS, CLASS D, TYPE 1 18"	FOOT	45	45
İ					
İ	54262715	METAL FLARED END SECTIONS 15"	EACH	6	6
l					
ı	54262718	METAL FLARED END SECTIONS 18"	EACH	2	2
Ì					
ł	59000200	EPOXY CRACK INJECTION	FOOT	10	10
Ì					
*	63500105	DELINEATORS	EACH	8	8
l					
l	66900200	NON-SPECIAL WASTE DISPOSAL	CU YD	891	891
ł					
	66900530	SOIL DISPOSAL ANALYSIS	EACH	1	1
ŀ					
*#	66901001	REGULATED SUBSTANCES PRE-CONSTRUCTION PLAN	LSUM	1	1
*#	66901003	REGULATED SUBSTANCES FINAL CONSTRUCTION REPORT	LSUM	1	1
*·#	66901006	REGULATED SUBSTANCES MONITORING	CAL DA	5	5
·					
				I.	1

^{*} INDICATES SPECIALTY ITEM

SUMMARY OF QUANTITIES

				CONSTRUCTIO
				CODE
				80% FED
				20% LOCAL
			TOTAL	ROADWAY
	ITEM	UNIT	TOTAL	0005
70100460 TR. 70100600 TR. 70102620 TR. 70300100 SH 72000100 SIG			QUANTITY	URBAN
67100100	MODULIZATION	LSUM	1	1
6/100100	MOBILIZATION	LOUM	1	1
70100450	TRAFFIC CONTROL AND PROTECTION, STANDARD 701201	LSUM	1	1
70100460	TRAFFIC CONTROL AND PROTECTION, STANDARD 701306	LSUM	1	1
70100600	TRAFFIC CONTROL AND PROTECTION, STANDARD 701336	LSUM	1	1
70102620	TRAFFIC CONTROL AND PROTECTION, STANDARD 701501	LSUM	1	1
70300100	SHORT TERM PAVEMENT MARKING	FOOT	3,159	3,159
70300150	SHORT TERM PAVEMENT MARKING REMOVAL	SQ FT	1,053	1,053
72000100	SIGN PANEL - TYPE 1	SQ FT	273	273
72400100	REMOVE SIGN PANEL ASSEMBLY - TYPE A	EACH	17	17
72400200	REMOVE SIGN PANEL ASSEMBLY - TYPE B	EACH	2	2
72400600	RELOCATE SIGN PANEL ASSEMBLY - TYPE B	EACH	2	2
72800100	TELESCOPING STEEL SIGN SUPPORT	FOOT	813	813
78000100	THERMOPLASTIC PAVEMENT MARKING - LETTERS AND SYMBOLS	SQ FT	73	73
78000200	THERMOPLASTIC PAVEMENT MARKING, LINE - 4"	FOOT	33,810	33,810
				274

[#] INDICATES SPECIAL PROVISION

SCALE:

BAXTER WOODMAN Consulting Engineers

PLOT DATE = 11/16/2021	DATE - 09-27-2021	FILE - 191518SHT-SOQ.dgn
PLOT SCALE = 40.0000 ' / in.	CHECKED DJS	REVISED -
	DRAWN MJO	REVISED -
USER NAME = jharris	DESIGNED SAM	REVISED -

STATE OF ILLINOIS DEPARTMENT OF TRANSPORTATION

	SUMMARY OF QUANTITIES				RTE.	SECTION	COUNTY	SHEETS	NO.			
					143	20-00008-00-RS	MCHENRY	26	5			
										CONTRACT	NO. 6	1H53
	SHEET	2	OF	3	SHEETS	STA.	TO STA.	ILLINOIS FED, AID PROJECT				

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STATE OF ILLINOIS - PROFESSIONAL DESIGN FIRM ILCENSE NO. - 184-001121 - EXPIRES 4/30/2021 harris monet, noted to the state of the state

[#] INDICATES SPECIAL PROVISION
S INDICATES CONSTRUCTION CODE 0042 TRAINEES

^{\$} INDICATES CONSTRUCTION CODE 0042 TRAINEES

					20% LOCAL
	CODE			TOTAL	ROADWAY
	CODE NO.	ITEM	UNIT	QUANTITY	0005
					URBAN
*	78000650	THERMOPLASTIC PAVEMENT MARKING, LINE - 24"	FOOT	18	18
#	X0327611	REMOVE AND REINSTALL BRICK PAVER	SQ FT	100	100
#	X4021000	TEMPORARY ACCESS (PRIVATE ENTRANCE)	EACH	16	16
	•				
и	V 4022000	TEMPODARY ACCESS (COMMERCIA), ENTRANCES	EACH	10	10
#	X4022000	TEMPORARY ACCESS (COMMERCIAL ENTRANCE)	ЕАСП	10	10
#	X4023000	TEMPORARY ACCESS (ROAD)	EACH	5	5
*#	X7810300	RECESSED REFLECTIVE PAVEMENT MARKERS	EACH	179	179
*#	Z0012754	STRUCTURAL REPAIR OF CONCRETE (DEPTH EQUAL TO OR LESS	SQ FT	15	15
		THAN 5 INCHES)	•		
	70010500		1 () () ()	2	
	20019600	DUST CONTROL WATERING	UNIT	3	3
	Z0030850	TEMPORARY INFORMATION SIGNING	SQ FT	129	129
\$#	Z0076600	TRAINEES	HOUR	500	500
					E-HILLOW -
\$#	70076604	TRAINEES TRAINING PROGRAM GRADUATE	HOUR	500	500
7					
					:
, is	INDICATES	SPECIALTY ITEM			

* INDICATES SPECIALTY ITEM
INDICATES SPECIAL PROVISION
\$ INDICATES CONSTRUCTION CODE 0042 TRAINEES

BAXTER WOODMAN Consulting Engineers

USER NAME = jharris	DESIGNED SAM	REVISED -
	DRAWN MJO	REVISED -
PLOT SCALE = 40.0000 ' / in.	CHECKED DJS	REVISED -
PLOT DATE = 11/10/2021	DATE - 09-27-2021	FILE - 191518SHT-SOQ.dgn


STATE OF ILLINOIS DEPARTMENT OF TRANSPORTATION

SUMMARY OF QUANTITIES										
SCALE:	SHEET	3	OF	3	SHEETS	STA.	TO STA.			

TR RTE,	SECTION	COUNTY SI	OTAL HEETS	NO.		
143	20-00008-00-RS	MCHENRY	26	6		
	,	CONTRACT N	10. 61	LH53		
ILLINOIS FED, AID PROJECT						


STATE OF ILLINOIS - PROFESSIONAL DESIGN FIRM ..., Plortdrv, podf-BW Default, pit LICENSE NO. - 184-001121 - EXPIRES 4/30/2021 ..., CAD/Plots\191518 Pen.tbl jharis 11/10/2021 12:52:21 PM i:\Crystal Lake\BULLV\191518-Mason Hill Road Ph

MASON HILL ROAD STA 10+00 to STA 75+53 STA 113+00 to STA 115+30

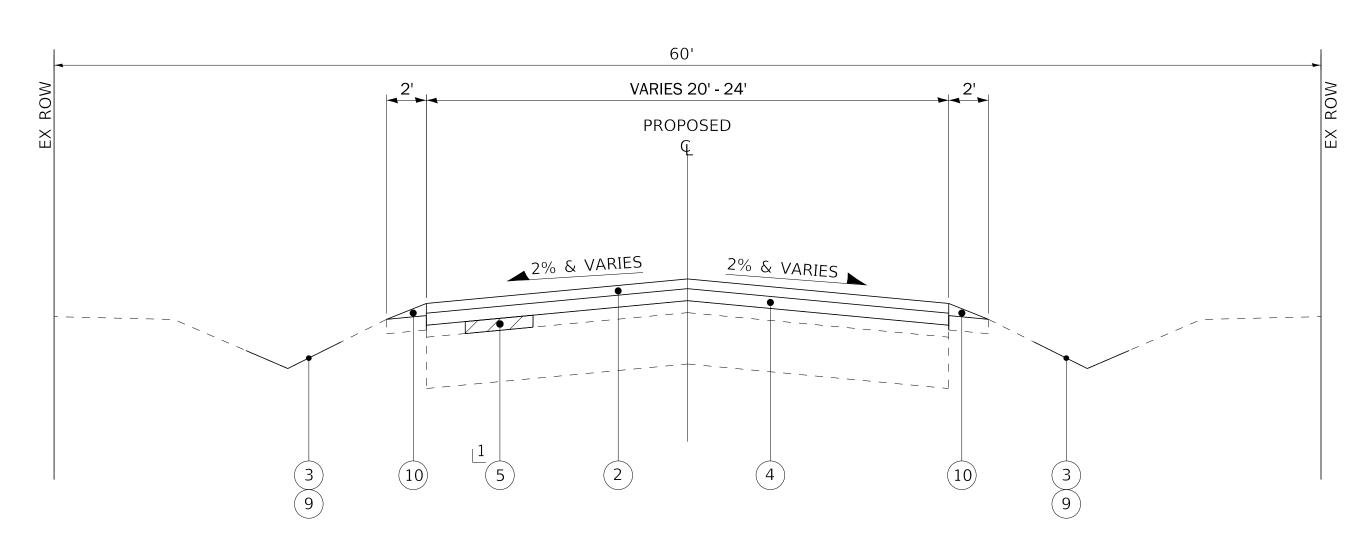


PROPOSED TYPICAL SECTION

MASON HILL ROAD STA 10+00 to STA 75+53 STA 113+00 to STA 115+30

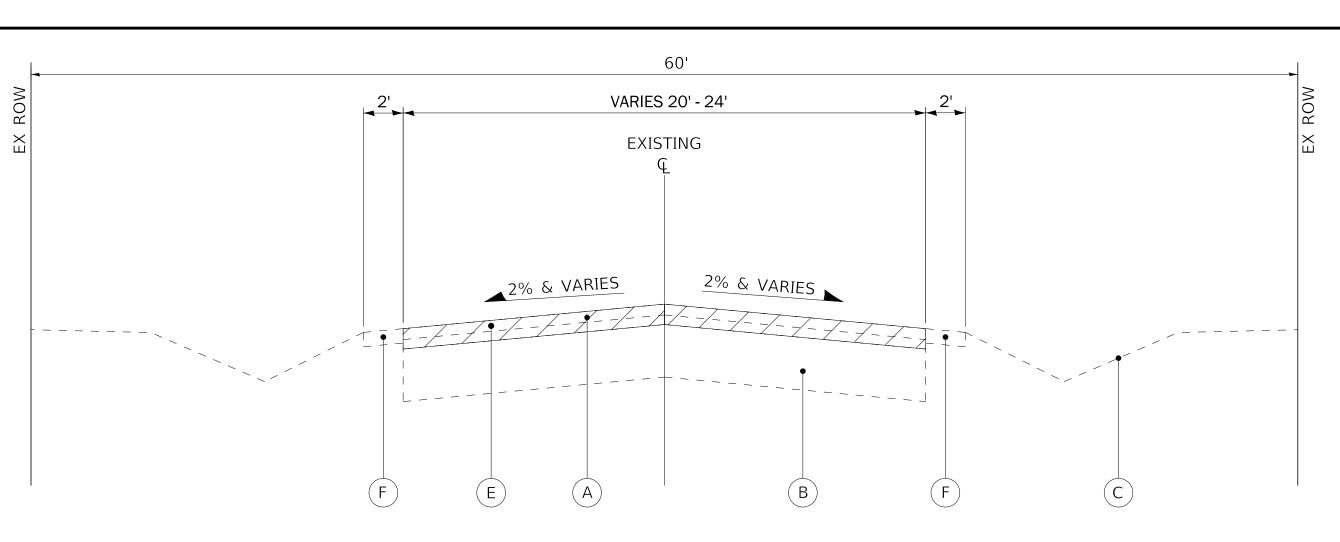

EXISTING TYPICAL SECTION

MASON HILL ROAD STA 75+53 to STA 113+00

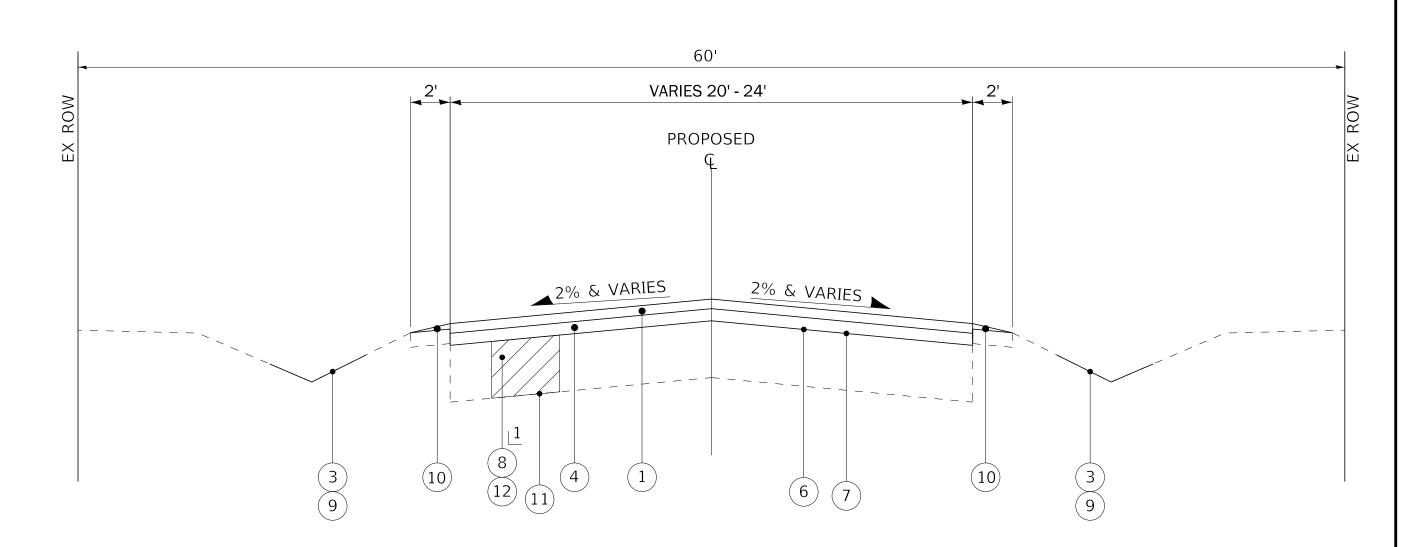

PROPOSED TYPICAL SECTION MASON HILL ROAD

STA 75+53 to STA 113+00

1 AS DETERMINED BY ENGINEER

EXISTING PAVEMENT THICKNESS TABLE

	EXISTING	EXISTING
	нма	AGGREGATE
STA	PAVEMENT	BASE
10+00	6.5"	5.75"
15+50	6.25"	9.5"
21+00	5.75"	6.75"
26+50	3"	5.25"
32+00	5.75"	6.25"
37+50	6.75"	8.5"
43+00	6.25"	6.5"
48+50	6.25"	6.5"
54+00	5.25"	12"
59+50	2.25"	6.5"
65+00	5.5"	10.75"
70+50	4.5"	7.75"
76+00	3.25"	5.5"
81+50	3"	9.25"
87+00	2.5"	9"
92+50	2.75"	11"
98+00	3.75"	7.25"
103+50	5"	16"
109+00	3.5"	4.75"
114+50	13.75"	6"

EXISTING LEGEND

EXISTING HMA BINDER & SURFACE COURSE, (SEE EXISTING PAVEMENT THICKNESS TABLE) EXISITNG AGGREGATE BASE COURSE, (SEE EXISTING PAVEMENT THICKNESS TABLE) EXISTING GROUND SURFACE HOT-MIX ASPHALT SURFACE REMOVAL, 2" HOT-MIX ASPHALT SURFACE REMOVAL, 4" EXISTING AGGREGATE SHOULDER

1 AS DETERMINED BY ENGINEER

PROPOSED LEGEND

- HOT-MIX ASPHALT SURFACE COURSE, IL-9.5, MIX "D", N50 2"
- HOT-MIX ASPHALT SURFACE COURSE, IL-9.5, MIX "D", N50 1.5"
- GRADING AND SHAPING DITCHES
 - HOT-MIX ASPHALT BINDER COURSE, IL-19.0, N50 2 1/2"
 - CLASS D PATCHES
- PREPARATION OF BASE
- AGGREGATE BASE REPAIR
- AGGREGATE SUBGRADE IMPROVEMENT
- SEEDING, CLASS 4A
- AGGREGATE WEDGE SHOULDER, TYPE B
- GEOTECHNICAL FABRIC FOR GROUND STABILIZATION
- REMOVAL AND DISPOSAL OF UNSUITABLE MATERIAL

HOT-MIX ASPHALT REQUIREMENTS

MIXTURE TYPE	AIR VOIDS @ Ndes	QMP
ESURFACING		,
HOT-MIX ASPHALT SURFACE COURSE, IL-9.5, MIX "D", N50; 2"	4% @ 50 GYR	LR 1030-2
HOT-MIX ASPHALT SURFACE COURSE, IL-9.5, MIX "D", N50; 1 1/2"	4% @ 50 GYR	LR 1030-2
HOT-MIX ASPHALT BINDER COURSE, IL-19.0, N50; 2-1/2"	4% @ 50 GYR	LR 1030-2
ATCHING		
CLASS D PATCHES (HMA BINDER COURSE, IL-19.0)	4% @ 70 GYR	LR 1030-2
RIVEWAYS		
INCIDENTAL HOT-MIX ASPHALT SURFACING (HOT-MIX ASPHALT SURFACE COURSE, IL-9.5, MIX "D", N50); 2"	4% @ 50 GYR	LR 1030-2
MP DESIGNATION: QUALITY CONTROL/QUALITY ASSURANCE (QC/QA) PER LR 1030-2	•	·

THE UNIT WEIGHT USED TO CALCULATE ALL HOT-MIX ASPHALT SURFACE MIXTURE QUANTITIES IS 112 LB/SY-IN.

TO STA.

THE 'AC TYPE' FOR POLYMERIZED HMA MIXES SHALL BE "SBS/SBR PG 76-22" AND FOR NON-POLYMERIZED HMA THE "AC TYPE" SHALL BE "PG 64-22" UNLESS MODIFIED BY RECLAIMED MATERIALS SPECIFICATIONS.

THE LONGITUDINAL JOINT SEALANT SHALL BE PLACED OVER THE HOT-MIX ASPHALT BINDER.

USER NAME = jharris	DESIGNED	SAM	REVISED -
	DRAWN	MJO	REVISED -
PLOT SCALE = 20.0000 ' / in.	CHECKED	DJS	REVISED -
PLOT DATE = 11/10/2021	DATE	- 09-27-2021	FILE - 191518SHT-TypSec.dgn

REMOVAL ITEM

STATE OF ILLINOIS DEPARTMENT OF TRANSPORTATION

			TYP	PICA	AL SEC	CTIONS	}
SCALE:	SHEET	1	OF	1	SHEETS	STA.	

TR RTE.	SECT	ΓΙΟΝ		COUNTY	TOTAL SHEETS	SHEET NO.
143	20-00008-00-RS			MCHENRY	26	7
				CONTRACT	NO. 6	1H53
		ILLINOIS	FED Δ	ID PROJECT		

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SCHEDULE OF QUANTITIES

				PRO	OPOSED	SIGN SCHED	ULE			
						72400100	72400200	72400600	72000100	72800100
						REMOVE SIGN PANEL ASSEMBLY- TYPE A	REMOVE SIGN PANEL ASSEMBLY- TYPE B		SIGN PANEL - TYPE 1	TELESCOPING STEEL SIGN SUPPORT
STA	OFFSET	SIGN	MUTCD CODE	SIGN SIZE	SIGN AREA	EACH	EACH	EACH	SQ FT	FOOT
9+70	RT	VILLAGE OF BULL VALLEY 50 MPH	IL-I101 R2-1	48X24 24X30	8.00 5.00	0	1	1	13.00	37.00
10+04	LT	45 MPH DORR TWP	R2-1	24X30 20X12	5.00 1.67	1	0	0	6.67	14.00
		BICYCLE	W11-1	30X30	6.25					
10+50	RT	SHARE THE ROAD	W16-1P	18X24	3.00	0	0	0	9.25	30.00
13+32	RT	INTERSECTION WARNING	W2-2	30X30	6.25	0	0	0	9.08	29.33
		CHERRY VALLEY ROAD	W16-8P	51X8	2.83	, and the second		,		29.55
15+50	LT	BICYCLE SHARE THE ROAD	W11-1 W16-1P	30X30 18X24	6.25 3.00	0	0	0	9.25	32.00
16+14	RT	STOP	R1-1	36X36	9.00	1	0	0	9.00	27.00
16+41	LT	TWO DIRECTION ARROW	W1-7	48X24	8.00	1	0	0	8.00	26.00
16+60	RT	STOP	R1-1	36X36	9.00	1	0	0	9.00	27.00
16+62	RT	CHERRY VALLEY ROAD	D3-1	78X12	6.50	1	0	0	11.75	13.00
		MASON HILL ROAD	D3-1	63X12	5.25					
17+30	RT	BICYCLE SHARE THE ROAD	W11-1 W16-1P	30X30 18X24	6.25 3.00	0	0	0	9.25	32.00
19+46	LT	INTERSECTION WARNING	W2-2	30X30	6.25	- 0	0	0	9.08	29.33
13140	LI	CHERRY VALLEY ROAD	W16-8P	51X8	2.83	U	U	Ü	3.00	29.33
20+15	RT	INTERSECTION WARNING	W2-2	30X30	6.25	0	0	0	9.08	29.33
21 - 05	1.7	CHERRY VALLEY ROAD	W16-8P	51X8	2.83	1			F 00	12.50
21+95	LT	50 MPH	R2-1	24X30	5.00	1			5.00	13.50
22+25	LT	BICYCLE SHARE THE ROAD	W11-1 W16-1P	30X30 18X24	6.25 3.00	0	0	0	9.25	32.00
22+97	LT	CHERRY VALLEY ROAD	D3-1	78X12	6.50	1	0	0	11 75	13.00
22+97	LI	MASON HILL ROAD	D3-1	63X12	5.25	1	U	U	11.75	13.00
23+04	LT	STOP	R1-1	36X36	9.00	1	0	0	9.00	27.00

						72400100	72400200	72400600	72000100	72800100	
						REMOVE SIGN PANEL ASSEMBLY- TYPE A	REMOVE SIGN PANEL ASSEMBLY- TYPE B	RELOCATE SIGN PANEL ASSEMBLY - TYPE B	SIGN PANEL - TYPE 1	TELESCOPING STEEL SIGN SUPPORT	
STA	OFFSET	SIGN	MUTCD CODE	SIGN SIZE	SIGN AREA	EACH	EACH	EACH	SQ FT	FOOT	
23+16	RT	TWO DIRECTION ARROW	W1-7	48X24	8.00	1	0	0	8.00	26.00	
		BICYCLE	W 1 1 - 1	30X30	6.25						
24+00	RT	SHARE THE ROAD	W16-1P	18X24	3.00	0	0	0	9.25	32.00	
25+00	RT	NO PASSING ZONE	W14-3	48X48X36	6.00	0	0	0	6.00	27.00	
26+29	LT	INTERSECTION WARNING	W2-2	30X30	6.25	0	0	0	9.08	29.33	
20123	L1	CHERRY VALLEY ROAD	W16-8P	51X8	2.83	Ü	Ü	O	3.00	29.33	
31+03	RT	50 MPH	R2-1	24X30	5.00	1	0	0	5.00	13.50	
62+82	RT	MAINTAINED BY		18×24	3.00	1	0	0	3.75	13.00	
02 1 02	111	NUNDA TWP		18x6	0.75	1	Ů	Ŭ	3.73	15.00	
71+09	LT	NO PASSING ZONE	W14-3	48X48X36	6.00	0	0	0	6.00	27.00	
74+93	RT	50 MPH	R2-1	24X30	5.00	1	0	0	5.00	13.50	
75+92	LT	MAINTAINED BY		18x24	3.00	1	0	0	3.75	13.00	
73+92	LI	NUNDA TWP		18x6	0.75	1	U	U	5.75	15.00	
90+77	LT	50 MPH	R2-1	24X30	5.00	1			5.00	13.50	
92+42	RT	INTERSECTION WARNING	W2-2	30X30	6.25	0	0	0	7.92	29.33	
		BALLINA LANE	W16-8P	30X8	1.67						
99+03	RT	STOP	R1-1	36X36	9.00	1	0	0	9.00	27.00	
99+03	RT	BALLINA LANE	D3-1	48X12	4.00	0	0	0	9.25	13.00	
33103	111	MASON HILL ROAD	D3-1	63X12	5.25	Ü	Ü	Ü	3.23	13.00	
102+04	LT	INTERSECTION WARNING	W2-2	30X30	6.25	0	0	0	7.92	29.33	
		BALLINA LANE	W16-8P	30X8	1.67						
112+93	RT	SIGNAL AHEAD	W3-3	30X30	6.25	1	0	0	6.25	14.50	
113+16	LT	VILLAGE OF BULL VALLEY		48X24	8.00	0	1	1	13.00	37.00	
112.07		50 MPH	R2-1	24X30	5.00				1.50	11.50	
113+87	LT	SCENIC DRIVE	1412.5	18X12	1.50	1	0	0	1.50	11.50	
114,75		BICYCLE	W 1 1 - 1	30X30	6.25				0.25	22.00	
114+75	LT	SHARE THE ROAD	W16-1P	18X24	3.00	0	0	0	9.25	32.00	
					TOTAL	17	2	2	273	813	

	USER NAME = kroberson	DESIGNED SAM	REVISED -
RAXTER AWOODMAN		DRAWN MJO	REVISED -
BAXTER WOODMAN Consulting Engineers	PLOT SCALE = 40.0000 ' / in.	CHECKED DJS	REVISED -
_	PLOT DATE = 11/3/2021	DATE - 09-27-2021	FILE - 191518SHT-SOQ.dgn

STATE OF ILLINOIS
DEPARTMENT OF TRANSPORTATION

SCALE:

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,	SCHI	וטעב	LE	OF QU	ANTITIE	5		143	20-0000	8-00-RS		MCHE
												CONT
SHEET	1	OF	1	SHEETS	STA.		TO STA.			ILLINOIS	FED. A	ID PROJECT

R2-1 SPEED 45 MPH LIMIT 24" X 30" **45** CUSTOM DORR TWP ROAD DIST 20" x 12" (BLACK LETTERS ON WHITE BACKGROUND, 3" CAPITAL LETTERS, SERIES C FONT) STA 10+00 TO STA 73+53 STA 10+04 HOT-MIX ASPHALT SURFACE COURSE, IL-9.5, MIX "D", N50 1.5" BEGIN IMPROVEMENTS HOT-MIX ASPHALT BINDER COURSE, IL-19.0, N50 2.5" MASON HILL ROAD [']HOT-MIX ASPHALT SURFACE REMOVAL, 2" STA 10+00 EX ROW EX ROW 00 AGGREGATE WEDGE SHOULDER, TYPE B (TYP) -HOT-MIX ASPHALT SURFACE REMOVAL-BUTT JOINTS -— 22' Е-Е LINE 30' **MASON HILL ROAD** REMOVE SIGN PANEL ASSEMBLY - TYPE B (2 SIGNS) $\frac{1}{\infty}$ LINE 4" (DOUBLE YELLOW, 11" C-C) EX ROW EX ROW 8019 Village Of LINE 4" (WHITE EDGE LINE) (TYP) -48 x 24 STA 9+70 RECESSED REFLECTIVE PAVEMENT MARKER - TWO WAY AMBER MAILBOX TURNOUT — AGGREGATE WEDGE SHOULDER, TYPE B (TYP) — HOT-MIX ASPHALT SURFACE — REMOVAL - BUTT JOINTS INCIDENTAL HOT-MIX ASPHALT SURFACING -**BICYCLE** RELOCATE SIGN PANEL ASSEMBLY - TYPE B (5 SIGNS) 30" X 30" W16-1P SHARE THE ROAD 18" X 24" STA 10+50 STA 16+41 BICYCLE GRADING AND SHAPING DITCHES - 100 ft -30" X 30" W16-1P SHARE THE ROAD LINE 4" (WHITE EDGE LINE) (TYP) — — PIPE CULVERT REMOVAL 7921 HOT-MIX ASPHALT SURFACE — ROAD 18" X 24" PIPE CULVERTS, CLASS D, TYPE 1 15" REMOVAL - BUTT JOINTS STA 15+50 AGGREGATE WEDGE SHOULDER, TYPE B (TYP) — METAL FLARED END SECTIONS 15" PE GRAVEL EX ROW **EX ROW** EX ROW 00 **MASON HILL ROAD** 18 57' — 22' Е-Е 15+00 LINE 45' 20' MAILBOX TURNOUT -----EX ROW EX ROW EX ROW RECESSED REFLECTIVE PAVEMENT -MARKER - TWO WAY AMBER Mason Hill Rd INTERSECTION WARNING - W11-1 BICYCLE TATE OF ILLINOIS - PROFESSIONAL DESIGN FIRM ICENSE NO. - 184-001121 - EXPIRES 4/30/2021 narris 9:45:18 AM LINE 4" (DOUBLE YELLOW, 11" C-C) — 30" X 30" D3-1 MASON HILL RD W16-1P CHERRY VALLEY RD \$\text{L MASON HILL ROAD STA 16+35}\$ SHARE THE ROAD 36" X 12" 51" X 8" SHARE Cherry Valley Rd CHERRY VALLEY ROAD 18" X 24" STOP R1-1— 36" X 36" STA 13+32 ROAD **Cherry Valley Rd** STA 17+30 AGGREGATE WEDGE SHOULDER, TYPE B (TYP) — STA 16+14 ROAD D3-1 GRADING AND SHAPING DITCHES - 100 ft -CHERRY VALLEY RD HOT-MIX ASPHALT SURFACE REMOVAL-BUTT JOINTS -NOTES: 78" X 12" **(STOP)** 36" × 36" STA 16+62 1. ALL PAVEMENT MARKINGS ARE THERMOPLASTIC UNLESS OTHERWISE NOTED. 2. ALL PROPOSED SIGNS SHALL BE MOUNTED ON TELESCOPING STEEL SIGN SUPPORTS. STA 16+60 TOTAL SHEET NO. TR RTE. USER NAME = jharris DESIGNED SAM REVISED SECTION COUNTY STATE OF ILLINOIS PLAN - MASON HILL ROAD BAXTER DRAWN MJO REVISED 26 20-00008-00-RS MCHENRY DEPARTMENT OF TRANSPORTATION PLOT SCALE = 20.0000 ' / in. CHECKED DJS REVISED CONTRACT NO. 61H53 PLOT DATE = 11/3/2021DATE - 09-27-2021 FILE - 191518SHT-Plan01.dgn SCALE: 1'' = 20' SHEET 1 OF 10 SHEETS STA. TO STA. ILLINOIS FED. AID PROJECT

STATE OF ILLINOIS - PROFESSIONAL DESIGN FIRM ...\P LICENSE NO. - 184-001121 - EXPIRES 4/30/2021 ...\C jharris 11/3/2021 9:45:19 AM I.\C MODEL: Default FILE NAME: I:\Crystal Lake\BULL\\191518-Mason Hill Road Ph 1\CAD\Sheets

CHERRY VALLEY
ROAD RECESSED REFLECTIVE PAVEMENT — Mason Hill Rd STOP MARKER - TWO WAY AMBER 36" X 36" D3-1 STA 23+04 MASON HILL RD INTERSECTION WARNING LIMIT R2-1 63" X 12" 30" X 30" 24" X 30" W16-8P Cherry Valley Rd Cherry Valley Rd CHERRY VALLEY RD STA 21+95 D3-1 51" X 8" CHERRY VALLEY RD TWO DIRECTION ARROW STA 19+46 LINE 4" (DOUBLE YELLOW, 11" C-C) — AGGREGATE WEDGE 9" HEIGHT 48" x 24" STA 23+16 SHOULDER, TYPE B (TYP) 78" X 12" EX ROW EX ROW 00 GRADING AND SHAPING-DITCHES - 100 ft **MASON HILL ROAD** Ò ST ∠— 22' E-E 120+00 AGGREGATE WEDGE SHOULDER, TYPE B (TYP) -EX ROW **EX ROW** EX ROW LINE 4" (WHITE EDGE LINE) (TYP) -BICYCLE 30" X 30" GRADING AND SHAPING — INTERSECTION WARNING DITCHES - 100 ft W16-1P SHARE THE ROAD SHARE 18" X 24" CHERRY VALLEY RD STA 22+25 51" X 8" PIPE CULVERT REMOVAL STA 20+15 ROAD PIPE CULVERTS, CLASS D, TYPE 1 15" METAL FLARED END SECTIONS 15" BICYCLE \$\psi\$ MASON HILL ROAD STA 23+21 30" X 30" CHERRY VALLEY ROAD W16-1P THE SHARE THE ROAD 18" X 24" HOT-MIX ASPHALT SURFACE — REMOVAL - BUTT JOIN STA 24+00 — LINE 4" (WHITE EDGE LINE) (TYP) - W2-2 INTERSECTION WARNING 30" X 30" AGGREGATE WEDGE SHOULDER, TYPE B (TYP) — W16-8P CHERRY VALLEY RD 51" X 8" STA 26+30 EX ROW EX ROW EX ROW 00 30. **MASON HILL ROAD** ____ 21' E-E ___ 27 EX ROW EX ROW EX ROW W14-3 NO PASSING ZONE 48" X 48" X 36" - AGGREGATE WEDGE SHOULDER, TYPE B (TYP) LINE 4" (30' SKIP, 10' DASH, YELLOW) — STA 25+00 RECESSED REFLECTIVE PAVEMENT MARKER - TWO WAY AMBER LINE 4" (WHITE EDGE LINE) (TYP) NOTES: 1. ALL PAVEMENT MARKINGS ARE THERMOPLASTIC UNLESS OTHERWISE NOTED. 2. ALL PROPOSED SIGNS SHALL BE MOUNTED ON TELESCOPING STEEL SIGN SUPPORTS. TOTAL SHEET NO. TR RTE. USER NAME = jharris DESIGNED SAM REVISED SECTION STATE OF ILLINOIS PLAN - MASON HILL ROAD BAXTER DRAWN MJO REVISED MCHENRY 26 20-00008-00-RS DEPARTMENT OF TRANSPORTATION PLOT SCALE = 20.0000 ' / in. CHECKED DJS REVISED CONTRACT NO. 61H53 DATE - 09-27-2021 PLOT DATE = 11/3/2021FILE - 191518SHT-Plan02.dgn SCALE: 1'' = 20' SHEET 2 OF 10 SHEETS STA. ILLINOIS FED. AID PROJECT

- HOT-MIX ASPHALT SURFACE N

REMOVAL - BUTT JOINT

STATE OF ILLINOIS - PROFESSIONAL DESIGN FIRM LICENSE NO. - 184-001121 - EXPIRES 4/30/2021 Jharris 11/3/2021 9:45:19 AM

EX ROW

EX ROW

LINE 4" (30' SKIP, 10' DASH, YELLOW) —

- HOT-MIX ASPHALT SURFACE

REMOVAL - BUTT JOINT

SPEED LIMIT

50

R2-1 50 MPH

24" x 30" STA 31+03

17'

AGGREGATE WEDGE SHOULDER, TYPE B (TYP) — HOT-MIX ASPHALT SURFACE — REMOVAL - BUTT JOINT 7510 MAILBOX TURNOUT — EX ROW EX ROW EX ROW 00 **MASON HILL ROAD** - INCIDENTAL HOT-MIX 42 ASPHALT SURFACING 26' 36' ____ 21' E-E <u> 1</u> 37 ₁ 38 | 40+00 MAT EX ROW EX ROW EX ROW RECESSED REFLECTIVE PAVEMENT — AGGREGATE WEDGE SHOULDER, TYPE B (TYP) -MARKER - TWO WAY AMBER LINE 4" (WHITE EDGE LINE) (TYP) — LINE 4" (30' SKIP, 10' DASH, YELLOW) — NOTES: 1. ALL PAVEMENT MARKINGS ARE THERMOPLASTIC UNLESS OTHERWISE NOTED. 2. ALL PROPOSED SIGNS SHALL BE MOUNTED ON TELESCOPING STEEL SIGN SUPPORTS. TOTAL SHEET NO. DESIGNED SAM REVISED TR RTE. USER NAME = jharris SECTION COUNTY STATE OF ILLINOIS PLAN - MASON HILL ROAD BAXTER REVISED DRAWN MJO MCHENRY 26 11 20-00008-00-RS DEPARTMENT OF TRANSPORTATION CHECKED DJS PLOT SCALE = 20.0000 ' / in. REVISED CONTRACT NO. 61H53 SCALE: 1'' = 20' | SHEET 3 OF 10 SHEETS | STA. PLOT DATE = 11/3/2021DATE - 09-27-2021 FILE - 191518SHT-Plan03.dgn ILLINOIS FED. AID PROJECT

AGGREGATE WEDGE SHOULDER, TYPE B (TYP) —

MASON HILL ROAD

EX ROW

LINE 4" (30' SKIP, 10' DASH, YELLOW) —

INCIDENTAL HOT-MIX — ASPHALT SURFACING

33'

7610

EX ROW

EX ROW

36

LINE

HOT-MIX ASPHALT SURFACE —

REMOVAL - BUTT JOINT

| 35+00

MAILBOX TURNOUT —

____ 21' E-E

RECESSED REFLECTIVE PAVEMENT —

MARKER - TWO WAY AMBER

EX ROW

AGGREGATE WEDGE SHOULDER, TYPE B (TYP) —

INCIDENTAL HOT-MIX — ASPHALT SURFACING HOT-MIX ASPHALT SURFACE — REMOVAL - BUTT JOINT MAILBOX TURNOUT — AGGREGATE WEDGE SHOULDER, TYPE B (TYP) — 7406 7406 INCIDENTAL HOT-MIX — ASPHALT SURFACING EX ROW EX ROW EX ROW 00 **MASON HILL ROAD** HOT-MIX ASPHALT SURFACE — 48 REMOVAL - BUTT JOINT 26' 45' 26' ____ 21' E-E ₁₄₆ LINE __ 44 _I 47 EX ROW EX ROW EX ROW LINE 4" (30' SKIP, 10' DASH, YELLOW) — RECESSED REFLECTIVE PAVEMENT — MARKER - TWO WAY AMBER LINE 4" (WHITE EDGE LINE) (TYP) AGGREGATE WEDGE SHOULDER, TYPE B (TYP) — PIPE CULVERT REMOVAL PIPE CULVERTS, CLASS D, TYPE 1 15" METAL FLARED END SECTIONS 15" GRADING AND SHAPING DITCHES - 100 ft — AGGREGATE WEDGE SHOULDER, TYPE B (TYP) — 7304 INCIDENTAL HOT-MIX -ASPHALT SURFACING EX ROW EX ROW 00 EX ROW **MASON HILL ROAD** HOT-MIX ASPHALT SURFACE — REMOVAL - BUTT JOINT - MAILBOX TURNOUT 28' ____ 21' E-E ___ 50+00 6 ı 49 ₁ 51 MAT EX ROW EX ROW AGGREGATE WEDGE SHOULDER, TYPE B (TYP) — RECESSED REFLECTIVE PAVEMENT MARKER - TWO WAY AMBER GRADING AND SHAPING DITCHES - 100 ft — LINE 4" (30' SKIP, 10' DASH, YELLOW) -LINE 4" (WHITE EDGE LINE) (TYP) — NOTES: 1. ALL PAVEMENT MARKINGS ARE THERMOPLASTIC UNLESS OTHERWISE NOTED. 2. ALL PROPOSED SIGNS SHALL BE MOUNTED ON TELESCOPING STEEL SIGN SUPPORTS. TOTAL SHEET NO. DESIGNED SAM REVISED TR RTE. USER NAME = jharris SECTION COUNTY STATE OF ILLINOIS PLAN - MASON HILL ROAD BAXTER REVISED DRAWN MJO MCHENRY 26 12 20-00008-00-RS DEPARTMENT OF TRANSPORTATION PLOT SCALE = 20.0000 ' / in. CHECKED DJS REVISED CONTRACT NO. 61H53

SCALE: 1" = 20' SHEET 4 OF 10 SHEETS STA.

ILLINOIS FED. AID PROJECT

PLOT DATE = 11/3/2021

DATE - 09-27-2021

FILE - 191518SHT-Plan04.dgn

INCIDENTAL HOT-MIX — ASPHALT SURFACING — HOT-MIX ASPHALT SURFACE — HOT-MIX ASPHALT SURFACE (7210)7214 AGGREGATE WEDGE SHOULDER, TYPE B (TYP) — REMOVAL - BUTT JOINT REMOVAL - BUTT JOINT MAILBOX TURNOUT EX ROW — MAILBOX TURNOUT EX ROW EX ROW 00 **MASON HILL ROAD** 09 23' — 21' E-E | 55+00 LINE ₁ 56 MATCH LINE 4" (WHITE EDGE LINE) (TYP) RECESSED REFLECTIVE PAVEMENT — MARKER - TWO WAY AMBER EX ROW EX ROW EX ROW INCIDENTAL HOT-MIX — — HOT-MIX ASPHALT SURFACE ASPHALT SURFACING - HOT-MIX ASPHALT SURFACE REMOVAL - BUTT JOINT REMOVAL - BUTT JOINT - INCIDENTAL HOT-MIX ASPHALT SURFACING LINE 4" (30' SKIP, 10' DASH, YELLOW) — AGGREGATE WEDGE SHOULDER, TYPE B (TYP) — RECESSED REFLECTIVE PAVEMENT — MARKER - TWO WAY AMBER 7020 7020 AGGREGATE WEDGE SHOULDER, TYPE B (TYP) — HOT-MIX ASPHALT SURFACE — HOT-MIX ASPHALT SURFACE — HOT-MIX ASPHALT SURFACE — [∞] HAILBOX TURNOUT — REMOVAL - BUTT JOINT REMOVAL - BUTT JOINT REMOVAL - BUTT JOINT EX ROW 00 EX ROW EX ROW MASON HILL ROAD PE HM INCIDENTAL HOT-MIX -INCIDENTAL HOT-MIX -INCIDENTAL HOT-MIX — -99 ASPHALT SURFACING ASPHALT SURFACING ASPHALT SURFACING 36' 32' 34' LINE ₁ 63 <u> [65+00</u> 60+0021' E-E MAT LINE 4" (30' SKIP, 10' DASH, YELLOW) — LINE 4" (WHITE EDGE LINE) (TYP) EX ROW EX ROW EX ROW AGGREGATE WEDGE SHOULDER, TYPE B (TYP) — STATE OF ILLINOIS - PROFESSIONAL DESIGN FIRM LICENSE NO. - 184-001121 - EXPIRES 4/30/2021 jharris 11/3/2021 CUSTOM 36" x 20" THIS ROAD MAINTAINED (WHITE LETTERS ON BLUE BACKGROUND, LOCAL 1.50" CAPITAL LETTERS, SERIES C FONT) TOWNSHIP ROAD DIST. CUSTOM 6" x 20" | (WHITE LETTERS ON BLUE BACKGROUND, 1.50" CAPITAL LETTERS, SERIES C FONT) STA 62+82 NOTES: 1. ALL PAVEMENT MARKINGS ARE THERMOPLASTIC UNLESS OTHERWISE NOTED. 2. ALL PROPOSED SIGNS SHALL BE MOUNTED ON TELESCOPING STEEL SIGN SUPPORTS. TOTAL SHEET SHEETS NO. TR RTE. USER NAME = jharris DESIGNED SAM REVISED SECTION COUNTY STATE OF ILLINOIS PLAN - MASON HILL ROAD BAXTER REVISED DRAWN MJO MCHENRY 26 13 20-00008-00-RS DEPARTMENT OF TRANSPORTATION CHECKED DJS PLOT SCALE = 20.0000 ' / in. REVISED CONTRACT NO. 61H53

SCALE: 1'' = 20' SHEET 5 OF 10 SHEETS STA.

54+00 TO STA.

ILLINOIS FED. AID PROJECT

PLOT DATE = 11/3/2021

DATE - 09-27-2021

FILE - 191518SHT-Plan05.dgn

___ INCIDENTAL HOT-MIX ASPHALT SURFACING INCIDENTAL HOT-MIX — — HOT-MIX ASPHALT SURFACE ASPHALT SURFACING REMOVAL - BUTT JOINT **(**6912) INCIDENTAL HOT-MIX — AGGREGATE WEDGE SHOULDER, TYPE B (TYP) — HOT-MIX ASPHALT SURFACE — ASPHALT SURFACING - DECORATIVE SIGN REMOVAL - BUTT JOINT HOT-MIX ASPHALT SURFACE — HOT-MIX ASPHALT SURFACE — REMOVAL - BUTT JOINT REMOVAL - BUTT JOINT - INCIDENTAL HOT-MIX ASPHALT SURFACING MAILBOX TURNOUT -EX ROW EX ROW EX ROW 00 00 MAILBOX TURNOUT — **MASON HILL ROAD** 99 72 23' 20' 19' 50' 81' — 21' E-E | 70+00 ш MATCH EX ROW EX ROW EX ROW AGGREGATE WEDGE SHOULDER, TYPE B (TYP) — LINE 4" (WHITE EDGE LINE) (TYP) -HOT-MIX ASPHALT SURFACE — 6907 REMOVAL - BUTT JOINT W14-3 LINE 4" (30' SKIP, 10' DASH, YELLOW) — NO PASSING ZONE INCIDENTAL HOT-MIX — ASPHALT SURFACING 48" X 48" X 36" STA 71+09 RECESSED REFLECTIVE PAVEMENT — MARKER - TWO WAY AMBER STA 75+53 TO STA 75+93 STA 10+00 TO STA 75+53 STA 75+93 TO STA 112+60 40' HOT-MIX ASPHALT SURFACE COURSE, IL-9.5, MIX "D", N50 2", RECESSED REFLECTIVE PAVEMENT — HOT-MIX ASPHALT SURFACE COURSE, IL-9.5, MIX "D", N50 1.5" HOT-MIX ASPHALT BINDER COURSE, IL-19.0, N50 2.5" MARKER - TWO WAY AMBER HOT-MIX ASPHALT BINDER COURSE, IL-19.0, N50 2.5" PAVING HOT-MIX ASPHALT SURFACE REMOVAL, 2" HOT-MIX ASPHALT SURFACE REMOVAL, 4" TRANSITION EX ROW EX ROW EX ROW +00 LINE 4" (DOUBLE YELLOW, 11" C-C) — AGGREGATE WEDGE SHOULDER, TYPE B (TYP) — **MASON HILL ROAD** 78 ∕— 20' E-E , 77 175+00 ₁74 MATCH EX ROW EX ROW EX ROW HOT-MIX ASPHALT SURFACE — ↑ AGGREGATE WEDGE SHOULDER, TYPE B (TYP) — SPEED REMOVAL - BUTT JOINT LINE 4" (WHITE EDGE LINE) (TYP) — CUSTOM 36" x 20" THIS ROAD MAINTAINED LIMIT TATE OF ILLINOIS - PROFESSIONAL DESIGN FIRM ICENSE NO. - 184-001121 - EXPIRES 4/30/2021 harris 9:45:22 AM INCIDENTAL HOT-MIX — **50** (WHITE LETTERS ON BLUE BACKGROUND, LOCAL ASPHALT SURFACING 1.50" CAPITAL LETTERS, SERIES C FONT) TOWNSHIP ROAD DIST. R2-1 CUSTOM 6" x 20" 50 MPH (WHITE LETTERS ON BLUE BACKGROUND, 24" X 30" STA 74+93 1.50" CAPITAL LETTERS, SERIES C FONT) STA 75+92 NOTES: 1. ALL PAVEMENT MARKINGS ARE THERMOPLASTIC UNLESS OTHERWISE NOTED. 2. ALL PROPOSED SIGNS SHALL BE MOUNTED ON TELESCOPING STEEL SIGN SUPPORTS. TOTAL SHEET NO. TR RTE. USER NAME = jharris DESIGNED SAM REVISED SECTION COUNTY STATE OF ILLINOIS PLAN - MASON HILL ROAD BAXTER DRAWN MJO REVISED MCHENRY 26 14 20-00008-00-RS DEPARTMENT OF TRANSPORTATION PLOT SCALE = 20.0000 ' / in. CHECKED DJS REVISED CONTRACT NO. 61H53

SCALE: 1'' = 20' SHEET 6 OF 10 SHEETS STA.

66+00 TO STA.

ILLINOIS FED. AID PROJECT

PLOT DATE = 11/3/2021

DATE - 09-27-2021

FILE - 191518SHT-Plan06.dgn

LINE 4" (WHITE EDGE LINE) (TYP) -EX ROW EX ROW EX ROW AGGREGATE WEDGE SHOULDER, TYPE B (TYP) — MASON HILL ROAD LINE 4" (DOUBLE YELLOW, 11" C-C) — AGGREGATE WEDGE SHOULDER, TYPE B (TYP) — EX ROW EX ROW EX ROW — SN 056-3205 CULVERT REPAIRS - SEE NOTE 3 RECESSED REFLECTIVE PAVEMENT — MARKER - TWO WAY AMBER RECESSED REFLECTIVE PAVEMENT — MARKER - TWO WAY AMBER HOT-MIX ASPHALT SURFACE — — INCIDENTAL HOT-MIX REMOVAL - BUTT JOINT 6604 ASPHALT SURFACING AGGREGATE WEDGE SHOULDER, TYPE B (TYP) — EX ROW EX ROW EX_ROW MASON HILL ROAD 00 42' MAILBOX TURNOUT -40' ∕— 20' E-E 185+00 31' LINE MATCH EX ROW AGGREGATE WEDGE SHOULDER, TYPE B (TYP) — EX ROW EX ROW LINE 4" (WHITE EDGE LINE) (TYP) -HOT-MIX ASPHALT SURFACE — REMOVAL - BUTT JOINT INCIDENTAL HOT-MIX — ASPHALT SURFACING NOTES: LINE 4" (DOUBLE YELLOW, 11" C-C) — 1. ALL PAVEMENT MARKINGS ARE THERMOPLASTIC UNLESS OTHERWISE NOTED. 2. ALL PROPOSED SIGNS SHALL BE MOUNTED ON TELESCOPING STEEL SIGN SUPPORTS. 3. CULVERT REPAIRS: *STRUCTURAL REPAIR OF CONCRETE (DEPTH EQUAL TO OR LESS THAN 5 IN) - 15 SQ FT *EPOXY CRACK INJECTION - 10 FT *ACTUAL REPAIR AREAS SHOULD BE DETERMINED IN THE FIELD BY THE ENGINEER. A NOMINAL AMOUNT OF ADDITIONAL REPAIR QUANTITIES HAVE BEEN PROVIDED TO ACCOUNT FOR REPAIRS NOT NOTED. TOTAL SHEET SHEETS NO. DESIGNED SAM USER NAME = jharris TR RTE. REVISED SECTION COUNTY STATE OF ILLINOIS PLAN - MASON HILL ROAD BAXTER REVISED DRAWN MJO MCHENRY 26 15 20-00008-00-RS DEPARTMENT OF TRANSPORTATION REVISED CHECKED DJS PLOT SCALE = 20.0000 ' / in. CONTRACT NO. 61H53 PLOT DATE = 11/3/2021DATE - 09-27-2021 FILE - 191518SHT-Plan07.dgn SCALE: 1'' = 20' SHEET 7 OF 10 SHEETS STA. 78+00 TO STA. 90+00ILLINOIS FED. AID PROJECT

SPEED LIMIT **50** RECESSED REFLECTIVE PAVEMENT -50 MPH 24" X 30" MARKER - TWO WAY AMBER STA 90+77 EX ROW EX ROW EX ROW AGGREGATE WEDGE SHOULDER, TYPE B (TYP) — **MASON HILL ROAD** — 20' Е-Е LINE 4" (WHITE EDGE LINE) (TYP) AGGREGATE WEDGE SHOULDER, TYPE B (TYP) — EX ROW EX ROW EX ROW LINE 4" (DOUBLE YELLOW, 11" C-C) — LINE 6" (6' SKIP, 2' DASH, WHITE) LINE 6" (WHITE) -**Ballina Ln** 30" X 8" STA 92+42 INCIDENTAL HOT-MIX -ASPHALT SURFACING HOT-MIX ASPHALT SURFACE -INCIDENTAL HOT-MIX — REMOVAL - BUTT JOINT LINE 4" (DOUBLE YELLOW, 11" C-C) — ASPHALT SURFACING ¢ MASON HILL ROAD STA 98+74 6220 HOT-MIX ASPHALT SURFACE -6220 RECESSED REFLECTIVE PAVEMENT — ¢ BALLINA LANE LINE 4" (DOUBLE YELLOW, 11" C-C) — REMOVAL - BUTT JOINT LINE 4" (DOUBLE YELLOW, 11" C-C) — MARKER - TWO WAY AMBER EX ROW EX ROW PE / HMA MASON HILL ROAD AGGREGATE WEDGE SHOULDER, TYPE B (TYP) — 02-31' 100+00 ── 20' E-E LINE 24" (WHITE STOP BAR) AGGREGATE WEDGE SHOULDER, TYPE B (TYP) -EX ROW EX ROW LINE 6" (WHITE) — LINE 4" (WHITE EDGE LINE) (TYP) — Mason Hill Rd - LETTERS AND SYMBOLS (WHITE) LETTERS AND SYMBOLS (WHITE) D3-1 MASON HILL RD 63" X 12" Ballina Ln BALLINA LANE BALLINA LANE 48" X 12" STA 99+03 NOTES: STOP 36" X 36" STA 99+03 1. ALL PAVEMENT MARKINGS ARE THERMOPLASTIC UNLESS OTHERWISE NOTED. HOT-MIX ASPHALT SURFACE — 2. ALL PROPOSED SIGNS SHALL BE MOUNTED ON TELESCOPING STEEL SIGN SUPPORTS. REMOVAL - BUTT JOINT TOTAL SHEET NO. DESIGNED SAM REVISED TR RTE. USER NAME = jharris SECTION COUNTY STATE OF ILLINOIS BAXTER WOODMAN Consulting Engineers PLAN - MASON HILL ROAD REVISED DRAWN MJO MCHENRY 26 16 20-00008-00-RS CHECKED DJS DEPARTMENT OF TRANSPORTATION PLOT SCALE = 20.0000 ' / in. REVISED CONTRACT NO. 61H53 DATE - 09-27-2021

SCALE: 1'' = 20' SHEET 8 OF 10 SHEETS STA. 90+00 TO STA.

ILLINOIS FED. AID PROJECT

PLOT DATE = 11/3/2021

FILE - 191518SHT-Plan08.dgn

— W2-2 INTERSECTION WARNING 30" X 30" W16-8P Ballina Ln BALLINA LN — AGGREGATE WEDGE SHOULDER, TYPE B (TYP) 30" X 8" LINE 4" (DOUBLE YELLOW, 11' C-C) — STA 102+04 EX ROW_ EX ROW **MASON HILL ROAD** 00 — MAILBOX TURNOUT — 20' Е-Е <u>| 105+00</u> EX ROW EX ROW - AGGREGATE WEDGE SHOULDER, TYPE B (TYP) RECESSED REFLECTIVE PAVEMENT -MARKER - TWO WAY AMBER LINE 4" (WHITE EDGE LINE) (TYP) — STA 112+60 TO STA 113+00 STA 75+93 TO STA 112+60 STA 113+00 TO STA 115+30 40' HOT-MIX ASPHALT SURFACE COURSE, IL-9.5, MIX "D", N50 1.5" HOT-MIX ASPHALT SURFACE COURSE, IL-9.5, MIX "D", N50 2" HOT-MIX ASPHALT BINDER COURSE, IL-19.0, N50 2.5" HOT-MIX ASPHALT BINDER COURSE, IL-19.0, N50 2.5" PAVING HOT-MIX ASPHALT SURFACE REMOVAL, 2" HOT-MIX ASPHALT SURFACE REMOVAL, 4" **TRANSITION** MCHENRY COUNTY Village Of **SCENIC DRIVE** 48 x 24 REMOVE SIGN PANEL ASSEMBLY - TYPE B (2 SIGNS) -STA 113+16 Bull Valley SCENIC DRIVE — INCIDENTAL HOT-MIX RELOCATE SIGN PANEL ASSEMBLY - TYPE B (5 SIGNS) -18" X 12" ASPHALT SURFACING SPEED STA 113+87 - INCIDENTAL HOT-MIX R2-1 — HOT-MIX ASPHALT SURFACE 50 MPH 24" X 30" **50** - GRADING AND REMOVAL - BUTT JOINT SHAPING DITCHES 6120 — HOT-MIX ASPHALT SURFACE 6212 (6210) INCIDENTAL HOT-MIX — - 100 ft REMOVAL - BUTT JOINT MAILBOX TURNOUT — ASPHALT SURFACING EX ROW EX ROW EX ROW HOT-MIX ASPHALT SURFACE -- MAILBOX TURNOUT 18' REMOVAL - BUTT JOINT AGGREGATE WEDGE SHOULDER, TYPE B (TYP) — MAILBOX TURNOUT 26' 29' 24' 61' 33' 0 1110+00 24' 20' — 20' Е-Е MASON HILL ROAD LINE 4" (WHITE EDGE LINE) (TYP) EX ROW EX ROW EX ROW RECESSED REFLECTIVE PAVEMENT — AGGREGATE WEDGE SHOULDER, TYPE B (TYP) — MARKER - TWO WAY AMBER HOT-MIX ASPHALT SURFACE — LINE 4" (DOUBLE YELLOW, 11' C-C) — REMOVAL - BUTT JOINT SIGNAL AHEAD 30" x 30" INCIDENTAL HOT-MIX STA 112+93 ASPHALT SURFACING PIPE CULVERT REMOVAL PIPE CULVERTS, CLASS D, TYPE 1 18" METAL FLARED END SECTIONS 18" NOTES: GRADING AND SHAPING DITCHES - 100 ft — 1. ALL PAVEMENT MARKINGS ARE THERMOPLASTIC UNLESS OTHERWISE NOTED. 2. ALL PROPOSED SIGNS SHALL BE MOUNTED ON TELESCOPING STEEL SIGN SUPPORTS. TOTAL SHEET NO. TR RTE. USER NAME = jharris DESIGNED SAM REVISED SECTION COUNTY BAXTER WOODMAN
Consulting Engineers STATE OF ILLINOIS PLAN - MASON HILL ROAD DRAWN MJO REVISED MCHENRY 26 17 20-00008-00-RS DEPARTMENT OF TRANSPORTATION PLOT SCALE = 20.0000 ' / in. CHECKED DJS REVISED CONTRACT NO. 61H53

SCALE: 1'' = 20' SHEET 9 OF 10 SHEETS STA. 102+00 TO STA.

ILLINOIS FED. AID PROJECT

STATE OF ILLINOIS - PROFESSIONAL DESIGN FIRM LICENSE NO. - 184-001121 - EXPIRES 4/30/2021 jharris 11/3/2021 9:45:24 AM

PLOT DATE = 11/3/2021

DATE - 09-27-2021

FILE - 191518SHT-Plan09.dgn



30" X 30" W16-1P 1 1 SHARE THE ROAD 1 1 18" X 24" ROAD STA 114+75 EX ROW +000 CRYSTAL LAKE ROAD — EXISTING CURB & GUTTER MASON HILL ROAD 4 - HOT-MIX ASPHALT SURFACE REMOVAL-BUTT JOINTS 115+00 EX ROW AGGREGATE WEDGE SHOULDER, — TYPE B (TYP) LINE 4" (WHITE EDGE LINE) (TYP) — 1 1 1 1 EXISTING CURB & GUTTER — 1 1 1 1 1 1 1 1 1 1 - END IMPROVEMENTS MASON HILL ROAD STA 115+30

NOTES:

- 1. ALL PAVEMENT MARKINGS ARE THERMOPLASTIC UNLESS OTHERWISE NOTED.
- 2. ALL PROPOSED SIGNS SHALL BE MOUNTED ON TELESCOPING STEEL SIGN SUPPORTS.

RAYTED MAN
BAXTER WOODMAN Consulting Engineers


USER NAME = jharris	DESIGNED SAM	REVISED -
	DRAWN MJO	REVISED -
PLOT SCALE = 20.0000 ' / in.	CHECKED DJS	REVISED -
PLOT DATE = 11/3/2021	DATE - 09-27-2021	FILE - 191518SHT-Plan10.dgn


STATE OF ILLINOIS
DEPARTMENT OF TRANSPORTATION

SCALE: 1'' = 20'

			B.41	4 0 0 N I		DOAD			TR RTE.	SECTION		COUNTY	TOTAL SHEETS	SHEET NO.
	PLAI	V –	· IVI	ASON	HILL	ROAD			143	20-00008-00-RS		MCHENRY	26	18
				Г								CONTRACT	NO. 6	1H53
SHEET	10	OF	10	SHEETS	STA.	114+00	TO STA.	116+01.43		ILLINOIS	FED. Al	D PROJECT		



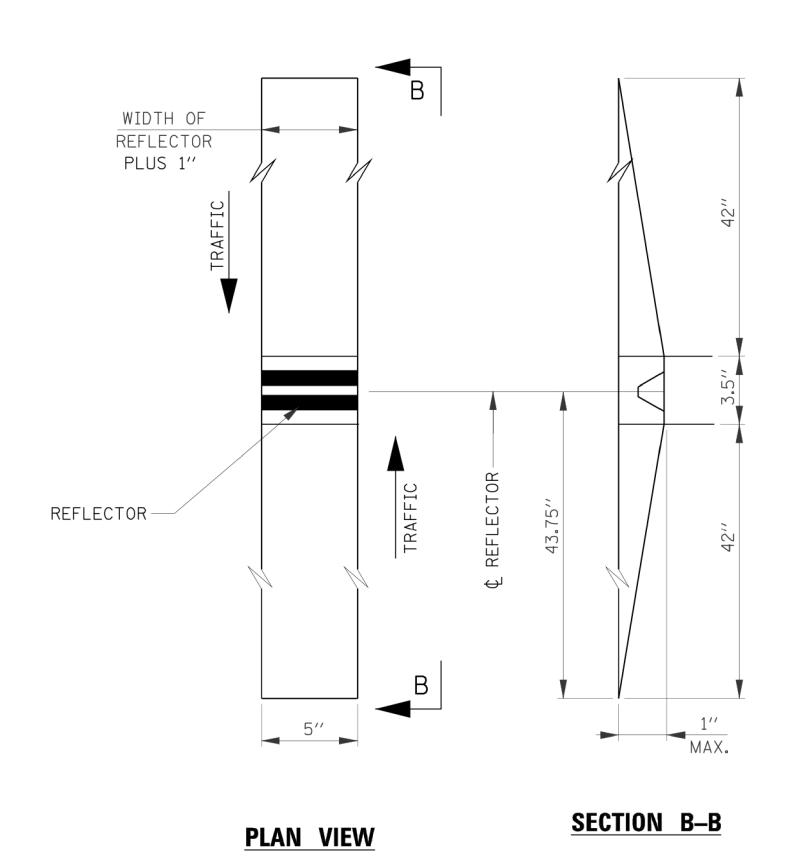

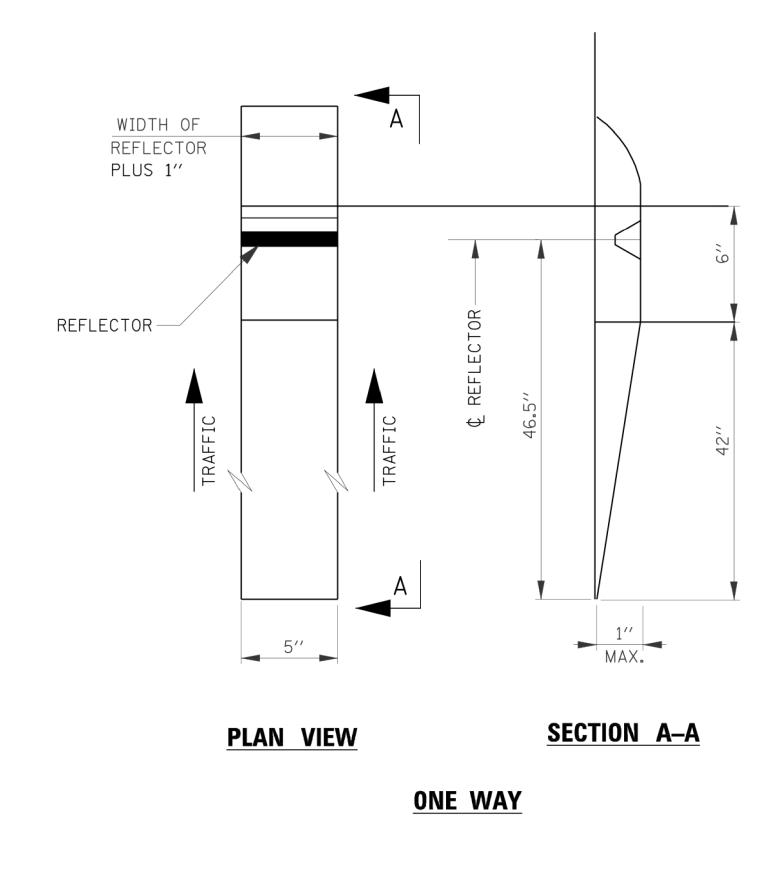

RECESSED REFLECTIVE MARKERS

INSTALLATION NOTES:

- 1. SAWCUT IN DIMENSIONS SHOWN.
- 2. SAWCUT AREAS TO BE DRY AND FREE OR MATERIAL THAT ADVERSELY AFFECTS THE ADHESIVE BAND.
- 3. INSTALL THE REFLECTOR WITH AN APPROVED TWO-COMPONENT EPOXY ADHESIVE. EPOXY SHOULD NOT OBSCURE OR BLOCK THE LENS.

TWO WAY

- 4. INSTALL TOP OF REFLECTOR $\frac{1}{2}$ TO $\frac{1}{4}$ INCH BELOW THE PAVEMENT SURFACE.
- 5. REFLECTOR SHALL BE 3M SERIES 290.


GENERAL NOTES:


- 1. INSTALLATION SHALL CONFORM TO IDOT DISTRICT 1 DETAIL TC-11 (OR LATEST) FOR MARKER PLACEMENT.
- 2. DISTRICT 1 DETAIL TC-11 SHALL BE MODIFIED TO REFLECT IN RECESSED PAVEMENT MARKERS INSTEAD OF RAISED PAVEMENT MARKERS.

MASON HILL ROAD

PAVING DETAIL

NO SCALE

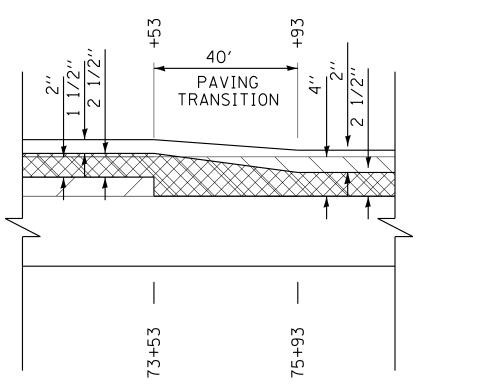

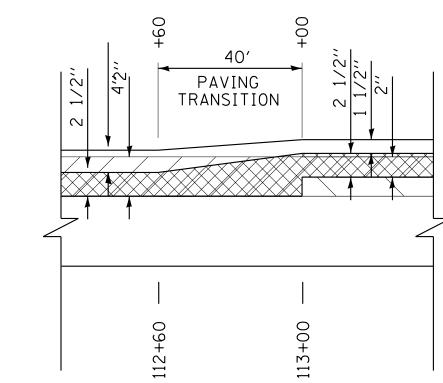

HOT-MIX ASPHALT SURFACE COURSE, MIX "D", N50

HOT-MIX ASPHALT BINDER COURSE, IL-19.0, N50

HOT-MIX ASPHALT SURFACE REMOVAL

EXISTING HOT-MIX ASPHALT PAVEMENT TO REMAIN


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BAXTER		DRA
Consulting Engineers	PLOT SCALE = 20.0000 ' / in.	СНЕ
_	PLOT DATE = 11/3/2021	DAT

USER NAME = jharris	DESIGNED SAM	REVISED -
	DRAWN MJO	REVISED -
PLOT SCALE = 20.0000 ' / in.	CHECKED DJS	REVISED -
PLOT DATE = 11/3/2021	DATE - 09-27-2021	FILE - 191518SHT-MiscDets.dgn

STATE OF ILLINOIS DEPARTMENT OF TRANSPORTATION

SCALE:

BALOOFILI ABIFOLIO DETALLO		TR RTE.	SECTION	COUNTY	OUNTY TOTAL SHEETS		
MISCELLANEOUS DETAILS		143	20-00008-00-RS	MCHENRY	26	19	
				CONTRACT	NO. 61	LH53	
FET 1 OF 1 SHEETS STA	TO STA	ILLINOIS EED AID BROJECT					

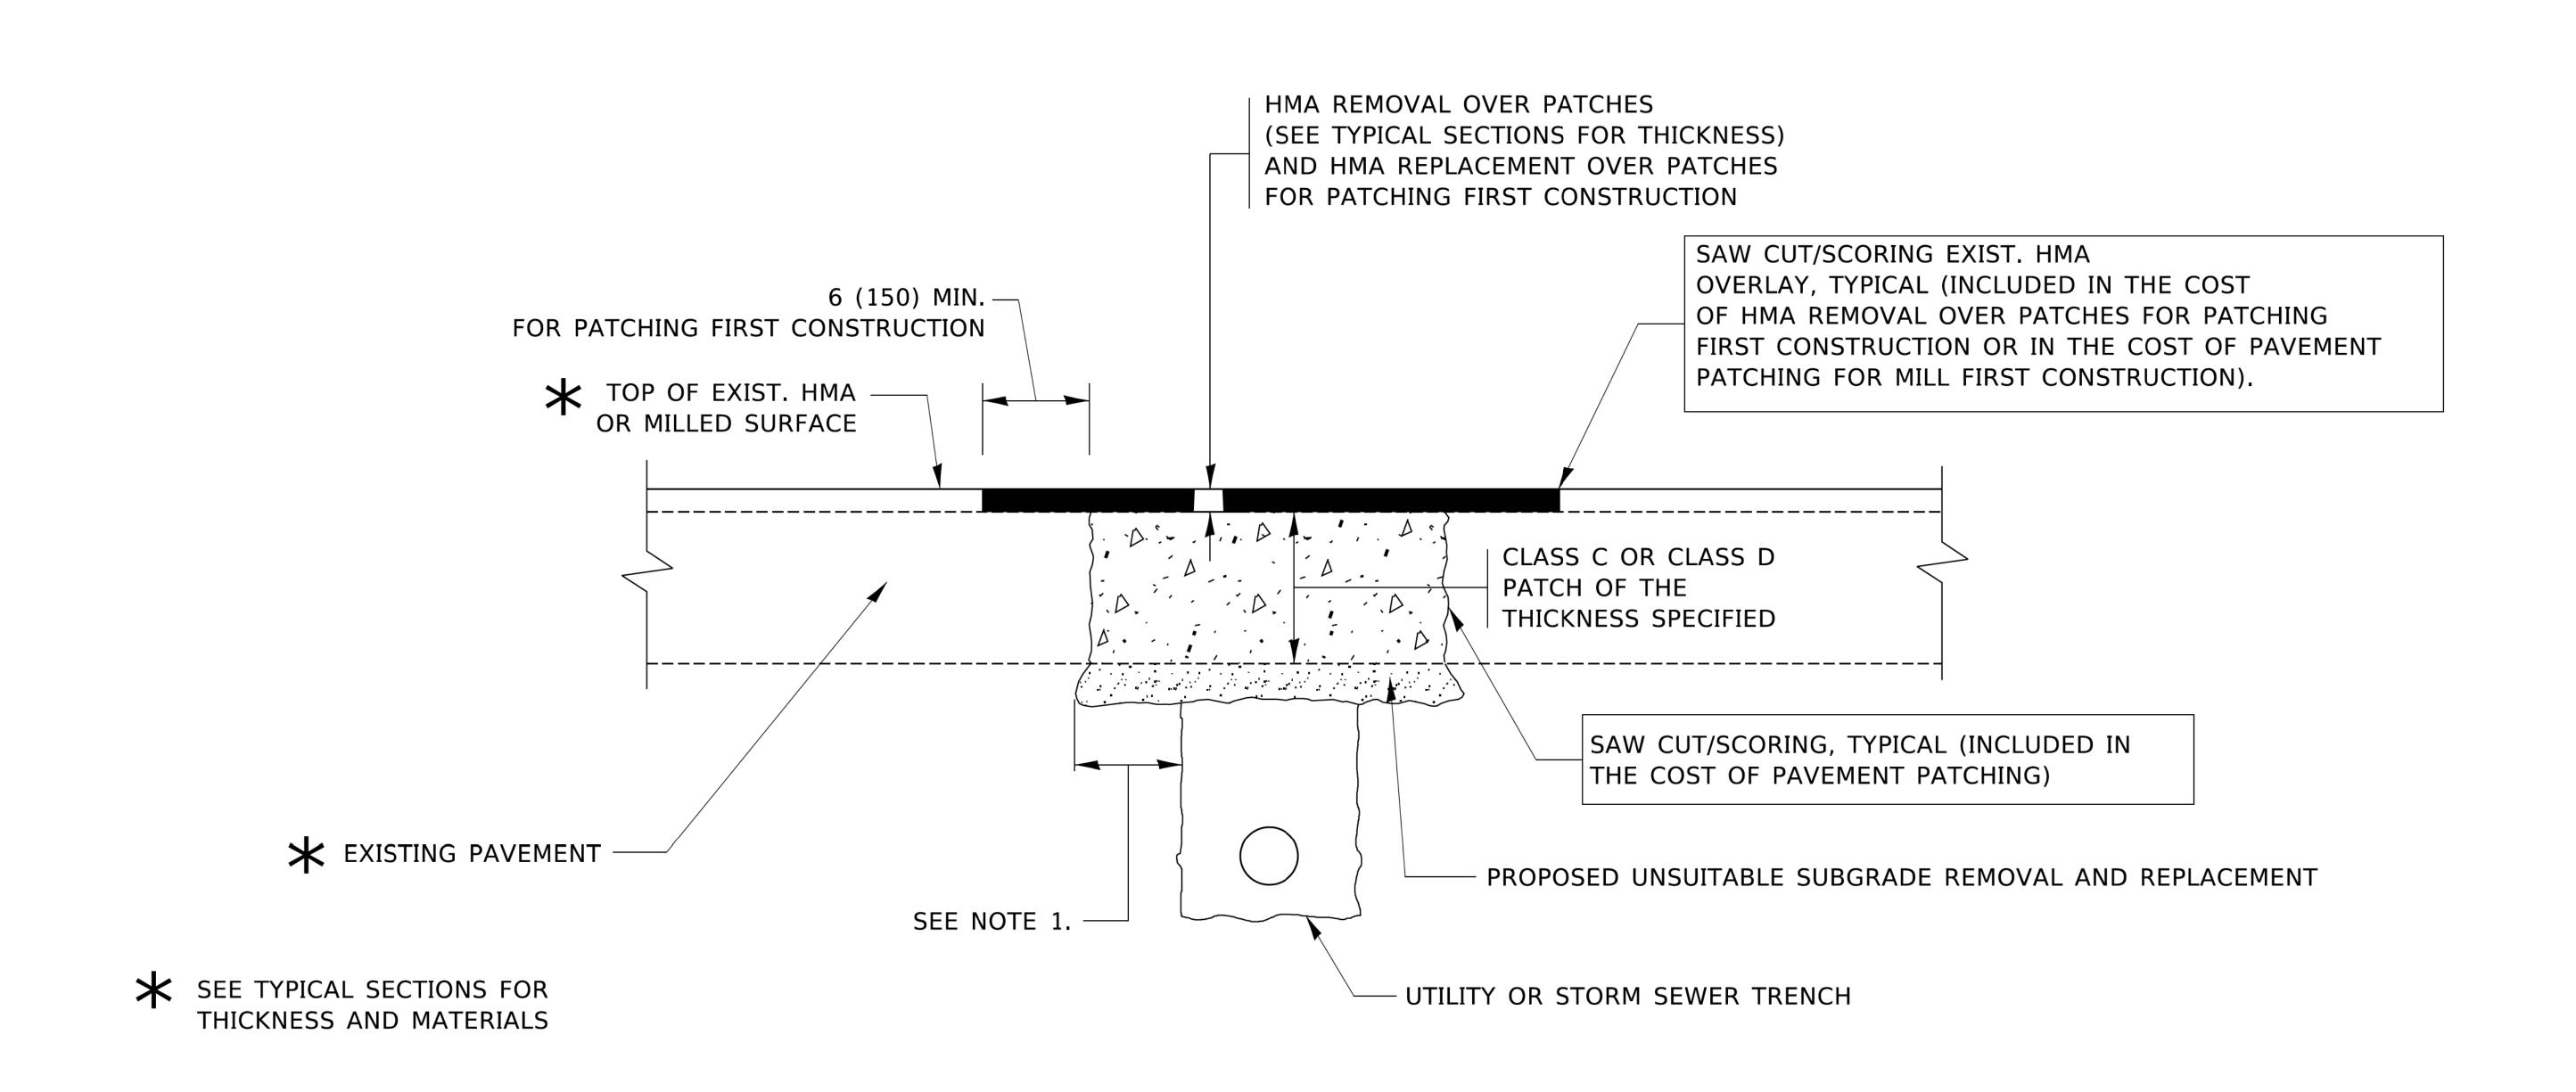

NOTES:

- 1. THE WIDTH OF THE FULL DEPTH PATCH OVER A TRENCH SHALL BE 12 (300) WIDER ON EACH SIDE OF THE TRENCH.
- 2. FOR METHOD OF MEASUREMENT AND BASIS OF PAYMENT, SEE RECURRING SPECIAL PROVISION "PATCHING WITH HOT-MIX ASPHALT OVERLAY REMOVAL".

SEQUENCE OF CONSTRUCTION (PATCHING FIRST)

- 1. REMOVE THE EXISTING HMA MATERIAL OVER THE AREA TO BE PATCHED.
- 2. REMOVE AND REPLACE WITH CLASS C OR D PATCH.
- 3. REPLACE HMA MATERIAL OVER THE AREA TO BE PATCHED.

SEQUENCE OF CONSTRUCTION (MILLING FIRST)


- 1. MILL HMA FIRST IF THERE IS AT LEAST $4\frac{1}{2}$ INCHES OR MORE OF HMA MATERIAL ON TOP OF THE EXISTING PAVEMENT OR IF THE PAVEMENT IS FULL DEPTH HMA. A MINIMUM OF 2 INCHES OF HMA MATERIAL SHALL BE IN PLACE AFTER MILLING.
- 2. REMOVE AND REPLACE WITH FULL DEPTH CLASS D PATCHES TO TOP OF MILLED SURFACE.

ALL DIMENSIONS ARE IN INCHES (MILLIMETERS) UNLESS OTHERWISE SHOWN.

USER NAME = TOOLEMI	DESIGNED - R. SHAH	REVISED - A. ABBAS 04-27-98			PAVEMENT PATCHING FOR	RTE	SECTION	COUNTY	SHEETS NO
	DRAWN -	REVISED - R. BORO 01-01-07	STATE OF ILLINOIS			1112.	20-00008-00-RS	MCHENRY	26 20
PLOT SCALE = 50.0000 ' / in.	CHECKED -	REVISED - R. BORO 09-04-07	DEPARTMENT OF TRANSPORTATION		HMA SURFACED PAVEMENT		BD400-04 (BD-22)	CONTRAC	T NO.61H53
PLOT DATE = $3/27/2019$	DATE - 10-25-94	REVISED - K. ENG 10-27-08		SCALE: NONE	SHEET 1 OF 1 SHEETS STA. TO STA.		ILLINOIS FED. A	AID PROJECT S	49M(198)

(FOR BUTT JOINT AND HMA TAPER SEE DETAIL BELOW)

OPTION 1

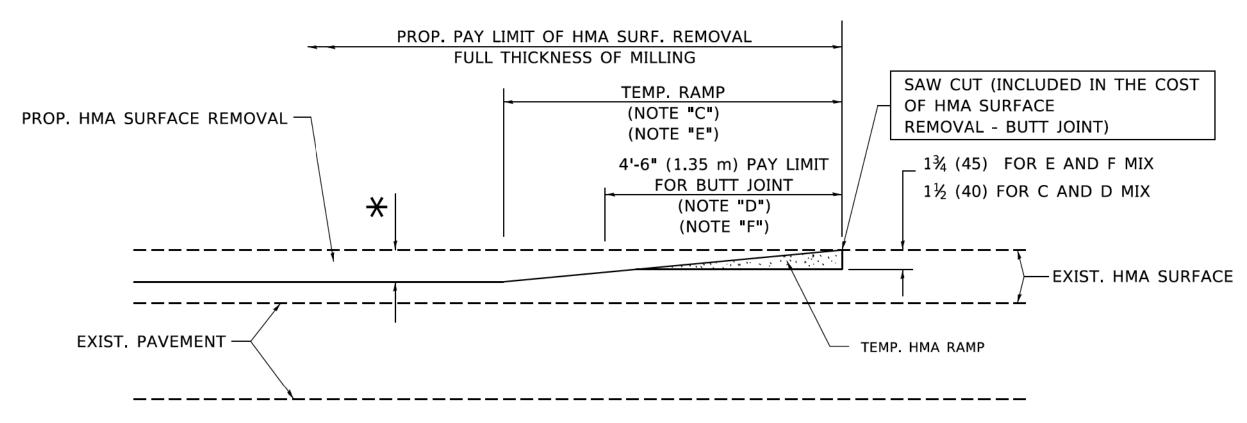


HMA CONSTRUCTED TEMPORARY RAMP

(FOR BUTT JOINT AND HMA TAPER SEE DETAIL BELOW)

OPTION 2

TYPICAL TEMPORARY RAMP

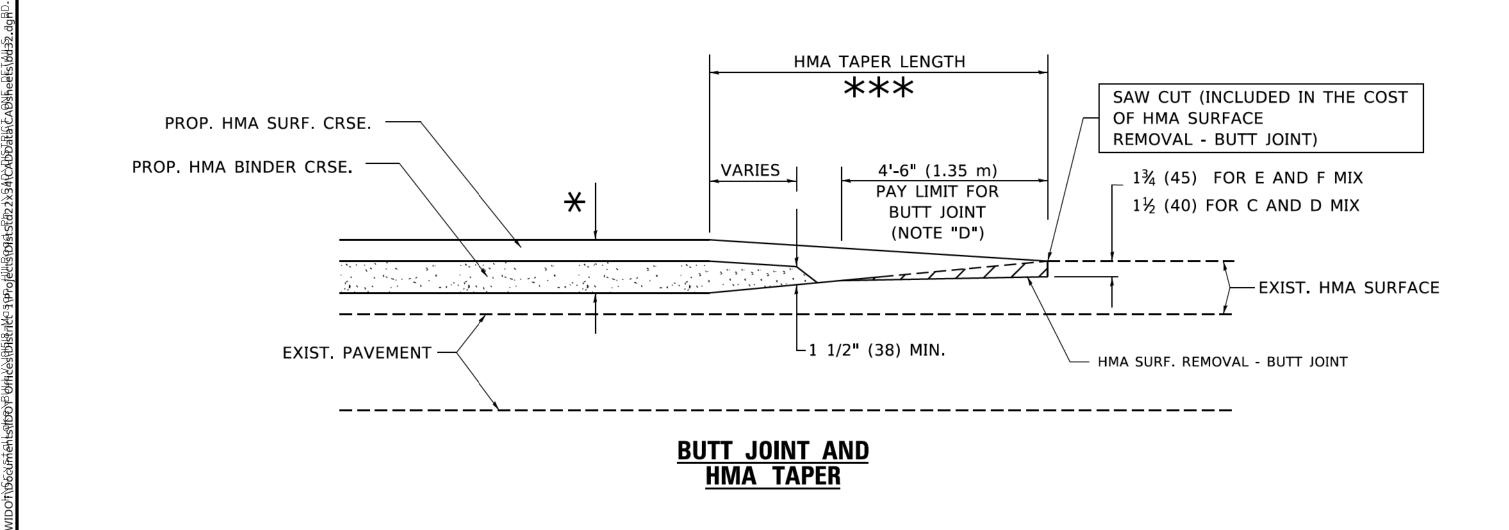

TYPICAL BUTT JOINT AND HMA TAPER FOR MILLING AND RESURFACING


 USER NAME
 = footemj
 DESIGNED
 M. DE YONG
 REVISED
 R. SHAH 10-25-94


 DRAWN
 REVISED
 A. ABBAS 03-21-97

 PLOT SCALE
 = 50.0000 ' / in.
 CHECKED
 REVISED
 M. GOMEZ 04-06-01

 PLOT DATE
 = 3/27/2019
 DATE
 06-13-90
 REVISED
 R.BORO 01-01-07

STATE OF ILLINOIS
DEPARTMENT OF TRANSPORTATION

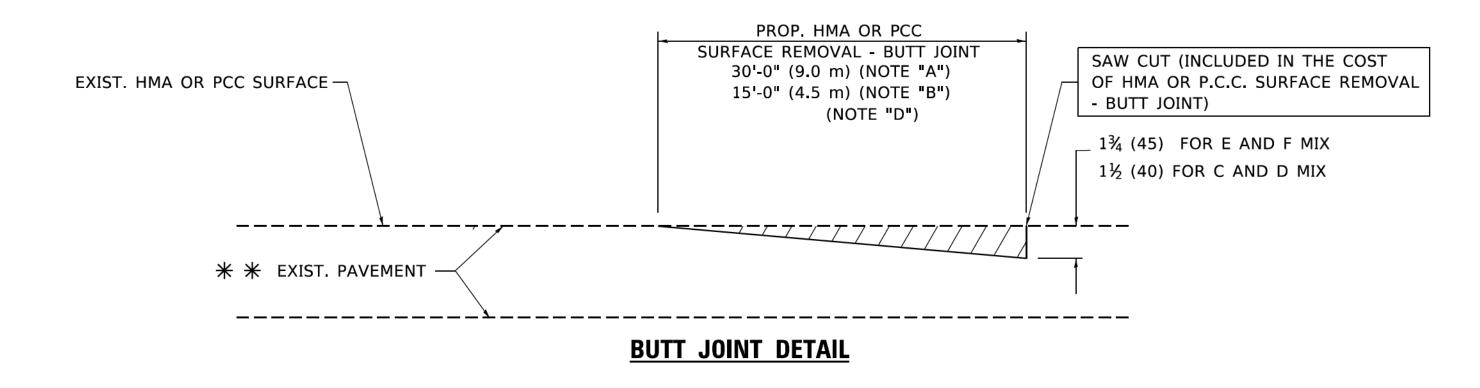

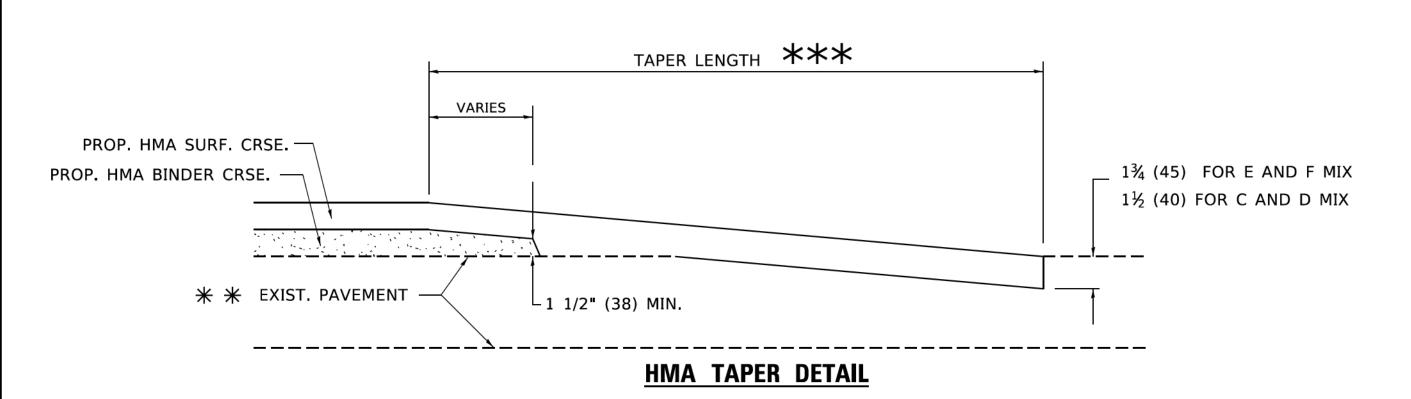

TYPICAL BUTT JOINT AND HMA TAPER FOR RESURFACING ONLY

PC CONCRETE, HMA OR HMA RESURFACED PAVEMENT.

NOTES

- A. MAINLINE ROADWAYS AND MAJOR SIDE ROADS.
- B. MINOR SIDE ROADS.
- C. THE TEMP. RAMP SHALL BE CONSTRUCTED IMMEDIATELY UPON REMOVAL OF THE EXISTING HMA SURFACE.
- D. THE BUTT JOINT SHALL BE CONSTRUCTED IMMEDIATELY PRIOR TO PLACING THE PROPOSED HMA COURSES.
- E. TAPER THE TEMP. RAMP AT A RATE OF 3'-0" (900 mm) PER 1 INCH (25 mm) OF MILLING THICKNESS.
- F. INSTALLATION AND REMOVAL OF THE 4'-6" (1.35 m) TEMP. RAMP IS INCLUDED IN COST OF HMA SURFACE REMOVAL BUTT JOINT.


 SEE TYPICAL SECTIONS FOR MILLING THICKNESS.
- G. SEE ARTICLE 406.08 AND 406.14 OF THE STANDARD SPECIFICATIONS FOR "HMA AND/OR PCC SURFACE REMOVAL, BUTT JOINT".

BASIS OF PAYMENT

THE BUTT JOINT WILL BE PAID FOR AT THE CONTRACT UNIT PRICE PER SQUARE YARD (SQUARE METER)
FOR "HOT-MIX ASPHALT SURFACE REMOVAL - BUTT JOINT" OR FOR "PORTLAND CEMENT CONCRETE SURFACE REMOVAL- BUTT JOINT".

SCALE: NONE

ALL DIMENSIONS ARE IN INCHES (MILLIMETERS) UNLESS OTHERWISE SHOWN.

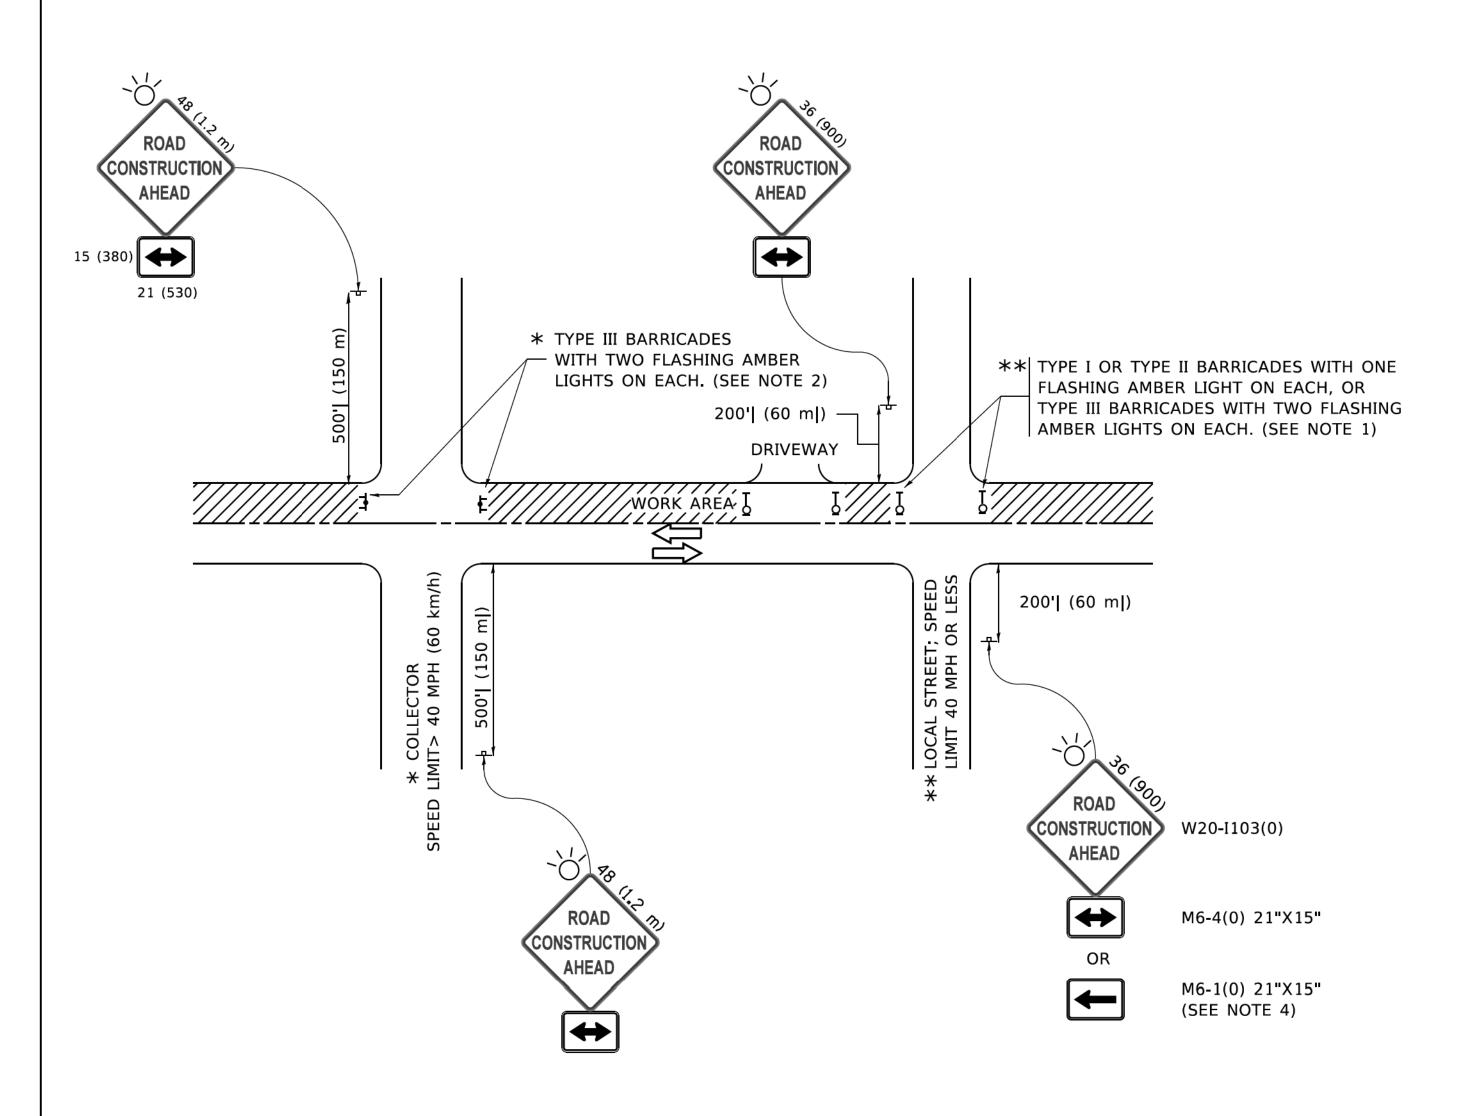

NOTES:

- 1. SIDE ROAD WITH A SPEED LIMIT OF 40 MPH (60 km/h) OR LESS AS SHOWN ON THE DRAWING AND AS DIRECTED BY THE ENGINEER:
- a) ONE "ROAD CONSTRUCTION AHEAD" SIGN 36 x 36 (900x900) WITH A FLASHER MOUNTED ON IT APPROXIMATELY 200' (60 m) IN ADVANCE OF THE MAIN ROUTE.
- b) THE CLOSED PORTION OF THE MAIN ROUTE SHALL BE PROTECTED BY BLOCKING WITH TYPE I, TYPE II OR TYPE III BARRICADES, 1/3 OF THE CROSS SECTION OF THE CLOSED PORTION.
- 2. SIDE ROAD WITH A SPEED LIMIT GREATER THAN 40 MPH (60 km/h) AS SHOWN ON THE DRAWING AND AS DIRECTED BY THE ENGINEER:
- a) ONE "ROAD CONSTRUCTION AHEAD" SIGN 48 x 48 (1.2 m x 1.2 m) WITH A FLASHER MOUNTED ON IT APPROXIMATELY 500' (150 m) IN ADVANCE OF THE MAIN ROUTE.
- THE CLOSED PORTION OF THE MAIN ROUTE SHALL BE PROTECTED BY
 b) BLOCKING WITH TYPE III BARRICADES, 1/2 OF THE CROSS SECTION
 OF THE CLOSED PORTION.
- 3. CONES MAY BE SUBSTITUTED FOR BARRICADES OR DRUMS AT HALF THE SPACING DURING DAY OPERATIONS. CONES SHALL BE A MINIMUM OF 28 (710) IN HEIGHT.
- WHEN THE SIDE ROAD LIES BETWEEN THE BEGINNING OF THE MAINLINE
 4. SIGNING AND THE WORK ZONE, A SINGLE HEADED ARROW (M6-1) SHALL
 BE USED IN LIEU OF THE DOUBLE HEADED ARROW (M6-4).

SCALE: NONE

- 5. WHEN WORK IS BEING PERFORMED ON A SIDE ROAD OR DRIVEWAY, FOLLOW THE APPLICABLE STANDARD(S). THE DIRECTIONAL ARROW (M6-1 OR M6-4) SHALL BE COVERED OR REMOVED WHEN NO LONGER CONSISTENT WITH THE TRAFFIC CONTROL SET-UP.
- ADVANCE WARNING SIGNS ARE TO BE OMITTED ON DRIVEWAYS UNLESS OTHERWISE SPECIFIED IN THE PLANS OR BY THE ENGINEER.
- 7. THE TRAFFIC CONTROL AND PROTECTION FOR SIDE ROADS, INTERSECTIONS, AND DRIVEWAYS SHALL BE INCLUDED IN THE COST OF SPECIFIED TRAFFIC CONTROL STANDARDS OR ITEMS.

All dimensions are in inches (millimeters) unless otherwise shown.

 USER NAME
 = footemj
 DESIGNED
 L.H.A.
 REVISED
 A. HOUSEH 10-15-96

 DRAWN
 REVISED
 T. RAMMACHER 01-06-00

 PLOT SCALE
 = 50.0000 ' / in.
 CHECKED
 REVISED
 A. SCHUETZE 07-01-13

 PLOT DATE
 = 3/4/2019
 DATE
 06-89
 REVISED
 A. SCHUETZE 09-15-16

STATE OF ILLINOIS
DEPARTMENT OF TRANSPORTATION

TRAFFIC CONTROL AND PROTECTION FOR SIDE ROADS, INTERSECTIONS, AND DRIVEWAYS

TO STA.


SHEET 1 OF 1 SHEETS STA.

F.A. RTE. SECTION COUNTY TOTAL SHEETS NO.

20-00008-00-RS MCHENRY 26 22

TC-10 CONTRACT NO.61H53


ILLINOIS FED. AID PROJECT \$49M(198)

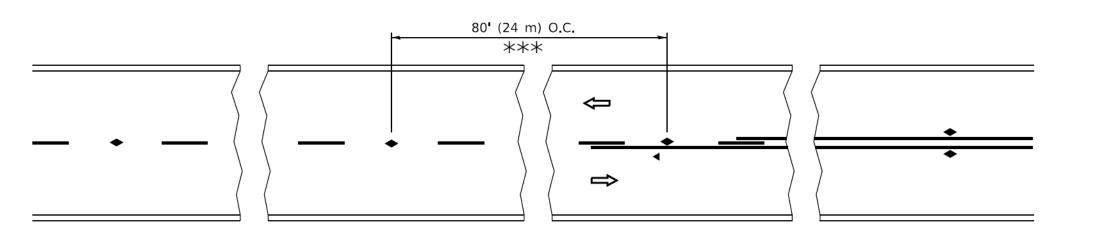

*** REDUCE TO 40' (12 m) O.C. ON CURVES WITH POSTED OR ADVISORY SPEED 45 M.P.H. (70 km/h) OR LESS.

LANE REDUCTION TRANSITION

SEE FIGURE 3B-14 MUTCD

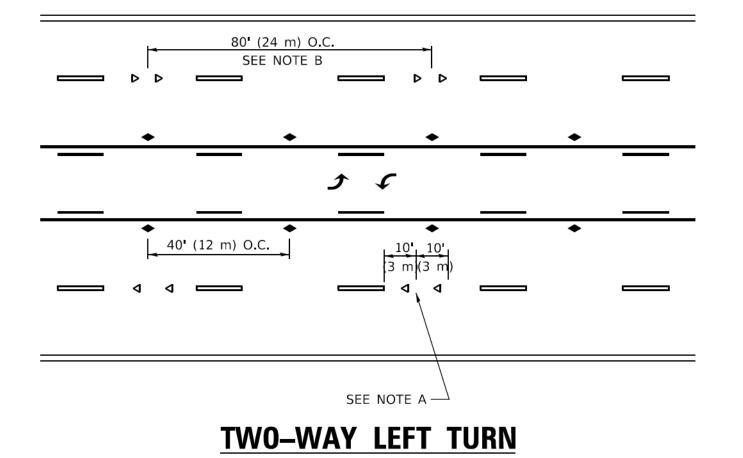

SYMBOLS

■ ONE-WAY AMBER MARKER


◆ TWO-WAY AMBER MARKER

◆ ONE-WAY CRYSTAL MARKER (W/O)


YELLOW STRIPE

WHITE STRIPE

TWO-LANE/TWO-WAY

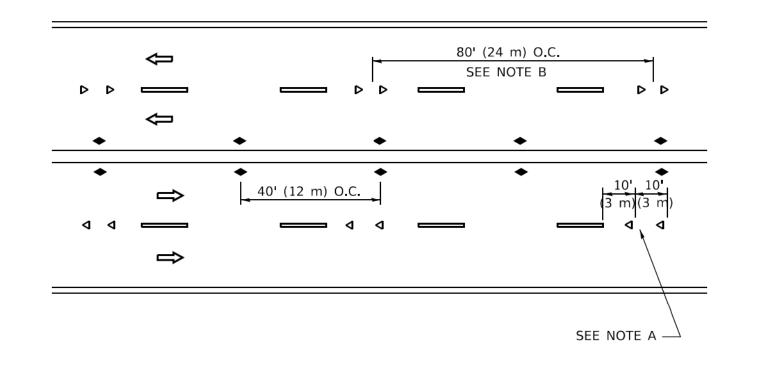



MULTI-LANE/UNDIVIDED

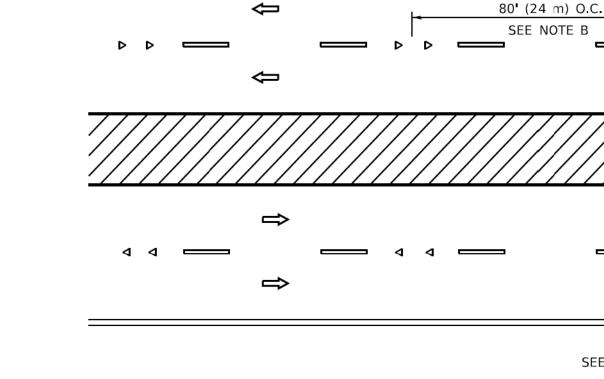

MULTI-LANE/DIVIDED

SEE NOTE A

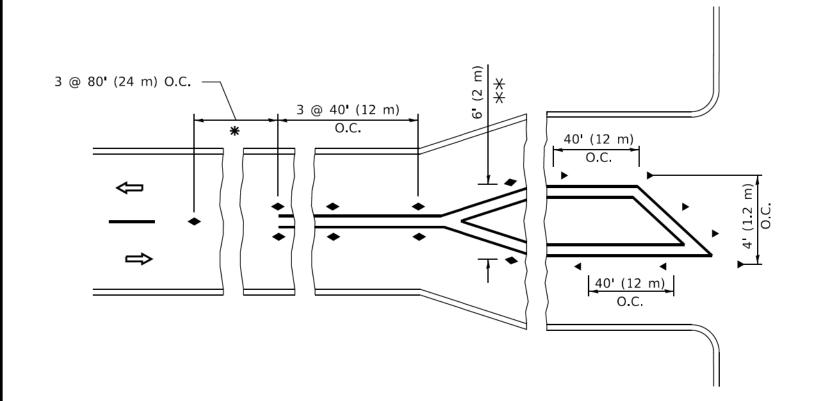

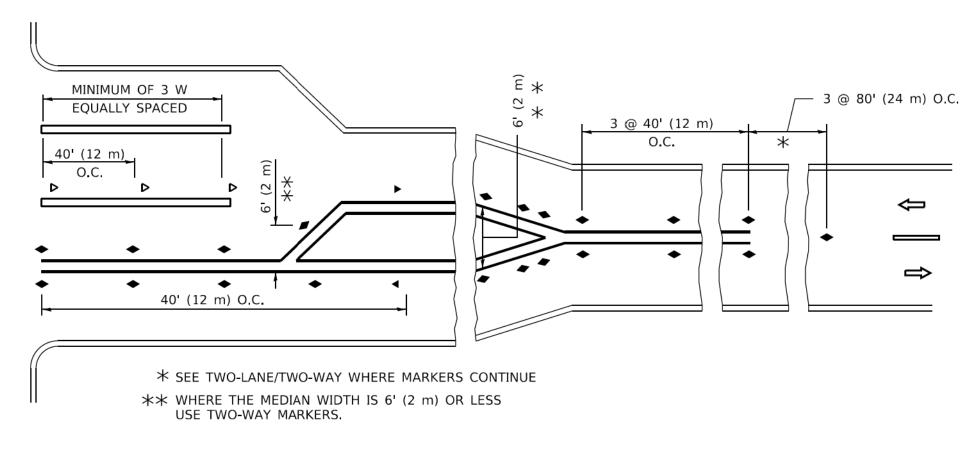

TURN LANES

GENERAL NOTES

- 1. MARKERS USED WITH DASHED LINES SHALL BE CENTERED IN THE GAP BETWEEN SEGMENTS.
- 2. MARKERS USED ADJACENT TO SOLID LINES SHALL BE OFFSET 2 TO 3 (50 TO 75) TOWARD TRAFFIC AS SHOWN.
- 3. MARKERS THROUGH TANGENTS LESS THAN 500' (150 m) IN LENGTH BETWEEN CURVES SHALL BE INSTALLED AT THE LESSER OF THE TWO CURVE SPACINGS.
- 4. MARKERS ARE TO BE USED ADJACENT TO BOTH SOLID WHITE LINES IN DUAL LEFT TURN LANES

LANE MARKER NOTES


- A. USE DOUBLE LANE LINE MARKERS SPACED AS SHOWN.
- B. REDUCE TO 40' (12 m) O.C. ON CURVES WHERE ADVISORY SPEEDS ARE 10 M.P.H (20 km/h) LOWER THAN POSTED SPEEDS.

DESIGN NOTES

- 1. DOUBLE LANE LINE MARKERS SHALL BE USED UNLESS SPECIFIED OTHERWISE.
- 2. EXCEPT AS SHOWN ON THE LANE REDUCTION TRANSITION AND FREEWAY EXIT RAMP DETAIL, MARKERS ARE NOT TO BE SPECIFIED ON RIGHT EDGE LINES.
- THE EXACT MARKER LIMITS, SPACING, AND COLOR SHALL BE INCLUDED IN THE PLANS WHEN STANDARD SPECIFICATIONS ARE NOT BEING USED.
- MARKERS SHOULD NOT BE USED ALONGSIDE CURBS EXCEPT FOR EXTREMELY SHORT SECTIONS OF CURBS WHERE NOT MORE THAN TWO MARKERS WOULD BE INVOLVED.

All dimensions are in inches (millimeters) unless otherwise shown.

	USER NAME = footemj	DESIGNED -	REVISED - T. RAMMACHER 03-12-99		TYPICAL APPLICATIONS		RTF S	ECTION	COUNTY S	HEETS	0
		DRAWN -	REVISED -T. RAMMACHER 01-06-00	STATE OF ILLINOIS		A/ DI ONA/ DEGLOTANT	20-000	008-00-RS N	MCHENRY	26 2	3 3
	PLOT SCALE = 50.0000 ' / in.	CHECKED -	REVISED - C. JUCIUS 09-09-09	DEPARTMENT OF TRANSPORTATION	RAISED REFLECTIVE PAVEMENT MARKERS (SNOW	N-PLUW RESISTANT)	TC-1	1 (CONTRACT N	10.61H53	
PLOT DATE = 3/4/2019 DATE		DATE -	REVISED - C. JUCIUS 07-01-13		SCALE: NONE SHEET 1 OF 1 SHEETS STA.	TO STA.		ILLINOIS FED. AID PI	ROJECT S49M((198)	

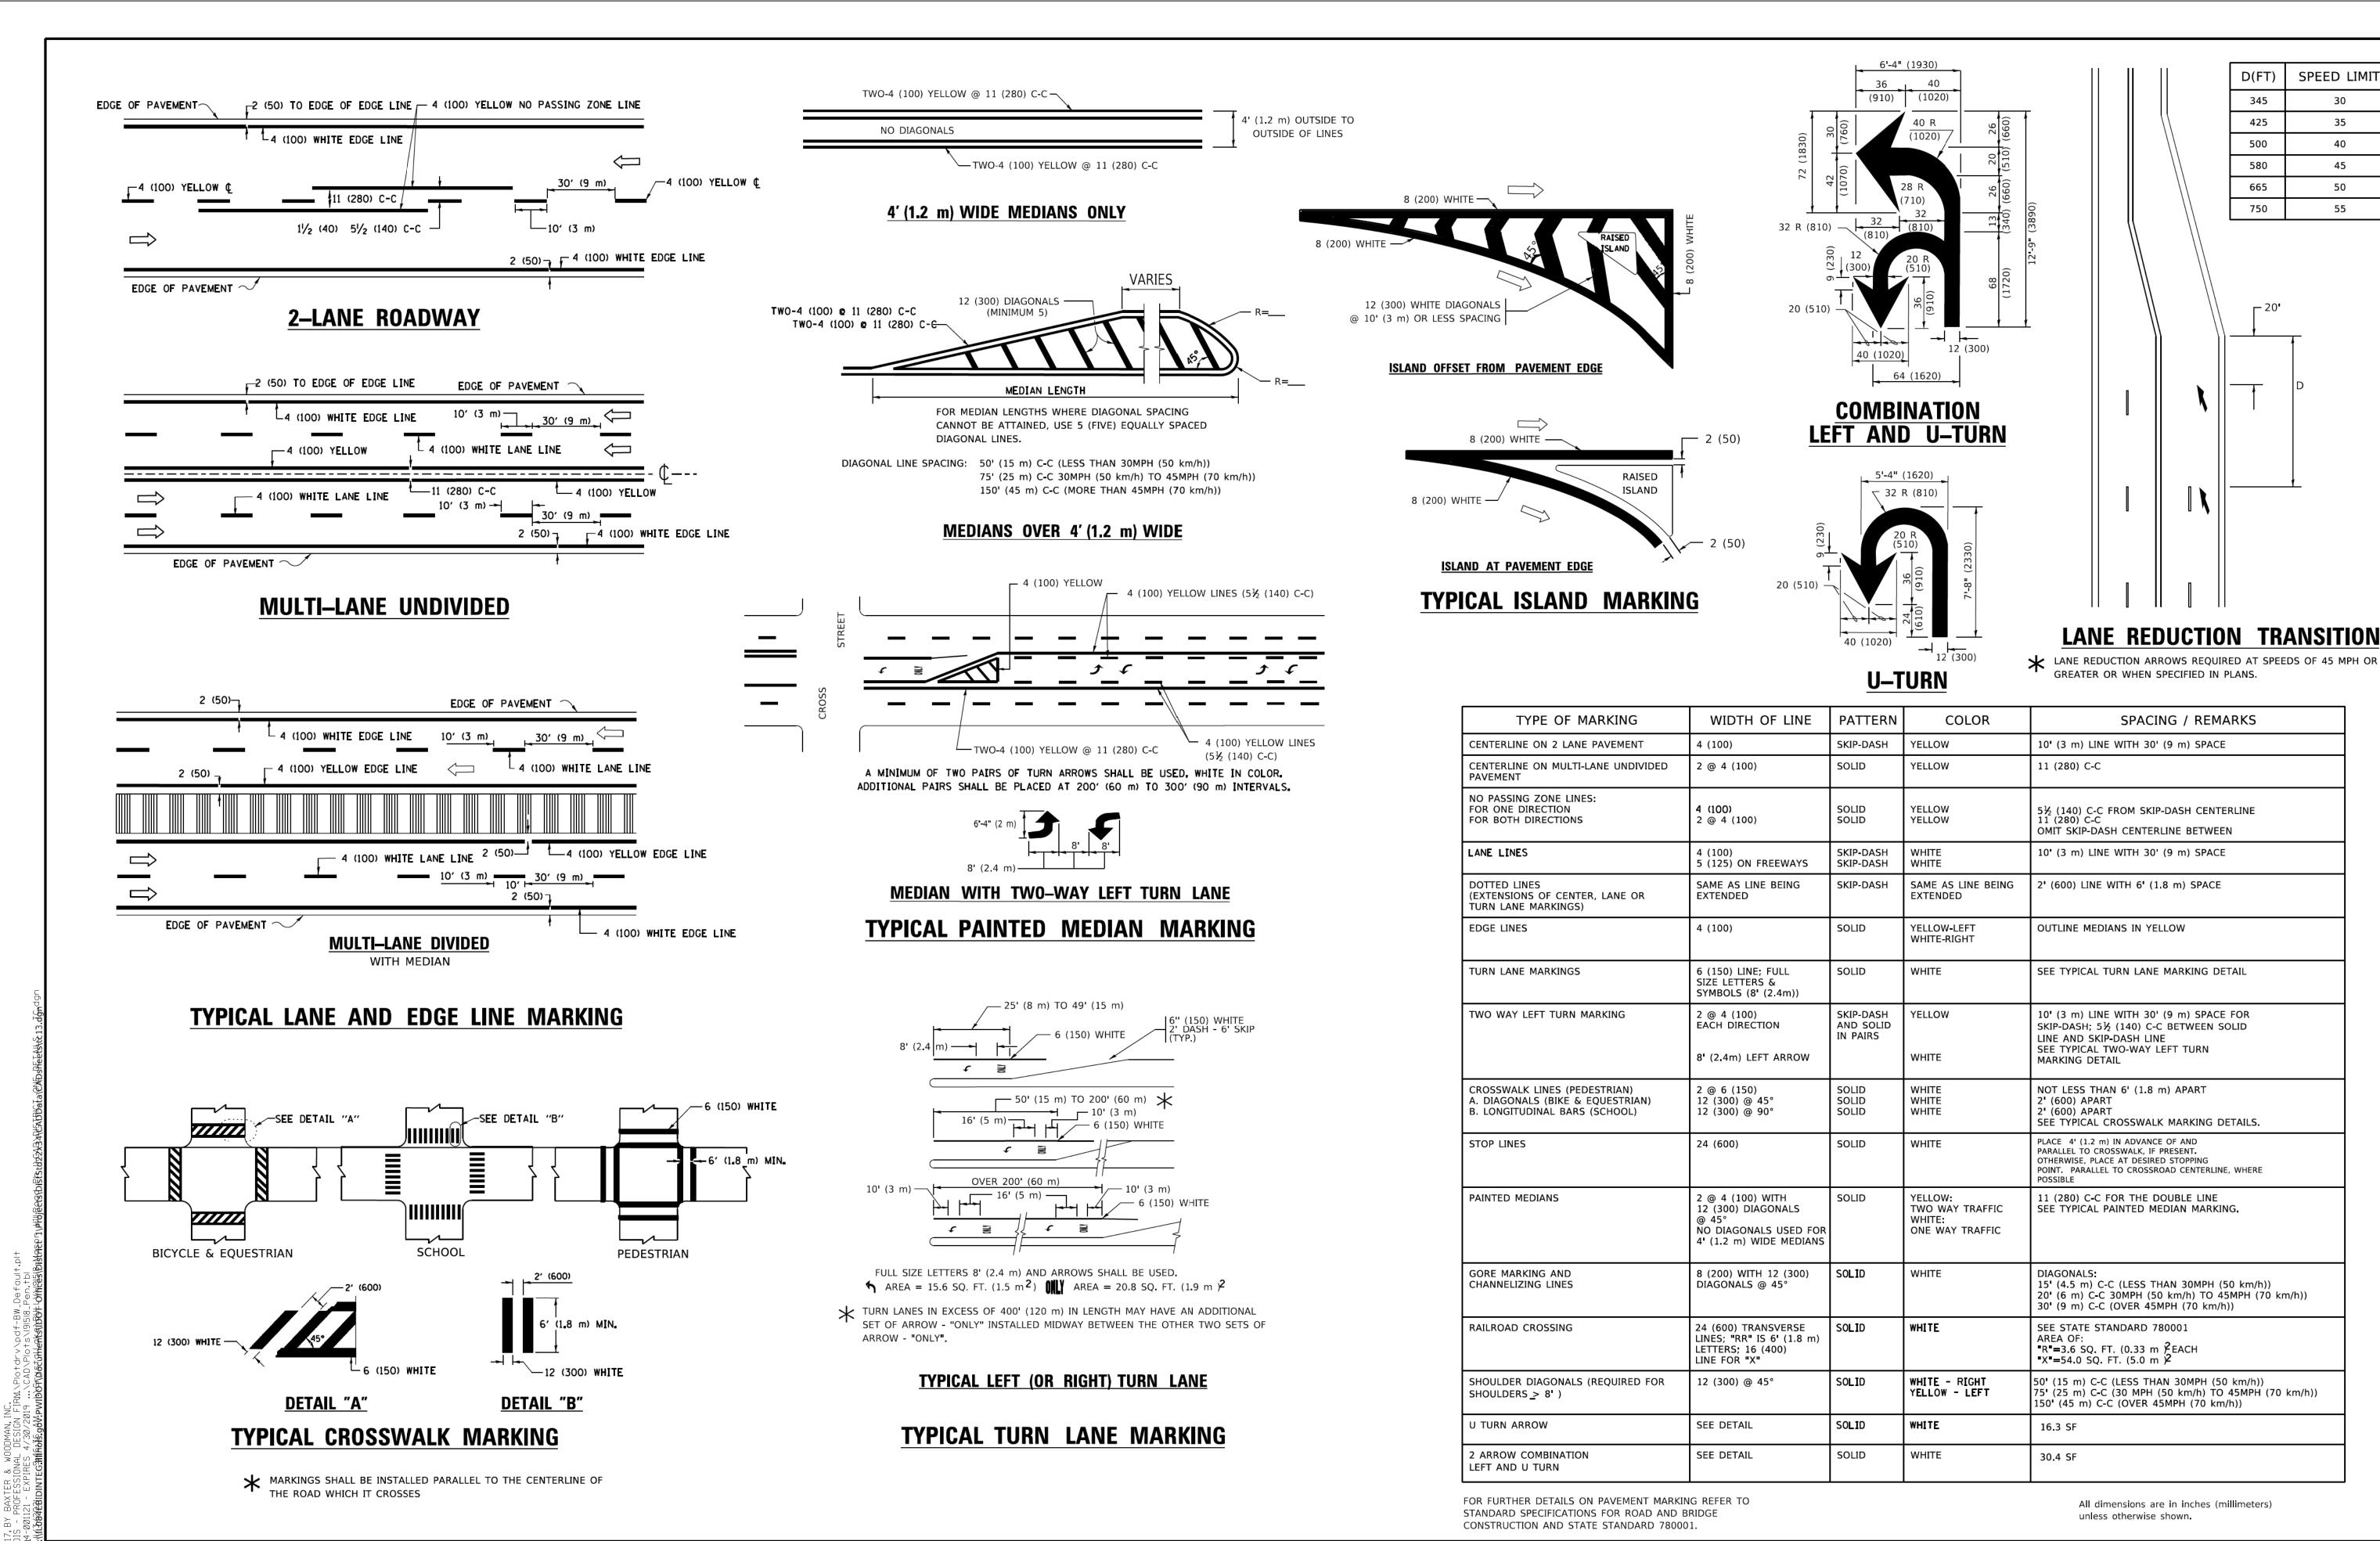

STATE OF ILLINOIS


SCALE: NONE

OTAL SHEE HEETS NO. **SECTION** COUNTY DISTRICT ONE 20-00008-00-RS MCHENRY 26 24 TYPICAL PAVEMENT MARKINGS TC-13 CONTRACT NO.61H53 OF 1 SHEETS STA. TO STA. ILLINOIS FED. AID PROJECT \$49M(198)

USER NAME = footemj DESIGNED -**EVERS** REVISED C. JUCIUS 09-09-09 DRAWN C. JUCIUS 07-01-13 PLOT SCALE = 50.0000 ' / in. CHECKED . REVISED - C. JUCIUS 12-21-15 DATE - 03-19-90 REVISED - C. JUCIUS 04-12-16 PLOT DATE = 3/4/2019

DEPARTMENT OF TRANSPORTATION

TURN BAY ENTRANCE AT START OF LANE CLOSURE TAPER

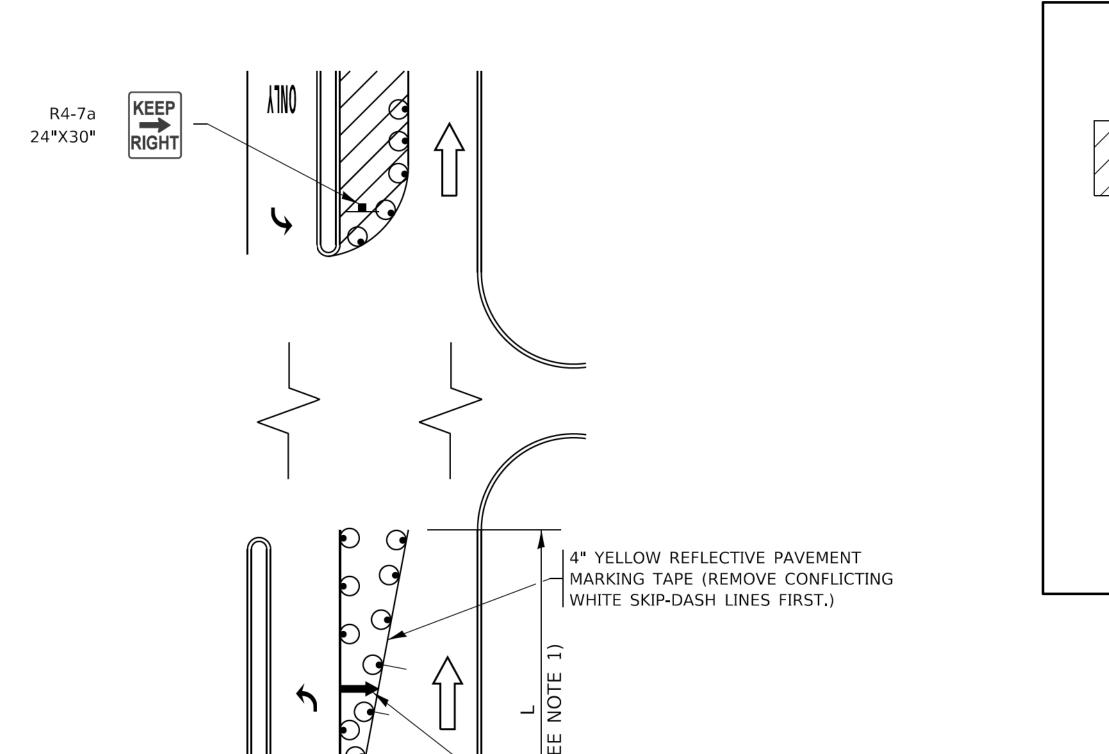


— ARROW BOARD

LEGEND LANE OPEN TO TRAFFIC ARROW BOARD TYPE I OR II BARRICADE OR DRUM WITH STEADY BURN LIGHT DRUM WITH STEADY BURN LIGHT SIGN ASSEMBLY TYPE I OR II CHECK BARRICADE WITH FLASHING LIGHT

NOTES:

- 1. A) WHEN "L" IS ≤ THE STORAGE LENGTH OF THE TURN LANE (AS SHOWN IN FIG. 1), USE FIGURE 1.
 - B) WHEN "L" IS > THE STORAGE LENGTH OF THE TURN LANE OR THE TURN LANE IS WITHIN THE LANE CLOSURE, USE FIGURE 2.
- 2. CONES MAY BE SUBSTITUTED FOR BARRICADES OR DRUMS AT HALF THE SPACING DURING DAY OPERATIONS. CONES SHALL BE A MINIMUM OF 28 (710) IN HEIGHT.
- 3. LIGHTS WILL NOT BE REQUIRED ON BARRICADES OR DRUMS FOR DAY OPERATIONS. ALL LIGHTS SHALL BE MONODIRECTIONAL.
- 4. REFLECTIVE TEMPORARY PAVEMENT MARKINGS SHALL BE PLACED THROUGHOUT THE BARRICADED AREAS OF EACH TURN BAY AS SHOWN WHERE THE CLOSURE TIME IS GREATER THAN FOURTEEN (14) DAYS.
- 5. THIS APPLICATION ALSO APPLIES WHEN WORK IS BEING PERFORMED IN THE RIGHT LANE(S) AND THE RIGHT TURN BAY IS TO REMAIN OPEN. UNDER THIS CONDITION, "RIGHT TURN LANE" R3-I100R 24 x 24 (600 x 600) AND M6-2R 21 x 15 (530 x 380) SHALL BE USED.
- 6. THESE CONTROLS SHALL SUPPLEMENT MAINLINE TRAFFIC CONTROL FOR LANE CLOSURES.
- 7. THE SIGNS SHALL BE MOUNTED ABOVE THE BARRICADES/DRUMS ON SEPARATE SIGN SUPPORTS THAT MEET NCHRP 350 OR MASH PREQUIREMENTS.
- 8. TRAFFIC CONTROL AND PROTECTION AT TURN BAYS (TO REMAIN OPEN TO TRAFFIC) SHALL BE INCLUDED IN THE COST OF SPECIFIED TRAFFIC CONTROL STANDARDS OR ITEMS.

TURN BAY ENTRANCE WITHIN A LANE CLOSURE

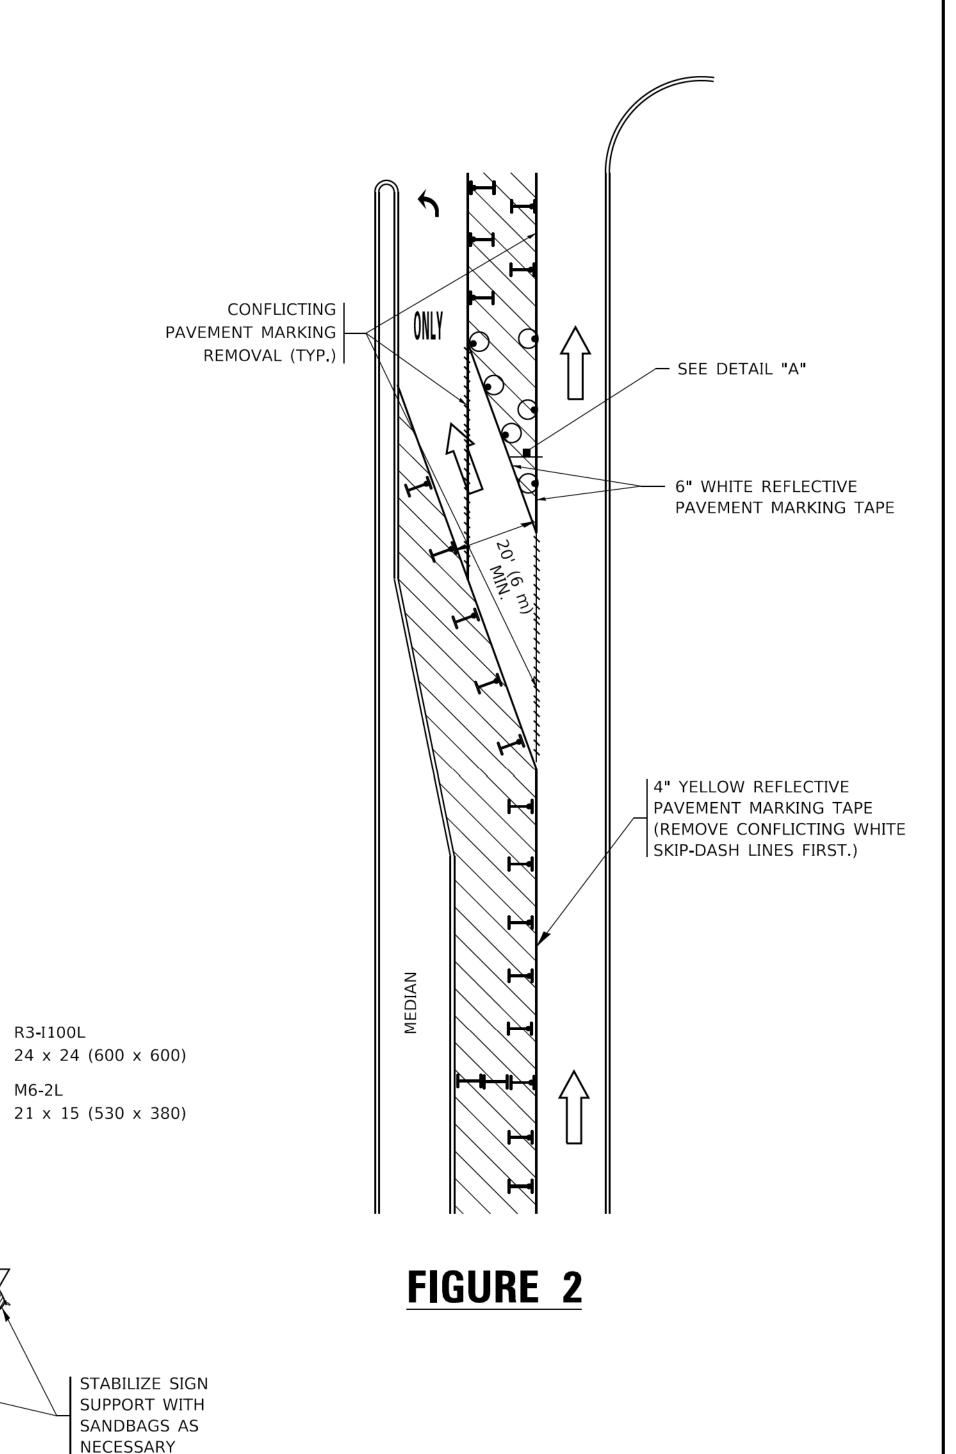

DETAIL A

SCALE: NONE

M6-2L

All dimensions are in inches (millimeters) unless otherwise shown.


USER NAME = footemj	DESIGNED	- T.	RAMMACHER 09	9-08-94	REVISED	-	R. BORO 09-14-09
	DRAWN	-	A. HOUSEH 1	1-07-95	REVISED	- A.	SCHUETZE 07-01-13
PLOT SCALE = 50.0000 ' / in.	CHECKED	-	A. HOUSEH 10	0-12-96	REVISED	- A.	SCHUETZE 09-15-16
PLOT DATE $= 3/4/2019$	DATE	- T.	RAMMACHER O	1-06-00	REVISED	-	

FIGURE 1

STATE OF ILLINOIS **DEPARTMENT OF TRANSPORTATION**

TRAFFIC CONTROL AND PROTECTION AT TURN BAYS (TO REMAIN OPEN TO TRAFFIC)					F.A. RTE.	SECTION	COUNTY	TOTAL SHEETS	SHEET NO.			
						20-00008-00-RS	MCHENRY	26	26			
(10 HEWAIN OF EN 10 HIATTIC)						TC-14 CONTRACT NO.61						
ONE	SHEET 1	OF 1	SHEETS	STA.	TO STA.	LILINOIS LEED AID PROJECT \$49M(198)						

SEE DETAIL "A" —

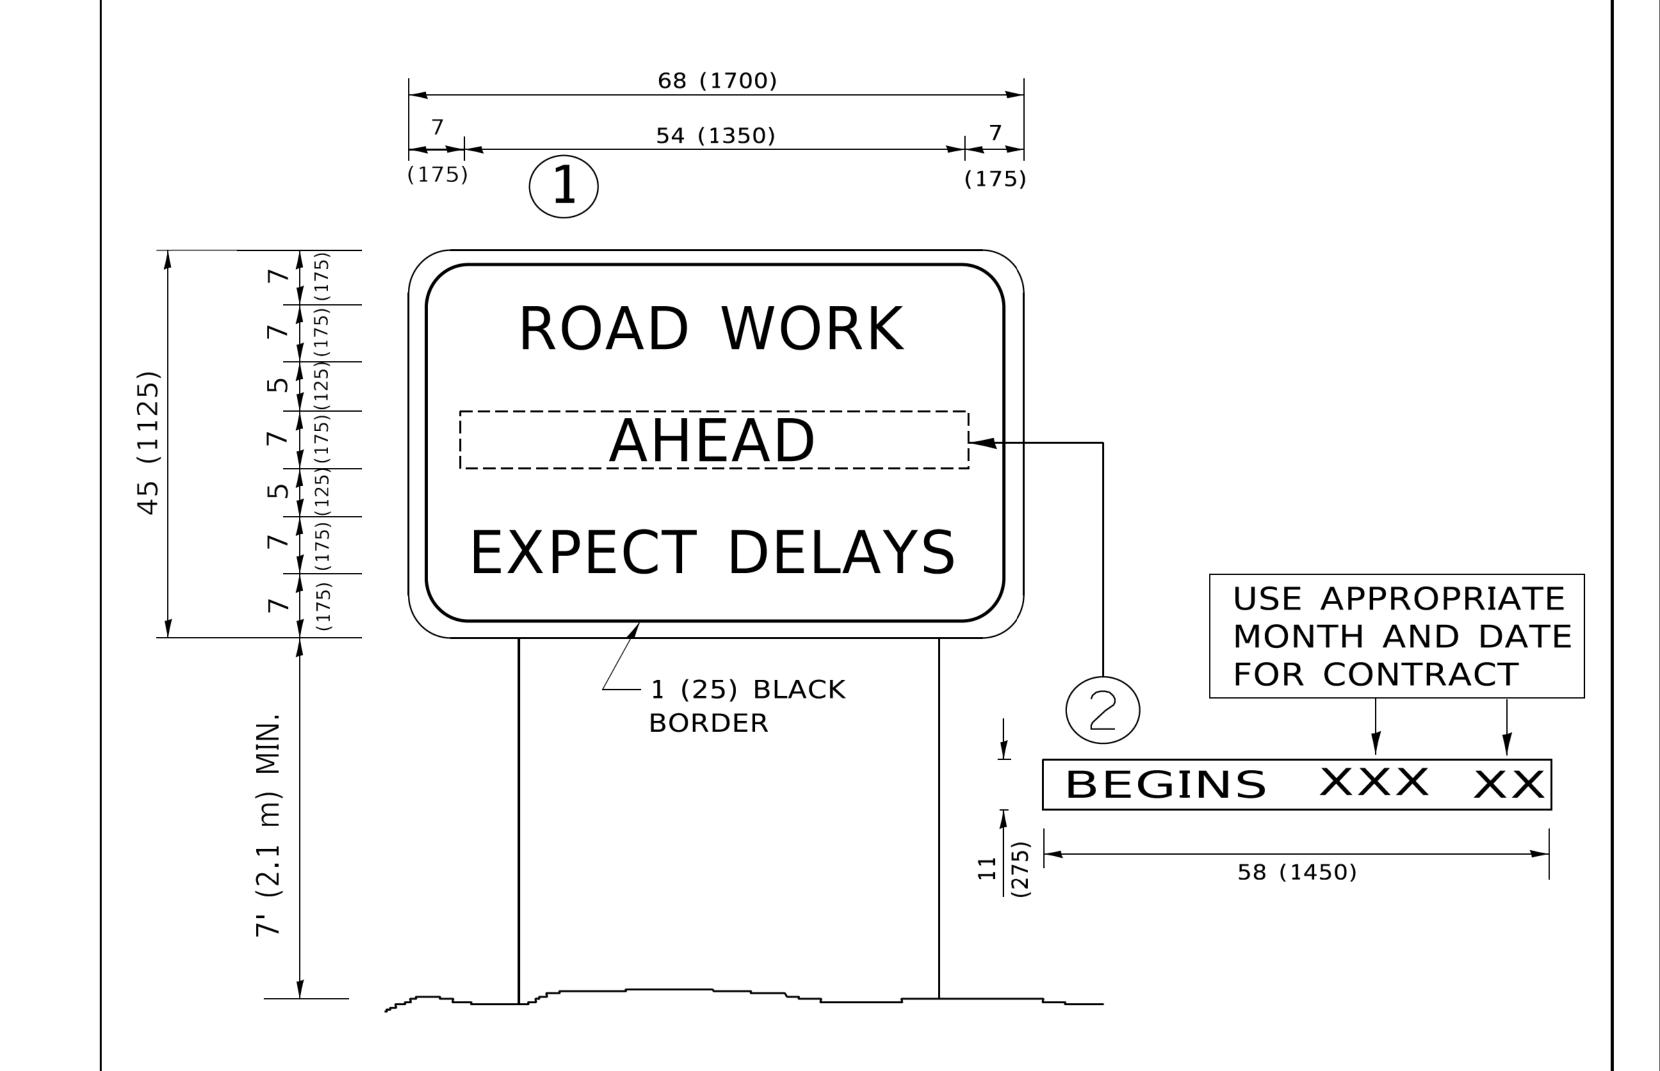

NOTES:

- 1. USE BLACK LETTERING ON ORANGE BACKGROUND.
- 2. ERECT SIGNS IN ADVANCE OF THE LOCATION FOR THE "ROAD CONSTRUCTION AHEAD" SIGN AT LOCATIONS AS DIRECTED BY THE ENGINEER.
- 3. ERECT SIGN 1 WITH INSTALLED PANEL 2 ONE WEEK PRIOR TO THE START OF CONSTRUCTION.
- 4. REMOVE PANEL 2 SOON AFTER THE START OF CONSTRUCTION.
- 5. SEE SPECIAL PROVISION FOR "TEMPORARY INFORMATION SIGNING" FOR ADDITIONAL INFORMATION.
- 6. ONE SIGN ASSEMBLY EQUALS 25.70 SQ. FT. (2.3 SQ. M.)
- 7. SHALL BE PAID FOR AS TEMPORARY INFORMATION SIGNING.

ALL DIMENSIONS ARE IN INCHES (MILLIMETERS)
UNLESS OTHERWISE SHOWN.

USER NAME = footemj	DESIGNED -	REVISED - R. MIRS 09-15-97				ARTERIAL RO	ΊΔΠ		RTF	SECTION	COUNTY	SHEETS NO	
	DRAWN -	REVISED - R. MIRS 12-11-97	STATE OF ILLINOIS						1112.	20-00008-00-RS	MCHENRY	26 25	· —
PLOT SCALE = 50.0000 ' / in.	CHECKED -	REVISED -T. RAMMACHER 02-02-99	DEPARTMENT OF TRANSPORTATION		INF	FORMATION	SIGN			TC-22	CONTRACT	NO.61H53	
PLOT DATE = 3/4/2019	DATE -	REVISED - C. JUCIUS 01-31-07		SCALE: NONE	SHEET 1 OF	1 SHEETS	STA.	TO STA.		ILLINOIS FED.	AID PROJECT S49	∂M(198)	