

SEC. 9, T. 19 N, R. 10 E.

SEC. 10, T. 19 N, R. 10 E.

SEC. 16, T. 19 N, R. 10 E.

SEC. 15, T. 19 N, R. 10 E.

EXIST. CURVE CURV31  
 PI STA. = 353+75.10  
 $\Delta = 3^\circ 12' 05''$  (RT)  
 $D = 0^\circ 38' 12''$   
 $R = 9,000.09'$   
 $T = 251.50'$   
 $L = 502.87'$   
 $E = 3.51'$   
 T.R. =  
 S.E. RUN =  
 P.C. STA. = 351+23.59  
 P.T. STA. = 356+26.47

EXISTING R.O.W.

EXISTING R.O.W.


HMA SHOULDERS, 6"

INCIDENTAL HMA SURFACING

AGG SHOULDERS-TYPE B, 6"

PLAN  
 DATE  
 BY  
 CHECKED  
 DATE  
 BY  
 NO. OF SHEETS  
 NO. OF THIS SHEET  
 NOTE BOOK NO.  
 DATE  
 NAME  
 NO.

PROFILE  
 DATE  
 BY  
 CHECKED  
 DATE  
 BY  
 NO. OF SHEETS  
 NO. OF THIS SHEET  
 NOTE BOOK NO.  
 DATE  
 NAME  
 NO.

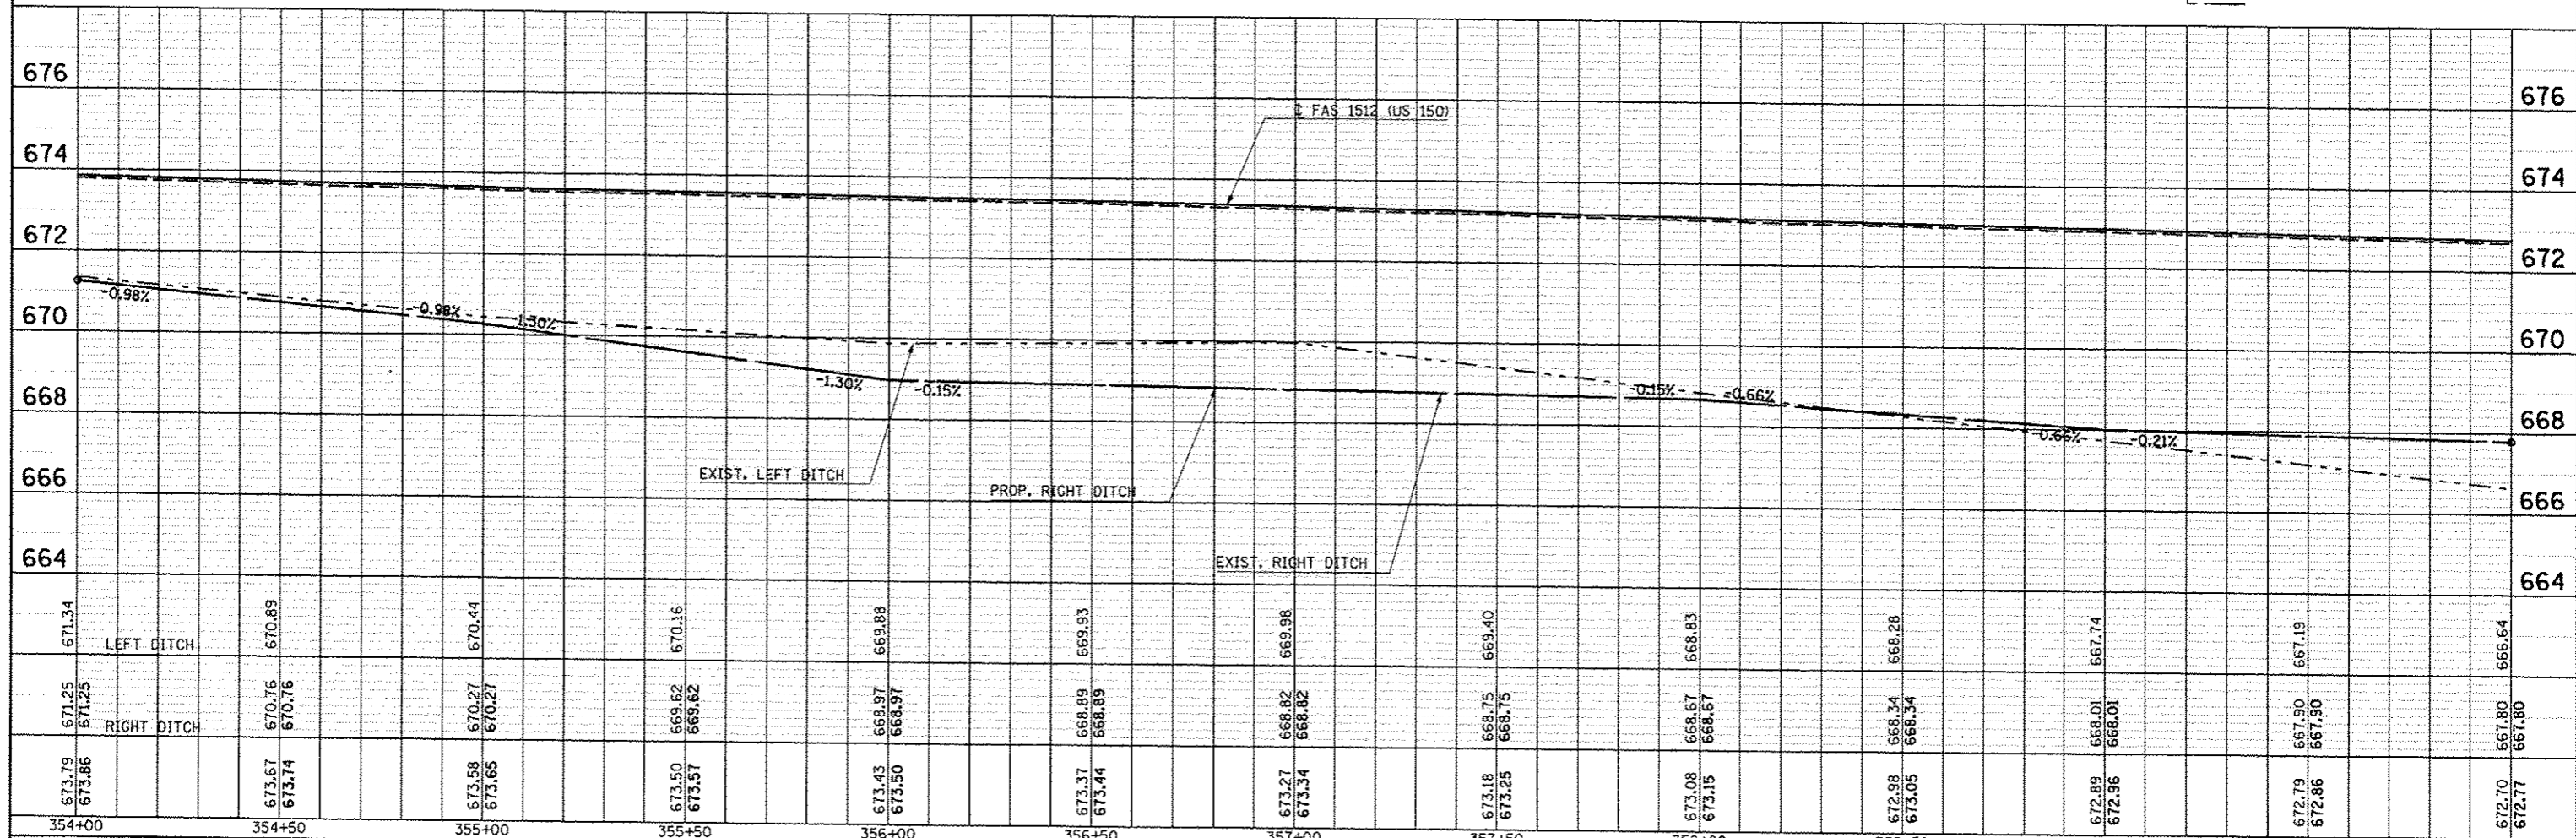

354+00	354+50	355+00	355+50	356+00	356+50	357+00	357+50	358+00	358+50	359+00	359+50	360+00
673.79 673.86	673.67 673.74	673.58 673.65	673.50 673.57	673.43 673.50	673.37 673.44	673.27 673.34	673.18 673.25	673.08 673.15	672.98 673.05	672.89 672.96	672.79 672.86	672.70 672.77
671.25 671.25	670.76 670.76	670.27 670.27	669.62 669.62	668.97 668.97	668.89 668.89	668.82 668.82	668.75 668.75	668.67 668.67	668.34 668.34	668.01 668.01	667.90 667.90	667.80 667.80
671.34 LEFT DITCH	670.89	670.44	670.16	669.88	669.93	669.98	669.40	668.83	668.28	667.74	667.19	666.64

STATE OF ILLINOIS  
 DEPARTMENT OF TRANSPORTATION

US 150 MAINLINE  
 PLAN AND PROFILE SHEET

F.A.U. RTE. SECTION COUNTY TOTAL SHEETS SHEET NO.  
 (2X,3)RS-3 & 2RS-4 Champaign 551 125  
 F.A.U. 7152 & F.A.S. 1512 CONTRACT NO. 70663  
 ILLINOIS FED. AID PROJECT

SCALE: 1" = 20' SHEET NO. 44 OF 54 SHEETS STA. 354+00.00 TO STA. 360+00.00

FILE NAME: USER NAME: cearlockjd  
 603-sht-plnpr.f.dgn  
 PLOT SCALE: 48.0000 / in.  
 PLOT DATE: 10/18/2013  
 DESIGNED: JMS  
 DRAWN: JMS  
 CHECKED:  
 DATE: 081610

REVISIONS  
 REVISION NO. DATE BY  
 1 081610 JMS