03-04-2016 LETTING ITEM 118

STATE OF ILLINOIS

DEPARTMENT OF TRANSPORTATION

DIVISION OF HIGHWAYS

FOR INDEX OF SHEETS, SEE SHEET NO. 2 FOR HIGHWAY STANDARDS, SEE SHEET NO. 2

PLANS FOR PROPOSED FEDERAL AID HIGHWAY

F.A.U. ROUTE 2996 (HIGH RIDGE ROAD)

VILLA PARK CORP. LIMITS TO

ARDMORE AVE. RESURFACING

SECTION 15-00095-00-RS

PROJECT NO. M-4003(578)

VILLAGE OF VILLA PARK


DuPAGE COUNTY

JOB NO. C-91-033-16

TRAFFIC DATA

2010 ADT: 3,418

POSTED SPEED LIMIT: 30 MPH (20 MPH WHEN CHILDREN PRESENT)
FUNCTIONAL CLASSIFICATION: MAJOR COLLECTOR

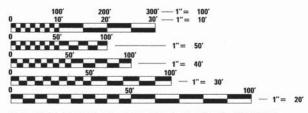

FULL SIZE PLANS HAVE BEEN PREPARED USING STANDARD ENGINEERING SCALES. REDUCED SIZED PLANS WILL NOT CONFORM TO STANDARD SCALES. IN MAKING MEASUREMENTS ON REDUCED PLANS, THE ABOVE SCALES MAY BE USED.

J.U.L.I.I

JOINT UTILITY LOCATION INFORMATION FOR EXCAVATION 1-800-892-0123
OR 811

PROJECT ENGINEER: WILLIAM M. ELDRINGHOFF, P.E. PROJECT MANAGER: RONALD O. NORDMEYER, P.E.

LOCATION MAP

GROSS AND NET LENGTH = 2,369.66 FT. = 0.449 MILES

369.66 FT. = 0.449 MILES



JO DAVIESS STEPHENSON WINNEBACO BOONE MC HENRY LAKE

CARROLL


OGLE

NENDALL

15-00095-00-RS

DuPAGE 12 1

CONTRACT NO. 61C42

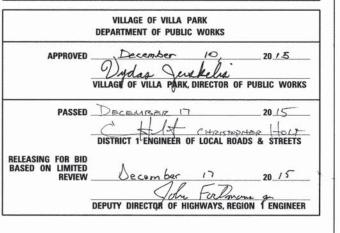

PRINTED BY THE AUTHORITY OF THE STATE OF ILLINOIS



LOCATION OF SECTION INDICATED THUS: -

DESIGN FIRM REGISTRATION No. 184-000450 118 SOUTH CLINTON STREET SUITE 600 CHICAGO, IL 60661 PHONE: 312.648.9900

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CONTRACT NO. 61C42

INDEX OF SHEETS

SHEET NO.	TITLE
1	COVER SHEET
2	INDEX OF SHEET, STANDARDS, GENERAL NOTES, AND COMMITMENTS
3	SUMMARY OF QUANTITIES
4	TYPICAL SECTIONS
5-7	ROADWAY PLAN
8	DETOUR PLAN
9-12	DISTRICT 1 STANDARDS

LIST OF DISTRICT 1 STANDARDS

BD-32	BUTT JOINT AND HMA TAPER DETAILS
TC-10	TRAFFIC CONTROL AND PROTECTION FOR SIDE ROADS, INTERSECTIONS, AND DRIVEWAYS
TC-13	DISTRICT ONE TYPICAL PAVEMENT MARKINGS
TC-16	PAVEMENT MARKING LETTERS AND SYMBOLS FOR TRAFFIC STAGING

LIST OF HIGHWAY STANDARDS

000001-06	STANDARD SYMBOLS, ABBREVIATIONS, AND PATTERNS
424001-08	PERPENDICULAR CURB RAMPS FOR SIDEWALKS
542001-04	CONCRETE END SECTIONS FOR PIPE CULVERTS 15" THRU 84" DIA.
542301-03	PRECAST REINFORCED CONCRETE FLARED END SECTION
542401-01	METAL END SECTION FOR PIPE CULVERTS
606001-06	CONCRETE CURB TYPE B AND COMBINATION CONCRETE CURB AND GUTTER
701006-05	OFF-RD OPERATIONS, 2L, 2W, 15' (4.5m) TO 24" (600 mm) FROM PAVEMENT EDGE
701301-04	LANE CLOSURE, 2L, 2W, SHORT TIME OPERATIONS
701311-03	LANE CLOSURE, 2L, 2W, MOVING OPERATIONS - DAY ONLY
701501-06	URBAN LANE CLOSURE, 2L, 2W, UNDIVIDED
701801-05	SIDEWALK, CORNER OR CROSSWALK CLOSURE
701901-04	TRAFFIC CONTROL DEVICES
780001-05	TYPICAL PAVEMENT MARKINGS

GENERAL NOTES

- 1. ALL CONSTRUCTION SHALL BE DONE IN ACCORDANCE WITH THE DETAILS IN THE PLANS, THE SPECIAL PROVISIONS INCLUDED IN THE CONTRACT DOCUMENTS, AND THE LATEST EDITION OF THE FOLLOWING STATE OF ILLINOIS SPECIFICATIONS: "THE STANDARD SPECIFICATIONS FOR ROAD AND BRIDGE CONSTRUCTION" (REFERRED TO AS THE "STANDARD SPECIFICATIONS"), THE "SUPPLEMENTAL SPECIFICATIONS AND RECURRING SPECIAL PROVISIONS," THE "MANUAL ON UNIFORM TRAFFIC CONTROL DEVICES FOR STREETS AND HIGHWAYS," AND THE "MANUAL OF TEST PROCEDURES FOR MATERIALS."
- 2. THE LOCATIONS OF PUBLIC OF PRIVATE UTILITIES SHOWN ON THE PLANS REPRESENT ONLY THE OPINION OF THE VILLAGE. THEY ARE ONLY INCLUDED FOR THE CONVENIENCE OF THE BIDDER AND THEIR ACCURACY IS NOT GUARANTEED. THE CONTRACTOR SHALL BE RESPONSIBLE FOR THE PROTECTION OF ALL UNDERGROUND OR SURFACE UTILITIES, EVEN THOUGH THEY MAY NOT BE SHOWN ON THE PLANS.
- 3. THE CONTRACTOR SHALL NOTIFY VYDAS JUSKELIS, THE DIRECTOR OF PUBLIC WORKS (630-834-8505), AT LEAST 48 HOURS IN ADVANCE OF BEGINNING WORK TO OBTAIN VILLAGE UTILITY LOCATIONS.
- . ONE (1) SET OF APPROVED PLANS MUST BE ON THE SITE AT ALL TIMES.
- THE CONTRACTOR SHALL CONTACT JEREMIE LUKOWICZ, THE ASSISTANT VILLAGE ENGINEER (630-834-8505), AND THE ENGINEER AT LEAST 48 HOURS PRIOR TO ANY CONCRETE OR HOT-MIX ASPHALT MATERIAL DELIVERIES.
- ACCESS TO PRIVATE DRIVEWAYS SHALL BE PROVIDED AT ALL TIMES EXCEPT DURING ACTUAL CONSTRUCTION
 ADJACENT THERETO.
- ANY EROSION CONTROL MEASURES THAT ARE DEEMED NECESSARY BY THE VILLAGE ENGINEER SHALL BE IMPLEMENTED IMMEDIATELY BY THE CONTRACTOR.
- PDFS OF THE LATEST FULL SIZE PLAN SET AND SPECIAL PROVISIONS WILL BE PROVIDED BY THE VILLAGE ON A CD WHICH WILL BE GIVEN TO THE GENERAL CONTRACTOR AT THE PRE-CONSTRUCTION CONFERENCE FOR THEIR USE. ADDITIONAL PAPER COPIES WILL NOT BE DISTRIBUTED BY THE ENGINEER.
- 3. THE DAY'S PAVING OPERATION SHOULD RESULT IN A SINGLE TRANSVERSE JOINT. ANY COLD LONGITUDINAL JOINTS WILL NOT BE ACCEPTED. PROVIDING A SINGLE TRANSVERSE JOINT SHALL BE ACCOMPLISHED BY PAVING ONE LANE OF SUFFICIENT LENGTH THAT WILL ALLOW FOR THE PAVING OF THE ADJACENT LANE IN THE SAME DAY.
- 10. IN ALL TRENCHES CROSSING DRIVEWAYS, SIDEWALKS, AND ALL PROPOSED AND EXISTING ROADWAYS, THE MATERIALS FOR THE TOP 12 INCHES SHALL BE CA-6 CRUSHED GRAVEL OR CRUSHED STONE AND BE INCLUDED IN THE PAY ITEM FOR TRENCH BACKFILL.
- AGGREGATE SHOULDERS, TYPE B SHALL MEET THE REQUIREMENTS OF ARTICLE 1004.4 OF THE STANDARD SPECIFICATIONS. RECLAIMED ASPHALT PAVEMENT (RAP) SHALL NOT BE ALLOWED AS AN ACCEPTABLE MATERIAL FOR AGGREGATE SHOULDERS, TYPE B.
- 2. THE CONTRACTOR SHALL PROVIDE AN INSTALL TWO (2) WEIGHTED SANDBAGS ON EACH TYPE I OR TYPE II BARRICADE USED. ONE (1) WEIGHTED SANDBAG SHALL BE PLACED ACROSS EACH BOTTOM RAIL.
- 13. ANY GEOTECHNICAL INFORMATION PROVIDED IS FOR INFORMATIONAL PURPOSES ONLY, AND DOES NOT GUARANTEE CONDITIONS WHICH WILL BE ENCOUNTERED IN THE FIELD.
- 14. PROPERTY LINES SHOWN ARE BASED ON VILLA PARK G.I.S. AND ARE APPROXIMATE.
- 15. ALL STATIONING ON THE PROJECT IS APPROXIMATE. ALL WORK LOCATIONS SHALL BE APPROVED BY THE ENGINEER.
- 6. THE CONTRACTOR SHALL MEASURE THE LOCATION OF ALL EXISTING PAVEMENT MARKINGS PRIOR TO REMOVAL. THE CONTRACTOR SHALL REPLACE THE PAVEMENT MARKING AS SHOWN ON THE PLANS.
- 17. THE R.O.W SHOWN IS FROM THE VILLA PARK GIS.
- 18. THE CONTRACTOR SHALL VERIFY AND MARK THE LOCATION OF ALL UTILITIES WITHIN THE CONSTRUCTION LIMITS AND IDENTIFY ANY UTILITY CONFLICTS PRIOR TO THE START OF CONSTRUCTION.
- 19. THE CONTRACTOR SHALL BE RESPONSIBLE FOR PROTECTING UTILITY PROPERTY FROM CONSTRUCTION OPERATIONS AS OUTLINED IN ARTICLE 107.31 OF THE STANDARD SPECIFICATIONS. THE JULLILE PHONE NUMBER IS: 800-892-0123. A MINIMUM OF 48 HOURS ADVANCE NOTICE IS REQUIRED.

COMMITMENTS

. NONE.

FILE NAME =	USER NAME = User:BEldringhoff	DESIGNED -	REVISED -	
P:\V0040170_Villa Park - High Ridge Rd	FO PH II\Plans\Sheets\Index General Notes.dg	nDRAWN -	REVISED -	
	PLOT SCALE = 1.0000 ' / in.	CHECKED -	REVISED -	
Default	PLOT DATE = 12/11/2015	DATE -	REVISED -	

SUMMARY OF QUANTITIES


	CODE NO.	ITEM	UNIT	TOTAL	ROADWAY STU FUNDS 75% FEDERAL 25% LOCAL 0005
	20200100	EARTH EXCAVATION	CU YD	407	407
	20800150	TRENCH BACKFILL	CU YD	30	30
	25000110	SEEDING, CLASS 1A	ACRE	0.25	0.25
	35200500	AGGREGATE BASE (OURSE, TYPE B) CEMENT	100 WT	350 3.670	3.670
	40201000	AGGREGATE FOR TEMPORARY ACCESS	TON	44	44
Δ	40600275	BITUMINOUS MATERIALS (PRIME COAT)	POUND	3,030	3,030
	40600827	POLYMERIZED LEVELING BINDER (MACHINE METHOD), IL-4.75, N50	TON	367	367
	40600982	HOT-MIX ASPHALT SURFACE REMOVAL - BUTT JOINT	SQ YD	184	184
	40603335	HOT-MIX ASPHALT SURFACE COURSE, MIX "D", N50	TON	763	763
	42400100	PORTLAND CEMENT CONCRETE SIDEWALK 4 INCH	SO FT	390	390
	42400800	DETECTABLE WARNINGS	SQ FT	48	48
	44000100	PAVEMENT REMOVAL	SO YD	58	58
	44000300	CURB REMOVAL	FOOT	20	20
	44000600	SIDEWALK REMOVAL	SQ FT	390	390
	48101500	AGGREGATE SHOULDERS, TYPE B 6"	SQ YD	1220	1220
	50105220	PIPE CULVERT REMOVAL	FOOT	340	340
	54213447	END SECTIONS 12"	EACH	2	2
	54213453	END SECTIONS 18"	EACH	8	8
	54213471	END SECTIONS 36"	EACH	4	4
	542D0217	PIPE CULVERTS, CLASS D, TYPE 1 12"	FOOT	30	30
	542D0223	PIPE CULVERTS, CLASS D, TYPE 1 18"	FOOT	184	184
	542D0241	PIPE CULVERTS, CLASS D, TYPE 1 36"	FOOT	125	125
	60600605	CONCRETE CURB, TYPE B	FOOT	20	20
	67100100	MOBILIZATION	LSUM	1	1
*	78000100	THERMOPLASTIC PAVEMENT MARKING - LETTERS AND SYMBOLS	SQ FT	78	78
*	78000200	THERMOPLASTIC PAVEMENT MARKING - LINE 4"	FOOT	594	594
*	78000650	THERMOPLASTIC PAVEMENT MARKING - LINE 24"	FOOT	94	94
Δ	X2020110	GRADING AND SHAPING SHOULDERS	UNIT	37	37
Δ	X7010216	TRAFFIC CONTROL AND PROTECTION (SPECIAL)	LSUM	1	1
Δ	XX009077	FULL-DEPTH RECLAMATION WITH CEMENT	SQ YD	6,660	6,660

LEGEND


 Δ = SPECIAL PROVISION

* = SPECIALITY ITEMS

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P:\V0040170_Villa Park - High Ridge Rd L	FO PH II\Plans\Sheets\Summary Of Qua	ntities d@RAWN -	REVISED -	STATE OF ILLINOIS			HIGH R	RIDGE ROAD		F.A.U. RTE.	SECTION	COUNTY	TOTAL	SHEET
	PLOT SCALE = 1.0000 ' / in.	CHECKED -	REVISED -	DEPARTMENT OF TRANSPORTATION		S		OF QUANTITIES		2996	15-00095-00-RS	DuPAGE	12	3
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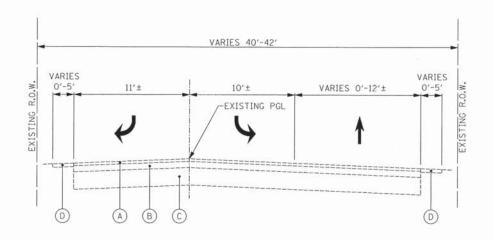


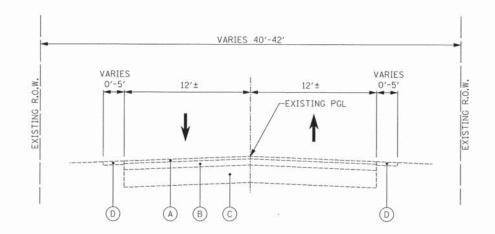EXISTING TYPICAL SECTION
HIGH RIDGE ROAD
STA. 26+09.81 TO 46+35.00

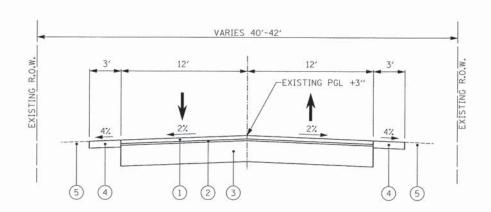


PROPOSED TYPICAL SECTION
HIGH RIDGE ROAD
STA. 26+09.81 TO 46+35.00

NOTE:
THE EXISTING PAVEMENT MATERIALS AND THICKNESSES WERE OBTAINED FROM PAVEMENT CORES. THIS REPRESENTS THE BEST AVAILABLE EXISTING PAVEMENT INFORMATION. NO ADDITIONAL COMPENSATION WILL BE ALLOWED FOR PAY ITEMS RELATED TO EXISTING PAVEMENT DUE TO VARIATIONS IN EXISTING PAVMENT MATERIALS OR THICKNESS.



EXISTING TYPICAL SECTION
HIGH RIDGE ROAD
STA. 46+35.00 TO 49+79.47

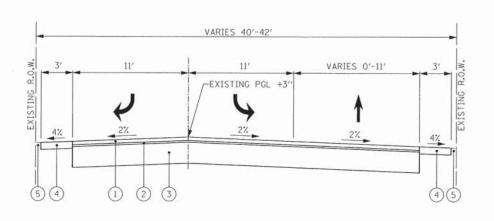

PROPOSED TYPICAL SECTION
HIGH RIDGE ROAD
STA. 46+35.00 TO 49+79.47

SCALE: N.T.S

EXISTING LEGEND

- (A) HOT-MIX ASPHALT SURFACE COURSE VARIES 1"-2"
- B) HOT-MIX ASPHALT BINDER COURSE VARIES 2"-6"
- C CRUSHED LIMESTONE BASE VARIES 6"-14"
- (D) AGGREGATE SHOULDER VARIES

PROPOSED LEGEND

- 1) HOT-MIX ASPHALT SURFACE COURSE, MIX "D", N50, 2"
- POLYMERIZED LEVELING BINDER (MACHINE METHOD), IL-19.0, N50, 1"
- 3 FULL-DEPTH RECLAMATION, 12"
- 4 AGGREGATE SHOULDERS, TYPE B 6"
- (5) SEEDING, CLASS 1A

HOT-MIX ASPHALT MIXTURE REQUIR	EMENTS
MIXTURE TYPE	AIR VOIDS
ROADWAY	
HOT-MIX ASPHALT SURFACE COURSE, MIX, "D", N50	4.0% @ 50 Gyr.
POLYMERIZED LEVELING BINDER (MACHINE METHOD), IL-4.75, N50	3.5% @ 50 Gyr.


THE UNIT WEIGHT USED TO CALCULATE ALL HMA SURFACE MIXTURE QUANTITIES IS


THE "AC TYPE" FOR POLYMERIZED HMA MIXES SHALL BE "SBS/SBR PG 76-22" AND FOR NON-POLYMERIZED HMA THE "AC TYPE" SHALL BE "PG 64-22" UNLESS MODIFIED BY DISTRICT ONE SPECIAL PROVISIONS. FOR USE OF RECYCLED MATERIAL SEE SPECIAL PROVISIONS.


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STATE	OF	ILLINOIS
DEPARTMENT	OF '	TRANSPORTATION

HIGH RIDGE ROAD				F.A.U. RTE.	SECTION	COUNTY	TOTAL	SHEET NO.	
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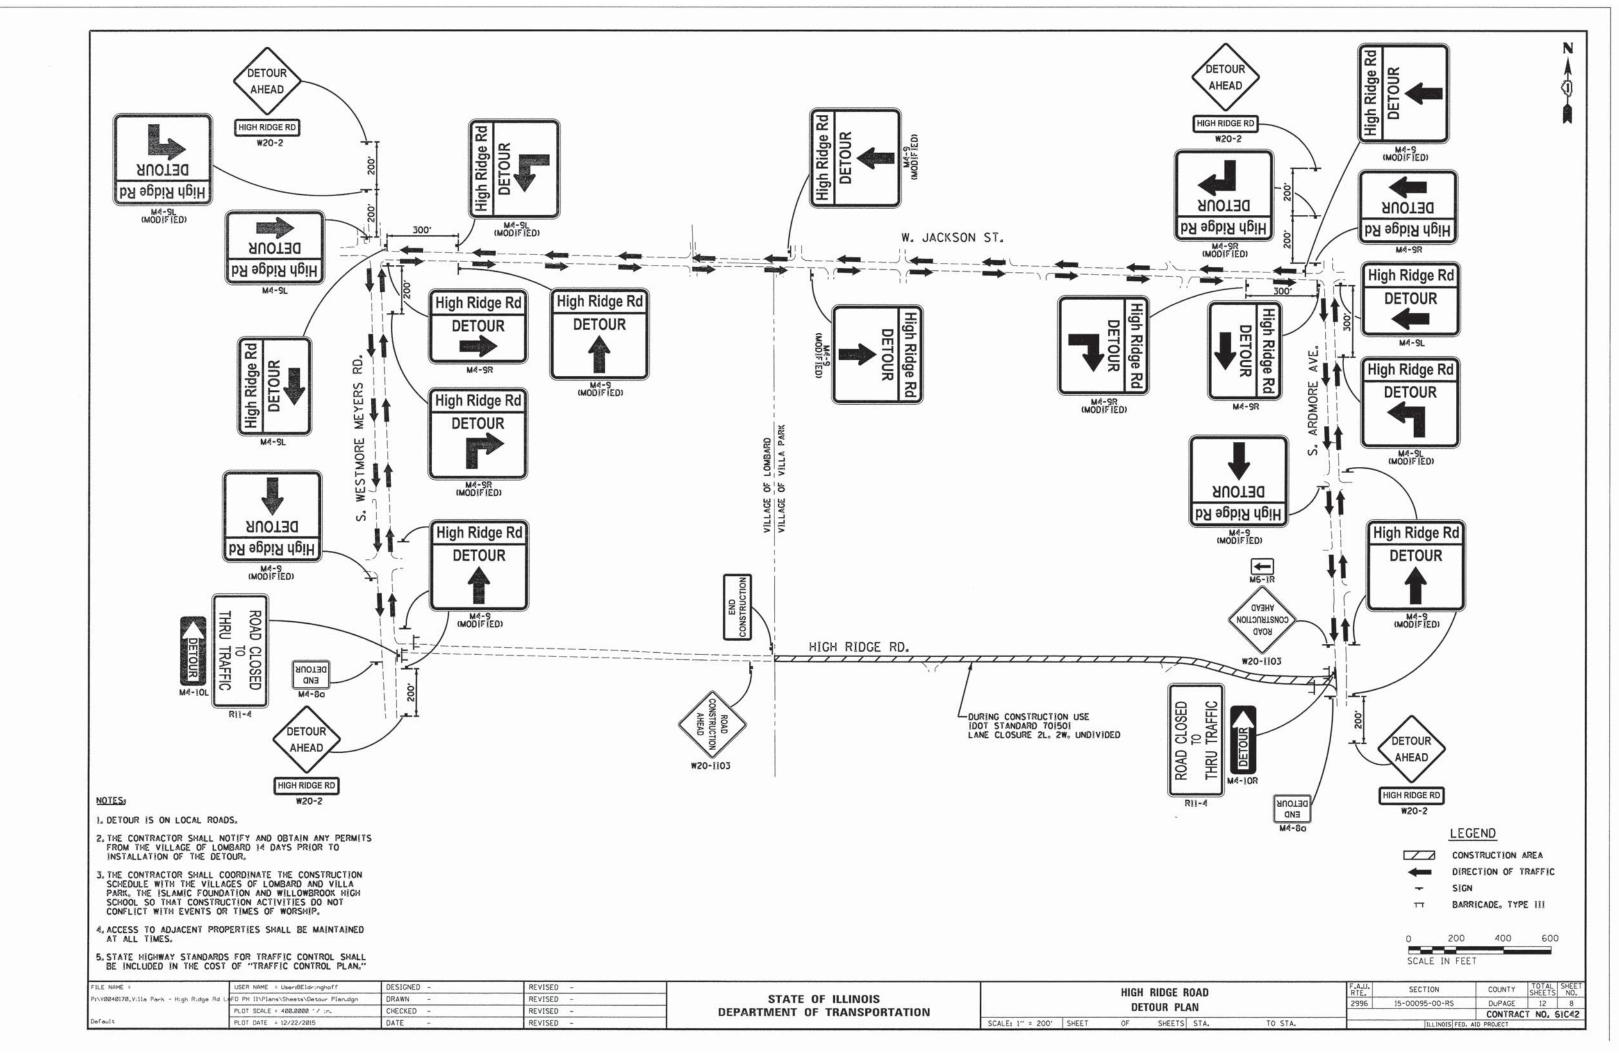
PAVEMENT MARKING LEGEND


- A THERMOPLASTIC PAVEMENT MARKING LETTERS AND SYMBOLS
- B THERMOPLASTIC PAVEMENT MARKING LINE 4" (YELLOW)
- C THERMOPLASTIC PAVEMENT MARKING LINE 4" (WHITE)
- (WHITE)
- (E) THERMOPLASTIC PAVEMENT MARKING LINE 4" (WHITE) (2' DASH, 6' SKIP)

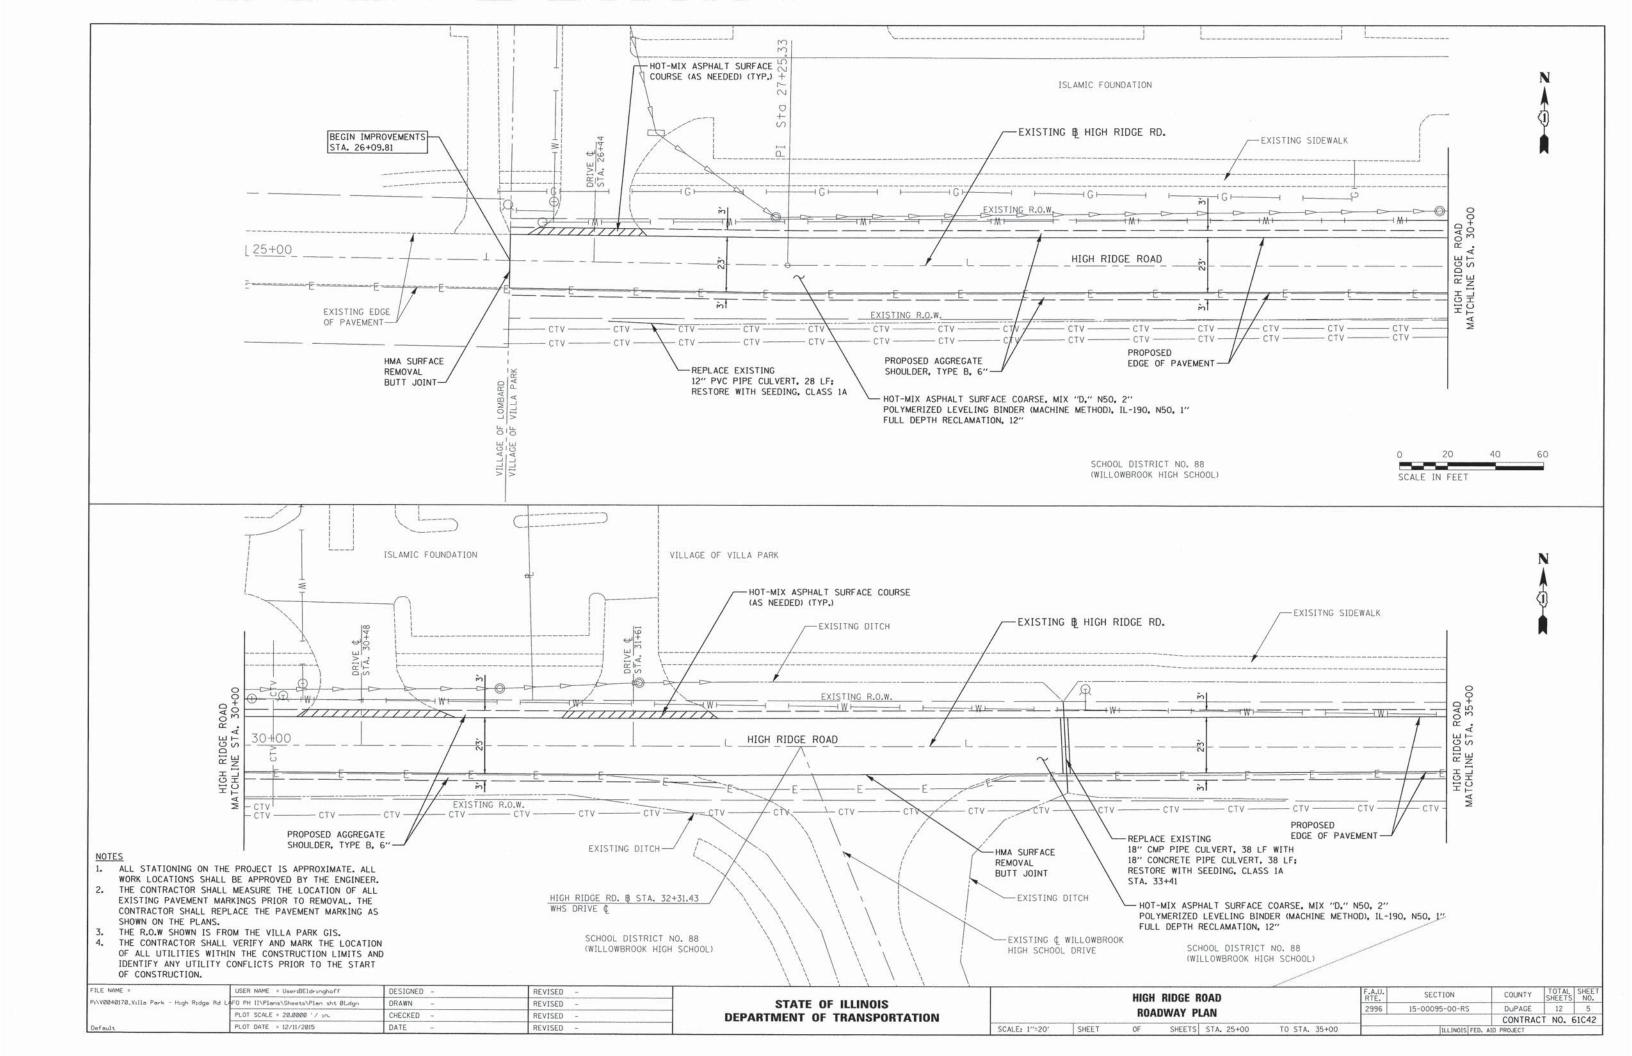NOTES

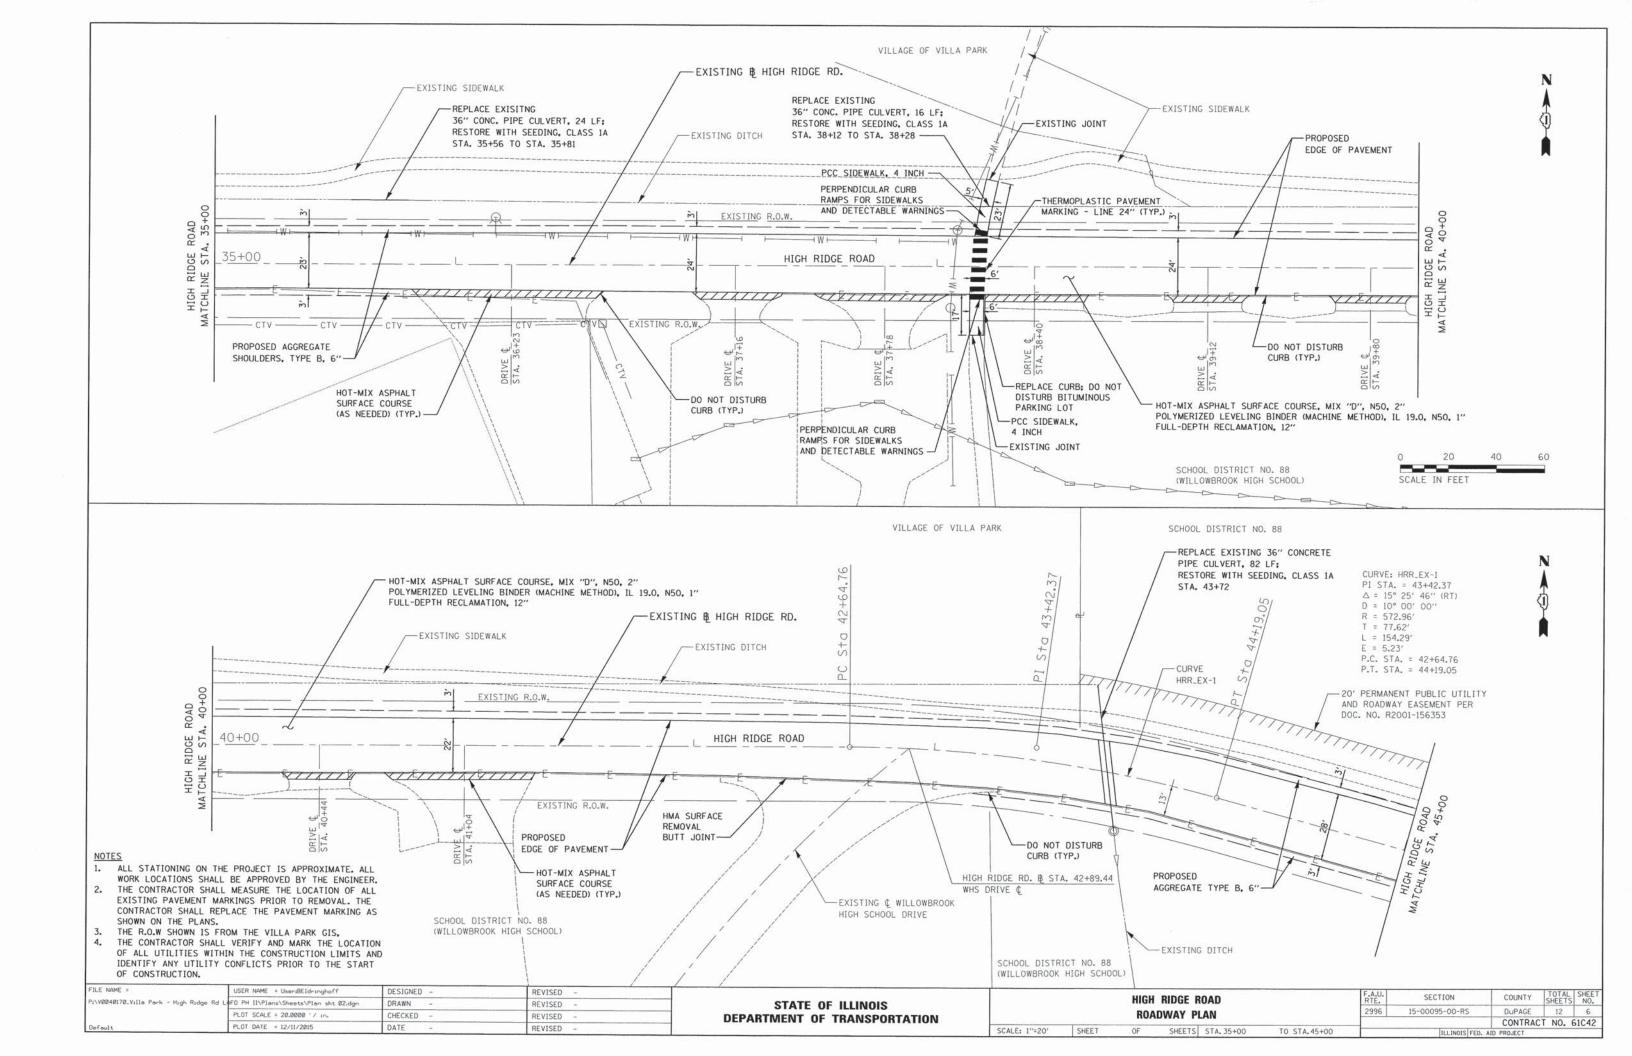- 1. ALL STATIONING ON THE PROJECT IS APPROXIMATE. ALL WORK LOCATIONS SHALL BE APPROVED BY THE ENGINEER.
- THE CONTRACTOR SHALL MEASURE THE LOCATION OF ALL EXISTING PAVEMENT MARKINGS PRIOR TO REMOVAL. THE CONTRACTOR SHALL REPLACE THE PAVEMENT MARKING AS SHOWN ON THE PLANS.
- 3. THE R.O.W SHOWN IS FROM THE VILLA PARK GIS.
- THE CONTRACTOR SHALL VERIFY AND MARK THE LOCATION OF ALL UTILITIES WITHIN THE CONSTRUCTION LIMITS AND IDENTIFY ANY UTILITY CONFLICTS PRIOR TO THE START OF CONSTRUCTION.

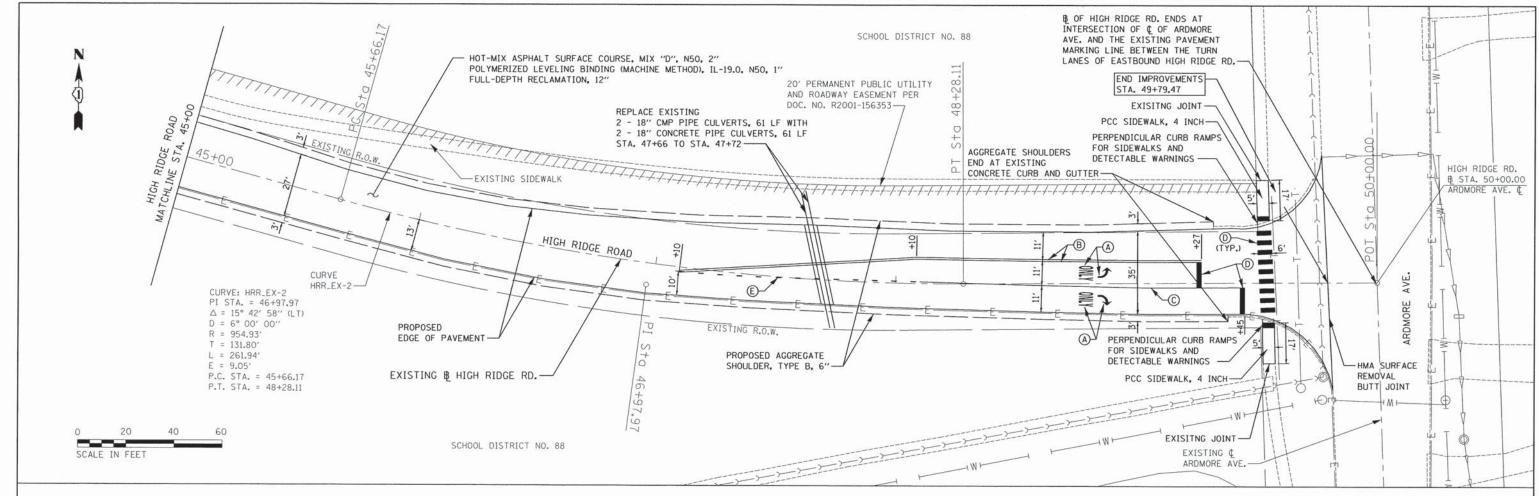
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(FOR BUTT JOINT AND HMA TAPER SEE DETAIL BELOW)


OPTION 1

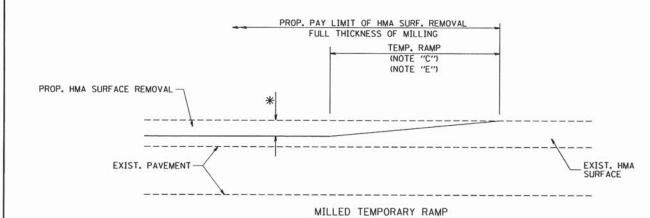

(FOR BUTT JOINT AND HMA TAPER SEE DETAIL BELOW)

OPTION 2

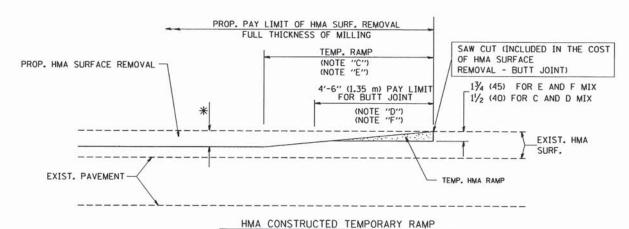TYPICAL TEMPORARY RAMP

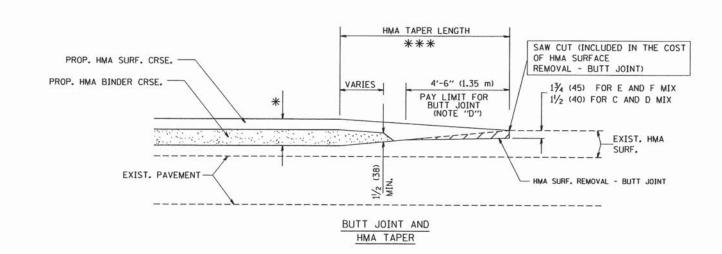

TYPICAL BUTT JOINT AND HMA TAPER FOR MILLING AND RESURFACING

FILE NAME = USER NAME = gaglianobt DESIGNED - M. DE YONG REVISED - R. SHAH 10-25-94 W:\diststd\22x34\bd32.dan DRAWN REVISED - A. ABBAS 03-21-97 PLOT SCALE = 50.0000 '/ IN. CHECKED REVISED - M. GOMEZ 04-06-01 PLOT DATE = 1/4/2008 DATE 06-13-90 REVISED

13/4 (45) FOR E AND F MIX 11/2 (40) FOR C AND D MIX * * EXIST. PAVEMENT BUTT JOINT DETAIL


PROP. HMA OR PCO

SURFACE REMOVAL - BUTT JOINT

30'-0" (9.0 m) (NOTE "A")

15'-0" (4.5 m) (NOTE "B")

(NOTE "D")

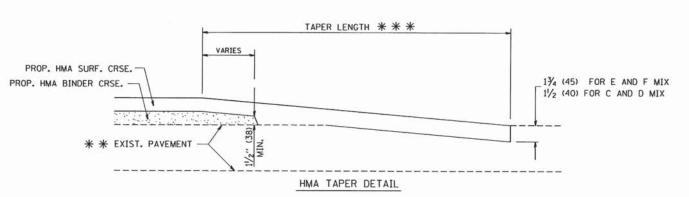

TYPICAL BUTT JOINT AND HMA TAPER FOR RESURFACING ONLY

* * PC CONCRETE, HMA OR HMA RESURFACED PAVEMENT.

NOTES

EXIST. HMA OR PCC SURFACE

- A: MAINLINE ROADWAYS AND MAJOR SIDE ROADS.
- B: MINOR SIDE ROADS.
- C: THE TEMP. RAMP SHALL BE CONSTRUCTED IMMEDIATELY UPON REMOVAL OF THE EXISTING HMA SURFACE.
- D: THE BUTT JOINT SHALL BE CONSTRUCTED IMMEDIATELY PRIOR TO PLACING THE PROPOSED HMA COURSES.
- E: TAPER THE TEMP. RAMP AT A RATE OF 3'-0" (900 mm) PER 1 INCH (25 mm) OF MILLING THICKNESS.
- F: INSTALLATION AND REMOVAL OF THE 4'-6" (1.35 m) TEMP. RAMP IS INCLUDED IN COST OF HMA SURFACE REMOVAL - BUTT JOINT
- G: SEE ARTICLE 406.08 AND 406.14 OF THE STANDARD SPECIFICATIONS FOR "HMA AND/OR PCC SURFACE REMOVAL. BUTT JOINT".
- * SEE TYPICAL SECTIONS FOR MILLING THICKNESS.
- * * * 20'-0" (6.1 m) PER 1 (25) RESURFACING (NOTE "A") 10'-0" (3.0 m) PER 1 (25) RESURFACING (NOTE "B")

BASIS OF PAYMENT:

THE BUTT JOINT WILL BE PAID FOR AT THE CONTRACT UNIT PRICE PER SQUARE YARD (SQUARE METER)
FOR "HOT-MIX ASPHALT SURFACE REMOVAL - BUTT JOINT" OR FOR "PORTLAND CEMENT CONCRETE SURFACE REMOVAL- BUTT JOINT".


ALL DIMENSIONS ARE IN INCHES (MILLIMETERS) UNLESS OTHERWISE SHOWN.

SAW CUT (INCLUDED IN THE COST

- BUTT JOINT)

OF HMA OR P.C.C. SURFACE REMOVAL

BUTT JOINT AND STATE OF ILLINOIS 15-00095-00-RS DuPAGE 12 9 HMA TAPER DETAILS DEPARTMENT OF TRANSPORTATION CONTRACT NO. 61C42 BD400-05 BD32 SHEET NO. 1 OF 1 SHEETS STA. SCALE: NONE TO STA. FED. ROAD DIST. NO. 1 ILLINOIS FED. AID PROJECT

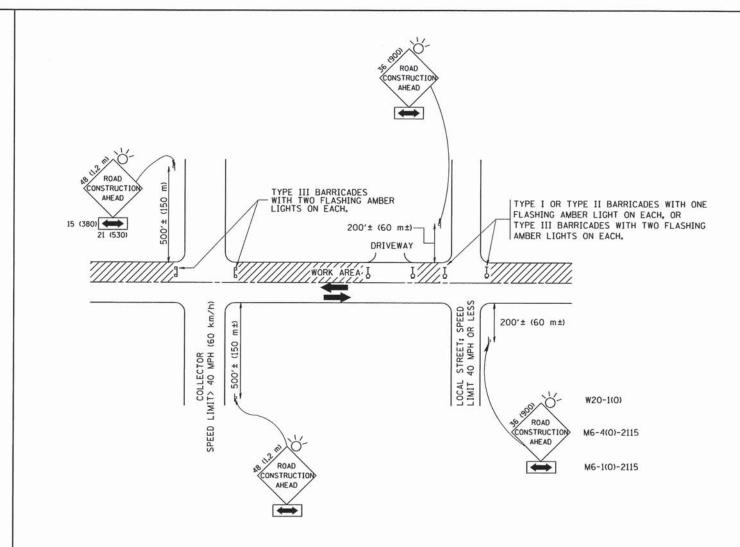

TRAFFIC CONTROL AND PROTECTION FOR SIDE ROADS, INTERSECTIONS, AND DRIVEWAYS

NOTES:

- A. FOR NO LANE RESTRICTION ON THE SIDE ROAD OR DRIVEWAYS
- SIDE ROAD WITH A SPEED LIMIT OF 40 MPH (60 km/h) OR LESS AS SHOWN ON THE DRAWING AND AS DIRECTED BY THE ENGINEER:
- O) ONE ROAD CONSTRUCTION AHEAD SIGN 36 x 36 (900x900) WITH A FLASHER AND FLAG MOUNTED ON IT APPROXIMATELY 200' (60 m) IN ADVANCE OF THE MAIN ROUTE.
- b) THE CLOSED PORTION OF THE MAIN ROUTE SHALL BE PROTECTED BY BLOCKING WITH TYPE I, TYPE II OR TYPE III BARRICADES, 1/3 OF THE CROSS SECTION OF THE CLOSED PORTION.
- SIDE ROAD WITH A SPEED LIMIT GREATER THAN 40 MPH (60 km/h) AS SHOWN ON THE DRAWING AND AS DIRECTED BY THE ENGINEER;
- O) ONE ROAD CONSTRUCTION AHEAD SIGN 48 x 48 (1.2 m x 1.2 m) WITH A FLASHER MOUNTED ON IT APPROXIMATELY 500' (150 m) IN ADVANCE OF THE MAIN ROUTE.
- b) THE CLOSED PORTION OF THE MAIN ROUTE SHALL BE PROTECTED BY
 BLOCKING WITH TYPE III BARRICADES, 1/2 OF THE CROSS SECTION
 OF THE CLOSED PORTION.

SCALE: NONE

 WHEN THE SIDE ROAD LIES BETWEEN THE BEGINNING OF THE MAINLINE SIGNING AND THE WORK ZONE, A SINGLE HEADED ARROW (MG-1) SHALL BE USED IN LIEU OF THE DOUBLE HEADED ARROW (MG-4).

B. FOR A LANE CLOSURE ON A SIDE ROAD OR DRIVEWAY:

USE APPLICABLE PORTIONS OF THE TYPICAL APPLICATION OF TRAFFIC CONTROL DEVICES (STD. 701501, STD. 701606 OR THE APPROPRIATE STANDARD). THE SPACING OF SIGNS AND BARRICADES SHALL BE ADJUSTED FOR FIELD CONDITIONS AS DIRECTED BY THE ENGINEER. THE DIRECTIONAL ARROW SHALL BE COVERED OR REMOVED WHEN NO LONGER CONSISTENT WITH THE SIDE ROAD LANE CLOSURE.


- C. ADVANCE WARNING SIGNS ARE TO BE OMITTED ON DRIVEWAY UNLESS OTHERWISE NOTED.
- D. THE TRAFFIC CONTROL AND PROTECTION FOR SIDE ROADS, INTERSECTIONS, AND DRIVEWAYS SHALL BE INCIDENTAL TO THE COST OF SPECIFIED TRAFFIC CONTROL STANDARDS OR ITEMS.

All dimensions are in millimeters (inches) unless otherwise shown.

FILE NAME =	USER NAME = gaglianobt	DESIGNED - LHA	REVISED - J. OBERLE 10-18-95
W:\diststd\22x34\tc10.dgn		DRAWN -	REVISED - A. HOUSEH 03-06-96
	PLOT SCALE = 50.000 ' / IN.	CHECKED -	REVISED - A. HOUSEH 10-15-96
	PLOT DATE = 1/4/2008	DATE - 06-89	REVISED -T. RAMMACHER 01-06-00


STATI	E OF	ILLINOIS
DEPARTMENT	OF	TRANSPORTATION

TRAFFIC CONTROL AND PROTECTION FOR	RTE.	SECTION	COUNTY	SHEETS	NO.
SIDE ROADS, INTERSECTIONS, AND DRIVEWAYS	2996	15-00095-00-RS	DuPAGE	12	10
SIDE HOADS, INTERSECTIONS, AND DRIVEWATS	TC-10		CONTRACT NO. 61C42		
SHEET NO. 1 OF 1 SHEETS STA TO STA	EED DOAD	DIST NO 1 THE THOIS SEE	AID DDO IECT		

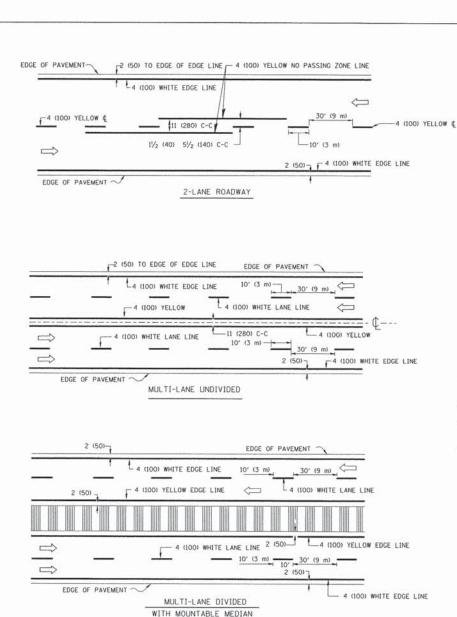


NOTE: MEDIANS WITH BARRIER CURB DO NOT REQUIRE AN EDGE LINE


TYPICAL LANE AND EDGE LINE MARKING

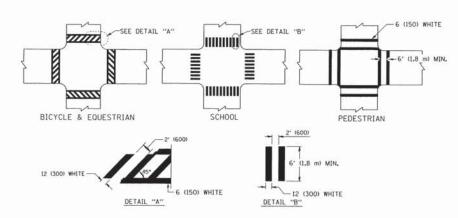

TYPICAL CROSSWALK MARKING

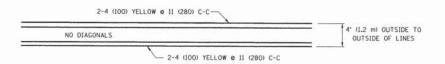


4' (1.2 m) WIDE MEDIANS ONLY

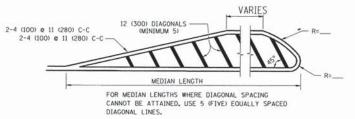

DIAGONAL LINE SPACING: 50' (15 m) C-C (LESS THAN 30MPH (50 km/h))
75' (25 m) C-C 30MPH (50 km/h) T0 45MPH (70 km/h))
150' (45 m) C-C (MORE THAN 45MPH (70 km/h))

MEDIANS OVER 4' (1.2 m) WIDE

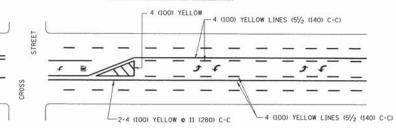


A MINIMUM OF TWO PAIRS OF TURN ARROWS SHALL BE USED, WHITE IN COLOR. ADDITIONAL PAIRS SHALL BE PLACED AT 200' (60 m) TO 300' (90 m) INTERVALS.



MEDIAN WITH TWO-WAY LEFT TURN LANE

TYPICAL PAINTED MEDIAN MARKING

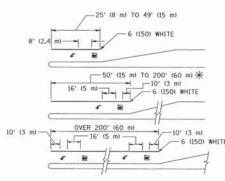



FULL SIZE LETTERS 8' (2.4 m) AND ARROWS SHALL BE USED. \uphi AREA = 15.6 SO. FT. (1.5 m²) \upmathbb{N} AREA = 20.8 SO. FT. (1.9 m²)

* TURN LANES IN EXCESS OF 400' (120 m) IN LENGTH MAY HAVE AN ADDITIONAL SET OF ARROW - "ONLY" INSTALLED MIDWAY BETWEEN THE OTHER TWO SETS OF ARROW - "ONLY".

TYPICAL LEFT (OR RIGHT) TURN LANE

TYPICAL TURN LANE MARKING

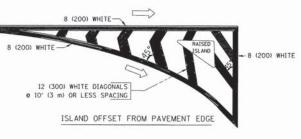

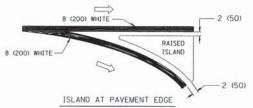

TYPICAL ISLAND MARKING

TYPE OF MARKING	WIDTH OF LINE	PATTERN	COLOR	SPACING / REMARKS
CENTERLINE ON 2 LANE PAVEMENT	4 (100)	SKIP-DASH	YELLOW	10' (3 m) LINE WITH 30' (9 m) SPACE
CENTERLINE ON MULTI-LANE UNDIVIDED PAVEMENT	2 & 4 (100)	SOLID	YELLOW	11 (280) C-C
NO PASSING ZONE LINES: FOR ONE DIRECTION FOR BOTH DIRECTIONS	4 (100) 2 @ 4 (100)	SOLID SOLID	YELLOW	5½ (140) C-C FROM SKIP-DASH CENTERLINE 11 (280) C-C OMIT SKIP-DASH CENTERLINE BETWEEN
LANE LINES	4 (100) 5 (125) ON FREEWAYS	SKIP-DASH SKIP-DASH	WHITE WHITE	10' (3 m) LINE WITH 30' (9 m) SPACE
DOTTED LINES (EXTENSIONS OF CENTER, LANE OR TURN LANE MARKINGS)	SAME AS LINE BEING EXTENDED	SKIP-DASH	SAME AS LINE BEING EXTENDED	2' (600) LINE WITH 6' (1.8 m) SPACE
EDGE LINES	4 (100)	SOLID	YELLOW-LEFT WHITE-RIGHT	OUTLINE MOUNTABLE MEDIANS IN YELLOW: EDGE LINES ARE NOT USED NEXT TO BARRIER CURB
TURN LANE MARKINGS	6 (150) LINE; FULL SIZE LETTERS & SYMBOLS (8' (2.4m))	SOLID	WHITE	SEE TYPICAL TURN LANE MARKING DETAIL
TWO WAY LEFT TURN MARKING	2 e 4 (100) EACH DIRECTION	SKIP-DASH AND SOLID	YELLOW	10' (3 m) LINE WITH 30' (9 m) SPACE FOR SKIP-DASH; 51/2 (140) C-C BETWEEN SOLID LINE AND SKIP-DASH LINE
	8' (2.4m) LEFT ARROW	IN PAIRS	WHITE	SEE TYPICAL TWO-WAY LEFT TURN MARKING DETAIL
CROSSWALK LINES (PEDESTRIAN) A. DIAGONALS (BIKE & EQUESTRIAN) B. LONGITUDINAL BARS (SCHOOL)	2 @ 6 (150) 12 (300) @ 45° 12 (300) @ 90°	SOLID SOLID SOLID	WHITE WHITE WHITE	NOT LESS THAN 6' (1.8 m) APART 2' (600) APART 2' (600) APART SEE TYPICAL CROSSWALK MARKING DETAILS.
STOP LINES	24 (600)	SOLID	WHITE	PLACE 4' (1.2 m) IN ADVANCE OF AND PARALLEL TO CROSSMALK, IF PRESENT. OTHERWISE, PLACE AT DESIRED STOPPING POINT. PARALLEL TO CROSSROAD CENTERLINE, WHERE POSSIBLE
PAINTED MEDIANS	2 @ 4 (100) WITH 12 (300) DIAGONALS @ 45° NO DIAGONALS USED FOR 4' (1.2 m) WIDE MEDIANS	SOLID	YELLOW: TWO WAY TRAFFIC WHITE: ONE WAY TRAFFIC	11 (280) C-C FOR THE DOUBLE LINE SEE TYPICAL PAINTED MEDIAN MARKING.
GORE MARKING AND CHANNELIZING LINES	8 (200) WITH 12 (300) DIAGONALS @ 45°	SOLID	WHITE	DIAGONALS: 15' (4.5 m) C-C (LESS THAN 30MPH (50 km/h)) 20' (6 m) C-C 30MPH (50 km/h) TO 45MPH (70 km/h)) 30' (9 m) C-C (0VER 45MPH (70 km/h))
RAILROAD CROSSING	24 (600) TRANSVERSE LINES: "RR" IS 6' (1.8 m) LETTERS: 16 (400) LINE FOR "X"	SOLID	WHITE	SEE STATE STANDARD 780001 AREA OF: "R"=3.6 SO. FT. (0.33 m²) EACH "X"=54,0 SO. FT. (5.0 m²)
SHOULDER DIAGONALS	12 (300) e 45°	SOLID	WHITE - RIGHT YELLOW - LEFT	50' (15 m) C-C (LESS THAN 30MPH (50 km/h)) 75' (25 m) C-C (30 MPH (50 km/h) T0 45MPH (70 km/h) 150' (45 m) C-C (0VER 45MPH (70 km/h))


FOR FURTHER DETAILS ON PAVEMENT MARKING REFER TO STANDARD SPECIFICATIONS FOR ROAD AND BRIDGE CONSTRUCTION AND STATE STANDARD 780001.


All dimensions are in inches (millimeters) unless otherwise shown.

FILE NAME =	USER NAME = drivakosgn	DESIGNED - EVERS	REVISED -T. RAMMACHER 10-27-94
c:\pw_work\pwidot\drivakosgn\d0108315\tol3	3.dgn	DRAWN -	REVISED -C. JUCIUS 09-09-09
1	PLOT SCALE = 50,000 ' / IN.	CHECKED -	REVISED -
	PLOT DATE = 9/9/2009	DATE - 03-19-90	REVISED -

STATI	E 01	FILLINOIS
DEPARTMENT	OF	TRANSPORTATION


	DISTRIC	ONE		F.A.U. RTE.	SECTION	COUNTY	TOTAL	SHEE NO.	
	TYPICAL PAVEME	NT MADVINGS		2996	15-00095-00-RS	DuPAGE	12	11	
	TYPICAL PAVEMENT MARKINGS				TC-13		CONTRACT NO. 61C42		
SCALE: NONE	SHEET NO. 1 OF 1 SHEET	S STA.	TO STA.	FED. ROAD	DIST. NO. 1 ILLINOIS FED.	AID PROJECT			

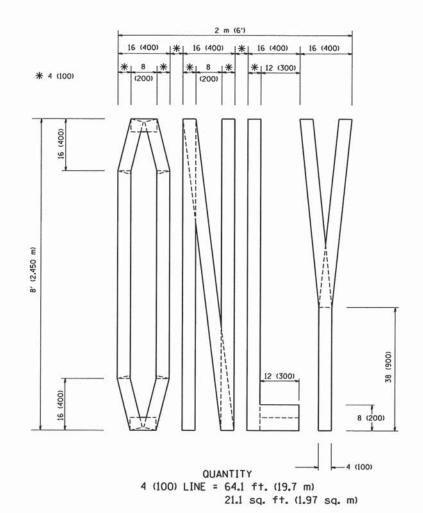

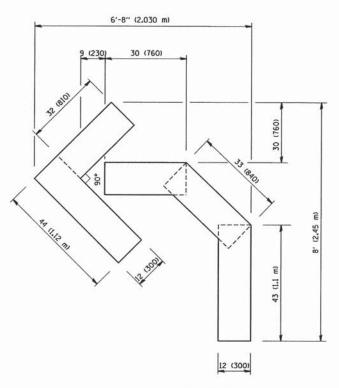

OUANTITY 4 (100) LINE = 45.5 ft. (13.9 m) 15.2 sq. ft. (1.39 sq. m)

SCALE: NONE

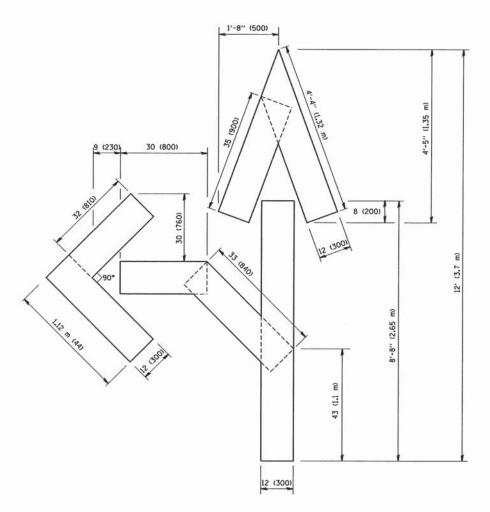

OUANTITY 4 (100) LINE = 82.5 ft. (25.3 m) 27.5 sq. ft. (2.53 sq. m)

All dimensions are in inches (millimeters) unless otherwise shown.

FILE NAME =	USER NAME = gaglianobt	DESIGNED -	REVISED -T. RAMMACHER 06-05-96
W:\diststd\22x34\tal6.dgn		DRAWN -	REVISED -T. RAMMACHER 11-04-97
	PLOT SCALE = 50.0000 ' / IN.	CHECKED -	REVISED -T. RAMMACHER 03-02-98
	PLOT DATE = 1/4/2008	DATE - 09-18-94	REVISED -E. GOMEZ 08-28-00

STATI	E 01	F ILLINOIS
DEPARTMENT	OF	TRANSPORTATION

PAVEMENT MARKING LETTERS AND SYMBOLS			RTE.	SECTION	COUNTY	SHEETS	SHEET NO.
EOD TRACEIC STACING			2996	15-00095-00-RS	DuPAGE	12	12
FOR TRAFFIC STAGING			TC-16		CONTRACT NO.		61C42
SHEET NO. 1 OF 1 SHEETS	STA.	TO STA.	FFD. ROAD	DIST NO 1 HILINOIS FED.			