03-05-2021 LETTING ITEM 076

FOR INDEX OF SHEETS, SEE SHEET NO. 2

PROJECT LOCATED IN THE CITY OF DES PLAINES. CITY OF PARK RIDGE, VILLAGE OF NILES, AND UNINCORPORATED MAINE TOWNSHIP

BALLARD ROAD

0

0

0

0

2018 ADT = 14,000POSTED SPEED = 35-40 MPH

STATE OF ILLINOIS **DEPARTMENT OF TRANSPORTATION**

HIGHWAY PLANS

RAND ROAD TO GREENWOOD AVE

PROJECT: STP-6NJ1(425)

C-91-338-20

R12E PROJECT BEGINS STATION 10+75 NILES DES PLAINES Des Pl MAINE TOWNSHIP

PROJECT ENDS **STATION** 110 + 21

TO DRWG NO 1 TO

OMISSION STA, 48 + 49 TO STA, 65 + 17

STATE OF ILLINOIS DEPARTMENT OF TRANSPORTATION SUBMITTED DECEMBER 9 20 20 January 2

LOCATION OF SECTION INDICATED THUS: - -

SECTION

D-91-540-20

2020-140-AS&SW

FED. ROAD DIST. NO. 1 | ILLINOIS CONTRACT NO. 62M18

50 1_

FULL SIZE PLANS HAVE BEEN PREPARED USING STANDARD ENGINEERING SCALES. REDUCED SIZED PLANS WILL NOT CONFORM TO STANDARD SCALES. IN MAKING MEASUREMENTS ON REDUCED PLANS, THE ABOVE SCALES MAY BE USED.

J.U.L.I.E.

JOINT UTILITY LOCATION INFORMATION FOR EXCAVATION 1-800-892-0123 OR 811

LOCATION MAP NOT TO SCALE

GROSS LENGTH OF PROJECT = 9,945 FT. = 1.88 MILES NET LENGTH OF PROJECT = 8,277 FT. = 1.57 MILES

PROJECT ENGINEER: VESLIN VELICHKOW, P.E. (847) 705-4432 PROJECT MANAGER: FAWAD AQUEEL, P.E. (847) 705-4247

CONTRACT NO. 62M18







PRINTED BY THE AUTHORITY OF THE STATE OF ILLINOIS

REV-SEP

PROPOSED

FAU ROUTE 1319: BALLARD ROAD

SECTION: 2020–140–RS&SW

SMART OVERLAY, ADA IMPROVEMENTS

COOK COUNTY

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- 45-50 PD-01 PROJECT DETAIL FOR CURB RAMPS

LIST OF HIGHWAY STANDARDS

000001-08	STANDARD SYMBOLS, ABBREVIATIONS, AND PATTERNS
280001-07	TEMPORARY EROSION CONTROL SYSTEMS
442201-03	CLASS C AND D PATCHES
606001-07	CONCRETE CURB TYPE B AND COMBINATION CONCRETE CURB AND GUTTER
701011-04	OFF-RD MOVING OPERATIONS, 2L, 2W, DAY ONLY
701301-04	LANE CLOSURE, 2L, 2W SHORT TIME OPERATIONS
701311-03	LANE CLOSURE, 2L, 2W MOVING OPERATIONS - DAY ONLY
701427-04	LANE CLOSURE, MULTILANE, INTERMITTENT OR MOVING OPER., FOR SPEEDS < OR = 40 MPH
701501-06	URBAN LANE CLOSURE, 2L, 2W UNDIVIDED
701606-10	URBAN SINGLE LANE CLOSURE, MULTILANE, 2W WITH MOUNTABLE MEDIAN
701701-10	URBAN LANE CLOSURE, MULTILANE INTERSECTION

COMMITMENTS

NO COMMITMENTS FOR THIS PROJECT

701901-08 TRAFFIC CONTROL DEVICES

701801-06 SIDEWALK, CORNER OR CROSSWALK CLOSURE

GENERAL NOTES

- BEFORE STARTING ANY EXCAVATION, THE CONTRACTOR SHALL CALL "J.U.L.I.E." AT (800) 892-0123 FOR FIELD LOCATIONS OF BURIED ELECTRIC, TELEPHONE AND GAS UTILITIES, 48 HOUR NOTIFICATION IS REQUIRED.
- THE CONTRACTOR SHALL TAKE CARE IN REMOVING OR EXCAVATING NEAR ALL EXISTING ITEMS WHICH WILL REMAIN. ANY DAMAGE DONE TO EXISTING ITEMS, BY THE CONTRACTOR, SHALL BE REPAIRED AT THE CONTRACTORS EXPENSE.
- 3. THE CONTRACTOR SHALL COORDINATE CONSTRUCTION ACTIVITIES WITH UTILITY COMPANIES, AND VILLAGES OF DES PLAINES, GLENVIEW, NILES, AND PARK RIDGE.
- 4. WHEN MILLED PAVEMENT IS OPEN TO TRAFFIC THE MAXIMUM GRADE DIFFERENTIAL BETWEEN PASSES OF THE MILLING MACHINE SHALL NOT EXCEED 1 1/2 INCHES WHERE THE SPEED LIMIT IS 45 MPH OR LESS AND 1 INCH WHERE THE SPEED LIMIT IS GREATER THAN 45 MPH. WITH WRITTEN APPROVAL FROM THE ENGINEER, A MAXIMUM GRADE DIFFERENTIAL OF 3 INCHES MAY BE ALLOWED IF THE EDGE OF THE MILLING IS SLOPED A MINIMUM 1:3 (V:H).
- THE CONTRACTOR SHALL CONTACT THE DISTRICT ONE TRAFFIC CONTROL SUPERVISOR AT KALPANA.KANNAN-HOSADURGA@ILLINOIS.GOV A MINIMUM OF 72 HOURS IN ADVANCE OF BEGINNING WORK.
- 6. BEFORE BEGINNING ANY WORK, THE CONTRACTOR SHALL RETAIN AND RECORD FOR FUTURE REFERENCES, ALL EXISTING PAVEMENT MARKING LINES AND RAISED REFLECTIVE PAVEMENT MARKERS IN ORDER THAT THESE LOCATIONS CAN BE RE-ESTABLISHED FOR STRIPING. EXACT LOCATIONS OF ALL STRIPING SHALL BE AS DIRECTED BY THE ENGINEER.
- 7. THE CONTRACTOR WILL NOT BE ALLOWED TO SET UP A YARD OR FIELD OFFICE ON STATE PROPERTY WITHOUT WRITTEN PERMISSION FROM THE DEPARTMENT.
- 8. THE CONTRACTOR SHALL BE REQUIRED TO PROVIDE ACCESS TO ABUTTING PROPERTY AT ALL TIMES DURING THE CONSTRUCTION OF THIS PROJECT.
- UNLESS OTHER CONDITIONS WARRANT EXTENDED LANE CLOSURE AS DETERMINED AND APPROVED IN WRITING BY THE ENGINEER OR AS PROVIDED FOR IN THE CONTRACT SPECIFICATIONS. OVERNIGHT CLOSURES SHALL NOT BE ALLOWED FOR REHABILITATION PROJECTS INVOLVING DAYTIME MILLING AND RESURFACING OPERATIONS AND CLASS D PATCHING
- 10. IN ADDITION TO FIELD AND AERIAL SURVEYS, PLAN DIMENSIONS AND DETAILS RELATIVE TO THE EXISTING FACILITIES HAVE BEEN TAKEN FROM EXISTING PLANS AND ARE SUBJECT TO CONSTRUCTION VARIATIONS. IT SHALL BE THE CONTRACTOR'S RESPONSIBILITY TO VERIFY SUCH DIMENSIONS AND EXISTING CONDITIONS IN THE FIELD PRIOR TO CONSTRUCTION AND ORDERING MATERIALS. SUCH VARIATIONS SHALL NOT BE A CAUSE FOR ADDITIONAL COMPENSATION DUE TO A CHANGE IN THE SCOPE OF WORK. HOWEVER, THE CONTRACTOR WILL BE PAID FOR THE QUANTITY ACTUALLY FURNISHED AT THE UNIT PRICE BID FOR THE WORK.
- 11. DO NOT SCALE PLANS FOR CONSTRUCTION DIMENSIONS.
- 12. FRAMES AND GRATES ADJUSTMENT OF PRIVATE UTILITIES WITHIN THE LIMITS OF THE IMPROVEMENTS SHALL BE DONE BY THEIR RESPECTIVE OWNERS AND ARE NOT PART OF THIS CONTRACT
- 13. ALL DAMAGE TO EXISTING PAVEMENT MARKINGS OR RAISED REFLECTIVE PAVEMENT MARKERS, OUTISDE THE REMOVAL LINE SHOWN ON THE PLANS, SHALL BE REPLACED AT NO ADDITIONAL COST TO THE DEPARTMENT.
- 14. THE CONTRACTOR SHALL PROVIDE ADEQUATE DRAINAGE AND EROSION CONTROL PROTECTION DURING ALL STAGES OF CONSTRUCTION.
- 15. BUTT JOINTS WILL BE INSTALLED AT THE ENDS OF ALL RESURFACING (WHERE RESURFACING MEETS EXISTING PAVEMENT), IN ACCORDANCE WITH THE "BUTT JOINT AND HOT-MIX ASPHALT TAPER DETAILS" SHEET INCLUDED IN THE PLANS, UNLESS OTHERWISE SPECIFIED
- 16. THE RESIDENT ENGINEER SHALL CONTACT WALTER CZARNY, AREA TRAFFIC FIELD ENGINEER, AT WALTER.CZARNY@ILLINOIS.GOV A MINIMUM OF TWO (2) WEEKS PRIOR TO THE PLACEMENT OF PERMANENT PAVEMENT MARKINGS.
- 17. POLLUTION CONTROL: THE CONTRACTOR SHALL BE REQUIRED TO COMPLY WITH THE STATE REGULATIONS REGARDING AIR, WATER, AND NOISE POLLUTION, THIS WORK IS NOT TO BE PAID SEPARATELY AND SHALL BE INCLUDED IN THE COST OF THE CONTRACT
- 18 THE COST OF SAW CUTTING SHALL BE INCLUDED IN THE UNIT PRICES FOR THE VARIOUS REMOVAL PAY ITEMS.
- 19. ANY PAVEMENT MARKINGS AND RAISED REFLECTIVE PAVEMENT MARKERS OBLITERATED BY MILLING AND RESURFACING OPERATIONS ON SIDE STREETS AND ENTRANCES SHALL BE REPLACED AND PAID FOR IN KIND.
- 20. DOUBLE LANE MARKERS ARE TO BE USED AS SHOWN ON THE DISTRICT ONE DETAIL "TYPICAL APPLICATIONS RAISED REFLECTIVE PAVEMENT MARKERS (SNOW-PLOW RESISTANT)" SHOWN ON THE PLANS.
- 21. PAVEMENT MARKING TAPE, TYPE IV SHALL BE USED FOR SHORT TERM PAVEMENT MARKINGS ON ALL FINAL SURFACES. THE COST OF THE PAVEMENT MARKING TAPE, TYPE IV AND ITS REMOVAL SHALL BE INCLUDED IN THE COST OF SHORT TERM PAVEMENT MARKING.
- 22. THE CONTRACTOR SHALL PLACE PROPOSED PAVEMENT MARKINGS IN ACCORDANCE WITH DISTRICT 1 TYPICAL PAVEMENT MARKINGS DETAILS (TC-13 & TC-14).
- 23. ALL PAVEMENT PATCHING LOCATIONS WILL BE DETERMINED IN THE FIELD BY THE ENGINEER.
- 24. PROPOSED SIDEWALK RAMPS SHALL CONFORM TO CURRENT ADA REQUIREMENTS AND APPLICABLE STATE HIGHWAY STANDARDS OR AS DETERMINED BY THE ENGINEER.
- 25. THE ENGINEER SHALL REPORT CLEARANCES UNDER BRIDGE AFTER RESURFACING



USER NAME = jcovarrubias	DESIGNED - TN	REVISED -
	DRAWN - JC	REVISED -
PLOT SCALE = 2.0000 ' / in.	CHECKED - TN	REVISED -
PLOT DATE = 12/11/2020	DATE -	REVISED -

STATE OF ILLINOIS **DEPARTMENT OF TRANSPORTATION**

BAL	LARD RD. (RAND	RD. TO GREENWOOD	AVE.)
INDEX OF	SHEETS, STATE ST	ANDARDS AND GENI	ERAL NOTES
SCALE: N/A	SHEET NO. 1 OF 1	SHEETS STA. N/A	TO STA. N/A

				CONST. TYPE CODE		
PAYCODE	ITEM DESCRIPTION	UNIT	TOTAL QUANTITIES	URBAN 80% FED 20% STATE	URBAN 100% STATE	
00000100	FARTY EVOLUATION	011.115		0005	0005	
20200100	EARTH EXCAVATION	CU YD	77	77		
21101615	TOPSOIL FURNISH AND PLACE, 4*	SQ YD	844	844		
25200110	SODDING, SALT TOLERANT	SQ YD	844	844		
25200200	SUPPLEMENTAL WATERING	UNIT	4	4		
1000000		201112		.====		
40600290	BITUMINOUS MATERIALS (TACK COAT)	POUND	15890	15890		
40600400	MIXTURE FOR CRACKS, JOINTS, AND FLANGEWAYS	TON	53	53		
40600982	HOT-MIX ASPHALT SURFACE REMOVAL - BUTT JOINT	SQ YD	412	412		
40601005	HOT-MIX ASPHALT REPLACEMENT OVER PATCHES	TON	93	93		
40004000	LIGT MAY ARRIVE TO UPSAGE COURSE ALLO S. MAY ARRIVED ATT	TON	0007	0007		
40604062	HOT-MIX ASPHALT SURFACE COURSE, IL-9.5, MIX "D", N70	TON	2967	2967		
42001300	PROTECTIVE COAT	SQ YD	1192	1192		
42400200	PORTLAND CEMENT CONCRETE SIDEWALK 5 INCH	SQ FT	5732	5732		
42400800	DETECTABLE MARNINGS	CO ET	F22	F22		
42400800	DETECTABLE WARNINGS	SQ FT	532	532		
44000155	HOT-MIX ASPHALT SURFACE REMOVAL, 1 1/2"	SQ YD	34899	34899		
44000600	SIDEWALK REMOVAL	SQ FT	4898	4898		
44002212	HOT-MIX ASPHALT REMOVAL OVER PATCHES, 3'	SQ YD	1103	1103		
44201753	CLASS D PATCHES, TYPE II, 9 INCH	SQ YD	209	209		
44201757	CLASS D PATCHES, TYPE III, 9 INCH	SQ YD	523	523		

* SPECIALTY ITEM

 \triangle NON-PARTICIPATING (100% STATE)

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PLOT DATE = 12/11/2020	DATE -	REVISED -

				CONST. TY	PE CODE
PAYCODE	E ITEM DESCRIPTION	UNIT	TOTAL QUANTITIES	URBAN 80% FED 20% STATE	URBAN 100% STA
44201759	CLASS D PATCHES, TYPE IV, 9 INCH	SQ YD	314	314	0003
48102100	AGGREGATE WEDGE SHOULDER, TYPE B	TON	466	466	
60255500	MANHOLES TO BE ADJUSTED	EACH	1	1	
60266600	VALVE BOXES TO BE ADJUSTED	EACH	2	2	
60300305	FRAMES AND LIDS TO BE ADJUSTED	EACH	25	25	
66900200	NON-SPECIAL WASTE DISPOSAL	CU YD	77	77	
00 300200	NON-SPECIAL WASTE DISPOSAL	CO 10	//	//	
66900530	SOIL DISPOSAL ANALYSIS	EACH	11	11	
66901001	REGULATED SUBSTANCES PRE-CONSTRUCTION PLAN	LSUM	1	1	
66901003	REGULATED SUBSTANCES FINAL CONSTRUCTION REPORT	LSUM	1	1	
66901006	REGULATED SUBSTANCES MONITORING	CAL DA	15	15	
67000400	ENGINEER'S FIELD OFFICE, TYPE A	CAL MO	12	12	
67100100	MOBILIZATION	L SUM	1	1	
70102620	TRAFFIC CONTROL AND PROTECTION, STANDARD 701501	L SUM	1	1	
70102622	TRAFFIC CONTROL AND PROTECTION, STANDARD 701502	L SUM	1	1	
70102625	TRAFFIC CONTROL AND PROTECTION, STANDARD 701606	L SUM	1	1	
70102630	TRAFFIC CONTROL AND PROTECTION, STANDARD 701601	L SUM	1	1	
	TRAFFIC CONTROL AND PROTECTION, STANDARD 701602	L SUM			

* SPECIALTY ITEM

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PLOT DATE = 12/11/2020	DATE -	REVISED -

PHII\WO28.Bollord Rood\01-CADD\02-Shts\03-D162M18-s	
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				1	CONST. TYPE CODE		
PAYCOI	PAYCODE	ITEM DESCRIPTION	UNIT	TOTAL QUANTITIES	URBAN 80% FED 20% STATE	URBAN 100% STATE	
ŀ	70102635	TRAFFIC CONTROL AND PROTECTION, STANDARD 701701	L SUM	1	1	0003	
ŀ							
	70102640	TRAFFIC CONTROL AND PROTECTION, STANDARD 701801	L SUM	1	1		
	70300100	SHORT TERM PAVEMENT MARKING	FOOT	4454	4454		
	70300150	SHORT TERM PAVEMENT MARKING REMOVAL	SQ FT	1485	1485		
ŀ							
	70300210	TEMPORARY PAVEMENT MARKING LETTERS AND SYMBOLS	SQ FT	536	536		
-	70300220	TEMPORARY PAVEMENT MARKING - LINE 4"	FOOT	24743	24743		
	70300240	TEMPORARY PAVEMENT MARKING - LINE 6"	FOOT	3000	2000		
\mid	70300240	TEMPORANT PAVEMENT MARKING - LINE 6	F001	שששצ	3000		
	70300260	TEMPORARY PAVEMENT MARKING - LINE 12"	FOOT	1345	1345		
	70300280	TEMPORARY PAVEMENT MARKING - LINE 24*	FOOT	752	752		
	78000100	THERMOPLASTIC PAVEMENT MARKING - LETTERS AND SYMBOLS	SQ FT	536	536		
	78000200	THERMOPLASTIC PAVEMENT MARKING - LINE 4"	FOOT	24743	24743		
-	78000400	THERMOPLASTIC PAVEMENT MARKING - LINE 6"	FOOT	3000	3000		
	78000600	THERMOPLASTIC PAVEMENT MARKING - LINE 12"	FOOT	1346	1346		
+	78000650	THERMOPLASTIC PAVEMENT MARKING - LINE 24"	FOOT	752	752		
ļ	78009012	MODIFIED URETHANE PAVEMENT MARKING - LINE 12"	FOOT	630	630		
	78100100	RAISED REFLECTIVE PAVEMENT MARKER	EACH	386	386		
-	78300200	RAISED REFLECTIVE PAVEMENT MARKER REMOVAL	EACH	386	386		

* SPECIALTY ITEM

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PLOT DATE = 12/11/2020	DATE -	REVISED -

*					CONST. TY	PE CODE
	PAYCODE	ITEM DESCRIPTION	UNIT	TOTAL QUANTITIES	URBAN 80% FED 20% STATE	URBAN 100% STAT
	78300202	PAVEMENT MARKING REMOVAL - WATER BLASTING	SQ FT	1134	1134	
-						
ļ	85000200	MAINTENANCE OF EXISTING TRAFFIC SIGNAL INSTALLATION	EACH	2	2	
-	88600600	DETECTOR LOOP REPLACEMENT	FOOT	1649	1649	
:	89502376	REBUILD EXISTING HANDHOLE	EACH	2	2	
_	XØ32ØØ5Ø	CONSTRUCTION LAYOUT (SPECIAL)	L SUM	1	1	
-	X4400501	COMBINATION CONCRETE CURB AND GUTTER REMOVAL AND REPLACEMENT LESS THAN OR EQUAL TO 10 FEET	FOOT	70	70	
k	X2600011	REMOVE AND RELOCATE SIGN PANEL	EACH	1	1	
-	X6Ø3Ø31Ø	FRAMES AND LIDS TO BE ADJUSTED (SPECIAL)	EACH	25	25	
	X7030005	TEMPORARY PAVEMENT MARKING REMOVAL	SQ FT	13133	13133	
-	ZØØØ4562	COMBINATION CONCRETE CURB AND GUTTER REMOVAL AND REPLACEMENT	FOOT	1978	1978	
۲	ZØØ185ØØ	DRAINAGE STRUCTURES TO BE CLEANED	EACH	22		22
-	ZØØ186ØØ	DRAINAGE STRUCTURES TO BE RECONSTRUCTED	EACH	2	2	
-	ZØØ3Ø85Ø	TEMPORARY INFORMATION SIGNING	SQ FT	182	182	
-	Z0033700	LONGITUDINAL JOINT SEALANT	FOOT	10673	10673	
ø	Z0076600	TRAINEES	HOURS	500	500	
Ø	Z0076604	TRAINEES - TRAINING PROGRAM GRADUATE	HOURS	500	500	

Ø 0042


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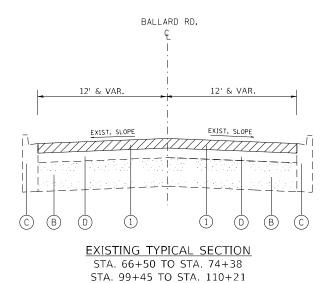
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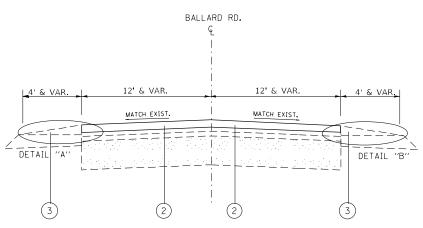
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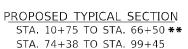
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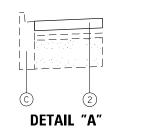







STA. 74+38 TO STA. 99+45




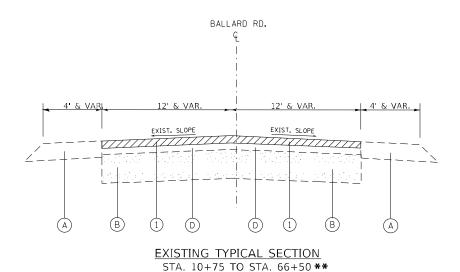

STA. 37+12 TO STA. 43+45

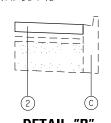

DETAIL "B" STA. 93+00 TO STA. 99+45

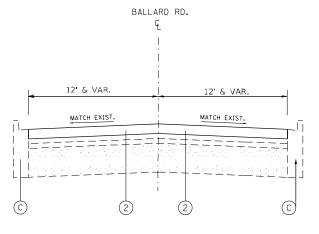

PROPOSED TYPICAL SECTION STA. 66+50 TO STA. 74+38 STA. 99+45 TO STA. 110+21

** PROJECT OMMISION

STA. 48+49 TO STA. 65+17

MIXTURE NOTES:

- 1. THE UNIT WEIGHT USED TO CALCULATE ALL HOT-MIX ASPHALT SURFACE MIXTURE IS 112 LBS/SQYD/IN.
- 2. THE "AC TYPE" FOR POLYMERIZED HMA MIXES SHALL BE "SBS/SBR PG 76 -22" AND FOR NON-POLYMERIZED HMA THE "AC TYPE" SHALL BE "PG 64 -22" UNLESS MODIFIED BY SPECIAL PROVISIONS. FOR USE OF RECYCLED MATERIALS SEE SPECIAL PROVISIONS.
- 3. QUALITY MANAGMENT PROGRAM (QMP) IDENTIFIES THE PARTICULAR QUALITY CONTROL SPECIFICATIONS THAT APPLIES TO THE HMA MIXTURE.

EXISTING LEGEND

- EXISTING AGGREGATE SHOULDER, TYPE B
- EXISTING PCC BASE COURSE, |9"
- EXISTING COMB. CURB & GUTTER, TYPE B-6.12
- EXISTING REMAINING HMA AFTER MILLING | 1"

PROPOSED LEGEND

- PROPOSED HMA SURFACE REMOVAL $1\frac{1}{2}$ "
- PROPOSED HMA SURFACE COURSE, IL-9.5, MIX "D", N70, $1\frac{1}{2}$ "
- PROPOSED AGGREGATE WEDGE SHOULDER, TYPE B

LONGITUDINAL JOINT SEALANT NOTE:

THE LONGITUDINAL JOINT SEALANT SHALL BE PLACED OVER THE MILLED SURFACE

HOT MIX ASPHALT MIXTURE REQUIREMENTS										
MIXTURE USES	AIR VOIDS	QMP TYPE								
SMART OVERLAY	HOT-MIX ASPHALT SURFACE COURSE, MIX "D", IL-9.5, N70, 1½"	4% @ 70 GYR.	QCP							
PATCHING	CLASS D PATCHES (HMA IL-19 mm)	4% @ 7 0 GYR.	QC/QA							
PATCHING	HMA REPLACEMENT OVER PATCHES (HMA BINDER IL-19 mm)	4% @ 7 0 GYR.	QC/QA							


PAY FOR PERFORMANCE (PFP)



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LOT SCALE = 10.0000 / in.	CHECKED - TN	REVISED -	
LOT DATE = 1/20/2021	DATE - 00/00/00	REVISED -	

STATE OF ILLINOIS **DEPARTMENT OF TRANSPORTATION**

	BALLARD RD. (RAND RD. TO GREENWOOD AVE.)	F.A.P RTE.	SECTION	COUNTY	TOTAL SHEETS	SHEE NO.
	TYPICAL SECTIONS	1319	1319 2020-140-RS&SW		49	7
	TIFICAL SECTIONS			CONTRACT	NO. 6	32M18
ı	SCALE: N/A SHEET NO. 1 OF 1 SHEETS STA. N/A TO STA. N/A	FED. R	OAD DIST. NO. 1 ILLINOIS FED. AL	D PROJECT		

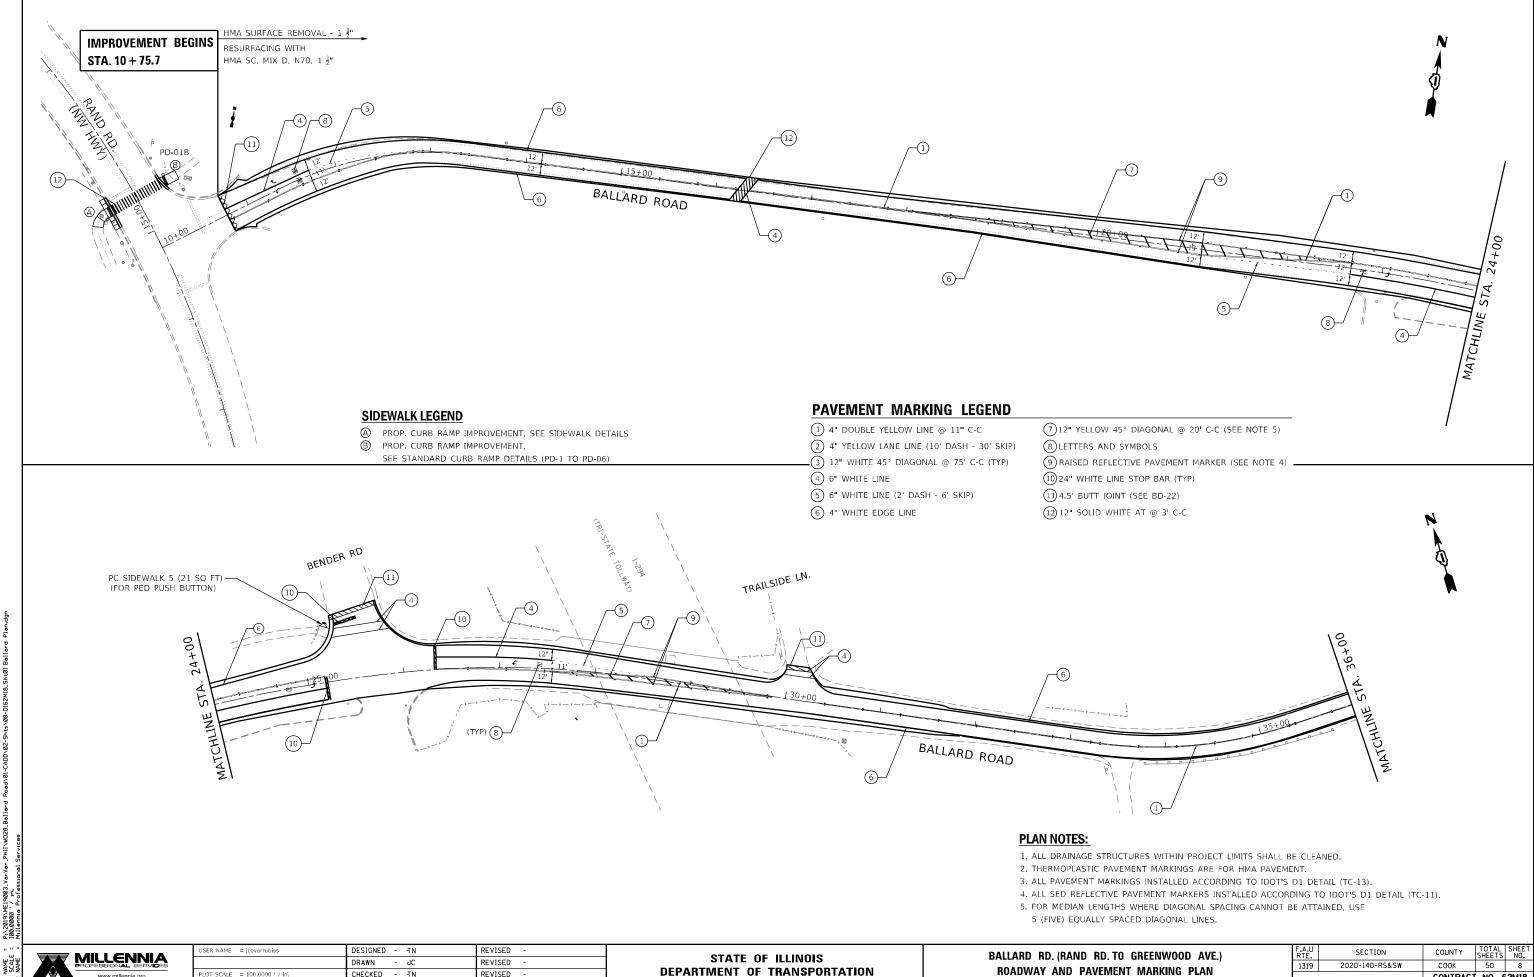


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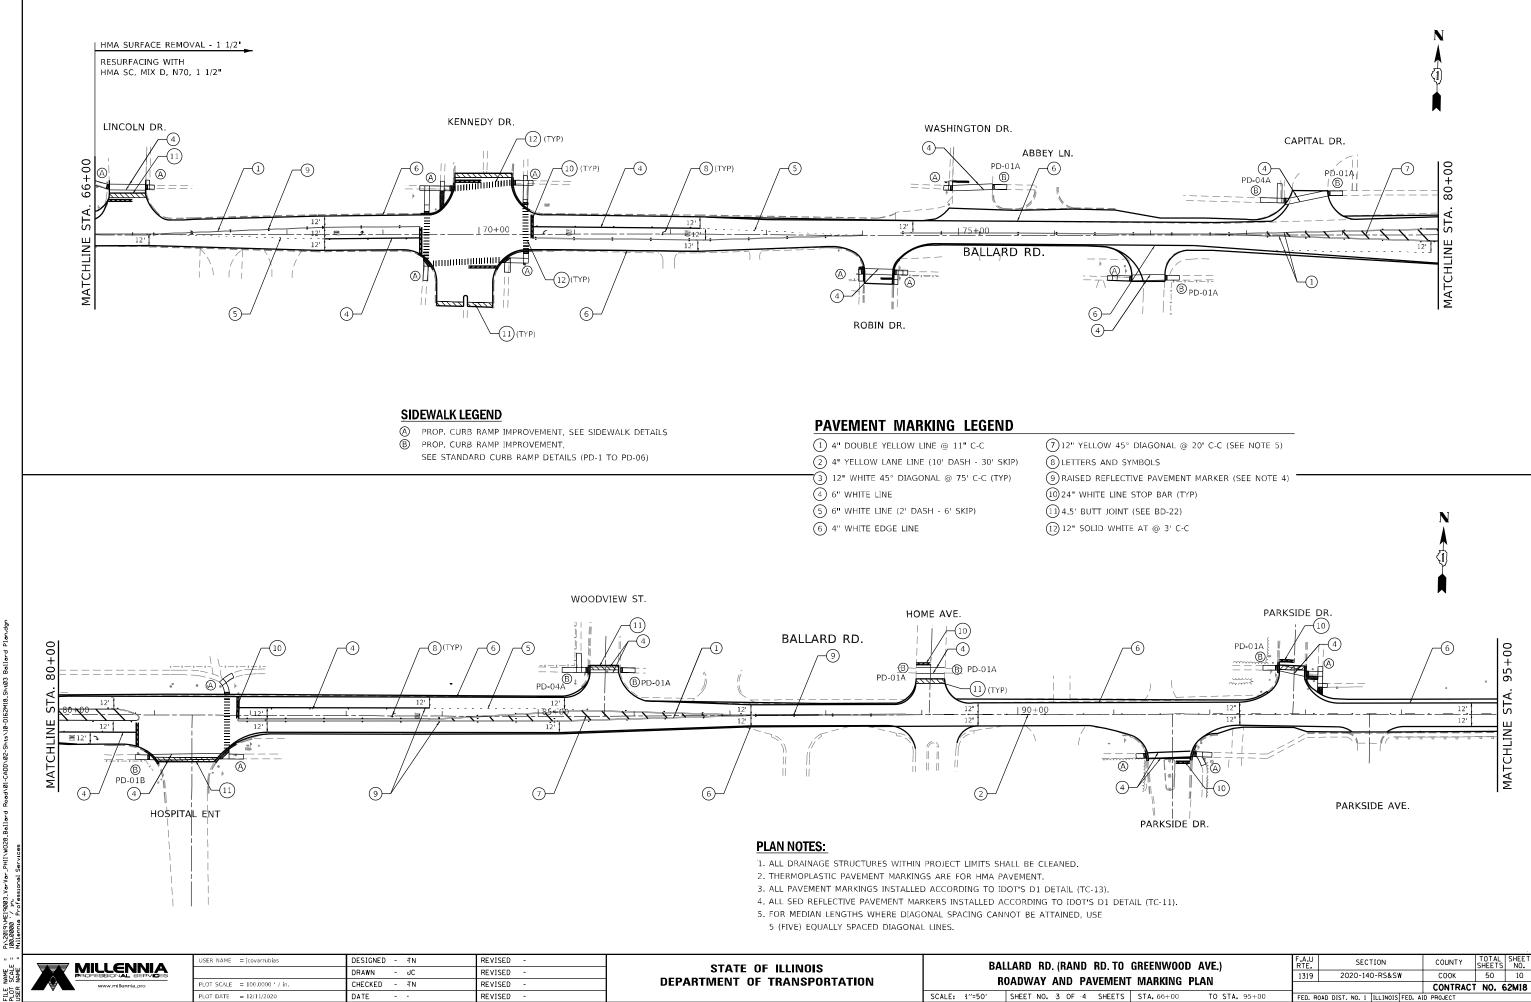
DEPARTMENT OF TRANSPORTATION


ROADWAY AND PAVEMENT MARKING PLAN

CONTRACT NO. 62M18

SCALE: 1"=50' SHEET NO. 1 OF 4 SHEETS STA. XX+XXX TO STA. 36+00 FED. ROAD DIST. NO. 1 | ILLINOIS|FED. AID PROJECT
P1.2019\ME1903.VarVar_PHI\\V028.Bellard Road\01-cADD\02-Shts\08-D162M18.Sht8'



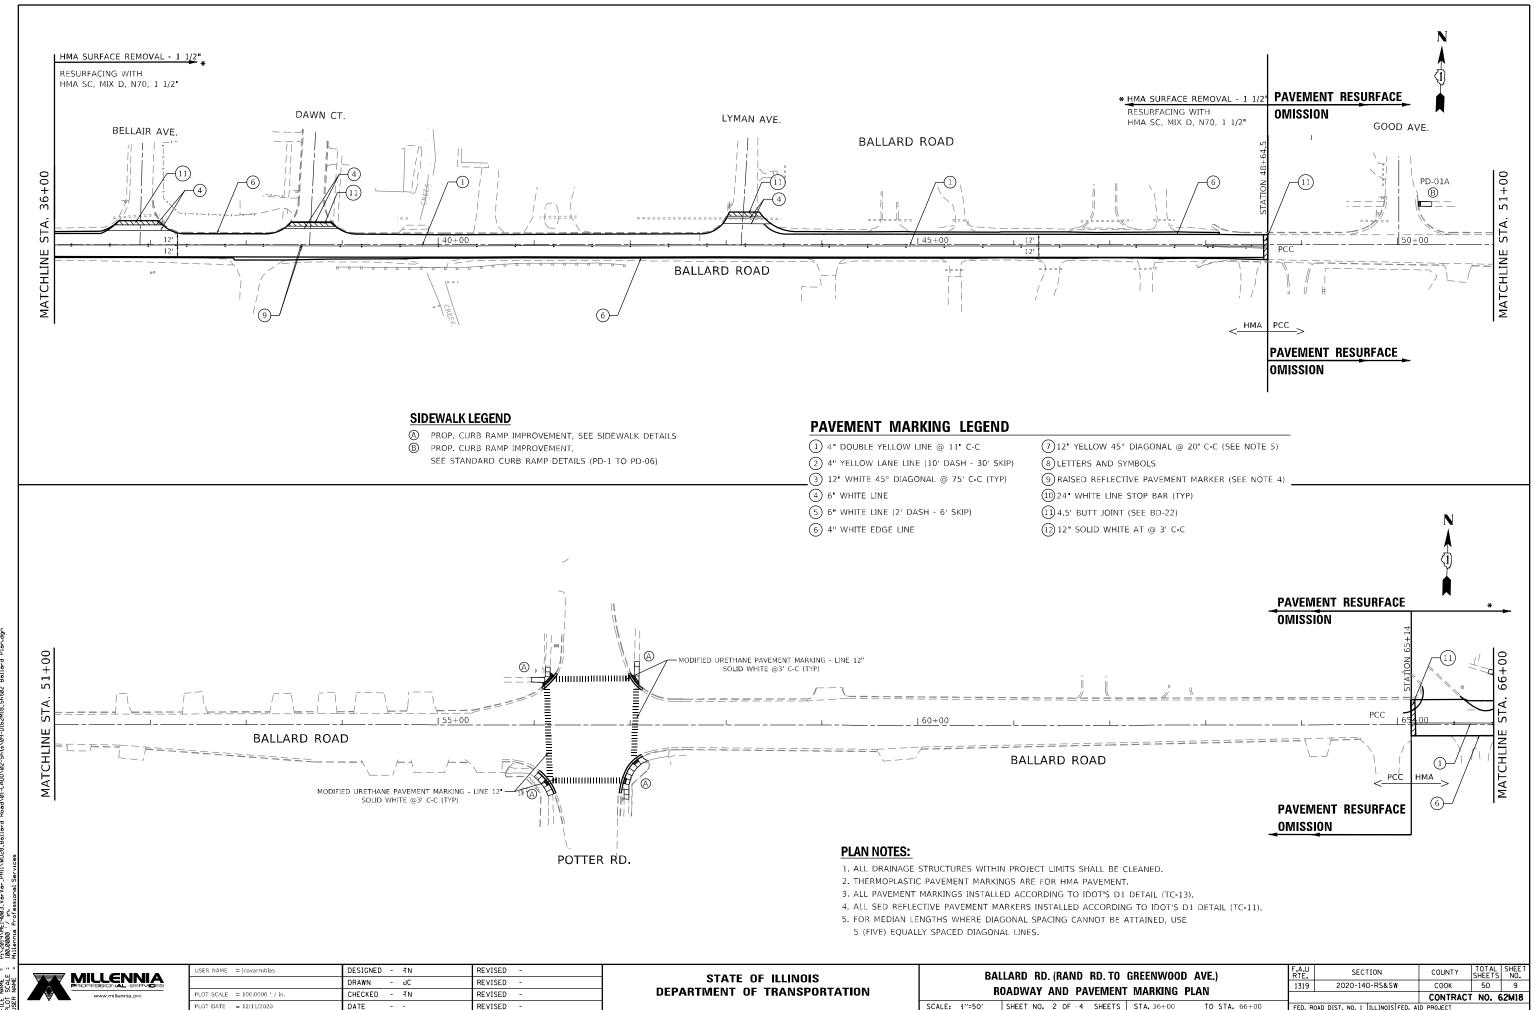

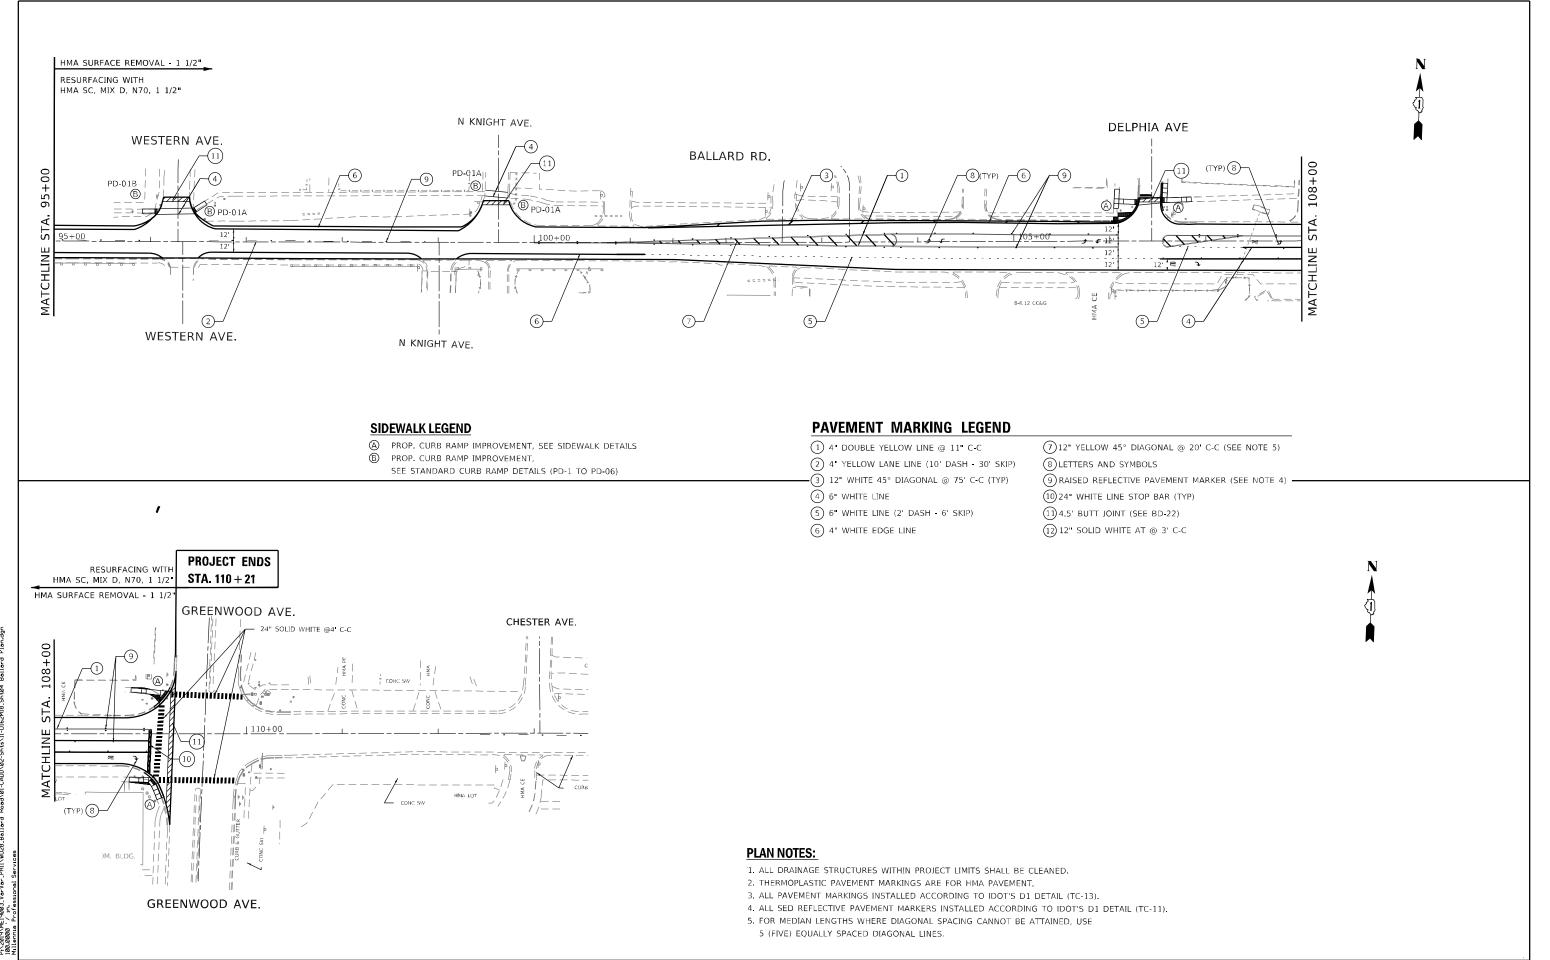

PACFESSIONAL SERVICES
www.millennis.pro

 USER NAME
 = jcovarrubias
 DESIGNED
 TN
 REVISED

 DRAWN
 JC
 REVISED

 PLOT SCALE
 = 100,0000 ' / in.
 CHECKED
 TN
 REVISED

 PLOT DATE
 = 12/11/2020
 DATE
 REVISED

STATE OF ILLINOIS
DEPARTMENT OF TRANSPORTATION

 BALLARD
 RD. (RAND
 RD. TO
 GREENWOOD
 AVE.)

 MAINTENANCE OF TRAFFIC

 SCALE:
 1"=50"
 SHEET NO. 4 OF 14 SHEETS
 SHEETS STA. 95+00
 TO STA

SCHEDULE OF QUANTITIES

	LOCATION			20200100	21101615	25200110	25200200	42001300	42400200	42400800	44000600	60300305	85000200	89502376	X0327998	X2600011	X4400221	Z0004562
SHEET NO.	BALLARD RD AT	CORNER	ADA DETAIL	EARTH	TOPSOIL F & P 4	SODDING SALT TOLERANT	SUPPLE WATERING	PROTECTIVE COAT	PC CONC SIDEWALK 5	DETECTABLE WARNINGS	SIDEWALK REM	FR & LIDS ADJUST	MAIN EX TR SIG INSTAL	REBUILD EX HANDHOLE	BOLLARD TO BE RELOCAT	REM & REL SIGN PANEL	COMB CC&G REM & REP <= 10	COMB CC&G REM & REP
	2511252.22			CU YD	SQ YD	SQ YD	UNIT	SQ YD	SQ FT	SQ FT	SQ FT	EACH	EACH	EACH	EACH	EACH	FOOT	FOOT
151.01	BENDER RD	NW		1	3	3	0.02	3	21		055							
ADA-01	RAND RD	NW	55.045	4	10	10	0.08	39	347	20	355	1	1	1	1			35
ADA-01	RAND RD	NE	PD-01B	2	4	4	0.03	12	105	20	105						- 10	20
151.00	GOOD AVE	NE	PD-01A	1	7	7	0.06	10	90	10	90						10	
ADA-02	POTTER RD	NW		2	8	8	0.06	18	157	20	176							22
ADA-02	POTTER RD	NE		2	8	8	0.06	13	113	20	113							22
ADA-03	POTTER RD	SW		2	4	4	0.03	18	161	11	161	-	1	1	-			29
ADA-03	POTTER RD	SE		3	8	8	0.06	33	290	23	290							46
ADA-04	LINCOLN DR	NW		2	<i>'</i>	7	0.06	12	104	10	78							
ADA-04	LINCOLN DR	NE NE		1	3	3	0.02	8	65	10	53							
ADA-05	KENNEDY DR	NW		4	26	26	0.21	35	309	20	214							54
ADA-05	KENNEDY DR	NE		3	14	14	0.11	26	234	20	192							41
ADA-06	DEE RD	SW		2	8	8	0.06	12	108	19	88							23
ADA-06	DEE RD	SE		3	18	18	0.14	25	220	25	64				-			45
ADA-07	ROBIN DR	SW		1	4	4	0.03	7	62	10	59							15
ADA-07	ROBIN DR	SE		2	7	7	0.06	13	110	10	96							27
ADA-08	WASHINGTON DR	NW		1	3	3	0.02	8	65	10	51					1	ļ	
	WASHINGTON DR	NE	PD-01A	1	7	7	0.06	10	90	10	90							
ADA-09	UNNAMED ROAD	SW	DD 011	2	9	9	0.07	16	138	10	96							
ADA-09	UNNAMED ROAD	SE	PD-01A	1	7	7	0.06	10	90	10	90							\perp
	CAPITAL DR	NW	PD-04A	3	17	17	0.14	25	217	10	217							\perp
ADA 40	CAPITAL DR	NE	PD-01A	1	,	,	0.06	10	90	10	90							
ADA-10	HOSPITAL ENTRANCE	SW	PD-01B	2	8	8	0.06	12	105	10	73							20
ADA-10	HOSPITAL ENTRANCE	SE		2	10	10	0.08	15	132	26	132							29
ADA-10	HOSPITAL ENTRANCE	NE NVA	DD 044	2	8	8	0.06	15	132	10	132						10	
ADA-11	WOODVIEW LN WOODVIEW LN	NW	PD-04A	3	17	17	0.14	25	217	10	54						10	-
ADA-11	HOME AVE	NE NVA/	PD-01A PD-01A	1	7	7	0.06 0.06	10 10	90 90	10 10	90 90							-
		NW		1	7	7												
ADA 12	HOME AVE	NE SW	PD-01A	1	,		0.06	10	90	10	90						10	-
ADA 12	PARKSIDE DR	SE		1	9	9	0.03	6	52	10	52 147						10	14
ADA-12 ADA-13	PARKSIDE DR		PD-01A	2	7	7	0.07 0.06	17	147	10								16
ADA-13 ADA-13	PARKSIDE AVE PARKSIDE AVE	NW NE	PD-UIA	2	17	17	0.06	10 21	90 187	10 10	61 223							14
ADA-13 ADA-14	WESTERN AVE	NW	PD-01B	2	8	8	0.14	12	105	10	52							14
ADA-14 ADA-14	WESTERN AVE	NE	PD-01B PD-01A	1	7	7	0.06	10	90	10	47				†			\vdash
ADA-14	N. KNIGHT AVE	NW	PD-01A PD-01A	1	7	7	0.06	10	90	10	90							
	N. KNIGHT AVE	NE	PD-01A PD-01A	1	7	7	0.06	10	90	10	90							+
ADA-15	DELPHIA ST	NW	ΓD-UIA	2	23	23	0.06	22	197		170				-			42
ADA-15 ADA-15	DELPHIA ST	NE NE		3	13	13	0.18	25	225	10	225	1						29
ADA-15 ADA-16	GREENWOOD RD	NW		2	16	16	0.10		200	10 24	178							29
ADA-16 ADA-16	GREENWOOD RD	SW		3	13	13	0.13	23 25	200	14	209	1			-			33
VDV-10		344										'						
	TOTAL			77	384	384	4	651	5732	532	4973	3	2	2	1	1	30	599


STATE OF ILLINOIS
DEPARTMENT OF TRANSPORTATION

BALLARD RD. (RAND RD. TO GREENWOOD AVE.)

SIDEWALK RAMP SCHEDULE OF QUANTITIES

| SHEET NO. OF SHEETS | STA. TO STA.

2019\ME19003_VarVar_PHII\W028_Ballard Road\01-CADD\02-Shts\12-D162M18_sht_ADA-00 Schedule

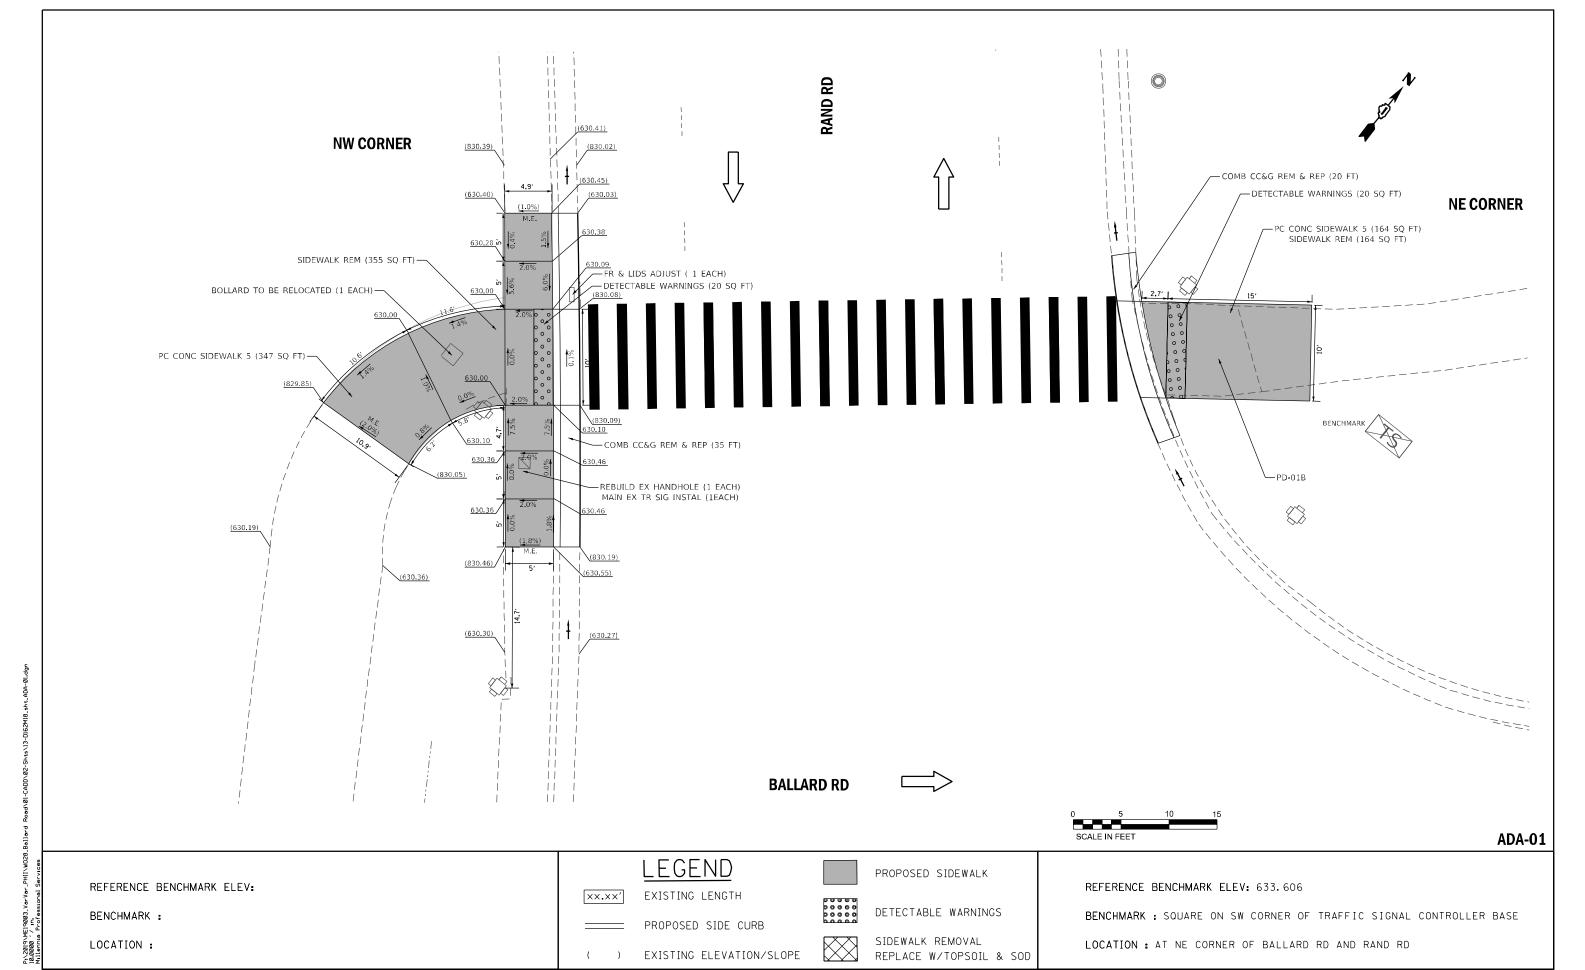



MILLENNIA PROFESSIONAL SERVICES www.mpa-il.com


STATE OF ILLINOIS DEPARTMENT OF TRANSPORTATION SIDEWALK DETAIL PLAN
BALLARD RD AT RAND RD


SHEET NO. OF SHEETS STA.

P:\2019\ME19003_VarVar_PHII\W028_Ballard Road\01-CADD\02-Shts\13-D162M18_sht_ADA-01.

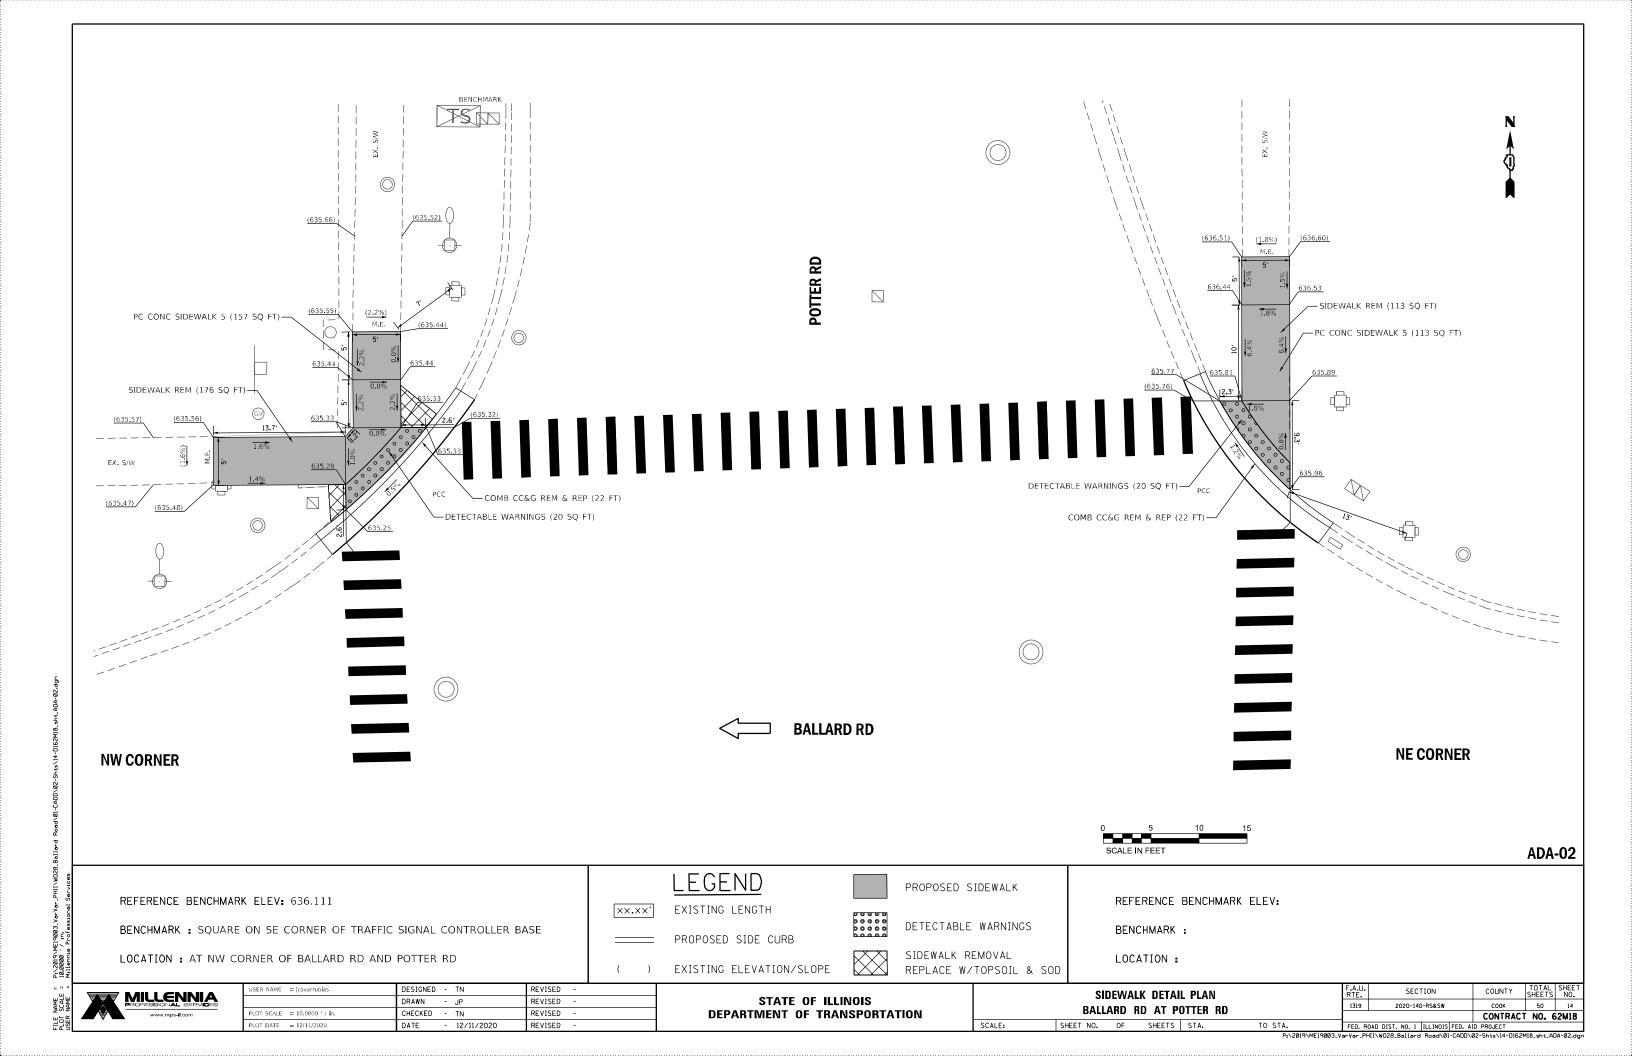

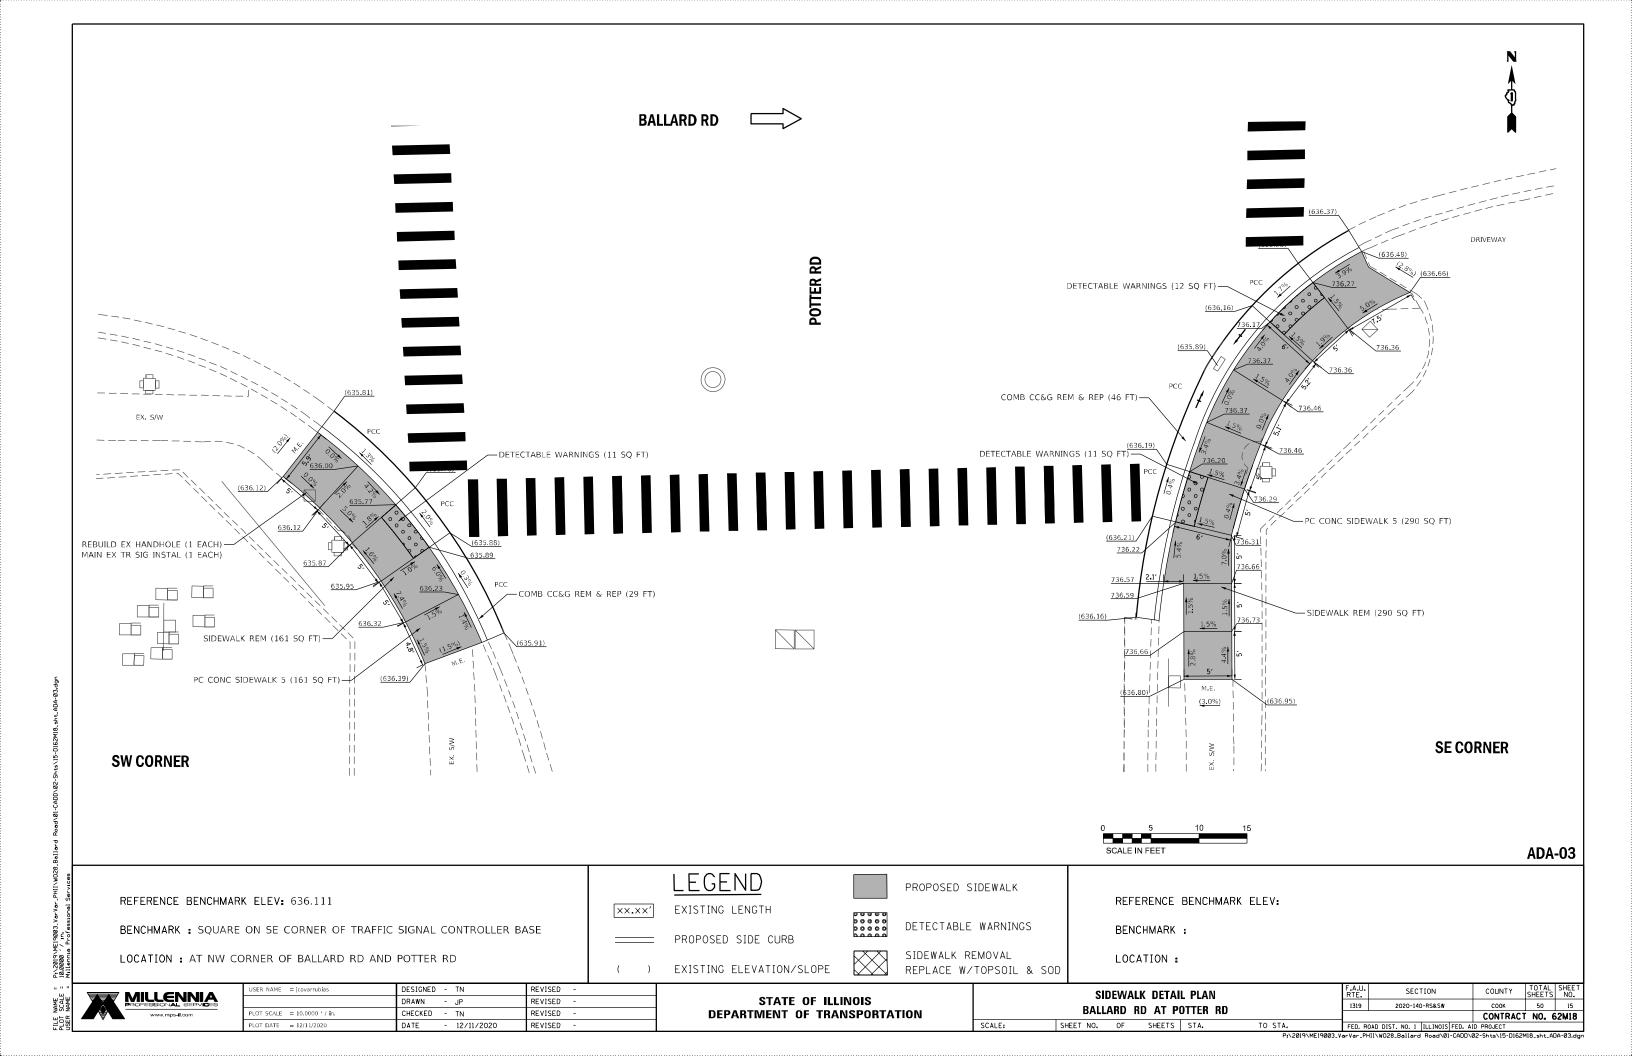

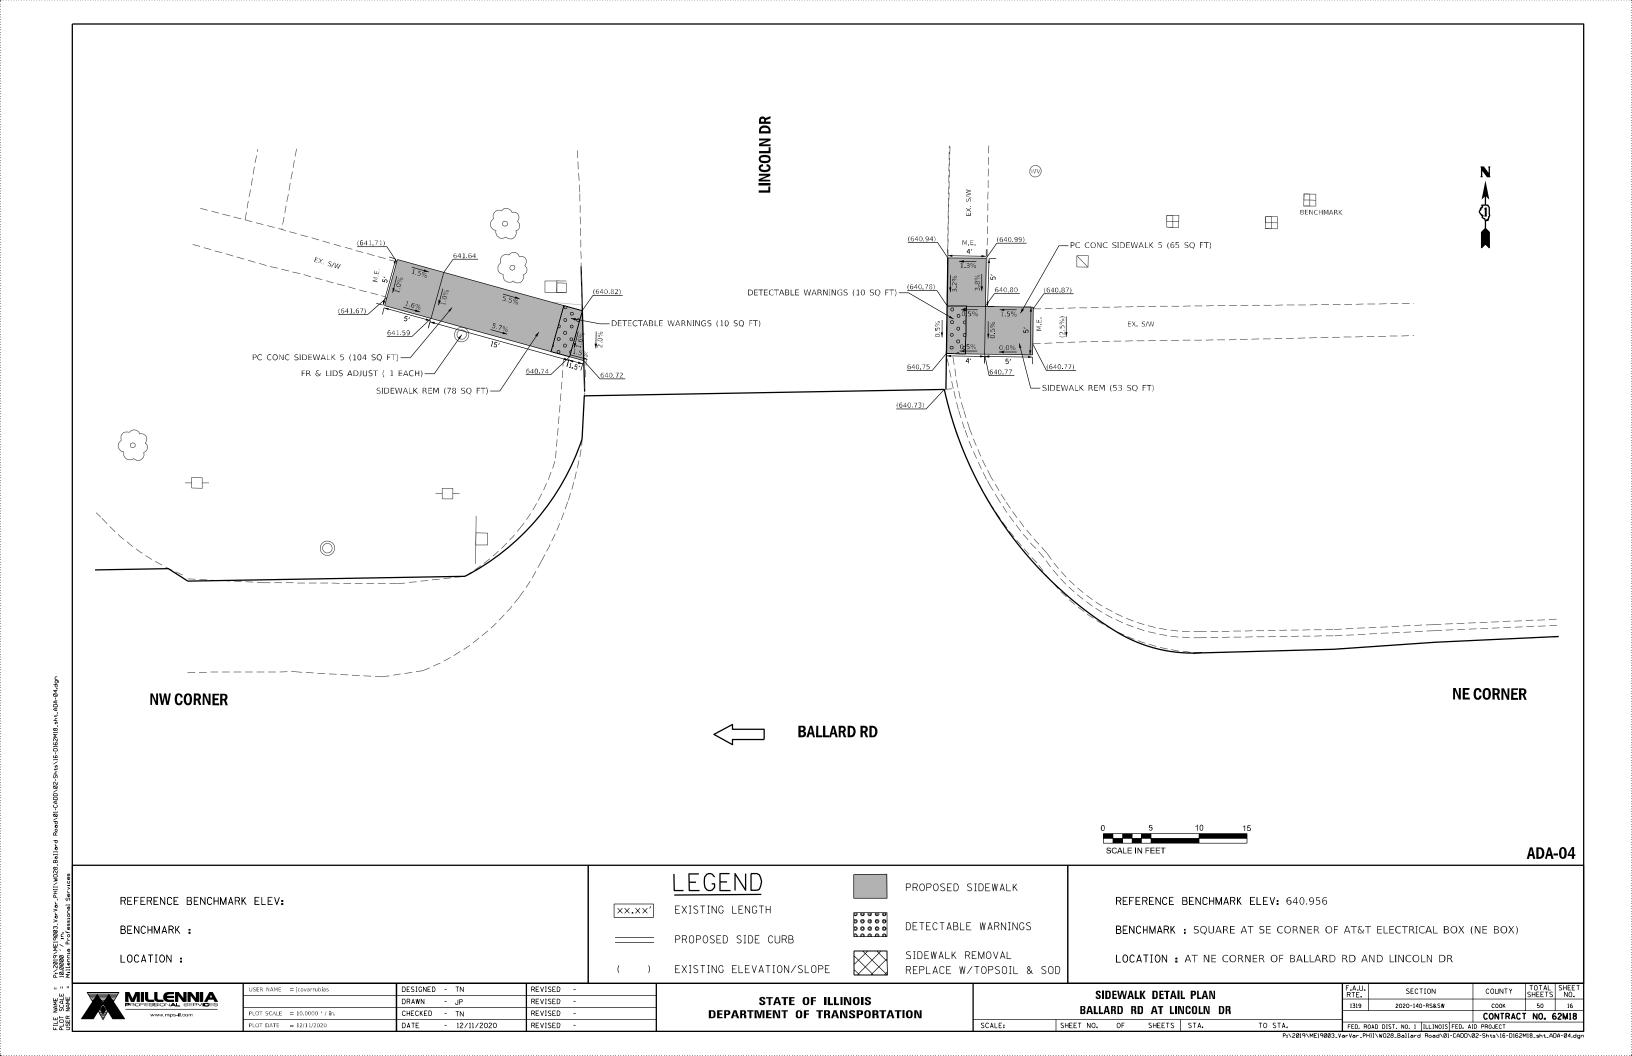


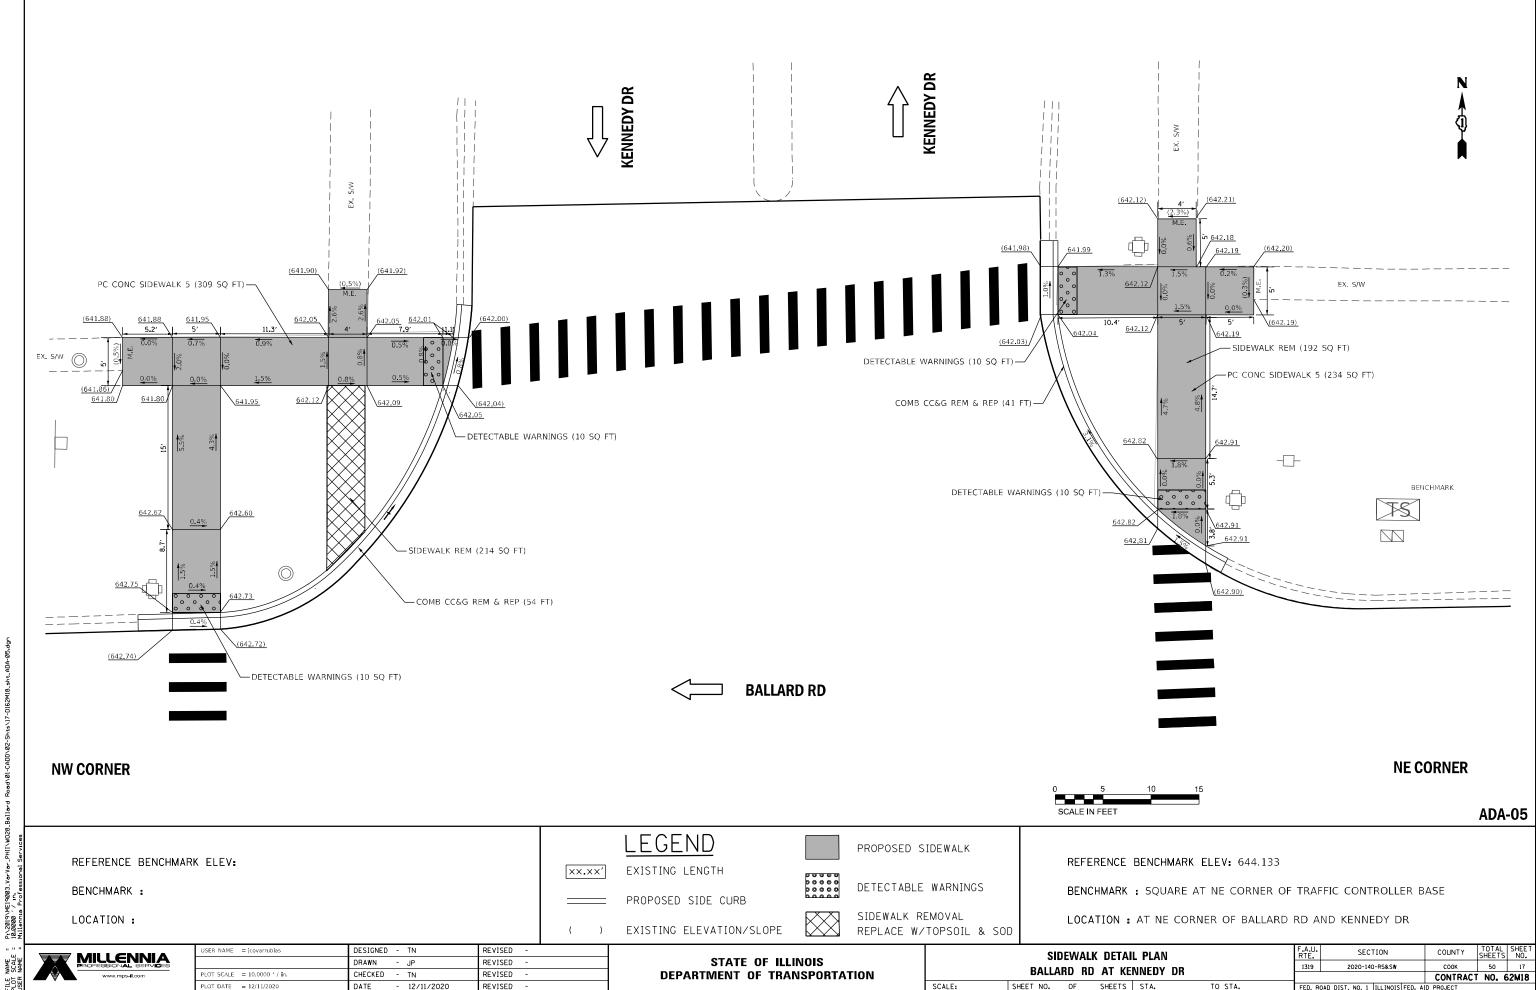



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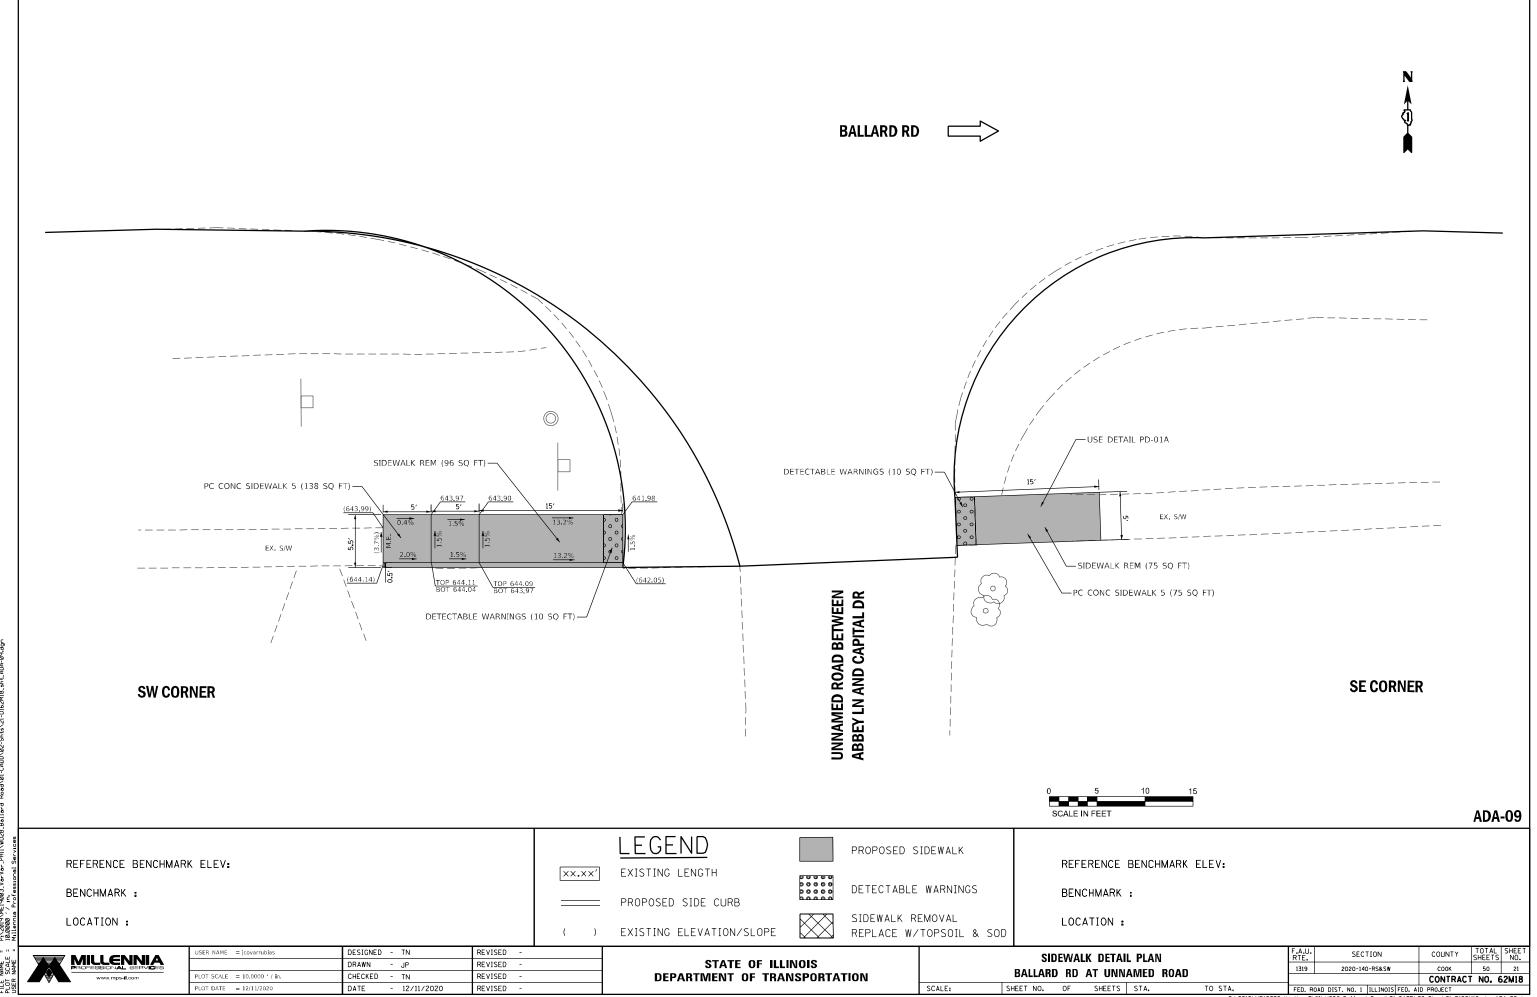
- 12/11/2020


REVISED




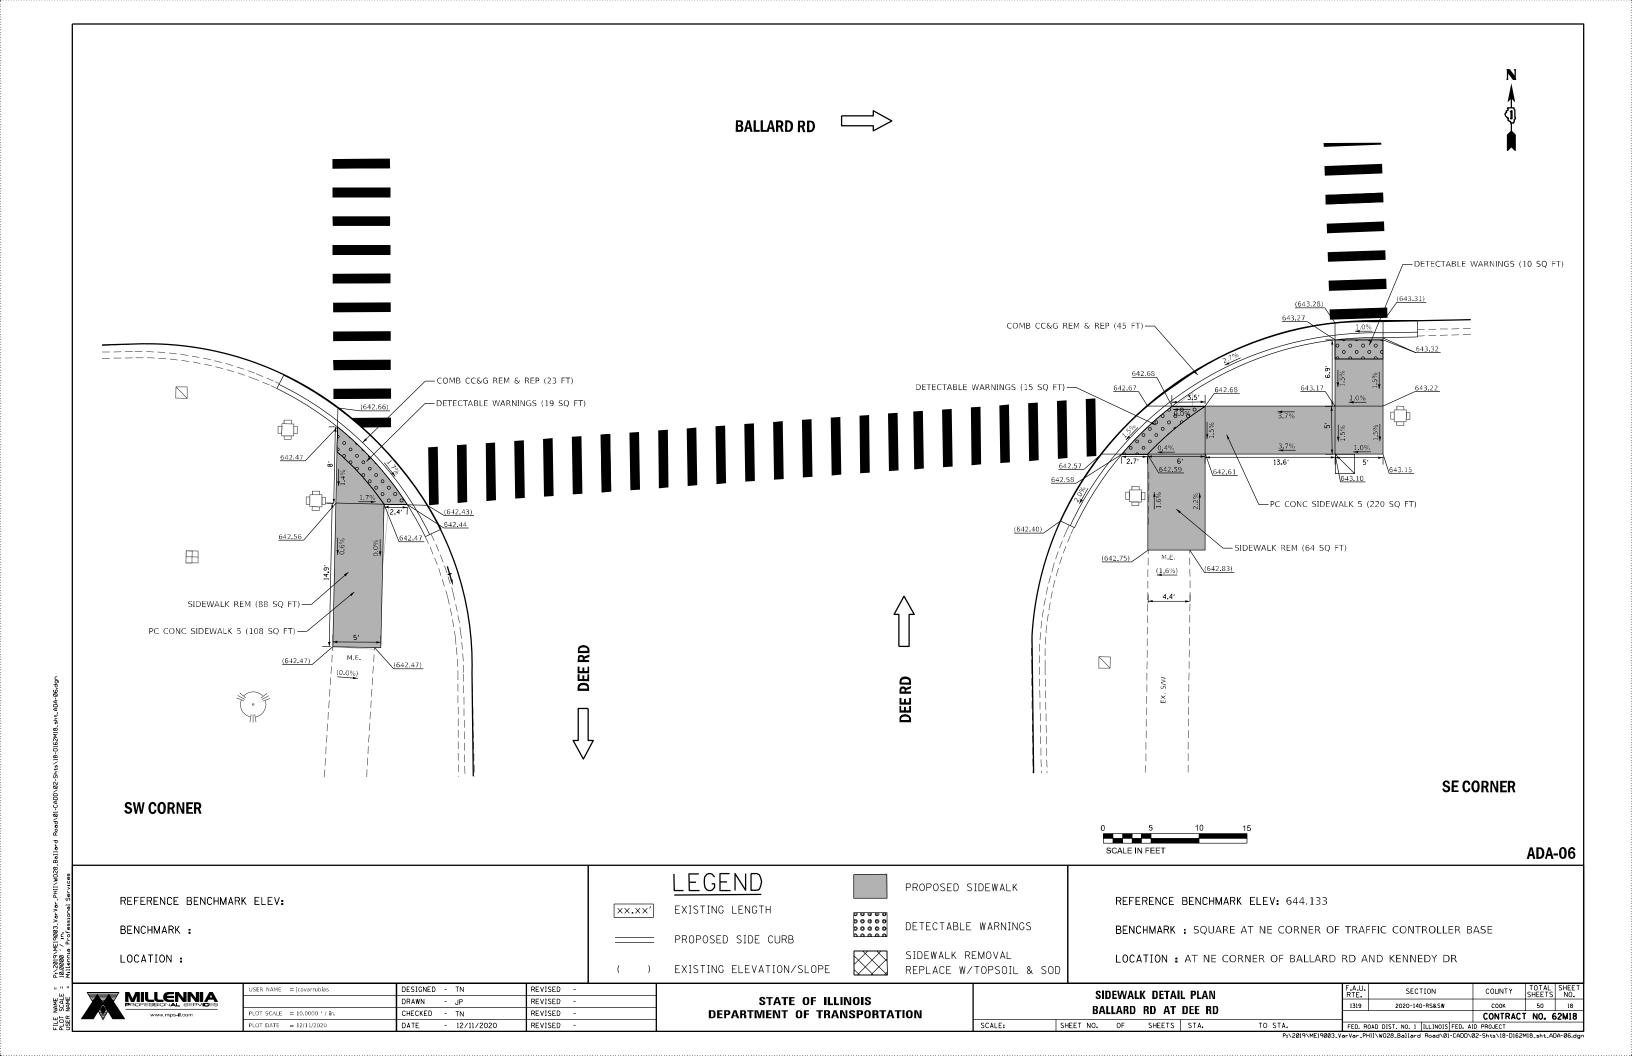


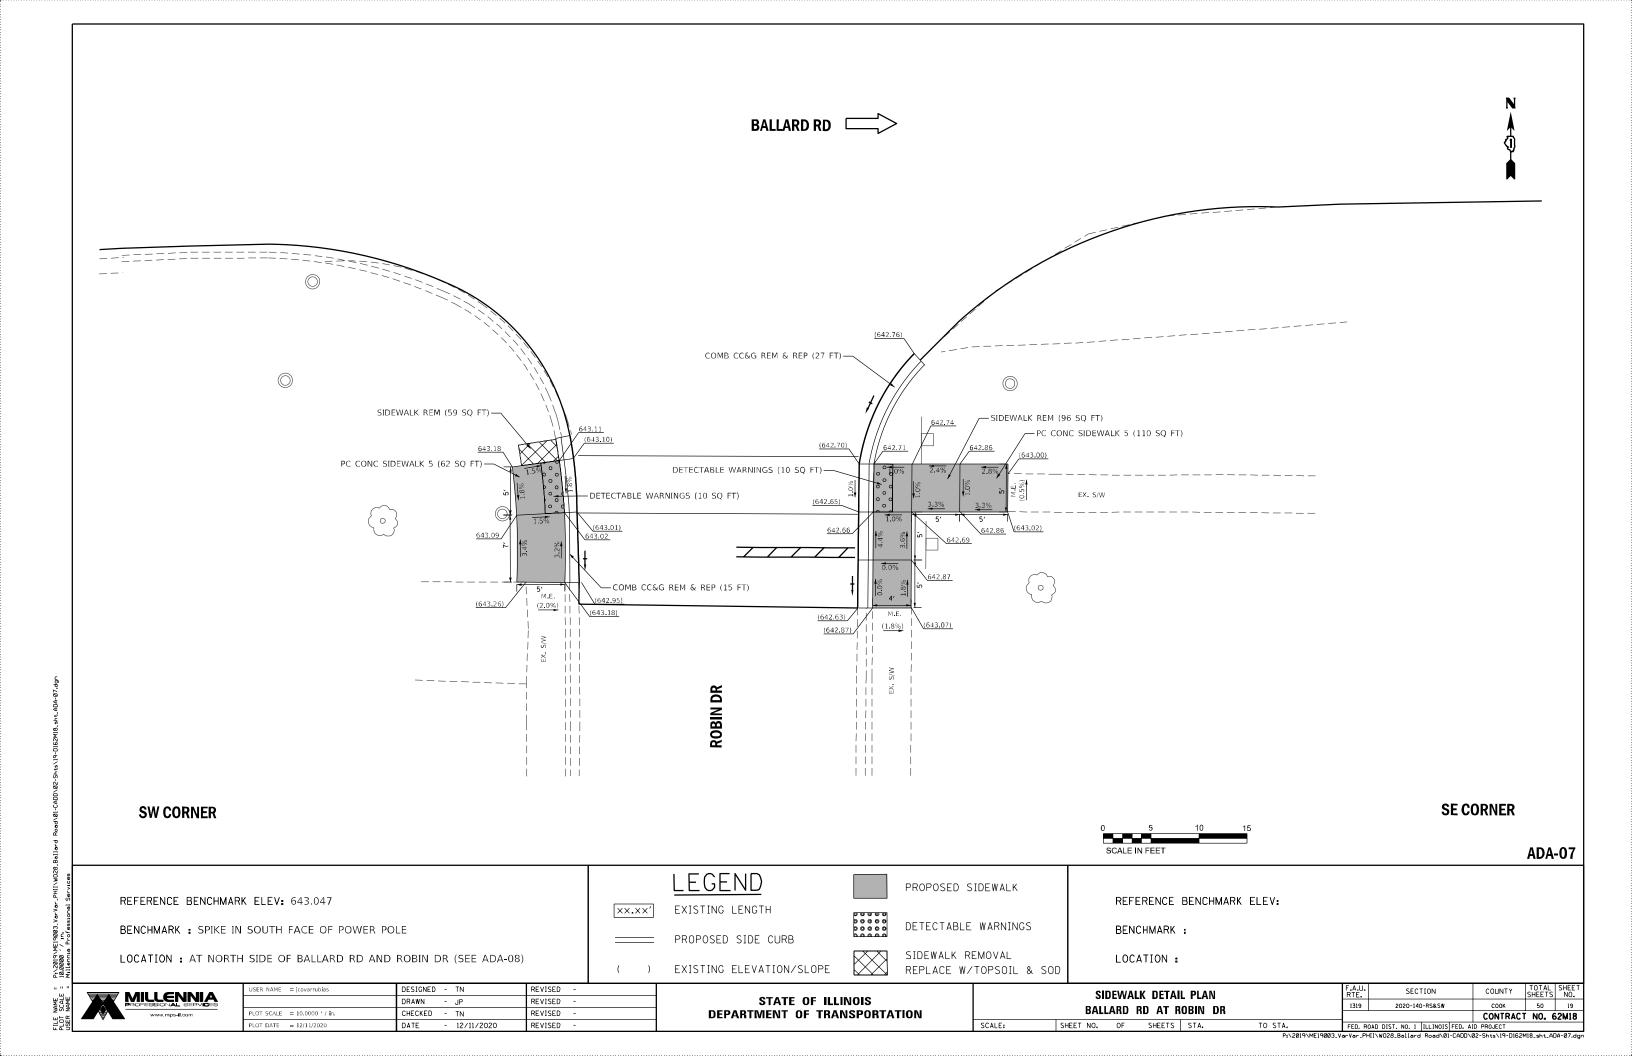


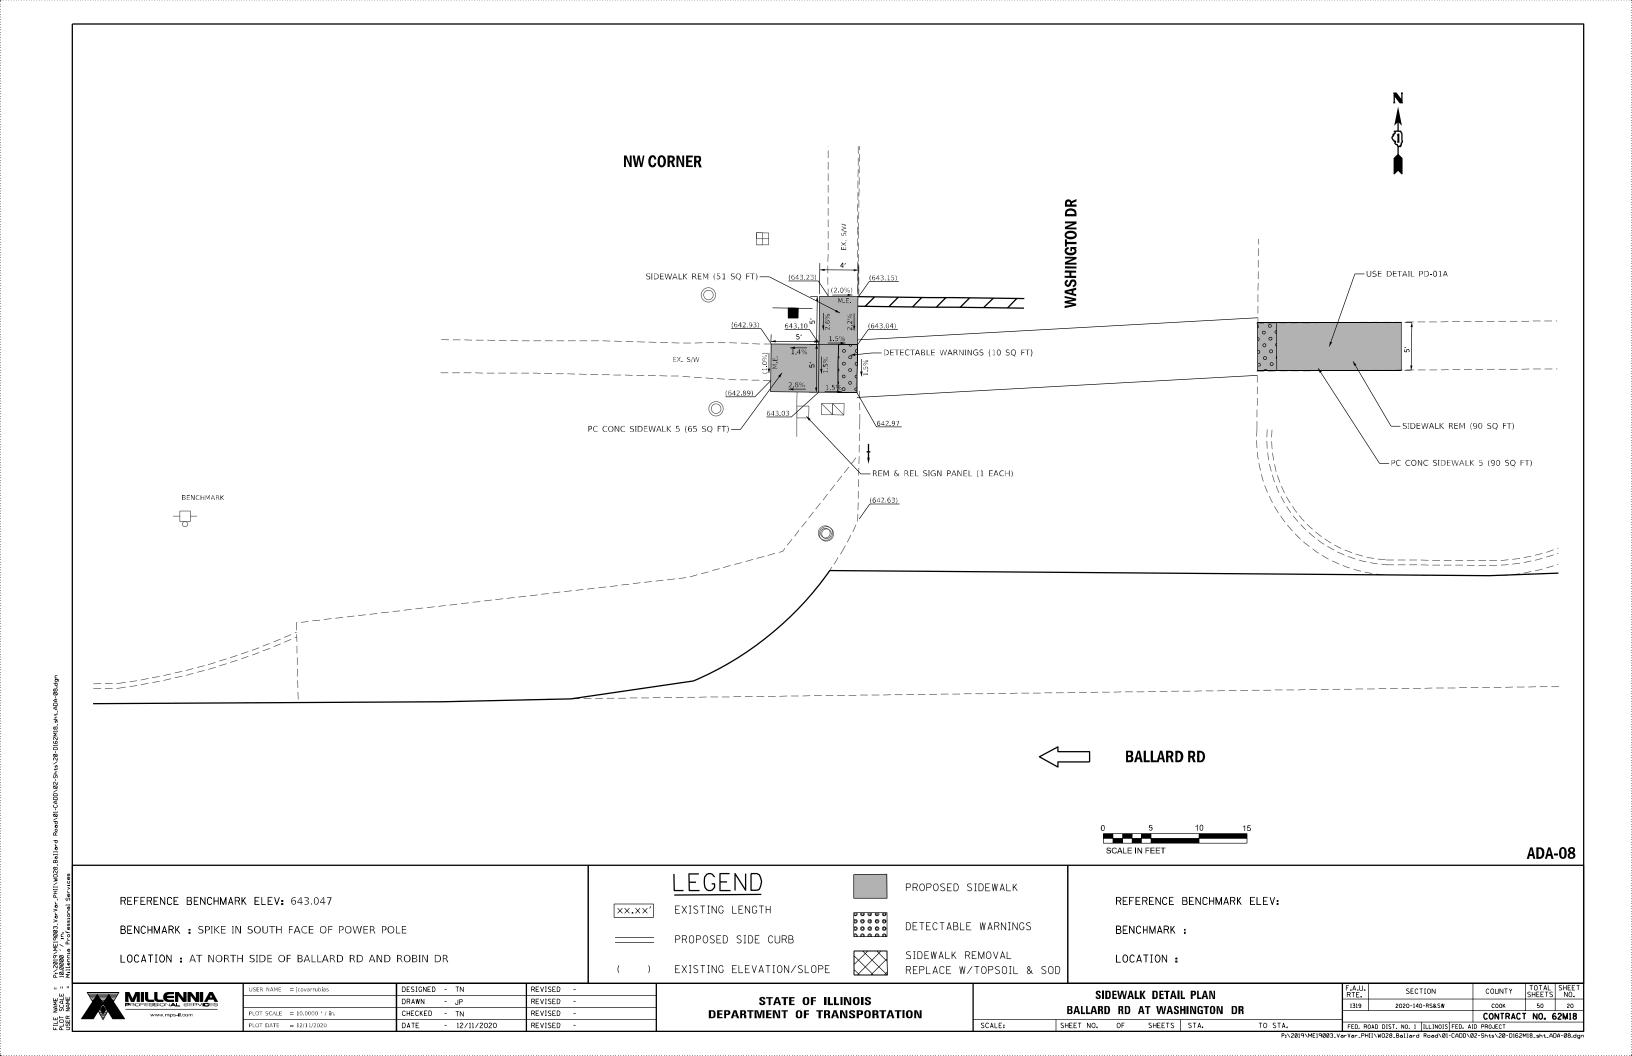


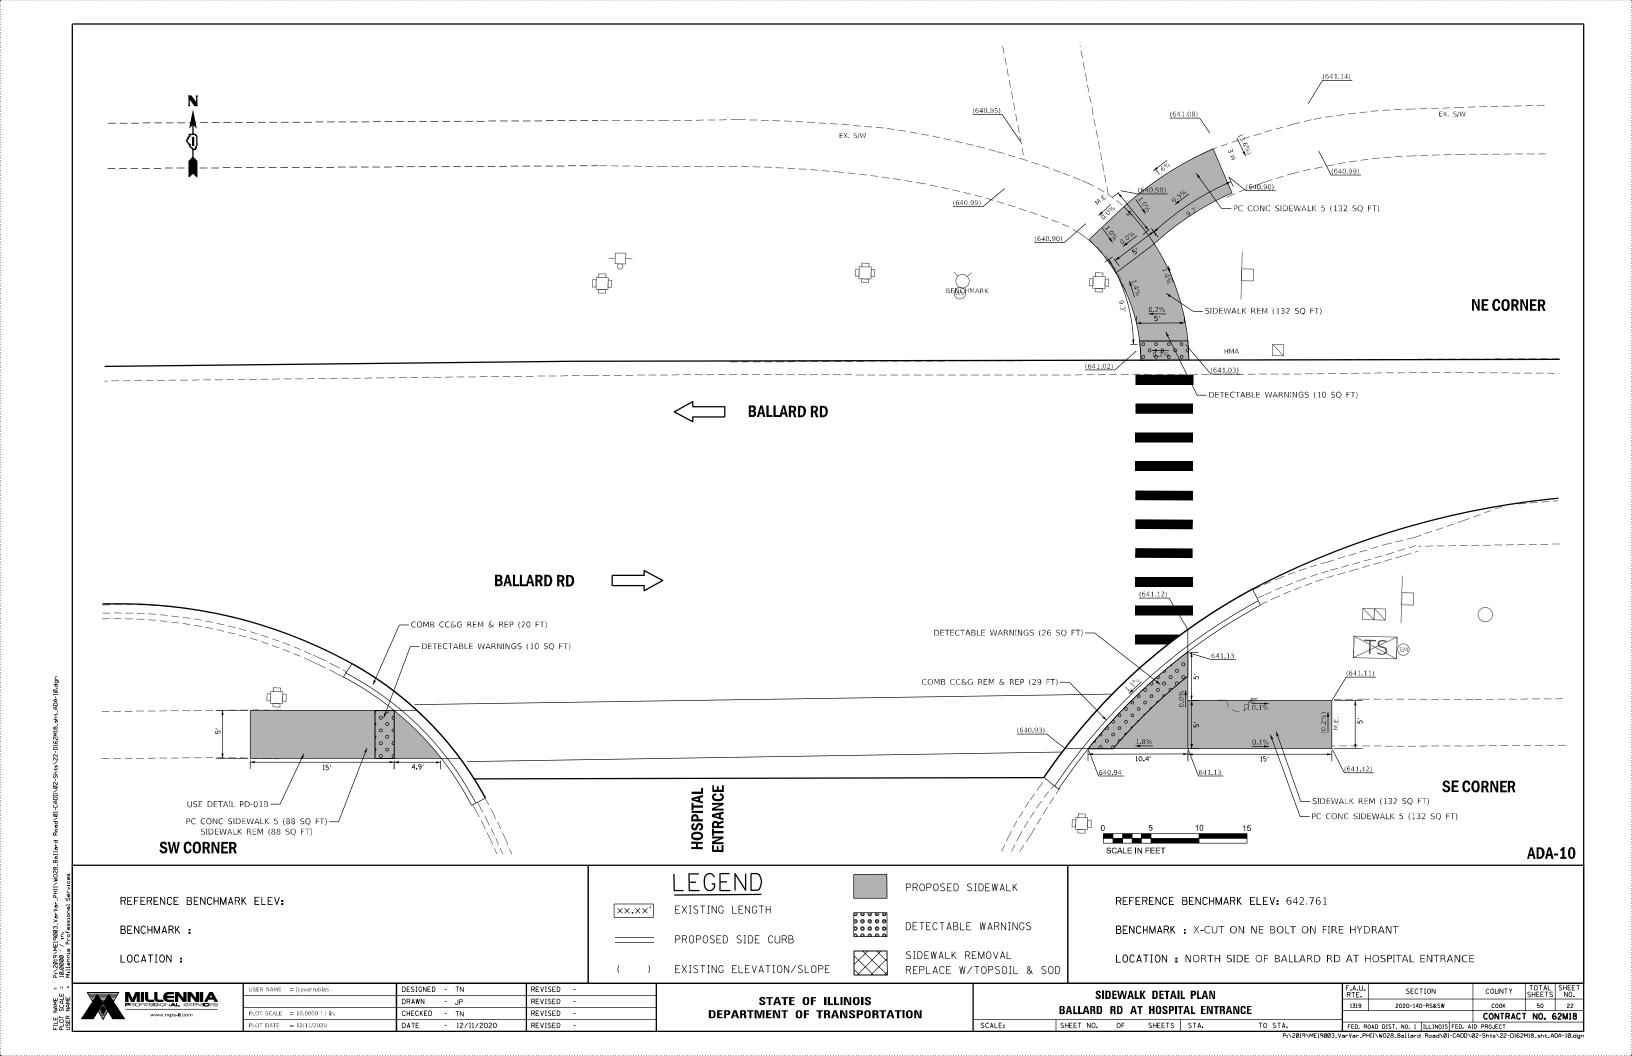

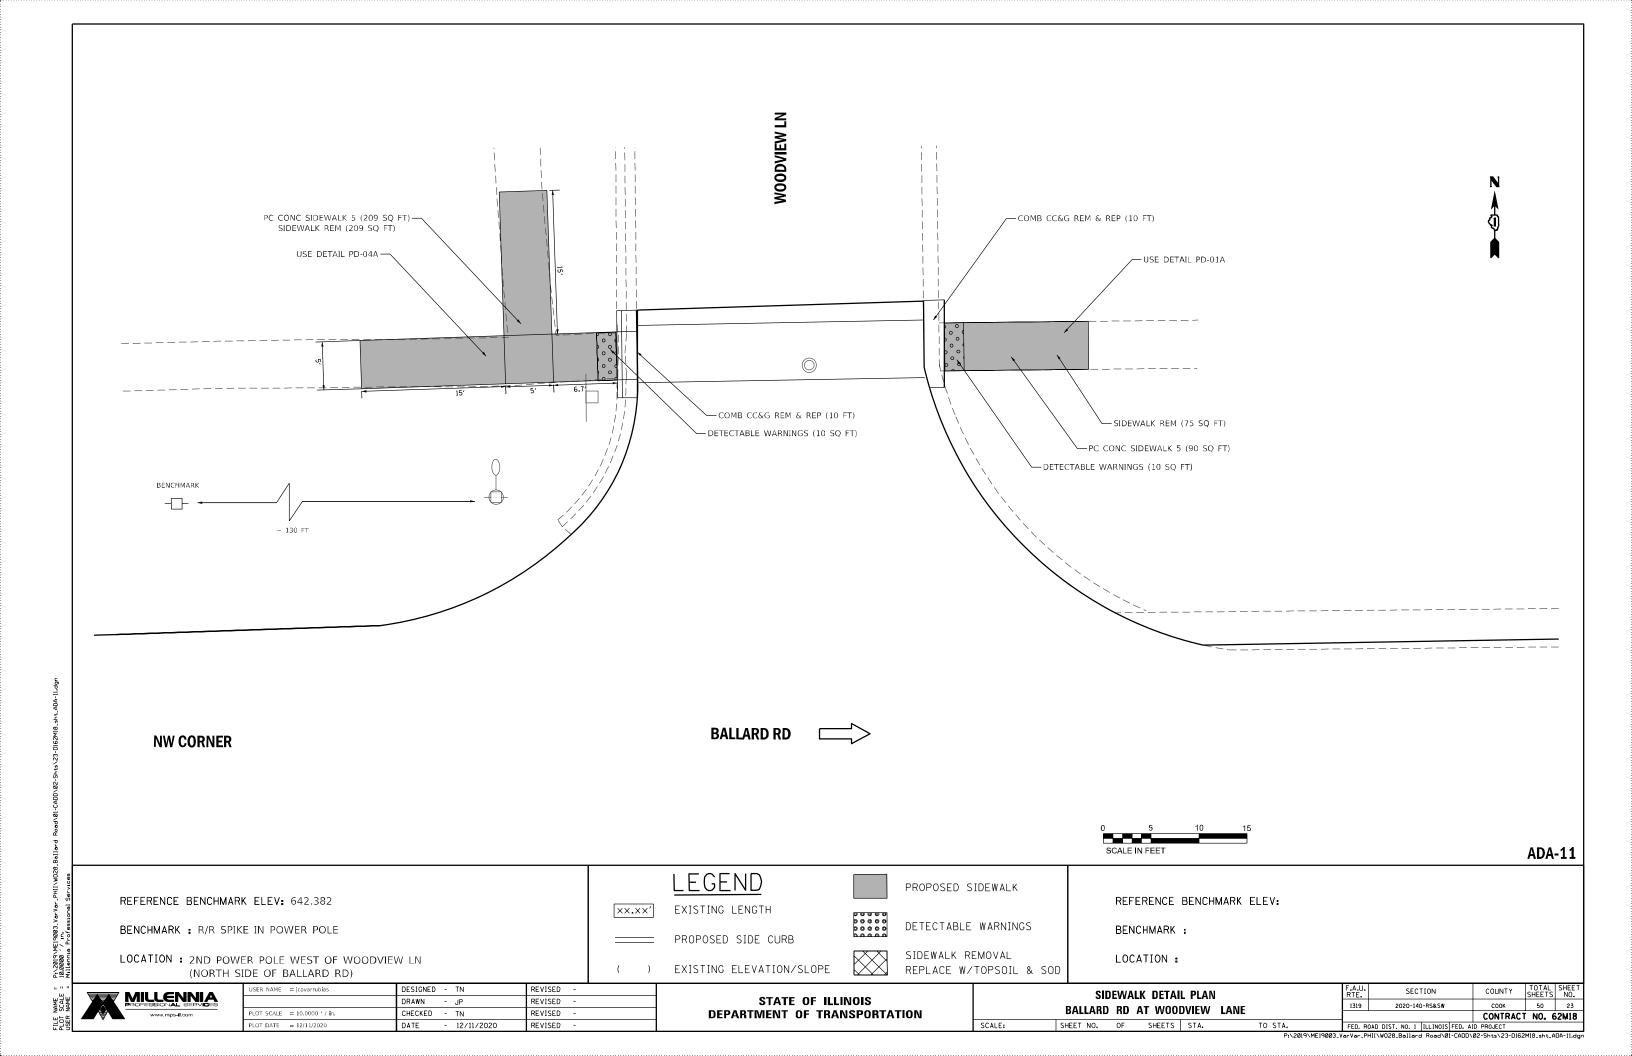

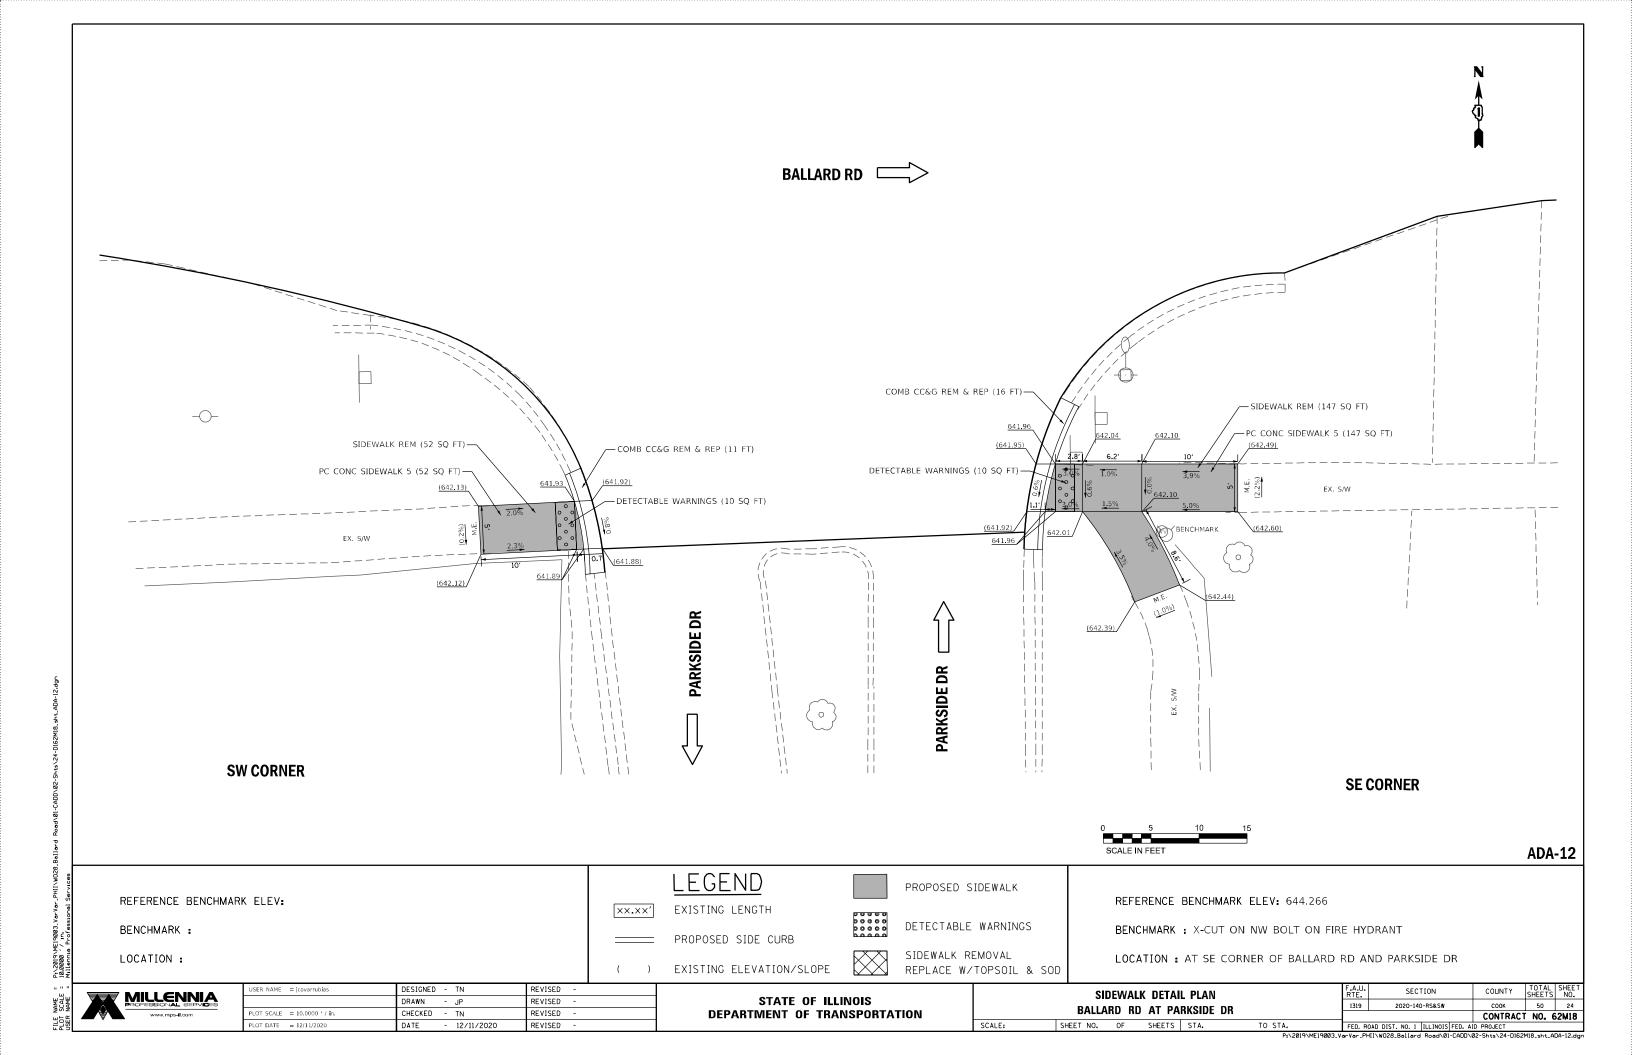

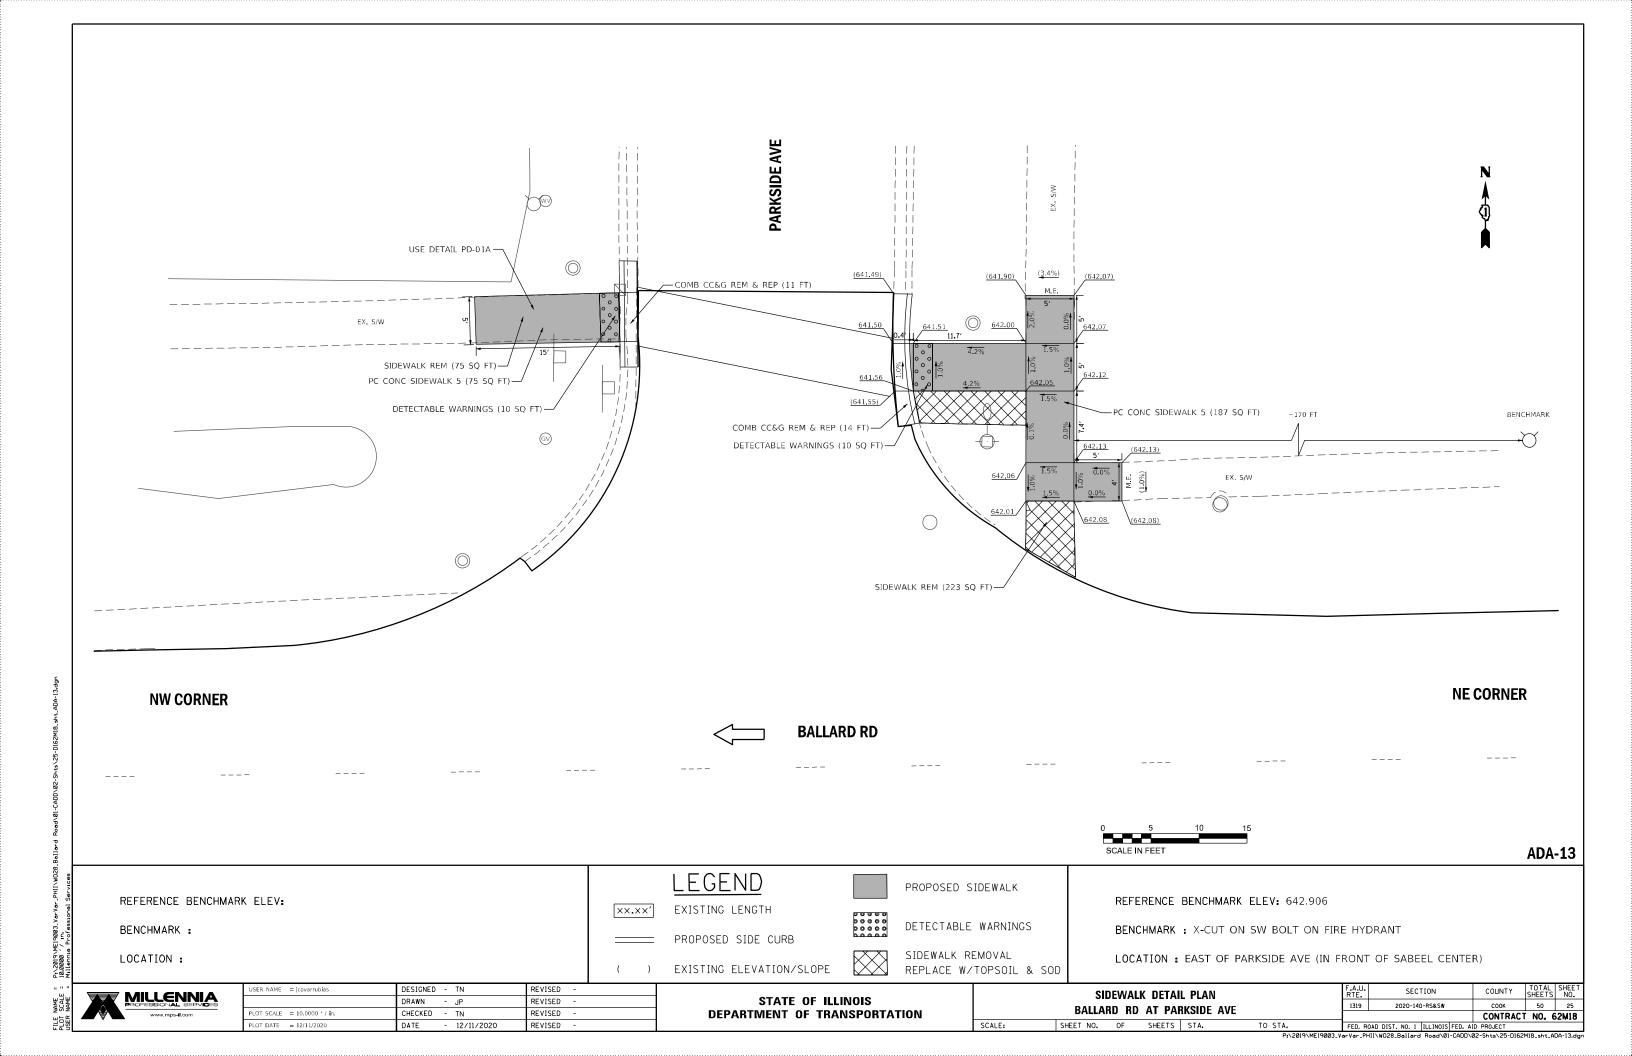


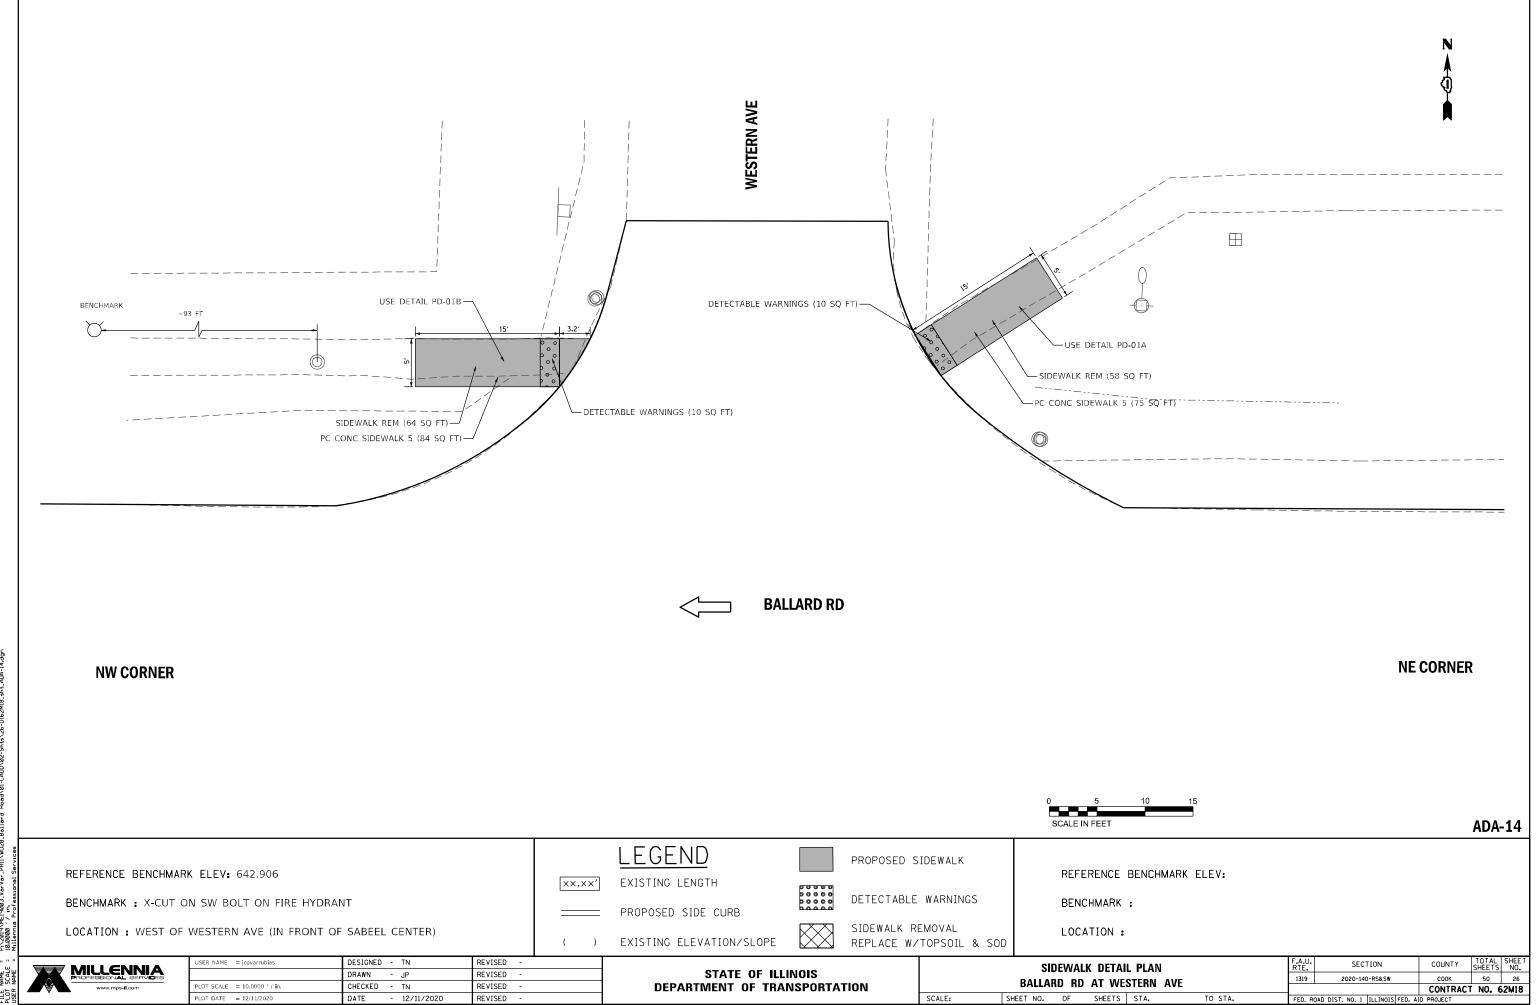

SHEET NO. OF SHEETS STA.

DATE - 12/11/2020

REVISED

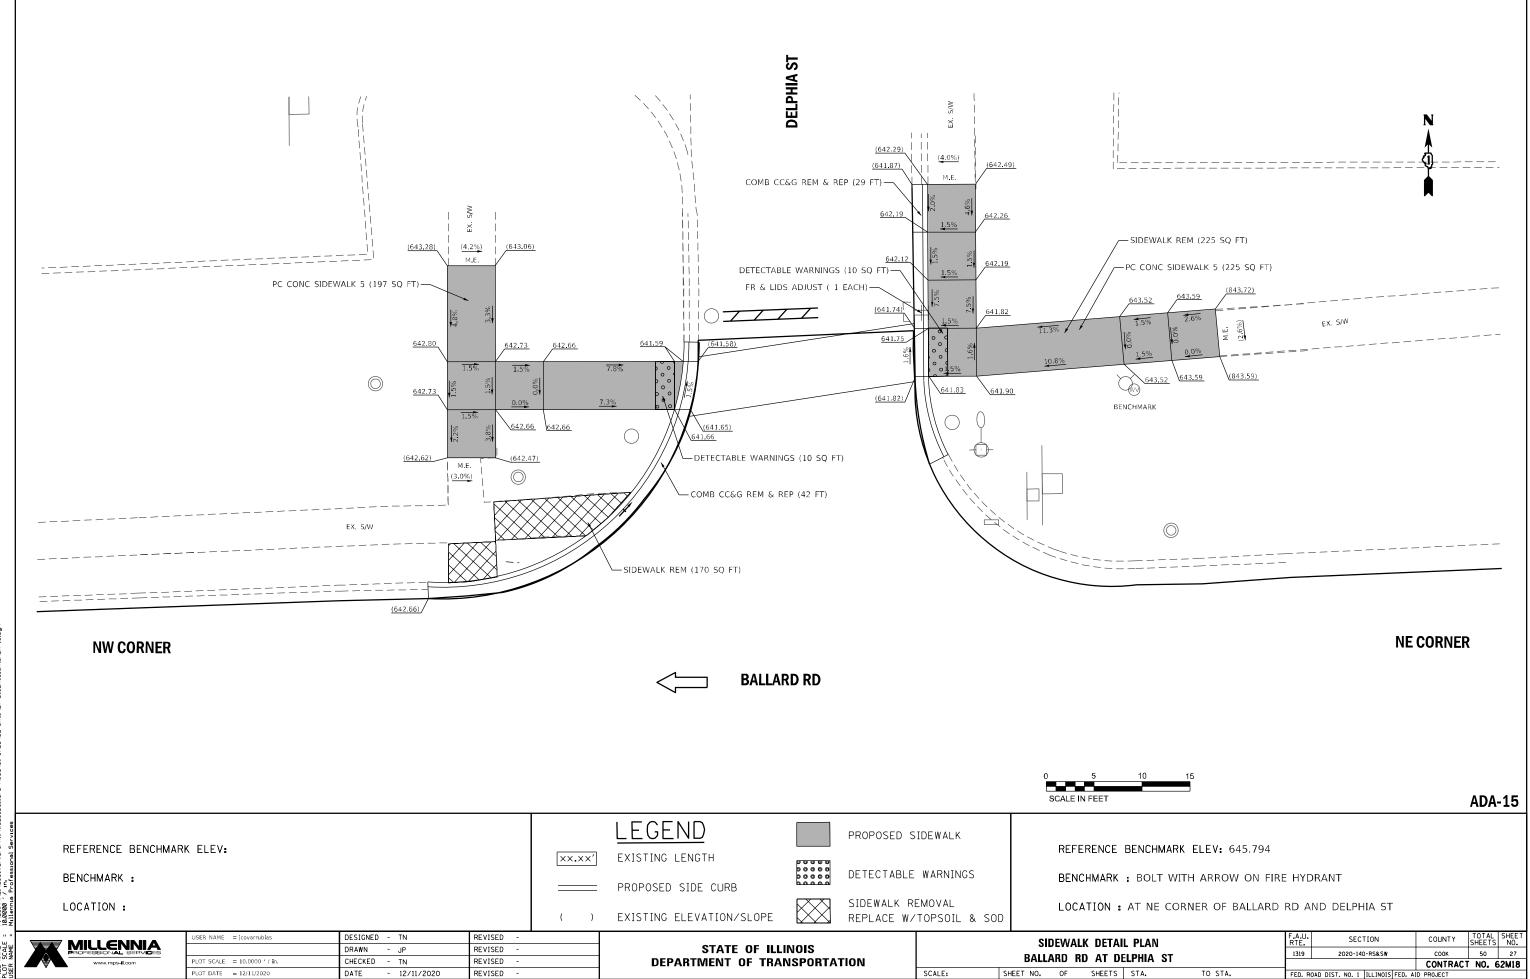

DEPARTMENT OF TRANSPORTATION


BALLARD RD AT DELPHIA ST


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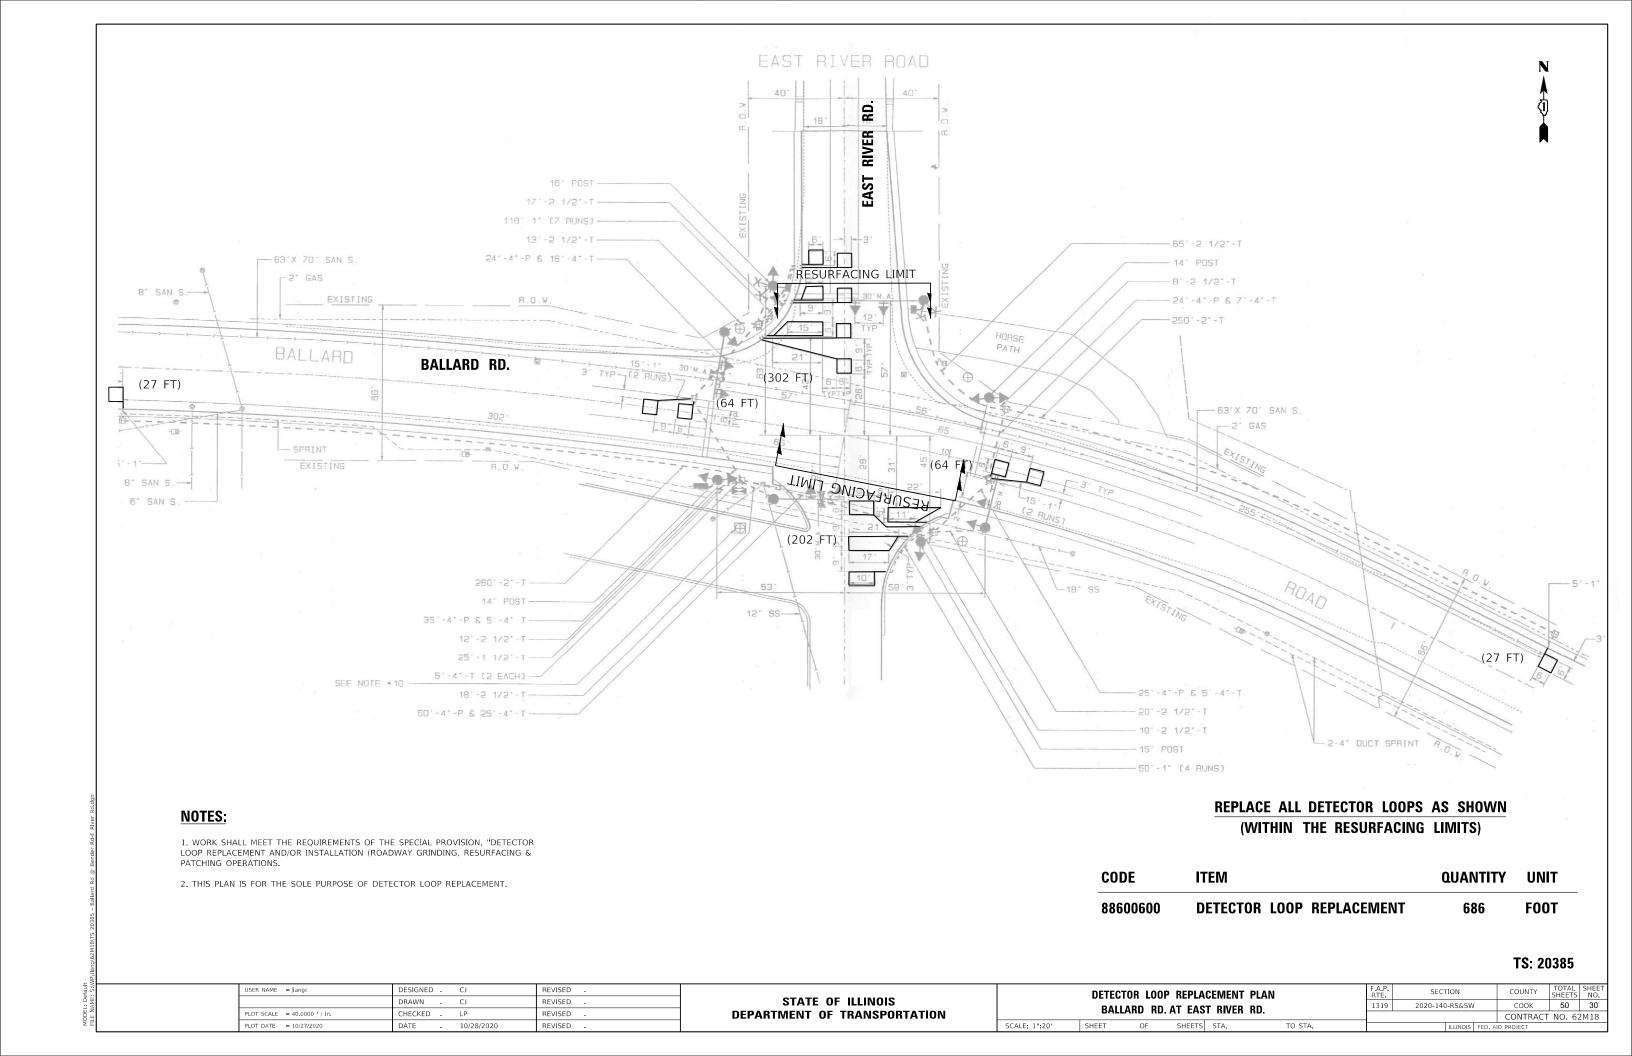
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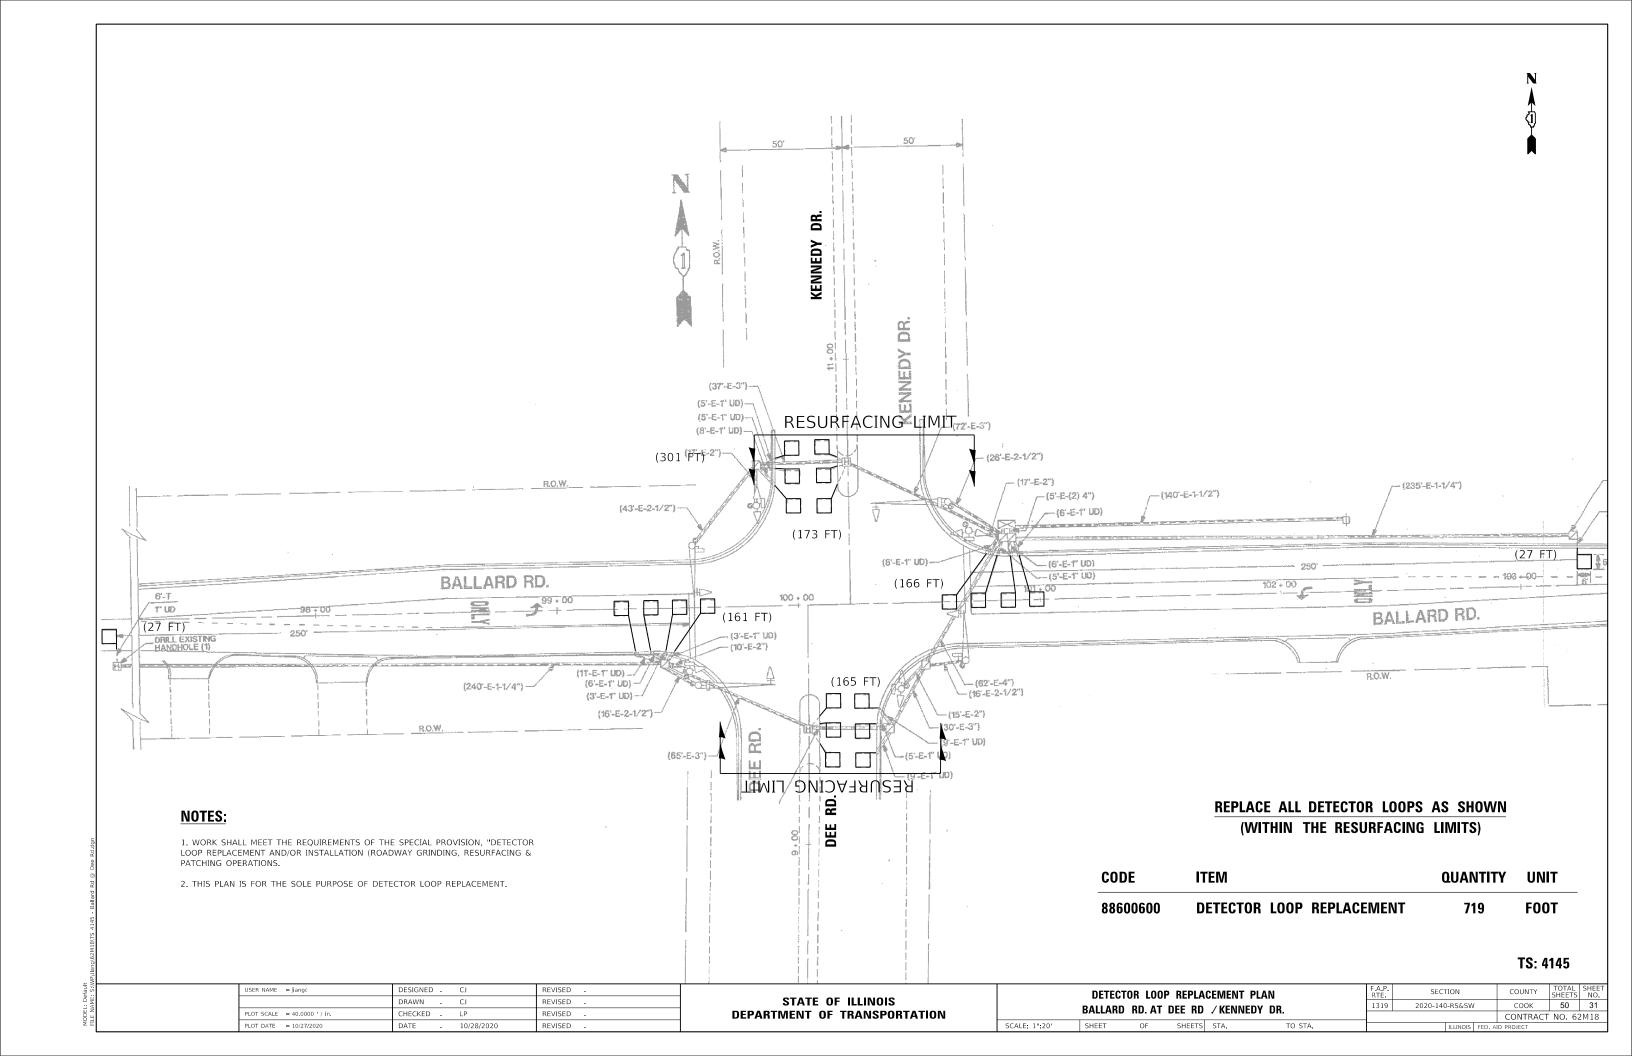
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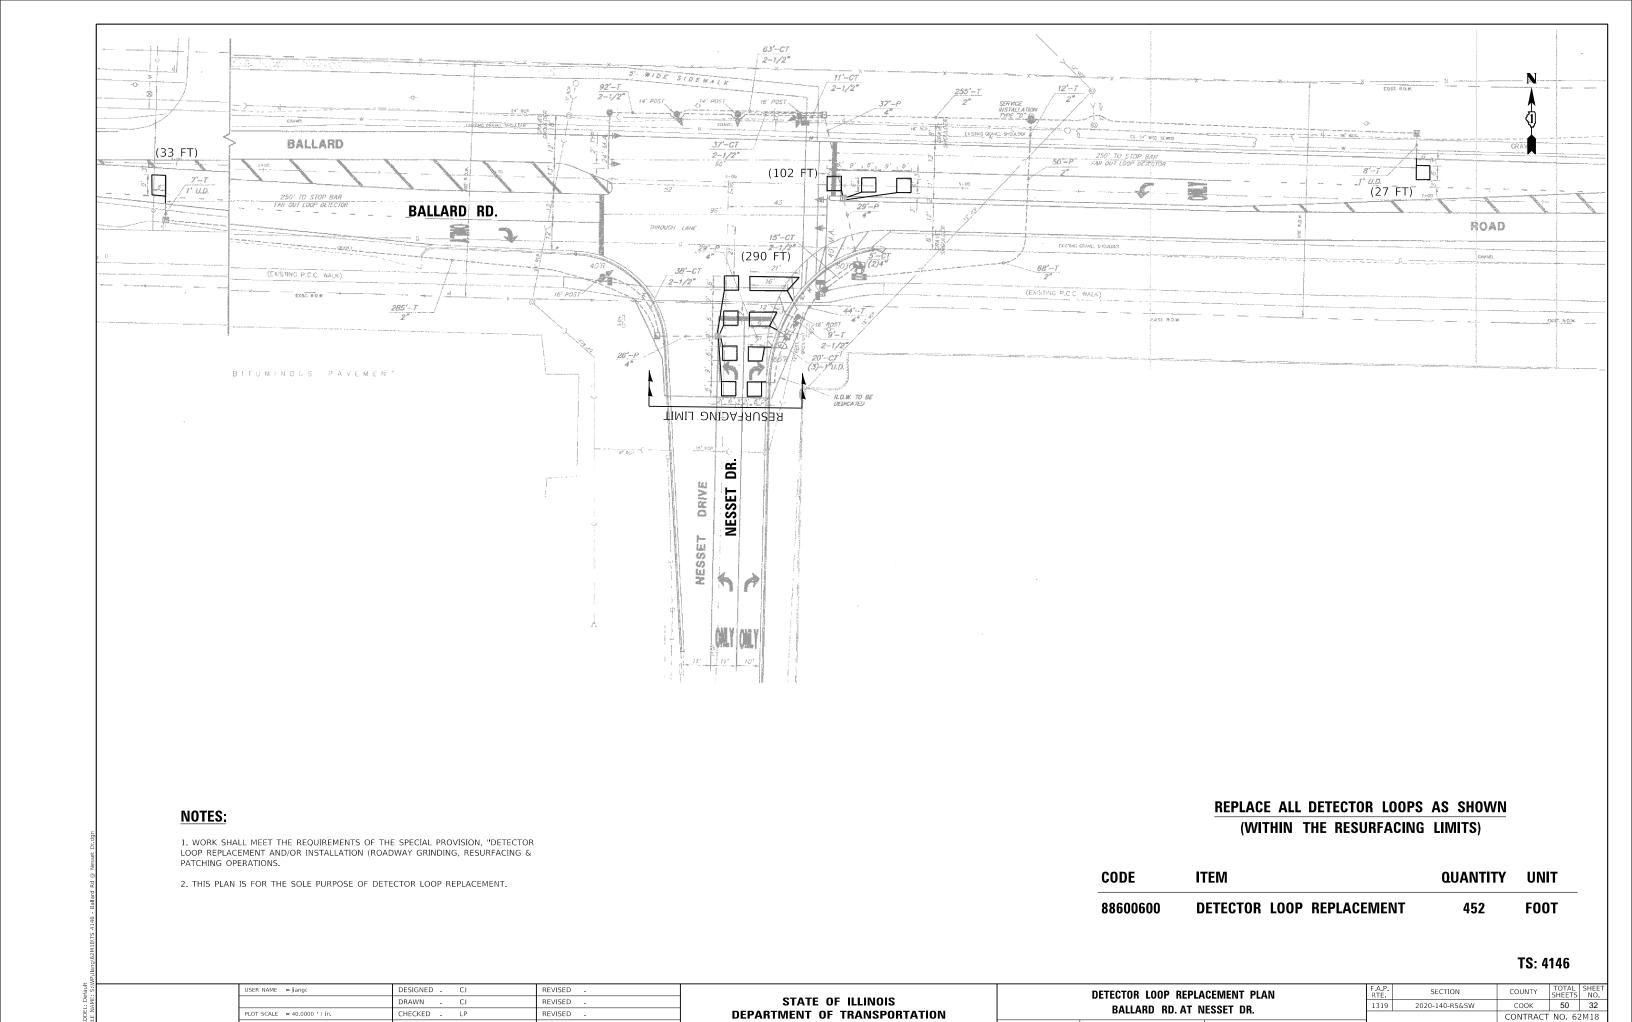
REVISED








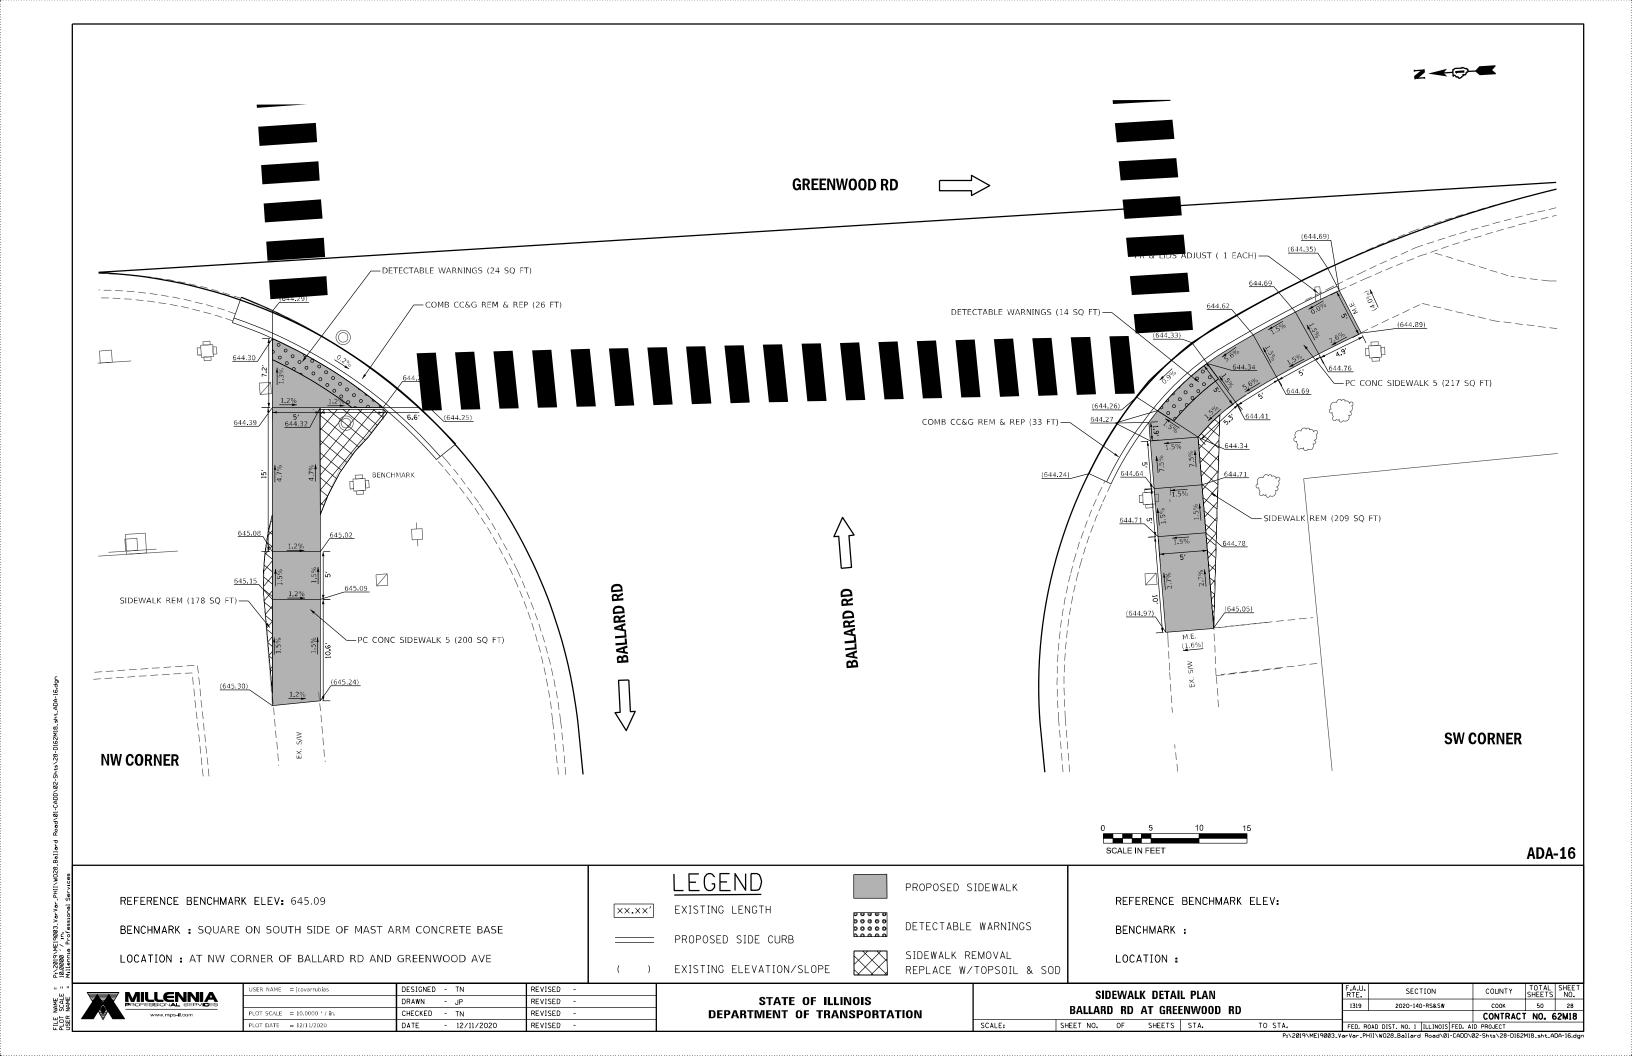


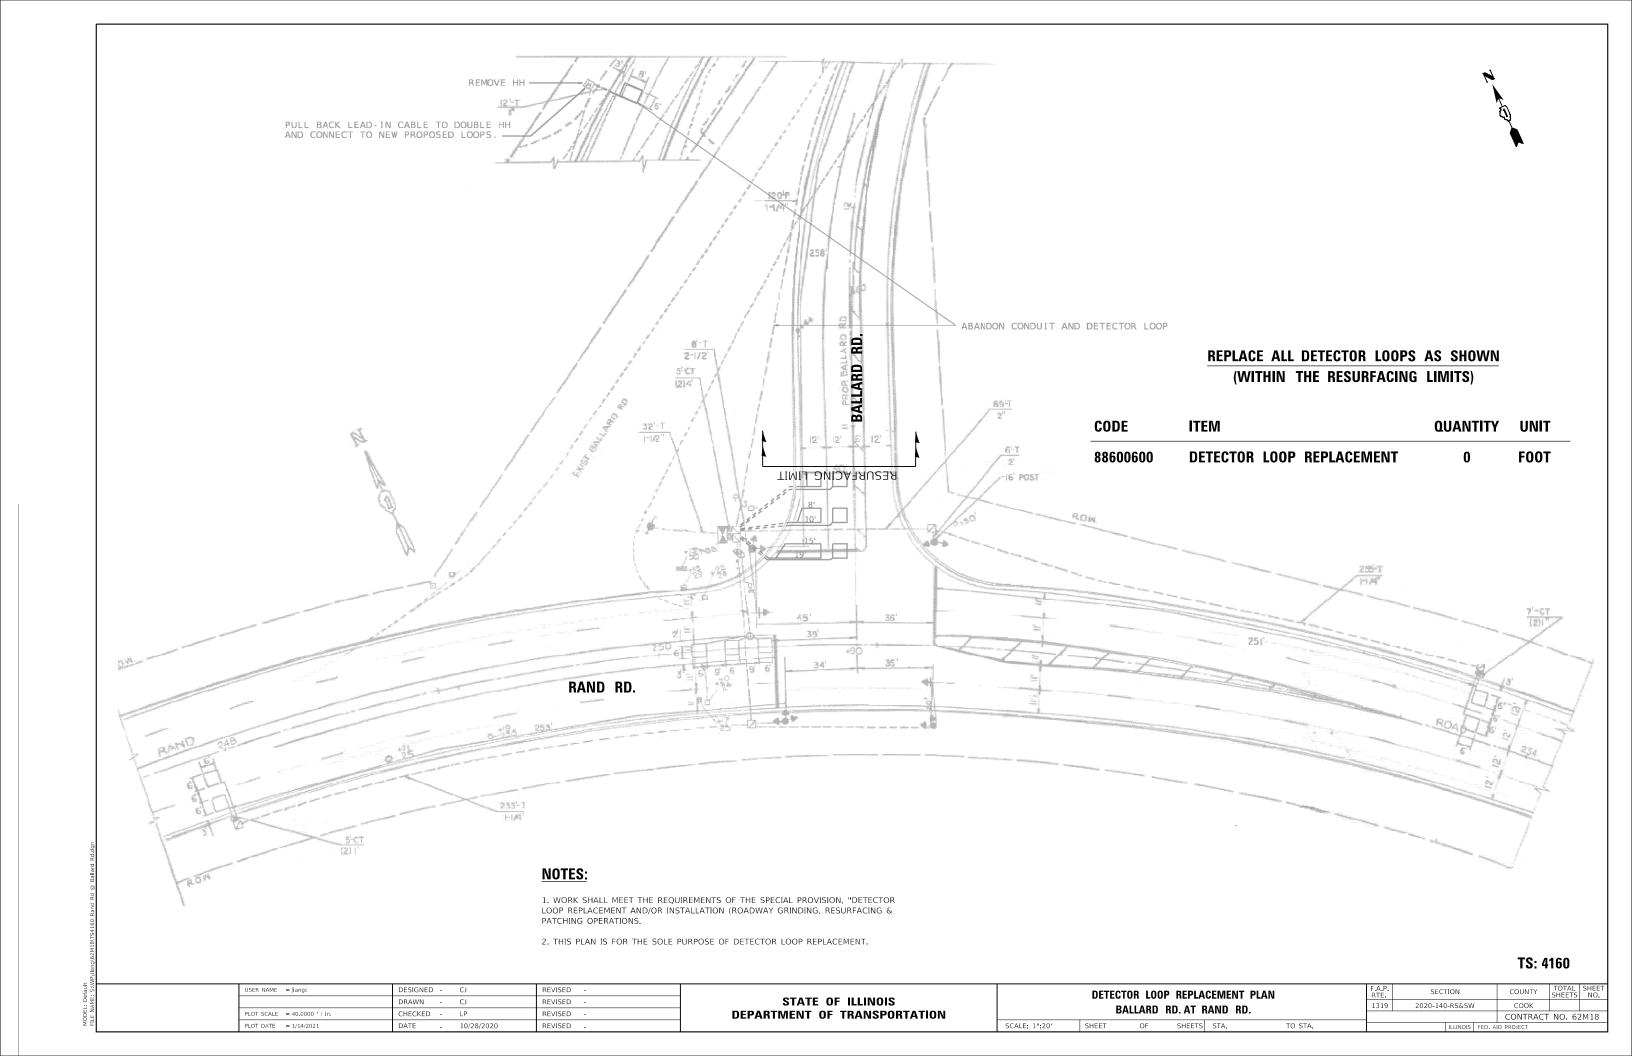


SCALE: 1":20"

PLOT DATE = 10/27/2020

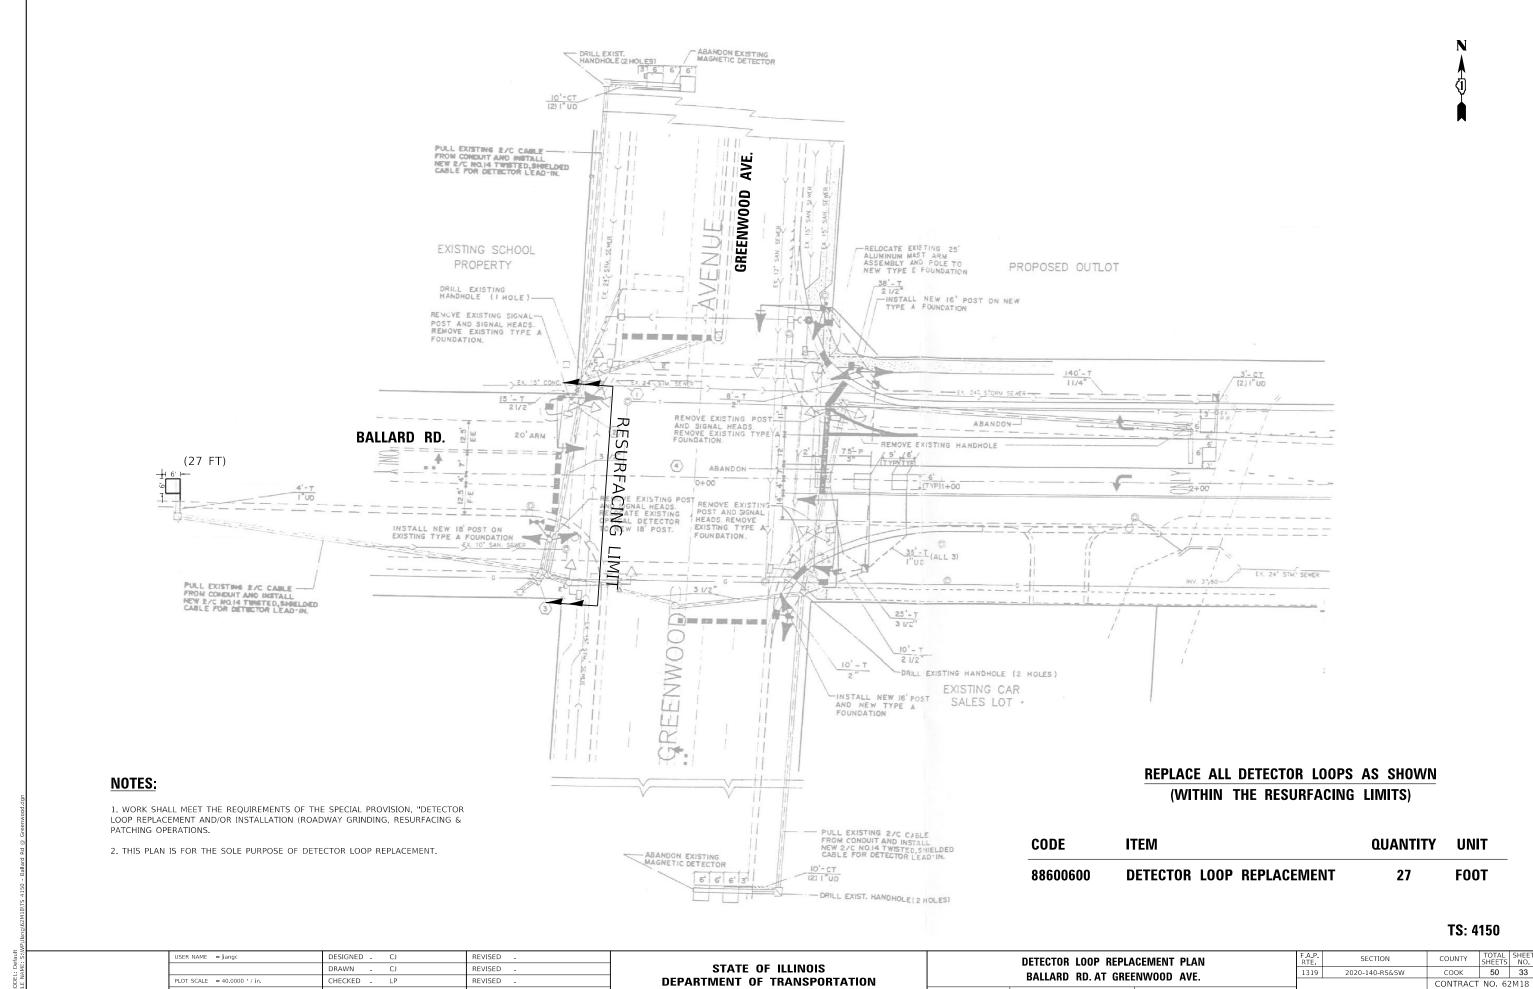

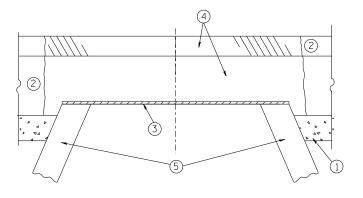

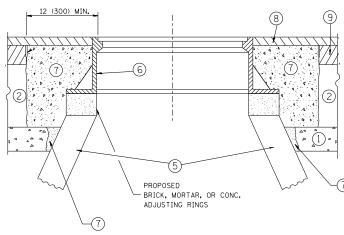

NOTES:

EXISTING BROKEN FRAMES AND LIDS SHALL BE REMOVED AND DISPOSED OF BY THE CONTRACTOR AND SHALL BE REPLACED AS DIRECTED BY THE ENGINEER. REPLACEMENT FRAMES AND LIDS WILL BE PAID FOR IN ACCORDANCE WITH ARTICLE 109.04 OF THE STANDARD SPECIFICATIONS UNLESS A SEPARATE PAY ITEM HAS BEEN PROVIDED.

IF THE EXISTING LIDS ARE OPEN, THE FRAME WILL BE ADJUSTED TO THE ELEVATION OF THE MILLED PAVEMENT SURFACE PRIOR TO THE MILLING OPERATION. THE FRAME WILL NOT BE REMOVED AND COVERED BY THE METAL PLATE.

CITY OF CHICAGO CASTINGS ARE THE PROPERTY OF THE CITY AND THE CONTRACTOR SHALL NOTIFY THE CITY FOR REMOVAL AND DISPOSITION OF THE CASTINGS.

THE METAL PLATE USED TO COVER THE STRUCTURE SHALL REMAIN THE PROPERTY OF THE CONTRACTOR.

WHEN STRUCTURES ARE TO BE ADJUSTED OR RECONSTRUCTED, THE LOWERING AND RAISING OF THE FRAMES AND LIDS WILL NOT BE PAID FOR SEPARATELY BUT WILL BE INCLUDED IN THE COST OF THE CORRESPONDING PAY ITEM.

SCALE: NONE

CONSTRUCTION PROCEDURES

STAGE 1 (BEFORE PAVEMENT MILLING)

- A) REMOVE A MINIMUM OF 12 (300) OF THE PAVEMENT FROM
- AROUND THE STRUCTURE.

 B) REMOVE THE EXISTING FRAME AND LID FROM THE STRUCTURE.
- C) COVER THE STRUCTURE OPENING WITH A 36 (900) DIAMETER METAL PLATE.

 D) BACKFILL WITH CRUSHED STONE AND A MINIMUM 1½ (40)
- THICK HMA SURFACE MIX APPROVED BY THE ENGINEER.

STAGE 2 (AFTER PAVEMENT MILLING)

- A) REMOVE THE HMA SURFACE MIX AND CRUSHED STONE.
- B) INSTALL THE FRAME AND LID; ADJUST THE FRAME TO ITS FINAL SURFACE ELEVATION.
- C) THE SURROUNDING SPACE SHALL BE FILLED WITH CLASS PP-1* CONCRETE TO THE ELEVATION OF THE SURFACE OF THE EXISTING BASE COURSE OR THE BINDER COURSE.
- *UNLESS OTHERWISE SPECIFIED IN THE PLANS.

THE PROCEDURE EXPLAINED ABOVE SHALL CONFORM TO THE APPLICABLE PORTIONS OF SECTIONS 353, 406, 602, AND 603 OF THE STANDARD SPECIFICATIONS EXCEPT THAT "THE CONTRACTOR SHALL ADJUST THE STRUCTURES TO THE FINISHED PAVEMENT ELEVATION NO MORE THAN 5 CALENDAR DAYS PRIOR TO PLACEMENT OF THE FINAL LIFT OF SURFACE UNLESS APPROVED BY THE

LEGEND

- 1 SUB-BASE GRANULAR MATERIAL
- (6) FRAME AND LID (SEE NOTES)
- 2 EXISTING PAVEMENT
- (7) CLASS PP-1* CONCRETE
- 3 36 (900) DIAMETER METAL PLATE
- PROPOSED CRUSHED STONE AND HMA SURFACE MIX
- (8) PROPOSED HMA SURFACE COURSE
- (5) EXISTING STRUCTURE
- (9) PROPOSED HMA BINDER COURSE

LOCATION OF STRUCTURES:

THE CONTRACTOR WILL BE REQUIRED TO KEEP A RECORD OF THE LOCATIONS OF THE BURIED STRUCTURES ACCORDING TO THE STATION AND DISTANCE LEFT OR RIGHT OF THE CENTERLINE OF PAVEMENT. UPON COMPLETION OF THE WORK, THE CONTRACTOR WILL DELIVER THE RECORD TO THE ENGINEER.

BASIS OF PAYMENT:

REMOVING FRAMES AND LIDS ON DRAINAGE AND UTILITY STRUCTURES IN THE PAVEMENT PRIOR TO MILLING, AND ADJUSTING TO FINAL GRADE PRIOR TO PLACING THE SURFACE COURSE, WILL BE PAID FOR AT THE CONTRACT UNIT PRICE EACH FOR "FRAMES AND LIDS TO BE ADJUSTED

THIS WORK WILL NOT BE PAID FOR WHEN DRAINAGE AND UTILITY STRUCTURES ARE SPECIFIED FOR PAYMENT AS STRUCTURE RECONSTRUCTION.

NEW FRAMES AND LIDS, WHEN SPECIFIED, WILL BE PAID FOR SEPARATELY.

DETAILS FOR FRAMES AND LIDS ADJUSTMENT WITH MILLING


ALL DIMENSIONS ARE IN INCHES (MILLIMETERS) UNLESS OTHERWISE SHOWN

DESIGNED - R. SHAH FILE NAME = USER NAME = bauerdl REVISED - R. WIEDEMAN 05-14-04 c:\pw_work\pwidot\bauerdl\d0108315\bd08 DRAWN REVISED - R. BORO 01-01-07 CHECKED REVISED REVISED - R. BORO 12-06-11 PLOT DATE = 12/6/2011 DATE 10-25-94

STATE OF ILLINOIS **DEPARTMENT OF TRANSPORTATION**

DETAILS FOR FRAMES AND LIDS ADJUSTMENT WITH MILLING SHEET NO. 1 OF 1 SHEETS STA.

COUNTY 1319 2020-140-RS&SW COOK 50 34 BD600-03 (BD-8) CONTRACT NO. 62M18

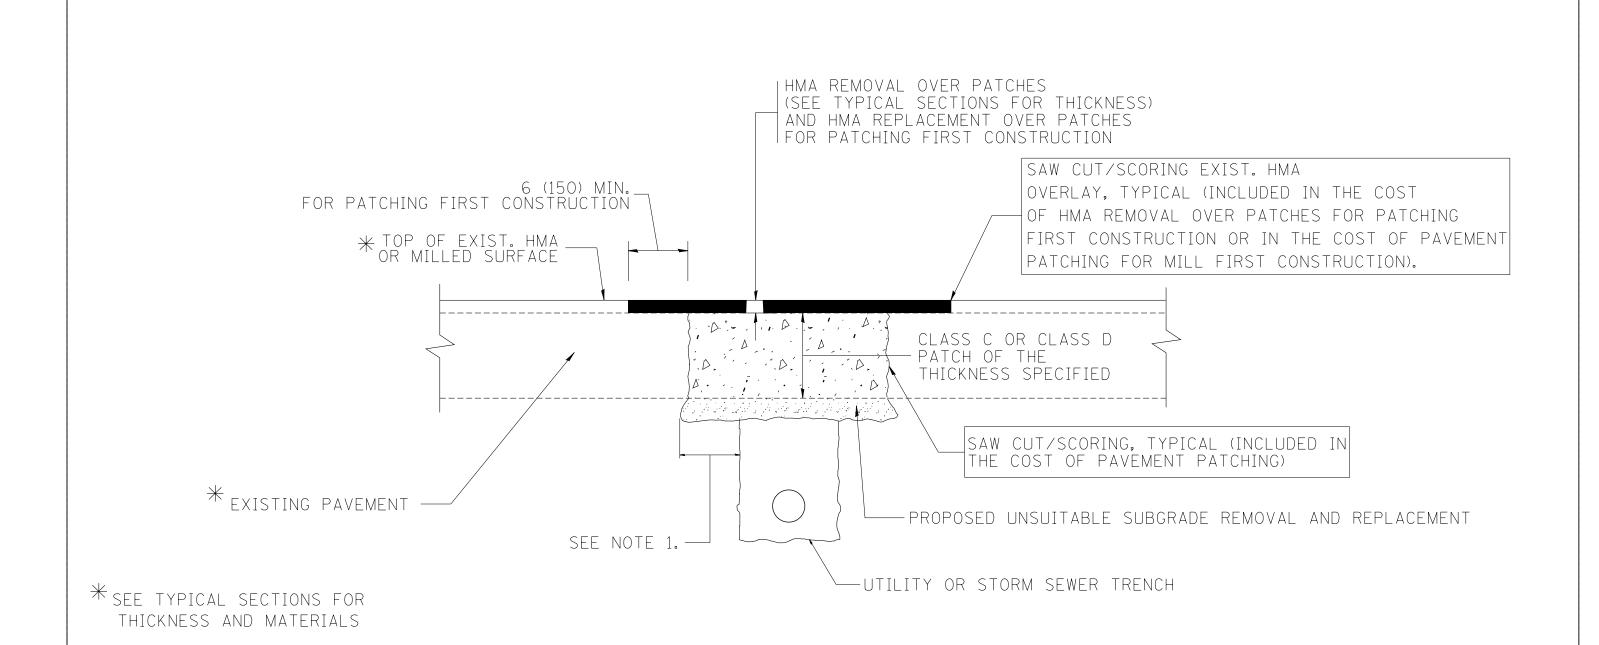

NOTES:

- 1. THE WIDTH OF THE FULL DEPTH PATCH OVER A TRENCH SHALL BE 12 (300) WIDER ON EACH SIDE OF THE TRENCH.
- 2. FOR METHOD OF MEASUREMENT AND BASIS OF PAYMENT, SEE RECURRING SPECIAL PROVISION "PATCHING WITH HOT-MIX ASPHALT OVERLAY REMOVAL".

SEQUENCE OF CONSTRUCTION (PATCHING FIRST)


- 1. REMOVE THE EXISTING HMA MATERIAL OVER THE AREA TO BE PATCHED.
- 2. REMOVE AND REPLACE WITH CLASS C OR D PATCH.
- 3. REPLACE HMA MATERIAL OVER THE AREA TO BE PATCHED.

SEQUENCE OF CONSTRUCTION (MILLING FIRST)

- 1. MILL HMA FIRST IF THERE IS AT LEAST 41/2 INCHES OR MORE OF HMA MATERIAL ON TOP OF THE EXISTING PAVEMENT OR IF THE PAVEMENT IS FULL DEPTH HMA. A MINIMUM OF 2 INCHES OF HMA MATERIAL SHALL BE IN PLACE AFTER MILLING.
- 2. REMOVE AND REPLACE WITH FULL DEPTH CLASS D PATCHES TO TOP OF MILLED SURFACE.

ALL DIMENSIONS ARE IN INCHES (MILLIMETERS) UNLESS OTHERWISE SHOWN.

FILE NAME =	USER NAME = bauerdl	DESIGNED - R. SHAH	REVISED - A. ABBAS 04-27-98			PAVEMENT PATCHING FOR	RTE.	SECTION	COUNTY	SHEETS NO.
c:\projects\diststd22x34\bd22.dgn		DRAWN -	REVISED - R. BORO 01-01-07	STATE OF ILLINOIS				2020-140-RS&SW	соок	50 35
	PLOT SCALE = 50.000 '/ IN.	CHECKED -	REVISED - R. BORO 09-04-07	DEPARTMENT OF TRANSPORTATION		HMA SURFACED PAVEMENT		RD400_04 (RD_22)	CONTRACT	NO. 62M18
	PLOT DATE = 10/27/2008	DATE - 10-25-94	REVISED - K. ENG 10-27-08		SCALE: NONE	SHEET NO. 1 OF 1 SHEETS STA. TO STA.	FED. RO	OAD DIST. NO. 1 ILLINOIS FED. A	ID PROJECT	

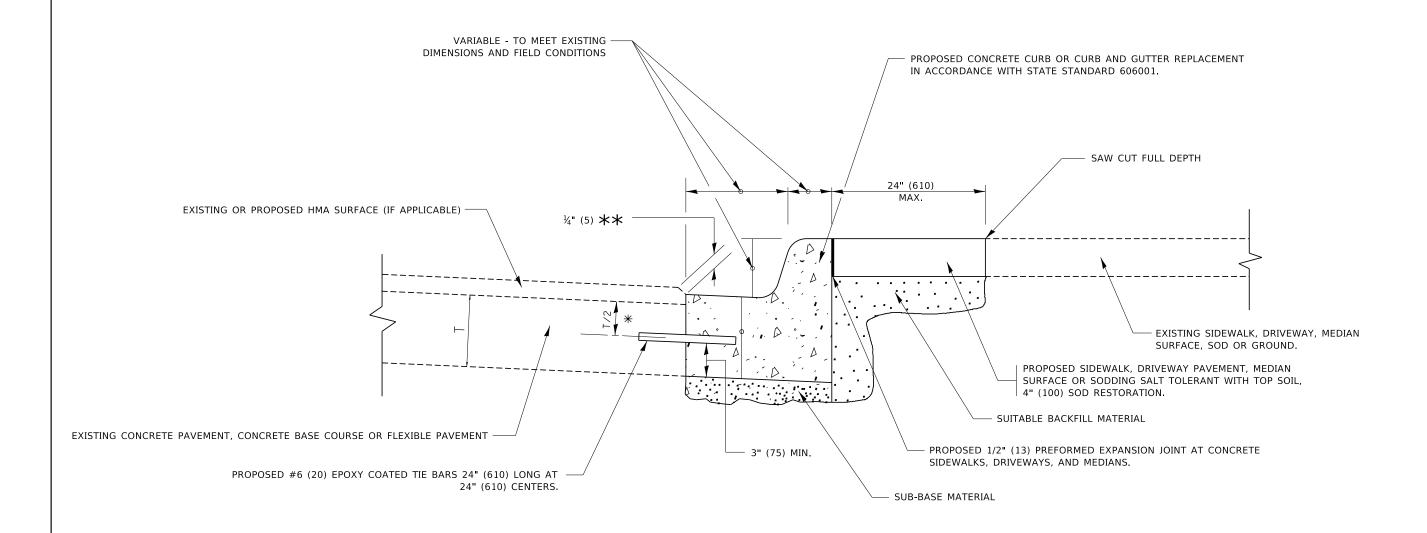


- 🗙 3" (75) MINIMUM FROM TOP AND BOTTOM OF THE CONCRETE PAVEMENT OR BASE COURSE.
- $\star\star$ IF THE FINAL SURFACE OF THE PAVEMENT IS CONCRETE, THE GUTTER IS TO BE FLUSH WITH THE PAVEMENT.

CURB OR CURB AND GUTTER REMOVAL AND REPLACEMENT


ALL DIMENSIONS ARE IN INCHES (MILLIMETERS) UNLESS OTHERWISE SHOWN.

JSER NAME = footemj DESIGNED - A. HOUSEH REVISED - A. ABBAS 03-21-97 COUNTY SHEETS NO.

COOK 50 36 **CURB OR CURB AND GUTTER** STATE OF ILLINOIS DRAWN REVISED - M. GOMEZ 01-22-01 REMOVAL AND REPLACEMENT CHECKED REVISED -R. BORO 12-15-09 **DEPARTMENT OF TRANSPORTATION** BD600-06 (BD-24) CONTRACT NO. SCALE: NONE SHEET 1 OF 1 SHEETS STA. K. SMITH 07-11-19 DATE

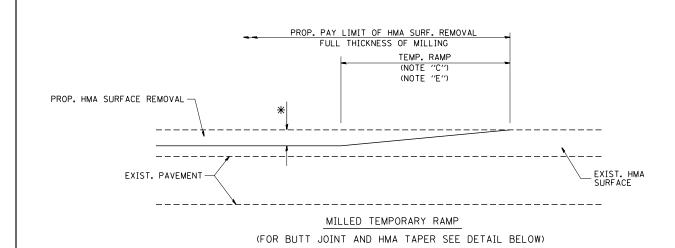


OPTION 1

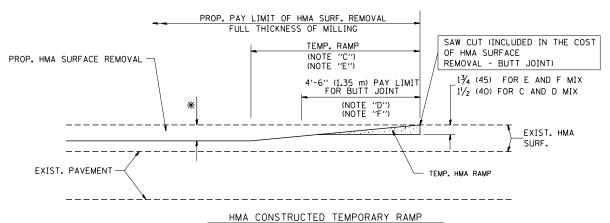

(FOR BUTT JOINT AND HMA TAPER SEE DETAIL BELOW)

OPTION 2

TYPICAL TEMPORARY RAMP

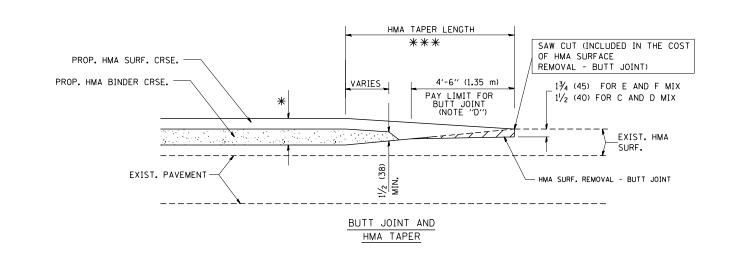


TYPICAL BUTT JOINT AND HMA TAPER FOR MILLING AND RESURFACING


FILE NAME = DESIGNED - M. DE YONG REVISED - R. SHAH 10-25-94 USER NAME = gaglianobt W:\diststd\22x34\bd32.dqr DRAWN REVISED A. ABBAS 03-21-97 PLOT SCALE = 50.0000 '/ IN. CHECKED REVISED M. GOMEZ 04-06-01 DATE R. BORO 01-01-07 PLOT DATE = 1/4/2008 06-13-90 REVISED

STATE OF ILLINOIS DEPARTMENT OF TRANSPORTATION

ALL DIMENSIONS ARE IN INCHES (MILLIMETERS) UNLESS

OTHERWISE SHOWN.

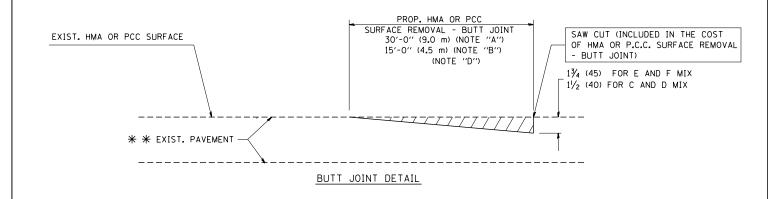

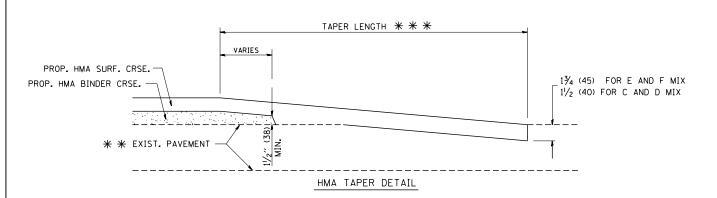

TYPICAL BUTT JOINT AND HMA TAPER FOR RESURFACING ONLY

* * PC CONCRETE, HMA OR HMA RESURFACED PAVEMENT.


NOTES

- A: MAINLINE ROADWAYS AND MAJOR SIDE ROADS.
- B: MINOR SIDE ROADS.
- C: THE TEMP. RAMP SHALL BE CONSTRUCTED IMMEDIATELY UPON REMOVAL OF THE EXISTING HMA SURFACE.
- D: THE BUTT JOINT SHALL BE CONSTRUCTED IMMEDIATELY PRIOR TO PLACING THE PROPOSED HMA COURSES.
- E: TAPER THE TEMP. RAMP AT A RATE OF 3'-0" (900 mm) PER 1 INCH (25 mm) OF MILLING THICKNESS.
- F: INSTALLATION AND REMOVAL OF THE 4'-6" (1.35 m) TEMP. RAMP IS INCLUDED IN COST OF HMA SURFACE REMOVAL BUTT JOINT
- G: SEE ARTICLE 406.08 AND 406.14 OF THE STANDARD SPECIFICATIONS FOR "HMA AND/OR PCC SURFACE REMOVAL, BUTT JOINT".
- * SEE TYPICAL SECTIONS FOR MILLING THICKNESS.
- ** \times 20'-0" (6.1 m) PER 1 (25) RESURFACING (NOTE "A") 10'-0" (3.0 m) PER 1 (25) RESURFACING (NOTE "B")

BASIS OF PAYMENT:

THE BUTT JOINT WILL BE PAID FOR AT THE CONTRACT UNIT PRICE PER SQUARE YARD (SQUARE METER) FOR "HOT-MIX ASPHALT SURFACE REMOVAL - BUTT JOINT" OR FOR "PORTLAND CEMENT CONCRETE SURFACE REMOVAL- BUTT JOINT".

SCALE: NONE

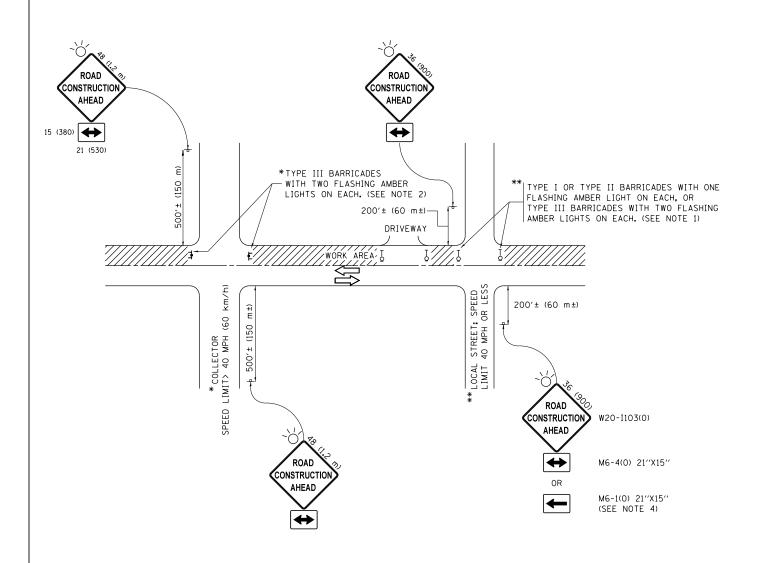

NOTES:

- SIDE ROAD WITH A SPEED LIMIT OF 40 MPH (60 km/h) OR LESS AS SHOWN ON THE DRAWING AND AS DIRECTED BY THE ENGINEER:
 - a) ONE "ROAD CONSTRUCTION AHEAD" SIGN 36 x 36 (900x900) WITH A FLASHER MOUNTED ON IT APPROXIMATELY 200" (60 m) IN ADVANCE OF THE MAIN ROUTE.
 - b) THE CLOSED PORTION OF THE MAIN ROUTE SHALL BE PROTECTED BY BLOCKING WITH TYPE I, TYPE II OR TYPE III BARRICADES, 1/3 OF THE CROSS SECTION OF THE CLOSED PORTION.
- 2. SIDE ROAD WITH A SPEED LIMIT GREATER THAN 40 MPH (60 km/h) AS SHOWN ON THE DRAWING AND AS DIRECTED BY THE ENGINEER:
 - a) ONE "ROAD CONSTRUCTION AHEAD" SIGN 48 x 48 (1.2 m x 1.2 m) WITH A FLASHER MOUNTED ON IT APPROXIMATELY 500" (150 m) IN ADVANCE OF THE MAIN ROUTE.
 - b) THE CLOSED PORTION OF THE MAIN ROUTE SHALL BE PROTECTED BY BLOCKING WITH TYPE III BARRICADES, 1/2 OF THE CROSS SECTION OF THE CLOSED PORTION.
- 3. CONES MAY BE SUBSTITUTED FOR BARRICADES OR DRUMS AT HALF THE SPACING DURING DAY OPERATIONS. CONES SHALL BE A MINIMUM OF 28 (710)
- 4. WHEN THE SIDE ROAD LIES BETWEEN THE BEGINNING OF THE MAINLINE SIGNING AND THE WORK ZONE, A SINGLE HEADED ARROW (M6-1) SHALL BE USED IN LIEU OF THE DOUBLE HEADED ARROW (M6-4).

SCALE: NONE


- 5. WHEN WORK IS BEING PERFORMED ON A SIDE ROAD OR DRIVEWAY, FOLLOW THE APPLICABLE STANDARD(S). THE DIRECTIONAL ARROW (M6-1 OR M6-4) SHALL BE COVERED OR REMOVED WHEN NO LONGER CONSISTENT WITH THE TRAFFIC CONTROL SET-UP.
- 6. ADVANCE WARNING SIGNS ARE TO BE OMITTED ON DRIVEWAYS UNLESS OTHERWISE SPECIFIED IN THE PLANS OR BY THE ENGINEER
- 7. THE TRAFFIC CONTROL AND PROTECTION FOR SIDE ROADS, INTERSECTIONS, AND DRIVEWAYS SHALL BE INCLUDED IN THE COST OF SPECIFIED TRAFFIC CONTROL STANDARDS OR ITEMS.

All dimensions are in inches (millimeters) unless otherwise shown.

FILE NAME =	USER NAME = footemj	DESIGNED - L.H.A.	REVISED	- A. HOUSEH 10-15-9
pw:\\IL084EBIDINTEG.:llinois.gov:PWIDOT\Do	cuments\IDOT Offices\District 1\Projects\Dist	CADSheets\tc10.dgn	REVISED	-T. RAMMACHER 01-06-0
	PLOT SCALE = 50.000 '/ in.	CHECKED -	REVISED	- A. SCHUETZE 07-01-1
Default	PLOT DATE = 9/15/2016	DATE - 06-89	REVISED	- A. SCHUETZE 09-15-1


STATI	E OF	ILLINOIS
DEPARTMENT	0F	TRANSPORTATION


	TRAFFIC (F.A. RTE.	SECTION				
СI	DE BUYDS	1319	2020-140-RS&SW				
SIDE ROADS, INTERSECTIONS				, AND L	DRIVEVVATO		TC-10
	SHEET 1	OF 1	SHEETS	STA.	TO STA.		III INOIS

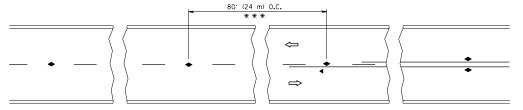

*** REDUCE TO 40' (12 m) O.C. ON CURVES WITH POSTED OR ADVISORY SPEED 45 M.P.H. (70 km/h) OR LESS.

TWO-LANE/TWO-WAY

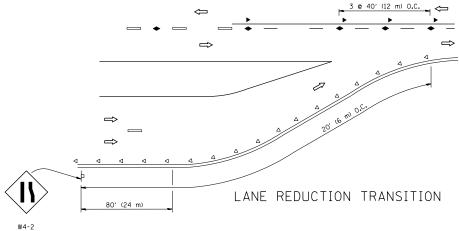

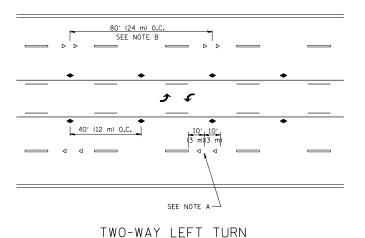

80' (24 m) 0.C.

SEE NOTE B


40' (12 m) 0.C.

(3 m)(3 m)

(3 m)(3 m)

SEE NOTE A

MULTI-LANE/UNDIVIDED

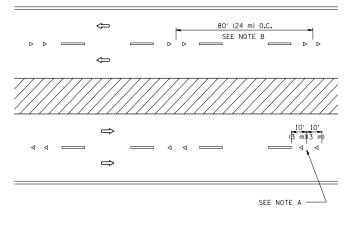

MULTI-LANE/DIVIDED

GENERAL NOTES

- 1. MARKERS USED WITH DASHED LINES SHALL BE CENTERED IN THE GAP BETWEEN SEGMENTS.
- 2. MARKERS USED ADJACENT TO SOLID LINES SHALL BE OFFSET 2 TO 3 (50 TO 75) TOWARD TRAFFIC AS SHOWN.
- 3. MARKERS THROUGH TANGENTS LESS THAN 500' (150 m) IN LENGTH BETWEEN CURVES SHALL BE INSTALLED AT THE LESSER OF THE TWO CURVE SPACINGS.

LANE MARKER NOTES

A. USE DOUBLE LANE LINE MARKERS SPACED AS SHOWN.

B. REDUCE TO 40' (12 m) O.C. ON CURVES WHERE ADVISORY SPEEDS ARE 10 M.P.H (20 km/h) LOWER THAN POSTED SPEEDS.

SYMBOLS

---- YELLOW STRIPE

── WHITE STRIPE

- ONE-WAY AMBER MARKER
- ONE-WAY CRYSTAL MARKER (W/O)
- ◆ TWO-WAY AMBER MARKER


DESIGN NOTES

- 1. DOUBLE LANE LINE MARKERS SHALL BE USED UNLESS SPECIFIED OTHERWISE.
- 2. EXCEPT AS SHOWN ON THE LANE REDUCTION TRANSITION AND FREEWAY EXIT RAMP DETAIL, MARKERS ARE NOT TO BE SPECIFIED ON RIGHT EDGE LINES.
- 3. THE EXACT MARKER LIMITS, SPACING, AND COLOR SHALL BE INCLUDED IN THE PLANS WHEN STANDARD SPECIFICATIONS ARE NOT BEING USED.
- 4. MARKERS SHOULD NOT BE USED ALONGSIDE CURBS EXCEPT FOR EXTREMELY SHORT SECTIONS OF CURBS WHERE NOT MORE THAN TWO MARKERS WOULD BE INVOLVED.

LEFT TURN

All dimensions are in inches (millimeters) unless otherwise shown.

FILE NAME =	USER NAME = leyso	DESIGNED -	REVISED -T. RAMMACHER 09-19-94		TYPICAL APPLICATIONS	F.A RTF.	SECTION	COUNTY	TOTAL SHEET
c:\pw_work\pwidot\leysa\d0108315\tc11.dgr		DRAWN -	REVISED -T. RAMMACHER 03-12-99	STATE OF ILLINOIS			020-140-RS&SW	соок	50 39
	PLOT SCALE = 50.000 '/ IN.	CHECKED -	REVISED -T. RAMMACHER 01-06-00	DEPARTMENT OF TRANSPORTATION	RAISED REFLECTIVE PAVEMENT MARKERS (SNOW-PLOW RESISTANT)	Т	TC-11	CONTRACT	NO. 62M18
	PLOT DATE = 3/2/2011	DATE -	REVISED - C. JUCIUS 09-09-09		SCALE: NONE SHEET NO. 1 OF 1 SHEETS STA. TO STA.	FED. ROAD DIST.	NO. 1 ILLINOIS FED. A	AID PROJECT	

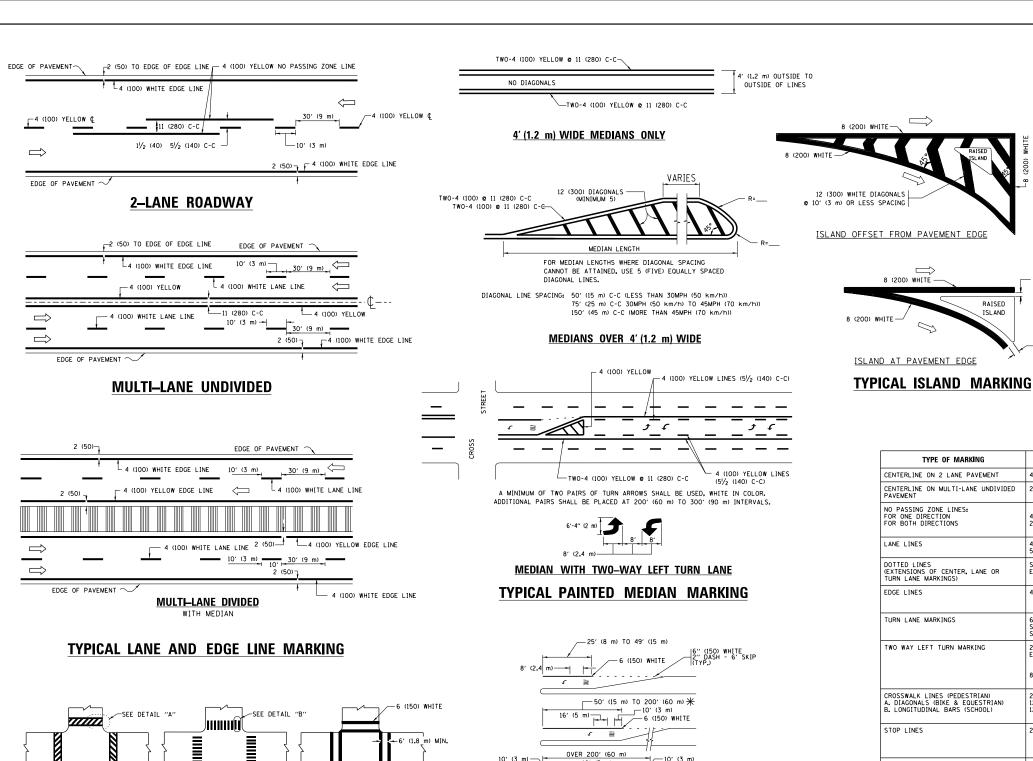

____ 6 (150) WHITE

FULL SIZE LETTERS 8' (2.4 m) AND ARROWS SHALL BE USED. \uparrow AREA = 15.6 SO. FT. (1.5 m²) **ONLY** AREA = 20.8 SO. FT. (1.9 m²)

* TURN LANES IN EXCESS OF 400' (120 m) IN LENGTH MAY HAVE AN ADDITIONAL SET OF ARROW - "ONLY" INSTALLED MIDWAY BETWEEN THE OTHER TWO SETS OF

TYPICAL LEFT (OR RIGHT) TURN LANE

TYPICAL TURN LANE MARKING

ARROW - "ONLY".

6'-4" (1930) D(FT) SPEED LIMIT 345 425 500 580 45 665 50 750 55 **-20**′ 40 (1020) COMBINATION LEFT AND U-TURN 5'-4" (1620) √ 32 R (810) LANE REDUCTION TRANSITION 40 (1020) * LANE REDUCTION ARROWS REQUIRED AT SPEEDS OF 45 MPH OR GREATER OR WHEN SPECIFIED IN PLANS. **U-TURN**

TYPE OF MARKING WIDTH OF LINE PATTERN COLOR SPACING / REMARKS CENTERLINE ON 2 LANE PAVEMENT 4 (100) SKIP-DASH 10' (3 m) LINE WITH 30' (9 m) SPACE YELLOW CENTERLINE ON MULTI-LANE UNDIVIDED PAVEMENT 2 @ 4 (100) SOLID YELLOW 11 (280) C-C NO PASSING ZONE LINES: FOR ONE DIRECTION FOR BOTH DIRECTIONS 51/2 (140) C-C FROM SKIP-DASH CENTERLINE 4 (100) 2 **@** 4 (100) SOLID SOLID YELLOW YELLOW 11 (280) C-C OMIT SKIP-DASH CENTERLINE BETWEEN LANE LINES SKIP-DASH SKIP-DASH 10' (3 m) LINE WITH 30' (9 m) SPACE 4 (100) 5 (125) ON FREEWAYS DOTTED LINES
(EXTENSIONS OF CENTER, LANE OR TURN LANE MARKINGS) SAME AS LINE BEING EXTENDED SKIP-DASH SAME AS LINE BEING EXTENDED 2' (600) LINE WITH 6' (1.8 m) SPACE EDGE LINES SOLID 4 (100) OUTLINE MEDIANS IN YELLOW YELLOW-LEFT WHITE-RIGHT 6 (150) LINE; FULL SIZE LETTERS & SYMBOLS (8' (2.4m) SEE TYPICAL TURN LANE MARKING DETAIL TURN LANE MARKINGS SOLID 10' (3 m) LINE WITH 30' (9 m) SPACE FOR SKIP-DASH; 5/2 (140) C-C BETWEEN SOLID LINE AND SKIP-DASH LINE SEE TYPICAL TWO-WAY LEFT TURN MARKING DETAIL TWO WAY LEFT TURN MARKING 2 @ 4 (100) EACH DIRECTION YELLOW 8' (2.4m) LEFT ARROW WHITE CROSSWALK LINES (PEDESTRIAN) A. DIAGONALS (BIKE & EQUESTRIAN) B. LONGITUDINAL BARS (SCHOOL) 2 @ 6 (150) 12 (300) @ 45° 12 (300) @ 90° NOT LESS THAN 6' (1.8 m) APART 2' (600) APART 2' (600) APART SOLID SOLID SEE TYPICAL CROSSWALK MARKING DETAILS. PLACE 4' (1.2 m) IN ADVANCE OF AND PARALLEL TO CROSSMALK, IF PRESENT.
OTHERWISE, PLACE AT DESIRED STOPPING POINT. PARALLEL TO CROSSROAD CENTERLINE, WHERE POSSIBLE STOP LINES 24 (600) SOLID WHITE 2 @ 4 (100) WITH 12 (300) DIAGONALS @ 45° NO DIAGONALS USED FOR 4' (1.2 m) WIDE MEDIANS 11 (280) C-C FOR THE DOUBLE LINE SEE TYPICAL PAINTED MEDIAN MARKING. SOLID PAINTED MEDIANS YELLOW: TWO WAY TRAFFIC WHITE: ONE WAY TRAFFIC GORE MARKING AND CHANNELIZING LINES 8 (200) WITH 12 (300) DIAGONALS @ 45° DIAGONALS: 15' (4.5' m) C-C (LESS THAN 30MPH (50 km/h)) 20' (6' m) C-C 30MPH (50 km/h) TO 45MPH (70 km/h)) 30' (9' m) C-C (OVER 45MPH (70 km/h)) 24 (600) TRANSVERSE LINES; "RR" IS 6' (1.8 LETTERS; 16 (400) LINE FOR "X" SEE STATE STANDARD 780001 AREA OF: "R"=3.6 SO. FT. (0.33 m²) EACH "X"=54.0 SO. FT. (5.0 m²) RAILROAD CROSSING SOLID WHITE 50' (15 m) C-C (LESS THAN 30MPH (50 km/h)) 75' (25 m) C-C (30 MPH (50 km/h) T0 45MPH (70 km/h)) 150' (45 m) C-C (0VER 45MPH (70 km/h)) SHOULDER DIAGONALS (REQUIRED FOR SHOULDERS \geq 8') 12 (300) **ø** 45° SOLID WHITE - RIGHT YELLOW - LEFT U TURN ARROW SEE DETAIL SOLID WHITE 16.3 SF 2 ARROW COMBINATION LEFT AND U TURN SEE DETAIL SOLID WHITE 30.4 SF

FOR FURTHER DETAILS ON PAVEMENT MARKING REFER TO STANDARD SPECIFICATIONS FOR ROAD AND BRIDGE CONSTRUCTION AND STATE STANDARD 780001.

SCALE: NON

8 (200) WHITE -

— 2 (50)

2 (50)

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	PLOT SCALE = 50.000 '/ in.	CHECKED -	REVISED -	C. JUCIUS 12-21-15
Default	PLOT DATE = 4/13/2016	DATE - 03-19-90	REVISED -	C. JUCIUS 04-12-16

TYPICAL CROSSWALK MARKING

* MARKINGS SHALL BE INSTALLED PARALLEL TO THE CENTERLINE OF

2' (600)

DETAIL "B"

-12 (300) WHITE

6 (150) WHITE

DETAIL "A"

PEDESTRIAN

BICYCLE & EQUESTRIAN

•	DISTRICT ONE							SECTION	COUNTY	TOTAL SHEETS	SHEET NO.
	TVD	ICAL	DΛ	VEMENT	MARKIN	1319	2020-140-RS&SW	соок	50	40	
		IUAL	<u> </u>	VEIVIEIVI	IVIZATIVITA	103	TC-13 CONTRACT NO.				
ONE	SHEET 1	OF	1	SHEETS	STA.	TO STA.	ILLINOIS FED. AID PROJECT				

TURN BAY ENTRANCE AT START OF LANE CLOSURE TAPER

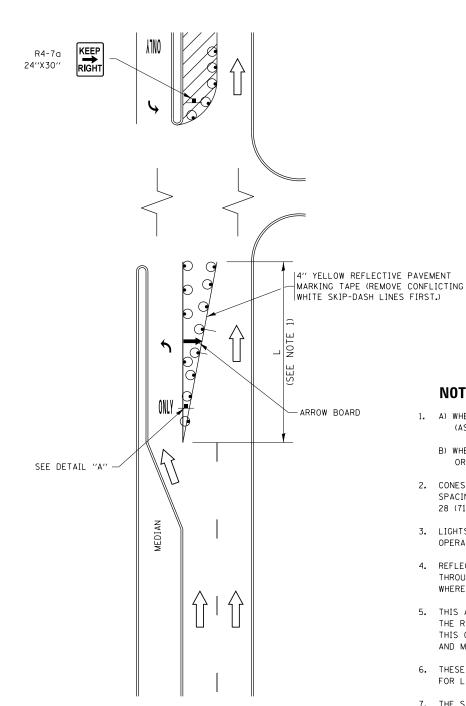



FIGURE 1

LEGEND WORK AREA LANE OPEN TO TRAFFIC ARROW BOARD TYPE I OR II BARRICADE OR DRUM WITH STEADY BURN LIGHT DRUM WITH STEADY BURN LIGHT SIGN ASSEMBLY TYPE I OR II CHECK BARRICADE WITH FLASHING LIGHT

NOTES:

- 1. A) WHEN "L" IS < THE STORAGE LENGTH OF THE TURN LANE (AS SHOWN IN FIG. 1), USE FIGURE 1.
 - B) WHEN "L" IS > THE STORAGE LENGTH OF THE TURN LANE OR THE TURN LANE IS WITHIN THE LANE CLOSURE, USE FIGURE 2.
- 2. CONES MAY BE SUBSTITUTED FOR BARRICADES OR DRUMS AT HALF THE SPACING DURING DAY OPERATIONS. CONES SHALL BE A MINIMUM OF 28 (710) IN HEIGHT.
- 3. LIGHTS WILL NOT BE REQUIRED ON BARRICADES OR DRUMS FOR DAY OPERATIONS. ALL LIGHTS SHALL BE MONODIRECTIONAL.
- 4. REFLECTIVE TEMPORARY PAVEMENT MARKINGS SHALL BE PLACED THROUGHOUT THE BARRICADED AREAS OF EACH TURN BAY AS SHOWN WHERE THE CLOSURE TIME IS GREATER THAN FOURTEEN (14) DAYS.
- 5. THIS APPLICATION ALSO APPLIES WHEN WORK IS BEING PERFORMED IN THE RIGHT LANE(S) AND THE RIGHT TURN BAY IS TO REMAIN OPEN. UNDER THIS CONDITION, "RIGHT TURN LANE" R3-I100R 24 x 24 (600 x 600) AND M6-2R 21 \times 15 (530 \times 380) SHALL BE USED.
- 6. THESE CONTROLS SHALL SUPPLEMENT MAINLINE TRAFFIC CONTROL FOR LANE CLOSURES.
- 7. THE SIGNS SHALL BE MOUNTED ABOVE THE BARRICADES/DRUMS ON SEPARATE SIGN SUPPORTS THAT MEET NCHRP 350 OR MASH PREQUIREMENTS.
- 8. TRAFFIC CONTROL AND PROTECTION AT TURN BAYS (TO REMAIN OPEN TO TRAFFIC) SHALL BE INCLUDED IN THE COST OF SPECIFIED TRAFFIC CONTROL STANDARDS OR ITEMS.

TURN BAY ENTRANCE WITHIN A LANE CLOSURE

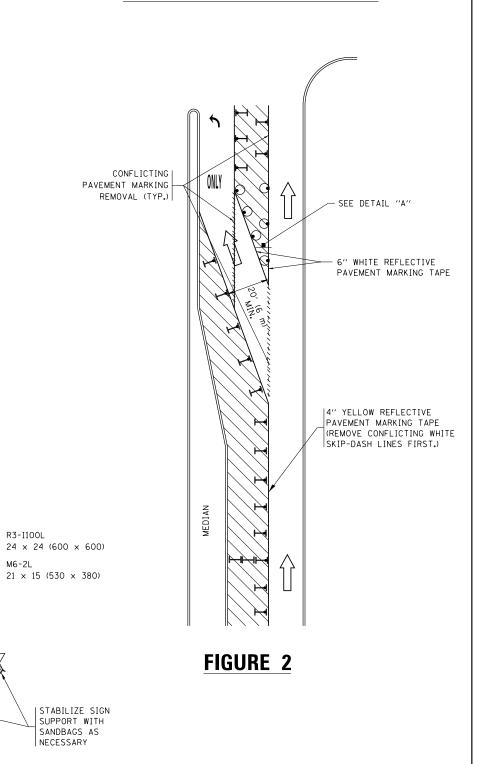


DETAIL A

TURN

LANE


All dimensions are in inches (millimeters) unless otherwise shown.

[FILE NAME =	USER NAME = footemj	REVISED -T. RAMMACHER 09-08-94	4 REVISED - R. BORO 09-14-09		TRAFFIC CONTROL AND PROTECTION AT TURN BAYS	F.A.	SECTION	COUNTY	TOTAL	SHEET NO.
	pw:\\ILØ84EBIDINTEG.:ll:nois.gov:PWIDOT\Do	cuments\IDOT Offices\District 1\Projects\Dist	t\$ t82%/\$42@ADData\C4QsHt4QU\$EH14.Ug07-95	REVISED - A. SCHUETZE 07-01-13	STATE OF ILLINOIS		1319	2020-140-RS&SW	соок	50	41
		PLOT SCALE = 50.0000 '/ in.	REVISED - A. HOUSEH 10-12-96	REVISED - A. SCHUETZE 09-15-16	DEPARTMENT OF TRANSPORTATION	(TO REMAIN OPEN TO TRAFFIC)		TC-14	CONTRACT	NO. (2M18
- 1	Default	PLOT DATE = 9/15/2016	REVISED -T. RAMMACHER 01-06-00	REVISED -		SCALE: NONE SHEET 1 OF 1 SHEETS STA. TO STA.		ILLINOIS FED.	AID PROJECT		

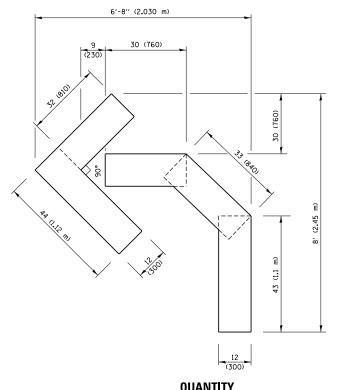


QUANTITY

4 (100) LINE = 45.5 ft. (13.9 m) 15.2 sq. ft. (1.41 sq. m)

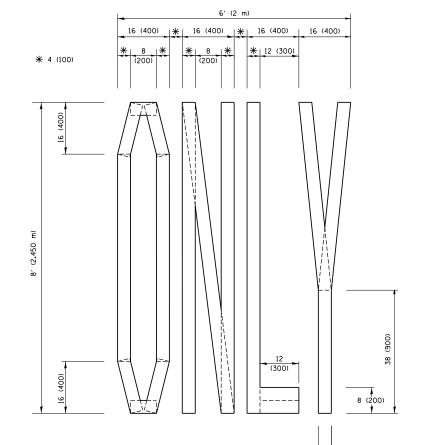

4 (100) LINE = 64.1 ft. (19.5 m) 21.4 sq. ft. (1.99 sq. m)

QUANTITY

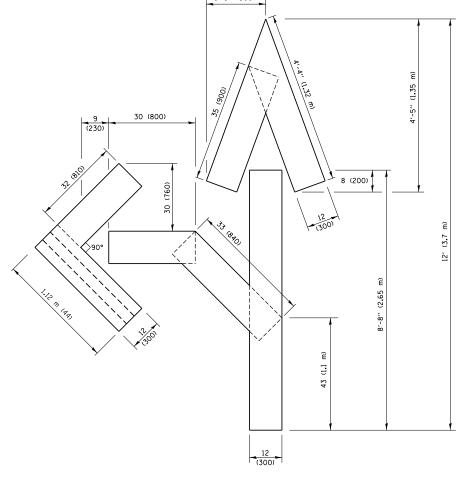


QUANTITY

4 (100) LINE = 82.5 ft. (25.1 m) 27.5 sq. ft. (2.53 sq. m)

NOTE:

ALL QUANTITIES OF PLACEMENT ARE REPRESENTED IN LINEAR FEET OF 4" LINES TO MATCH THE 4" TEMPORARY TAPE PAY ITEM AND REPRESENTS THE TOTAL QUANTITY OF 4" TAPE REQUIRED.

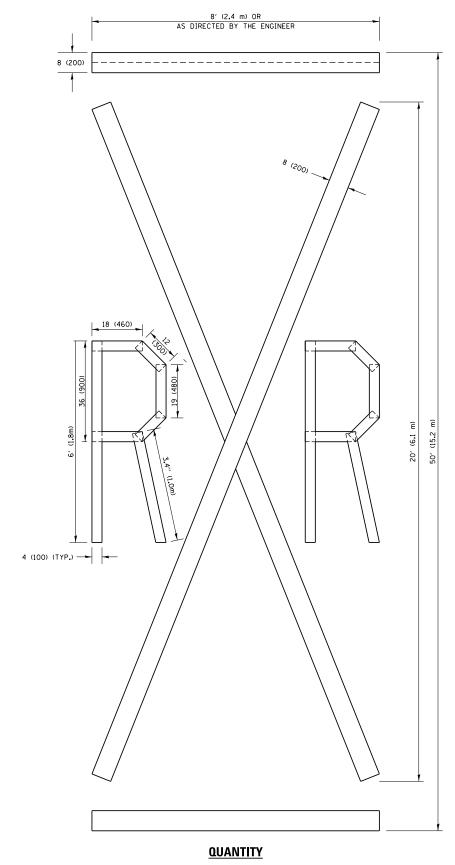

4 (100) LINE = 225.9 ft. (68.9 m) 75.3 sq. ft. (6.99 sq. m)

> All dimensions are in inches (millimeters) unless otherwise shown.


FILE NAME =	USER NAME = footemj	DESIGNED -	REVISED	-T. RAMMACHER 03-02-9
pw:\\ILØ84EBIDINTEG.:ll:nois.gov:PWIDOT\Do	cuments\IDOT Offices\District 1\Projects\Dist	t @R‰wm \CADData\CADsheets\tcl6.dgn	REVISED	-E. GOMEZ 08-28-00
	PLOT SCALE = 50.0000 '/ in.	CHECKED -	REVISED	-E. GOMEZ 08-28-00
	PLOT DATE = 9/15/2016	DATE - 09-18-94	REVISED	- A. SCHUETZE 09-15-16

STATE OF ILLINOIS **DEPARTMENT OF TRANSPORTATION**

				OVEREDOLO.		RTE.	SECTION				
SHORT TERM PAVEMENT MARKING LETTERS AND SYMBOLS					1319	2020-140-RS&SW	Γ				
										TC-16	Γ
CALE: NONE	SHEET	NO. 1	OF 1	SHEETS	STA.		TO STA.		FFD RO	AD DIST NO 1 THE INDIS FED A	ᇊ

COUNTY TOTAL SHEETS NO.

COOK 50 42 CONTRACT NO. 62M18

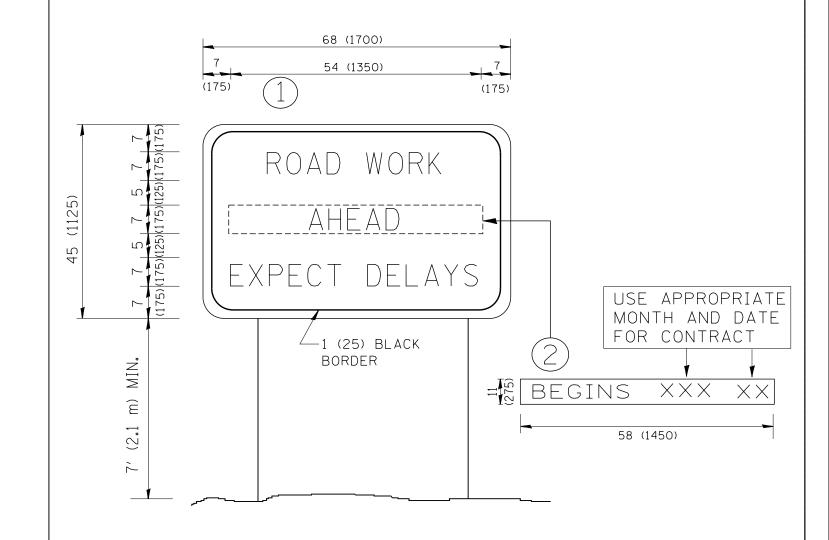

NOTES:

- 1. USE BLACK LETTERING ON ORANGE BACKGROUND.
- 2. ERECT SIGNS IN ADVANCE OF THE LOCATION FOR THE "ROAD CONSTRUCTION AHEAD" SIGN AT LOCATIONS AS DIRECTED BY THE ENGINEER.
- 3. ERECT SIGN (1) WITH INSTALLED PANEL (2) ONE WEEK PRIOR TO THE START OF CONSTRUCTION.
- 4. REMOVE PANEL 2) SOON AFTER THE START OF CONSTRUCTION.
- 5. SEE SPECIAL PROVISION FOR "TEMPORARY INFORMATION SIGNING" FOR ADDITIONAL INFORMATION.
- 6. ONE SIGN ASSEMBLY EQUALS 25.70 SQ. FT. (2.3 SQ. M.)
- 7. SHALL BE PAID FOR AS TEMPORARY INFORMATION SIGNING.


ALL DIMENSIONS ARE IN INCHES (MILLIMETERS) UNLESS OTHERWISE SHOWN.

FILE NAME =	USER NAME = gaglianobt	DESIGNED -	REVISED - R. MIRS 09-15-97	<u>.</u>		ARTERIAL ROAD		F.A	SECTION	COUNTY	TOTAL SHEET
W:\diststd\22x34\tc22.dgn		DRAWN -	REVISED - R. MIRS 12-11-97	STATE OF ILLINOIS				1319	2020-140-RS&SW	соок	50 43
	PLOT SCALE = 50.000 '/ IN.	CHECKED -	REVISED -T. RAMMACHER 02-02-99	DEPARTMENT OF TRANSPORTATION		INFORMATION SIGN			TC-22	CONTRACT	NO. 62M18
	PLOT DATE = 1/4/2008	DATE -	REVISED - C. JUCIUS 01-31-07		SCALE: NONE	SHEET NO. 1 OF 1 SHEETS STA.	TO STA.	FED. ROA	D DIST. NO. 1 ILLINOIS FED. AII	PROJECT	

LOOPS NEXT TO SHOULDERS PROVIDE A PAVEMENT REPLACEMENT NOTE WHICH SHOULD EQUAL 3' (900 mm) X WIDTH OF PAVED SHOULDER. PAVED OR NON-PAVED SHOULDER =6′ (1.8 m) (1.5 m) (1.8 m) (1.5 m) 1" (25 mm) UNI DUCT-TRENCHED (3.0 m) (3.0 m) * = (600 mm)* * UNIT DUCT IS TO BE SHOWN ON PLAN SHEETS BUT SHALL NOT BE INCLUDED IN THE PAY ITEMS. ARTERIAL-VOLUME DENSITY ("FAR OUT" DETECTION)

FILE NAME =

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PLAN SHEET FOR DETECTOR LOOP REPLACEMENT

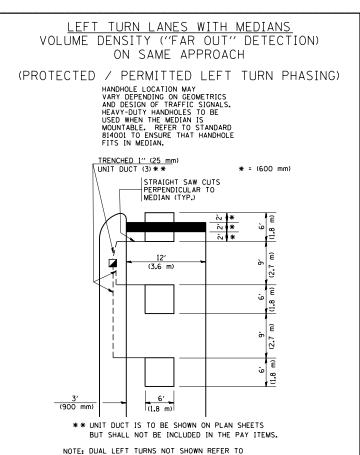VOLUME DENSITY ("FAR OUT" DETECTION)

ON SAME APPROACH

(PROTECTED / PERMITTED LEFT TURN PHASING)

* = (600 mm)


* = (600 mm)

* = (600 mm)

| 12' | (3.6 m) | 12' | (3.6 m)
| STRAIGHT SAW CUT TO HEAVY DUTY HANDHOLE (TYP.) PLACE HEAVY DUTY HANDHOLE BETWEEN FIRST AND SECOND LOOP AS SHOWN.

NOTE: DUAL LEFT TURNS NOT SHOWN REFER TO PLAN SHEET FOR DETECTOR LOOP REPLACEMENT

ARTERIAL-VOLUME DENSITY ("FAR OUT" DETECTION)
CROSS STREET-NON VOLUME DENSITY ("UPTIGHT" PRESENCE DETECTION)

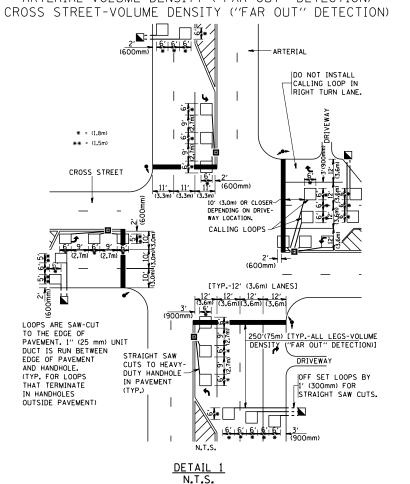

DESIGNED

CHECKED

R.K.F.

DRAWN

DATE

USER NAME = gaglianobt


PLOT DATE = 1/4/2008

REVISED

REVISED

REVISED

REVISED

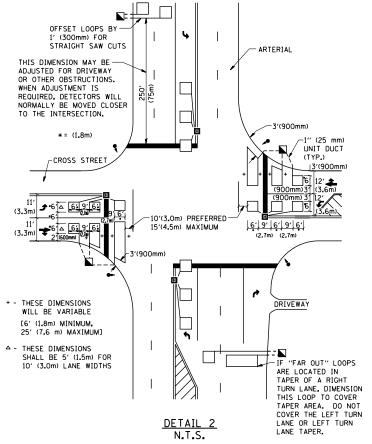

SCALE: NONE

NOTES:

VEHICLES LOOP DETECTORS

- * ALL LEAD IN CABLE SHALL BE TWO CONDUCTOR NO. 14 TWISTED, SHIFLDED.
- * EACH DETECTOR LOOP SHALL HAVE ITS OWN SAW CUT FROM THE LOOP TO THE EDGE OF PAVEMENT OR TO A HANDHOLE IN THE PAVEMENT.
- * EACH DETECTOR LOOP SHALL HAVE ITS OWN ONE INCH (25 mm) UNIT DUCT BETWEEN THE EDGE OF PAVEMENT AND THE FIRST HANDHOLE OR JUNCTION BOX, EACH UNIT DUCT RUN SHALL BE SHOWN ON THE PLANS BY THE DESIGNER, BUT SHALL NOT BE PAID FOR SEPARATLY. THIS ITEM IS INCIDENTAL TO THE PAY ITEM FOR DETECTOR LOOPS.
- * ONE DIMENSION OF <u>ALL</u> DETECTOR LOOPS SHALL BE SIX FEET (1.8 m)
- * EACH LANE OF NON-LOCKING, PRESENCE DETECTION AND EACH LANE OF A DOUBLE LEFT TURN LANE REQUIRES A SEPARATE INDUCTIVE LOOP DETECTOR AND LEAD IN CABLE.
- * WHEN NON-LOCKING, PRESENCE DETECTION IS USED, MORE THAN ONE LOOP PER LANE IS REQUIRED BEHIND THE STOP BAR (i.e. 1-1/2, 1-3/4, 2).
- * WHEN SYSTEM LOOPS ARE REQUIRED ON AN APPROACH OF AN INTERSECTION, THE LOOPS USED FOR VOLUME DENSITY AND INTERSECTION TIMING SHALL ALSO BE USED AS SYSTEM DETECTORS. EACH ONE OF THESE TYPE OF LOOPS REQUIRES A SEPARATE TWO CONDUCTOR NO. 14 TWISTED SHIELDED CABLE AND A SEPARATE INDUCTIVE LOOP DETECTOR WHEN NEW CONTROLLERS ARE UTILIZED. THE DESIGNER SHALL LABEL THESE TYPES OF LOOPS AS "INTERSECTION AND SAMPLING (SYSTEM) DETECTORS" ON THE SIGNAL LAYOUT, THE INTERCONNECT PLAN AND THE SYSTEM CABLE PLAN. WHEN AN EXISTING CONTROLLER IS UTILIZED FOR THIS TYPE OF DETECTION, THE PAY ITEM "INDUCTIVE LOOP DETECTOR WITH SYSTEM OUTPUT" SHOULD BE USED.

PLACEMENT OF DETECTORS

THE FOLLOWING FIGURES REPRESENT THE MOST COMMON DETECTOR LOOP LOCATIONS AND SIZES. ADJUSTMENTS WILL BE NECESSARY FOR SPECIFIC GEOMETRIC CONSIDERATIONS.

LOCATIONS AND DEMENSIONS OF DETECTOR LOOPS ARE REQUIRED ON ALL SIGNAL LAYOUT PLAN SHEETS.

"FAR OUT" DETECTION REFERS TO LOCKING, PRESENCE TYPE DETECTION LOCATED IN THRU LANES, RIGHT TURN LANES, AND RIGHT TURN LANE TAPER AREAS (IF APPLICABLE), USUALLY 250' (75 m) IN ADVANCE OF STOP BARS. "UPTIGHT" DETECTION REFERS TO NON-LOCKING PRESENCE TYPE DETECTION LOCATED IN ALL LANES AND 10'-15' (3.0 m-4.5 m) BEHIND THE CROSSING STREET'S EDGE OF PAVEMENT EXTENDED.


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ALL DETAILS AND NOTES SHOWN ARE FROM THE I.D.O.T. DISTRICT 1 TRAFFIC SIGNAL DESIGN GUIDELINES DATED JANUARY 1995


THIS DRAWING HAS BEEN PREPARED TO ASSIST THE RESIDENT ENGINEER FOR ALL ROADWAY RESURFACING OR S.M.A.R.T. PROJECTS WHERE THE DIMENSIONS ARE NOT SHOWN ON THE PLANS AND THE FINAL LOCATIONS FOR CROSSWALKS OR STOP BARS ARE NOT DETERMINED.

DISTRICT 1 – DE	ECTOR L	DOP INSTALL	ATION	F.A.P. RTE.	SEC.	TION	COUNTY TOTAL SHE		
DETAILS FOR	DO A DIA/	V DECLIDEAC	INC	1319	2020-140	-RS&SW	соок	50	44
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SHEET NO. 1 OF 1	SHEETS	STA.	TO STA.	FED. R	OAD DIST. NO. 1	ILLINOIS FED. A	ID PROJECT		


PD-01A

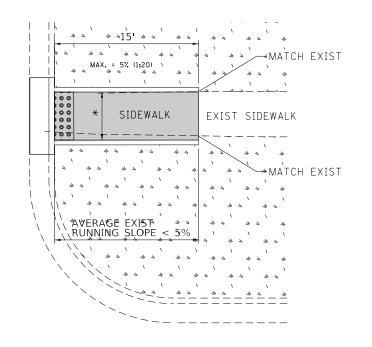

PD-01B

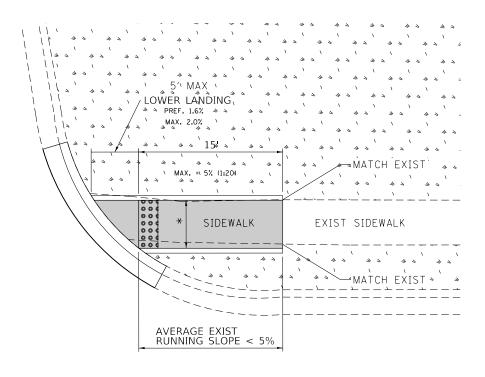

PD-01C

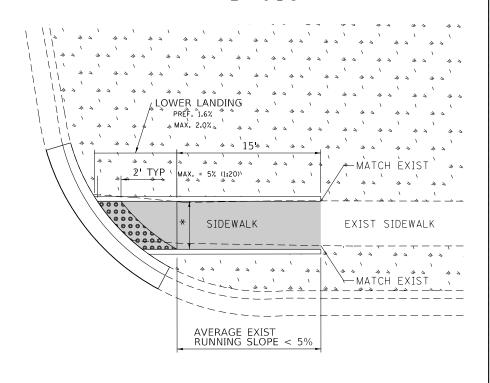

DESIGNER NOTES:

- 1) ALL CROSS SLOPES ARE PREFERRED 1.6% (1:64), MAXIMUM 2% (1:50).
- SIDEWALK REALIGNMENT WILL REQUIRE DETAILED DESIGN.
- 3) AREAS SURROUNDED BY PCC/ASPHALT, BUILDINGS, OR ARE NEAR TO DRIVEWAYS, REALIGNED SIDEWALK, UTILITY AND SIGNAL POLES, OR WHEN PRIVATE SIDEWALK TIES IN, WILL REQUIRE DETAILED SURVEY AND DESIGN.
- 4) ALL BRICK CORNERS WILL REQUIRE SUPERVISOR APPROVAL BEFORE USING PROJECT

LEGEND

PROPOSED SIDE CURB



EXIST. GRASS



PROPOSED SIDEWALK



DETECTABLE WARNINGS

CONSTRUCTION NOTES:

1) ALL CROSS SLOPES ARE PREFERRED 1.6% (1:64), MAXIMUM 2% (1:50) EXCEPT WHEN TRANSITIONING TO EXISTING SIDEWALK

COOK 50 45


CONTRACT NO.


* MATCH EXISTING SIDEWALK WIDTH


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	PROJECT	F.A. SECTION						
		1319	2020-140-RS&SW					
		PD-01						
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ADA DETAIL FOR SINGLE PERPENDICULAR CURB RAMPS W/ EXIST. 5% OR GREATER RUN. SLOPE





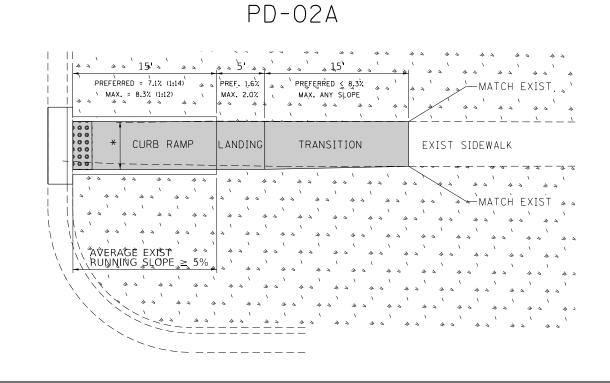

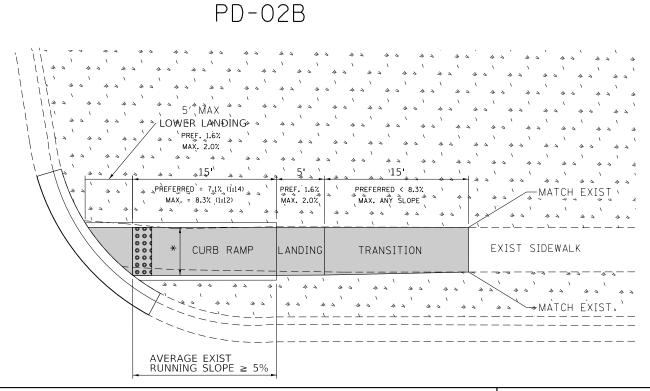DESIGNER NOTES:

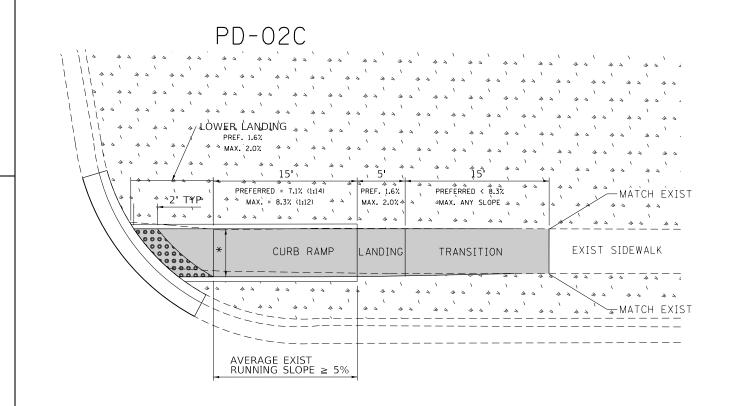- ALL CROSS SLOPES ARE PREFERRED 1.6% (1:64), MAXIMUM 2% (1:50).
- SIDEWALK REALIGNMENT WILL REQUIRE DETAILED DESIGN.
- AREAS SURROUNDED BY PCC/ASPHALT, BUILDINGS, OR ARE NEAR TO DRIVEWAYS, REALIGNED SIDEWALK, UTILITY AND SIGNAL POLES, OR WHEN PRIVATE SIDEWALK TIES IN, WILL REQUIRE DETAILED SURVEY AND DESIGN.
- ALL BRICK CORNERS WILL REQUIRE SUPERVISOR APPROVAL BEFORE USING PROJECT DETAILS

LEGEND

PROPOSED SIDE CURB

EXIST. GRASS

PROPOSED SIDEWALK

DETECTABLE WARNINGS

SCALE:

CONSTRUCTION NOTES:

- 1) ALL CROSS SLOPES ARE PREFERRED 1.6% (1:64), MAXIMUM 2% (1:50) EXCEPT WHEN TRANSITIONING TO EXISTING SIDEWALK
- * MATCH EXISTING SIDEWALK WIDTH

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PROJECT	DETAIL	FOR	R SINGLE PERPENDICULA		ENDICULAR	CURB	JRB RAMPS F.A. SECTION C		COUNTY	TOTAL SHEETS	SHEET NO.	
(PD-02)							1319	2020-140-RS&SW	COOK	50	46	
(I D-02)								PD-02 CONTRACT NO.				
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ADA DETAIL FOR DOUBLE PERPENDICULAR CURB RAMPS PD-03B PD-03A `LANDÌNG» » PREF. 1.6% \ PREF. 1.6% \ LANDSCAPE OR PCC AREA LANDSCAPE OR PCC AREA LANDING PREF. 1.6% \ PREF. 1.6% \ **MAX. 2.0%** **AATCH EXIST MATCH EXIST TRANSITION TRANSITION * EXIST SIDEWALK * EXIST SIDEWALK PREFERRED < 8.3% PREFERRED < 8.3% MATCH EXIST ₩ATCH EXIST MAX. ANY SLOPE MAX. ANY SLOPE 44 44 44 REFERRED` = 7.1% (1:14) \ \ REFERRED = 7.1% (1:14) RRÉD ANÝ MAX. = 8.3% (1:12) IAX. = 8.3% (1:12) GRASS BUFFER GRASS'BUFFER SIDEWALK EXIST SIDEWALK - — — — <u>- — - — - </u> E_XIST -ĒXIST MÀTCH E MUST BE EXIST. LANDSCAPED SURFACE. EXIST. CONCRETE SURFACE WILL REQUIRE - MUST BE EXIST. LANDSCAPED SURFACE. EXIST. CONCRETE SURFACE WILL REQUIRE DETAILED DESIGN 2 MIN 2 MIN. LEGEND CONSTRUCTION NOTES: **DESIGNER NOTES:** EXIST. GRASS ALL CROSS SLOPES ARE PREFERRED 1.6% (1:64), MAXIMUM 2% (1:50). 1) ALL CROSS SLOPES ARE PREFERRED 1.6% (1:64), MAXIMUM 2% (1:50) EXCEPT WHEN SIDEWALK REALIGNMENT WILL REQUIRE DETAILED DESIGN. TRANSITIONING TO EXISTING SIDEWALK AREAS SURROUNDED BY PCC/ASPHALT, BUILDINGS, OR ARE NEAR TO DRIVEWAYS, PROPOSED SIDEWALK REALIGNED SIDEWALK, UTILITY AND SIGNAL POLES, OR WHEN PRIVATE SIDEWALK TIES IN, WILL REQUIRE DETAILED SURVEY AND DESIGN. PROPOSED SIDE CURB * MATCH EXISTING SIDEWALK WIDTH ALL BRICK CORNERS WILL REQUIRE SUPERVISOR APPROVAL BEFORE USING PROJECT DETAILS DETECTABLE WARNINGS FILE NAME = DESIGNED -REVISED COUNTY PROJECT DETAIL FOR DOUBLE PERPENDICULAR CURB RAMPS STATE OF ILLINOIS S:\WP\PLANPREP\SQUAD_1\Des_RL\Tupical ADA details\Tupical-ADA-sht-plan.dom DRAWN - RL REVISED COOK 50 47 2020-140-RS&SW 1319 CHECKED REVISED **DEPARTMENT OF TRANSPORTATION** PD-03 CONTRACT NO. SHEETS STA. PLOT DATE = 11/12/2019 SHEET

ADA DETAIL FOR SINGLE PERPENDICULAR CURB RAMPS W/ TURNING SPACE PD-04B PD-04A LANDÌNG» » LANDÌNGℷ MAX. 2.0% LANDING . . ' PREF. 1.6% \ ✓× MATCH EXIST /* MATCH EXIST CURB RAMP TRANSITION CURB RAMP TRANSITION * EXIST SIDEWALK * EXIST SIDEWALK PREFERRED = 7.1% (1:14) PREFERRED = 7.1% (1:14) MAX. = 8.3% (1:12) MAX. = 8.3% (1:12) , PREFERRED < 8.3% PREFERRED < 8.3% MATCH EXIST & N MATCH EXIST MAX. ANY SLOPE MAX. ANY SLOPE RRÉD < 8.3% ANÝ SLOPE RRÉD ANÝ , || \ || 2' Mink MATCH EXIST. SIDEWALK SIDEWALK ÉXIST. ÉXIST. ,MATČH MUST BE EXIST. LANDSCAPED SURFACE. EXIST. CONCRETE SURFACE WILL REQUIRE MUST BE EXIST. LANDSCAPED SURFACE. EXIST. CONCRETE SURFACE WILL REQUIRE || > > EXIST DETAILED DESIGN DETAILED DESIGN 2' MIN. LEGEND CONSTRUCTION NOTES: EXIST. GRASS ALL CROSS SLOPES ARE PREFERRED 1.6% (1:64), MAXIMUM 2% (1:50) EXCEPT WHEN ALL CROSS SLOPES ARE PREFERRED 1.6% (1:64), MAXIMUM 2% (1:50). SIDEWALK REALIGNMENT WILL REQUIRE DETAILED DESIGN. TRANSITIONING TO EXISTING SIDEWALK AREAS SURROUNDED BY PCC/ASPHALT, BUILDINGS, OR ARE NEAR TO DRIVEWAYS, PROPOSED SIDEWALK REALIGNED SIDEWALK, UTILITY AND SIGNAL POLES, OR WHEN PRIVATE SIDEWALK TIES IN, WILL REQUIRE DETAILED SURVEY AND DESIGN. PROPOSED SIDE CURB * MATCH EXISTING SIDEWALK WIDTH ALL BRICK CORNERS WILL REQUIRE SUPERVISOR APPROVAL BEFORE USING PROJECT DETECTABLE WARNINGS DETAILS COUNTY TOTAL SHEET NO. COOK 50 48 FILE NAME = DESIGNED -REVISED PROJECT DETAIL FOR SINGLE PERPENDICULAR CURB RAMPS STATE OF ILLINOIS S:\WP\PLANPREP\SQUAD_1\Des_RL\Tupical 4 A details\Tupical-ADA-sht-plan.do DRAWN - RL REVISED 2020-140-RS&SW 1319 W/TURNING SPACE (PD-04) CHECKED REVISED **DEPARTMENT OF TRANSPORTATION** PD-04 CONTRACT NO.

PLOT DATE = 11/12/2019

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ADA DETAIL FOR DEPRESSED CORNER CURB RAMPS PD-05A PD-05B AVERAGE EXIST RUNNING SLOPE ≥ 5% RUNNING SLOPE < 5% DEPR. CORNF PREF MATCH EXIST CURB RAMP LANDING TRANSITION EXIST SIDEWALK DEPR. PREFERRED < 8.3% \ MAX. ANY SLOPE > ► MATCH EXIST 👢 * 15' * * RAMP AVERAGE EXIST RUNNING SLOPE MAX. 2.0% SIDEWALK EXIST SIDEWALK MATCH EXIST MAX. = 5% (1:20) LANDING PREF. 1.67. MAX. 2.07. -MUST BE EXIST. LANDSCAPED SURFACE. EXIST. CONCRETE PREFERRED < 8.3%" "MAX. ANY SLOPE " , " 1 - " SURFACE WILL REQUIRE EXIST EXIST. SIDEWALK "MATCH MUST BE EXIST. LANDSCAPED SURFACE. EXIST. CONCRETE SURFACE WILL REQUIRE EXIST DETAILED DESIGN 2' MIN EXIST > 111 EXISŢ 2 MIN EXIST LEGEND CONSTRUCTION NOTES: EXIST. GRASS ALL CROSS SLOPES ARE PREFERRED 1.6% (1:64), MAXIMUM 2% (1:50) EXCEPT WHEN ALL CROSS SLOPES ARE PREFERRED 1.6% (1:64), MAXIMUM 2% (1:50). SIDEWALK REALIGNMENT WILL REQUIRE DETAILED DESIGN. TRANSITIONING TO EXISTING SIDEWALK AREAS SURROUNDED BY PCC/ASPHALT, BUILDINGS, OR ARE NEAR TO DRIVEWAYS, PROPOSED SIDEWALK REALIGNED SIDEWALK, UTILITY AND SIGNAL POLES, OR WHEN PRIVATE SIDEWALK TIES IN, WILL REQUIRE DETAILED SURVEY AND DESIGN. PROPOSED SIDE CURB * MATCH EXISTING SIDEWALK WIDTH ALL BRICK CORNERS WILL REQUIRE SUPERVISOR APPROVAL BEFORE USING PROJECT DETECTABLE WARNINGS DETAILS COUNTY TOTAL SHEET NO. COOK 50 49 FILE NAME = DESIGNED -REVISED SECTION PROJECT DETAIL FOR DEPRESSED CORNER CURB RAMPS STATE OF ILLINOIS S:\WP\PLANPREP\SQUAD_1\Des_RL\Tupical 4 A details\Tupical-ADA-sht-plan.do DRAWN - RL REVISED 2020-140-RS&SW 1319 (PD-05) CHECKED REVISED **DEPARTMENT OF TRANSPORTATION** PD-05 CONTRACT NO.

PLOT DATE = 11/12/2019

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