03-05-2021 LETTING ITEM 097

FOR INDEX OF SHEETS SEE SHEET NO. 2

SEE SHEET NO. 2

FOR LIST OF HIGHWAY STANDARDS

950 ADT (2016)

FAU 1710 (123RD STREET)

FUNCTIONAL CLASSIFICATION: MINOR COLLECTOR

0.7% TRUCKS
POSTED SPEED LIMIT = 20 MPH

STATE OF ILLINOIS **DEPARTMENT OF TRANSPORTATION**

PLANS FOR PROPOSED FEDERAL AID HIGHWAY

FAU 1710 (123RD STREET) 76TH AVENUE TO HARLEM AVENUE RECONSTRUCTION **SECTION 15-00053-00-PV PROJECT 0M80(991) CITY OF PALOS HEIGHTS COOK COUNTY**

JOB NO. C-91-423-15 RANGE 12 EAST

END PROJECT 123RD STREET STA 26+07 **BEGIN PROJECT** 123RD STREET STA 0+14

1"-10"

FULL SIZE PLANS HAVE BEEN PREPARED USING STANDARD ENGINEERING SCALES REDUCED SIZED PLANS WILL NOT CONFORM TO STANDARD SCALES IN MAKING MEASUREMENTS ON REDUCED PLANS, THE ABOVE SCALES MAY BE USED.

SCALES (PLAN

CROSS-SECTIONS HORIZ. CROSS-SECTIONS VERT.


1 INCH = 20 FEET 1 INCH = 10 FEET 1 INCH = 5 FEET

Cell Hefore You Dig 800.892.0123

LOCATION MAP

MAP SCALE: N.T.S. - - DENOTES PROJECT LOCATION GROSS AND NET LINGTH OF PROJECT = 2.593 FEET (0.49 MILE) | SECTION | SECTION | STATE | SECTION | SECTIO

P-91-423-15 D-91-423-15

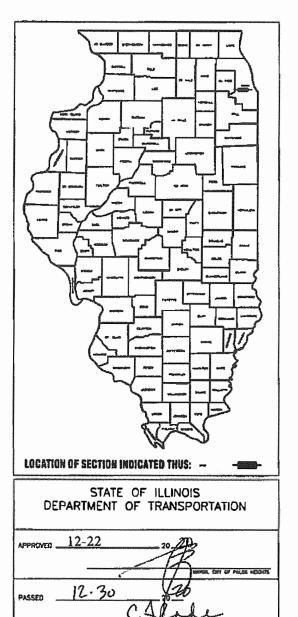



SIGNED 17/77/2020 EXPIRES 11/70/2021

PRINTED BY THE AUTHORITY OF THE STATE OF ILLINOIS

CONTRACT NO. 61G81

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- 9-10) REMOVAL PLAN
- 11-15) PLAN & PROFILE ROADWAY, PAVEMENT MARKING, & SIGNING
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 - 22) ADA RAMP DETAILS
- 23-27) PLAN & PROFILE WATERMAIN
- 28-29) GRADING & EROSION CONTROL PLANS
- 30-37) DETAILS
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LIST OF ILLINOIS DOT HIGHWAY STANDARDS

000001-08	STANDARD SYMBOLS, ABBREVIATIONS, AND PATTERNS
280001-07	TEMPORARY EROSION CONTROL SYSTEMS
424001-11	PERPENDICULAR CURB RAMPS FOR SIDEWALKS
542301-03	PRECAST REINFORCED CONCRETE FLARED END SECTION
601001-05	PIPE UNDERDRAINS
602001-02	CATCH BASIN TYPE A
602301-04	INLET TYPE A
604036-03	GRATE TYPE 8
701001-02	OFF-ROAD OPERATIONS, 2L, 2W, MORE THAN 15' (4.5M) AWAY
701006-05	OFF-ROAD OPERATIONS, 2L, 2W, 15' (4.5 m) TO 24" (600 mm) FROM PAVEMENT EDGE
701301-04	LANE CLOSURE, 2L, 2W, SHORT TIME OPERATIONS
701311-03	LANE CLOSURE 2L, 2W MOVING OPERATIONS - DAY ONLY
701501-06	URBAN LANE CLOSURE, 2L, 2W, UNDIVIDED
701801-06	SIDEWALK, CORNER, OR CROSSWALK CLOSURE
701901-08	TRAFFIC CONTROL DEVICES
780001-05	TYPICAL PAVEMENT MARKINGS

DISTRICT ONE DETAILS

BD-01	DRIVEWAY DETAILS — DISTANCE BETWEEN ROW AND FACE, FACE OF CURB & EDGE OF SHOULDER 15' (4.5 M)
BD-32	BUTT JOINT AND HMA TAPER DETAILS
TC-10	TRAFFIC CONTROL AND PROTECTION FOR SIDE ROADS, INTERSECTIONS, AND DRIVEWAYS
TC-13	DISTRICT ONE TYPICAL PAVEMENT MARKINGS
TC-21	DETOUR SIGNING FOR CLOSING STATE HIGHWAYS
TC-22	ARTERIAL ROAD INFORMATION SIGN
TC-26	DRIVEWAY ENTRANCE SIGNING

GENERAL NOTES

- 1. THE CONTRACTOR SHALL BE RESPONSIBLE FOR PROVIDING SAFE AND HEALTHFUL WORKING CONDITIONS IN ACCORDANCE WITH SECTION 107 OF THE STANDARD SPECIFICATIONS FOR ROAD AND BRIDGE CONSTRUCTION THROUGHOUT THE CONSTRUCTION OF THE PROPOSED IMPROVEMENTS.
- 2. SOIL EROSION AND SEDIMENTATION CONTROL PRACTICES AND DEVICES SHALL BE IN ACCORDANCE WITH THE LATEST EDITION OF THE URBAN COMMITTEE OF THE ASSOCIATION OF ILLINOIS SOIL AND WATER CONSERVATION DISTRICTS' PROCEDURES AND STANDARDS FOR URBAN SOIL EROSION AND SEDIMENTATION CONTROL IN ILLINOIS AND ALL REVISIONS THERETO AND IN ACCORDANCE WITH THE DETAILS ON THE PLANS.
- 3. THE CONTRACTOR SHALL BE AWARE OF POTENTIAL CONFLICTS WITH EXISTING UTILITIES AS INDICATED ON THE PLANS. THE CONTRACTOR SHALL EXCAVATE AROUND UTILITIES TO DETERMINE ELEVATIONS BEFORE BEGINNING CONSTRUCTION.
- 4. THE CONTRACTOR SHALL BE RESPONSIBLE FOR NOTIFYING EACH OF THE UTILITY COMPANIES BEFORE ANY WORK COMMENCES. ALL UTILITIES SHALL BE STAKED PRIOR TO CONSTRUCTION
- 5. THE OWNER WILL FURNISH THE CONTRACTOR WITH LINES, GRADES AND ELEVATIONS NECESSARY TO THE PROPER EXECUTION AND CONTROL OF THE WORK ONCE.
- 6. THE CONTRACTOR SHALL INFORM THE ENGINEER, CITY OF PALOS HEIGHTS AT LEAST FORTY-EIGHT (48) HOURS PRIOR TO COMMENCEMENT OF CONSTRUCTION.

TELEPHONE NUMBERS: ENGINEER - (630) 271-0770 PALOS HEIGHTS - (708) 361-1806

- 7. WHERE SHOWN ON THE PLANS OR DIRECTED BY THE ENGINEER, EXISTING DRAINAGE STRUCTURES AND SYSTEMS SHALL BE CLEANED OF DEBRIS AND PATCHED AS NECESSARY TO ASSURE INTEGRITY OF THE STRUCTURE. THIS WORK WILL BE PAID FOR AT THE CONTRACT UNIT PRICE PER EACH FOR STRUCTURES AND CONTRACT UNIT PRICE PER LINEAL FOOT FOR SYSTEMS WHICH SHALL BE PAYMENT IN FULL FOR CLEANING, PATCHING, REMOVAL AND DISPOSAL OF DEBRIS AND DIRT. DRAINAGE STRUCTURES AND SYSTEMS CONSTRUCTED AS PART OF THIS PROJECT SHALL BE MAINTAINED BY THE CONTRACTOR AT HIS EXPENSE UNTIL FINAL ACCEPTANCE BY THE OWNER OR COUNTY.
- 8. THE CONTRACTOR SHALL KEEP PUBLIC STREET PAVEMENTS CLEAN OF DIRT AND DEBRIS AND, WHEN NECESSARY, SHALL ON A DAILY BASIS CLEAN THE PAVEMENT OF SUCH DIRT AND DEBRIS RESULTING FROM CONSTRUCTION OPERATIONS.
- 9. THE CONTRACTOR SHALL PROVIDE PIPE BEDDING IN ACCORDANCE WITH THE DETAIL ON THE PLANS. THE COST OF THE BEDDING SHALL BE INCLUDED IN THE UNIT PRICE PER LINEAL FOOT OF THE VARIOUS SIZES OF STORM SEWER.
- 10. THE CONTRACTOR SHALL PLACE TOPSOIL AT A 4" MINIMUM DEPTH AND SEED OR SOD ALL AREAS DESIGNATED BY THE ENGINEER.
- 11. THE CONTRACTOR SHALL EXAMINE THE DRAINAGE PATTERNS SHOWN ON THE PLANS AND MAKE CERTAIN THAT ALL OVERFLOW POINT ELEVATIONS AND CROSS SECTIONS ARE CONSTRUCTED STRICTLY IN ACCORDANCE WITH THOSE SHOWN ON THE PLANS.
- 12. ALL CONSTRUCTION SHALL CONFORM WITH THE PERMIT PLANS AND REVISIONS THERETO APPROVED BY COOK COUNTY.
- 13. THE CONTRACTOR SHALL CONTACT J.U.L.I.E. (1-800-892-0123) PRIOR TO ANY WORK IN THE RIGHT OF WAY OR EASEMENTS TO LOCATE UTILITIES, AND CONTACT THE OWNER'S REPRESENTATIVE SHOULD PUBLIC UTILITIES APPEAR TO BE IN CONFLICT WITH THE PROPOSED IMPROVEMENTS.
- 14. ALL WORK HEREIN PROPOSED SHALL BE COMPLETED IN ACCORDANCE WITH THE REQUIREMENTS OF THE STATE OF ILLINOIS ENVIRONMENTAL PROTECTION AGENCY, COOK COUNTY PUBLIC WORKS DEPARTMENT, THE MUNICIPALITY, AND ALL PERTINENT LAWS, DIRECTIVES, ORDINANCES AND THE LIKE SHALL BE CONSIDERED TO BE A PART OF THESE SPECIFICATIONS.
- 15. THE APPROXIMATE LOCATION OF KNOWN PUBLIC UTILITIES ARE SHOWN ON THE PLANS. HOWEVER, THE ENGINEER DOES NOT GUARANTEE ITS ACCURACY. THE CONTRACTOR SHALL BE RESPONSIBLE FOR NOTIFYING EACH OF THE UTILITY COMPANIES BEFORE ANY WORK COMMENCES.
- 16. ALL PROPOSED ELEVATIONS SHOWN ARE RELATIVE TO U.S.G.S. DATUM NAVD88.

- 17. THE CONTRACTOR SHALL TAKE CARE TO PROTECT ALL SIGNS ALONG THE ROUTE OF CONSTRUCTION. SIGNS SHALL BE REMOVED IF THEY ARE IN CONFLICT WITH PROPOSED WORK, AND APPROVED BY ENGINEER. THE CONTRACTOR SHALL NOTIFY THE ENGINEER OF ANY EXISTING DAMAGE TO A SIGN PRIOR TO REMOVAL. THE CONTRACTOR SHALL REPLACE ALL SIGNS AND POSTS DAMAGED AFTER REMOVAL.
- 18. DIRT ON PAVEMENT WHERE A CONTRACTOR'S EQUIPMENT IS OPERATED UPON AN EXISTING PAVEMENT USED BY TRAFFIC THE CONTRACTOR SHALL CLEAN THE PAVEMENT OF ALL DIRT AND DEBRIS AT THE END OF EACH DAY'S OPERATIONS AND AT OTHER TIMES AS DIRECTED BY THE OWNER, THE ENGINEER, OR THE GOVERNING MUNICIPALITY.
- 19. GEOTECHNICAL FABRIC FOR GROUND STABILIZATION AND/OR AGGREGATE SUBGRADE IMPROVEMENT (CU YD) HAVE BEEN PROVIDED FOR USE AT THE LOCATIONS INDICATED FOR SOILS THAT TEND TO BE UNSTABLE AND/OR UNSUITABLE. THE ACTUAL NEED FOR REMOVAL AND REPLACEMENT WITH ABOVE ITEM WILL BE DETERMINED IN THE FIELD AT THE TIME OF CONSTRUCTION BY THE GEOTECHNICAL ENGINEER. ALL POTENTIALLY UNSTABLE SOILS SHOULD BE TESTED WITH A STATIC OR DYNAMIC CONE PENETROMETER AND TREATED IN ACCORDANCE WITH ARTICLE 301.04 OF THE SSRBC AND IDOT SUBGRADE STABILITY MANUAL. IF UNSTABLE AND/OR UNSUITABLE SOILS ARE NOT ENCOUNTERED, THEN THE QUANTITY SHALL BE DEDUCTED, AND NO ADDITIONAL COMPENSATION WILL BE DUE TO THE CONTRACTOR.
- 20. ANY AGGREGATE SUBGRADE IMPROVEMENT CONTAMINATED AND/OR DAMAGED BY THE CONTRACTOR'S VEHICLES AND/OR EQUIPMENTS IS TO BE REMOVED AND REPLACED AS DIRECT BY THE ENGINEER AT CONTRACTOR EXPENSE.
- 21. PIPE UNDERDRAINS SHALL BE INSTALLED ACCORDING TO SECTION 601 OF THE SSRBC AND STANDARD 601001-05. TOP OF PIPE UNDERDRAINS SHALL BE PLACED MINIMUM 6" BELOW THE AGGREGATE SUBGRADE IMPROVEMENT LAYER. THE COST OF MAKING PIPE UNDERDRAINS CONNECTIONS TO DRAINAGE STRUCTURES SHALL BE INCLUDED IN THE COST OF THE PIPE UNDERDRAINS.
- 22. BACKFILLING STORM SEWER CONSTRUCTED UNDER THE ROADWAY SPECIFIED UNDER ART. 550.07(b, c) OF THE SSRBC WILL NOT BE ALLOWED.

COMMITMENTS

NO COMMITMENTS

USER NAME =	DESIGNED - AS	REVISED -
	DRAWN - DJB	REVISED -
PLOT SCALE =	CHECKED - AS	REVISED -
PLOT DATE = Jan 26, 2021	DATE -	REVISED -

STATE OF ILLINOIS
DEPARTMENT OF TRANSPORTATION

SCALE:

	INDEX OF SHEETS	S, STA	NDARDS LIS	 Г,	F.A.U. RTE.	SECTION	COUNTY	TOTAL SHEETS	SHEE NO.
GENERAL NOTES, & COMMITMENTS		1710	15-00053-00-PV	COOK	46	2			
			TOTAL CO	CONTRACT	NO. 6	1G81			
	SHEET NO. 1 OF 2 S	SHEETS	STA.	TO STA.		ILLINOIS FED. AI	D PROJECT		

WATERMAIN NOTES

- ALL SANITARY SEWER AND WATERMAIN WORK SHALL BE CONSTRUCTED IN ACCORDANCE WITH THE APPLICABLE SECTIONS OF THE STANDARD SPECIFICATIONS FOR WATER AND SEWER MAIN CONSTRUCTION IN ILLINOIS, LATEST EDITION. ENGLISH UNITS SHALL BE USED.
- 2. THE CONTRACTOR SHALL NOTIFY ALL UTILITY COMPANIES PRIOR TO CONSTRUCTION TO VERIFY IN THE FIELD THE LOCATIONS OF ALL EXISTING AND UNDERGROUND UTILITIES ADJACENT TO THE PROJECT, AND BE RESPONSIBLE FOR PROTECTION OF SAME. THE CONTRACTOR SHALL ALSO NOTIFY THE OWNER AND MORRIS ENGINEERING, INC. AT LEAST 48 HOURS PRIOR TO START OF CONSTRUCTION.
- 3. THE CONTRACTOR SHALL BEWARE OF POTENTIAL CONFLICTS WITH EXISTING UTILITIES AS INDICATED ON THE PLANS. THE CONTRACTOR SHALL EXCAVATE AROUND UTILITIES TO DETERMINE LOCATIONS AND ELEVATIONS OF ALL POTENTIALLY CONFLICTING UTILITIES BEFORE BEGINNING CONSTRUCTION.
- 4. ALL EXISTING FIELD DRAINAGE TILES ENCOUNTERED OR DAMAGED DURING CONSTRUCTION SHALL BE RESTORED TO THEIR ORIGINAL CONDITION, PROPERLY REROUTED AND/OR CONNECTED TO THE STORM SYSTEM. ALL LOCATIONS OF ENCOUNTERED FIELD DRAINAGE TILE SHALL BE PROPERLY INDICATED ON THE RECORD SET OF DRAWINGS.
- 5. THE CONTRACTOR RESPONSIBLE FOR SANITARY AND WATERMAIN IMPROVEMENTS (UNDERGROUND STRUCTURES AND CONDUITS) SHALL DISPOSE OF ALL SURPLUS EXCAVATED MATERIAL FROM TRENCHES OR STRUCTURE EXCAVATIONS AND SHALL DEPOSIT SAID SURPLUS MATERIALS ON THE SITE IN ACCORDANCE WITH THE GRADING PLAN OR AS DIRECTED BY THE ENGINEER.
- 6. ALL EXISTING UTILITIES OR IMPROVEMENTS, INCLUDING WALKS, CURBS, PAVEMENT AND PARKWAYS DAMAGED OR REMOVED DURING CONSTRUCTION SHALL BE PROMPTLY RESTORED TO THEIR RESPECTIVE ORIGINAL CONDITION.
- 7. ANY EXISTING UTILITY STRUCTURES REQUIRING ADJUSTMENT SHALL BE ADJUSTED (UP TO 8" TOTAL ADJUSTMENT) OR RECONSTRUCTED BY THE CONTRACTOR.
- 8. SANITARY SEWERS AND WATERMAIN SHALL HAVE A MINIMUM OF 5.5 FEET OF COVER AND SHALL BE RUN IN STRAIGHT ALIGNMENT BETWEEN STRUCTURES UNLESS SPECIFICALLY SHOWN OTHERWISE ON THE PLANS.
- ALL WATERMAIN SHALL BE CEMENT LINED DUCTILE IRON PIPE, CLASS 52 CONFORMING TO AWWA C-150 WITH PUSH-ON OR MECHANICAL JOINTS.
- 10. VALVE VAULT FRAMES AND LIDS SHALL BE NEENAH R1772-C OR APPROVED EQUAL WITH LIDS IMPRINTED "WATER".
- 11. POLYETHYLENE FILM WRAP FOR WATERMAIN IN ACCORDANCE WITH AWWA C-105-82 SHALL BE PLACED OVER ALL WATER MAIN SUCH THAT THE WATER MAIN SHALL NOT BE IN DIRECT CONTACT WITH THE TRENCH SOIL. THIS ITEM WILL BE INCIDENTAL TO THE WATERMAIN.
- 12. ALL WATER MAINS SHALL BE PRESSURE TESTED AND DISINFECTED IN ACCORDANCE WITH STANDARDS AND PROCEDURES MEETING THE APPROVAL OF THE CITY OF PALOS HEIGHTS. THE COST OF TESTING AND DISINFECTION SHALL BE INCLUDED IN THE COST OF WATERMAIN INSTALLATION.
- 13. WATERMAIN DISINFECTIONS SHALL BE PERFORMED BY FLUSHING, THEN CHLORINATING AT A RATE OF 50 PPM TO INSURE A RESIDUAL OF 25 PPM AFTER 24 HOURS. THEN AFTER A SECOND FLUSHING A MINUMUM OF TWO WATER SAMPLES ON TWO CONSECUTIVE DAYS 24 HOURS APART SHALL BE TAKEN TO AN APPROVED TESTING SERVICE.

- 14. THE CONTRACTOR SHALL PROVIDE A SAMPLING TAP IF REQUIRED AT NO EXTRA COST.
- 15. FIRE HYDRANTS SHALL BE OF THE TYPE SHOWN ON THE WATER DETAIL SHEET OF THE PLANS.
- 16. ALL WATER SERVICE LINES SHALL BE CLASS "K" COPPER OR DUCTILE IRON PIPE (CLASS 52) AWWA-C600 WITH "PUSH ON" JOINTS, CEMENT LINED IN ACCORDANCE WITH ASA A21.04.
- 17. CONNECTIONS TO EXISTING SANITARY SEWER AND WATER SYSTEMS SHALL BE PAID AT THE CONTRACT UNIT PRICE.
- 18. GRANULAR CRADLE CONFORMING TO THE DETAIL SHOWN ON THE DETAIL SHEET OF THE PLANS SHALL BE PLACED IN ANY UTILITY TRENCH OVER WHICH ANOTHER UTILITY PASSES.
- 19. COMPACTED GRANULAR TRENCH BACKFILL SHALL BE USED IN ALL LOCATIONS WHERE THE PROPOSED UNDERGROUND UTILITY IS TO BE CONSTRUCTED UNDER OR WITHIN TWO (2) FEET OF PERMANENT TYPE PAVEMENTS, DRIVEWAYS, OR SIDEWALKS OR IN LOCATIONS AS DIRECTED BY THE ENGINEER. TRENCH BACKFILL SHALL BE EXTENDED TWO (2) FEET ON EACH SIDE OF THE PERMANENT TYPE SURFACE.
- 20. AT THE COMPLETION OF THIS PROJECT ONE SET OF RECORD PLANS IS TO BE SUBMITTED TO THE ENGINEER SHOWING THE LOCATION OF ALL OF THE SERVICES, PIPES, STRUCTURES, GRADING AND UTILITIES.
- 21. ALL SERVICES SHALL BE MARKED AT THE PROPERTY LINE USING A 2x2 PAINTED BLUE FOR WATER AND GREEN FOR SANITARY.

PROTECTION OF WATER MAIN & WATER MAIN SERVICE LINES

WATER MAINS AND WATER SERVICE LINES SHALL BE PROTECTED FROM SANITARY SEWERS, STORM SEWERS, COMBINED SEWERS, HOUSE SEWER SERVICE CONNECTIONS AND DRAINS AS FOLLOWS:

- a) WATER MAINS:
 - 1) HORIZONTAL SEPARATION:
 - A) WATER MAINS SHALL BE LAID AT LEAST TEN FEET HORIZONTALLY FROM ANY EXISTING OR PROPOSED DRAIN, STORM SEWER, SANITARY SEWER, COMBINED SEWER OR SEWER SERVICE CONNECTION.

WATER MAINS MAY BE LAID CLOSER THAN TEN FEET TO A SEWER LINE WHEN:

- B)
- i) LOCAL CONDITIONS PREVENT A LATERAL SEPARATION OF TEN FEET;
- ii) THE WATER MAIN INVERT IS AT LEAST 18 INCHES ABOVE THE CROWN OF THE SEWER; AND
- iii) THE WATER MAIN IS EITHER IN A SEPARATE TRENCH OR IN THE SAME TRENCH ON AN UNDISTURBED EARTH SHELF LOCATED TO ONE SIDE OF THE SEWER
- C) BOTH THE WATER MAIN AND DRAIN OR SEWER SHALL BE CONSTRUCTED OF SLIP-ON OR MECHANICAL JOINT CAST OR DUCTILE IRON PIPE, ASBESTOS-CEMENT PRESSURE PIPE, PRESTRESSED CONCRETE PIPE, OR PVC PIPE MEETING THE REQUIREMENTS OF SECTION 41 OF THE STANDARD SPECIFICATION FOR WATER & SEWER MAIN CONSTRUCTION IN ILLINOIS LATEST EDITION, WHEN IT IS IMPOSSIBLE TO MEET (A) OR (B) ABOVE. THE DRAIN OR SEWER SHALL BE PRESSURE TESTED TO THE MAXIMUM EXPECTED SURCHARGE HEAD BEFORE BACKFILLING.

2) VERTICAL SEPARATION:

- A) A WATER MAIN SHALL BE LAID SO THAT ITS INVERT IS 18 INCHES ABOVE THE CROWN OF THE DRAIN OR SEWER WHENEVER WATER MAINS CROSS STORM SEWERS, SANITARY SEWERS OR SEWER SERVICE CONNECTIONS. THE VERTICAL SEPARATION SHALL BE MAINTAINED FOR THAT PORTION OF THE WATER MAIN LOCATED WITHIN TEN FEET HORIZONTALLY OF ANY SEWER OR DRAIN CROSSED. A LENGTH OF WATER MAIN PIPE SHALL BE CENTERED OVER THE SEWER TO BE CROSSED WITH JOINTS EQUIDISTANT FROM THE SEWER OR DRAIN.
- B) BOTH THE WATER MAIN AND SEWER SHALL BE CONSTRUCTED OF SLIP-ON OR MECHANICAL JOINT CAST OR DUCTILE IRON PIPE, ASBESTOS-CEMENT PRESSURE PIPE, REINFORCED CONCRETE PRESSURE PIPE (AWWA C303), OR PVC PIPE MEETING REQUIREMENTS OF SECTION 41 OF THE STANDARD SPECIFICATION FOR WATER & SEWER MAIN CONSTRUCTION IN ILLINOIS LATEST EDITION, WHEN:
 - i) IT IS IMPOSSIBLE TO OBTAIN THE PROPER VERTICAL SEPARATION AS DESCRIBED IN (1) ABOVE; OR
 - ii) THE WATER MAIN PASSED UNDER A SEWER OR DRAIN.
- C) A VERTICAL SEPARATION OF 18 INCHES BETWEEN THE INVERT OF THE SEWER OR DRAIN AND THE CROWN OF THE WATER MAIN SHALL BE MAINTAINED WHERE A WATER MAIN CROSSES UNDER A SEWER. SUPPORT THE SEWER OR DRAIN LINES TO PREVENT SETTLING AND BREAKING THE WATER MAIN.
- D) CONSTRUCTION SHALL EXTEND ON EACH SIDE OF THE CROSSING UNTIL THE NORMAL DISTANCE FROM THE WATER MAIN TO THE SEWER OR DRAIN LINE IS AT LEAST TEN FEET.
- b) WATER SERVICE LINES:
 - 1) THE HORIZONTAL AND VERTICAL SEPARATION BETWEEN WATER SERVICES LINES AND ALL STORM SEWERS, SANITARY SEWERS, COMBINED SEWERS OR ANY DRAIN OR SEWER SERVICE CONNECTION SHALL BE THE SAME AS WATER MAIN SEPARATION DESCRIBED IN (1) ABOVE.
 - WATER PIPE DESCRIBED IN (1) ABOVE SHALL BE USED FOR SEWER SERVICE LINES WHEN MINIMUM HORIZONTAL AND VERTICAL SEPARATION CANNOT BE MAINTAINED.
- c) WATER MAINS SHALL BE SEPARATED FROM SEPTIC TANKS, DISPOSAL FIELD AND SEEPAGE BEDS BY A MINIMUM OF 25 FEET.
- i) WATER MAINS AND WATER SERVICE LINES SHALL BE PROTECTED AGAINST ENTRANCE OF HYDROCARBONS THROUGH DIFFUSION THROUGH ANY MATERIAL USED IN CONSTRUCTION OF THE LINE.

MEMBERS OF J.U.L.I.E. KNOWN TO BE WITHIN THE LIMITS OF THE IMPROVEMENTS ARE:

AT&T

SCALE:

- COMED
- COMCAST
- NICOR
- CITY OF PALOS HEIGHTS

USER NAME =	DESIGNED - AS	REVISED -
	DRAWN - DJB	REVISED -
PLOT SCALE =	CHECKED - AS	REVISED -
PLOT DATE = Jan 26, 2021	DATE -	REVISED -

				F.A.U. RTE.	SECT	ION	COUNTY	TOTAL SHEETS	SHEET NO.
	STANDARDS LIST ANI	GENERAL N	OTFS	1710	15-00053	3-00-PV	COOK	46	3
							CONTRACT	NO. 6	1G81
. –	SHEET NO. 2 OF 2 SHEE	S STA.	TO STA.			ILLINOIS FED AL	ID PROJECT		

	1					
		SUMMARY OF QUANTITIES			ROADWAY RECONSTRUCTION CODE 0004	TRAINEES CODE 0042
					80% FEDERA	L / 20% LOCAL
	CODE	O I ITEM	LUNI	r TOTAL	SUBTOTAL S'	TU SUBTOTAL
		0 TREE TRUNK PROTECTION	EAC		40	
		0 TREE ROOT PRUNING	EACI			
•		0 EARTH EXCAVATION				
		0 TRENCH BACKELL	CUY			
			CUY			
		GEOTECHNICAL FABRIC FOR GROUND STABILIZATION	SQ YI		1947	
		TOPSOIL FURNISH AND PLACE, 4"	SQ YI	12137	. 12137	
	2140010	GRADING AND SHAPING DITCHES	F001	3880	3880	
4	25200110	SODDING, SALT TOLERANT	SQ YI	12137	12137	
	25200200	SUPPLEMENTAL WATERING	UNIT	10	10	
	28000250	TEMPORARY EROSION CONTROL SEEDING	POUN	379	379	
	28000305	TEMPORARY DITCH CHECKS	F001	230	230	
	28000400	PERIMETER EROSION BARRIER	FOOT	3493	3493	
	28000510	INLET FILTERS	EACH	31	. 31	
	28001100	TEMPORARY EROSION CONTROL BLANKET	SQ YE	12137	12137	•
	30300001	AGGREGATE SUBGRADE IMPROVEMENT	CU YD	651	651	
*	30300112	AGGREGATE SUBGRADE IMPROVEMENTS 12"	SQ YD	7780	. 7780	
	31101200	SUBBASE GRANULAR MATERIAL, TYPE B 4"	SQ YD	305	305	
	40201000	AGGREGATE FOR TEMPORARY ACCESS	TON	500	500	
	40300200	BITUMINOUS MATERIALS (PRIME COAT)	TON	0.13	0.13	
	40600290	BITUMINOUS MATERIALS (TACK COAT)	POUND	3114	3114	
	40603080	HOT-MIX ASPHALT BINDER COURSE, IL-19.0, N50	TON	2696	2696	•
	40604060	HOT-MIX ASPHALT SURFACE COURSE, IL-9.5, MIX "D", N50	TON	1041	1041	-
	42300100	PORTLAND CEMENT CONCRETE DRIVEWAY PAVEMENT, 5 INCH	SQ YD	298	298	
	42400200	PORTLAND CEMENT CONCRETE SIDEWALK 5 INCH	SQ FT	2735	2735	
	42400800	DETECTABLE WARNINGS	SQ FT	40	40	
*	44000100	PAVEMENT REMOVAL	SQ YD	7918	. 7918	
1		DRIVEWAY PAVEMENT REMOVAL	SQ YD	1500	1500	
.		AGGREGATE SHOULDERS, TYPE B 6"				
ļ		PIPE CULVERT REMOVAL	SQ YD	975	975	
-			FOOT	962	962	
<u> </u>		PRECAST REINFORCED CONCRETE FLARED-END SECTION 12"	EACH	16	16	
-		STORM SEWERS, CLASS A, TYPE 2 12"	FOOT	732	732	
F	550A0410	STORM SEWERS, CLASS A, TYPE 2 24"	FOOT	1003	1003	
_						


		SUMMARY OF QUANTITIES			ROADWAY RECONSTRUCTION CODE 0004	TRAINEES CODE 0042
					80% FEDERAL	/ 20% LOCAL
					ST	υ
Δ *	56103000		FOOT	149	149	
A *	56103300	DUCTILE IRON WATER MAIN 12"	FOOT	2359	2359	
	60108204	PIPE UNDERDRAINS, TYPE 2, 4"	FOOT	2761	2761	
	60200805	CATCH BASINS, TYPE A, 4'-DIAMETER, TYPE 8 GRATE	EACH	14	14	
	60236200	INLETS, TYPE A, TYPE 8 GRATE	EACH	10	10	
	60300105	FRAMES AND GRATES TO BE ADJUSTED	EACH	7	7	
	60500040	REMOVING MANHOLES	EACH	13	13	
	67100100	MOBILIZATION	L SUM	1	1	
*.	70102621	TRAFFIC CONTROL AND PROTECTION, STANDARD 701501	EACH	1	. 1	
Δ	78000600	THERMOPLASTIC PAVEMENT MARKING - LINE 12"	FOOT	144	144	
Δ *	K0036120	MULCH PLACEMENT 4"	SQ YD	115	115	
۸ *	X0323449	REMOVE EXISTING WATER VALVE	EACH	7	7	
Δ *	X5610746	WATERMAIN LINE STOP, 6"	EACH	15	15	
彬	X7010216	TRAFFIC CONTROL AND PROTECTION (SPECIAL)	L SUM	1	1	
, *	Z0004510	HOT-MIX ASPHALT DRIVEWAY PAVEMENT, 3"	SQ YD	1185	1185	
*	Z0030850	TEMPORARY INFORMATION SIGNING	SQ FT			
*	Z0042200	PORTLAND CEMENT CONCRETE PAVEMENT SURFACE REMOVAL	SQ YD	382	382	
Δ*	Z0056900	SANITARY SEWER 8"	FOOT	80	80	•
Δ *	Z0073510	TEMPORARY TRAFFIC SIGNAL TIMING	EACH	1	1	,
*	20076600	TRAINEES	HOUR	500		500
*	Z0076604	TRAINEES TRAINING PROGRAM GRADUATE	HOUR	500	· · ·	500
Δ*	XX000052	REMOVE EXISTING WATERMAIN	FOOT	200	200	
*	XX003424	CONNECTION TO EXISTING STRUCTURE	EACH	1	1	
*		STABILIZED TURF SHOULDER	SQ YD	975	975	
Δ*		GATE VALVE 6" WITH VAULT, 5' DIAMETER	EACH	7	7	
	70000110					

* SPECIAL PROVISION

A SPECIALTY ITEMS

	USER NAME =	DESIGNED - AS	REVISED -
		DRAWN - DJB	REVISED -
ı	PLOT SCALE =	CHECKED - AS	REVISED -
	PLOT DATE = Jan 05, 2021	DATE -	REVISED -

	F.A.U. RTE.	SECTION	COUNTY	TOTAL	SHEET NO.
SUMMARY OF QUANTITIES	1710	15-00053-00-PV	COOK	41	4
SUMMARY OF QUARTITIES			CONTRACT	NO. 6	1G81
SCALE: - SHEET NO. 1 OF 1 SHEETS STA. TO STA.		ILLINOIS FED. A	D PROJECT		

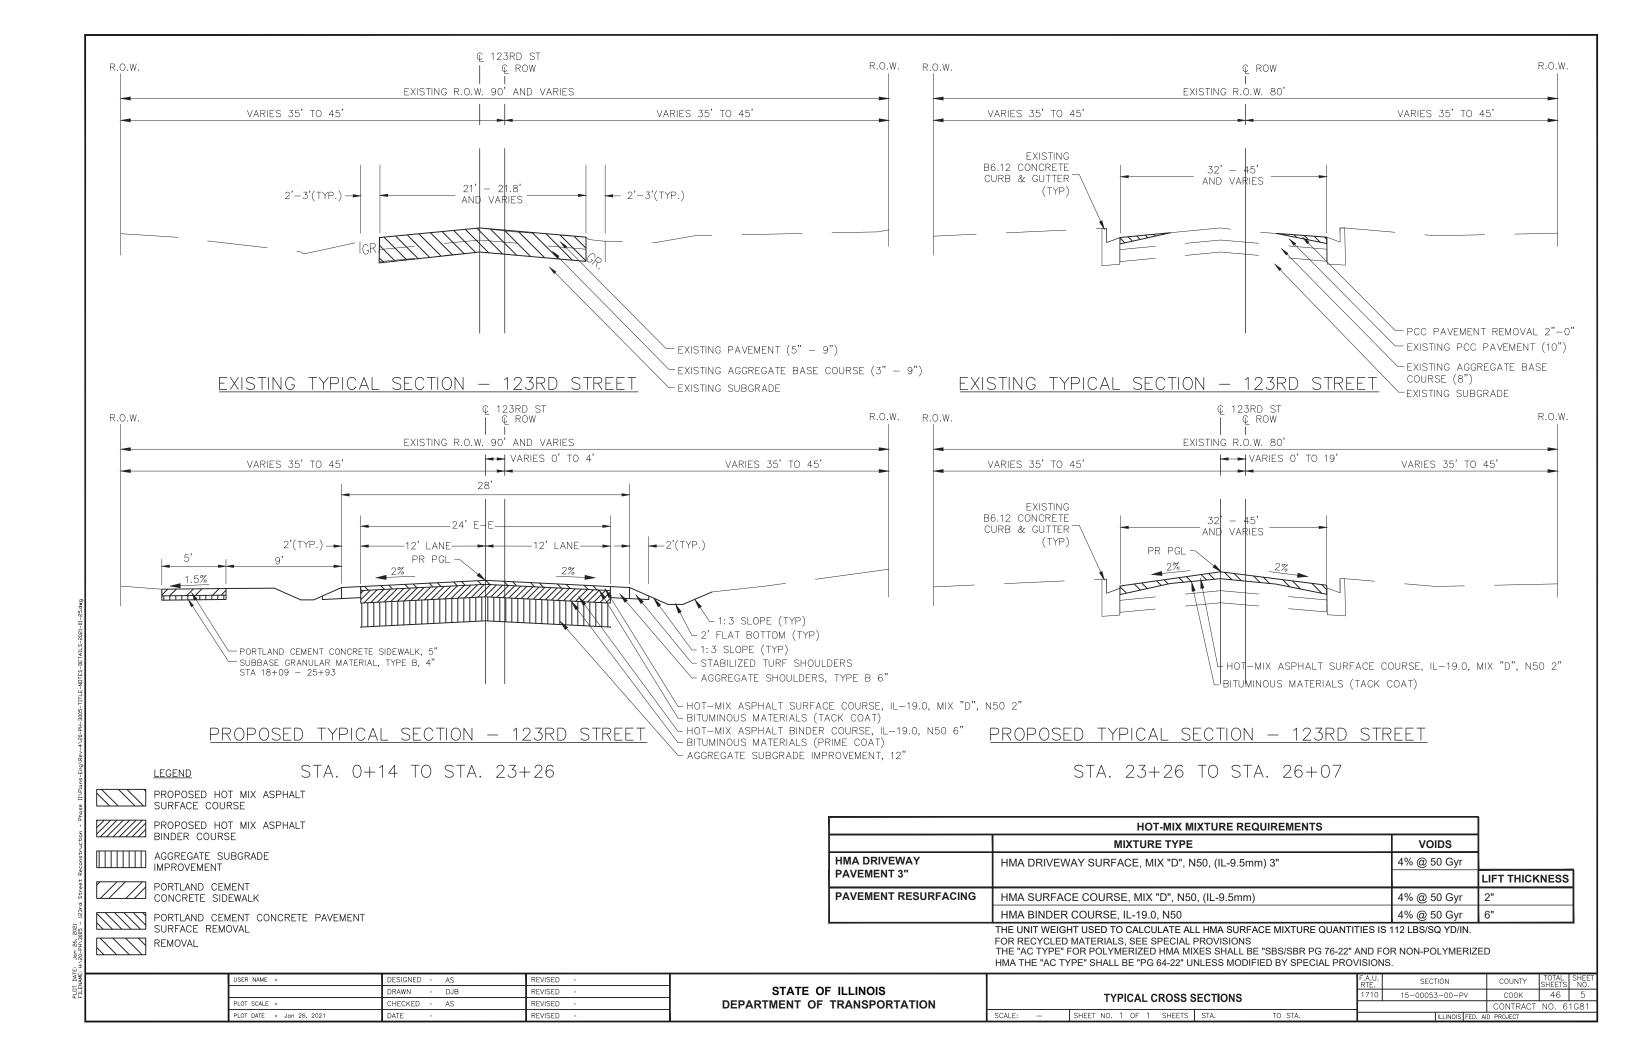

	SCHEDULE OF QUANTITIES			123RD ST STA 0+14 TO	123RD ST STA 5+72 TO	123RD ST STA 11+44 TO	123RD ST STA 17+17 TO	123RD ST STA 22+73 TO
CODE NO	ITEM	UNIT	TOTAL	STA 5+72	STA 11+44	STA 17+17	STA 22+75	STA 26+0
20101100	TREE TRUNK PROTECTION	EACH	43	11	15	10	7	
20101200	TREE ROOT PRUNING	EACH	13	4	8	1		
20200100	EARTH EXCAVATION	CU YD	3925	798	760	1129	1052	1
	TRENCH BACKFILL	CU YD	414	160	50		68	
	GEOTECHNICAL FABRIC FOR GROUND STABILIZATION	SQ YD	1947	424	489	488	410	
	TOPSOIL FURNISH AND PLACE, 4"	SQ YD	12137	3100	3050		2552	
								•
	GRADING AND SHAPING DITCHES	FOOT	3880	890	1015		980	
	SODDING, SALT TOLERANT	SQ YD	12137	3100	3050	3150	2552	2
25200200	SUPPLEMENTAL WATERING	UNIT	10					
28000250	TEMPORARY EROSION CONTROL SEEDING	POUND	379	97	95	98	80	
28000305	TEMPORARY DITCH CHECKS	FOOT	230	60	60	60	50	
28000400	PERIMETER EROSION BARRIER	FOOT	3493	366	1025	1000	960	
28000510	INLET FILTERS	EACH	31	2	11	9	6	
28001100	TEMPORARY EROSION CONTROL BLANKET	SQ YD	12137	3100	3050	3150	2552	
30300001	AGGREGATE SUBGRADE IMPROVEMENT	CU YD	651	142	163	163	137	
30300112	AGGREGATE SUBGRADE IMPROVEMENTS 12"	SQ YD	7780	1694	1954	1951	1637	
31101200	SUBBASE GRANULAR MATERIAL, TYPE B 4"	SQ YD	305				252	
40201000	AGGREGATE FOR TEMPORARY ACCESS	TON	500	100	100	100	100	
40300200	BITUMINOUS MATERIALS (PRIME COAT)	TON	0.1	0.03	0.03	0.03	0.03	С
40600290	BITUMINOUS MATERIALS (TACK COAT)	POUND	3114	678	782	781	655	
40603080	HOT-MIX ASPHALT BINDER COURSE, IL-19.0, N50	TON	2696	587	677	676	567	
40604060	HOT-MIX ASPHALT SURFACE COURSE, IL-9.5, MIX "D", N50	TON	1041	196	226	226	189	
	PORTLAND CEMENT CONCRETE DRIVEWAY PAVEMENT, 5 INCH	SQ YD	298	134	164			
	PORTLAND CEMENT CONCRETE SIDEWALK 5 INCH	SQ FT	2735		0	0	2260	
	DETECTABLE WARNINGS	SQ FT	40	0	0		20	
	PAVEMENT REMOVAL	SQ YD	7918		1796		1634	,
	DRIVEWAY PAVEMENT REMOVAL	SQ YD	1500		391	336	207	
	AGGREGATE SHOULDERS, TYPE B 6"	SQ YD	975		253		234	
	PIPE CULVERT REMOVAL	FOOT	962	219	62	175	448	
54213657	PRECAST REINFORCED CONCRETE FLARED-END SECTION 12"	EACH	16	12	3			
550A0340	STORM SEWERS, CLASS A, TYPE 2 12"	FOOT	732	378	119	135	90	
550A0410	STORM SEWERS, CLASS A, TYPE 2 24"	FOOT	1003	0	0	492	453	
56103000	DUCTILE IRON WATER MAIN 6"	FOOT	149	16	44	44	22	
56103300	DUCTILE IRON WATER MAIN 12"	FOOT	2359	541	572	573	572	
60108204	PIPE UNDERDRAINS, TYPE 2, 4"	FOOT	2761	571	855	780	520	
60200805	CATCH BASINS, TYPE A, 4'-DIAMETER, TYPE 8 GRATE	EACH	14	2	1	6	4	
60236200	INLETS, TYPE A, TYPE 8 GRATE	EACH	10	2	3	3	2	

	SCHEDULE OF QUANTITIES		123RD ST STA 0+14 TO	123RD ST STA 5+72 TO	123RD ST STA 11+44 TO	123RD ST STA 17+17 TO	123RD ST STA 22+75 TO	
CODE NO	ITEM	UNIT	TOTAL	STA 5+72	STA 11+44	STA 17+17	STA 22+75	STA 26+07
60500040	REMOVING MANHOLES	EACH	13	3	3	3	3	
78000600	THERMOPLASTIC PAVEMENT MARKING - LINE 12"	FOOT	144	0	0	0	48	9
K0036120	MULCH PLACEMENT 4"	SQ YD	115	28	39	28	20	
X0323449	REMOVE EXISTING WATER VALVE	EACH	7	1	2	2	1	
X5610746	WATERMAIN LINE STOP, 6"	EACH	15	2	4	4	2	
X7010216	TRAFFIC CONTROL AND PROTECTION (SPECIAL)	LSUM	1					
Z0004514	HOT-MIX ASPHALT DRIVEWAY PAVEMENT, 3"	SQ YD	1185	420	229	332	204	
Z0030850	TEMPORARY INFORMATION SIGNING	SQ FT	50					
<u>Z</u> 0042200	PORTLAND CEMENT CONCRETE PAVEMENT SURFACE REMOVAL	Ş <u>Q</u> <u>Y</u> .D	382					38
Z0076604	TRAINEES TRAINING PROGRAM GRADUATE	HOUR						
XX000052	REMOVE EXISTING WATERMAIN	FOOT	200	40	40	40	40	4
XX003424	CONNECTION TO EXISTING STRUCTURE	EACH	1					
XX007091	STABILIZED TURF SHOULDER	SQ YD	975	217	253	248	234	2
XX009443	GATE VALVE 6" WITH VAULT, 5' DIAMETER	EACH	7	1	2	2	1	


TR	EE TRUNK
PRO	TECTION (EA)
	,
	DISTANCE FROM
STATION	CENTER LINE
0+27	21' R
0+50	33' L
1+54	23' R
1+72	31' R
1+95	27' R
2+54	12' R
2+68	27' L
2+99	43' L
3+55	50' L
3+87	44' L
4+09	45' L
5+60	44' L
6+09	44' L
6+85	40' R
6+90	25' R
6+92	25' R
7+35	28' R
7+42	39' L
7+75	29' R
9+65	29' R
10+11	39' L
10+15	39' L
10+17	38' L
10+24	38' R
11+12	36' R
11+22	36' R
12+05	25' L
12+25	43' L
12+77	37' L
13+01	33' R
13+75	33' L
13+84	43' R
13+98	34' L
14+10	45' R


		ı		
	REE TRUNK		TF	REE ROOT
PRO	TECTION (EA)		PR	UNING (EA)
	5,074,107, 550,1			
	DISTANCE FROM			DISTANCE
TATION	CENTER LINE		STATION	CENTER
15+19	32' L		0+27	21' R
15+84	33' L		1+54	23' R
18+12	23' L		1+72	31' R
20+27	45' R		1+95	27' R
20+37	40' R		6+85	40' R
20+60	33' L		6+90	25' R
21+51	28' L		6+92	25' R
22+05	31' L		7+35	28' R
22+07	35' L		7+75	29' R
TOTAL	43		9+65	29' R
			10+24	38' R
			11+12	36' R
			11+22	36' R
			13±01	33' D


PR	UNING (EA)
	DISTANCE FROM
STATION	CENTER LINE
0+27	21' R
1+54	23' R
1+72	31' R
1+95	27' R
6+85	40' R
6+90	25' R
6+92	25' R
7+35	28' R
7+75	29' R
9+65	29' R
10+24	38' R
11+12	36' R
11+22	36' R
13+01	33' R
TOTAL	13


USER NAME = DESIGNED - AS REVISED -DRAWN - DJB REVISED -REVISED -CHECKED - AS PLOT SCALE = DATE -REVISED -PLOT DATE = Jan 28, 2021


		F.A.U. RTE.	SECTION	COUNTY	TOTAL SHEETS	SHEET NO.		
	SCHEDULE OF QU	1710	15-00053-00-PV	COOK	46	6		
				CONTRACT	NO. 6	1G81		
SCALE: -	SHEET NO. 1 OF 1 SHEETS	STA.	TO STA.		ILLINOIS FED.	AID PROJECT		

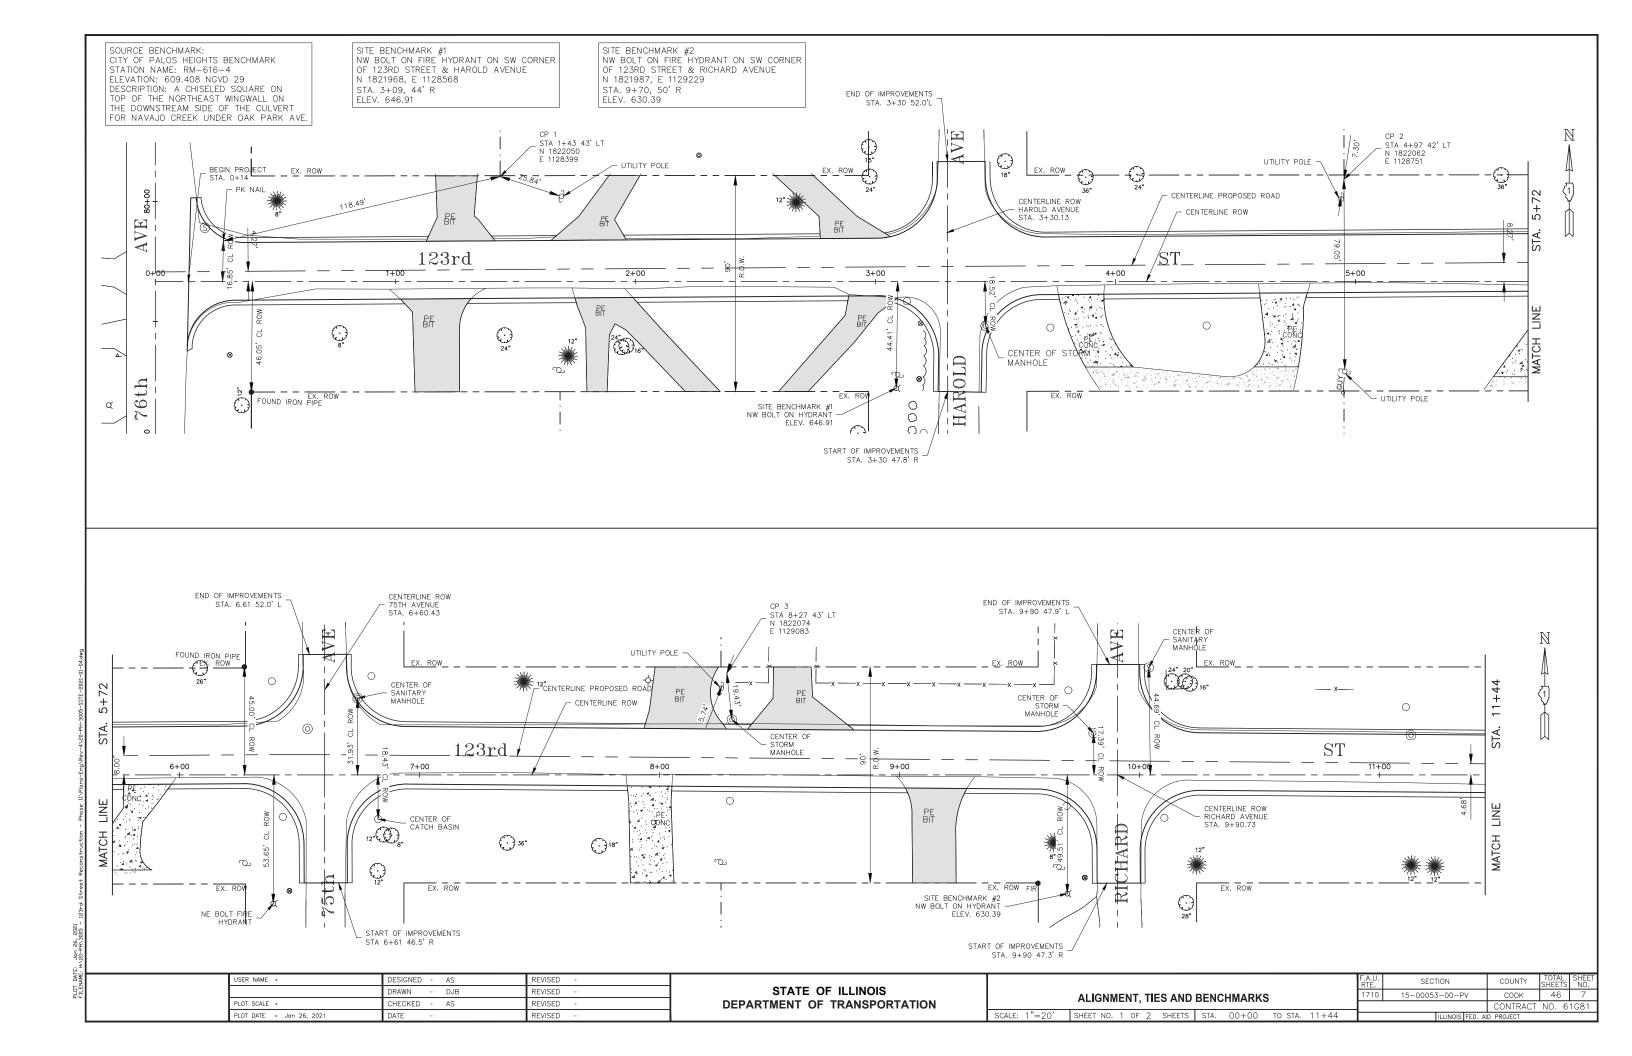


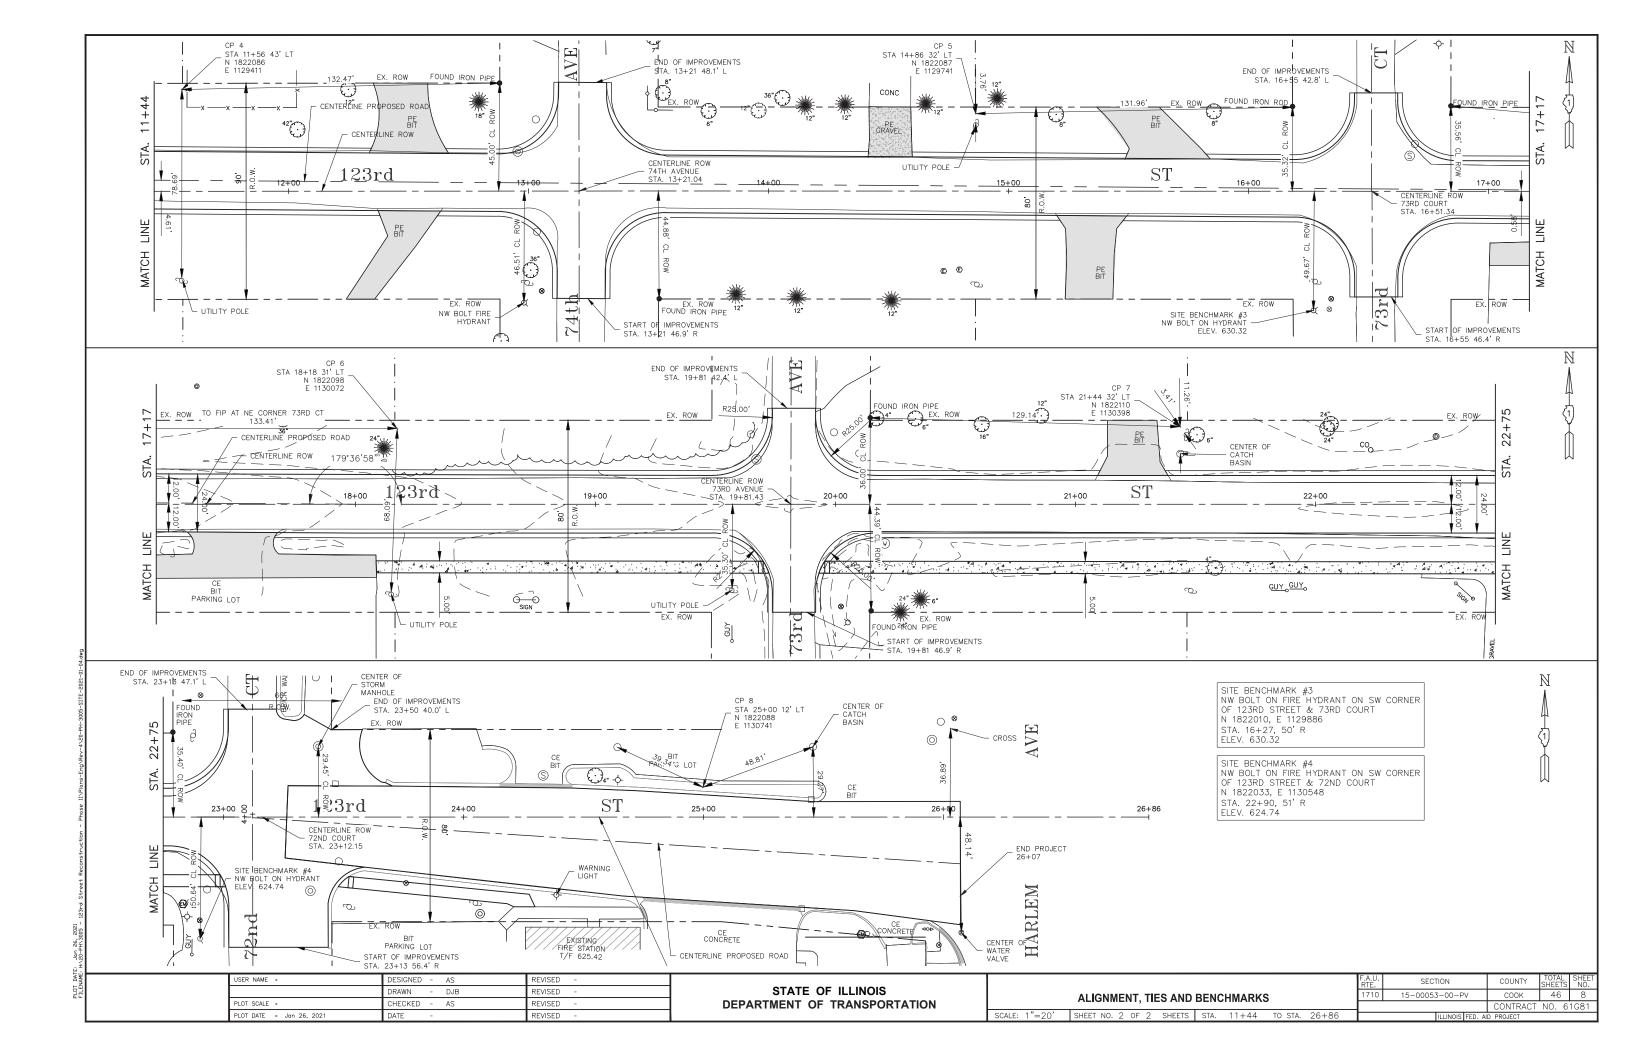


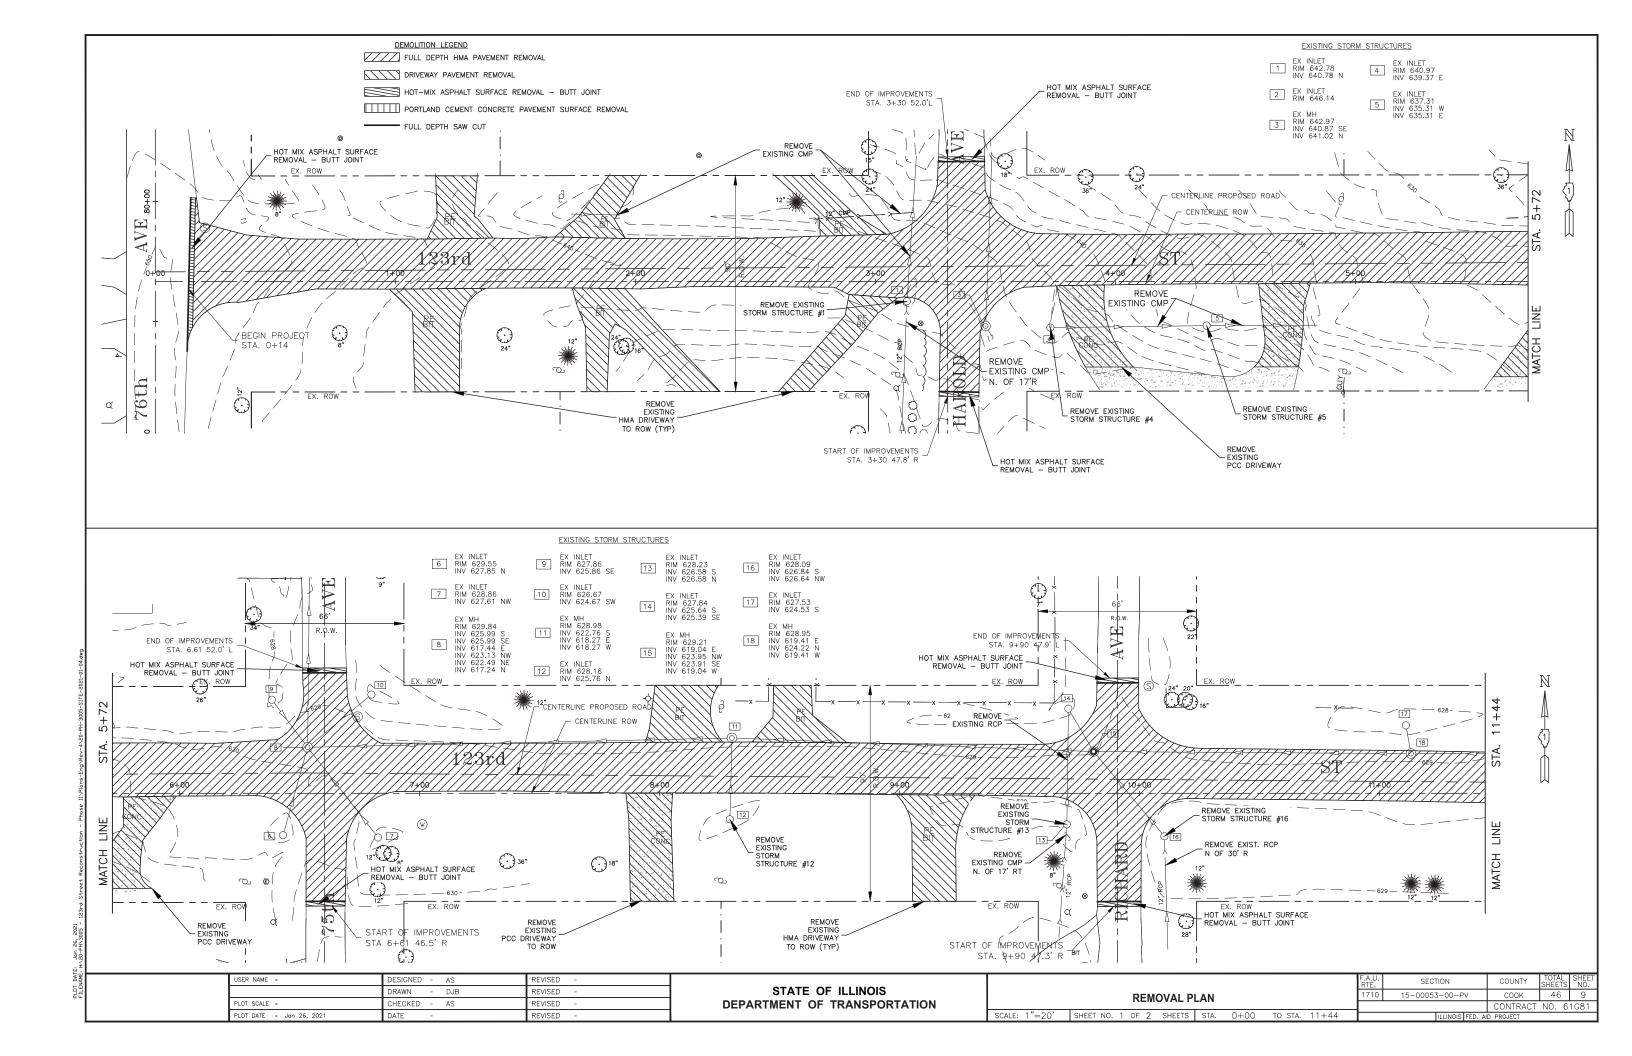


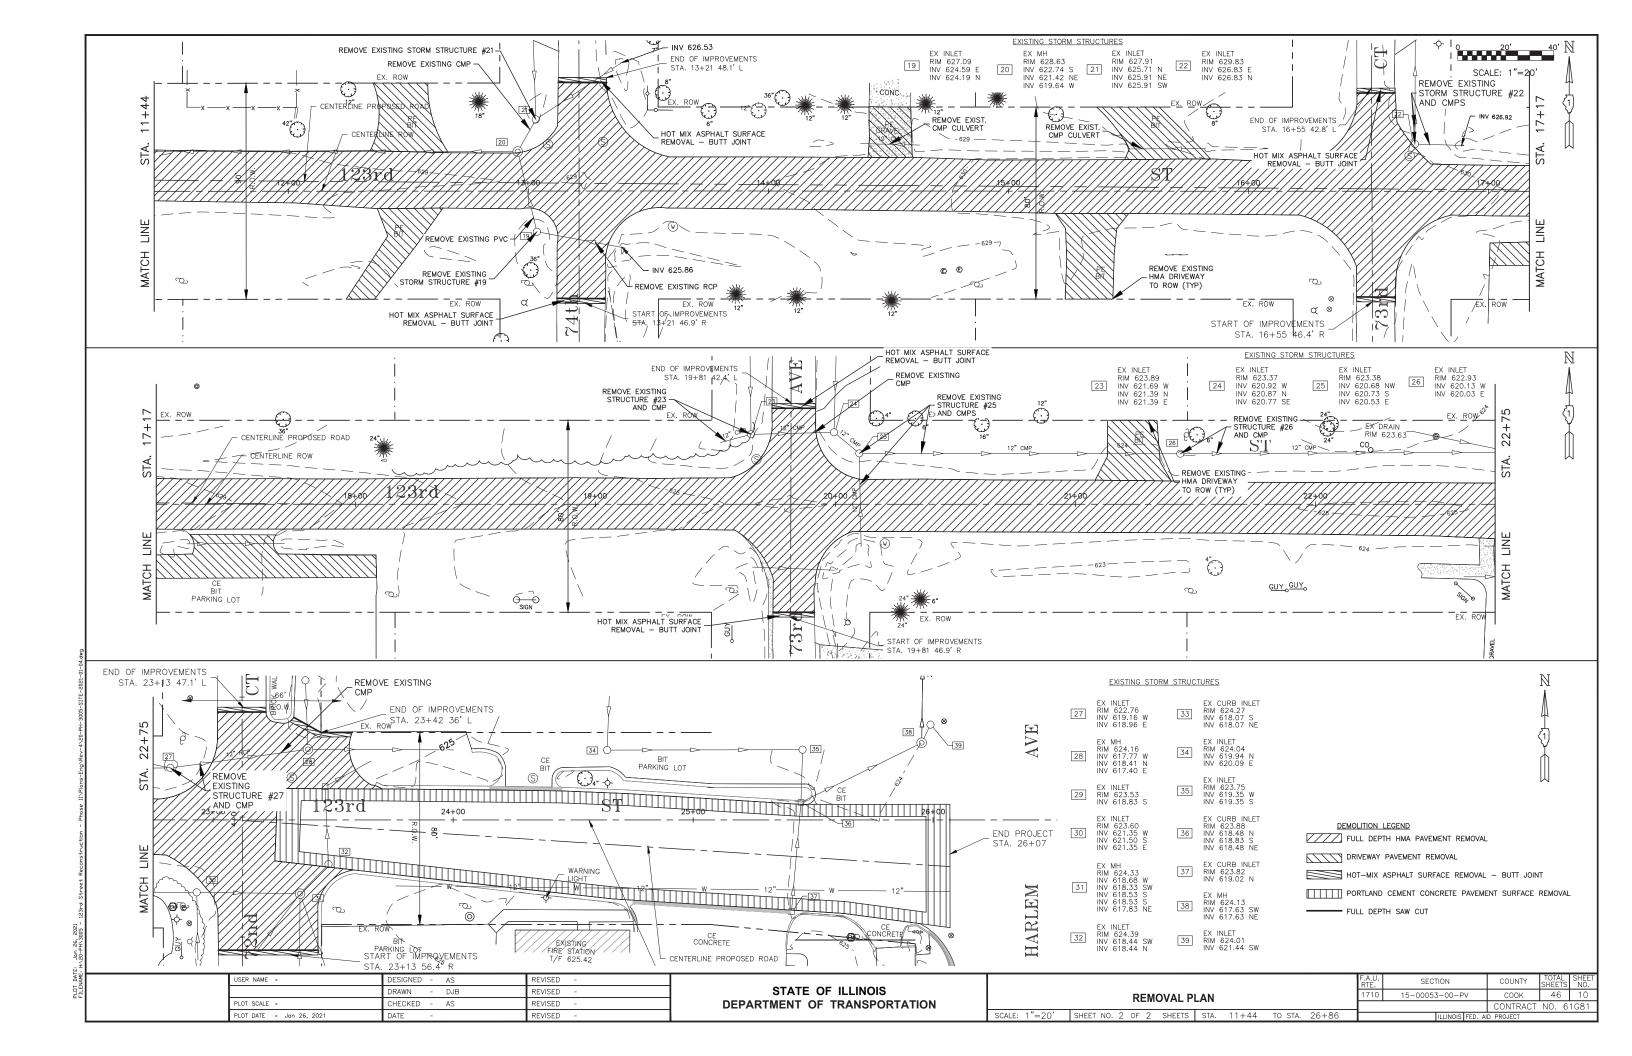


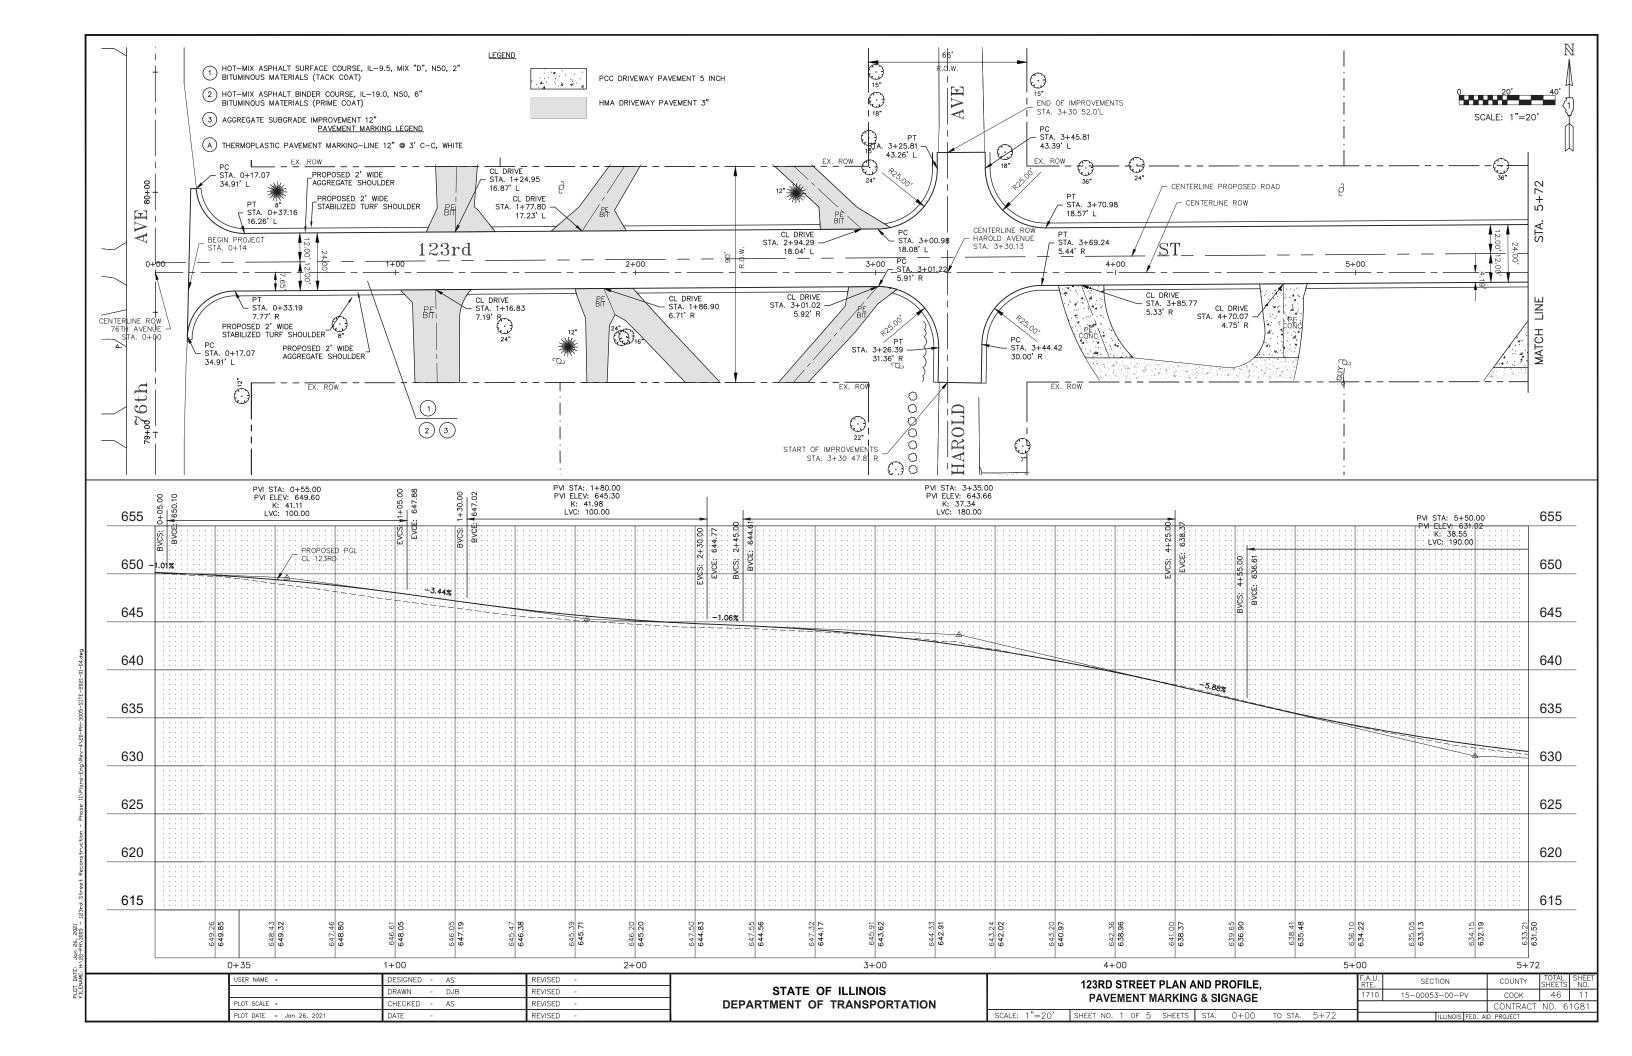


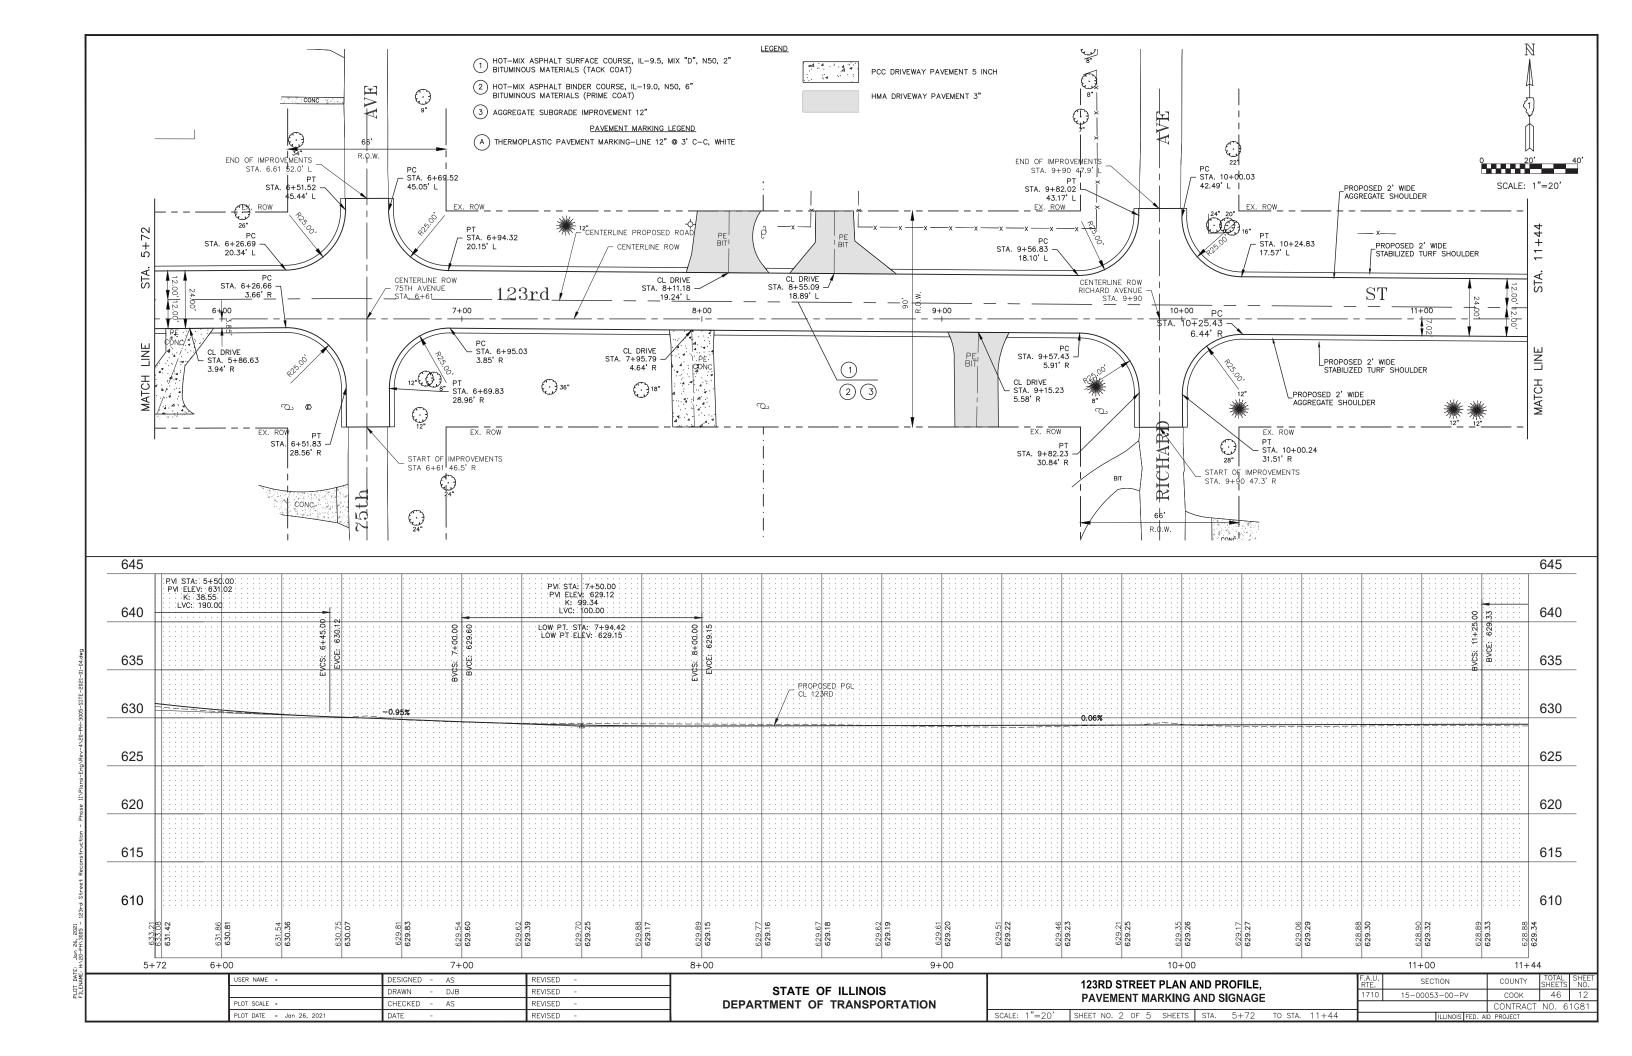


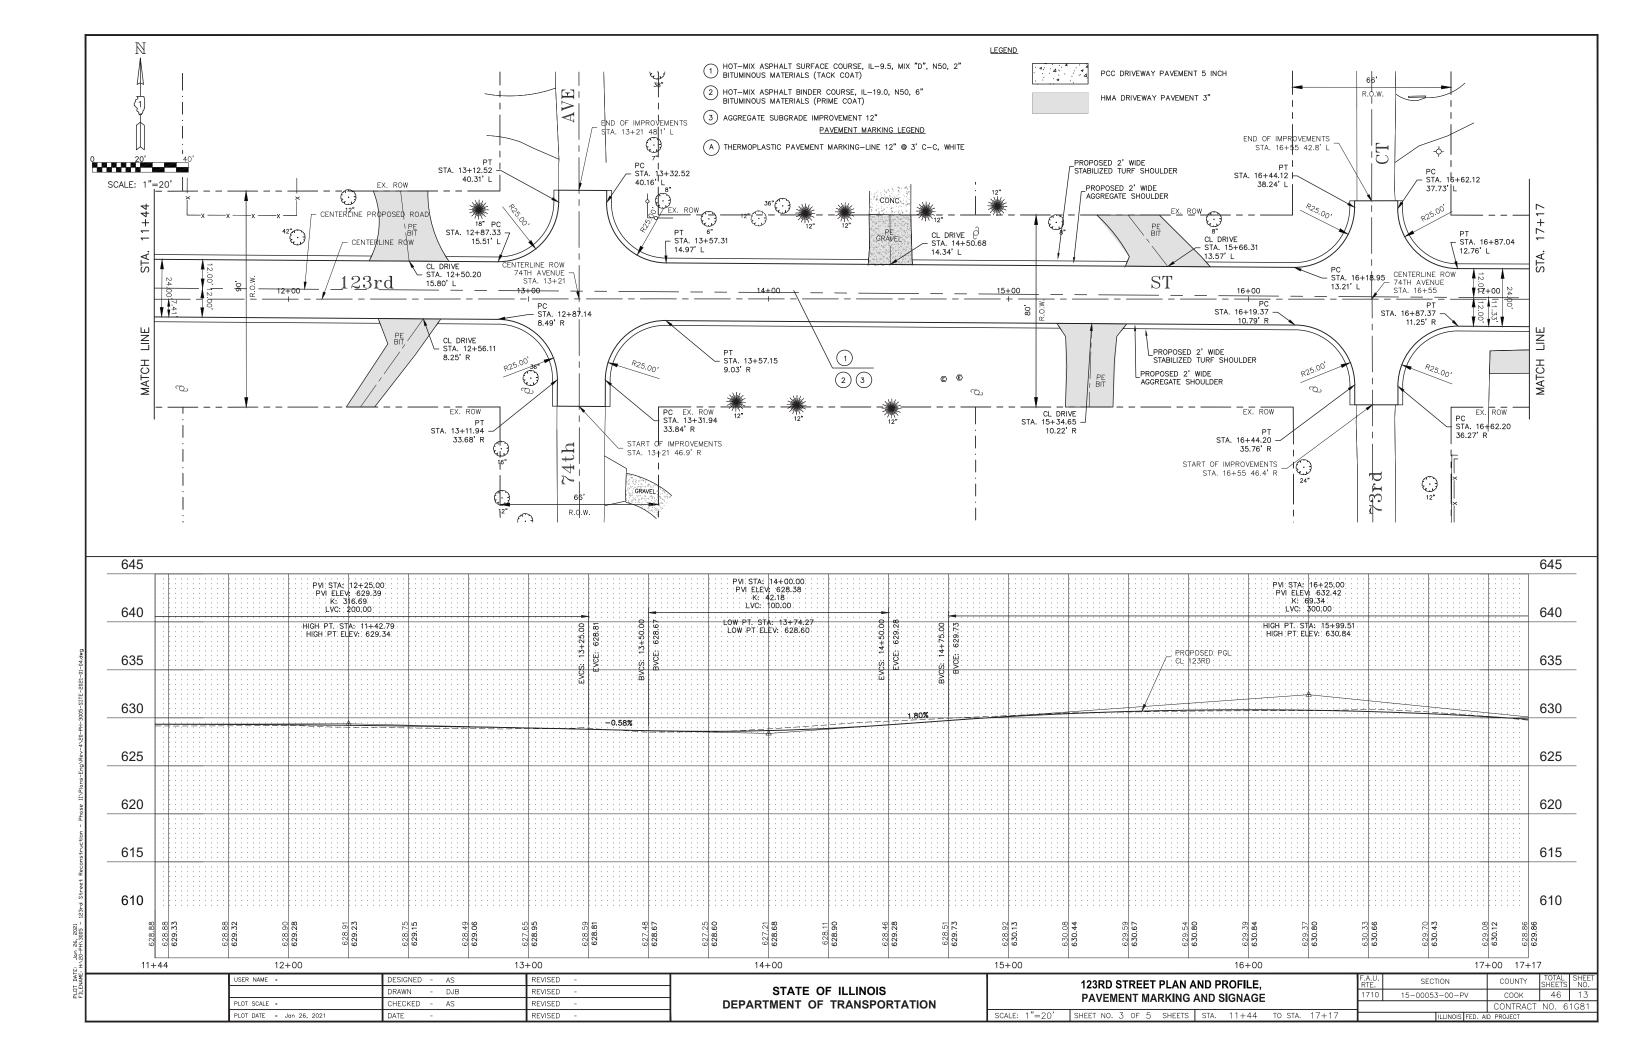


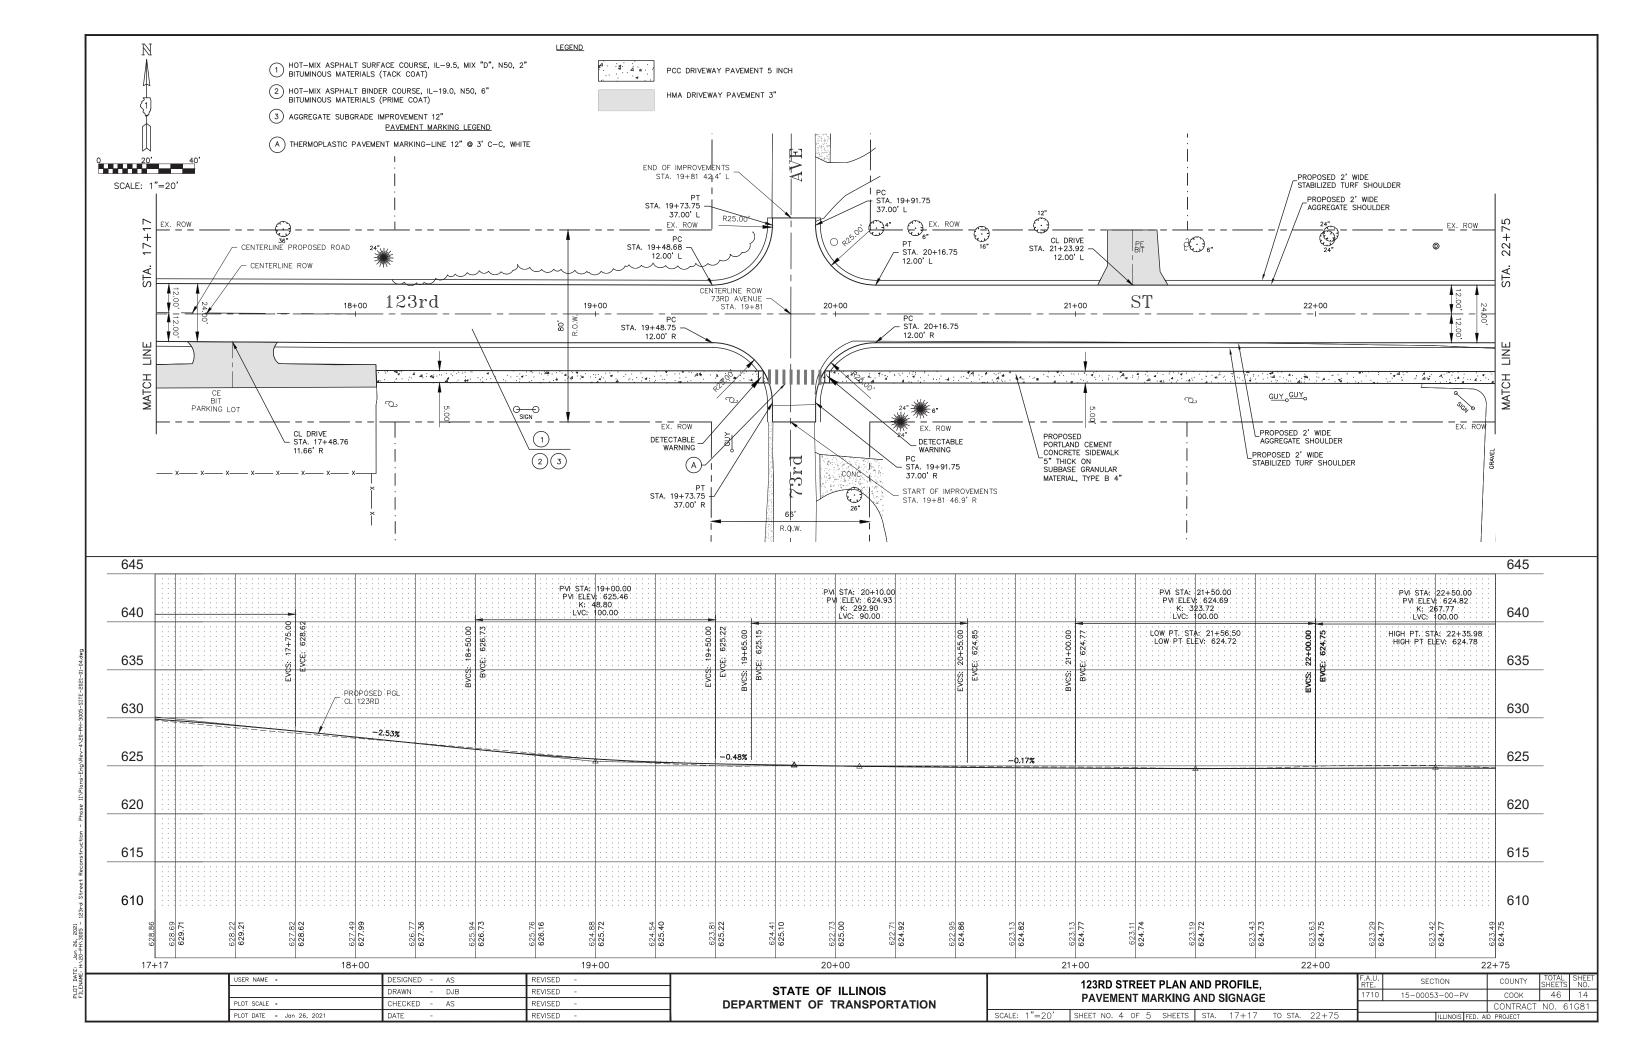


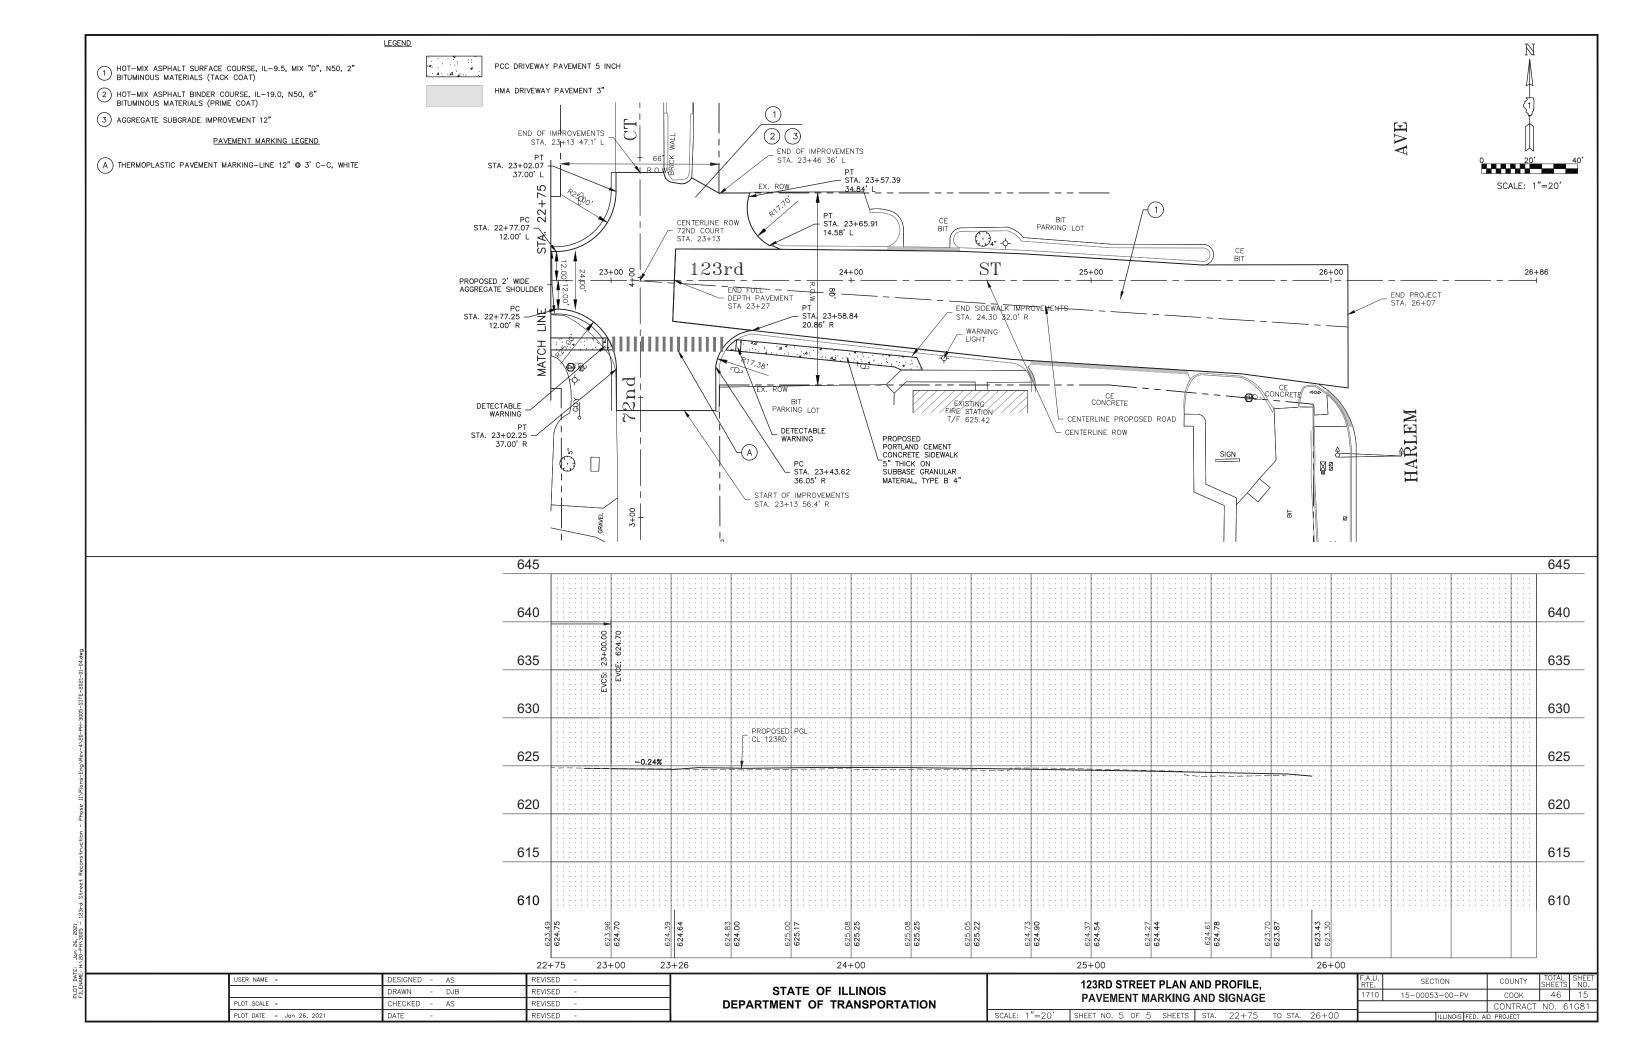


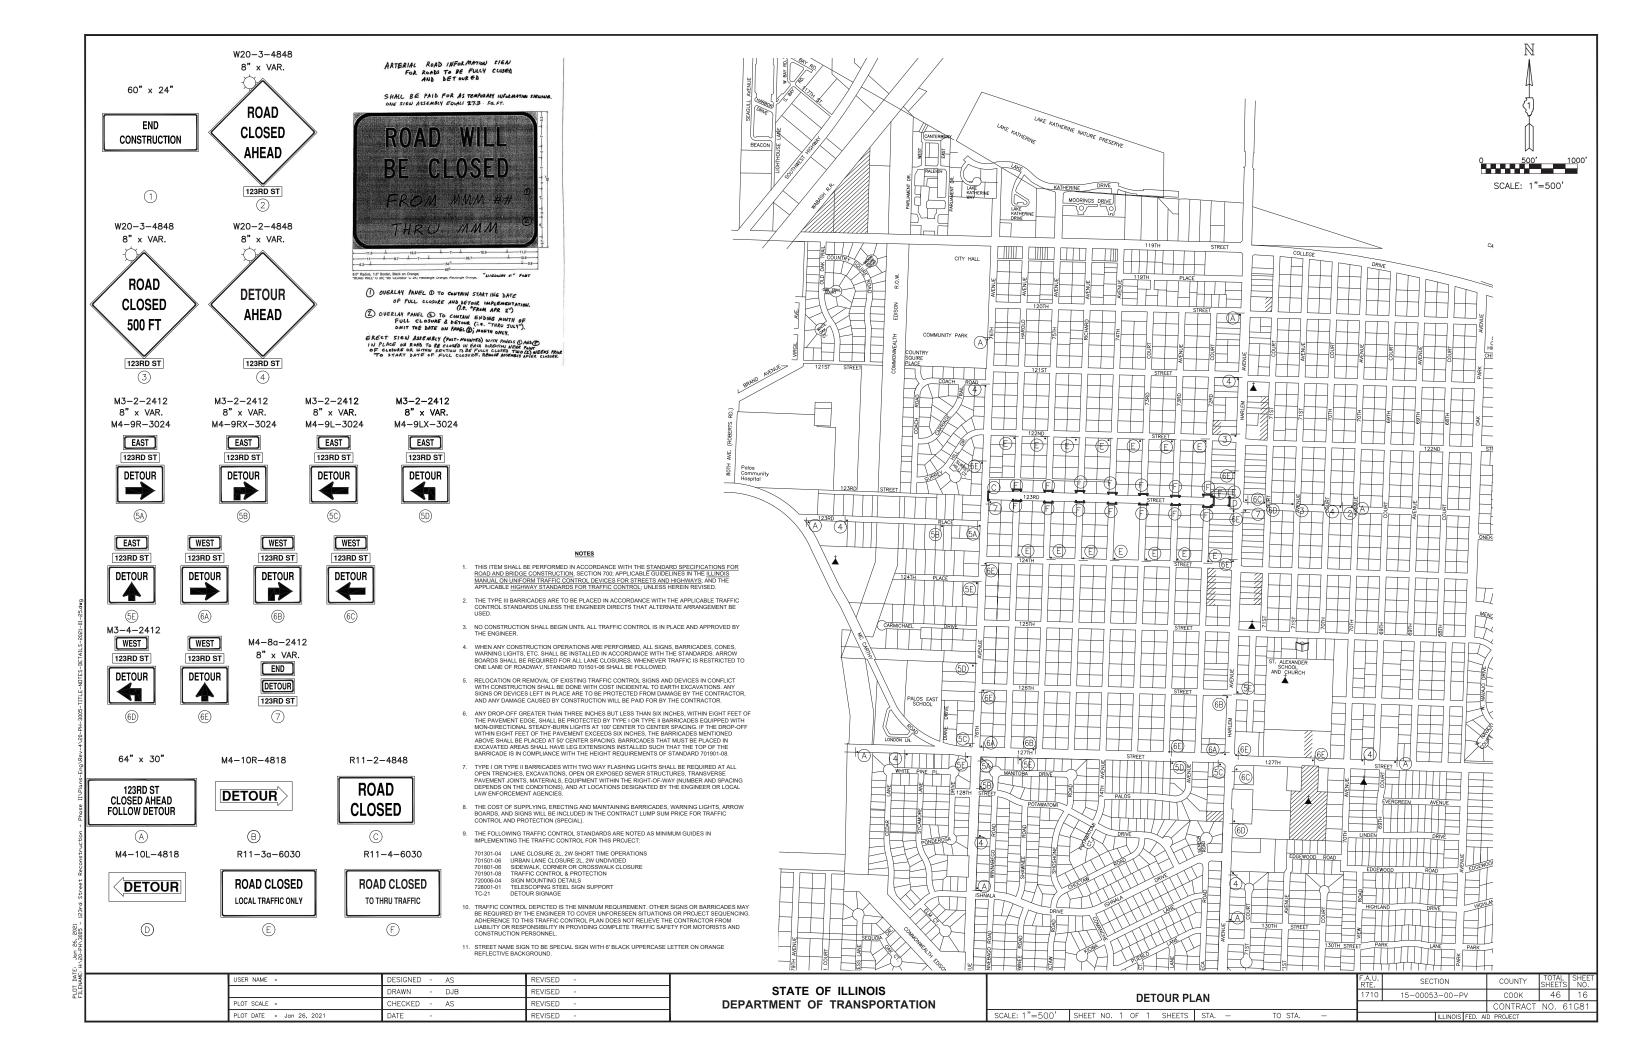


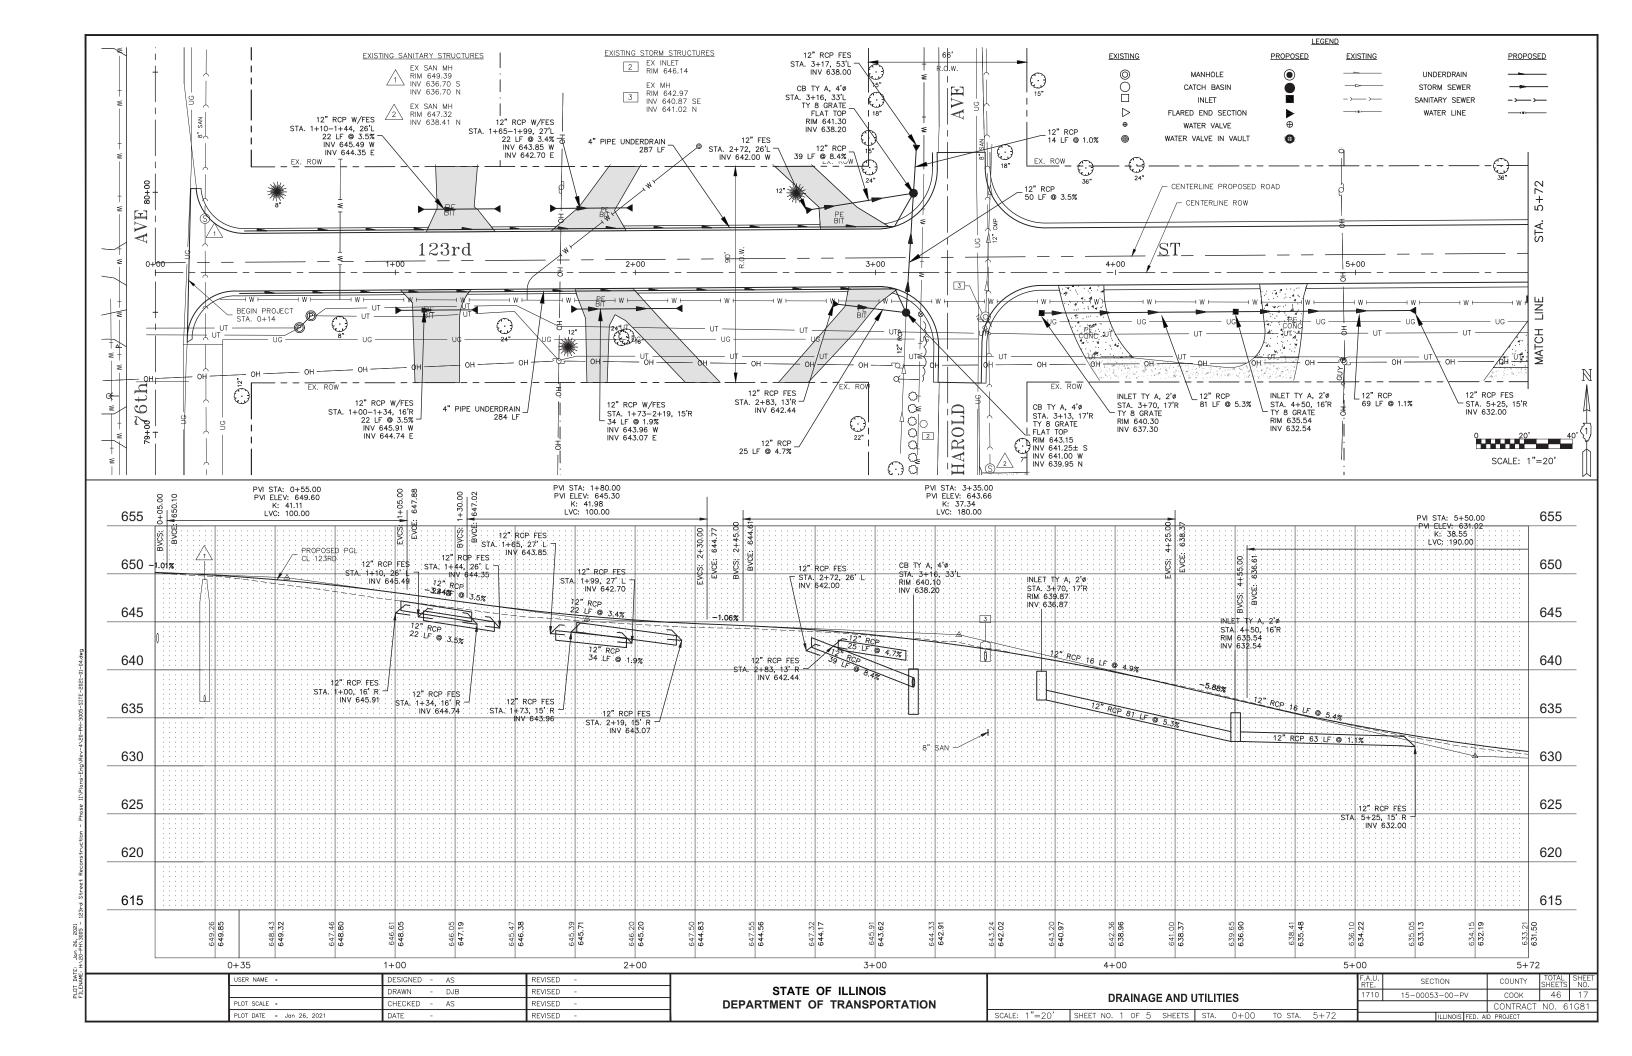


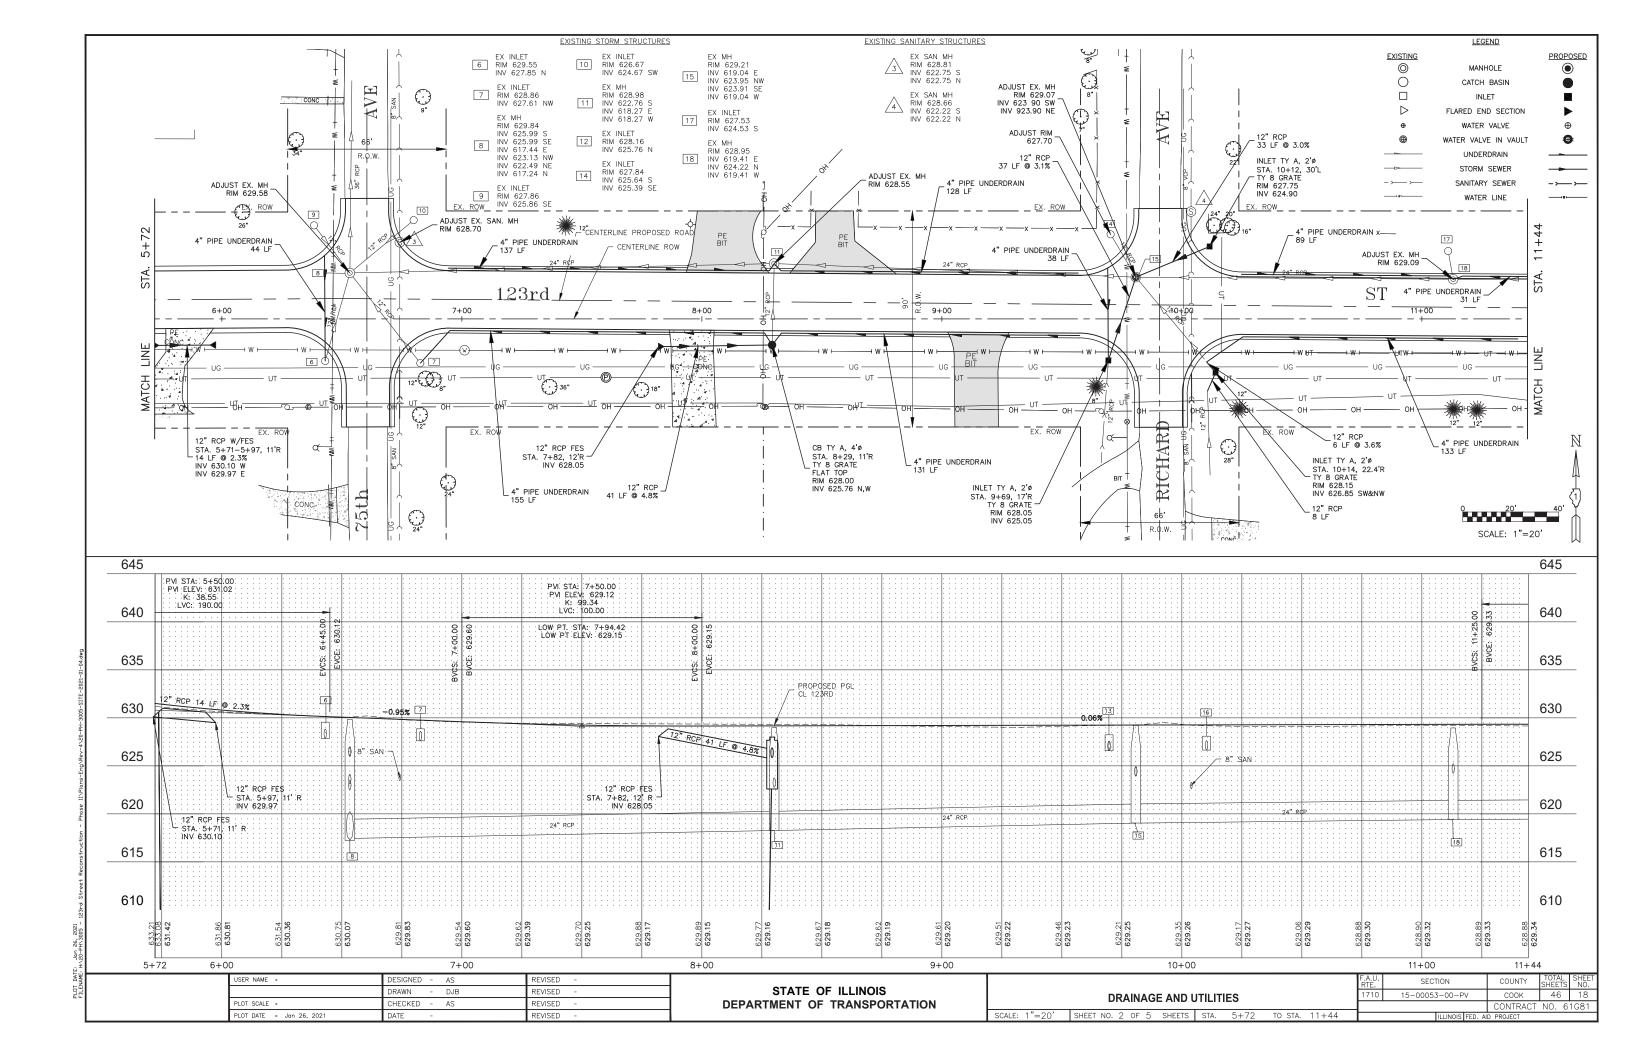

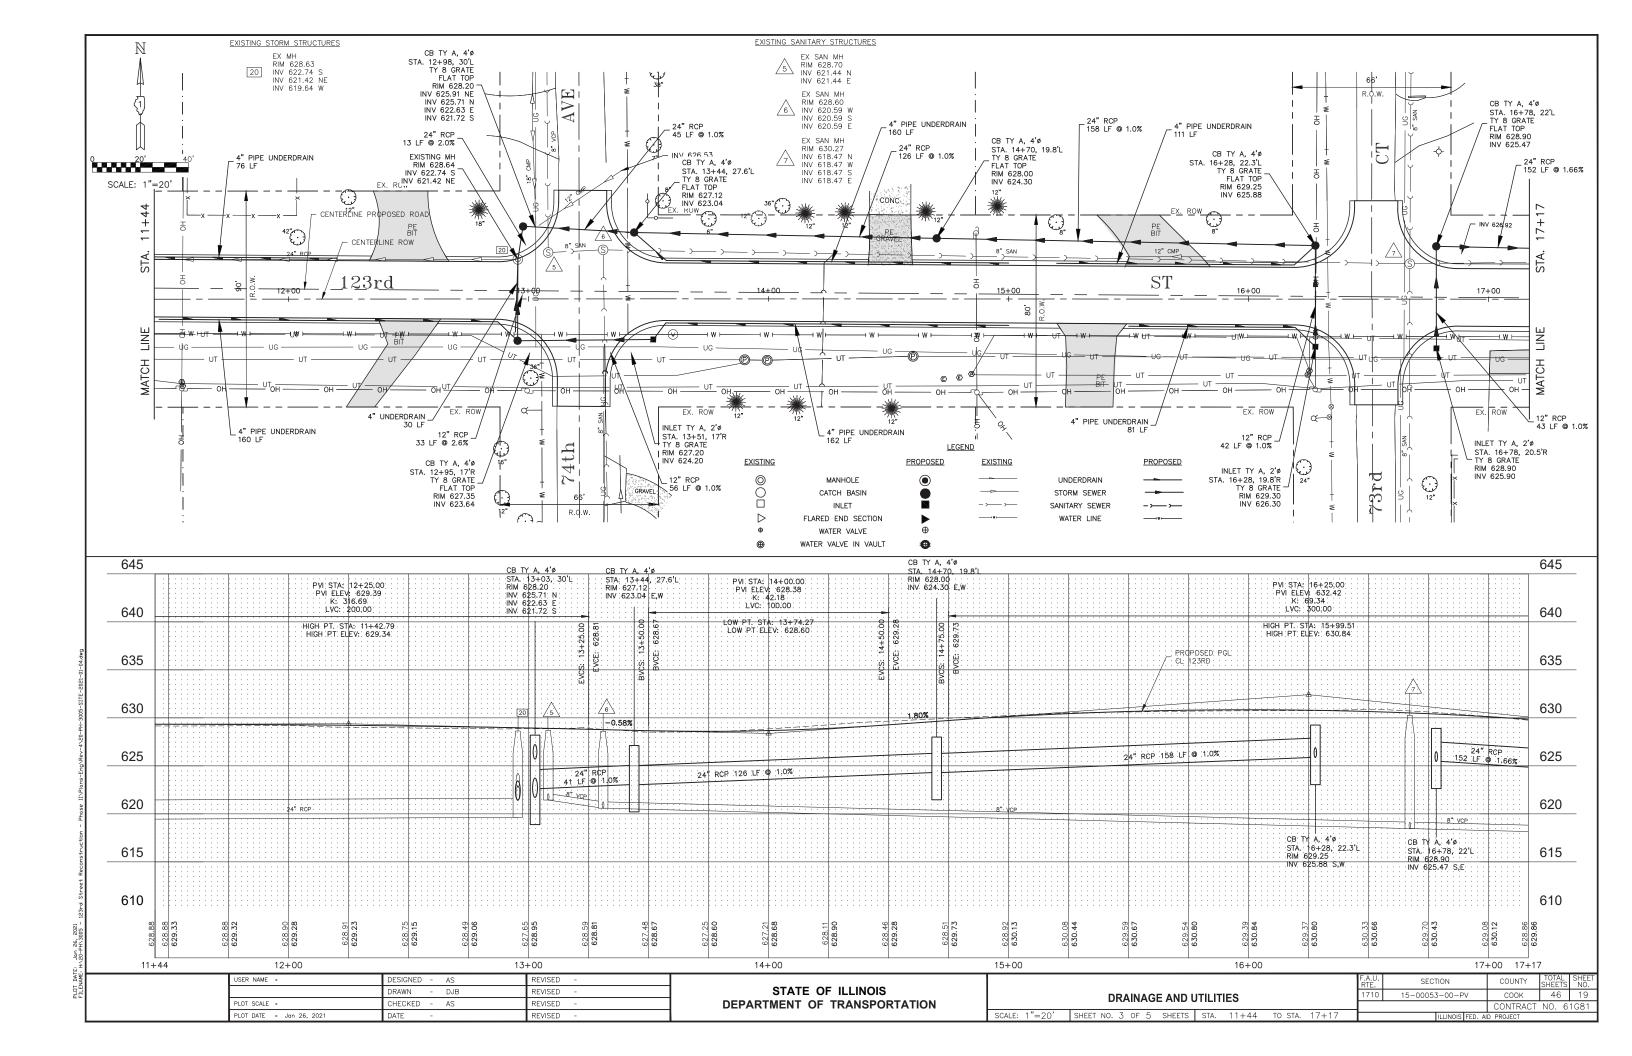

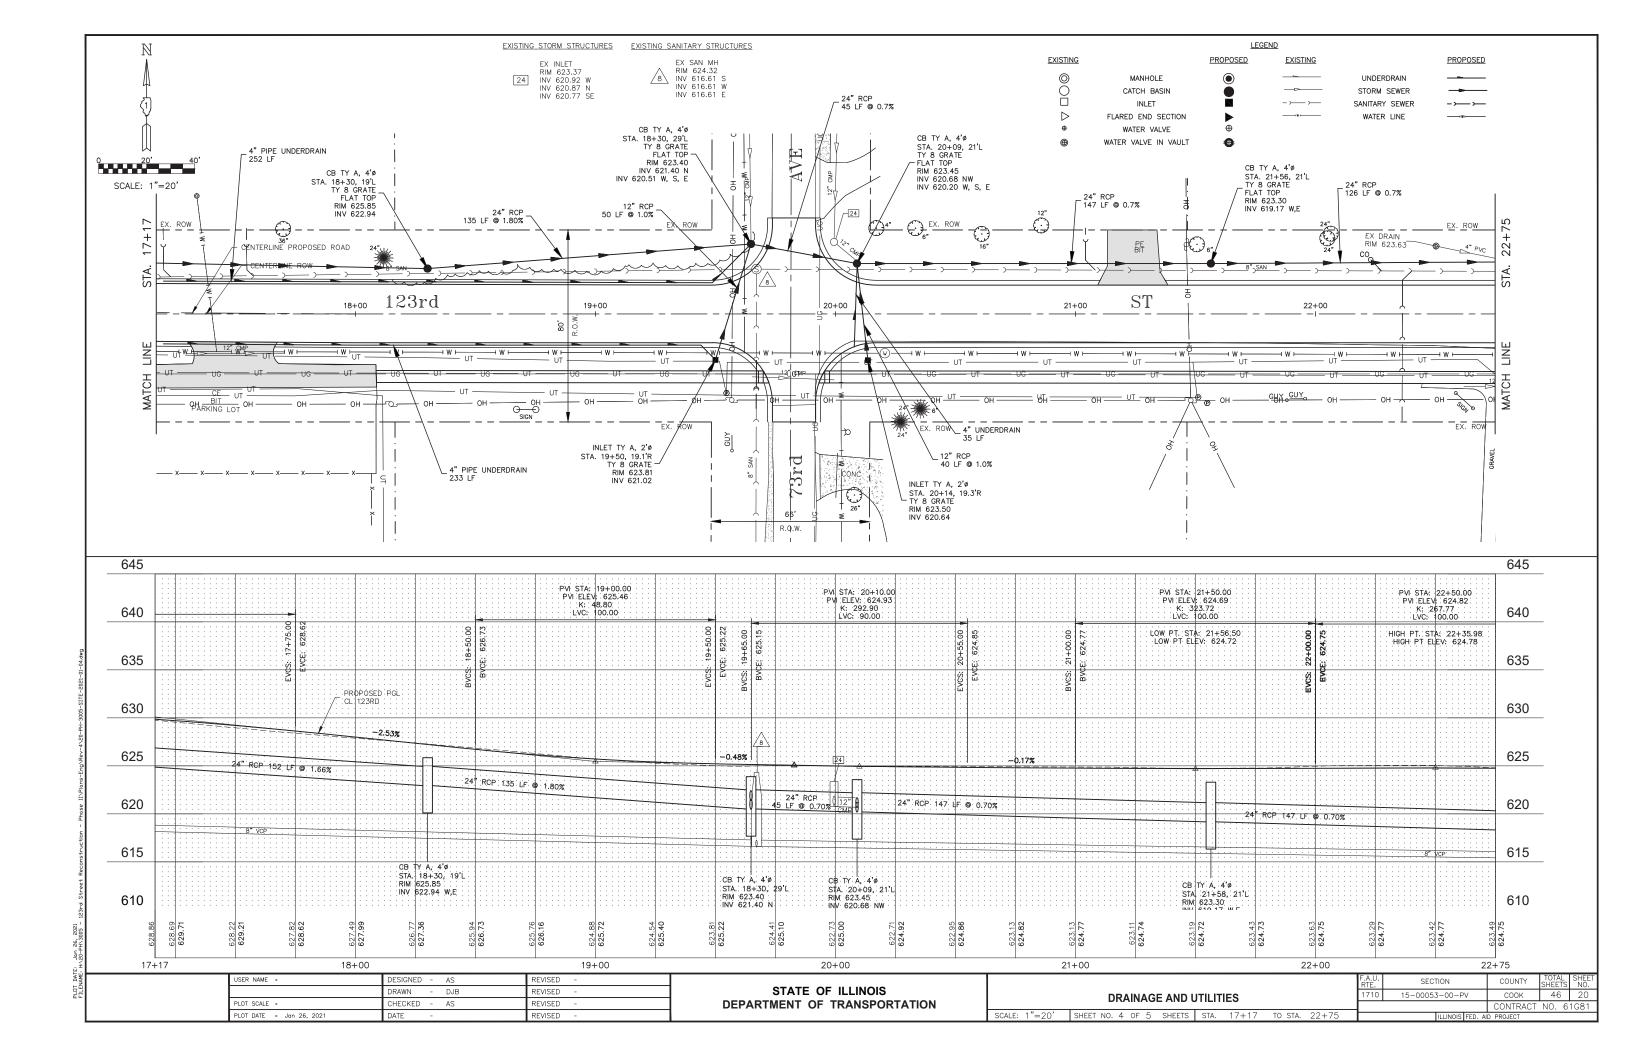

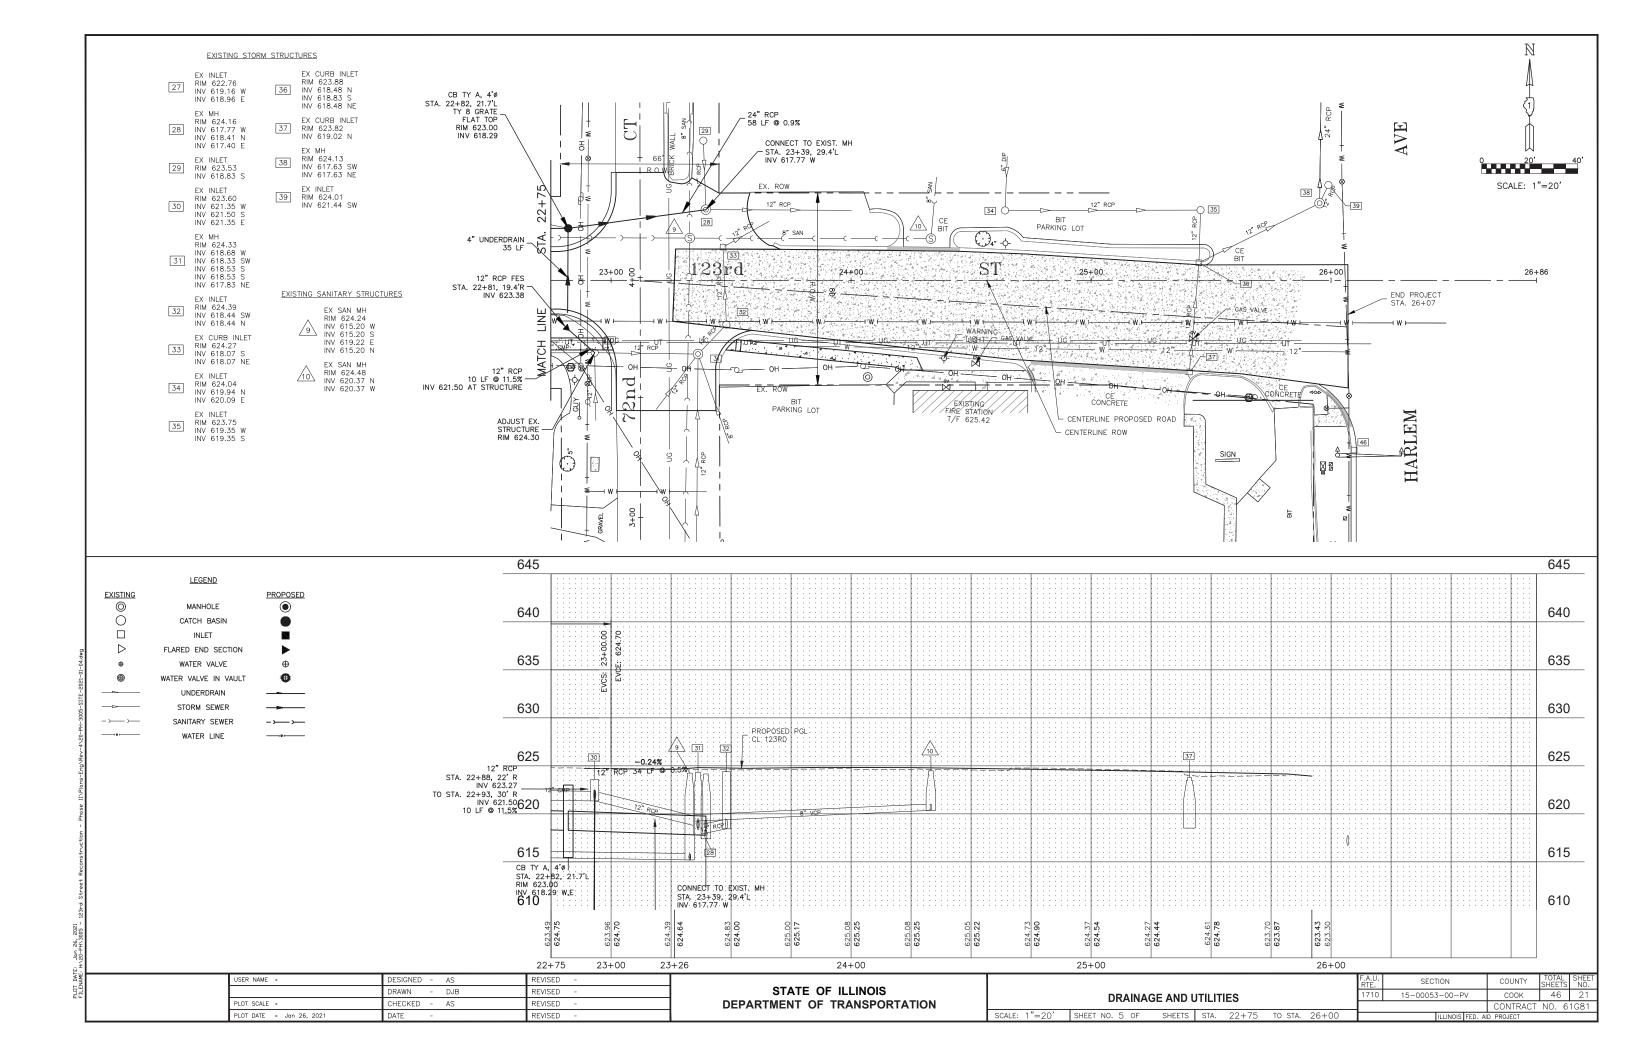

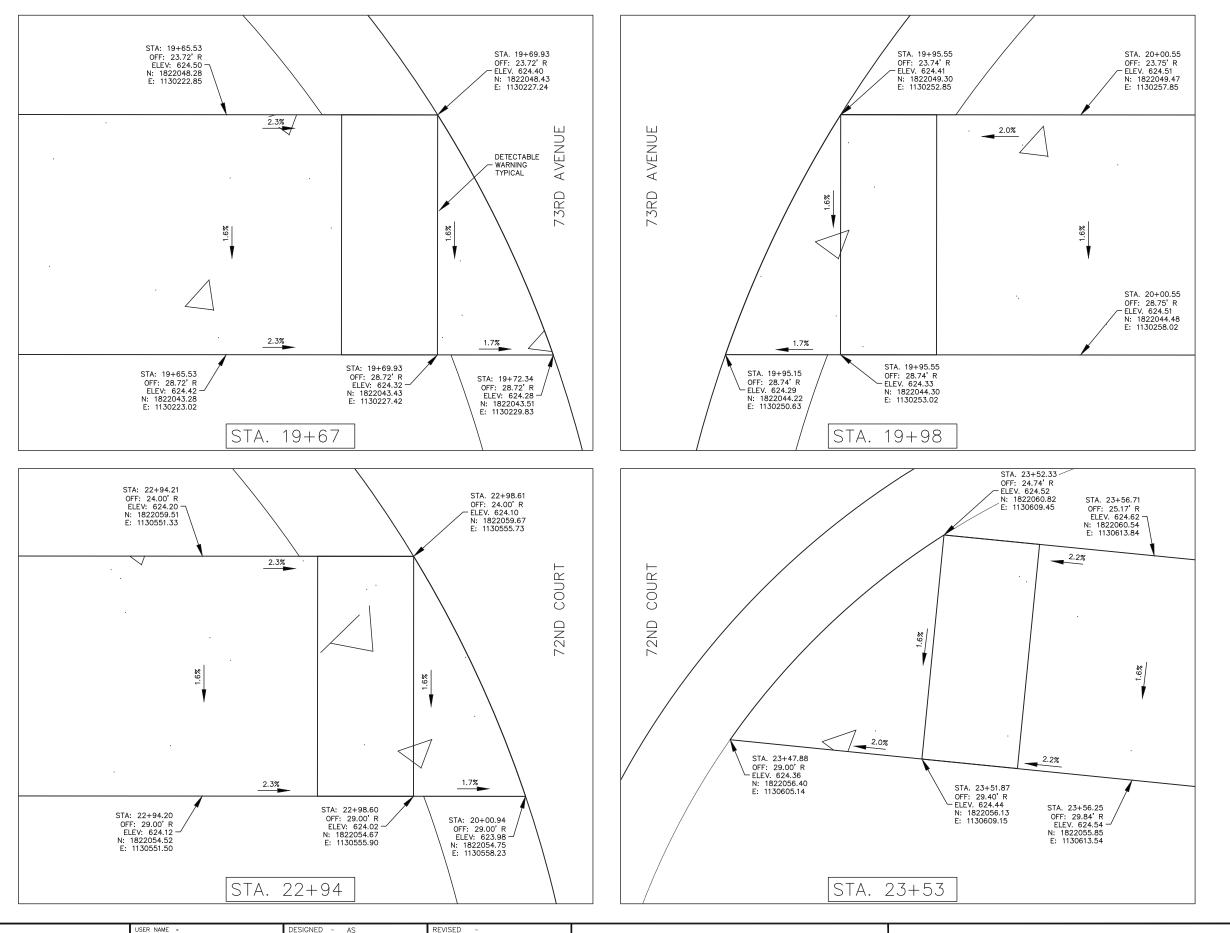

REVISED

REVISED

REVISED

DRAWN

DATE

CHECKED - AS

PLOT SCALE =

PLOT DATE = Jan 26, 2021

DJB


STATE OF ILLINOIS


DEPARTMENT OF TRANSPORTATION


SCALE: 1"=1'


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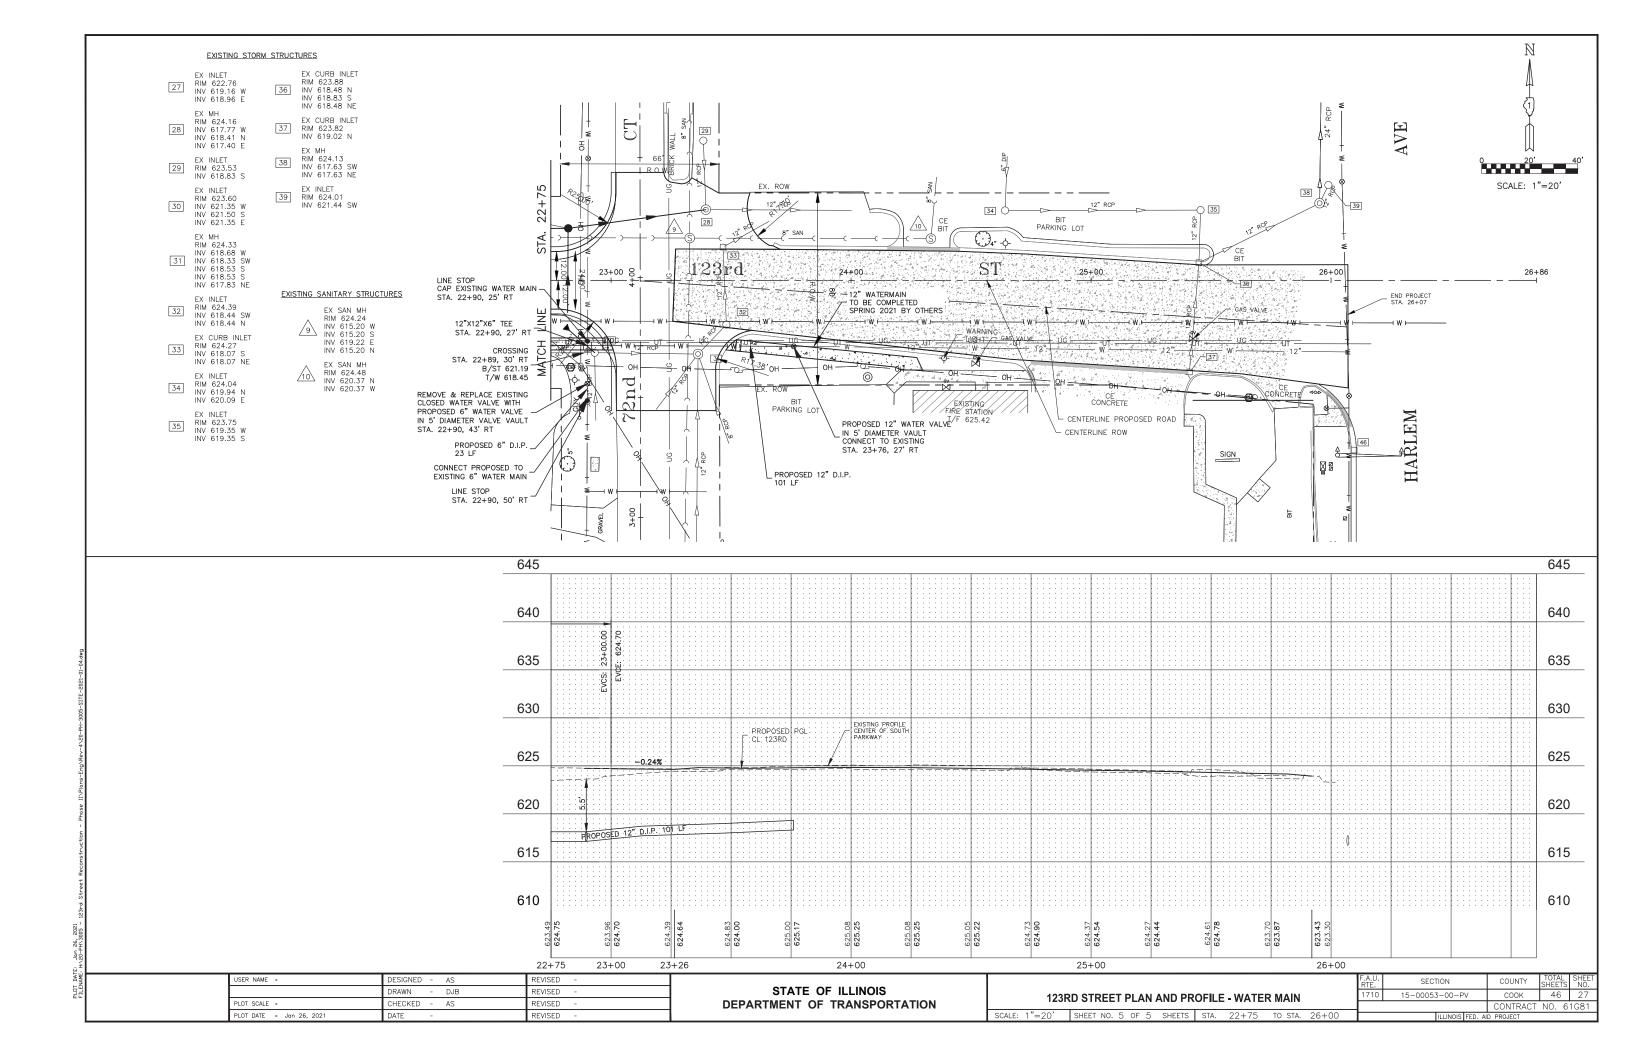
SCALE: 1"=1'




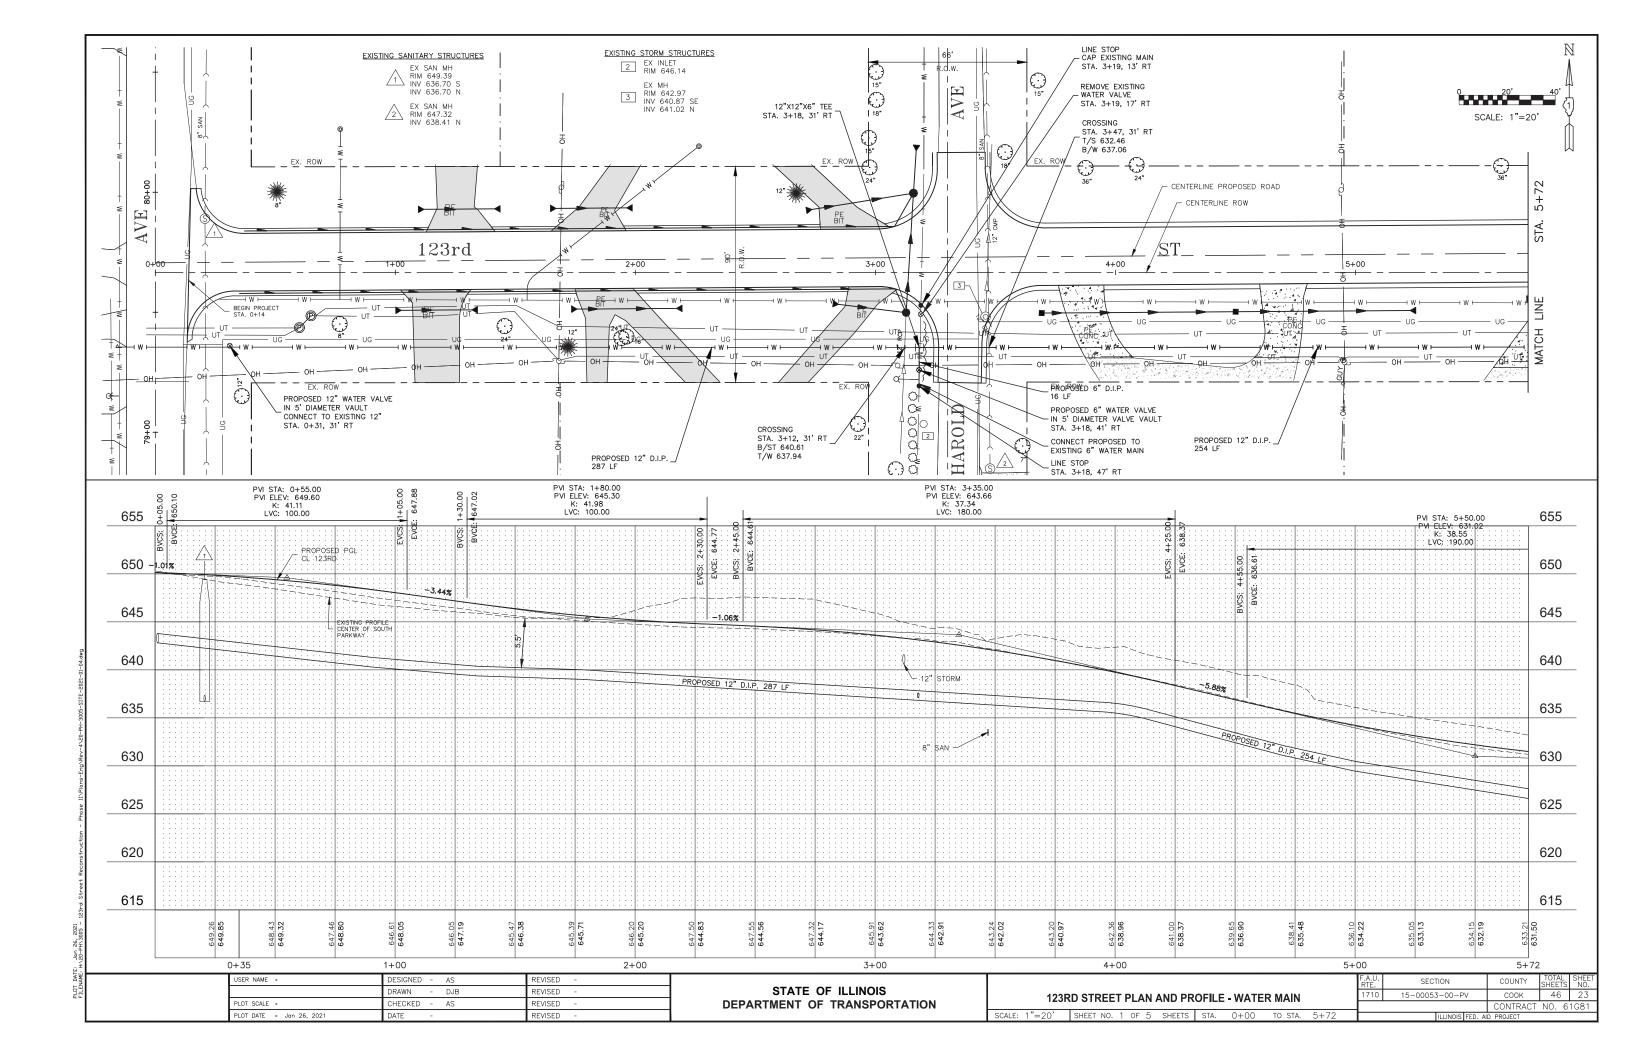


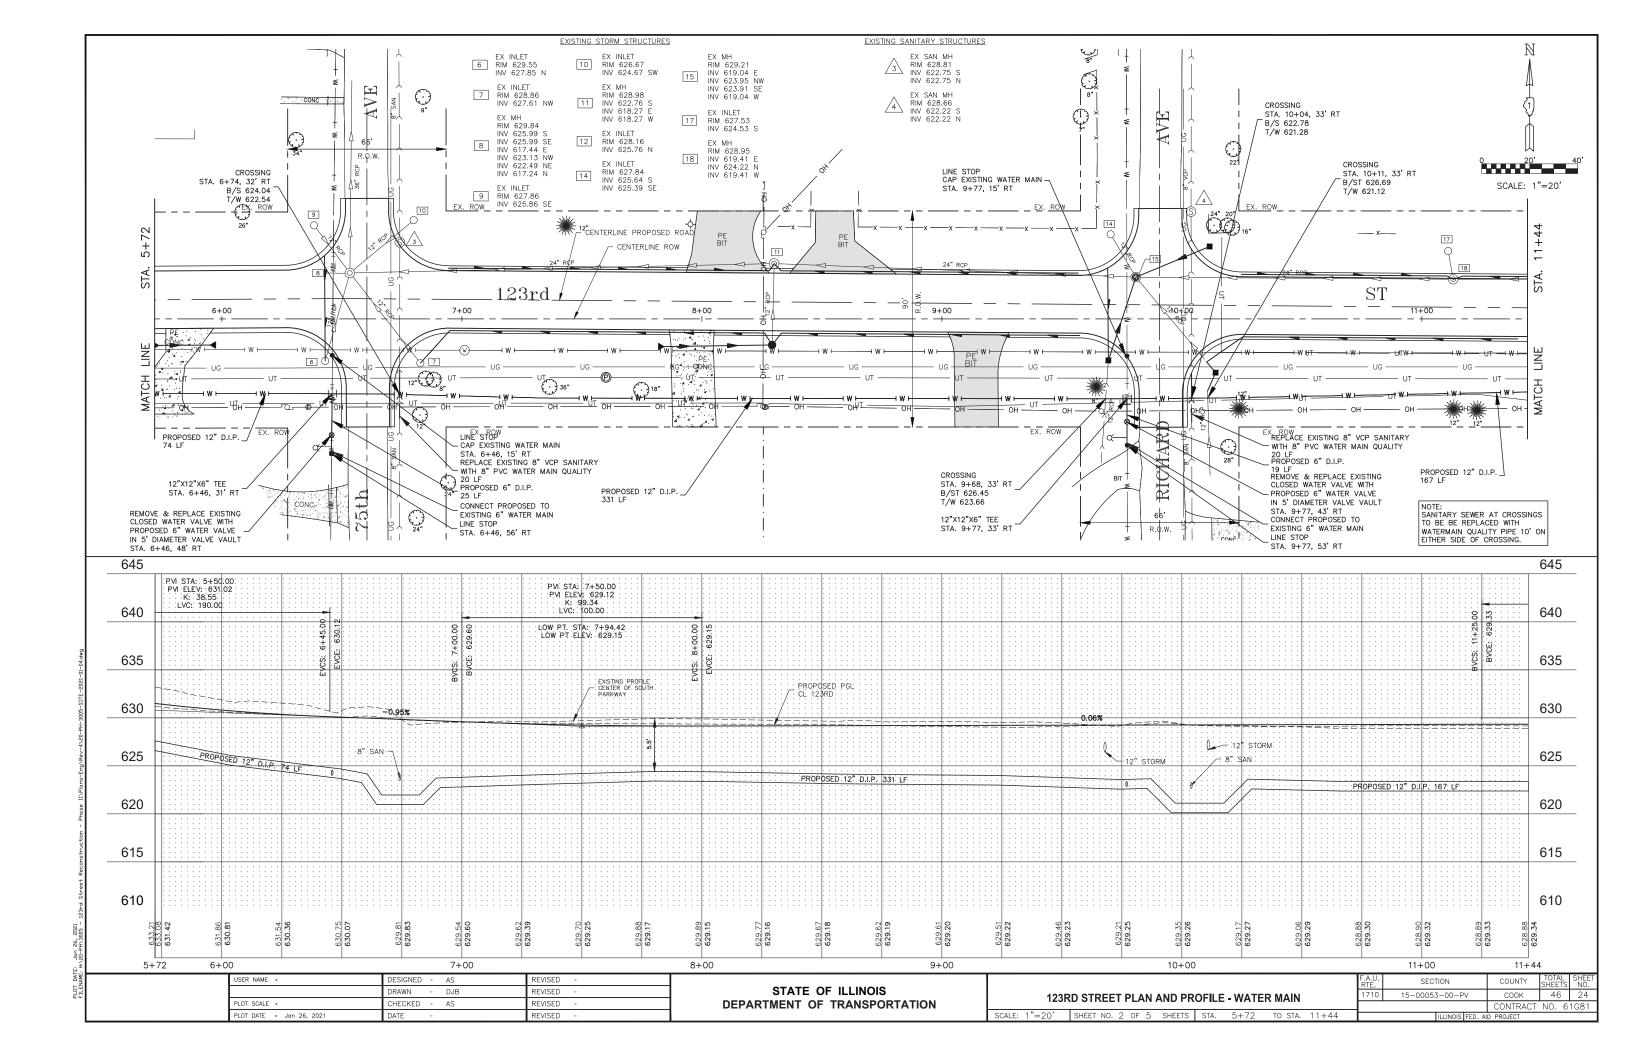


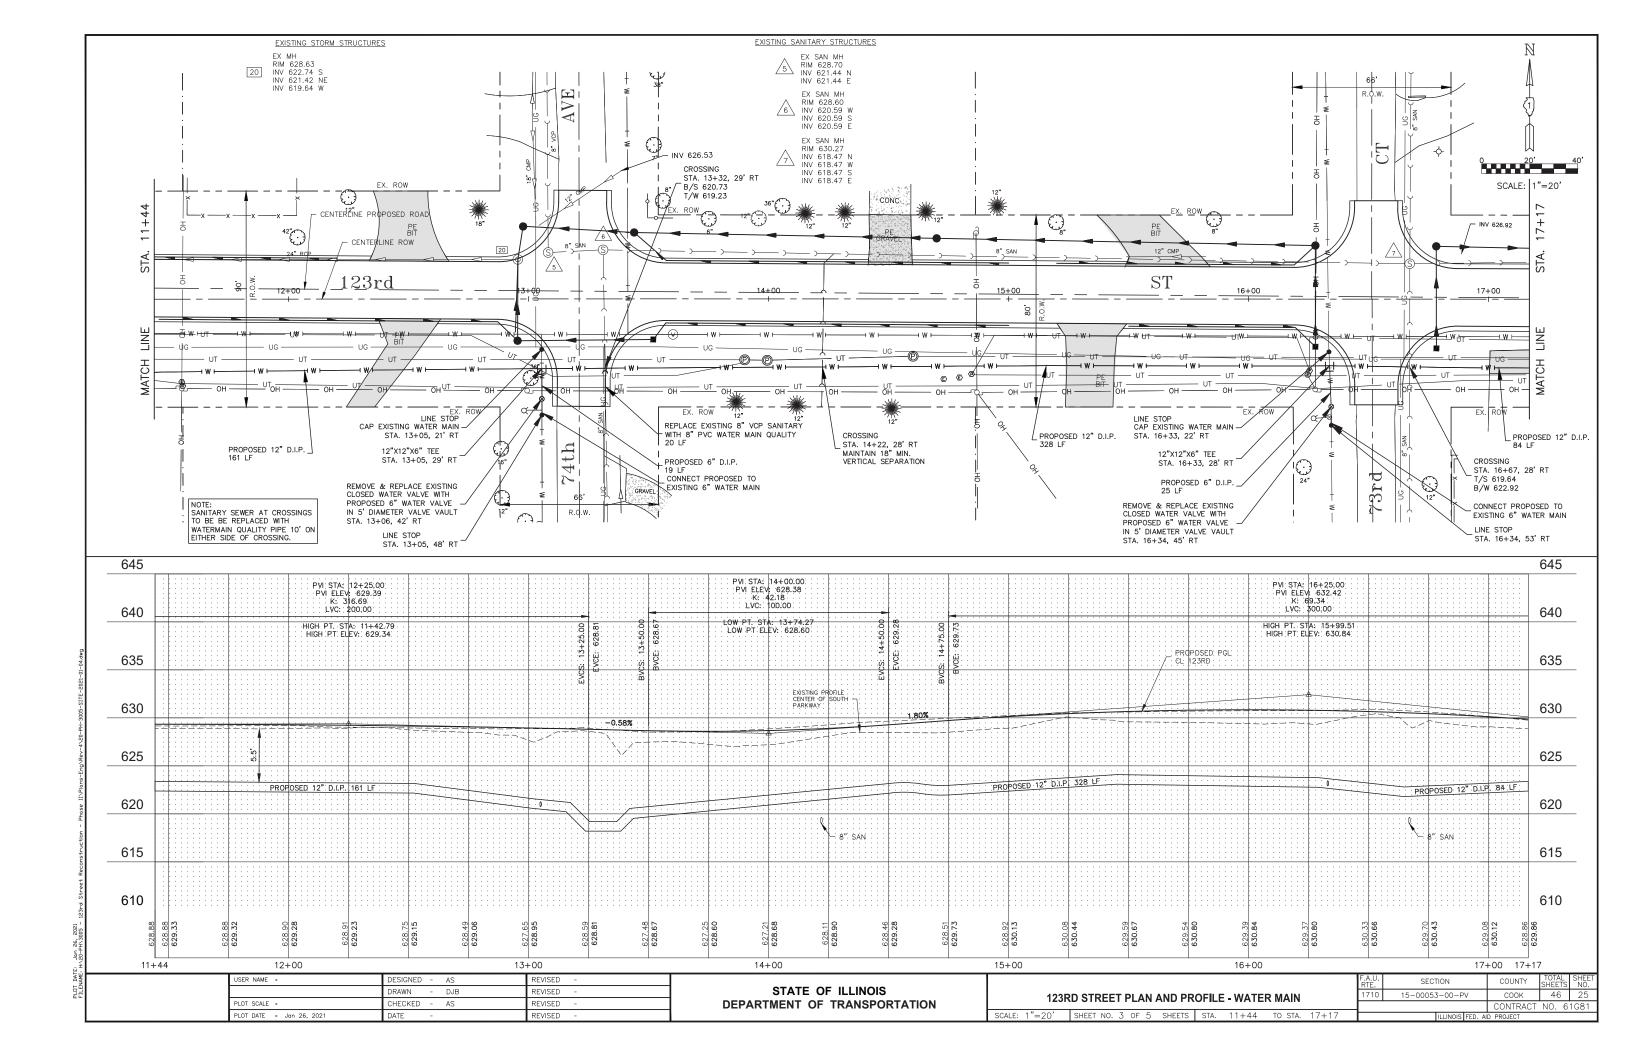


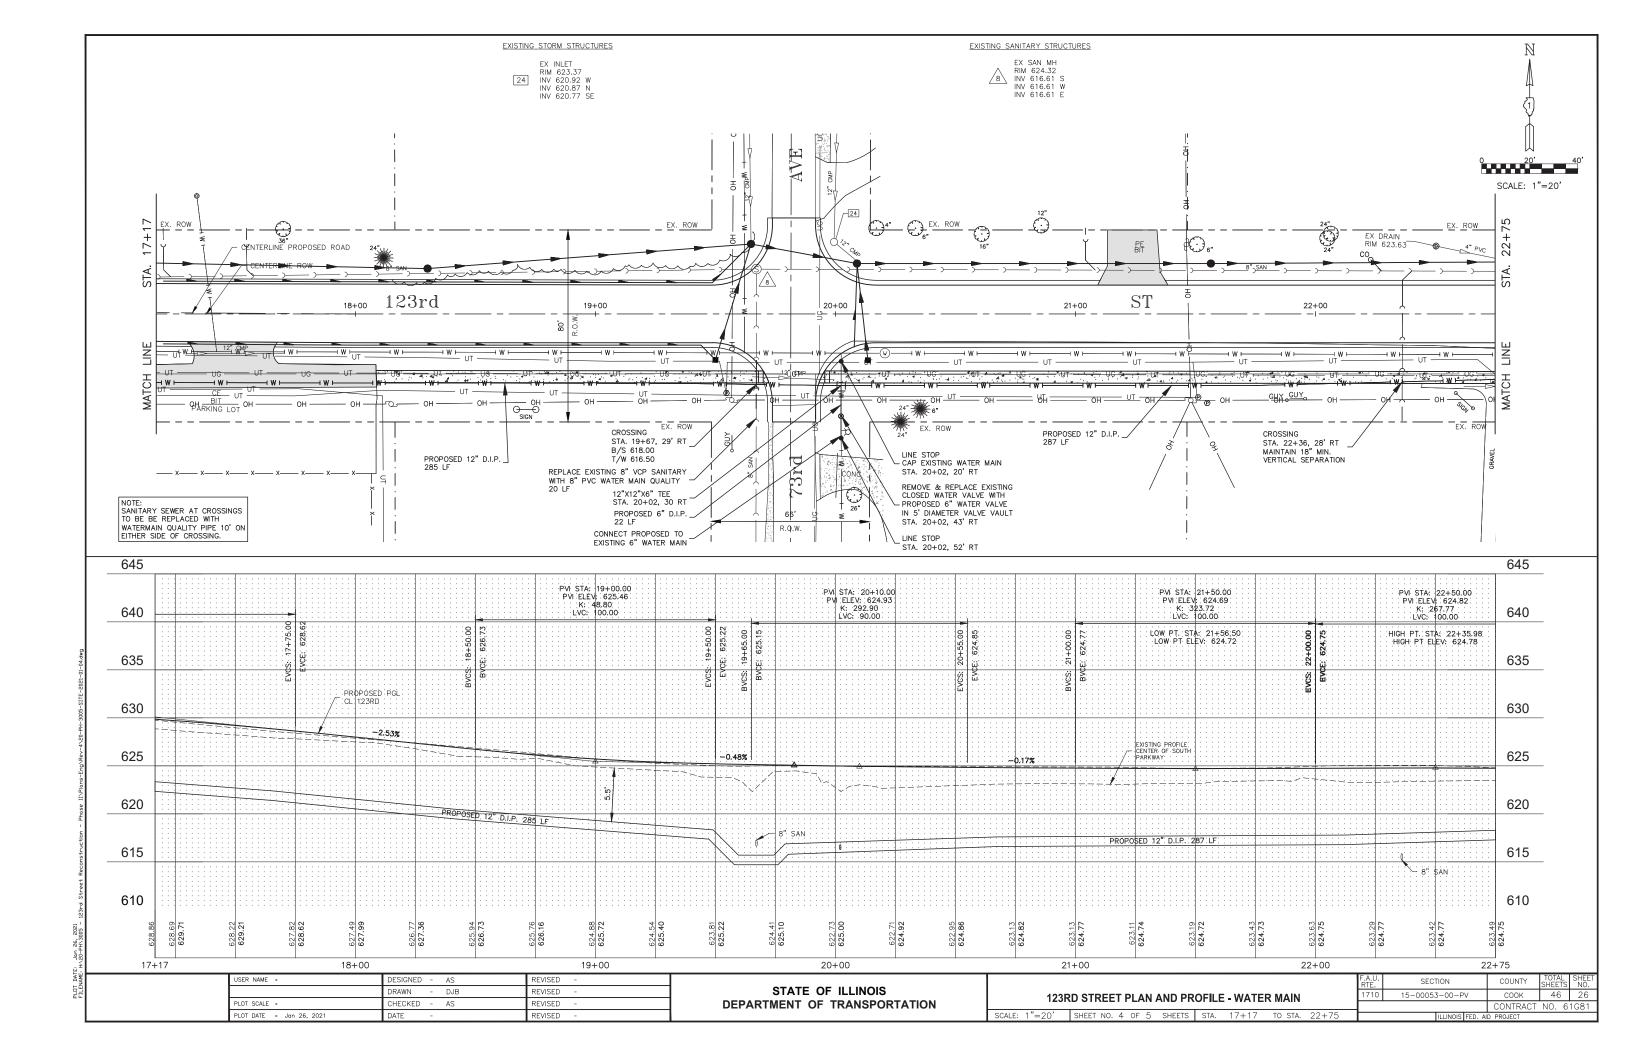


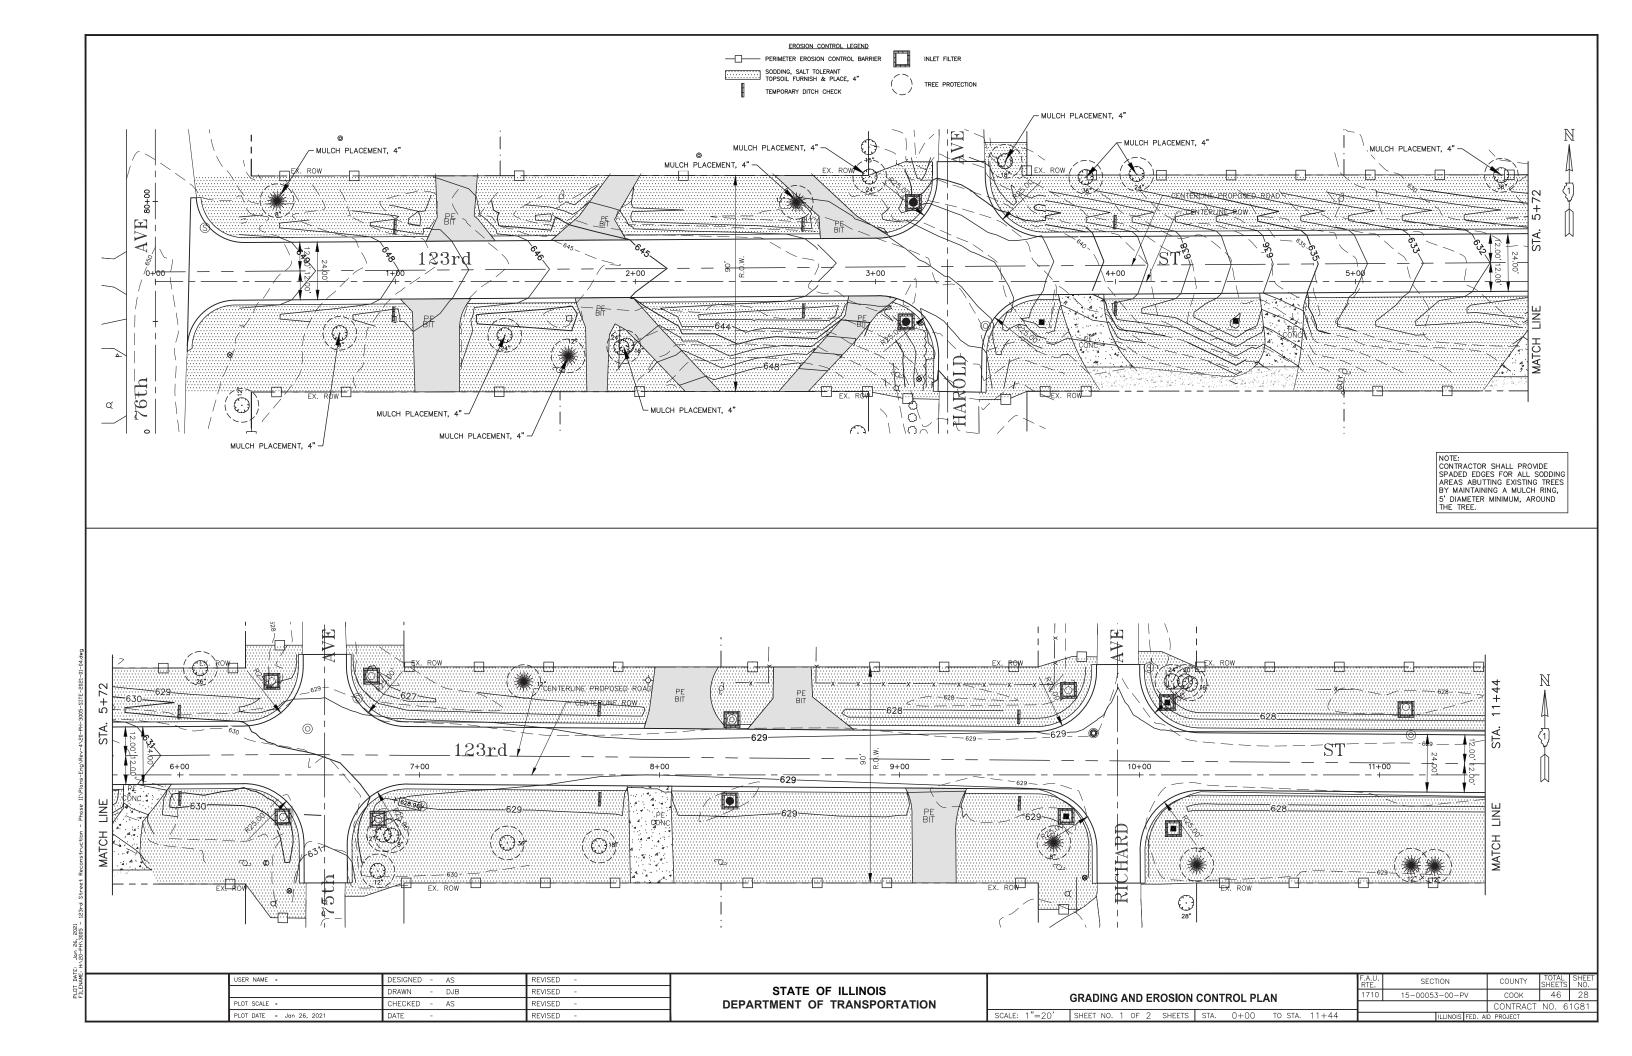


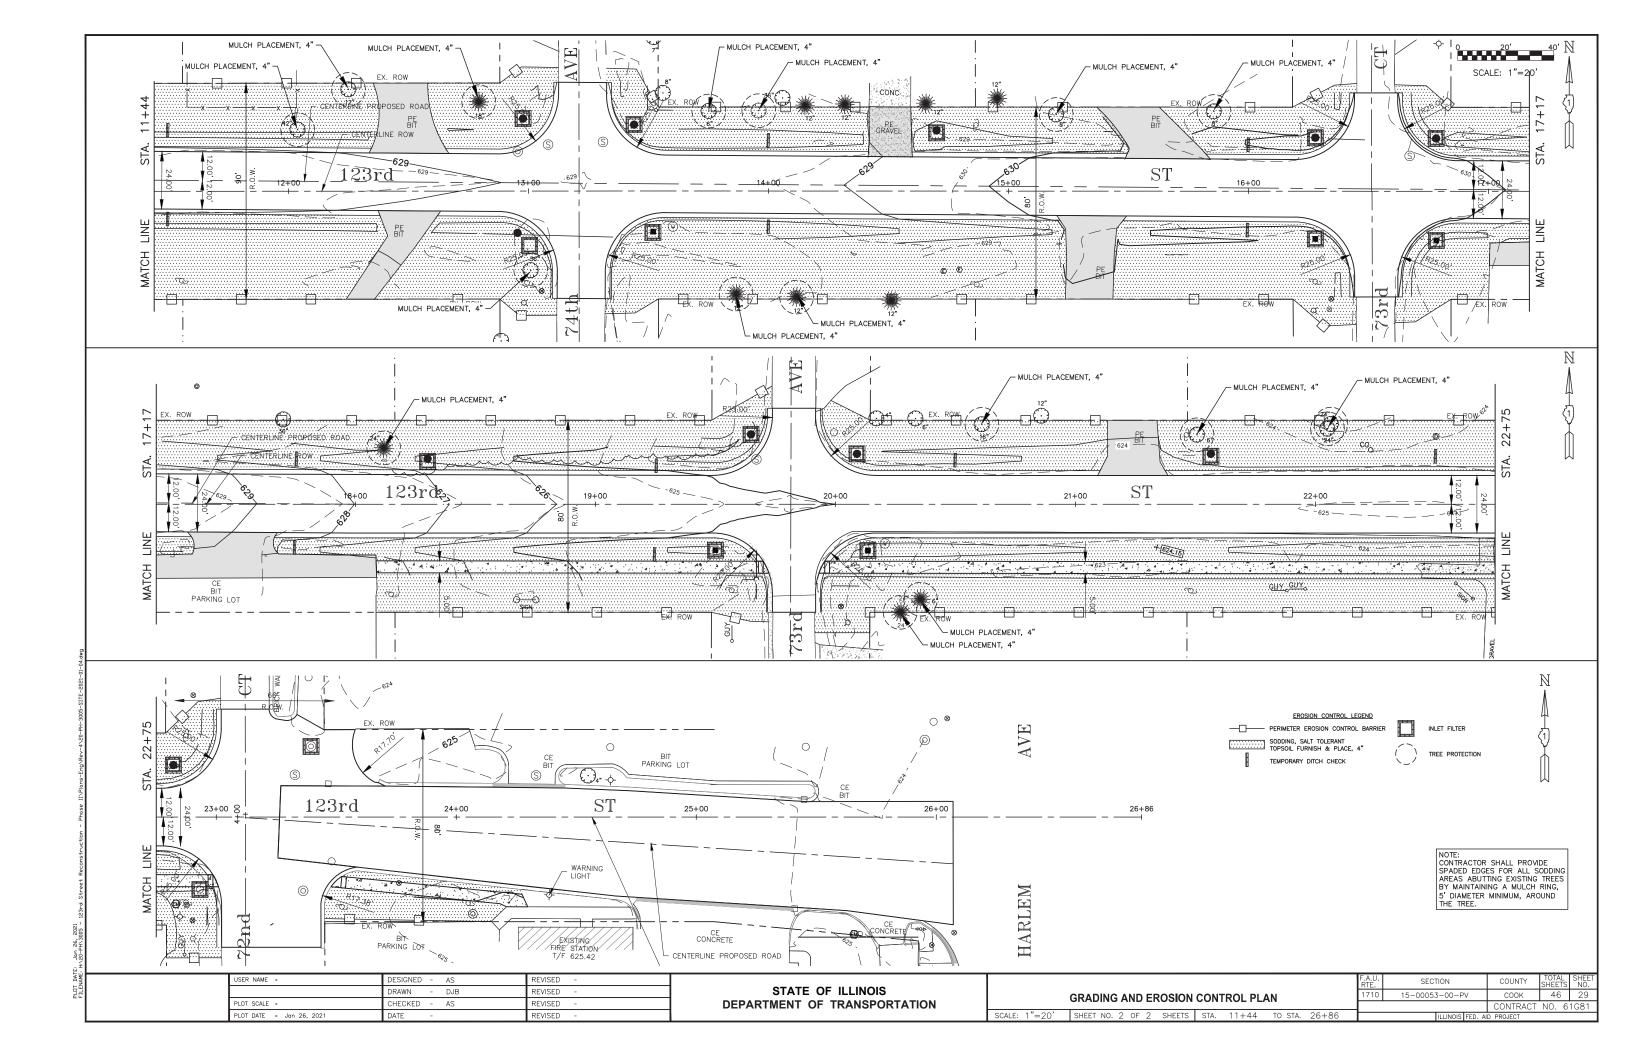


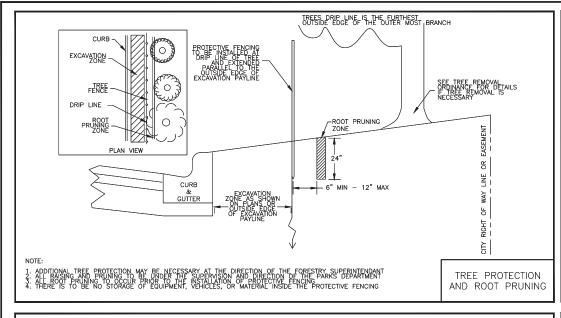


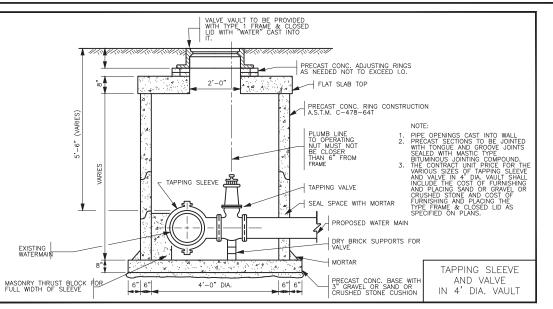

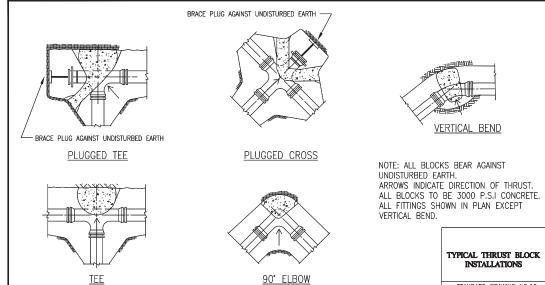

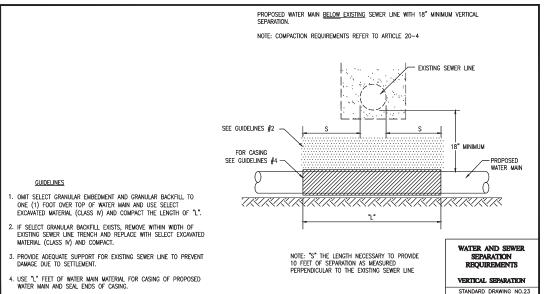

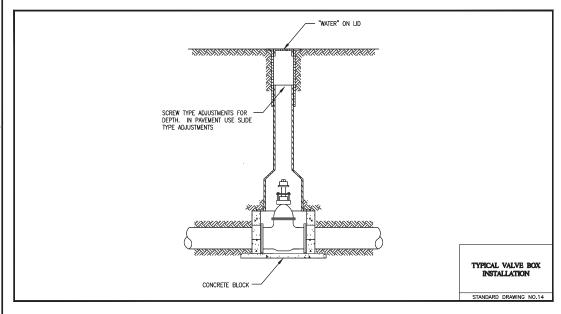

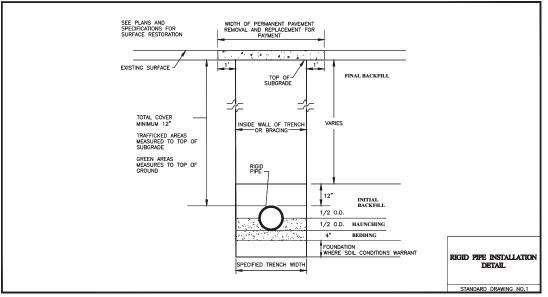



USER NAME =	DESIGNED - AS	REVISED -
	DRAWN - DJB	REVISED -
PLOT SCALE =	CHECKED - AS	REVISED -
PLOT DATE = Jan 26, 2021	DATE -	REVISED -


STANDARD DRAWING NO.12


Ц							F.A.U. SECTION		COUNTY	TOTAL SHEETS	SHEET NO.	
DETAIL SHEET								15-00053-00-PV		COOK	46	30
				7.02 0112						CONTRACT	NO. 6	1G81
CALE: -		SHEET NO. 1	OF 1	SHEETS	STA.	TO STA.	ILLINOIS FED. AID PROJECT					

WITH CONCRETE CURB, TYPE B

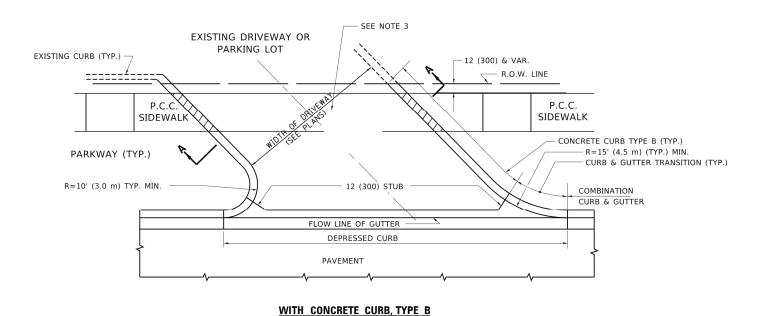

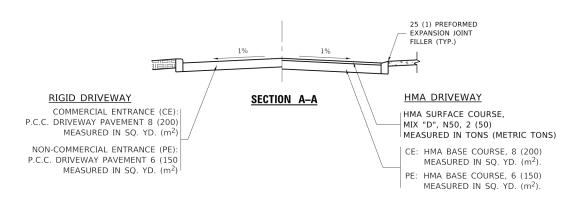

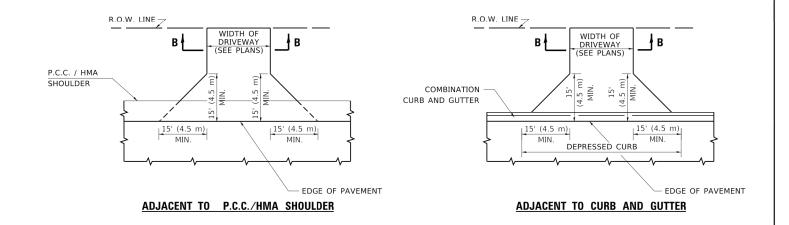

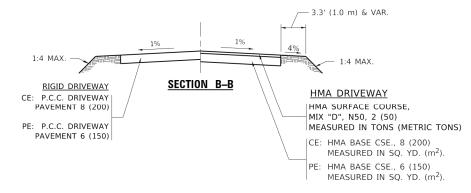

DRIVEWAY SLOPES, LOCATIONS, & GEOMETRIC LAYOUT SHALL BE IN ACCORDANCE WITH THE LATEST EDITION OF THE "HANDBOOK FOR POLICY ON PERMITS FOR ACCESS DRIVEWAYS TO STATE HIGHWAYS". FOR FURTHER LAYOUT REQUIREMENTS, REFER TO ILLUSTRATIONS IN THE PERMIT HANDBOOK. DRIVEWAYS SHALL BE REPLACED IN KIND, UNLESS OTHERWISE NOTED ON THE PLANS.

GENERAL NOTES:

COMMERCIAL DRIVEWAYS SHALL BE CONSTRUCTED WITH CONCRETE CURB, TYPE B RETURNS EXCEPT WHEN THE SIDEWALK EDGE IS 4 FEET (1.2 METERS) OR LESS FROM THE BACK OF CURB, CONSTRUCT A FLARE DRIVEWAY WITHOUT CURB.

THE RESIDENT ENGINEER SHALL CONTACT THE TRAFFIC PERMIT OFFICE AT 847/ 705-4131 FOR ANY QUESTIONS ON DRIVEWAYS SHOWN IN THE PLANS; SPECIFICALLY IN REFERENCE TO ADDITIONAL AND/OR RELOCATION/REMOVAL OF A DRIVEWAY.

COMBINATION CONCRETE CURB & GUTTER SHALL BE MEASURED STRAIGHT ACROSS THE DRIVEWAY. NO ADDITIONAL COMPENSATION WILL BE ALLOWED FOR THE CURB & GUTTER TRANSITION.

1 (25) PREFORMED EXPANSION JOINT FILLER WILL NOT BE PAID SEPARATELY, BUT SHALL BE CONSIDERED INCLUDED IN THE COST OF THE P.C.C. DRIVEWAY PAVEMENT OR P.C.C. SIDEWALK.

WHEN THE P.C.C. SIDEWALK EXTENDS THROUGH THE DRIVEWAY, THE THICKNESS OF THE SIDEWALK IN THE DRIVEWAY AREA SHALL BE THE SAME AS THE DRIVEWAY THICKNESS. SIDEWALK WILL BE PAID FOR AS P.C.C. SIDEWALK OF THE THICKNESS SPECIFIED. SIDEWALK CROSS SLOPE THRU DRIVEWAY AREA TO BE A MAXIMUM OF 1:50.

RURAL FIELD ENTRANCE (FE)

HMA SURFACE COURSE, MIX "D", N50, 2 (50) MEASURED IN TONS (METRIC TONS)

AGGREGATE BASE CSE., TYPE B, 8 (200) MEASURED IN SQ. YD. (m²).

USER NAME = footemj	DESIGNED	-	R. SHAH	REVISED	-	P. LaFLUER 04-15-03
	DRAWN	-		REVISED	-	R. BORO 01-01-07
PLOT SCALE = 50.0000 ' / in.	CHECKED	-		REVISED	-	R. BORO 06-11-08
PLOT DATE = 3/27/2019	DATE	-	11-04-95	REVISED	-	R. BORO 09-06-11


STATE OF ILLINOIS
DEPARTMENT OF TRANSPORTATION

DRIVEWAY DETAILS – DISTANCE BETWEEN R.O.W.										
AND	FACE OF	CURB	&	EDGE OF	SHOULDER	≥ 15′(4.5m)				
SCALE: NONE	SHEET	1 OF	1	SHEETS	STA.	TO STA.				

	F.A.U. RTE.	SECT	TON		COUNTY	TOTAL SHEETS	SHEET NO.				
	1710	15-00053	3-00-P	COOK	46	31					
_	В	D400-01 (BD-	-01)		CONTRACT NO. 61G81						
			ILLINOIS	FED. A	ID PROJECT						

RECONS WALKING - FINSE II MAINS-ENGINEV-4 AGO-FR-SUUS-III LE-INDIES-DE HILS-C


i Jan 26, 2021 Hi\20-PH\3005 - 123rd Street Reconstruction - Phase II\Plans-Eng\Re

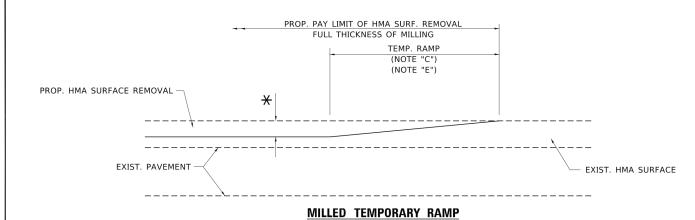

(FOR BUTT JOINT AND HMA TAPER SEE DETAIL BELOW)

N BOTT JOINT AND HIMA TAILK SEE BETA

OPTION 1

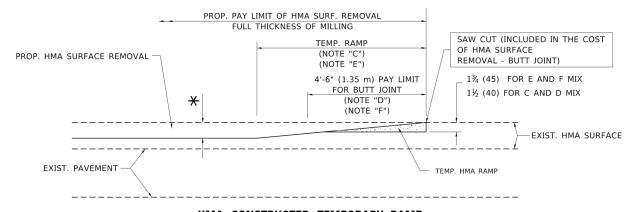


HMA CONSTRUCTED TEMPORARY RAMP


(FOR BUTT JOINT AND HMA TAPER SEE DETAIL BELOW)


OPTION 2

TYPICAL TEMPORARY RAMP

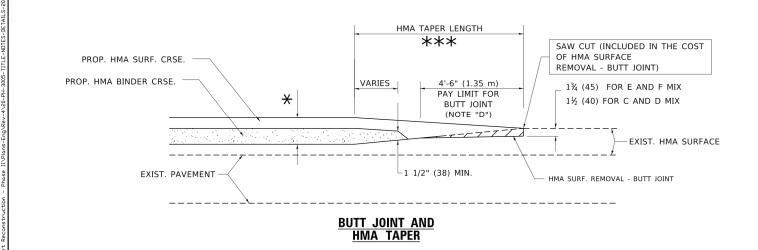

TYPICAL BUTT JOINT AND HMA TAPER FOR MILLING AND RESURFACING

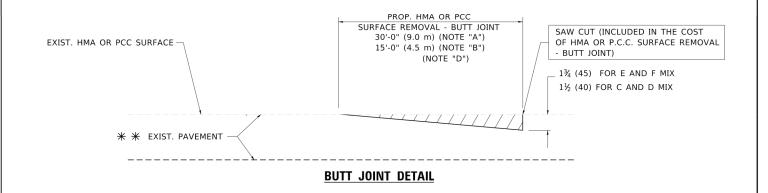

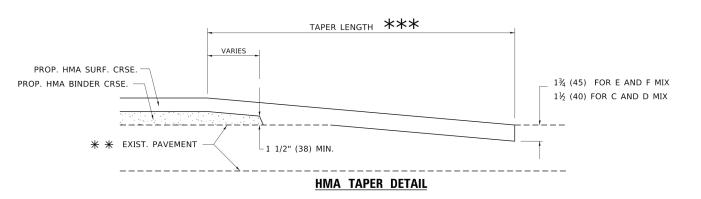

TYPICAL BUTT JOINT AND HMA TAPER FOR RESURFACING ONLY

** PC CONCRETE, HMA OR HMA RESURFACED PAVEMENT

NOTES

- A. MAINLINE ROADWAYS AND MAJOR SIDE ROADS.
- B. MINOR SIDE ROADS.
- C. THE TEMP. RAMP SHALL BE CONSTRUCTED IMMEDIATELY UPON REMOVAL OF THE EXISTING HMA SURFACE.
- D. THE BUTT JOINT SHALL BE CONSTRUCTED IMMEDIATELY PRIOR TO PLACING THE PROPOSED HMA COURSES.
- E. TAPER THE TEMP. RAMP AT A RATE OF 3'-0" (900 mm) PER 1 INCH (25 mm) OF MILLING THICKNESS.
- F. INSTALLATION AND REMOVAL OF THE 4'-6" (1.35 m) TEMP. RAMP IS INCLUDED IN COST OF HMA SURFACE REMOVAL BUTT JOINT.

 ** SEE TYPICAL SECTIONS FOR MILLING THICKNESS.
- G. SEE ARTICLE 406.08 AND 406.14 OF THE STANDARD SPECIFICATIONS FOR "HMA AND/OR PCC SURFACE REMOVAL, BUTT JOINT".

20'-0" (6.1 m) PER 1 (25) RESURFACING (NOTE "A")

10'-0" (3.0 m) PER 1 (25) RESURFACING (NOTE "B")


BASIS OF PAYMENT

THE BUTT JOINT WILL BE PAID FOR AT THE CONTRACT UNIT PRICE PER SQUARE YARD (SQUARE METER)
FOR "HOT-MIX ASPHALT SURFACE REMOVAL - BUTT JOINT" OR FOR "PORTLAND CEMENT CONCRETE SURFACE REMOVAL- BUTT JOINT".

ALL DIMENSIONS ARE IN INCHES (MILLIMETERS) UNLESS OTHERWISE SHOWN.

USER NAME = footemj	DESIGNED	-	M. DE YONG	REVISED	-	R. SHAH 10-25-94
	DRAWN	-		REVISED	-	A. ABBAS 03-21-97
PLOT SCALE = 50.0000 ' / in.	CHECKED	-		REVISED	-	M. GOMEZ 04-06-01
PLOT DATE = 3/27/2019	DATE	-	06-13-90	REVISED	-	R.BORO 01-01-07

BUTT JOINT AND							F.A.U. RTE.	SECTION		COUNTY	TOTAL SHEETS	SHEET NO.
HMA TAPER DETAILS						1710	15-00053-00-PV	/	COOK	46	32	
							BD400-05 BD32	Ĭ	CONTRACT	NO. 6	1G81	
SCALE: NONE	SHEET 1	OF	1	SHEETS	STA.	TO STA.		ILLINOIS	FED. AI	D PROJECT		

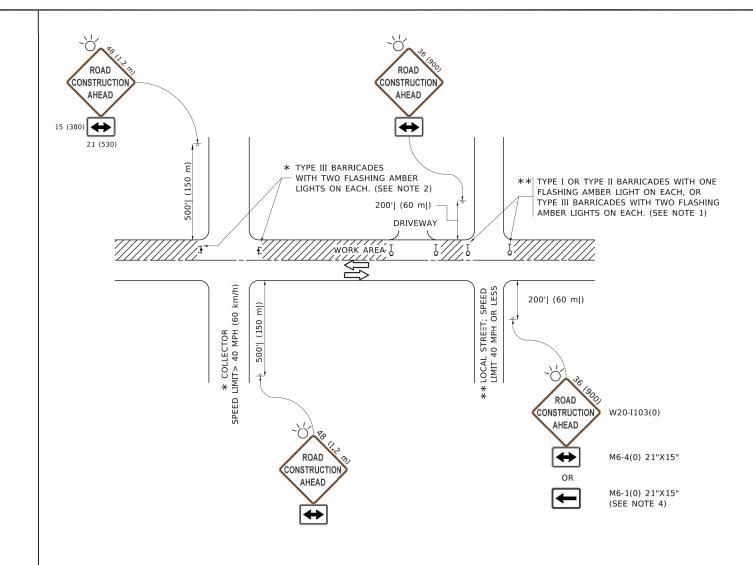

NOTES:

- 1. SIDE ROAD WITH A SPEED LIMIT OF 40 MPH (60 km/h) OR LESS AS SHOWN ON THE DRAWING AND AS DIRECTED BY THE ENGINEER:
- a) ONE "ROAD CONSTRUCTION AHEAD" SIGN 36 x 36 (900x900) WITH A FLASHER MOUNTED ON IT APPROXIMATELY 200' (60 m) IN ADVANCE OF THE MAIN ROUTE.
- b) THE CLOSED PORTION OF THE MAIN ROUTE SHALL BE PROTECTED BY BLOCKING WITH TYPE I, TYPE II OR TYPE III BARRICADES, 1/3 OF THE CROSS SECTION OF THE CLOSED PORTION.
- SIDE ROAD WITH A SPEED LIMIT GREATER THAN 40 MPH (60 km/h) AS SHOWN ON THE DRAWING AND AS DIRECTED BY THE ENGINEER:
- a) ONE "ROAD CONSTRUCTION AHEAD" SIGN 48 x 48 (1.2 m x 1.2 m) WITH A FLASHER MOUNTED ON IT APPROXIMATELY 500' (150 m) IN ADVANCE OF THE MAIN ROUTE.
- THE CLOSED PORTION OF THE MAIN ROUTE SHALL BE PROTECTED BY
 b) BLOCKING WITH TYPE III BARRICADES, 1/2 OF THE CROSS SECTION
 OF THE CLOSED PORTION.
- CONES MAY BE SUBSTITUTED FOR BARRICADES OR DRUMS AT HALF THE SPACING DURING DAY OPERATIONS. CONES SHALL BE A MINIMUM OF 28 (710) IN HEIGHT.
- WHEN THE SIDE ROAD LIES BETWEEN THE BEGINNING OF THE MAINLINE 4. SIGNING AND THE WORK ZONE, A SINGLE HEADED ARROW (M6-1) SHALL BE USED IN LIEU OF THE DOUBLE HEADED ARROW (M6-4).

- 5. WHEN WORK IS BEING PERFORMED ON A SIDE ROAD OR DRIVEWAY, FOLLOW THE APPLICABLE STANDARD(S). THE DIRECTIONAL ARROW (M6-1 OR M6-4) SHALL BE COVERED OR REMOVED WHEN NO LONGER CONSISTENT WITH THE TRAFFIC CONTROL SET-UP.
- 6. ADVANCE WARNING SIGNS ARE TO BE OMITTED ON DRIVEWAYS UNLESS OTHERWISE SPECIFIED IN THE PLANS OR BY THE
- 7. THE TRAFFIC CONTROL AND PROTECTION FOR SIDE ROADS, INTERSECTIONS, AND DRIVEWAYS SHALL BE INCLUDED IN THE COST OF SPECIFIED TRAFFIC CONTROL STANDARDS OR ITEMS.

All dimensions are in inches (millimeters) unless otherwise shown.

STATE OF ILLINOIS DEPARTMENT OF TRANSPORTATION

TRAFFIC CONTROL AND PROTECTION FOR SIDE ROADS, INTERSECTIONS, AND DRIVEWAYS


 FAU. RTE.
 SECTION
 COUNTY
 TOTAL SHEETS
 SHEETS NO.


 1710
 15-00053-00-PV
 COOK
 46
 33

 TC-10
 CONTRACT
 NO.
 61G81

 SIDE NOADS, INTERSECTIONS, AND DRIVEWATS
 TC-10
 CO

 SCALE: NONE
 SHEET 1 OF 1 SHEETS STA. TO STA.
 ILLINOIS FED. AID PRO

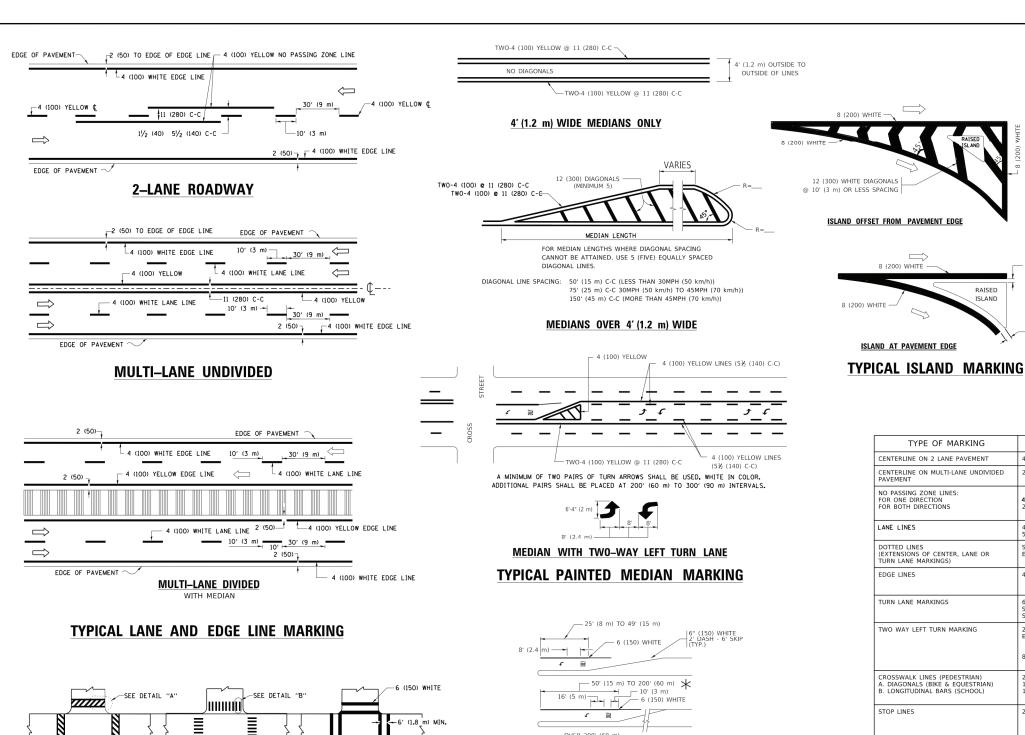

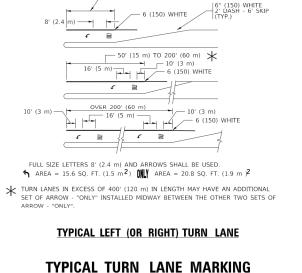

LANE LINES SKIP-DASH SKIP-DASH 10' (3 m) LINE WITH 30' (9 m) SPACE 4 (100) 5 (125) ON FREEWAYS DOTTED LINES (EXTENSIONS OF CENTER, LANE OR TURN LANE MARKINGS) SAME AS LINE BEING EXTENDED SKIP-DASI SAME AS LINE BEING EXTENDED 2' (600) LINE WITH 6' (1.8 m) SPACE EDGE LINES 4 (100) SOLID YELLOW-LEFT OUTLINE MEDIANS IN YELLOW 6 (150) LINE; FULL SIZE LETTERS & SYMBOLS (8' (2.4m)) SEE TYPICAL TURN LANE MARKING DETAIL TURN LANE MARKINGS SOLID WHITE 10' (3 m) LINE WITH 30' (9 m) SPACE FOR SKIP-DASH; 5½ (140) C-C BETWEEN SOLID TWO WAY LEFT TURN MARKING YELLOW LINE AND SKIP-DASH LINE SEE TYPICAL TWO-WAY LEFT TURN MARKING DETAIL 8' (2.4m) LEFT ARROW CROSSWALK LINES (PEDESTRIAN) A. DIAGONALS (BIKE & EQUESTRIAN) B. LONGITUDINAL BARS (SCHOOL) NOT LESS THAN 6' (1.8 m) APART 2' (600) APART 2' (600) APART 5EE TYPICAL CROSSWALK MARKING DETAILS. 2 @ 6 (150) 12 (300) @ 45° 12 (300) @ 90° PLACE 4' (1.2 m) IN ADVANCE OF AND
PARALLEL TO CROSSWALK, IF PRESENT.
OTHERWISE, PLACE AT DESIRED STOPPING
POINT. PARALLEL TO CROSSROAD CENTERLINE, WHERE
POSSIBLE STOP LINES 24 (600) SOLID WHITE 2 @ 4 (100) WITH 12 (300) DIAGONALS @ 45° NO DIAGONALS USED FOR 4' (1.2 m) WIDE MEDIANS YELLOW: TWO WAY TRAFFIC WHITE: ONE WAY TRAFFIC GORE MARKING AND CHANNELIZING LINES 8 (200) WITH 12 (300) DIAGONALS @ 45° SOLID WHITE DIAGONALS: DIAGONALS: 15' (4.5 m) C-C (LESS THAN 30MPH (50 km/h)) 20' (6 m) C-C 30MPH (50 km/h) TO 45MPH (70 km/h)) 30' (9 m) C-C (OVER 45MPH (70 km/h)) 24 (600) TRANSVERSE LINES; "RR" IS 6' (1.8 m LETTERS; 16 (400) LINE FOR "X" SEE STATE STANDARD 780001 AREA OF: "R"=3.6 SQ. FT. (0.33 m PEACH "X"=54.0 SQ. FT. (5.0 m P RAILROAD CROSSING SOLID WHITE SHOULDER DIAGONALS (REQUIRED FOR SHOULDERS > 8') WHITE - RIGHT YELLOW - LEFT SOLID U TURN ARROW SEE DETAIL SOLID WHITE SOLID WHITE 2 ARROW COMBINATION SEE DETAIL 30.4 SF LEFT AND U TURN

WIDTH OF LINE

4 (100)

2 @ 4 (100)

4 (100) 2 @ 4 (100)

COMBINATION

LEFT AND U-TURN

5'-4" (1620)

32 R (810)

U-TURN

COLOR

YELLOW

YELLOW

YELLOW YELLOW

PATTERN

SKIP-DASH

SOLID

SOLID SOLID

FOR FURTHER DETAILS ON PAVEMENT MARKING REFER TO STANDARD SPECIFICATIONS FOR ROAD AND BRIDGE CONSTRUCTION AND STATE STANDARD 780001.

8 (200) WHITE

RAISED ISLAND

TYPE OF MARKING

CENTERLINE ON MULTI-LANE UNDIVIDED

CENTERLINE ON 2 LANE PAVEMENT

NO PASSING ZONE LINES:

FOR ONE DIRECTION FOR BOTH DIRECTIONS

unless otherwise shown.

D(FT)

345

425

500

580

665

750

LANE REDUCTION TRANSITION * LANE REDUCTION ARROWS REQUIRED AT SPEEDS OF 45 MPH OR GREATER OR WHEN SPECIFIED IN PLANS.

SPACING / REMARKS

10' (3 m) LINE WITH 30' (9 m) SPACE

5½ (140) C-C FROM SKIP-DASH CENTERLINE 11 (280) C-C OMIT SKIP-DASH CENTERLINE BETWEEN

11 (280) C-C

SPEED LIMIT

35

50

DESIGNED -EVERS C. JUCIUS 09-09-09 JSER NAME = footem REVISED DRAWN REVISED C. JUCIUS 07-01-13 CHECKED C. JUCIUS 12-21-15 DATE REVISED PLOT DATE = 3/4/2019 03-19-90 C. JUCIUS 04-12-16

PEDESTRIAN

-6 (150) WHITE

TYPICAL CROSSWALK MARKING

* MARKINGS SHALL BE INSTALLED PARALLEL TO THE CENTERLINE OF THE ROAD WHICH IT CROSSES

DETAIL "A"

2' (600)

DETAIL "B"


__12 (300) WHITE


STATE OF ILLINOIS DEPARTMENT OF TRANSPORTATION

DISTRICT ONE TYPICAL PAVEMENT MARKINGS						F.AU RTE.	SECTION	COUNTY	TOTAL SHEETS	SHEET NO.	
						1710	15-00053-00-PV	соок	46	34	
TITIOAL LAVEIMENT MAININGS								TC-13	CONTRACT NO. 61G81		
SCALE: NONE	SHEET 1	OF 2	SHEETS	STA.	TO STA.		ILLINOIS FED AID PROJECT				

///////

BICYCLE & EQUESTRIAN

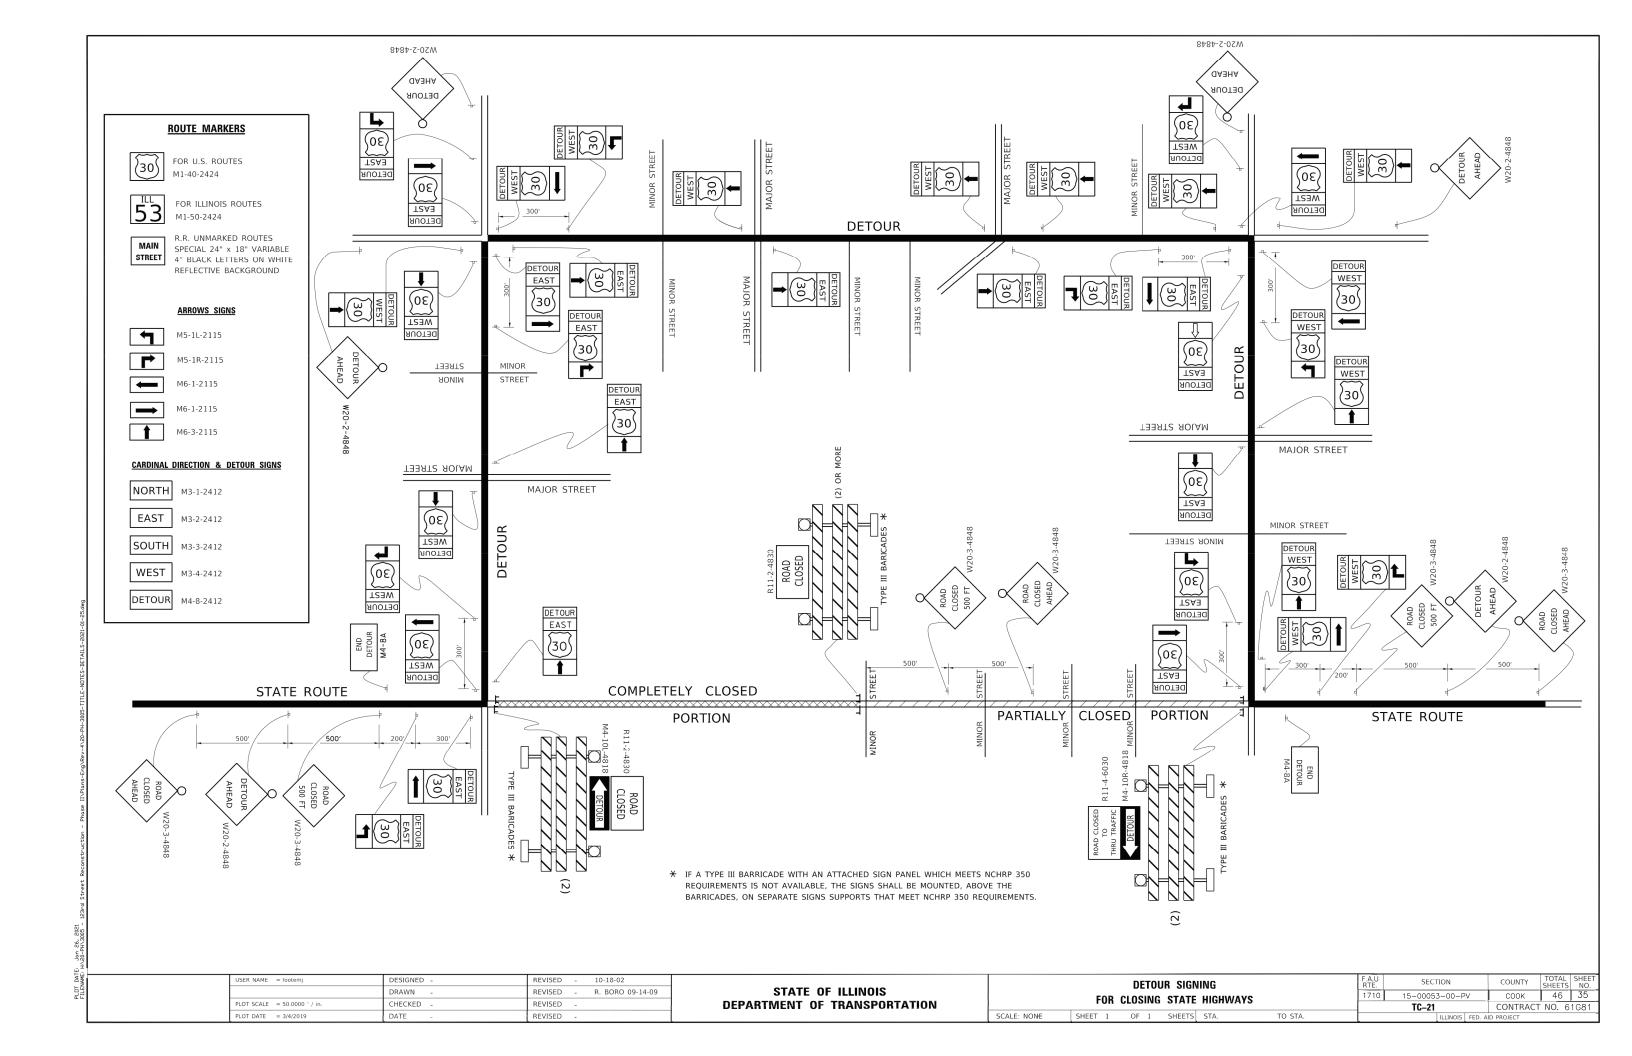

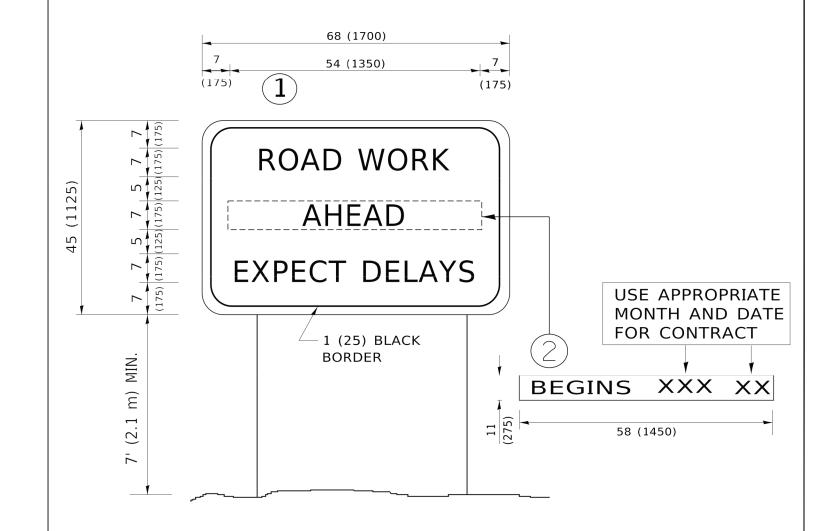

NOTES:

- 1. USE BLACK LETTERING ON ORANGE BACKGROUND.
- 2. ERECT SIGNS IN ADVANCE OF THE LOCATION FOR THE "ROAD CONSTRUCTION AHEAD" SIGN AT LOCATIONS AS DIRECTED BY THE ENGINEER.
- 3. ERECT SIGN 1) WITH INSTALLED PANEL 2) ONE WEEK PRIOR TO THE START OF CONSTRUCTION.
- 4. REMOVE PANEL(2)SOON AFTER THE START OF CONSTRUCTION.
- 5. SEE SPECIAL PROVISION FOR "TEMPORARY INFORMATION SIGNING" FOR ADDITIONAL INFORMATION.
- 6. ONE SIGN ASSEMBLY EQUALS 25.70 SQ. FT. (2.3 SQ. M.)
- 7. SHALL BE PAID FOR AS TEMPORARY INFORMATION SIGNING.

ALL DIMENSIONS ARE IN INCHES (MILLIMETERS)
UNLESS OTHERWISE SHOWN.


USER NAME = footemj	DESIGNED -	REVISED - R. MIRS 09-15-97				ARTERIAL	ROAD		F.A.U.	SECTION	COUNTY	TOTAL SHEET
	DRAWN -	REVISED - R. MIRS 12-11-97	STATE OF ILLINOIS						1710	15-00053-00-PV	соок	46 36
PLOT SCALE = 50.0000 ' / in.	CHECKED -	REVISED -T. RAMMACHER 02-02-99	DEPARTMENT OF TRANSPORTATION	INFORMATION SIGN				TC-22	CONTRAC	T NO. 61G81		
PLOT DATE = 3/4/2019	DATE -	REVISED - C. JUCIUS 01-31-07		SCALE: NONE	SHEET 1	OF 1 SHE	ETS STA	. TO STA.		ILLINOIS FED.	AID PROJECT	

3.0" RADIUS, 0.5" BORDER, WHITE ON GREEN; REFLECTORIZED "DRIVEWAY" D; "ENTRANCE" D; STANDARD ARROW CUSTOM 12.0" x 5.0"


NOTES:

- 1. HALF OF THE SIGNS WILL REQUIRE A LEFT HAND FACING ARROW.
- 2. TWO SIGNS SHALL BE USED AT EACH COMMERCIAL ENTRANCE PLACED BACK-TO-BACK: ONE WITH A RIGHT HAND ARROW (SHOWN) SHALL BE PLACED ON THE NEAR RIGHT SIDE THE DRIVEWAY AND ONE WITH A LEFT HAND ARROW SHALL BE PLACED ON THE FAR LEFT SIDE OF THE DRIVEWAY.
- 3. SIGNS TO BE PAID FOR AS ITEM "TEMPORARY INFORMATION SIGNING".


STATE OF ILLINOIS
DEPARTMENT OF TRANSPORTATION

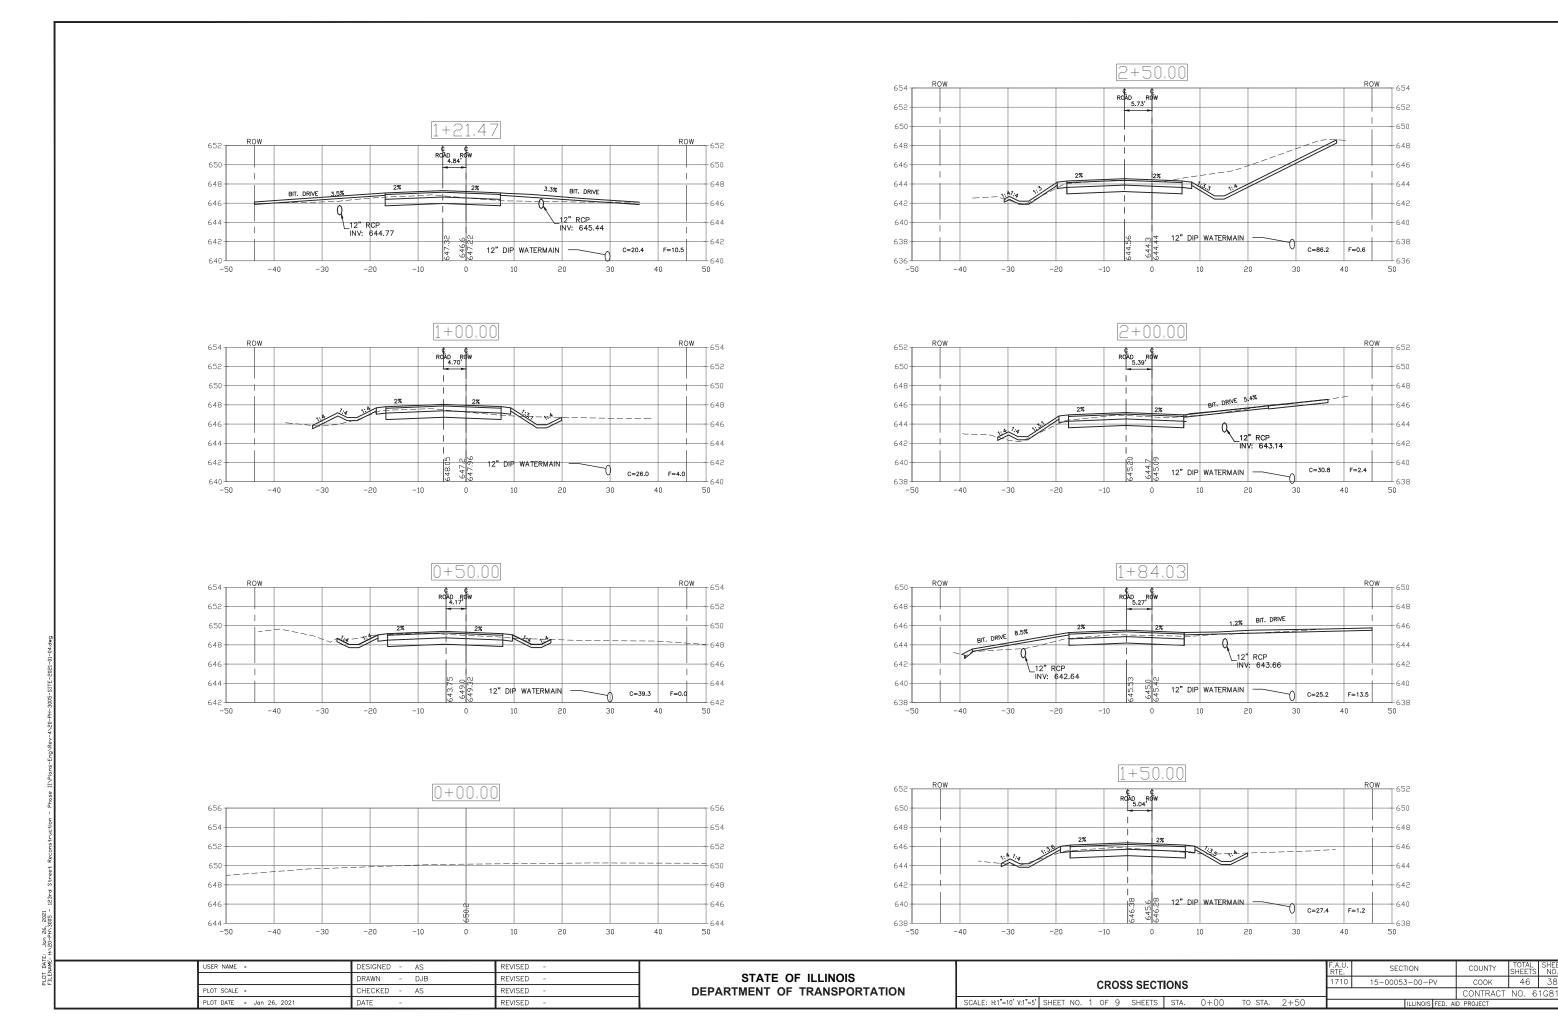



TOTAL SHEE NO. 46 38

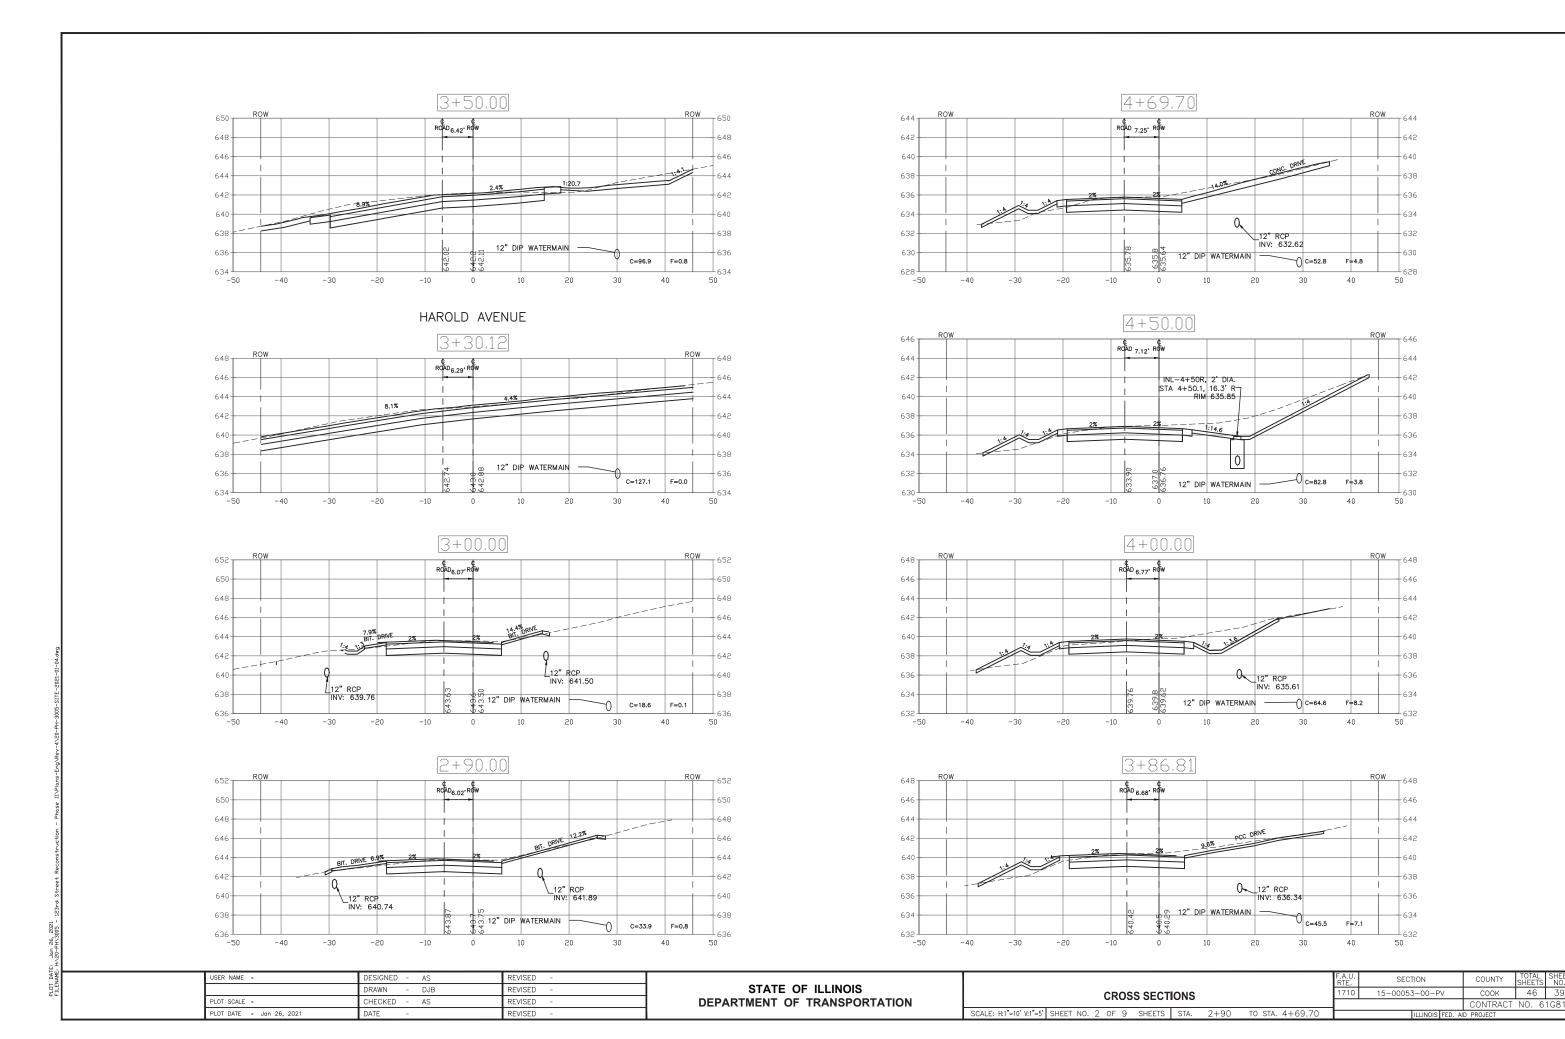



46 39

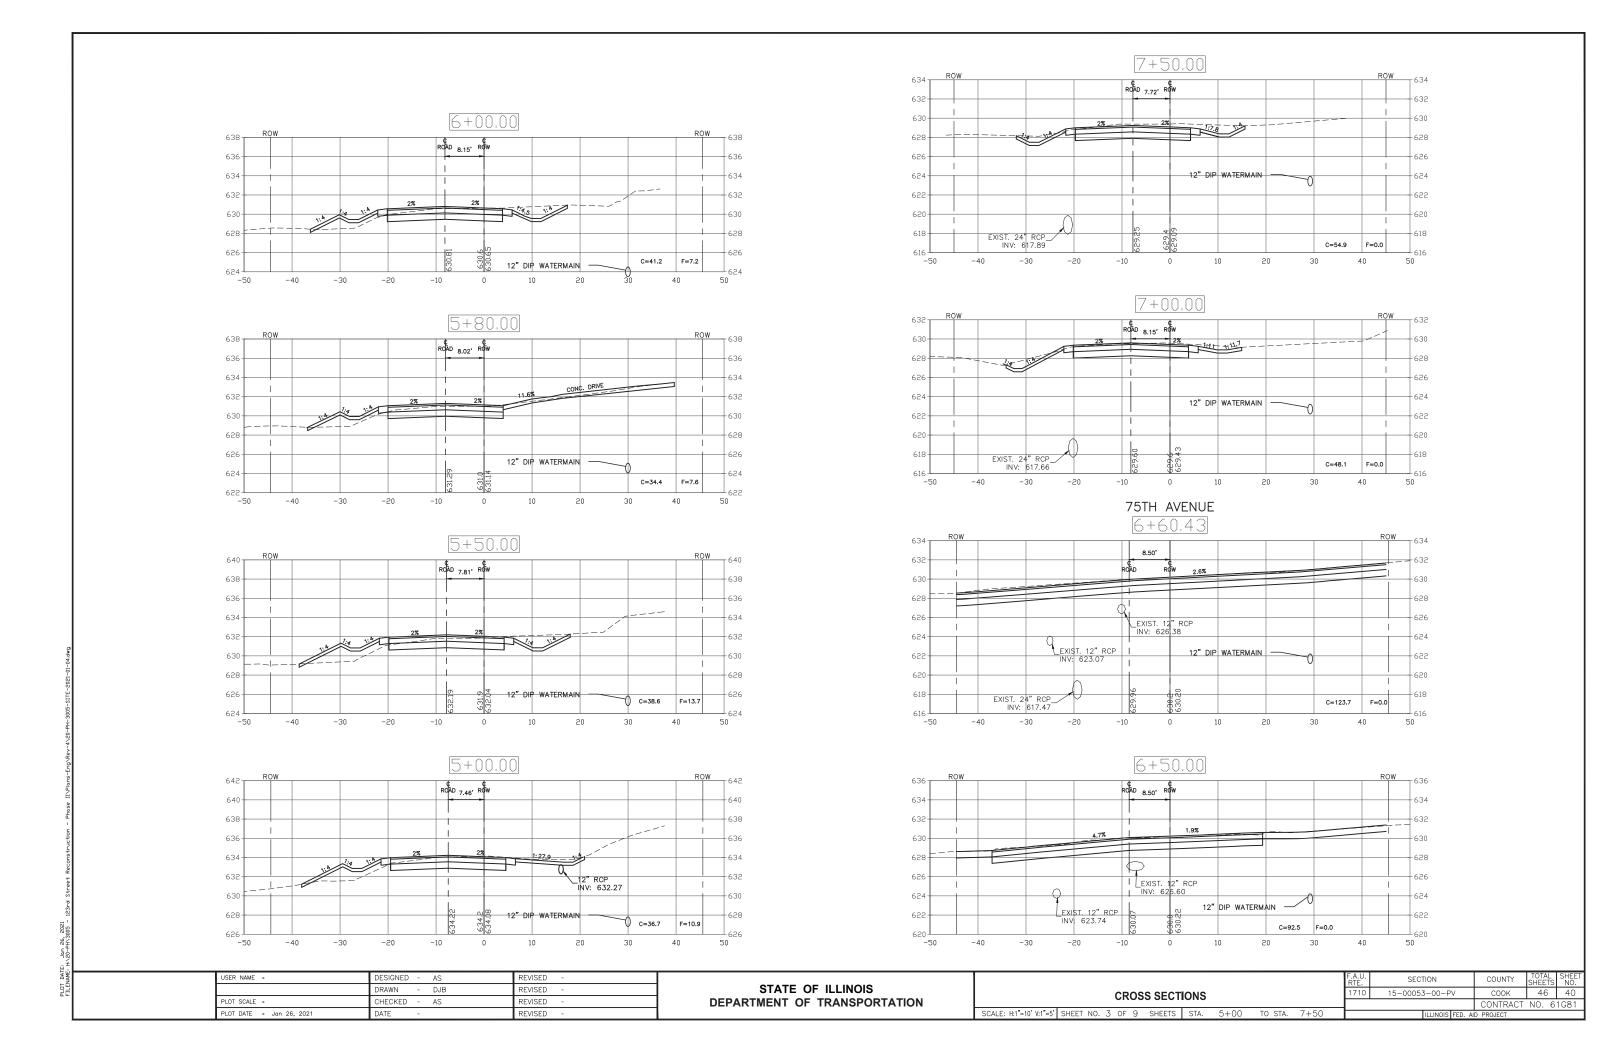

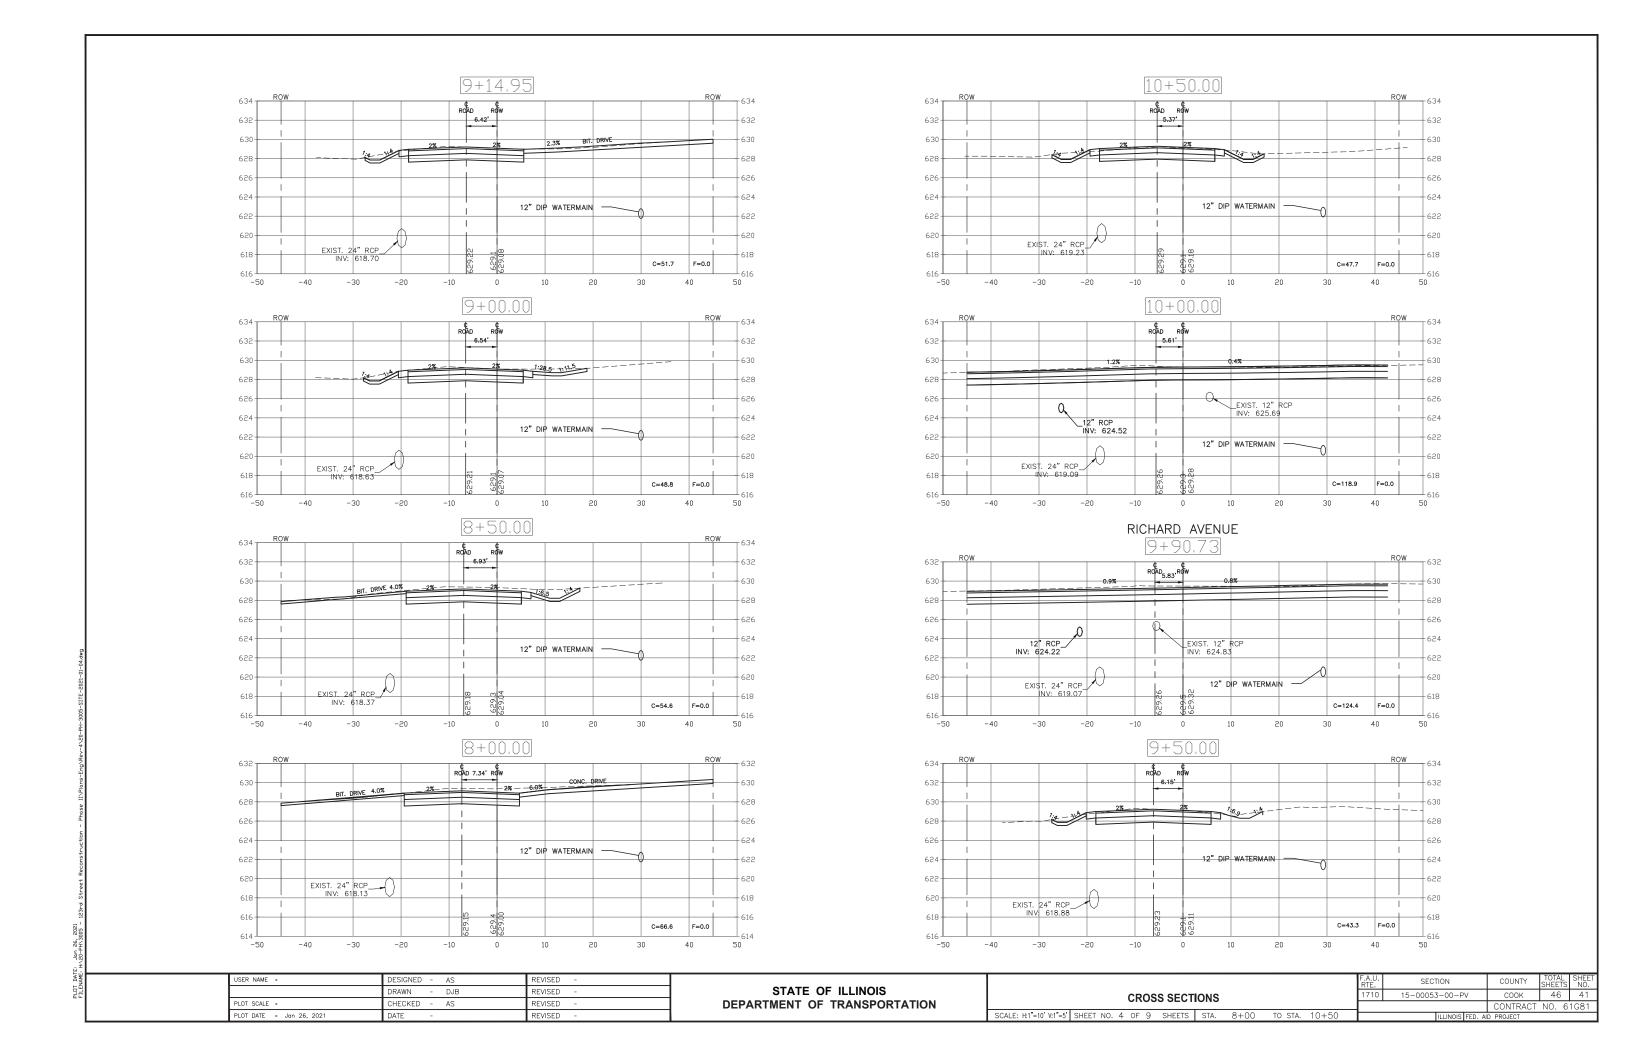

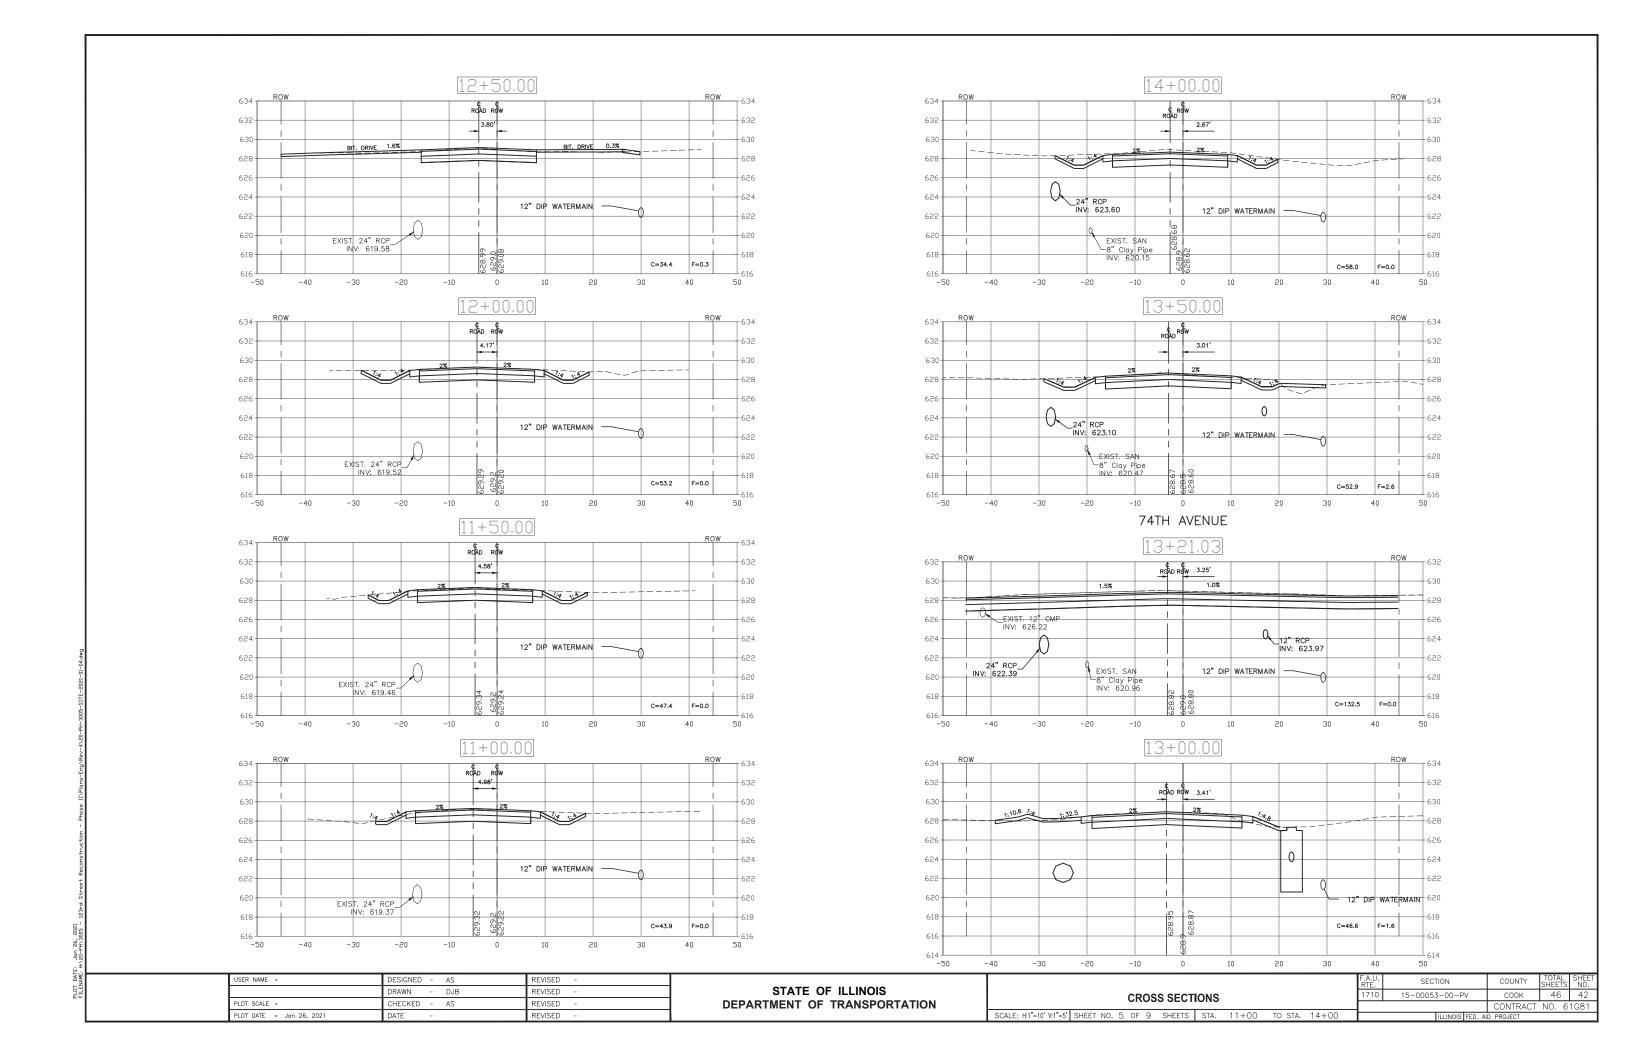

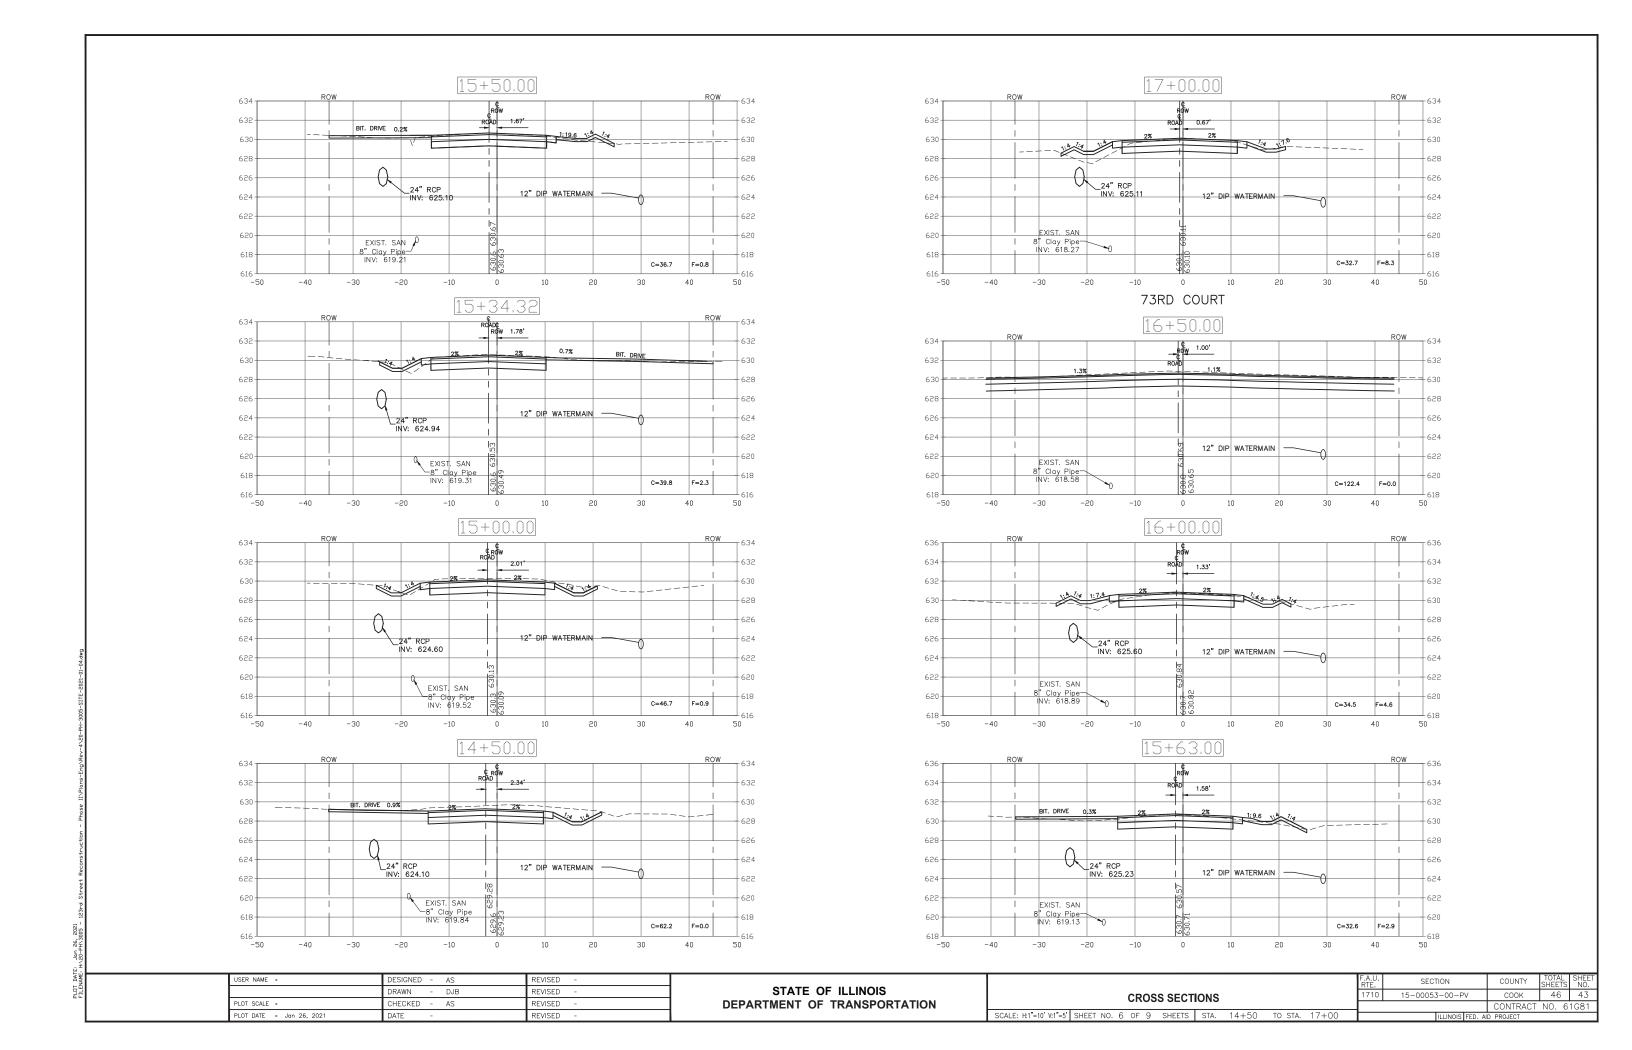

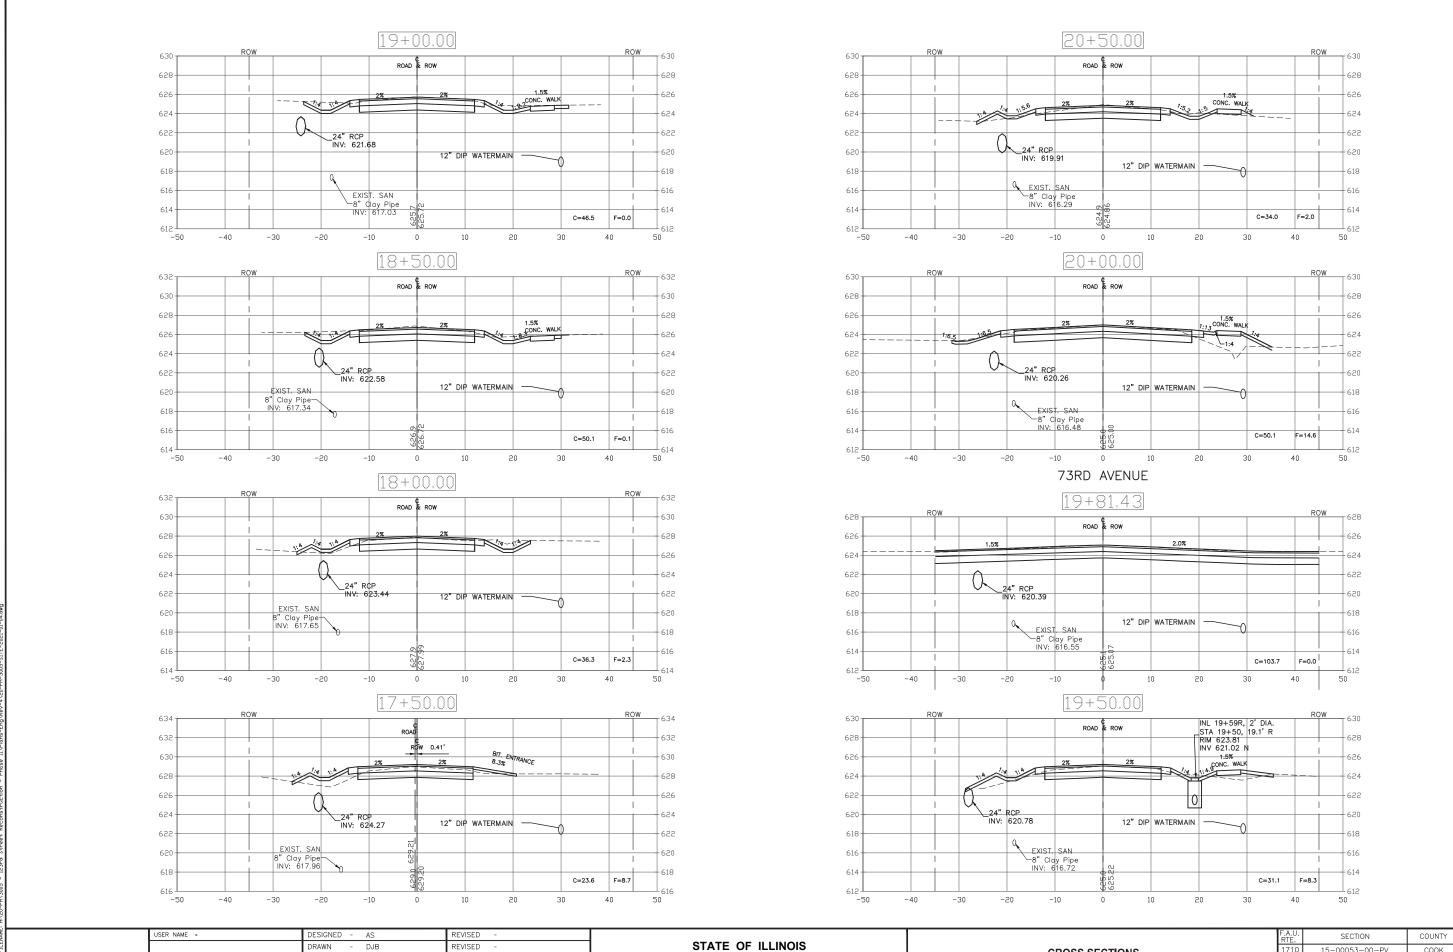

PLDT DATE: Jan 26, 2021

PLOT SCALE =


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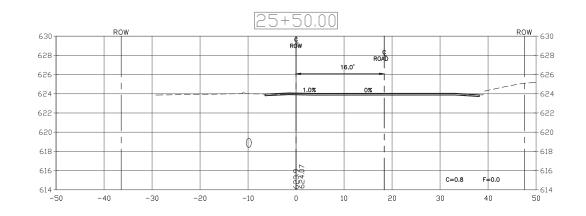
 DRAWN
 DJB
 REVISED


 CHECKED
 AS
 REVISED


 DATE
 REVISED


DEPARTMENT OF TRANSPORTATION



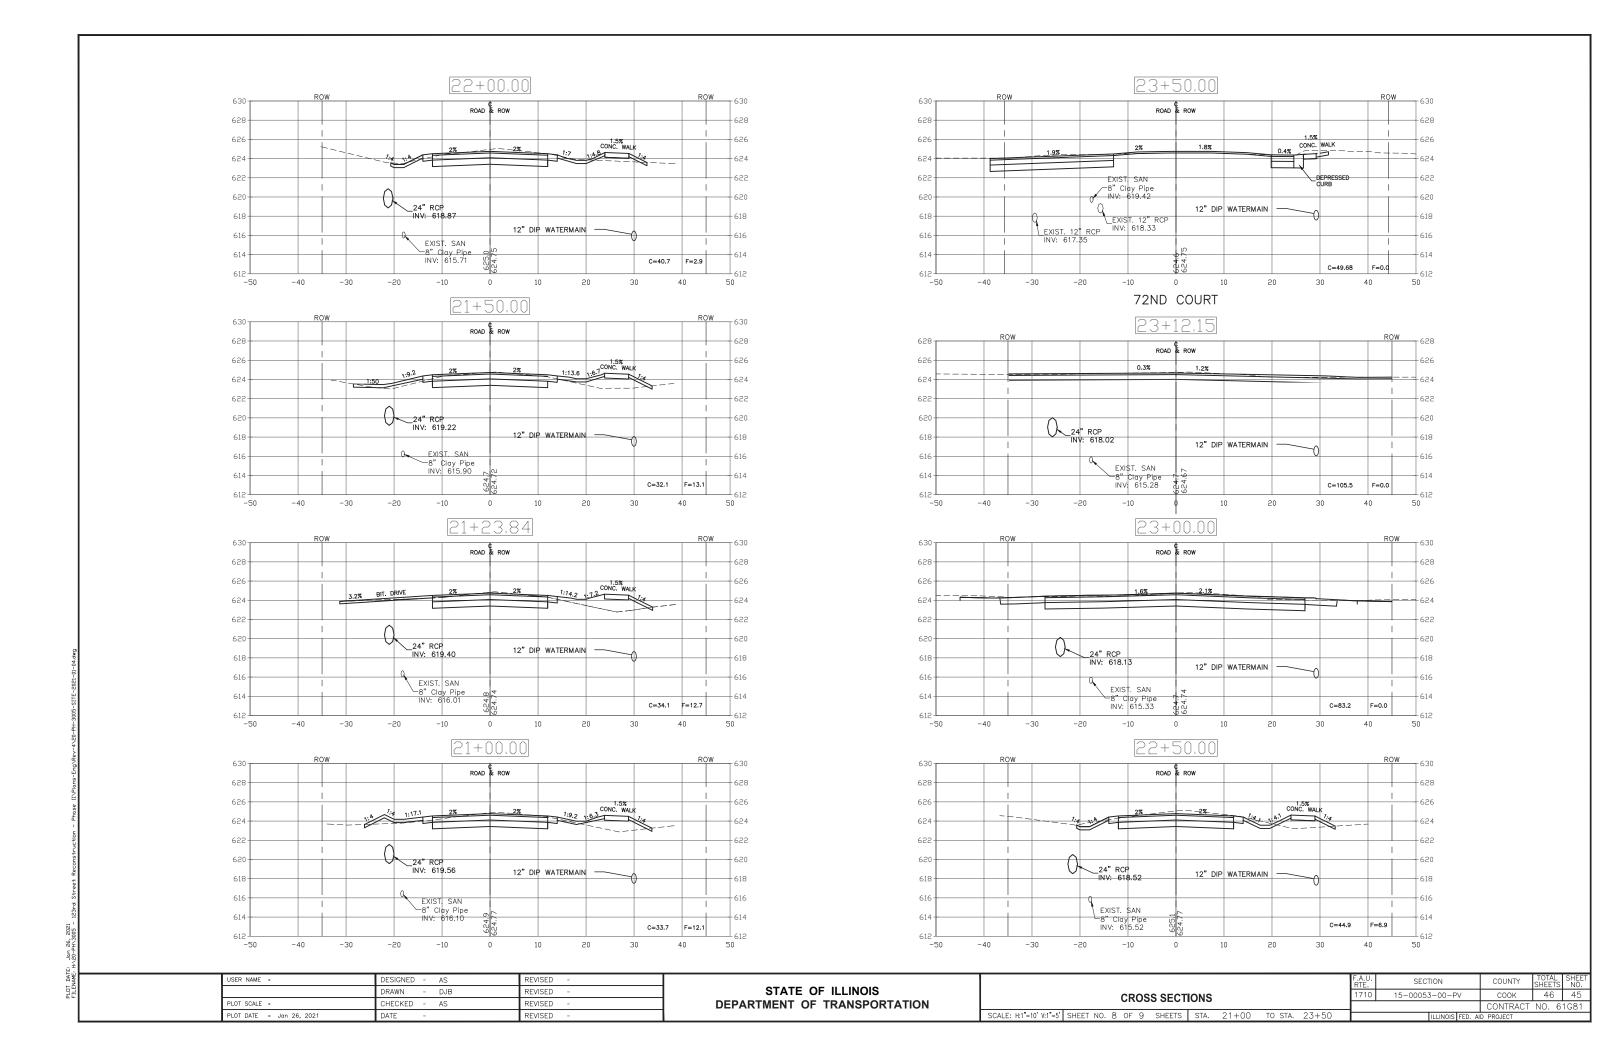

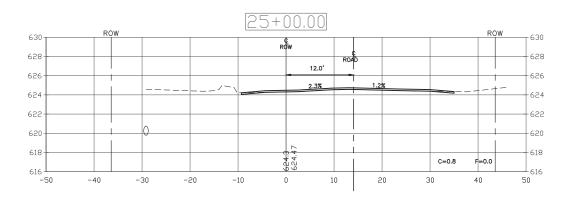

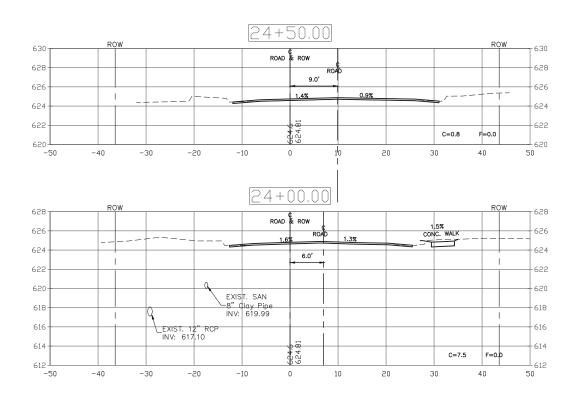

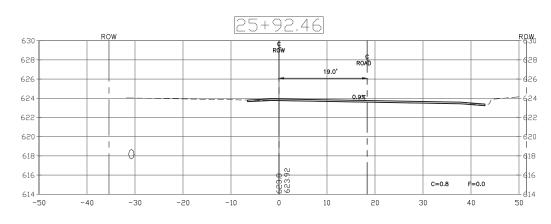

USER NAME =	DESIGNED -	AS	REVISED -
	DRAWN -	DJB	REVISED -
PLOT SCALE =	CHECKED -	AS	REVISED -
PLOT DATE = Jan 26, 2021	DATE -		REVISED -

Ī		F.A.U. RTE.	SECTION	COUNTY TOTAL SHEETS		
ı	CROSS SECTIONS	1710	15-00053-00-PV	COOK	46	46
L				CONTRACT	NO. 6	1G81
ı	SCALE: H:1"=10' V:1"=5' SHEET NO. 9 OF 9 SHEETS STA. 24+00 TO STA. 25+92.46	ILLINOIS FED. AID PROJECT				