
INDEX OF SHEETS 03-05-2021 LETTING ITEM 122

SEE SHEET #2

SEE SHEET #2

STATE OF ILLINOIS

FAU ROUTE 7807

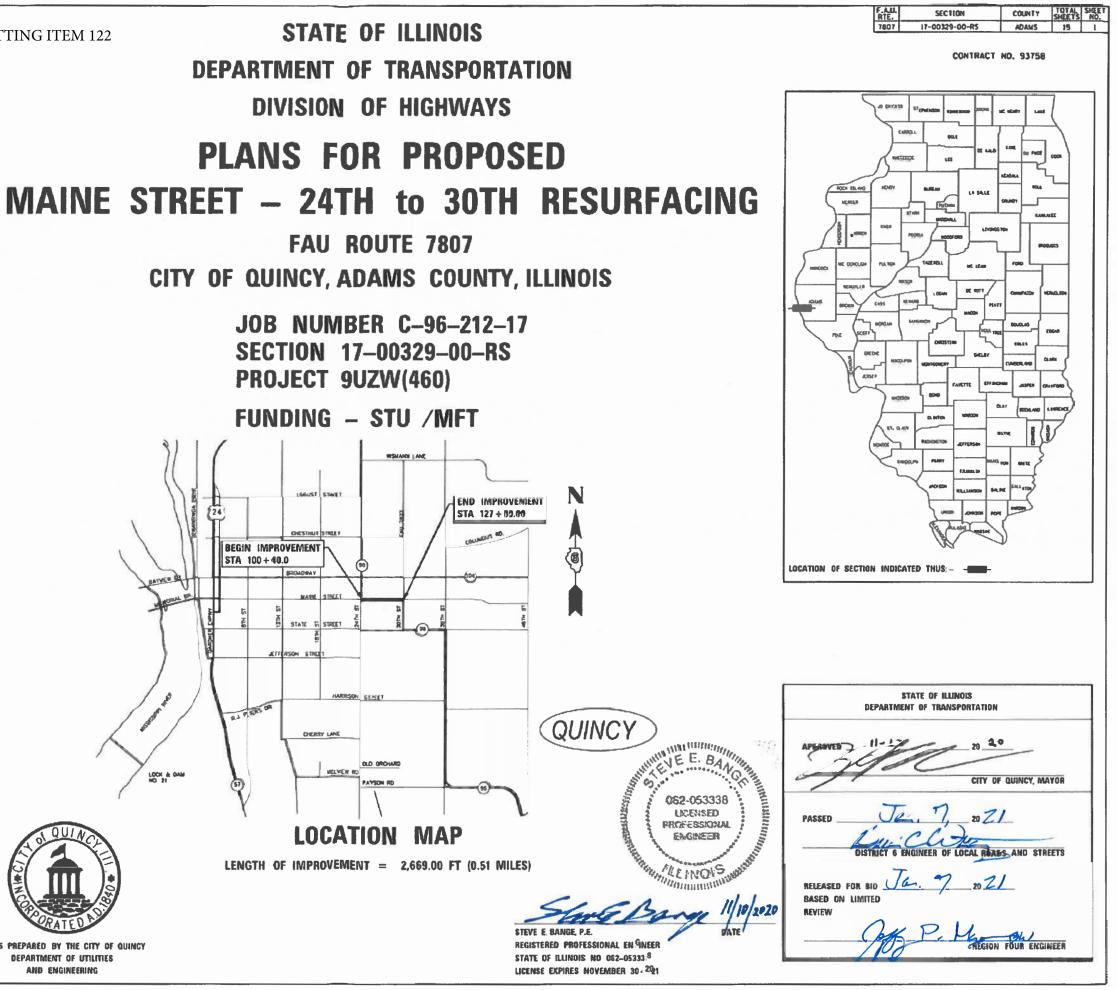


DESIGN DESIGNATIONS

HIGHWAY STANDARDS

FAU 7807 (MAINE STREET): URBAN MINOR ARTERIAL ADT = 5850 (2019); DESIGN SPEED: 30 MPH

PROJECT DESCRIPTION

PROJECT CONSISTS OF MILLING AND OVERLAY, CURB REPAIR, PATCHING, PCC SIDEWALK REPLACEMENT. ADA SIDEWALK RAMPS ALONG WITH OTHER **MISCELLANEOUS APPURTENANCES.**

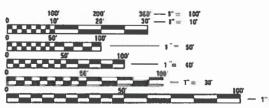

FULL SIZE PLANS HAVE BEEN PREPARED USING STANDARD ENGINEERING SCALES, REDUCED SIZED PLANS WILL NOT CONFORM TO STANDARD SCALES, IN MAKING MEASUREMENTS ON REDUCED PLANS, THE ABOVE SCALES MAY BE USED.

J.U.LI.E. JOINT UTILITY LOCATION INFORMATION FOR EXCAVATION 1-800-892-0123 OR 811

UTILITIES

AT&T (TELEPHONE)	1-309-757-5762
AMEREN IL (ELECTRIC & GAS)	1-888-659-4540
COMCAST (CABLE)	1-800-934-6489
CITY OF QUINCY (SEWER & SIGNALS)	1-217-228-4527
ADAMS (FIBER)	1-217-214-3423

CONTRACT NO. 93758

PLANS PREPARED BY THE CITY OF QUINCY DEPARTMENT OF UTILITIES AND ENGINEERING

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INDEX OF SHEETS

- COVER SHEET 1
- INDEX OF SHEETS, HIGHWAY STANDARDS, AND GENERAL NOTES 2
- 3-4 SUMMARY OF QUANTITIES
- TYPICAL SECTIONS 5
- SCHEDULE OF QUANTITIES 6
- 7-9 MAINE STREET PLAN & PROFILE
- 10-12 MAINE STREET PAVEMENT MARKING PLAN
- DETECTOR LOOP REPLACEMENT / REPAIR 13
- 14 MISCELLANEOUS DETAILS - ENTRANCES
- 15 MISCELLANEOUS DETAILS - TRAFFIC CONTROL & PROTECTION

HIGHWAY STANDARDS

- STANDARD SYMBOLS, ABBREVIATIONS AND PATTERNS 000001-08
- 424001-11 PERPENDICULAR CURB RAMPS FOR SIDEWALKS
- CLASS C AND D PATCHES 442201-03
- 606001-07 CONCRETE CURB TYPE B AND COMBINATION CONCRETE CURB AND GUTTER
- OFF-ROAD OPERATIONS, 2L, 2W, MORE THAN 15"(4.5 M) AWAY 701001-02
- 701006-05 OFF-ROAD OPERATIONS, 2L, 2W, 15"(4.5 M) TO 24""(600 MM) FROM PAVEMENT EDGE
- 701011-04 OFF-ROAD MOVING OPERATIONS, 2L, 2W, DAY ONLY
- 701301-04 LANE CLOSURE, 2L, 2W, SHORT TIME OPERATIONS
- 701311**-**03 LANE CLOSURE, 2L, 2W, MOVING OPERATIONS - DAY ONLY
- URBAN LANE CLOSURE, MULTILANE INTERSECTION 701701-10
- 701801-06 SIDEWALK, CORNER OR CROSSWALK CLOSURE
- TRAFFIC CONTROL DEVICES 701901-08
- 886001-01 DETECTOR LOOP INSTALLATIONS
- TYPICAL LAYOUT FOR DETECTION LOOPS 886006-01

GENERAL NOTES

- THE NOMINAL THICKNESS FOR BASE AND SURFACE ARE SHOWN ON THE TYPICAL SECTIONS, STANDARDS, SCHEDULES, OR SPECIAL DETAILS. THE CONSTRUCTED THICKNESS OF THE ABOVE ITEMS SHALL NOT BE LESS THAN 90 PERCENT OF THE NOMINAL THICKNESS AT ANY LOCATION.
- 2. THE CONTRACTOR SHALL PROTECT AND CAREFULLY PRESERVE ALL PROPERTY MARKERS AND MONUMENTS UNTIL THE OWNER, AUTHORIZED AGENT, OR LAND SURVEYOR HAS WITNESSED OR OTHERWISE REFERENCED THEIR LOCATION. WHERE SECTION OR SUB-SECTION MONUMENTS ARE ENCOUNTERED, THE ENGINEER SHALL BE NOTIFIED BEFORE SUCH MONUMENTS ARE REMOVED. THE CONTRACTOR SHALL BE RESPONSIBLE FOR HAVING AN AUTHORIZED SURVEYOR RE-ESTABLISH ANY SECTION OR SUB-SECTION MONUMENTS DESTROYED BY HIS OPERATIONS.
- 3. THE CONTRACTOR SHALL BE RESPONSIBLE FOR PROTECTING UTILITY PROPERTY FROM CONSTRUCTION OPERATIONS AS OUTLINED IN ARTICLE 107.39 OF THE STANDARD SPECIFICATIONS. THE J.U.L.I.E. NUMBER IS 1-800-892-0123. A MINIMUM OF 48 HOURS ADVANCE NOTICE IS REQUIRED.
- 4. THE LOCATION OF BURIED AND ABOVE GROUND UTILITIES SHOWN ARE APPROXIMATE AND ARE SHOWN FOR THE CONTRACTOR INFORMATIONAL USE ONLY. LOCATIONS ARE NOT TO BE REFERENCED FOR CONSTRUCTION PURPOSES. THE IMPLIED PRESENCE OR ABSENCE OF UTILITIES IS NOT TO BE CONSTRUED BY THE THE OWNER, ENGINEER, CONTRACTOR, OR SUBCONTRACTORS TO BE AN ACCURATE AND COMPLETE REPRESENTATION OF UTILITIES THAT MAY OR MAY NOT EXIST ON THE CONSTRUCTION SITE. BURIED AND ABOVE GROUND UTILITY LOCATIONS, IDENTIFICATION, AND MARKING ARE THE SOLE RESPONSIBILITY OF THE CONTRACTOR. REROUTING, DISCONNECTION, PROTECTION, ETC. OF ANY UTILITIES MUST BE COORDINATED BETWEEN THE CONTRACTOR, UTILITY COMPANY, AND OWNER, SITE SAFETY, INCLUDING THE AVOIDANCE OF HAZARDS ASSOCIATED WITH BURIED AND ABOVE GROUND UTILITIES, REMAINS THE SOLE RESPONSIBILITY OF THE CONTRACTOR.
- 5. IN ADDITION TO FIELD SURVEYS, PLAN DIMENSIONS AND DETAILS RELATIVE TO THE EXISTING FACILITES HAVE BEEN TAKEN FROM EXISTING PLANS AND ARE SUBJECT TO CONSTRUCTION VARIATIONS. IT SHALL BE THE CONTRACTORS RESPONSIBILITY TO VERIFY SUCH DIMENSIONS AND DETAILS IN THE FIELD. SUCH VARIATIONS SHALL NOT BE A CAUSE FOR ADDITIONAL COMPENSATION DUE TO A CHANGE IN THE SCOPE OF WORK: HOWEVER, THE CONTRACTOR WILL BE PAID FOR THE QUANTITY ACTUALLY FURNISHED AT THE UNIT PRICE BID FOR THE WORK. THE THICKNESS OF BITUMINOUS MIXTURES SHOWN ON THE PLANS IS THE NOMINAL.
- 6. ANY REFERENCE TO A STANDARD IN THESE PLANS SHALL BE INTERPRETED TO MEAN THE EDITION AS INDICATED BY THE SUB-NUMBER IN THE INDEX OF SHEETS OR THE COPY OF THE STANDARD INCLUDED IN THESE PLANS.
- 7. ANY EXISTING ROAD SIGNS THAT INTERFERE WITH CONSTRUCTION WILL BE REMOVED OR RELOCATED AS DIRECTED BY THE ENGINEER. AFTER THE CONSTRUCTION IS COMPLETED, THE CONTRACTOR WILL REPLACE THE SIGNS AS DIRECTED BY THE ENGINEER. THIS WORK WILL BE DONE AT NO ADDITIONAL COST TO THE CITY.
- 8. ALL SAW CUTS, NECESSARY TO COMPLETE THE WORK DETAILED IN THESE PLANS, SHALL BE INCLUDED IN THE COST FOR THE VARIOUS PAY ITEMS INVOLVED.
- SEEDING WILL NOT BE PERMITTED AT ANY TIME WHEN THE GROUND IS FROZEN, WET, OR IN AN UNTILLABLE CONDITION. LOCATIONS TO BE SEEDED SHALL BE DETERMINED BY THE ENGINEER

AGGREGATE (SUR STONE DUMPED R

HOT-MIX ASPHALT BITUMINOUS

> BITUMINOUS SURFACE / F

SEEDING: NITROGEN F PHOSPHORU POTASSIUM AGRICULTUR TEMPORARY

COMMITMENTS

NONE

LOCATION(S)	MAINE STREET	MAINE STREET
	& SIDE STREETS	& SIDE STREETS
MIXTURE USE(S)	SURFACE	BINDER
AC/PG	SPS-PG 64-28	PG 64-22
DESIGN AIR VOIDS	4% N50 DESIGN	4% N50 DESIGN
MIXTURE COMPOSITION		
(MIXTURE GRADATION)	IL 9.5	IL 9.5
FRICTION AGGREGATE	MIX "D"	-
QUALITY MANAGEMENT	QC/QA	QC/QA

OF QUINCY	USER NAME = sbange	DESIGNED -	REVISED -		FAU 7807 (MAINE STREET)			F.A.U. BTE	SECTION	COUNTY	TOTAL SHE	ΞT.			
		DRAWN -	REVISED -			GENERAL NOTES		7807	17-00329-00-RS	ADAMS	15 2	-			
ITIES &	PLOT SCALE = 40.0000 / in.	CHECKED -	REVISED -	CITY OF QUINCY, ILLINOIS	GENERAL NUTES					CONTRACT NO.			-		
NEERING	PLOT DATE = 11/10/2020	DATE -	REVISED -		SCALE: NONE	SHEET 1	OF 1	SHEETS	STA.	TO STA.	ILLINOIS FED. AID PROJECT				_

RATES OF APPLICATION TABLE

RFACE, BASE, SUBBASE, OR BACKFILL) RIPRAP	1.80 TON / CU YD 1.50 TON / CU YD
T:	
S MATERIALS (TACK COAT)	0.05 LB / SQ FT (on Concrete & milled HMA) 0.025 LB / SQ FT (on HMA lifts & brick)
5 MATERIALS (PRIME COAT)	0.25 LB / SQ FT (on aggregate)
BINDER / LEVELING BINDER (112 lbs)	0.056 TON / SQ YD IN
FERTILIZER NUTRIENT	90 LBS / ACRE
JS FERTILIZER NUTRIENT	90 LBS / ACRE
FERTILIZER NUTRIENT	90 LBS / ACRE
RAL GROUND LIMESTONE	2.0 TON / ACRE
' EROSION CONTROL SEEDING	100 LBS / ACRE PER APPLICATION

MIXTURE REQUIREMENTS


					PARTICIPATING		NON-PARTICIPATING			
#	PAY		1 1 6 17-	TOTAL	ROADWAY					
	ITEM #	ITEM	UNIT	QUANTITY	0005					
1	25000100	SEEDING, CLASS 1	ACRE	0.75	0.75					
2	25000400	NITROGEN FERTILIZER NUTRIENT	POUND	70	70					
3	25000500	PHOSPHORUS FERTILIZER NUTRIENT	POUND	70	70					
4	25000600	POTASSIUM FERTILIZER NUTRIENT	POUND	70	70					
5	25100105	MULCH, METHOD 1	ACRE	0.75	0.75					
6	35100300	AGGREGATE BASE COURSE, TYPE A 4"	SQ YD	542	542					
7	40600290	BITUMINOUS MATERIALS (TACK COAT)	POUND	/540	/540					
8	40600982	HOT-MIX ASPHALT SURFACE REMOVAL - BUTT JOINT	SQ YD	275	275					
9	40602978	HOT-MIX ASPHALT BINDER COURSE, IL- 9.5, N50	TON	937	937					
10	40604160	POLYMERIZED HOT-MIX ASPHALT SURFACE COURSE, IL-9.5, MIX "D", N50	TON	937	937					
11	42300200	PORTLAND CEMENT CONCRETE DRIVEWAY PAVEMENT, 6 INCH	SQ YD	365	365					
12	42300400	PORTLAND CEMENT CONCRETE DRIVEWAY PAVEMENT, 8 INCH	SQ YD	177	177					
13	42400100	PORTLAND CEMENT CONCRETE SIDEWALK 4 INCH	SQ FT	11206	11206					
14	42400300 PORTLAND CEMENT CONCRETE SIDEWALK 6 INCH		SQ FT	919	919					
15	42400800	DETECTABLE WARNINGS	SQ FT	60	60	******************				
16	44000161	HOT-MIX ASPHALT SURFACE REMOVAL, 3"	SQ YD	10896	10896					
17	44000200	DRIVEWAY PAVEMENT REMOVAL	SQ YD	. 501	501					
18	44000500	COMBINATION CURB AND GUTTER REMOVAL	FOOT	158	158					
19	44000600	SIDEWALK REMOVAL	SQ FT	12554	12554					
20	44200094	PAVEMENT PATCHING, TYPE II, 8 INCH	SQ YD	6	6					
21	44200099	PAVEMENT PATCHING, TYPE III, 8 INCH	SQ YD	207	207					
22	60255800	MANHOLES TO BE ADJUSTED WITH NEW TYPE 1 FRAME, CLOSED LID	EACH	13	13					
23	60266600	VALVE BOXES TO BE ADJUSTED	EACH	17	17					
24	60603800	COMBINATION CONCRETE CURB AND GUTTER, TYPE B-6.12	FOOT	158	158					
25	67100100	MOBILIZATION	L SUM	1	1					
26	78000100	THERMOPLASTIC PAVEMENT MARKING - LETTERS AND SYMBOLS	SQ FT	62.4	62.4					
27	78000300	THERMOPLASTIC PAVEMENT MARKING - LINE 5"	FOOT	2790	2790					
28	78000400	THERMOPLASTIC PAVEMENT MARKING - LINE 6"	FOOT	1100	1100					
29	78000600			202	202					
30	78000650			133	133					
• - SP	ECIAL PROVISION				I	·····	I	<u></u>	I	
	OF QUINCY	R NAME = sbange DESIGNED - REVISED - DRAWN - REVISED -				·	MAINE STREET		F.A.U. RTE.	SECTION COUNTY TOTA

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									PARTICIF	ATING	NON-PART	TICIPATING
		PAY						TOTAL	ROADWAY			
	#	ITEM #		IT	EM	U	NIT	QUANTITY	0005			
Δ	31	88600100	DETECTOR LOOP, TYPE	Ι		FC	тос	674	674			
*	32	X7010216	TRAFFIC CONTROL AND	PROTECTION, (SPECIAL)		L S	SUM	1	1			
*	33	Z0012500	CONCRETE CURB REPAI	IR		FC	тос	1999	1999			
*	34	Z0013798	CONSTRUCTION LAYOU	Г		LS	SUM	1	1			
*	35	Z0033700	LONGITUDINAL JOINT SI	EALANT		FC	тос	2669	2669			
#	36	20076600	TRAINEES			Н	ouR	500	500			
#	37	z0076604	TRAINEES TRAININ	G PROGRAM GRADUA:	TE	He	bur	500	500			
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E Sel S	CITY	OL ADINCI	ER NAME = sbange	DESIGNED - DRAWN -	REVISED - REVISED -	-					MAIN	NF STRFF
		EFFOINC -	OT SCALE = 40.0000 ' / in.	CHECKED -	REVISED -	C	ITY O	F QUINCY, ILL	INOIS		SUMMARY	OF QUA
No.	ENGIN	EERING PU	OT DATE = 11/10/2020	DATE -	REVISED -	<u> </u>				SCALE:	SHEET 2 OF 2	SHEETS S

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		F.A.U.		TOTAL SHEET
T NTITIES		F.A.U. SECTIO RTE. 7807 17-00329-0	00-RS ADAMS	TOTAL SHEET SHEETS NO. 15 4
STA.	TO STA.	11.	CONTRACT	NO. 93758



CITY OF QUINCY	USER NAME = sbange	DESIGNED -	REVISED -			FAU	7807 ((MAINE
FI		DRAWN -	REVISED -	CITY OF QUINCY, ILLINOIS			• • • • •	•••••
UTILITIES &	PLOT SCALE = 40.0000 / in.	CHECKED -	REVISED -		TYPICAL SECT			
Sengineering	PLOT DATE = 11/10/2020	DATE -	REVISED -		SCALE: None	SHEET 1	OF 1	SHEETS

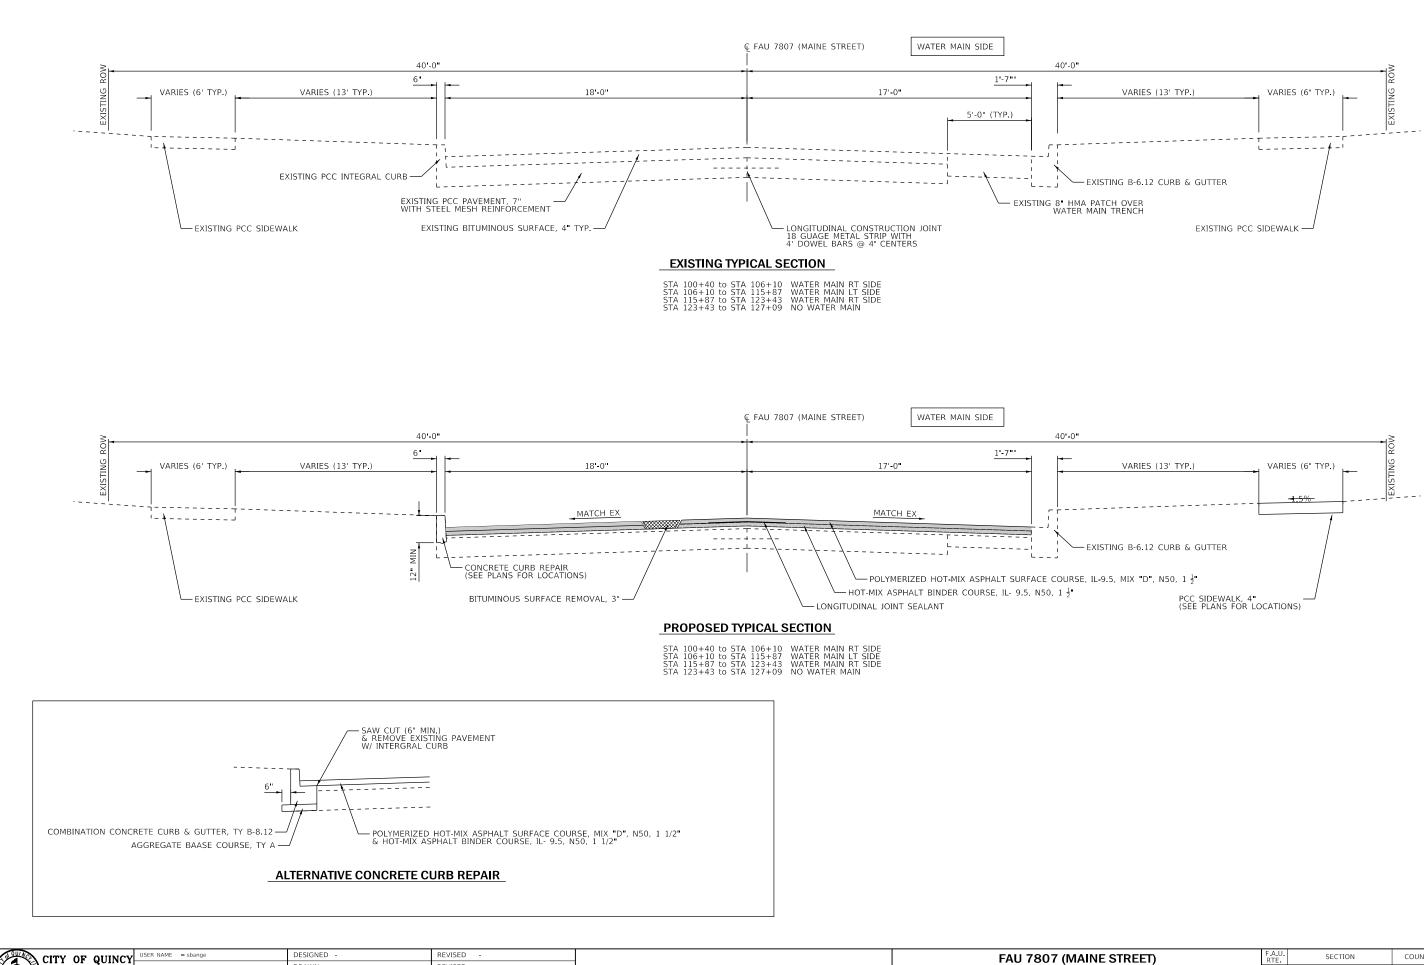NE STREET)				SECTION			COUNTY	TOTAL SHEETS	SHEET NO.
сτ	CTIONS			7807 17-00329-00-RS			ADAMS	15	5
							CONTRACT	NO. 93	3758
TS	STA	TO STA.			ILLINOIS	FED, AI	ID PROJECT		

		SEEDING	G SCHEDU	LE		
LOCATION		SEEDING, CLASS 1	NITROGEN FERTILIZER NUTRIENT	PHOSPHORUS FERTILIZER NUTRIENT	POTASSIUM FERTILIZER NUTRIENT	MULCH, METHOD 1
		(ACRE)	(LB)	(LB)	(LB)	(ACRE)
100+40 0 to 105+50 0	LT	0.08	7.2	7.2	7.2	0.08
100+40.010105+50.0	RT	0.08	7.2	7.2	7.2	0.08
105+50.0 to 111+50.0	LT	0.09	8.1	8.1	8.1	0.09
105+50.0 to 111+50.0	RT	0.09	8.1	8.1	8.1	0.09
444.50 01- 447.50 0	LT	0.09	8.1	8.1	8.1	0.09
111+50.0 to 117+50.0	RT	0.09	8.1	8.1	8.1	0.09
117.50 0t- 100.50 0	LT	0.07	6.3	6.3	6.3	0.07
117+50.0 to 122+50.0	RT	0.07	6.3	6.3	6.3	0.07
400.50.01.407.00.0	LT	0.07	6.3	6.3	6.3	0.07
122+50.0 to 127+09.0	RT	0.07	6.3	6.3	6.3	0.07
OTALS		0.75	70	70	70	0.8

		PAV	EMENT SC	HEDULE			
LOCATION		HOT-MIX ASPHALT SURFACE REMOVAL - BUTT JOINT	HOT-MIX ASPHALT SURFACE REMOVAL, 3"	HMA BINDER COURSE, IL- 9.5, N50	POLY HMA SURFACE COURSE, IL- 9.5, MIX "D", N50	BITUMINOUS MATERIALS (TACK COAT)	LONG JOINT SEALANT
	(SQ YD)	(SQ YD)	(TON)	(TON)	(POUND)	(FT)	
100+40 0 to 105+50 0	LT	21.3	999.7	86	86	690	510
100+40.0 10 105+50.0	RT	25.6	960.8	83	83	665	510
105+50.0 to 111+50.0	LT	29.7	1218.6	105	105	845	600
105+50.0 to 111+50.0	RT	-	1192.3	100	100	805	800
111+50.0 to 117+50.0	LT	60.7	1325.0	116	116	935	600
111+50.0 to 117+50.0	RT	-	1170.2	98	98	790	600
447.50.04-400.50.0	LT	37.7	1067.3	93	93	745	500
117+50.0 to 122+50.0	RT	-	944.4	79	79	635	500
400,50,04-407,00,0	LT	22.6	898.2	77	77	620	450
122+50.0 to 127+09.0	RT	77.3	1119.1	100	100	810	459
TOTALS		275	10896	937	937	7540	2669

LOCATION	

		THERM	OPLASTIC PAVE	MENT MARKIN	G - LINE	
LOCATION	5"	6"	12"		24"	LETTERS &
LOCATION	YELLOW	WHITE (FT)	YELLOW	WHITE	WHITE (FT)	SYMBOLS
	(FT)		(FT)	(FT)		(FT)
100+45.0 to 101+61.0	230	115			25	31.2
101+61.0 to 103+91.0	920		59			
103+91.0 to 123+55.0	490					
N. 26th INTERSECTION		126		84	12	
PARK PLAZA INTERSECTION		47			11	
N. 27th INTERSECTION		70			17	
N. 28th INTERSECTION		70			17	
EMERY DRIVE INTERSECTION		45			12	
WOODLAWN ROAD INTERSECTION		512			14	
123+55.0 to 125+85.0	920		59			
125+85.0 to 127+06.0	230	115			25	31.2
TOTALS	2790	1100	118	84	133	62.4

	LOCATIO	N	PCC SIDEWALK 4 INCH	PCC SIDEWALK 6 INCH	DETECTABLE WARNINGS	SIDEWALK REMOVAL
			(SQ FT)	(SQ FT)	(SQ FT)	(SQ FT)
00+48.0	to 101+6	4.0 LT	696			776
02+11.0	to 102+8	1.0 LT	420			420
06+44.0	to 107+1	5.2 LT	427.2			427
06+50.0	to 107+1	4.4 RT		94		94
07+27.2	to 107+8	4.4 LT	343.2			343
07+39.0	to 108+2	9.0 RT		540		540
07+96.4	to 108+2	8.9 LT	195			195
108+40.9	to 108+7	3.0 LT	193			193
08+82.6	to 109+1	9.0 RT		75		75
08+85.0	to 109+1	9.9 LT	209			209
09+29.9	to 109+6	9.6 LT	238			238
09+83.0	to 110+9	3.0 RT	660			660
09+87.6	to 110+5	9.3 LT	430			430
10+76.8	to 111+6	4.0 LT	523			523
12+15.0	to 113+1	0.0 LT	570			570
13+22.0	to 113+7	'1.3 LT	296			296
13+83.3	to 115+3	6.0 LT	916			916
14+24.0	to 114+5	9.0 RT		210		210
16+39.0	to 118+2	9.2 LT	1210		12	1355
17+56.3	to 118+0	1.3 RT	270			270
18+66.3	to 118+9	9.0 LT	230		12	388
20+20.7	to 120+6	8.0 RT	284			284
20+80.0	to 121+2	8.2 RT	289			289
21+49.2	to 121+9	2.4 RT	259			259
22+03.4	to 122+5	4.2 RT	305			305
22+66.2	to 123+2	0.0 RT	323			323
22+82.0	to 123+1	2.0 LT	234			234
23+38.0	to 123+6	4.0 LT	156			156
23+57.0	to 124+0	7.3 RT	308		12	306
24+19.3	to 125+6	9.3 RT	787		12	837
25+05.0	to 125+1	1.1 LT	37			37
25+24.1	to 125+5	7.0 LT	197			197
25+91.2	to 125+9	7.2 LT	36			36
26+01.0	to 126+2	3.0 RT	134		12	132
26+15.2	to 126+2	0.2 LT	30			30
DTALS			11206	919	60	12554

		CURB	AND G	UTTER SC	HEDULE	
	LO	CATION		COMB CONC CURB & GUTTER, TY B-6.12	COMB CURB AND GUTTER REMOVAL	CONCRETE CURB REPAIR
				(FT)	(FT)	(FT)
100+54.5	to	101+24.0	LT			69.5
101+43.0	to	101+70.0	LT			27
102+07.0	to	102+76.0	LT			69
103+06.0	to	105+76.0	LT			270
106+07.0	to	106+76.0	RT			69
107+10.0	to	108+88.0	RT			178
109+21.0	to	109+42.0	RT			21
112+25.0	to	115+27.0	RT			302
116+24.8	to	118+13.6	LT			189
118+79.6	to	119+62.5	LT			83
119+77.2	to	120+85.1	LT			108
121+03.3	to	121+31.4	LT			28
121+50.2	to	122+55.2	LT			105
122+72.1	to	123+09.0	LT			37
123+27.1	to	123+82.5	LT			55
123+75.1	to	125+47.3	RT			172
124+04.9	to	124+44.9	LT			40
124+67.5	to	125+06.1	LT			39
125+29.1	to	125+34.1	LT			5
125+45.0	to	125+92.2	LT			47
126+20.2	to	127+05.9	LT			86
NW CO	ORNE	R - 28TH &	MAINE	35	35	
NE CC	RNE	R - 28TH & I	MAINE	33	33	
SE CORN	IER -	EMERY DR	& MAINE	36	36	
SW CORN	ER - '	WOODLAW	N & MAINE	36	36	
SE CORN	ER - ۱	NOODLAW	N & MAINE	18	18	
TOTALS				158	158	1999

	UTILIT	Y ADJUST	MENT SCH	EDULE
	LOC	ATION	MH TO BE ADJ W/ NEW TY 1 FR, CLSD LID	VALVE BOXES TO BE ADJUSTED
			(EACH)	(EACH)
	101+21.2	4.8' LT	1	
	101+27.0	14.1' LT		1
	102+51.0	8.5' LT	1	
	103+79.5	8.9' LT	1	
	105+62.1	14.4' RT		1
	106+03.5	13.0' LT		1
	106+07.2	32.6' LT		1
	106+08.7	40.5' LT		1
	106+16.7	0.2' LT	1	
	108+43.7	0.2' LT	1	
	108+57.0	8.2' LT		1
	110+79.1	7.5' LT		1
	111+01.5	0.2' LT	1	
	111+82.2	14.9' LT		1
	111+96.2	33.9' LT		1
	112+30.4	4.9' LT	1	
	115+55.5	14.6' RT		1
	115+79.2	41.5' LT		1
	115+89.1	5.3' LT	1	
	115+95.1	13.0' LT		1
	115+96.9	12.7' RT		1
	116+23.9	16.1' RT		1
	118+52.7	5.6' LT	1	
	122+52.5	5.6' LT	1	
	123+22.9	14.5' RT		1
	123+24.1	13.1' LT		1
	125+03.2	15.7' LT		1
	126+00.7	5.8' LT	1	
	126+18.3	4.9' LT	1	
	126+90.0	6.0' LT	1	
	TOTALS		13	17
_				


		ENTRAN	ICE SCHEE	DULE	
LOCA		PCC DRIVEWA	AY PAVEMENT	AGGREGATE BASE COURSE,	DRIVEWAY PAVEMENT
		6"	8"	TYPE A 4"	REMOVAL
		(SQ YD)	(SQ YD)	(SQ YD)	(SQ YD)
102+91.0	LT		51.2	51.2	48.2
107+90.4	LT	24.8		24.8	24.8
108+79.0	LT	21.5		21.5	21.2
108+99.2	RT		63.3	63.3	62.5
109+24.9	LT	18.8		18.8	18.8
109+78.6	LT	33.1		33.1	33.1
113+16.0 LT		8.0		8.0	8.0
113+77.3 LT		23.0		23.0	23.0
118+09.3 RT		8.0		8.0	8.0
120+14.7	RT	8.0		8.0	8.0
120+74.0	RT	8.0		8.0	8.0
122+60.2	RT	8.0		8.0	8.0
123+98.5	LT	24.4		24.4	19.4
124+13.3	RT	29.8		29.8	21.8
124+51.3	LT	24.4		24.4	19.4
125+17.6	LT	33.7		33.7	27.6
126+06.2	LT	45.2		45.2	41.0
106+93.4	RT		62.8	62.8	54.2
107+21.2	LT	24.2		24.2	24.2
108+34.9	LT	21.8		21.8	21.5
TOTALS		365	177	542	501
F	РАТСНІ	NG SCHED]		
LOCA	TION		PATCHING, 8"]	
		TYII	TY III	1	
		(SQ YD)	(SQ YD)	J	


TOTALS	
124+81	L
124+47	ι
123+05	ι
120+25	L
117+63	L
117+28	L
116+22	L
115+00	L
112+89	L
109+06	L
100+60	l

S ENCINEERING	USER NAME = sbange	DESIGNED -	REVISED -					
	PLOT SCALE = 40.0000 ' / in.	DRAWN - CHECKED -	REVISED - REVISED -	CITY OF QUINCY, ILLINOIS	SCHEDULE OF QUA			
	PLOT DATE = 11/10/2020	DATE -	REVISED -		SCALE:	SHEET 1 OF 1 SHEETS		

АТСНІ	NG SCHED	ULE
	PAVEMENT F	PATCHING, 8"
ION	TY II	TY III
	(SQ YD)	(SQ YD)
.T	5.6	
T & RT		20.0
T & RT		20.0
T & RT		20.0
T & RT		18.7
T & RT		20.0
T & RT		24.0
T & RT		24.0
	6	207

			F.A.U. RTE	U. SECTION			COUNTY	TOTAL SHEETS	SHEET NO.
Įυ	ANTITIES		7807	7807 17-00329-00-RS		ADAMS	15	6	
						CONTRACT NO. 9375			3758
TS	STA.	TO STA.			ILLINOIS	FED. A	ID PROJECT		

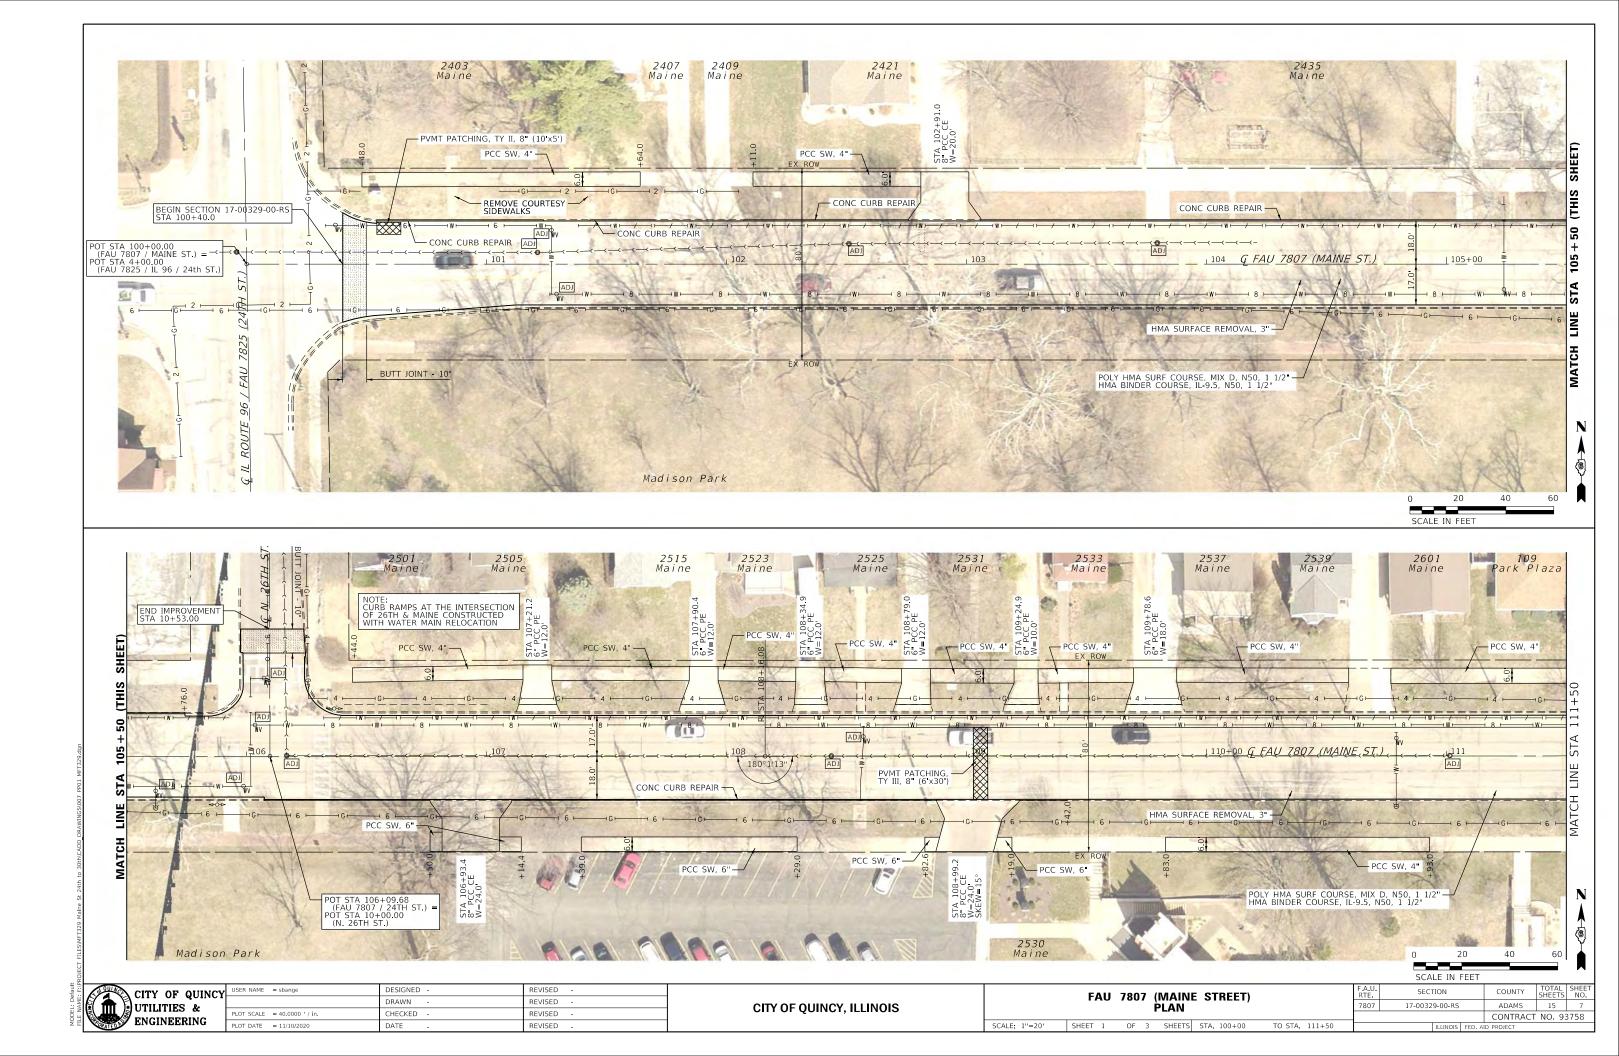

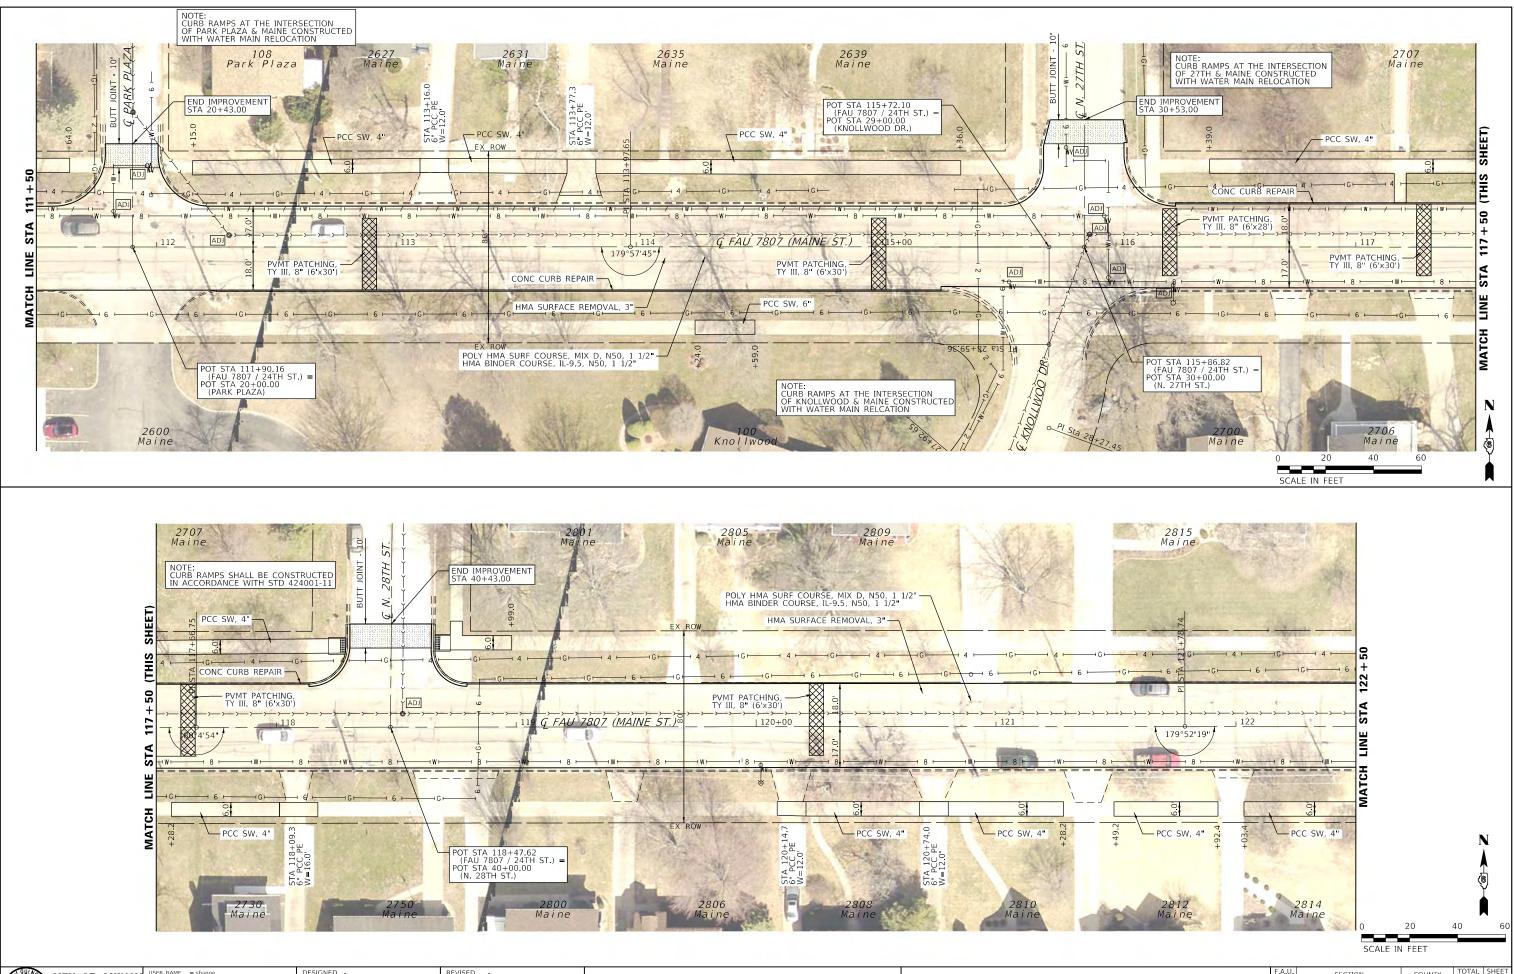


A A A A A A A A A A A A A A A A A A A	CITY OF QUINCY	TY OF QUINCY USER NAME = sbange DESIGNED -	DESIGNED -	REVISED -		FAU 7807 (MAINE STREET) PLAN			F.A.U. BTE	SECTION	COUNTY	TOTAL	HEET NO.
	UTILITIES &		DRAWN -	REVISED -	CITY OF QUINCY, ILLINOIS				7807	17-00329-00-RS	ADAMS	15	8
	E DIGINE CONTRACTOR	PLOT SCALE = 40.0000 / in.	CHECKED -	REVISED -							CONTRAC	T NO. 93	758
RATED		PLOT DATE = 11/10/2020	DATE -	REVISED -		SCALE: 1 =20	SHEET 2 OF 3 SHEETS STA. 111+50	TO STA. 122+50		ILLINOIS FED. A	ID PROJECT		




CITY OF QUINCY	USER NAME = sbange	DESIGNED -	REVISED -		FAU 7807 (MAINE STREET	T)	F.A.U. RTE	SECTION	COUNTY TOTAL SHEETS	L SHEET	
			REVISED -	CITY OF QUINCY, ILLINOIS	PLAN			7807	17-00329-00-RS	ADAMS 15	9
	PLOT SCALE = 40.0000 / in.	CHECKED -	REVISED -				_		CONTRACT NO. 93	93758	
	PLOT DATE = 11/10/2020	DATE -	REVISED -		SCALE: 1"=20'	50 TO STA. 127+50		ILLINOIS FED. A	FED. AID PROJECT		

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0 20 SCALE IN FEET




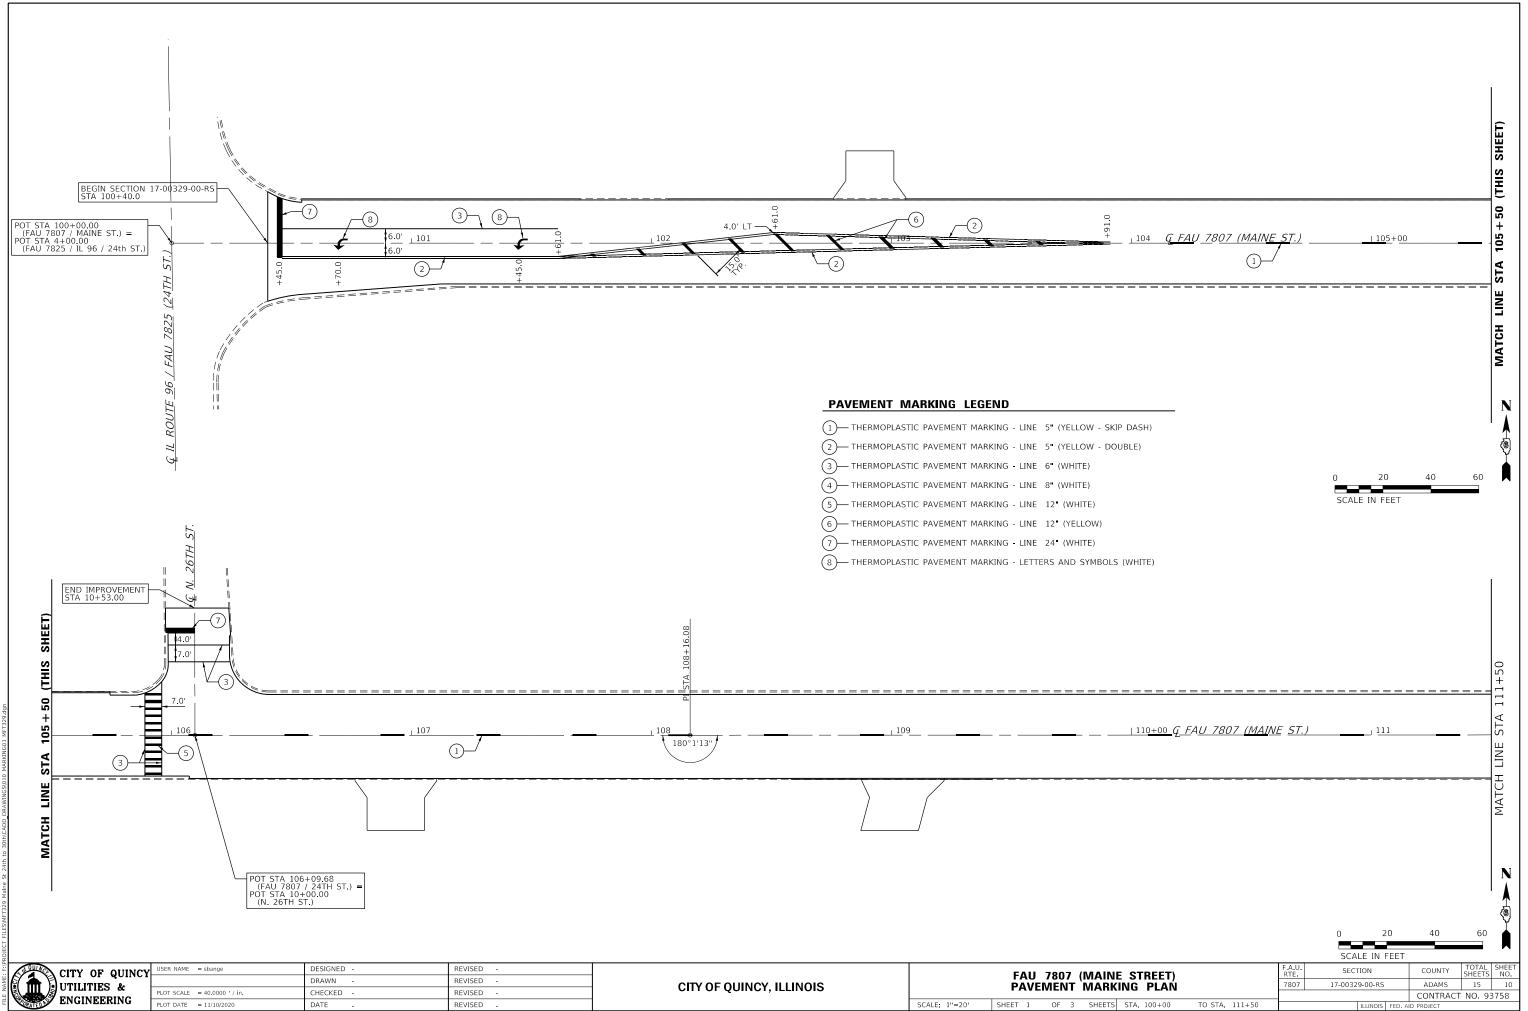

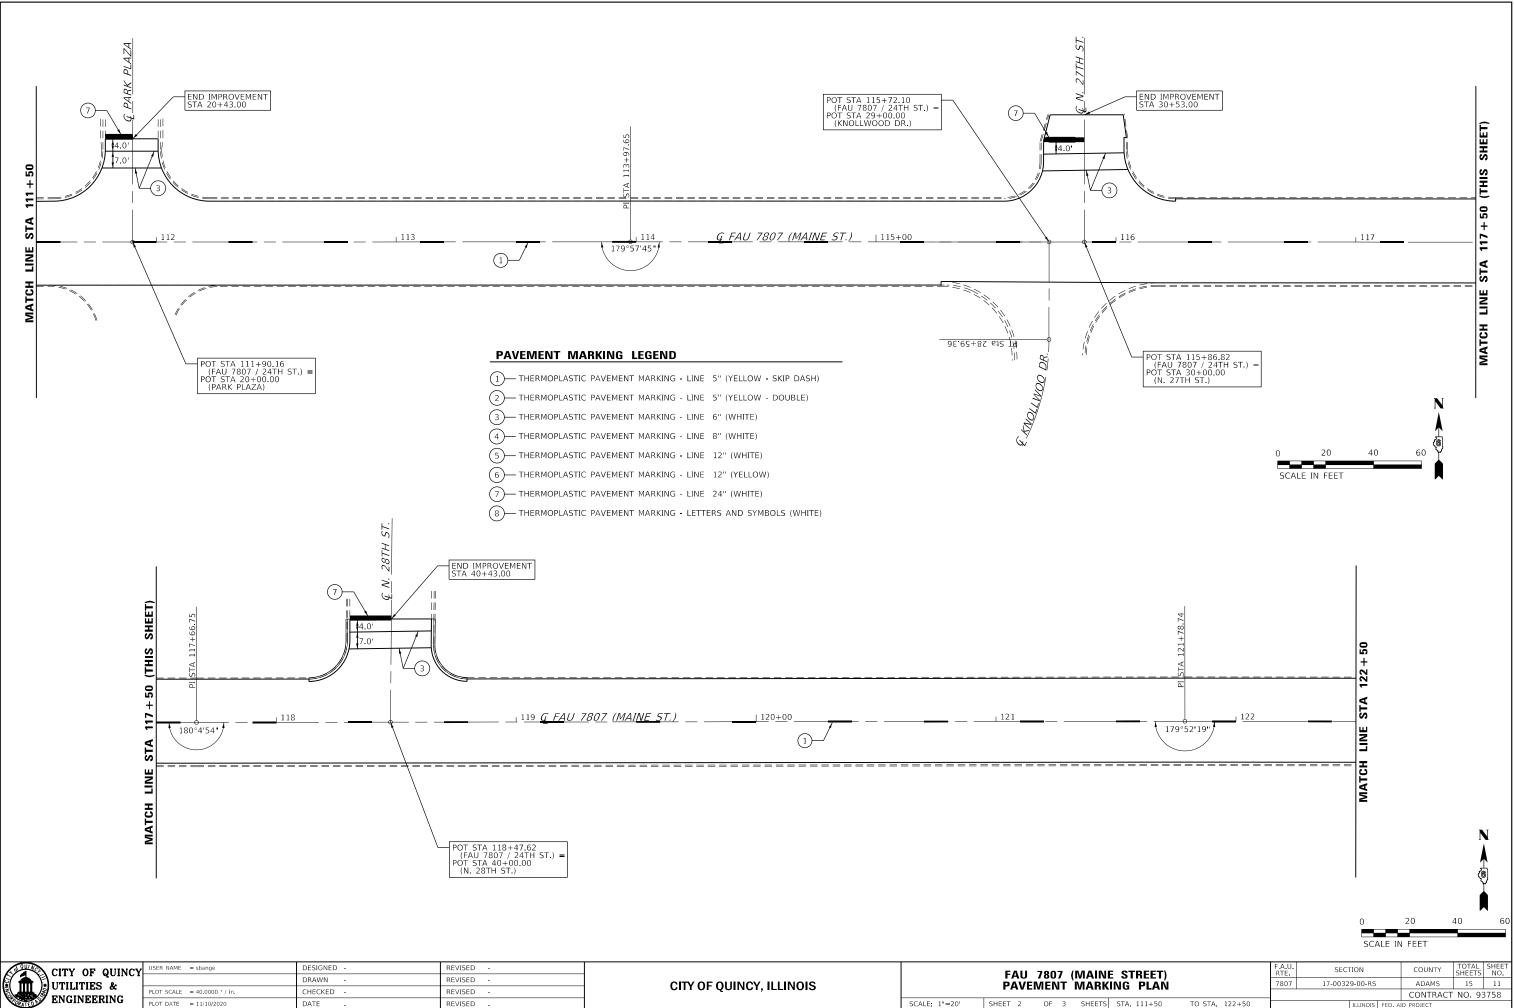
SCALE: 1"=20'

PAVEMENT MARKING LEGEND

- 1) THERMOPLASTIC PAVEMENT MARKING LINE 5" (YELLOW SKIP DASH)
- (2) THERMOPLASTIC PAVEMENT MARKING LINE 5" (YELLOW DOUBLE)
- (3)— THERMOPLASTIC PAVEMENT MARKING LINE 6" (WHITE)
- (4) THERMOPLASTIC PAVEMENT MARKING LINE 8" (WHITE)
- (5) THERMOPLASTIC PAVEMENT MARKING LINE 12" (WHITE)
- (6) THERMOPLASTIC PAVEMENT MARKING LINE 12" (YELLOW)
- (7)— THERMOPLASTIC PAVEMENT MARKING LINE 24" (WHITE)
- (8) THERMOPLASTIC PAVEMENT MARKING LETTERS AND SYMBOLS (WHITE)

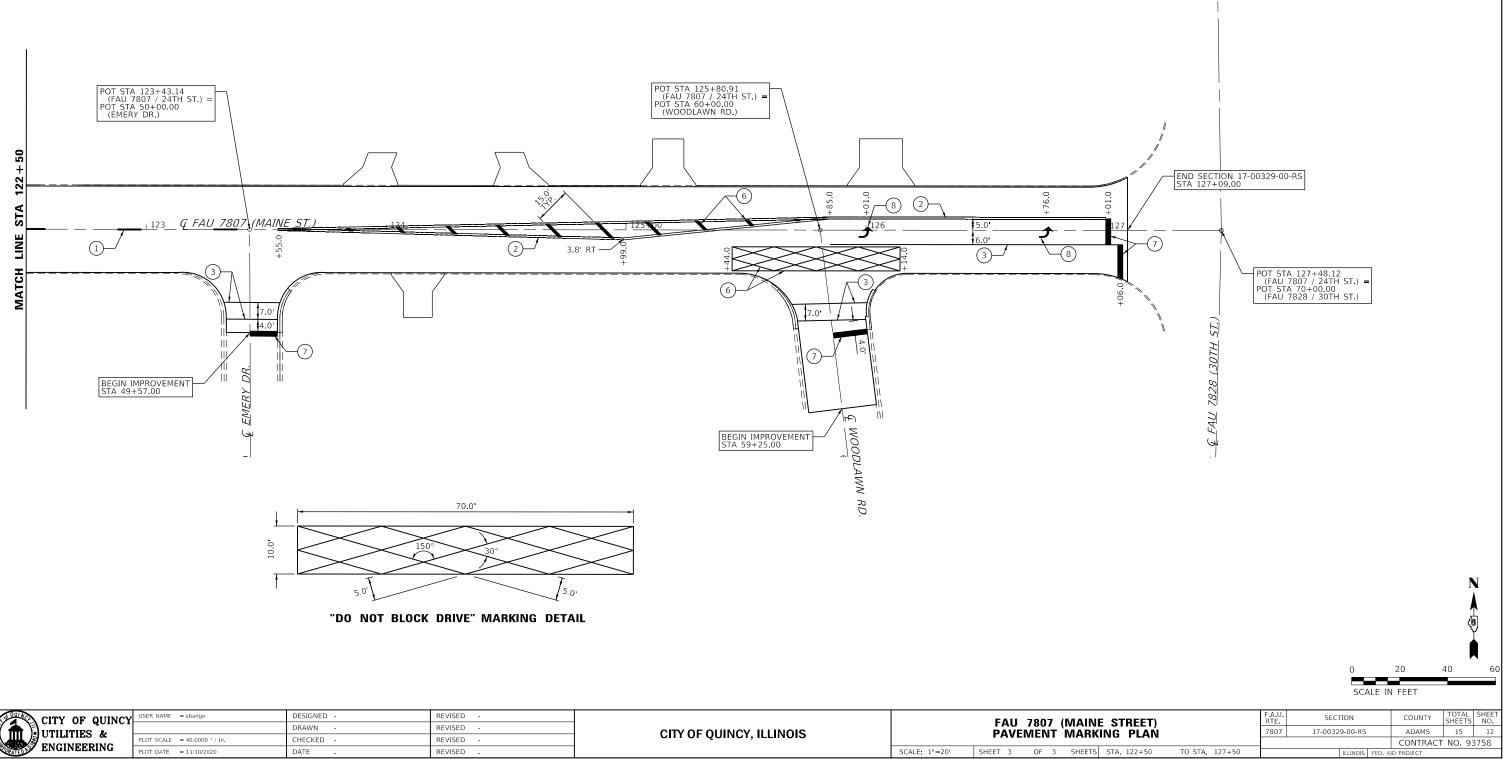

efault F:\PI	CITY OF QUINCY	USER NAME = sbange	DESIGNED -	REVISED -			EAU	7007	(MAIN
AME	UTILITIES &		DRAWN -	REVISED -	CITY OF QUINCY, ILLINOIS		FAU PAVEI		MAR
DDEL PDEL		PLOT SCALE = 40.0000 ' / in.	CHECKED -	REVISED -			FAVE		IVIANE
M	ENGINEERING	PLOT DATE = 11/10/2020	DATE -	REVISED -		SCALE: 1"=20'	SHEET 3	OF 3	SHEETS

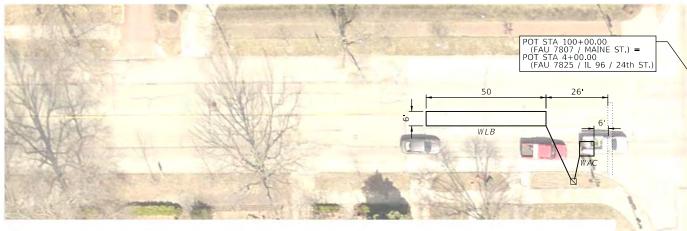

DESIGNATION	LOCATION	SIZE	TYPE	TURNS	DETECTOR LOOP, TYPE	
					(FT)	
EAC	WESTBOUND THRU/RT	6' x 6'	POINT	5	42	
EAE	WESTBOUND THRU/RT	12' x 2'	POINT	4	37	
EAF	WESTBOUND THRU/RT	12' x 2'	POINT	4	47	
ELT	WESTBOUND LT	35' x 6'	QUAD	2-4-2	145	
ELB	WESTBOUND LT	48' x 6'	PRESENCE	2	141	
SAE	NORTHBOUND THRU / RT	6' x 6'	POINT	4	32	
SAF	NORTHBOUND THRU / RT	6' x 6'	POINT	5	57	
WAC	EASTBOUND THRU / RT	6' x 6'	POINT	4	33	
WLB	EASTBOUND LT	50' x 6'	PRESENCE	2	140	
TOTALS					674	


NOTES:

DETECTOR LOOPS IN THE NORTHBOUND AND EASTBOUND LANES ARE FOR THE REPLACEMENT OF EXISTING FAILED LOOPS. TRAFFIC CONTROL AND PROTECTION DURING THE INSTALLATION OF THE DETECTOR LOOPS SHALL BE IN ACCORDANCE WITH HIGHWAY STANDARD 701701.

0 NE ST.) = 5 / 24th ST.)		
<u>Ģ IL ROUTE 96 / FAU 7825</u> 3(24TH ST.)	127'	
S	AF	*

NAME: F:\F	CITY OF QUINCY	USER NAME = sbange	DESIGNED - DRAWN -	REVISED - REVISED -	CITY OF QUINCY, ILLINOIS	FAU 7807 (MAIN TRAFFIC SIGNAL DETECTOR LOO			
FILE	ENGINEERING	PLOT SCALE = 40.0000 ' / in. PLOT DATE = 11/10/2020	CHECKED - DATE -	REVISED - REVISED -	, ,	SCALE: 1"=20'	SHEET 1		HEETS



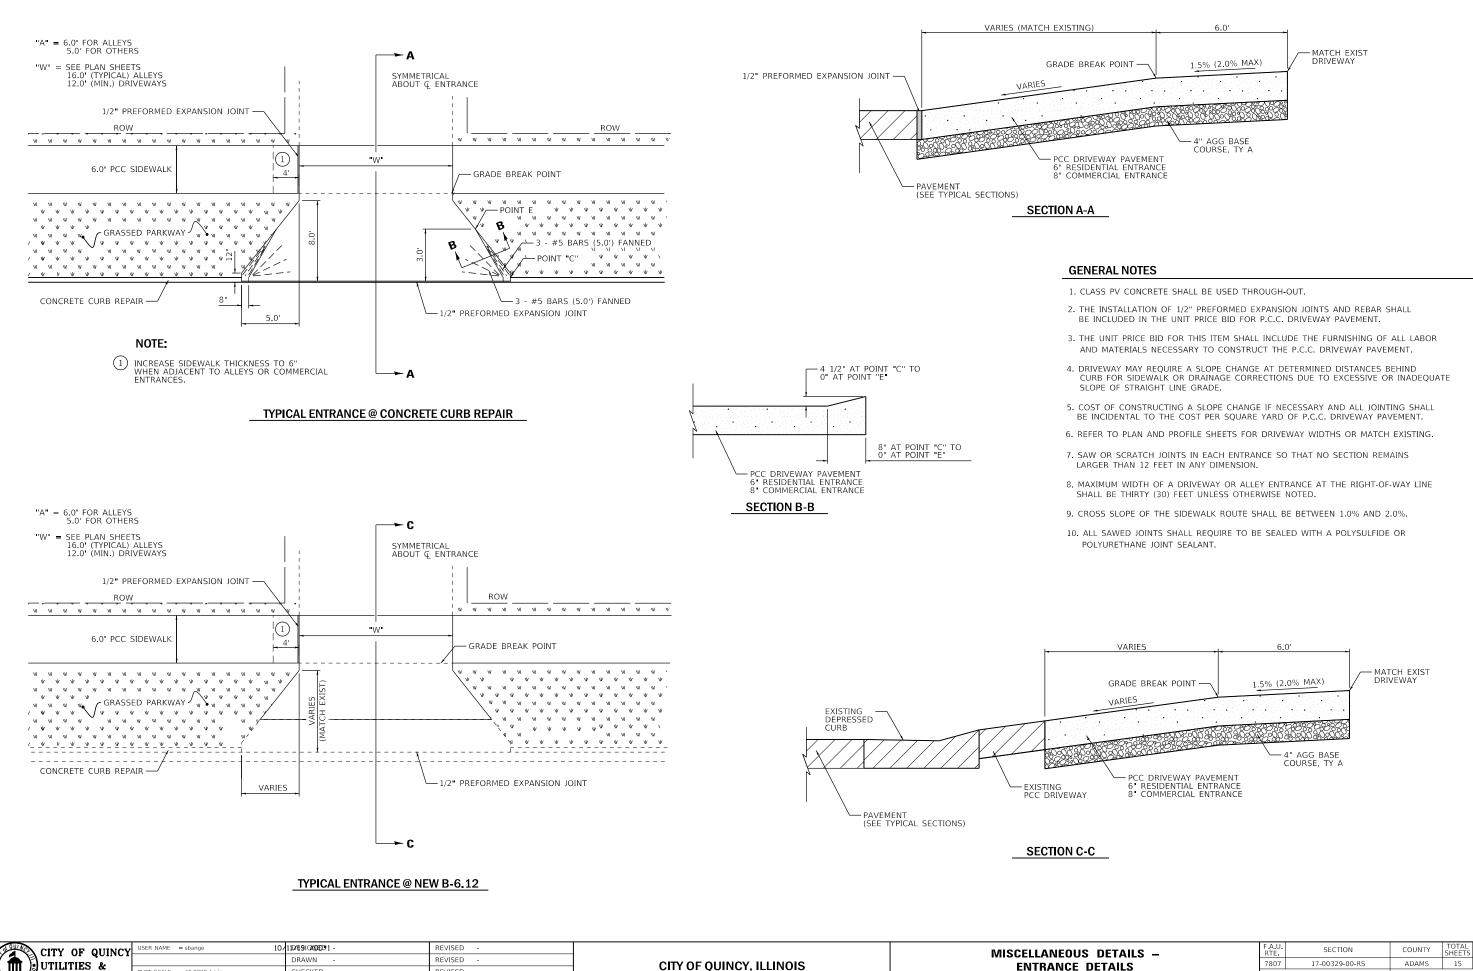


DRAWN REVISED UTILITIES & **CITY OF QUINCY, ILLINOIS** OT SCALE = 40.0000 ' / in. HECKED REVISED ENGINEERING LOT DATE = 11/10/2020 REVISED DATE



SCALE:

DETAILS – DETAILS		F.A.U. RTE	SECTION			COUNTY	TOTAL SHEETS	SHEET NO.	
		7807	17-00329-00-RS			ADAMS	15	14	
		CONTRACT NO. 93758						3758	
٢S	STA.	TO STA.			ILLINOIS	FED, AI	D PROJECT		

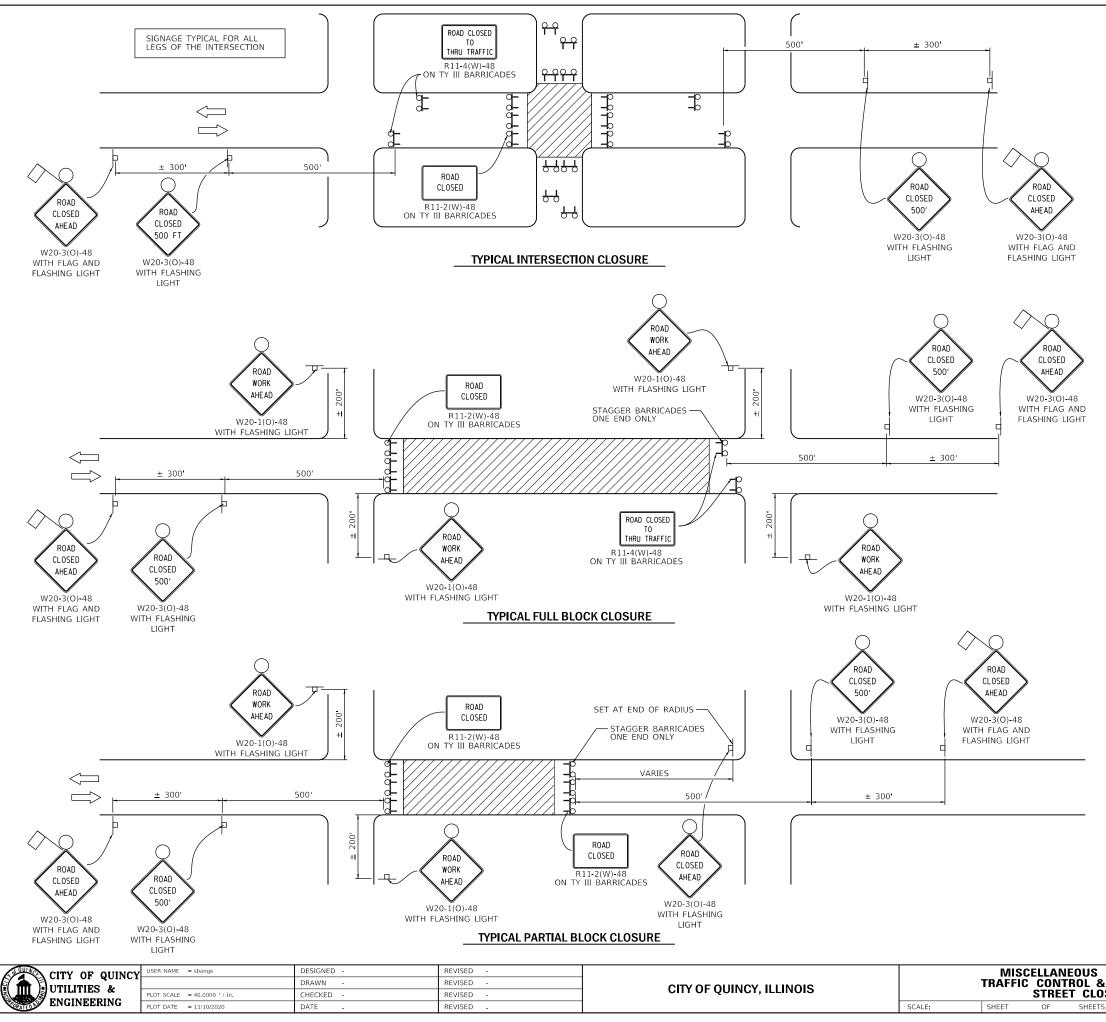

LEGEND



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WORK AREA

TYPE III BARRICADE WITH FLASHING LIGHTS

SIGN ON PORTABLE OR POST MOUNTED SUPPORT

GENERAL NOTES

- CLOSURES CAN BE COMBINED AS NEEDED TO MEET THE LIMITS OF THE WORK ZONE. 1.
- THE EXACT NUMBER OF TYPE III BARRICADES REQUIRED TO BE DETERMINED IN THE FILED BY THE ENGINEER. 2.
- SIGNS SHALL BE POST MOUNTED IF THE CLOSURE IS GREATER THAN FOUR (4) CALENDAR DAYS. 3.
- DIMENSIONS MAY BE VARIED DUE TO SITE CONDITIONS, TOPOGRAPHY, AND URBAN LANDSCAPE. 4.
- ORANGE FLAG MINIMUM 18" BY 18" 5.
- FOR CLOSURES ON ONE-WAY STREETS, PLACE WARNING SIGNS ON APPROACH SIDE ONLY. 6.
- ENGINEER TO DETERMINE WHICH APPROACH TO STAGGER THE TYPE III BARRICADES. 7.
- TRAFFIC CONTROL AND PROTECTION IN THIS DETAIL TO BE MEASURED ON AN EACH BASIS. WORK ZONES MUST BE SPACED GREATER THAN 800 APART FOR THE TRAFFIC 8. CONTROL AND PROTECTION TO BE MEASURED FOR SEPARATELY.

DETAILS – Protection Sure		SECTION			COUNTY	TOTAL SHEETS	SHEET NO.
		17-00329-00-RS			ADAMS	15	15
					CONTRACT NO. 93758		
STA. TO STA.			ILLINOIS	FED. A	ID PROJECT		