COVER SHEET

SUMMARY OF QUANTITIES AND DETAILS

EXISTING TOPOGRAPHIC AND OVERALL SITE PLAN SITE PLAN AND GRADING PLAN

SANITARY SEWER LATERAL AND PLAN AND PROFILE C-5

A0.1 ARCHITECTURAL LEGEND SHEET ARCHITECTURAL SITE PLAN & NOTES

A2.2 ARCHITECTURAL FLOOR PLAN & PARTITION TYPES

ROOF PLAN AND DETAILS

A3.1 REFLECTED CEILING PLAN A4.1 BUILDING ELEVATIONS AND SECTION

A4.2 BUILDING FLEVATIONS

WALL SECTIONS & EXTERIOR DETAILS A5.1

DOOR & WINDOW TYPES, DETAILS & SCHEDULES A7.1 INTERIOR ELEVATIONS & DETAILS

M1.1 MECHANICAL PLAN AND NOTES

POWER & COMMUNICATIONS PLAN AND NOTES E1.1

E2.1 LIGHTING PLAN AND NOTES PLUMBING PLAN AND NOTES

FOUNDATION PLAN

ROOF FRAMING PLAN AND SHEAR WALL PLAN

WALL DETAILS

FRAMING DETAILS

SHEAR WALL DETAILS SHEAR WALL SCHEDULE

DECK FRAMING PLAN

DECK FRAMING PLAN DETAILS

IDOT STANDARDS

TEMPORARY EROSION CONTROL SYSTEMS

CURB RAMPS FOR SIDEWALKS CLASS C&D PATCHES

701501-05 701901-01 URBAN LANE CLOSURE, 2L, 2W, UNDIVIDED TRAFFIC CONTROL DEVICES

SIGN PANEL MOUNTING DETAIL SIGN PANEL ERECTION DETAIL 720006-02 TELESCOPING STEEL SIGN SUPPORT

UTILITIES

WATER, SEWER & GAS CITY OF CHESTER 1330 SWANWICK STREET CHESTER, ILLINOIS 62233 (618)826-2326

ELECTRIC

AMEREN IP 1050 WEST BOULEVARD BELLEVILLE, IL 62221 (800)755-5000


TELEPHONE

VERIZON 1401 HIGH STREET

CHESTER, ILLINOIS 62233 (800)483-4000

CABLE T.V.

NEW WAVE 823 EAST BROADWAY SPARTA, ILLINOIS 62286

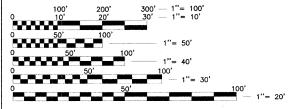


FULL SIZE PLANS HAVE BEEN PREPARED USING STANDARD ENGINEERING SCALES, REDUCED SIZED PLANS WILL NOT CONFORM TO STANDARD SCALES, IN MAKING MEASUREMENTS ON REDUCED PLANS, THE ABOVE SCALES MAY BE USED.

JOINT UTILITY LOCATION INFORMATION FOR EXCAVATION 1-800-892-0123

STATE OF ILLINOIS DEPARTMENT OF TRANSPORTATION PLANS FOR PROPOSED **CHESTER WELCOME CENTER**

SECTION 06-00058-00-HP JOB NO. C-98-306-07 CITY OF CHESTER, ILLINOIS RANDOLPH COUNTY PROJECT NO. TE-0008(120)

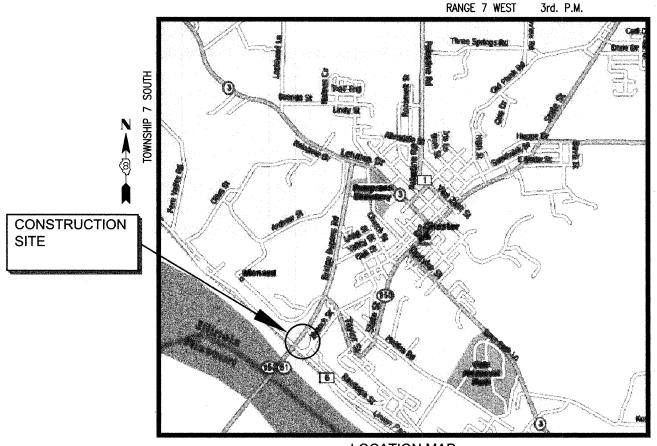

STREET DESIGN DESIGNATION:

DESIGN SPEED - N/A

ROADWAY CLASSIFICATION - N/A

DESIGN TRAFFIC (2027) ADT - N/A


LOCATION MAP

LENGTH OF PROJECT TOTAL SITE AREA ±3 ACRES

SECTION COUNTY 06-000 58-00-HP RANDOLPH LOCAL ROAD PROJECT ILLINOIS

FEDERAL AID PROJECT

LOCATION OF SECTION INDICATED THUS:

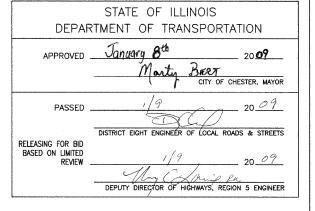



rur Rrom CRAIG BRAUER, P.E. LICENSE NO 047294

ÓATĚ EXPIRES 11-30-09



THOUVENOT, WADE & MOERCHEN, INC.

,	SUMMARY OF QUANTITIE	S	
PAY CODE NUMBER	PAY ITEM DESCRIPTION	UNIT	TOTAL QUANTITY
20400800	FURNISHED EXCAVATION	CU YD	95
20800150	TRENCH BACKFILL	CU YD	61
25000100	SEEDING, CLASS 1	ACRE	0.20
25000400	NITROGEN FERTILIZER NUTRIENT	POUND	18
25000500	PHOSPHORUS FERTILIZER NUTRIENT	POUND	18
25000600	POTASSIUM FERTILIZER NUTRIENT	POUND	18
25100105	MULCH, METHOD 1	ACRE	0.20
25101504	WOOD CHIP MULCH 4"	SQ YD	55
25200100	SODDING	SQ YD	40
28000400	PERIMETER EROSION BARRIER	FOOT	362
40300100	BITUMINOUS MATERIALS (PRIME COAT)	GALLON	607
40300300	BITUMINOUS MATERIALS (COVER AND SEAL COATS)	GALLON	567
40300600	SEAL COAT AGGREGATE	TON	16
42300200	PORTLAND CEMENT CONCRETE DRIVEWAY PAVEMENT, 6 INCH	SQ YD	36
42400100	PORTLAND CEMENT CONCRETE SIDEWALK 4 INCH	SQ FT	861
42400800	DETECTABLE WARNINGS	SQ FT	16
	8.77 9.	4 4	
44000600	SIDEWALK REMOVAL	SQ FT	72
44201741	CLASS D PATCHES, TYPE II. 8 INCH	SQ YD	30
56200500	WATER SERVICE LINE 1 1/2"	FOOT	89
67100100	MOBILIZATION	LUMP SUM	1
70101800	TRAFFIC CONTROL AND PROTECTION, (SPECIAL)	LUMP SUM	1
70102620	TRAFFIC CONTROL AND PROTECTION, STANDARD 701501	LUMP SUM	i
72000100	SIGN PANEL - TYPE 1	SQ FT	2
72800100	TELESCOPING STEEL SIGN SUPPORT	FOOT	12
X0321309	CONCRETE PAD	SQ YD	14
X0322672	SPLIT RAIL FENCE TO BE REMOVED AND RE-ERECTED	FOOT	100
XX000959	TRASH RECEPTACLES	EACH	3
XX005661	REMOVE AND RELOCATE SIGN NO. 1	EACH	1
XX005662	REMOVE AND RELOCATE SIGN NO. 2	EACH	l i
XX005962	BENCH	EACH	2
XX007056	BUILDING	LUMP SUM	1
Z0056800	SANITARY SEWER, 6"	FOOT	262

* ASTERICK REPRESENTS SPECIALTY ITEMS.

EARTHWORK SCHEDULE						
LOCATION ENTIRE SITE	EARTH EXCAVATION (CU YD) 20200100	EARTH EXCAVATION ADJUSTED FOR SHRINKAGE (CU YD)	EMBANKMENT	EARTHWORK BALANCE WASTE (+) SHORTAGE (-) (CU YD)		
	0	0	95	-95		


EARTHWORK NOTE:

THERE IS MINIMAL EARTH EXCAVATION WITH THE NEW SIDEWALK CONSTRUCTION AND THE FURNISHED EXCAVATION IS TO BE PLACED NEAR BRANCH STREET FOR COVER OVER THE PROPOSED SEWER LATERAL.

6" UNREINFORCED PORTLAND CEMENT CONCRETE PAVEMENT


COMPACTED AND ---PROOF ROLLED SUBGRADE

HANDICAPED PARKING PAVEMENT

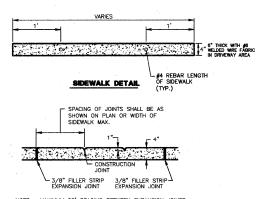


NOTE: MAXIMUM 25' SPACING BETWEEN EXPANSION JOINTS PROVIDE EXPANSION JOINT MATERIAL AND SEALANT WHERE SIDEWALK AND BUILDING INTERFACE.

SIDEWALK JOINT DETAIL

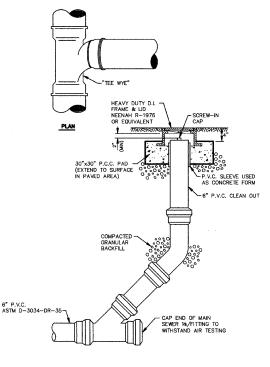

CLEANOUT DETAIL

SPECIFICATIONS: SANITARY SEWER PIPE SHALL CONFORM TO ASTM D-3034-DR-35 WITH ELASTOMERIC JOINTS IN CONFORMANCE WITH ASTM D-3212.

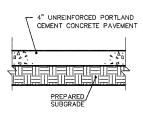

CONCRETE PAD FOR RELOCATED PICNIC TABLE

GENERAL NOTES

ANY REFERENCE TO A STANDARD IN THESE PLANS SHALL BE INTERPRETED TO MEAN THE EDITION, AS INDICATED BY THE SUB-NUMBER LISTED IN THE INDEX OF SHEETS, OR THE COPY OF THE STANDARD INCLUDED IN THESE PLANS

ANY FACILITIES OR APPURTENANCES WHICH ARE THE PROPERTY OF ANY PUBLIC UTILITY LOCATED WITHIN THE LIMITS OF CONSTRUCTION SHALL BE RELOCATED OR ADJUSTED BY THEIR RESPECTIVE OWNERS. THE CONTRACTOR SHALL NOTIFY AND COOPERATE WITH THE OWNERS OF ANY SUCH FACILITY IN THEIR REMOVAL AND REARRANGE HIS OPERATIONS IN ORDER THAT THE UTILITY'S OPERATIONS AND THE CONSTRUCTION OF THIS PROJECT MAY PROGRESS IN A REASONABLE MANNER.

THE TYPE, SIZE, AND LOCATION OF UTILITIES AS DELINEATED IN THESE TOPOGRAPHIC LAND SURVEY DOCUMENTS AND/OR CIVIL ENGINEERING DESIGN DOCUMENTS HAVE BEEN DETERMINED BY REVIEW OF AVAILABLE EXISTING "AS-BUILT" OR RECORD DRAWINGS: FIELD SURVEY OF JULILLE, MARKED UTILITIES: OR FIELD SURVEY OF ABOVE GROUND SURFACE UTILITY FEATURES. THE OWNER AND ENGINEER HAVE NOT UNDERTAKEN SUBSURFACE EXPLORATORY INVESTIGATIONS TO CONFIRM OR VERIFY THE UTILITIES SHOWN ON THESE DOCUMENTS, THEREFORE THEIR EXACT LOCATION, SIZE AND FUNCTION MUST BE CONSIDERED APPROXIMATE AND MUST BE FIELD CONFIRMED BY THE CONTRACTOR.

THE ENGINEER AND OWNER FURTHER DO NOT WARRANT THAT ALL UTILITIES HAVE BEEN ILLUSTRATED ON THESE DOCUMENTS. THE CONTRACTOR IS SOLELY RESPONSIBLE FOR CONTACTING J.U.L.I.E. FOR FIELD VERIFICATION OF ALL UTILITIES ON THE SITE PRIOR TO COMMENCEMENT OF CONSTRUCTION. IF THE CONTRACTOR DETERMINES THAT SUBSTANTIAL DISCREPANCY EXISTS BETWEEN FIELD VERIFIED UTILITIES AND THESE PLANS WHICH WOULD SIGNIFICANTLY AFFECT THE FUNCTION, COST, OR PERFORMANCE OF THE PROJECT, THE CONTRACTOR SHALL IMMEDIATELY CONTACT THE ENGINEER FOR CLARIFICATION AND PROJECT

THE CONTRACTOR SHALL CONFINE HIS OPERATIONS TO THE AREA LOCATED WITHIN THE CONSTRUCTION LIMIT LINES, AS SHOWN ON PLANS. ANY AREA DISTURBED BEYOND THESE LIMITS SHALL BE RESTORED TO ITS ORIGINAL CONDITION AT THE CONTRACTOR'S EXPENSE.

EVERY TREE SHALL BE SAVED IF POSSIBLE. THE ENGINEER IN THE FIELD WILL VERIFY AND MARK ALL TREES REQUIRED TO BE REMOVED. SHOULD THE ENGINEER'S DECISION INCREASE OR DECREASE THE QUANTITIES OF WORK TO BE PERFORMED FROM THE PLANS, THE CONTRACTOR SHALL ACCEPT PAYMENT AS STATED IN ARTICLE 104.03 OF THE STANDARD SPECIFICATIONS. TREES OUTSIDE THE LIMITS OF CONSTRUCTION SHALL NOT BE DISTURBED UNLESS DESIGNATED BY THE

IT IS THE CONTRACTOR'S RESPONSIBILITY TO INSURE THAT ALL EROSION AND DISPLACED SEDIMENT DOES NOT MIGRATE OFF SITE. IF UNEXPECTED EROSION OR SEDIMENTATION OCCURS, OR IF THE EROSION PLAN STRUCTURES BECOME DAMAGED, THE CONTRACTOR SHALL PROVIDE SUFFICIENT MEASURES TO REPAIR, REPLACE, OR INSTALL EROSION CONTROL STRUCTURES TO INSURE OFF-SITE DAMAGE DOES NOT OCCUR. ANY SEDIMENT OR EROSION DAMAGE WHICH OCCURS OFF-SITE SHALL BE REPAIRED BY THE CONTRACTOR AT HIS EXPENSE.

ALL EARTH SURFACES DISTURBED BY CONSTRUCTION OR AS DIRECTED BY THE ENGINEER SHALL BE SEEDED. THE FOLLOWING QUANTITIES HAVE BEEN INCLUDED IN THE PAY ITEM "SEEDING, CLASS 1" AND NO ADDITIONAL COMPENSATION WILL BE ALLOWED.

0.61 ACRES SEEDING CL 1 NITROGEN FERTILIZER NUTRIENT 55 POUNDS 55 POUNDS 55 POUNDS PHOSPHORUS FERTILIZER NUTRIENT SEEDING DATES: FALL: AUG. 16 - DEC. 31

SPRING: JAN. 1 - MAY 31 NO SEEDING SHALL BE DONE BETWEEN

IT IS INTENDED THAT ANY CULVERTS DAMAGED BY OR REMOVED BY THE CONTRACTOR OTHER THAN THOSE NOTED ON THE PLANS TO BE REMOVED WILL HAVE TO BE REMOVED AND/OR REPLACED AT THE CONTRACTOR'S SOLE EXPENSE.

ALL TRAFFIC CONTROL INCLUDING BUT NOT LIMITED TO, WORK ZONE, TEMPORARY, AND PERMANENT, SHALL BE FURNISHED, INSTALLED, MAINTAINED, RELOCATED, AND/OR REMOVED IN ACCORDANCE WITH SECTION 701 OF THE LATEST EDITION OF THE IDOT STANDARD SPECIFICATIONS FOR ROAD AND BRIDGE CONSTRUCTION AND THE LATEST EDITION OF THE MANUAL ON UNIFORM TRAFFIC CONTROL DEVICES.

TRAFFIC CONTROL SIGNS SHALL BE 48" FLUORESCENT ORANGE.

THE CONTRACTOR IS RESPONSIBLE FOR CONTACTING THE CITY OF CHESTER AT LEAST FORTY-EIGHT (48) HOURS IN ADVANCE PRIOR TO COMMENCEMENT OF ANY CONSTRUCTION ACTIVITIES OR WORK REQUIRING INSPECTION OR APPROVAL BY THE AFFECTED UNITS OF GOVERNMENT.





□ CORPORATE OFFICE

4940 OLD COLLINSVILLE RD. SWANSEA, ILLINOIS 62226 FAX (618) 624-6688 corp@twm-inc.com

☑ WATERLOO OFFICE

113 SOUTH MAIN STREET WATERLOO, ILLINOIS 62298 TEL (618) 939-5050 FAX (618) 939-3938

ST. LOUIS OFFICE 1001 CRAIG ROAD, SUITE 260 ST. LOUIS, MISSOURI 63146 TEL (314) 236-5052 FAX (314) 872-2194

PROFESSIONAL REGISTRATIONS LICENSE NO. PROFESSIONAL ENGINEERING CORP. 62-035370 PROFESSIONAL STRUCTURAL ENGR. CORP ILLINOIS PROF. LAND SURVEYING CORP. 048-000029

MISSOURI PROFESSIONAL ENGR. CORP. NC 001528 MISSOURI LAND SURVEYING CORP.

Expiration Date:
STATEMENT OF RESPONSIBILITY hereby confirm that the document herein to be outhenticated by my seal is restricted to this shee and I hereby disclaim any responsibility for all oth drawings, specifications, estimates, reports or other





CREATED ON: JANUARY 04, 2008 EV. DATE DESCRIPTION 09/02/08 REVISIONS PER CITY OF CHESTER


12/16/08 REVISIONS PER I.D.O.T. 01/09/09 REVISIONS PER I.D.O.T.

DRAWN BY: KAK	SHEET
DESIGNED BY:	
CHECKED BY:	C-
APPROVED BY:	
PROJECT D33050421	OF SHI

ISSUED FOR REVIEW | RECORD DRAWING

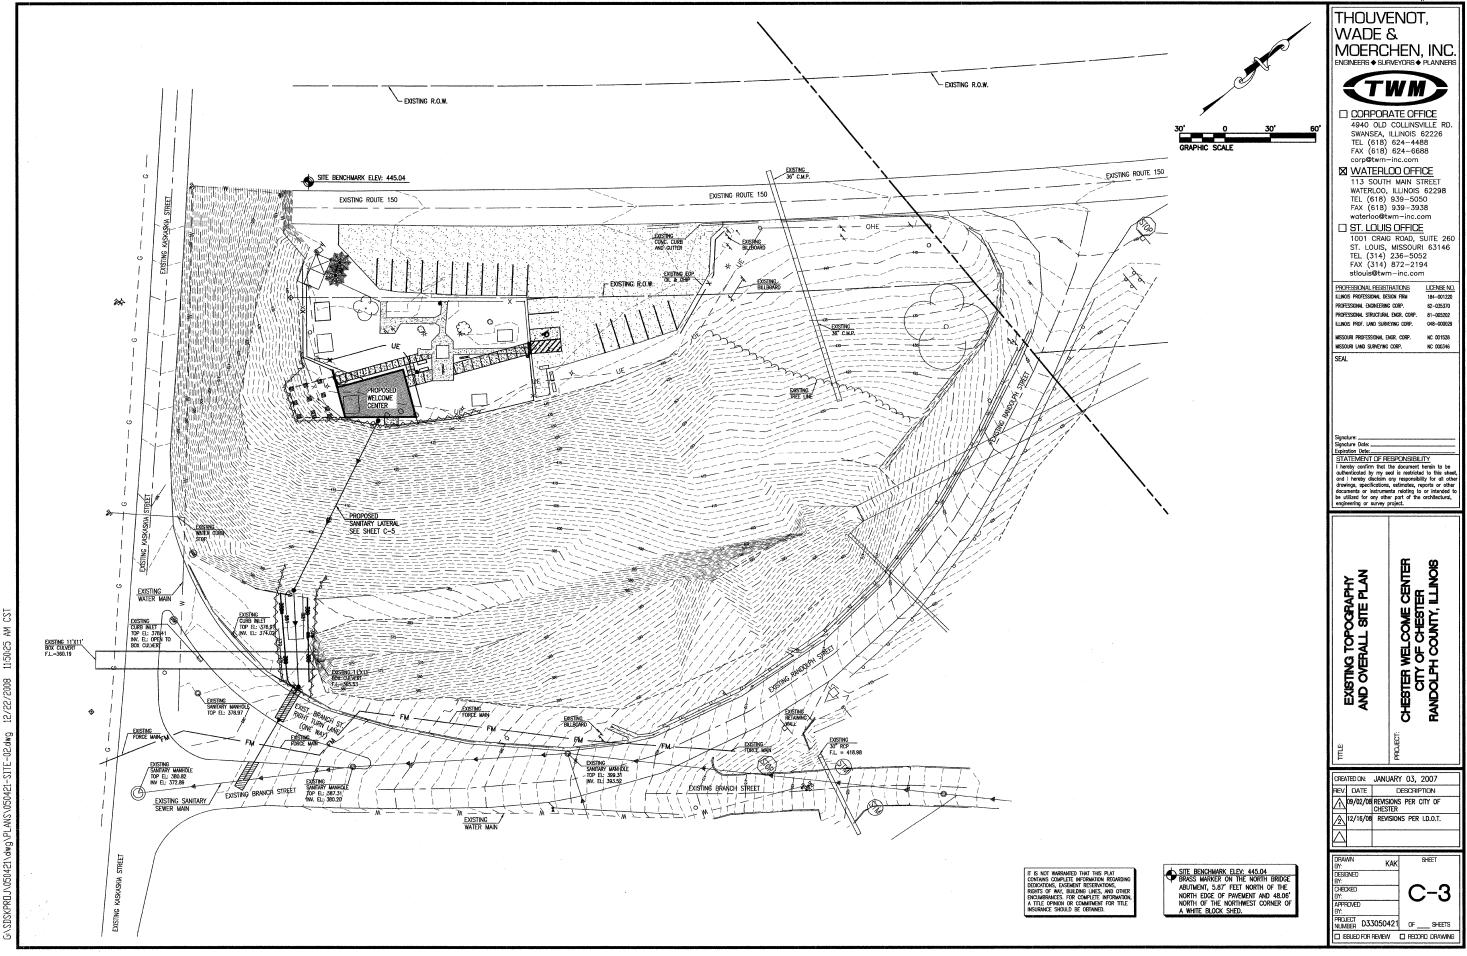

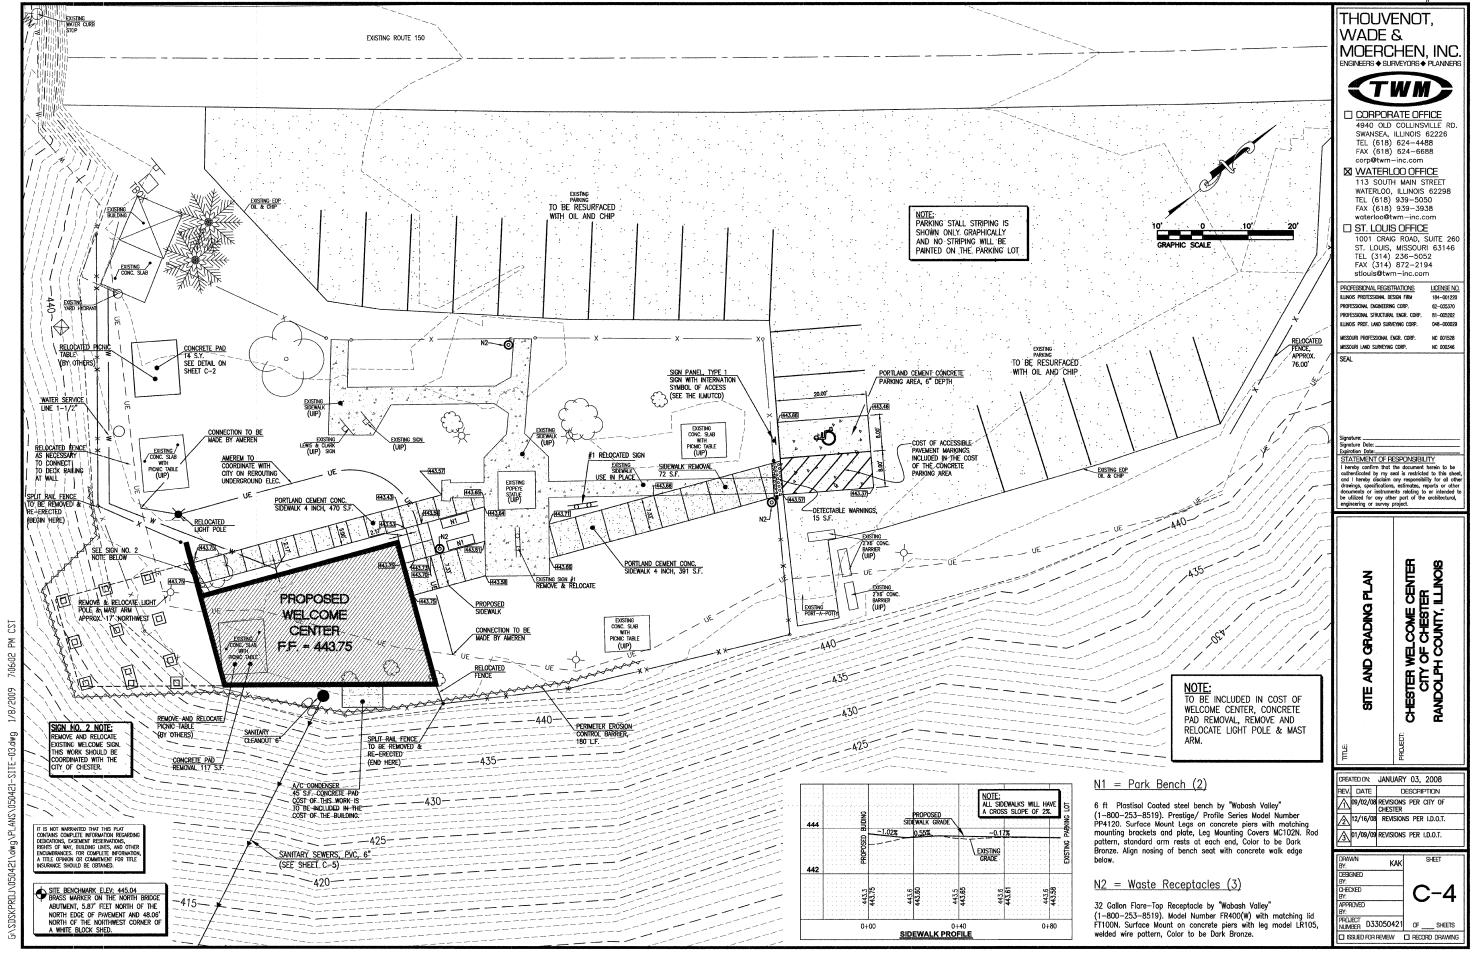

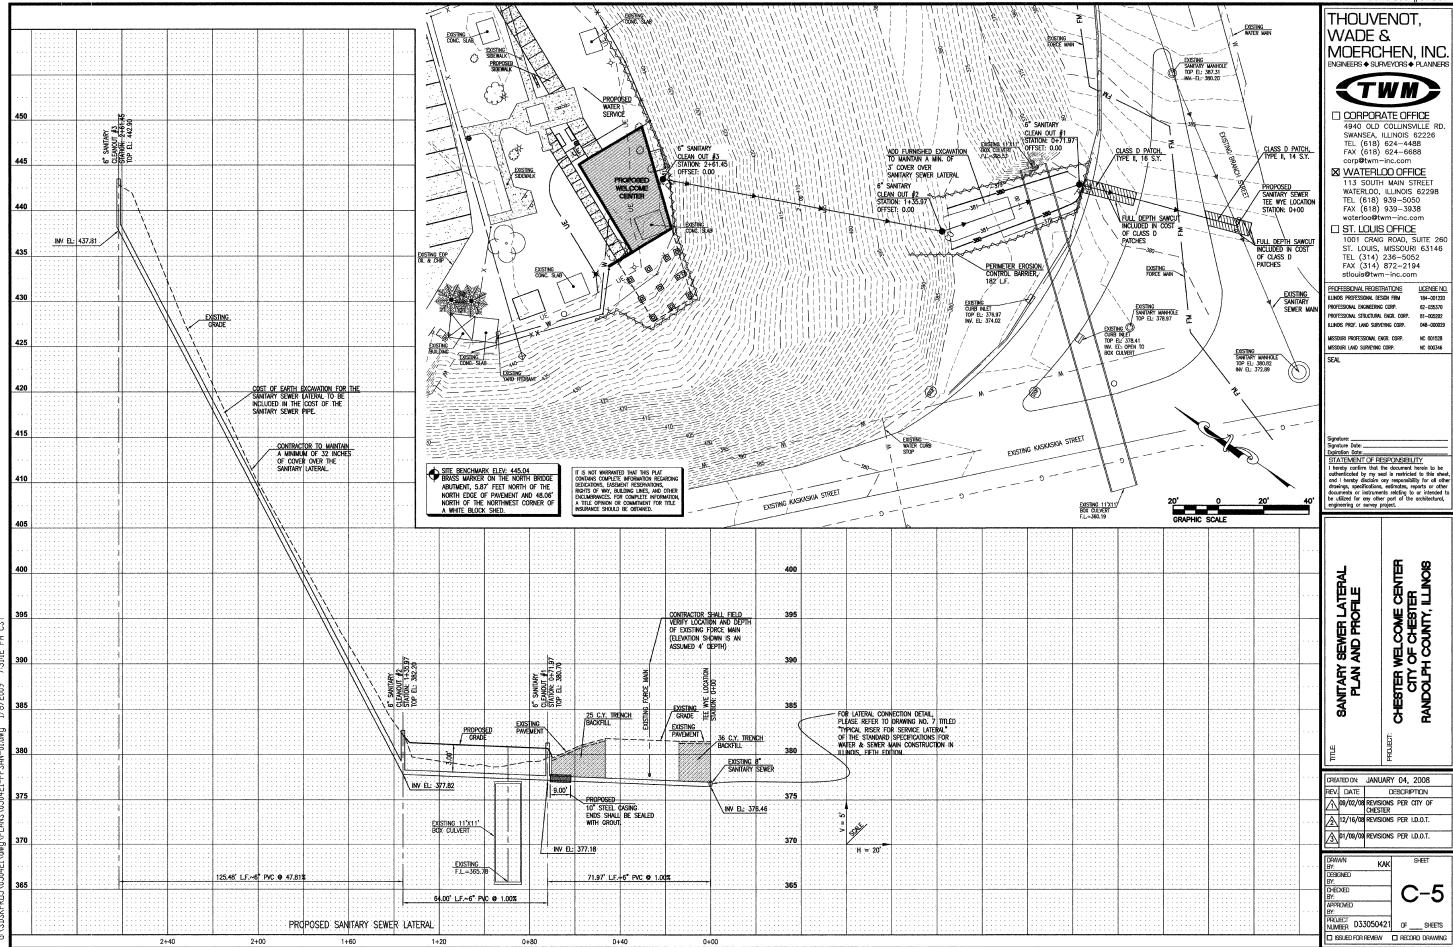

LIST OF ABBREVIATIONS CODE DATA outside air on center(s) outside diameter, outside dimensi original equipment manufacturer overhead opening opposite CODES RELEVANT TO THIS PROJECT INCLUDE BOTH CODES LEGALLY ADOPTED BY GOVERNMENTAL AGENCIES AND CODES ADOPTED BY THE CLIENT AS A MINIMUM STANDARD OF DESIGN AND INSTALLATION. ONE CODE OR STANDARD MAY REFERENCE ANOTHER, THEN BOTH CODES SHALL BE CONSIDERED A REQUIREMENT OF THIS PROJECT, CODES RELEVANT TO THIS PROJECT INCLUDE BUT MAY NOT BE acoustical acrylic acoustical tile area drain AC ACR ACT AD ADD ADH ADJ AFF AGA AHJ AIAI AISI ALUM ALLOW ALT ANSOI APPROX APP ARCH ASHRAE OA OC OD OEM OH OPNG OPP LIMITED TO THE FOLLOWING: addendum adhesive adjustable above finished floor CHESTER ZONING ORDINANCE 2006 INTERNATIONAL BUILDING CODE INTERNATIONAL MECHANICAL CODE PBG plumbing piece process per cubic foot phose PL plote; property line plate; property line plate; propiect point(ed) pR point(ed) project; projected products per square foot point; point; point ILLINOIS PLUMBING CODE american gas association authority having jurisdiction air-handling unit NATIONAL ELECTRIC CODE-NEPA TO NATIONAL FUEL GAS CODE-NFPA 54 INTERNATIONAL ENERGY CONSERVATION CODE american institute of architects american iron & steel institute aluminum AMERICANS WITH DISABILITIES ACT ILLINOIS ACCESSIBILITY CODE alternate aluminum american national standards institute anodized BUILDING CODE DATA BUILDING OCCUPANT LOAD: DISPLAY AREAS = (1 PERSON PER IS S.F.) = 41 CHAMBER OFFICE = 2 PROPOSED BUILDING AREA 1236 S.F. (PER IBC 502) PROPOSED DECK AREA 132 S.F. (PER IBC 502) TOTAL BUILDING OCCUPANT LOAD: 43 BUILDING CODE OCCUPANCY: A3-A\$95MBLY BUILDING CODE CONSTRUCTION TYPE: 5B, INPROTECTED - COMBUSTIBLE BUILDING AREA, PER FLOOR, ALLOWED BY IBC: 9000 9.F. BASE G GA GB GALV GC GEN GFMU gage; gauge gypsum board golvonized general contract(or) general ground (ace masonry unit glass; glazing gallons per minute ASPH ASTM ATT AUTH AVG A/C AOR QTY quantity radius, riser roof drain rectangle refer (ence) refrigerator regular required required required required required required reduced for proposal reductive humidity room round rough opening R RD RECT REF REFR REGO'D REV REFO REV RFP RMD RO **ACCESSIBILITY NOTES** I. THIS PROJECT MUST COMPLY FULLY WITH ALL REQUIREMENTS OF THE ILLINOIS ACCESSIBILITY CODE 400,310 - PUBLIC FACILITIES, NEW CONSTRUCTION. PUBLIC FACILITIES WITHIN THE PROJECT WILL 8. PUSH/PULL SHALL NOT EXCEED 8 1/2 LBS ON EXTERIOR DOORS HEFA BAS BD BITUM BLDG BLKG BM BPL BRG BRK BRZ BSMT BTM BTU BTUH B high-efficiency particulate air horizontal building automation system board AND 5 LBS ON INTERIOR DOORS. board bituminous building blocking bearn bearing plate bearing brick bronze basement bottom british thermal unit BTU per hour bottom of hondicap header hardware hollow metal hondrali; hour height heeting heater heeting/ventilating/air conditioning hot water high point BE ACCESSIBLE PER ADA REQUIREMENTS. 2. THIS PROJECT WILL COMPLY FULLY WITH ADA/ADAAG REQUIREMENTS OF SECTION 4.1.6 10. TOILET ROOMS WILL COMPLY WITH IAC 400,310 SECTIONS IN THROUGH & AND ICC/ANSI AUT I CHAPTER 6 3. ALL NEW, ALTERED, REPAIRED, OR REPLACED DOORS LEADING INTO REQUIRED ACCESSIBLE ROOMS AND SPACES TO BE 3' WIDE MINIMUM, HAVE LEVER-OPERATED HARDWARE OR EGUAL AND II. ACCESSIBLE TOILETS WILL HAVE OPEN-FRONT SEATS IT" - 19" ABOVE FINISHED FLOOR EXPOSED PIPES BENEATH LAVATORIES WILL BE INSULATED WITH "HANDI-LAV" INSULATION. FAUCETS WILL schedule storm drain; smoke detector section square foot single hung sheet similar specification(s) square stornission coefficient stornission coefficient stornission stornis SCH SD SECT SF SH SHT SIM SPEC SQ SST STC STD STOR STOR STOR STUCT SUBJ SURF SUSP SUSP SYS schedu!e COMPLY FULLY WITH IAC SECTION 400.310(J) AND ADA/ADAAG high point hot water return 12. AT LEAST 5% (NOT LESS THAN I) OF ALL TABLES WILL BE FULL 4. ALL NEW, ALTERED, REPAIRED, OR REPLACED DOORS LEADING INTO HAZARDOUS ROOMS TO HAVE KNURLED LEVERS. ACCESSIBLE AND COMPLY WITH IAC 400.310. channel calculated capacity catch basin plywood, grade C&D, exterior glue cubic feet per minute clear(ance) ceiling clear(ance) concrete mosonry unit(s) indoor air quality international building code 3. NEW OR ALTERED SEATING, TABLES, AND WORK SURFACES WILL CALC CAP CB CDX CF CFM CLC CLG CCNC CONST CONST CONTC ALL CONTROLS AND OPERATING MECHANISMS TO BE WITHIN impact insulation class inside diameter inside dimensions inch REACH RANGE PER IAC 410.310(R) AND ADAAG ID ID IN INCL. INSFINT INC. 6. ALL PROVIDED EMERGENCY WARNING (ALARM) SYSTEMS TO BE AUDIBLE AND VISUAL AND COMPLY FULLY WITH IAC AND ADAAG. STROBE LIGHTS AND HORNS ARE NOT REQUIRED. 1. TOILET ROOM AND PARKING SPACE SIGNAGE WILL BE PROVIDED PER IAC SECTION 400.310 AND ADAAG 4.13 clear(ance) concrete masonry unit(s) column concrete construction continuous; continued contract(or) IRC tongue and groove top of curb testing and balancing telephone thick(ness) transformer FIRE ALARM & DETECTION FIRE SPRINKLERS coordinat corrugated coping ceramic tile KIT KSI KW kitchen kips per square inch kilowatt (s) THIS BUILDING DOES NOT REQUIRE AN AUTOMATIC SPRINKLER BYSTEM PER IBC 903. (A-3 ASSEMBLY OCCUPANCY IN A ONE I A MANUAL FIRE ALARM SYSTEM IS NOT REQUIRED IN THIS PROJECT: (GROUP A OCCUPANCY WITH A TOTAL OCCUPANT LOAD OF LESS THAN 300) countertop counter; center cubic cold water; concrete walk center of STORY BUILDING WITH LESS THAN 12,000 SF OF FIRE AREA AND HAS typical top of IN OCCUPANT LOAD OF LESS THAN 300 PEOPLE.) LB/LF LAM LAV LD LEED LF LG LL LT LV LVR L.P. . IF ANY SMOKE ALARMS ARE INSTALLED, UNITS MUST HAVE MAXIMUM EXIT ACCESS TRAVEL DISTANCE (WITHOUT SPRINKLERS) STROBE NOTIFICATION, HAVE PRIMARY AC POWER, BE INTERCONNECTED, AND BE LOCATED IN EACH ROOM WHERE DBL DET DF DIAG DIV DO DP DTL DWG leadership in energy & environmental design V VAR VAV VERT VEST VF VG VIF VIN VOL VSG volt; vertical voic, vertical variable oir volume vertical vestibule vinyl fabric vertical grain verify in field vinyl volume vinyl sheet good IF A CENTRAL ALARY SYSTEM IS PROVIDED, IT MUST MEET THE NATIONAL FIRE ALARY CODE, NFPA 12. direct current department detail diagenal diagenal direction division; divider dead load down door opening, ditto u.s. department of energy depth door double strength, downspoul detail detail devening detail devening detail devening detail devening detail devening detail devening d direct current maintenance west; width wide air network water claset; water column wood water heater window waterproof(ing) water, oil, gas (cold working pressure) water resistant weight **SIGNAGE** mechanical medium mechanical, electrical, plumbing mezzanine MECH MED MEP MEZZ MFD MFR MIN MISC MO MTL MRB MULT . OWNER OR THEIR SIGN PROVIDER MUST FILE SEPARATE SIGN PERMIT APPLICATION FOR SIGNS. ANY SIGNS INDICATED ON THESI DRAVINGS ARE PRELIMINARY ONLY. DO NOT BEGIN FABRICATION OF ANY SIGNS, SUPPORTS, ETC., UNTIL SIGN PERMITS HAVE BEEN 199UED. each elevation electric(al) elevator / elevation enclose; enclosure enlarged EA ELEC ELEV ENCL ENL EPA EPDM EQ EQUIV EST EWC EXTG 2. ISSUANCE OF A BUILDING PERMIT DOES NOT IMPLY ANY weight welded wire fabric with without APPROVAL OF SIGNS INDICATED HEREIN. 3. SIGNS ARE PROVIDED UNDER SEPARATE CONTRACT. COORDINATE ELECTRICAL NEEDS SUCH AS POWER AND DATA LINES OR LIGHTING WITH OWNER AND GENERAL CONTRACTOR. marble multi; multiply not ovailable; not applicable not in contract national fire protection asso-nominal number not to scale noise reduction coefficient 4. SUPPORTS INCLUDING COLUMNS, WALLS, AND FOUNDATIONS FOR FREESTANDING SIGNS MUST MEET APPLICABLE BUILDING CODE RECUIREMENTS INCLUDING SEISHIC PERFORMANCE. SIGN CONTRACTOR IS RESPONSIBLE FOR THOSE DRAWINGS AND OR CALCULATIONS. estimated electric water cooler existing SYMBOL LIST THE DRAWINGS IN THIS SET BEARING MY STAMP WERE PREPARED BY ME AND UNDER MY DIRECT SUPERVISION. TO THE SCOPE DOCUMENTS TILE These drawings indicate the general scope of the project in terms of architectural design concept, the dimensions of the building, the type of structural, mechanical, electrical, and utili systems, and an outline of major architectural elements of BEST OF MY KNOWLEDGE, THE DESIGN LUSTRATED HEREIN COMPLIES WITH APPLICABLE CODES AND REGULATIONS. construction. As "scope" documents, these drawings do not necessarily indicate or describe all work required for the full performance and completion of the work. Contracts will be le on the basis of such documents with the understanding that MICHAEL J. SCHNEIDER the Contractor, Subcontractors, and Material Suppliers are to furnish all items required for proper completion of the work without adjustment to the contract or subcontract price. It i intended that the work be of sound and quality construction /001-013566 / 5 see note 5, same sheet and the Contractor, Subcontractors, and Material Suppliers sha be solely responsible for the inclusion of adequate amounts to SECTION KEY ELEVATION KEY WALL TYPE INTERIOR ELEVATIONS KEY NOTE cover installation of all items indicated, described, or implied ILLINOIS LICENSED ARCHITECT #001-013566 EXPIRES 11.30.10

⟨wi⟩ ~

Chester Welcome Center

Elzie C. Segar Memorial Park Chester, Illinois 62233

GENERAL NOTES

NO GENERAL NOTES ON THIS SHE

IDOT Submittal description

ARCHITECTURAL LEGEND SHEET

CHESTER

WELCOME

CENTER

Chester, Illinois

INDEX OF DRAWINGS


- A0.1 ARCHITECTURAL LEGEND SHEET
- A1.1 ARCHITECTURAL SITE PLAN & NOTES
- ARCHITECTURAL FIRST FLOOR PLA & PARTITION TYPES
- A2.3 ROOF PLAN & NOTES
- A3.1 REFLECTED CEILING PLAN
- A4.1 BUILDING ELEVATIONS & SECTION
- A4.2 BUILDING ELEVATIONS
- A5.1 EXTERIOR WALL SECTIONS & DETAILS
- DOOR & WINDOW TYPES SCHEDULES & DETAILS
- A7.1 INTERIOR ELEVATIONS
- M1.1 MECHANICAL PLAN & NOTES
- E1.1 POWER & COMMUNICATIONS PLAN & NOTES
- F2.1 LIGHTING PLAN & NOTES
- P1.1 PLUMBING PLAN & NOTES
- S1 STRUCTURAL NOTES AND SPECIFICATIONS
- S2 FOUNDATION PLAN
- S3 ROOF FRAMING PLAN AND SHEAR WALL PLAN
- S4 WALL DETAILS
- S5 FRAMING DETAILS
- S6 SHEAR WALL DETAILS
- S7 SHEAR WALL SCHEDULE
- S8 DECK FRAMING PLAN
- S9 DECK FRAMING PLAN DETAILS


QUADRANT design architects & planner:

135 south main street waterloo, illinois 62298 phone 618.939.0606

20525 drawn by checked by

A0.1

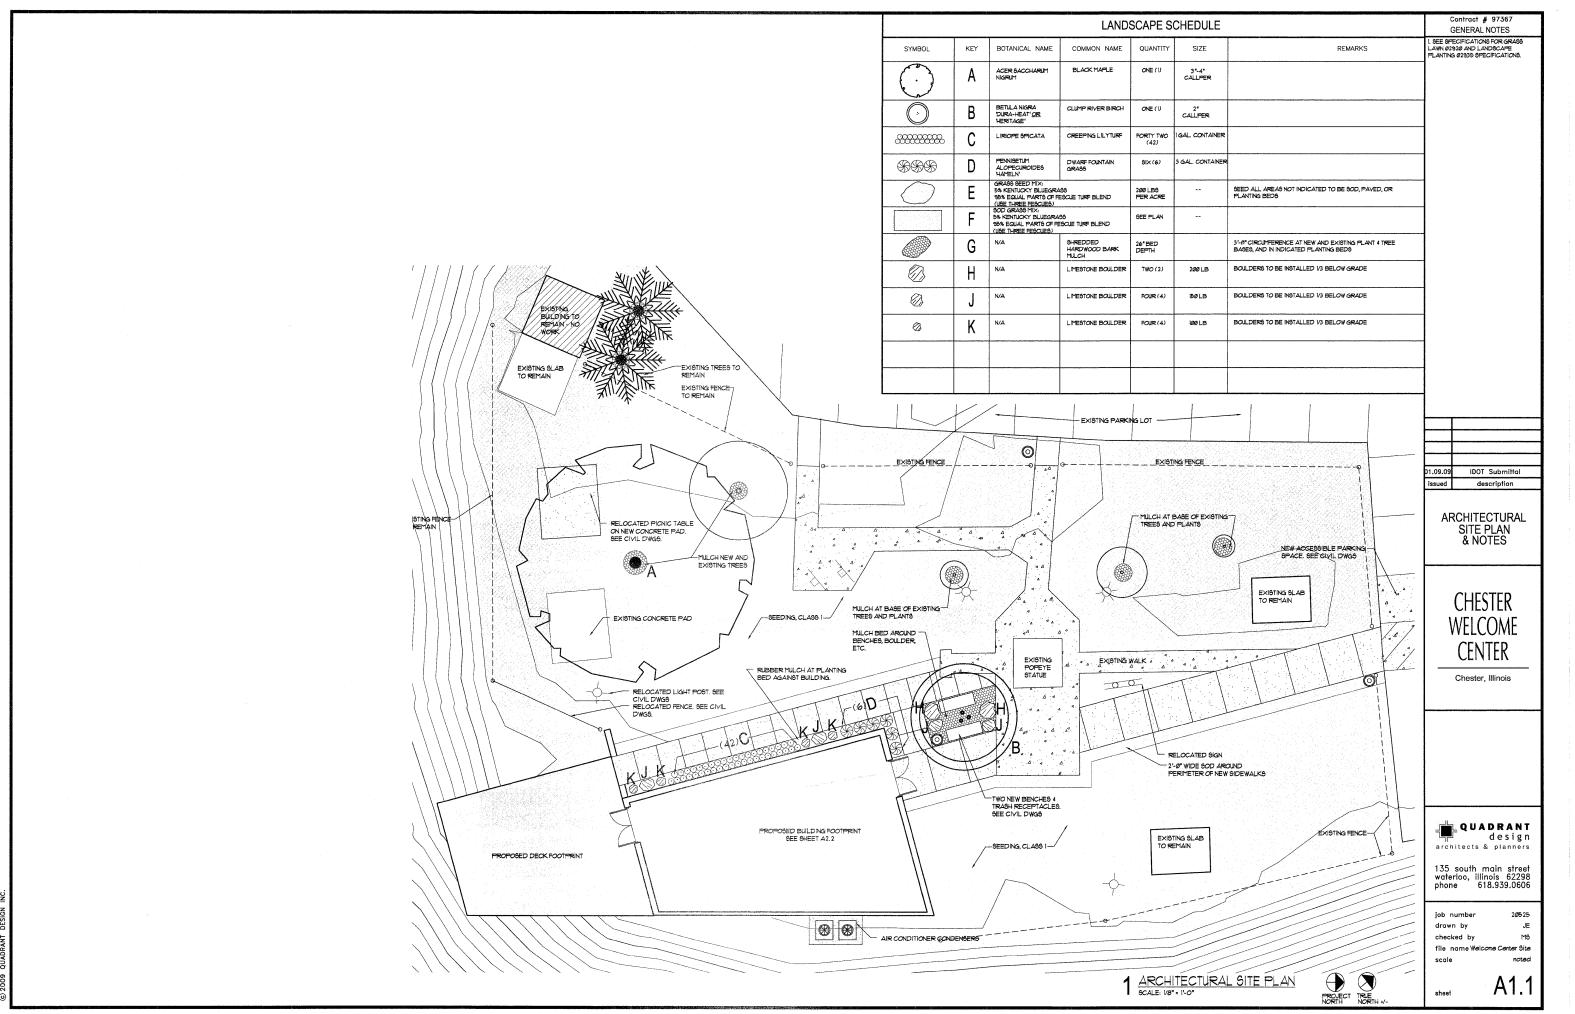

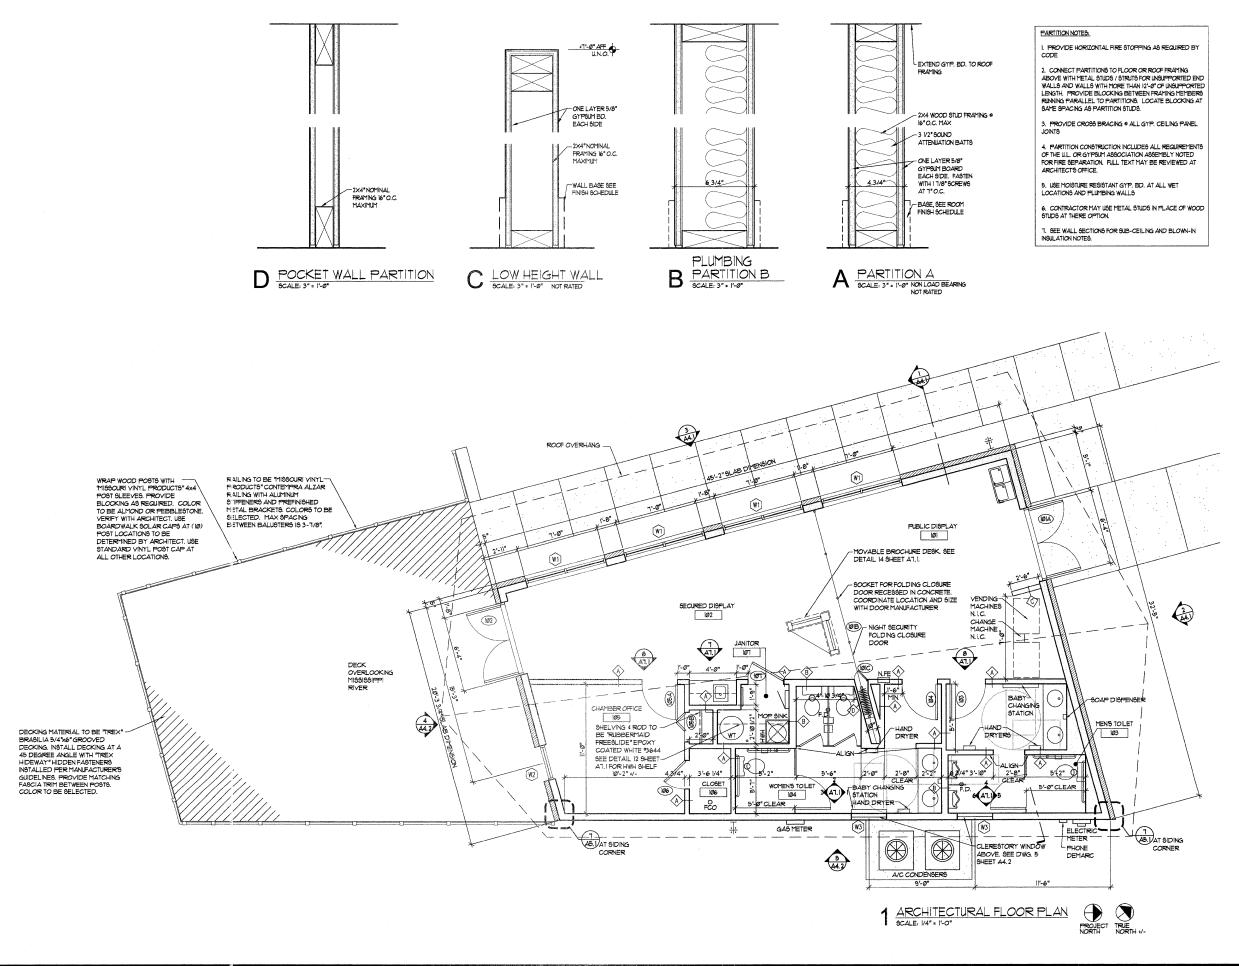

Contract # 97367 GENERAL NOTES

PROVIDE BLOCKING IN CLOSET ALLS FOR INSTALLATION OF ADJUSTABLE SHELVING AND BY AND ARDS FROM FLOOR TO 8'-0" AFF. PROVIDE ACCESSIBLE COAT ROD AND SHELVING IN EACH CLOSET.

3. ALL INTERIOR DIMENSIONS ARE T FACE OF GYP. BD. UNLESS NOTED THERWISE.

4. ALL BATHROOMS OR TOILET ROOMS TO HAVE BLOCKING INSIDE WALLS TO SUPPORT GRAB BARS CURRENT OR FUTURE) AND ACCESSORIES.

5. THE HEIGHT OF TABLES OR COUNTER TOPS SHALL BE FROM 28' TO 34" IN HEIGHT ABOVE THE FINISH 10 34 IN REIGHT ABOVE THE FINISH FLOOR IF SEATING IS PROVIDED AT TABLES OR COUNTERS, KNEE SPACE AT LEAST 27" HIGH, 30" WIDE AND IS DEEP SHALL BE PROVIDED.

FIRE EXTINGUISHERS SHOWN ON DE TIRE EXTINGUIDHERD SHOWN ON PLAN ARE MINIMUM. VERIFY EXACT NUMBER AND LOCATION PER APPLICABLE CODES.

LEGEND

NEW CONSTRUCTION

N.FE. 1022-B-16-VW'
9EMI-RECE99ED CABINET V
13010 FIRE EXTINGUISHER

01.09.09 IDOT Submittal issued description

> ARCHITECTURAL FLOOR PLAN & PARTITION TYPES

> > **CHESTER** WELCOME CENTER

Chester, Illinois

QUADRANT


design architects & planners


135 south main street waterloo, illinois 62298 phone 618.939.0606


20525 iob number drawn by checked by

scale


MS

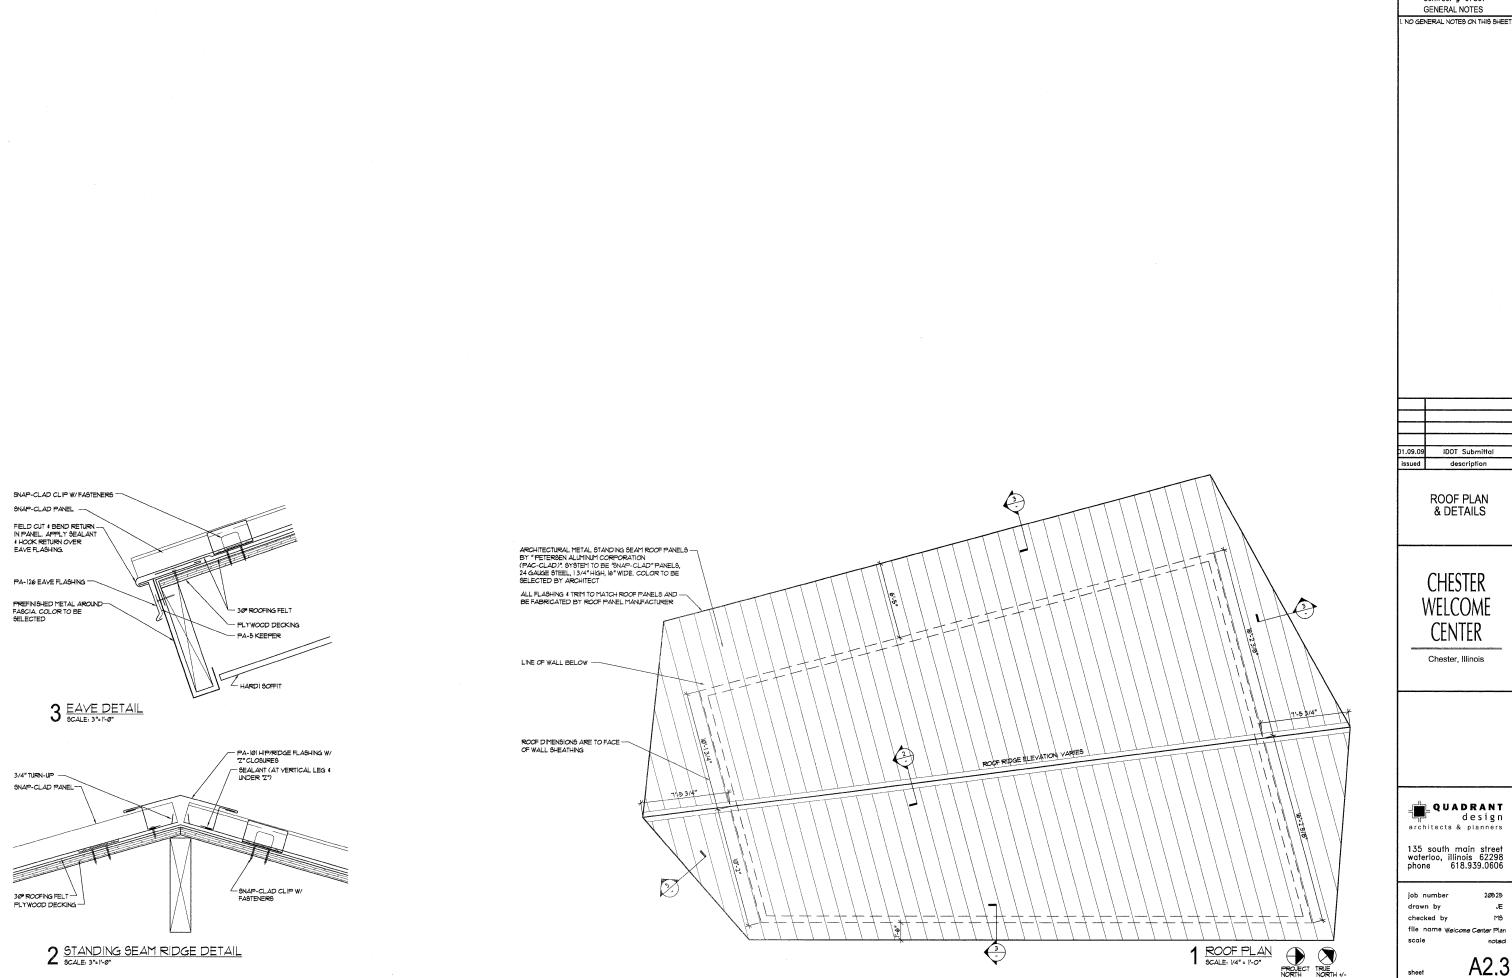

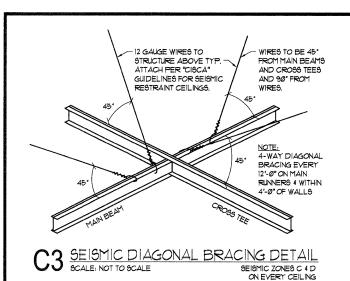


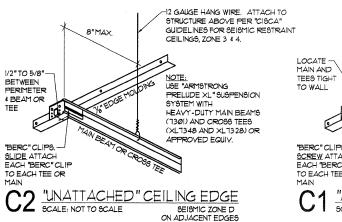


OF EVERY CEILING

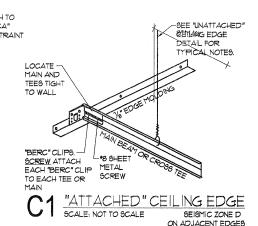

OF EVERY CEILING

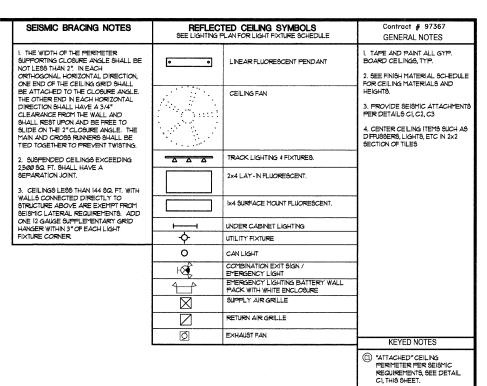

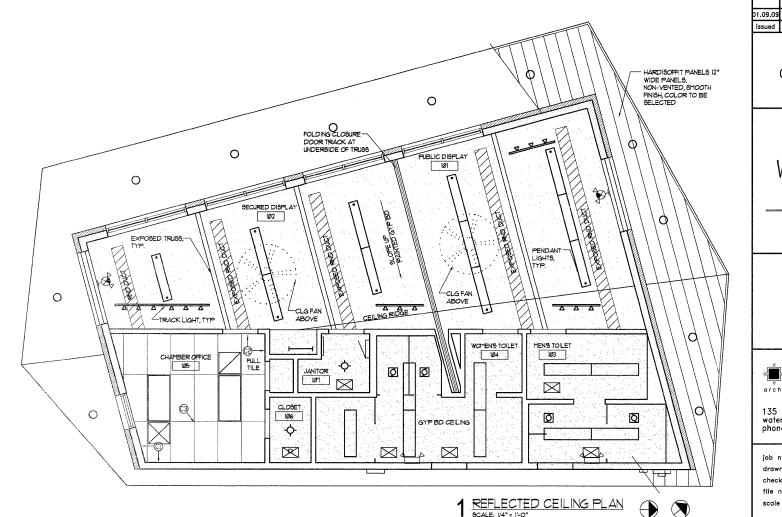

CHESTER WELCOME **CENTER**

(2) "UNATTACHED" CEILING PERIMETER PER SEISMIC REGUIREMENTS. SEE DETAIL C2, THIS SHEET.

IDOT Submittal

description

REFLECTED

CEILING PLAN

Chester, Illinois

QUADRANT design architects & planners

135 south main street waterloo, illinois 62298 phone 618.939.0606

job number drawn by checked by

scale

sheet

PROJECT NORTH

TRUE NORTH +/


file name Welcome Center Plan noted


20525

JΕ

MS

A3.1

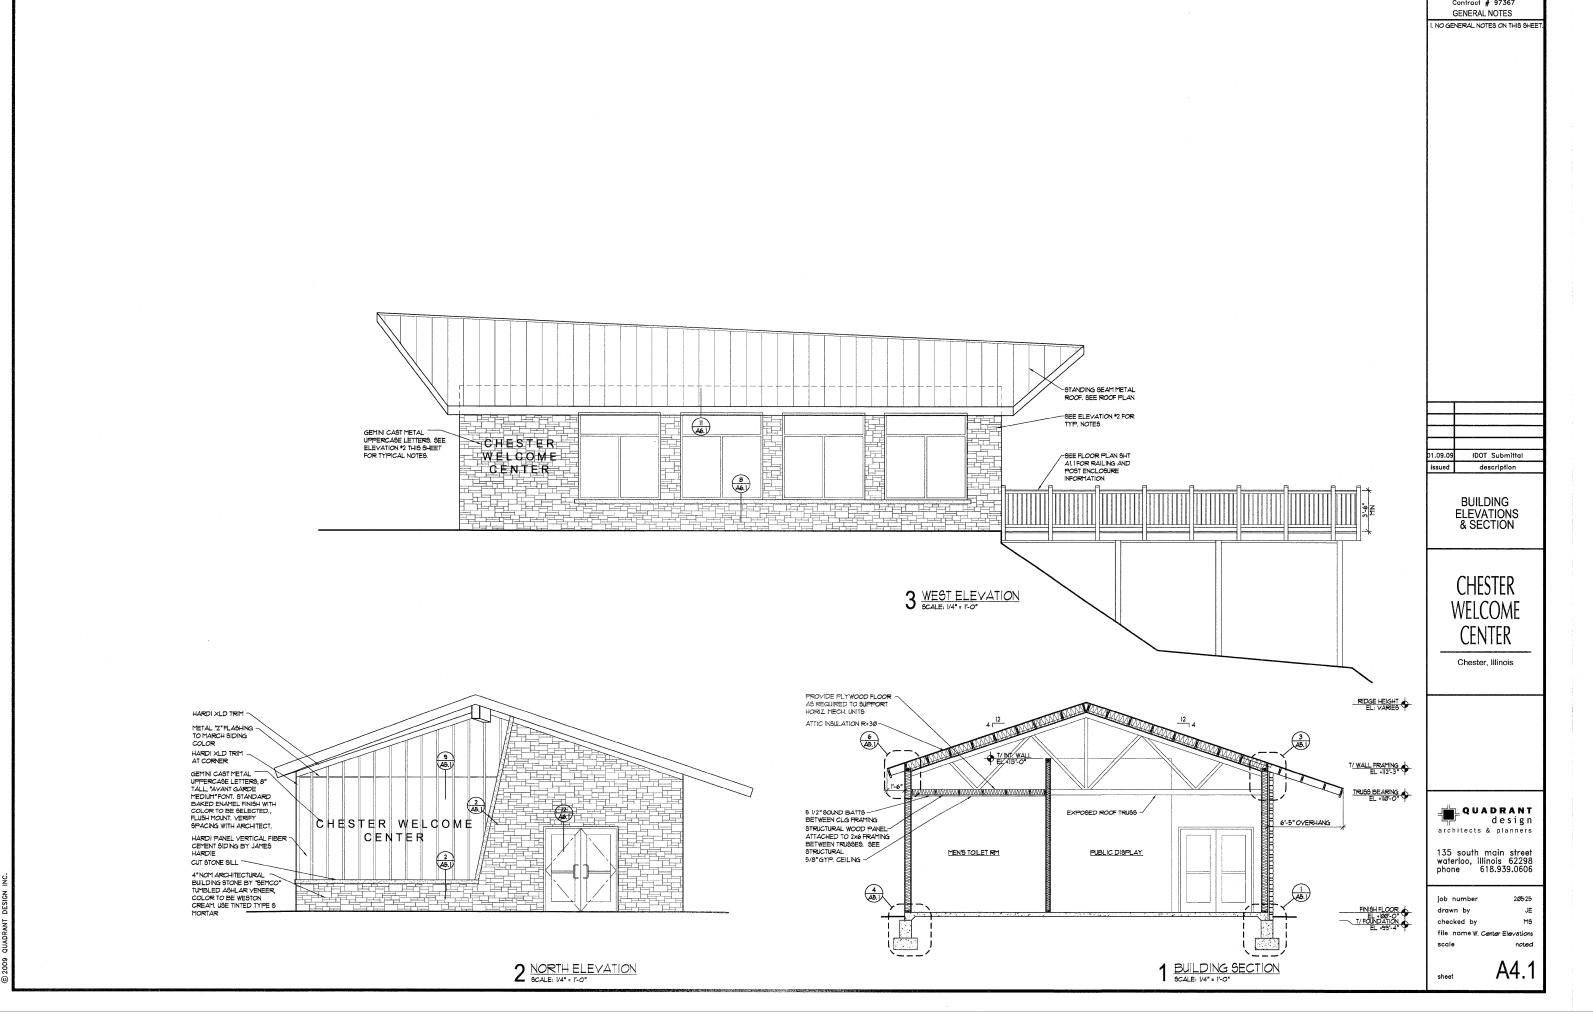


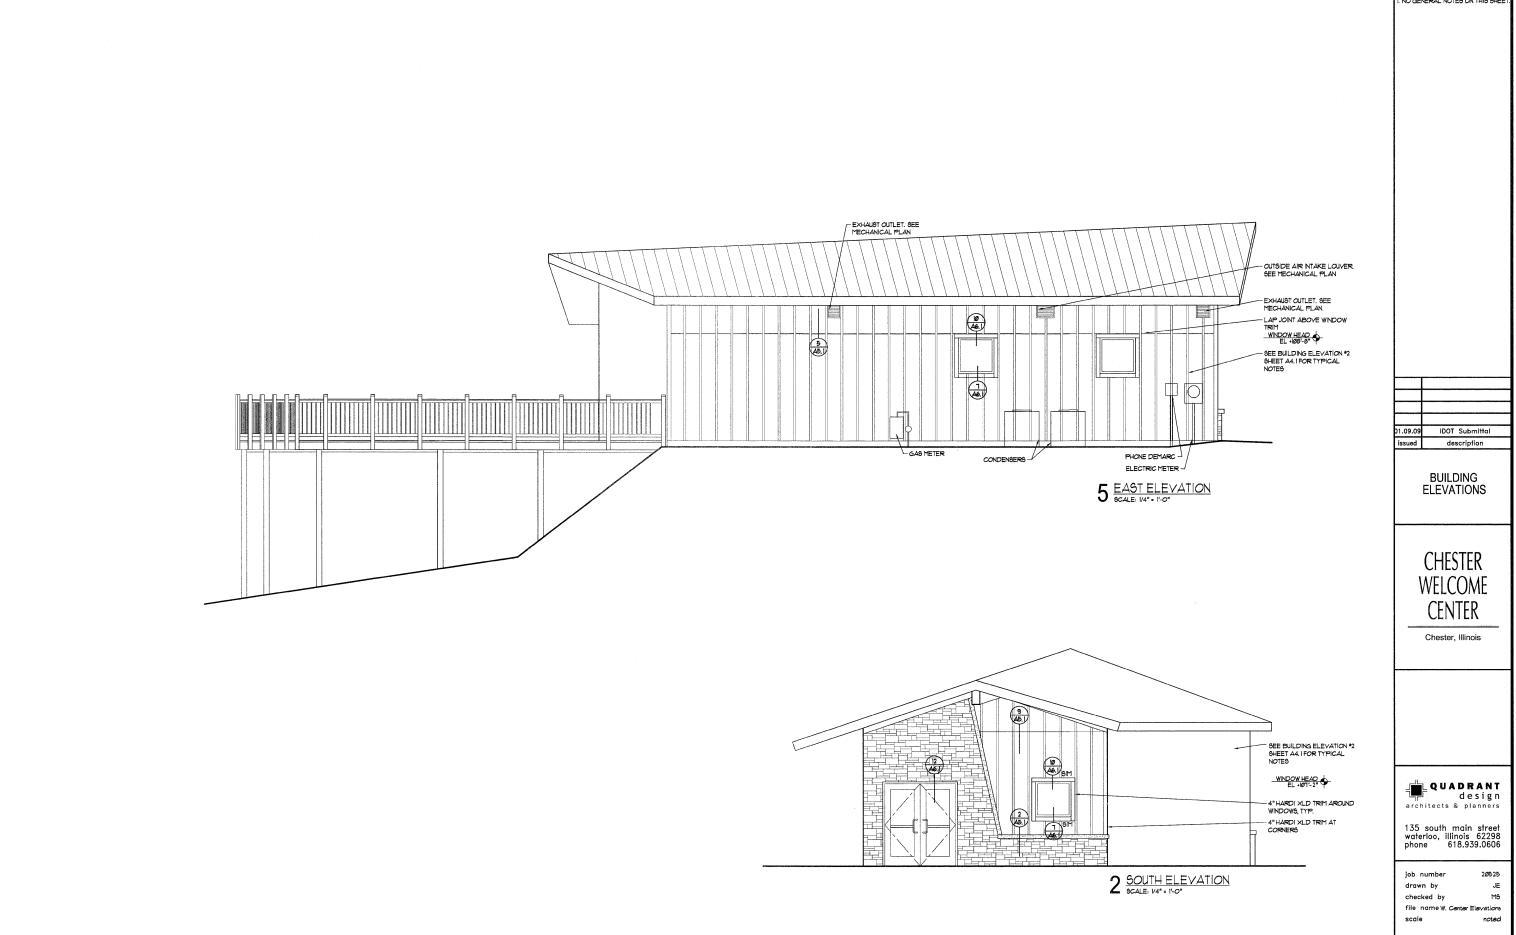


Contract # 97367 GENERAL NOTES


I. NO GENERAL NOTES ON THIS SHEET


heet A4.2

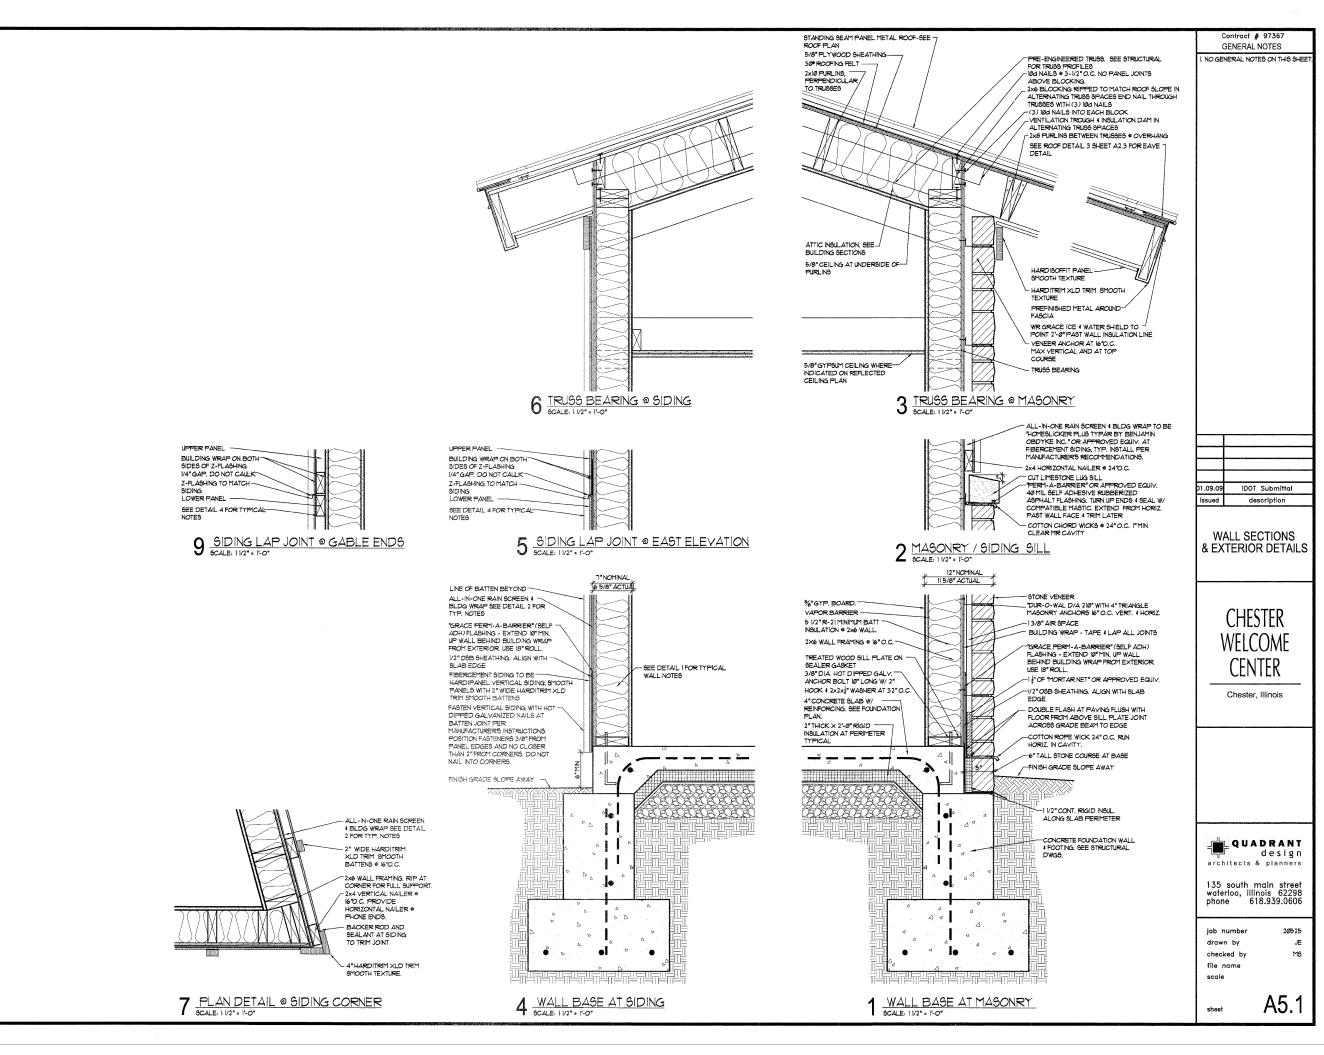

ON NOISES INTESTIC SOC

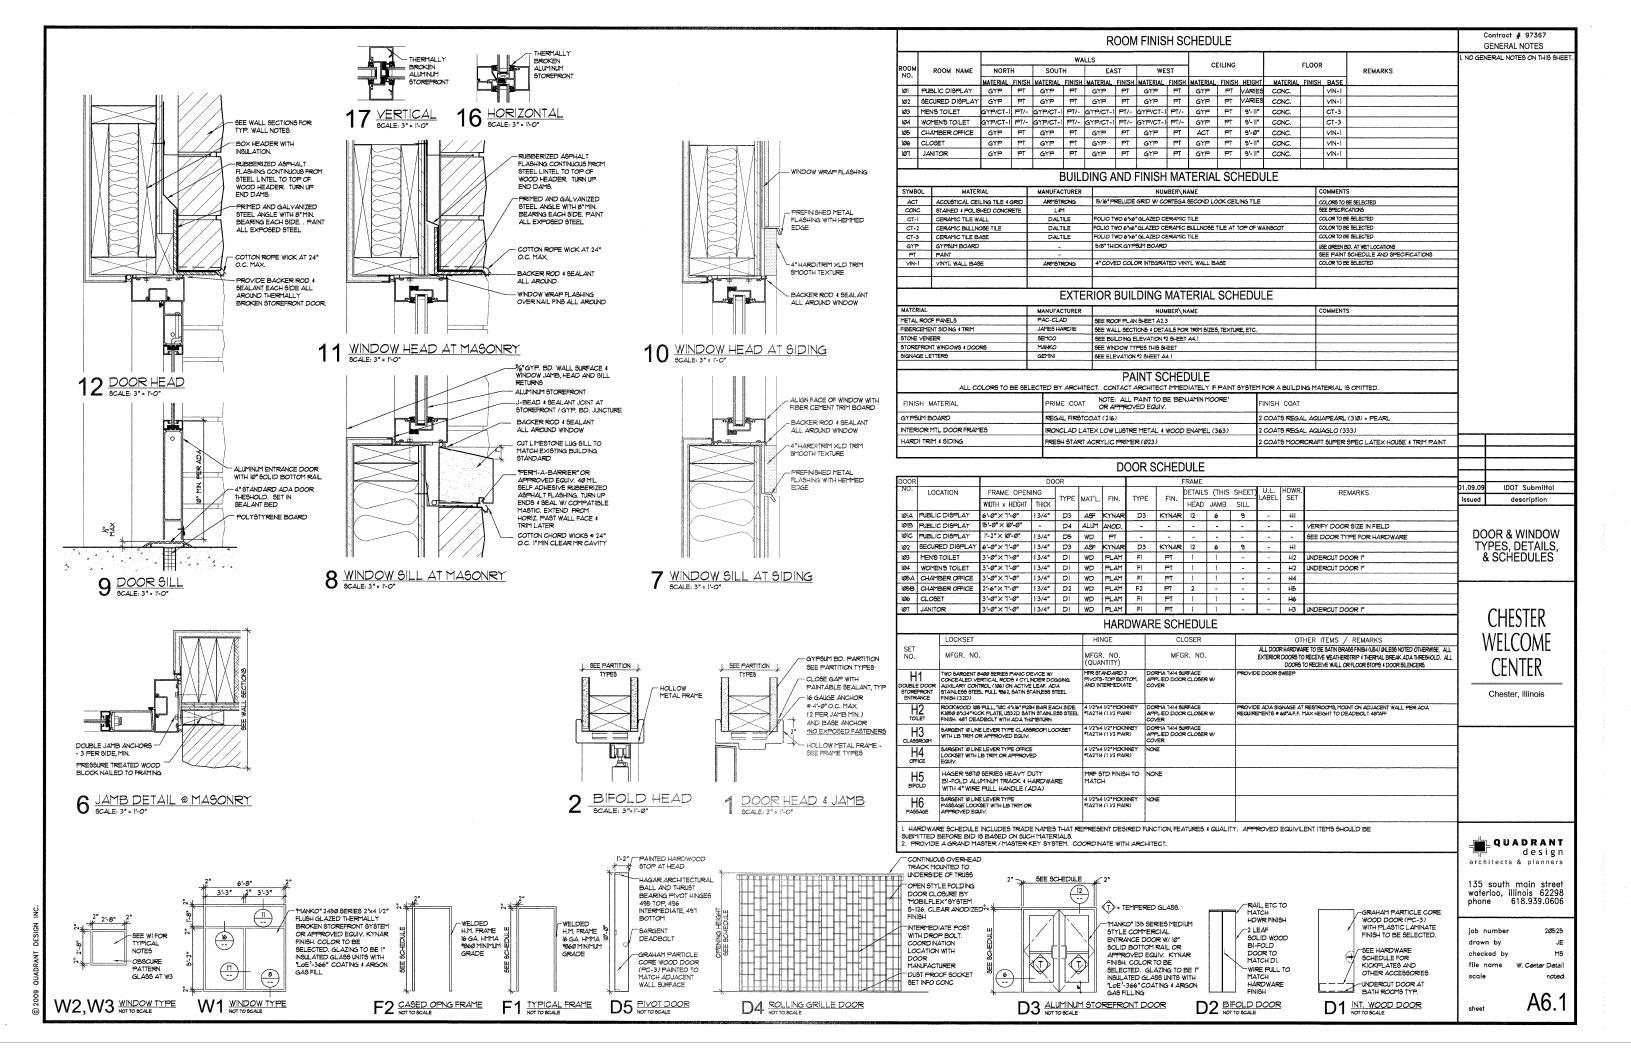

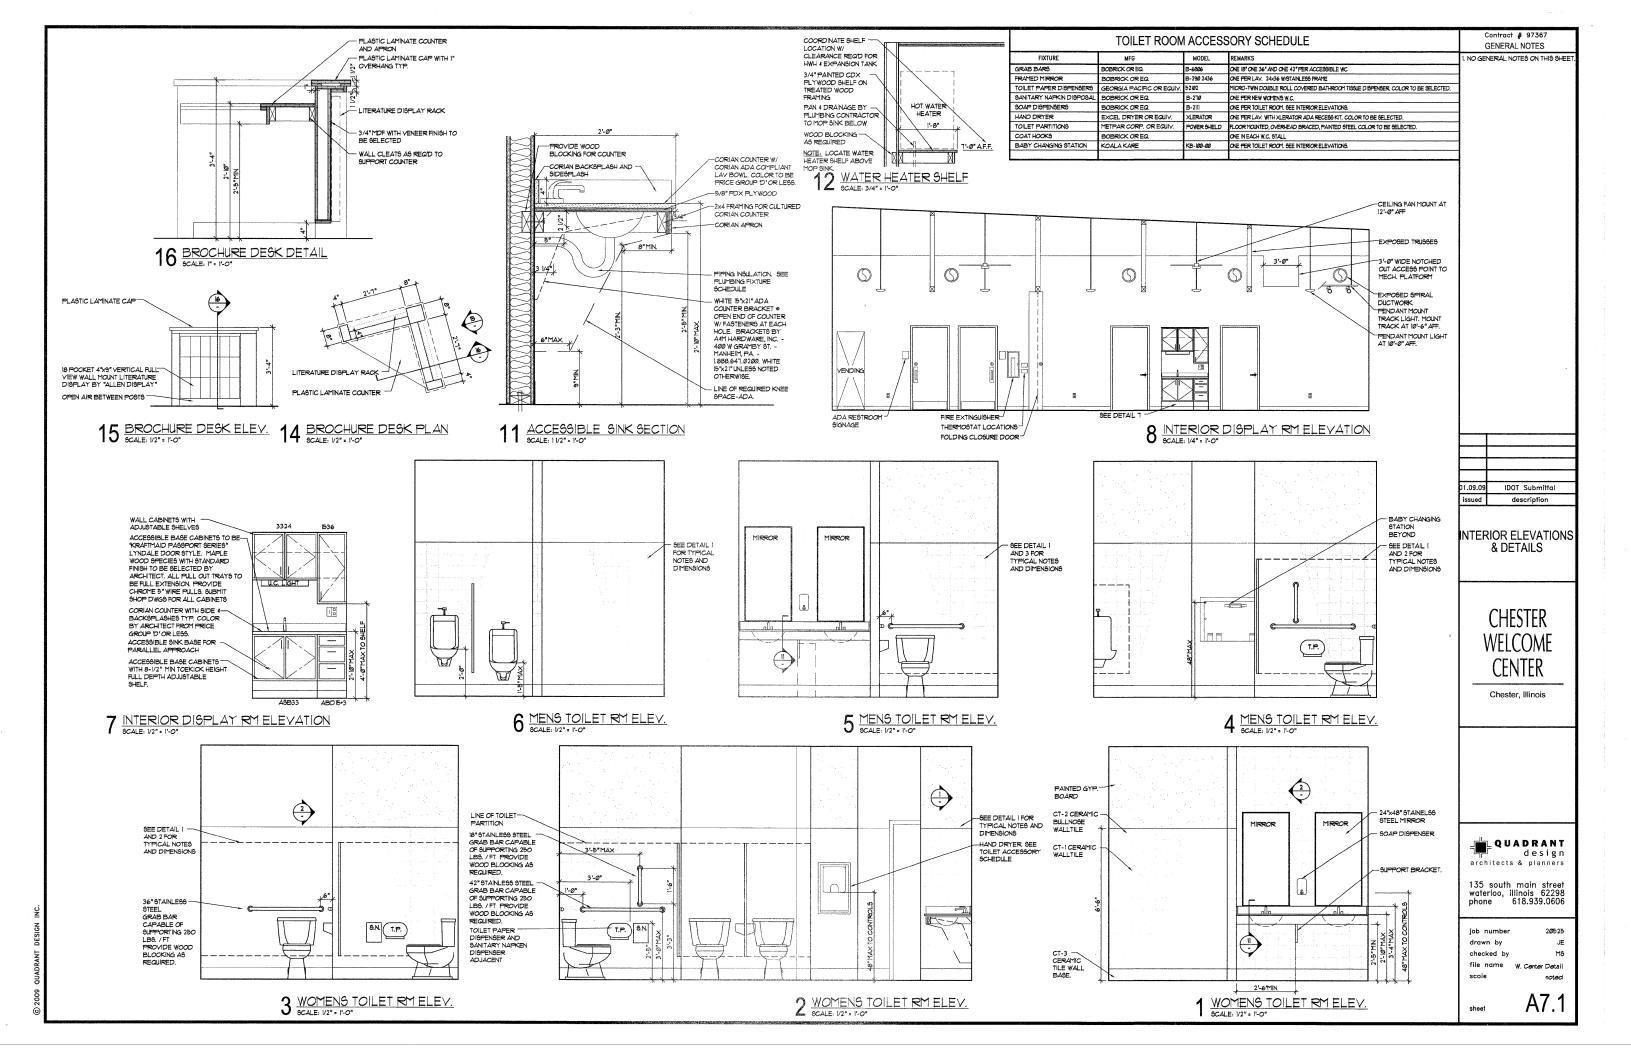

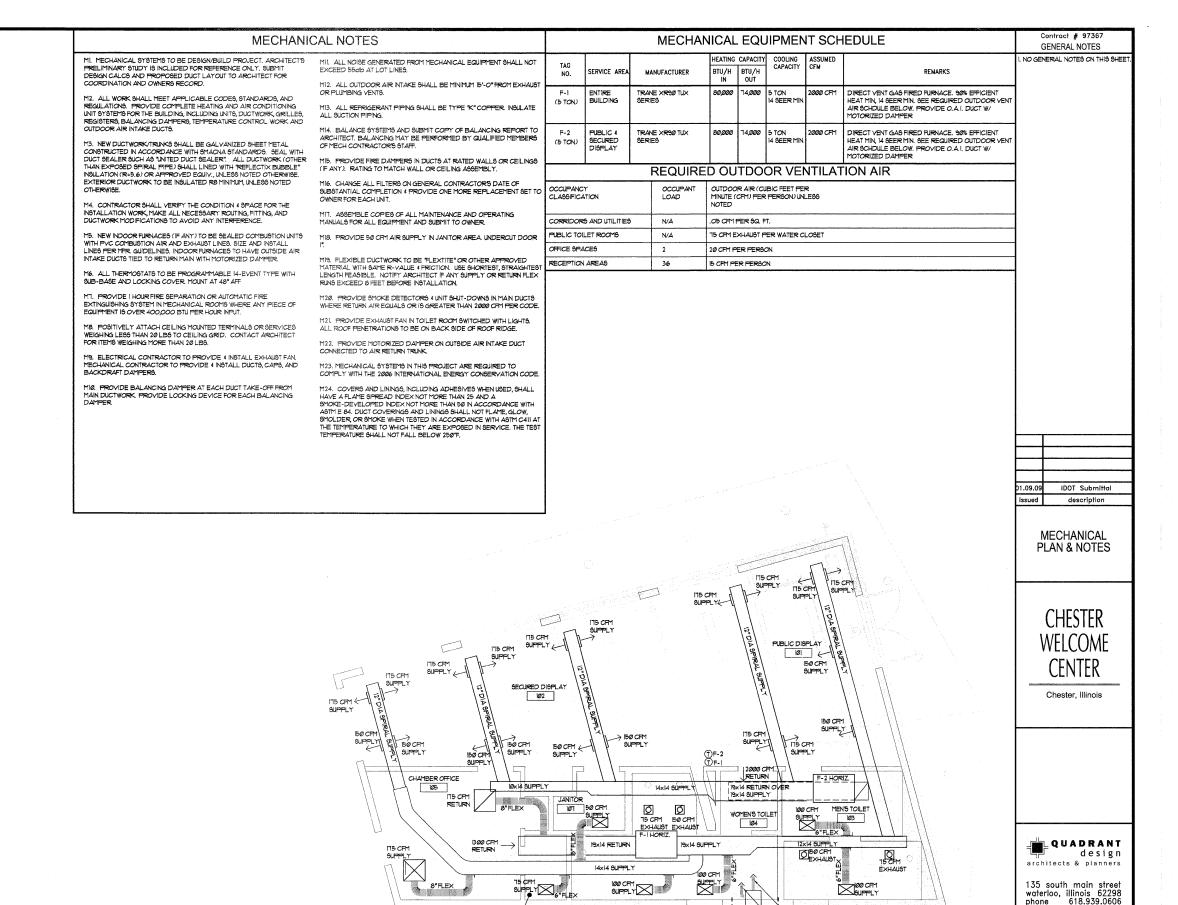

CLOSET

EXHAUST FAN WALL JACK FOR

FANS, LOCATE 15'-0"MIN FROM OA

WOMEN'S TOILET 104 WITH BACKDRAFT DAMPER USE RIGID DUCTWORK TO GAS METER

HANDI FRS

COPPER LINES TO CONDENSER-RUN UP THROUGH WALL TO MECH. PLATFORM AND THEN TO AIR

16x12 LOUVER WITH INSECT SCREEN

NOTE: RUN PVC COMBUSTION AIR FOR F-1 AND F-2 THRU

SIDEWALL ADJACENT TO

MECHANICAL PLAN
9CALE: 1/4" = 1'-0"
PROJECT TRUE
NORTH NORTH 4/-

10" O.A.I. FLEX, 435 EXHAUST FAN WALL JACK FOR

FURNACE RETURN

7" O.A.I. FLEX, 165


FURNACE RETURN

MENS TOILET 103 WITH BACKDRAFT DAMPER USE RIGID DUCTOWERK TO FANS.


LOCATE 15'-0" MIN FROM OA

job number 20525 drawn by JE checked by M3 file name

M1.1

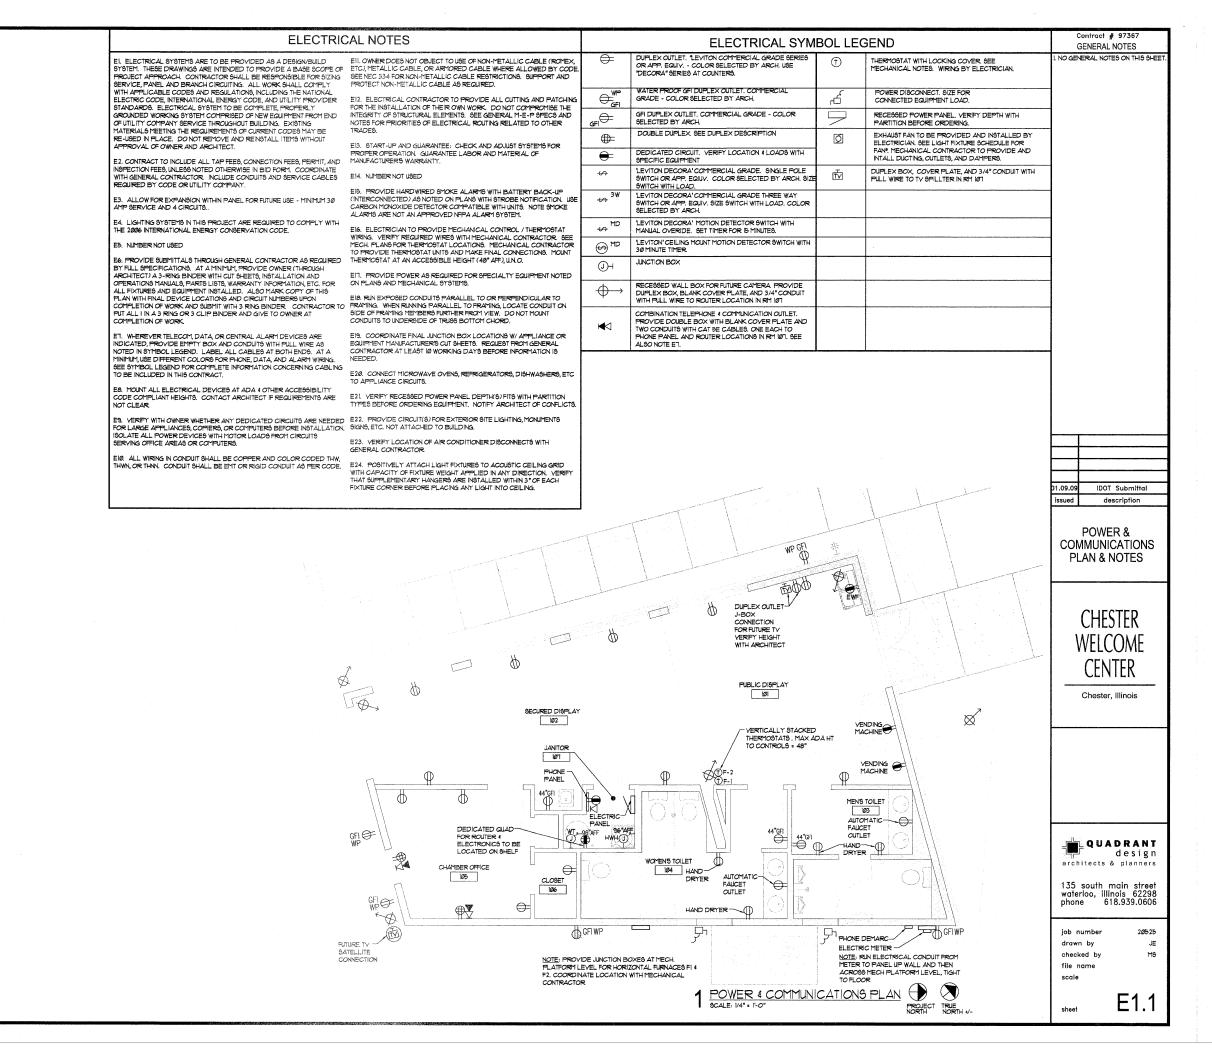

			HT FIXTURE S		RING FIXTURES. TYPICAL	NOTE: 9EE ELECTRICAL 9YMBOL LEGEND FOR LIGHT 9WITCH INFO		Contract # 97367 SENERAL NOTES
YPE	SYMBOL	DESCRIPTION	MANUFACTURER	CATALOG NUMBER	LAMPS	REMARKS	I. NO GE	NERAL NOTES ON THIS SH
A	A	2x4 RECESSED INDIRECT LAY-IN	HUBBELL LIGHTING- COLUMBIA LIGHTING		ELECTRONIC BALLAST (2) 28W T5 LAMPS			
В	В	LINEAR HIGH ABUSE FLUORESCENT SURFACE MOUNT	KENALL-MILLENIUM STRETCH	MLHA126 SERIES	ELECTRONIC BALLAST (2) 28W T5 LAMPS	ROUNDED END CAPS, MATTE WHITE HOUSING FINISH, CLEAR POLYCARBONATE LENS. SEE LIGHTING PLAN FOR ROW LENGTHS		
С	• • • c	LINEAR FLUORESCENT PENDANT	HUBBELL LIGHTING- ALERA LIGHTING	CURY (CV)	ELECTRONIC BALLAST (2) 28W 15 LAMPS	PERFORATED HOUSING, SCE'SHALLOW CURV END CAP, ADJUSTABLE CABLE MOUNT AT EACH END OF ROW. ELETRONIC BALLAST, LIGHT GREY FINISH RAL 1835! SEE LIGHTING PLAN FOR ROW LENGTHS		
D		TRACK LIGHTING	HUBBELL LIGHTING- PRESCOLITE ARCHITRAK	AKTGP38	40 W PAR 38 FRONT LOADING, WHITE FINISH	SEE PLAN FOR TRACK LENGTH, WHITE FINISH, PROVIDE 10 ADDITIONAL TRACK HEADS FOR "ATTIC" STOCK		
Ε	- \$ _E	UTILITY FIXTURE	KICHLER	8102Ni	(2) 13 W A19 BASE FLUORESCENT			
F	├ ─ ─ -	UNDER CABINET LIGHTING	KICHLER	XENON 1058199	(3) LIGHT9, 21.5"			
G	6	PENDANT CEILING FAN	HUNTER	THE ALLEGRO 28412	NO LAMPS	ADJUSTABLE PENDANT MOUNT, 52", WHITE HOUSING, ALL FAN 3 SPEED DIAL FAN CONTROL		
Н	O _H	EXTERIOR SLOPED CEILING DOWNLIGHT	HUBBELL LIGHTING- PRESCOLITE	9CIBX8	20 W AI9 BASE FLUORESCENT	8" TRIM TO BE OPEN 9LOPED 9PECULAR CLEAR ALZAK REFLECTOR 19686"		
	⊗	CEILING MOUNTED EXIT SIGN	HUBBELL LIGHTING- PRESCOLITE	PLED9	L.E.D. RED	EXIT SIGN WITH WHITE PLASTIC ENCLOSURE WITH RED LED LIGHTS.		
	ŀæţ	COMBINATION EXIT SIGN / EMERGENCY LIGHT	HUBBELL LIGHTING- PRE9COLITE	PEXHL-3-R-EC	L.E.D. RED EXIT & ADJUSTABLE 5.4 WATT INCANDESCENT LAMPHEADS	MOUNT AT 1'-6" AFF UNLESS NOTED OTHERWISE WHITE HOUSING FINISH		
F-!	Ø	EXHAUST FAN	BROAN- ULTRA SILENT SERIES	QXTEØ8Ø	N/A	80 CFM, .3 SONES, 6" DUCTING. SEE NOTE MS SHEET MI.)		
F-2	Ø	EXHAUST FAN	BROAN- ULTRA SILENT SERIES	QXTE IBØ	NA	150 CPM, 1.4 SONES, 6" DUCTING. SEE NOTE MS SHEET MI.1		
-	1	EMERGENCY LIGHTING BATTERY WALL PACK WITH WHITE ENCLOSURE	HUBBELL LIGHTING- PRESCOLITE	ELB4	1.2 W STANDARD INCANDESCENT LAMPS WITH REMOTE CAPABILITY, 6 OUTPUT BOLTS	BATTERY PACK TO MATCH EXIT SIGN		
CAPI	TAL LETTERS ADJACENT	TO SYMBOLS INDICATE FIXTURE TYPE	. NUMBERS ADJACENT	TO SYMBOLS INDICAT	E CIRCUIT NUMBER			· · · · · · · · · · · · · · · · · · ·
						·		

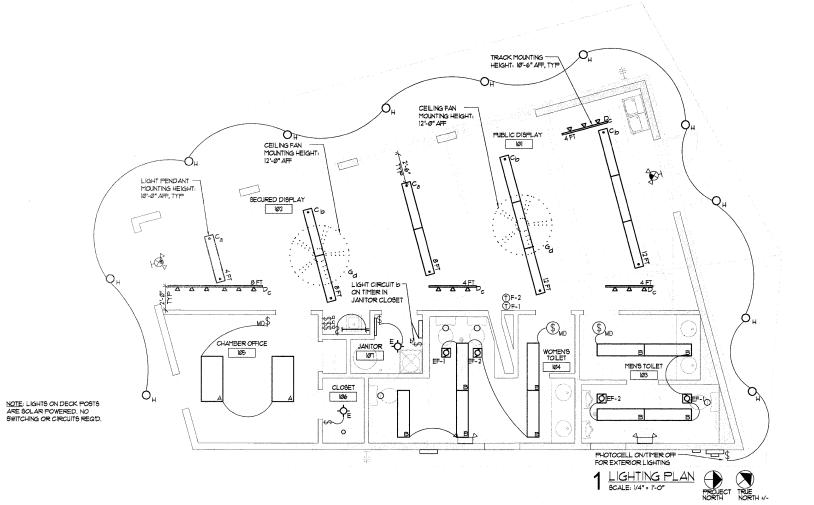

LIGHTING PLAN & NOTES

issued description

CHESTER WELCOME CENTER

Chester, Illinois

QUADRANT design architects & planners

135 south main street waterloo, illinois 62298 phone 618.939.0606

drawn by checked by


file name scale

E2.1

PLUMBING NOTES

- PI. THESE DRAWINGS ARE SCOPE DOCUMENTS. PILIMBING CONTRACTOR SHALL PROVIDE A COMPLETE, CODE-COMPLIANT SYSTEM WITH ALL MATERIALS, LABOR, FITTINGS, AND TRIM. REVIEW DRAWINGS AND NOTIFY ARCHITECT IMMEDIATELY OF AREAS OF CONCERN OR CORFLICT. WHERE OWNER-SUPPLIED FIXTURES ARE NOTED (IF ANY), CONTRACTOR SHALL PROVIDE ALL NECESSARY PIPING CONNECTIONS INCLUDING TAIL PIECES AND TRAPS. UNLESS NOTED OTHERWISE, NEW FILMING FIXTURES INCLUDING WATER HEATER, ARE PROVIDED BY THE CONTRACTOR.
- P2. CONTRACTOR SHALL YERIFY THE CONDITION AND SPACE FOR THE INSTALLATION OF WORK. MAKE ALL NECESSARY ROUTING, FITTING, AND CONNECTIONS AS REGUIRED FOR A COMPLETE SYSTEM.
- P3. THIS BUILDING, LESS THAN 5,000 SQ. FEET IS NOT REQUIRED TO HAVE A DRINKING FOUNTAIN PER IPC *890.810-b2AI. IF THE OWNER REQUESTS A DRINKING FOUNTAIN, IT MUST BE PHYSICALLY ACCESSIBLE
- P4. THE DRINKING FOUNTAIN MUST BE A HIGH/LOW ACCESSIBLE UNIT.
- P5. ALL PLUMBING WORK TO CONFORM TO APPLICABLE CODES AND REGULATIONS INCLUDING, BUT NOT LIMITED TO THE ILLINOIS PLUMBING CODE AND THE ILLINOIS ACCESSIBILITY CODE.
- P6. WATER SUPPLY AND SEWER SYSTEMS ARE PROVIDED BY AND INSTALLATIONS MUST CONFORM WITH THEIR REGULATIONS AND STANDARD PROCEDURES.
- PT. PROVIDE COMPLETE NEW DOMESTIC WATER DISTRIBUTION SYSTEM NSIDE BUILDING NOLLIDING HOT WATER PIPING, COLD WATER PIPING, DOMESTIC HOT WATER HEATER, INSULATION, AND ALL NECESSARY SHOTE YALVES. ANY UNDERGROUND WATER SERVICE PIPE SHALL BE TYPE "COMPER PER ALL APPLICABLE CODES.
- P8. PROVIDE DIELECTRIC FITTING AND SEPARATION BETWEEN TWO DISSIMILAR METALS.
- P9. PROVIDE SHUT-OFF VALVES TO FACILITATE CONTINUED OCCUPANCY OF THE INDEPENDENT OF PROJECT AREA.
- PIØ. ALL BRANCH PIPING SHUT-OFF VALVES TO BE 125 LB. BALL TYPE.
- PII. ALL HOT AND COLD WATER LINES TO BE TYPE K (UNDERGROUND) AND TYPE L (EXPOSED) COIPPER WITH LEAD FREE SWEATED FITTINGS, REMOVE ALL (IF ANY) LEAD WATER LINES AND REMOVE ALL EXPOSED OR ACCESSIBLE GALVANIZED WATER SUPPLY LINES.
- PI2. ROD EXISTING SEWER LINES TO STREET BEFORE ADDING TO OR REVISING THE SYSTEM. PROVIDE A CLEAN-OUT AT THE BASE OF THE VERTICAL STACK IF ONE DOES NOT EXIST.
- PI3. PROVIDE ANTI-SCALD PROTECTION ON ALL FAUCETS.
- PI4. PROVIDE AT LEAST ONE MAIN VENT STACK EXTENDING THROUGH ROOF. ROD EXISTING IF NECESSARY TO CREATE PROPERLY FUNCTIONING SYSTEM.
- PIB. PROVIDE STAINLESS STEEL GRAB BARS AND FRAMED MIRROR IN EACH TOILET ROOM, INSTALLED PER ILLINOIS ACCESSIBILITY CODE AND ANSI AITT. 1.
- FIG. TOILETS TO BE ACCESSIBLE WITH OPEN FRONT GEATS.
 LAVATORY FAUCETS TO BE ACCESSIBLE WITH PROINTED ON WALL.
 HUNG LAVATORIES, MOINTED AT ACCESSIBLE HEIGHT. INSULATE WASTE
 AND SUPPLY LINES BENEATH LAV TO PROTECT LEGS FROM SCALDS OR
 CUTS WITH "FILEPERO" WINTED OR EQUIAL.
- PIT. INSULATE ALL HOT WATER LINES AND HORIZONTAL COLD WATER LINES WITH 1/2" THICK INSULATION. LOCATE ALL WATER LINES WITHIN THE TEMPERED SACES OF THE BUILDING. DO NOT RUN WATER LINES ABOVE THE BUILDING NIGULATION LEVEL.
- PIB. PROVIDE BACKFLOW PREVENTERS, AIR CHAMBERS, AIR GAPS, ETC. AS REQUIRED BY ILLINOIS PLUMBING CODE AND AS INDICATED ON THE DRAWINGS.
- P19. ALL GAS PIPING TO BE 9CHEDULE 40 BLACK STEEL PIPE WITH MINIMUM OF 12 PSIG FITTING. PROVIDE A SHUT-OFF WITHIN 42" OF EACH APPLIANCE.
- P28. TESTING AND GUARANTEE: CONTRACTOR SHALL START-UP, CHECK, AND ADJUST SYSTEMS FOR PROPER OFFERATION. TESTING SHALL BE PERFORMED BEFORE APPLYING INSULATION. FLUSH AND/OR STERILIZE WATER PIPING AS REQUIRED BY LOCAL CODE. CONTRACTOR TO GUIRANTEE THEIR WORK (BOTH LABOR AND MATERIALS) TO BE FREE OF DEFECTS FOR ONE YEAR.
- P21. CONTRACTOR TO PUT ALL BOOKLETS, OPERATION INSTRUCTIONS, WARRANTY INFO, PAIRTS, DIAGRAMS, ETC., IN ONE 3 RING BINDER OR 3 CLIP FOLDER AND GIVE TO OWNER AT COMPLETION OF WORK.
- P22. CONTRACTOR TO PROVIDE ALL TOILETS, SINKS, AND OTHER SCHEDULED PLUMBING FIXTURES NOT SPECIFICALLY LABLED AS PROVIDED BY OTHERS. CONTRACTOR TO PROVIDE ALL TRIM, SHUTOPPS, ETC UNLESS SPECIFICALLY NOTED AS PROVIDED BY OTHERS
- P23. PROVIDE ALL NECESSARY PIPING CONNECTIONS TO THE OWNER FURNISHED FIXTURES OR EQUIPMENT, INCLUDING ALL TAIL PIECES AND TRAPS.
- P24. METAL ROOF PAN LAYOUT TAKES PRECEDENT OVER PLUMBING VENT LOCATION. COORDINATE ROOF PENETRATION WITH ROOFING CONTRACTOR
- P25. PROVIDE WATER CLOSETS WITH FLUSH LEVER ON THE OPEN SIDE OF THE ROOM.
- P26. ALL SUMP PUMP PITS TO HAVE SEALED AIRTIGHT PLASTIC OR POLYCARBONATE LIDS WITH RUBBER COUPLINGS AND A CLEAR VIEW-PORT FOR OBSERVATION.

	PLUMBING FIXTURE SCHEDULE					
FIXTURE	MFG	MODEL	REMARKS			
WC-1 ACCESSIBLE TOILET	TOTO OR APP. EQUIV.	DRAKE CST144SL 1.6GPF LOW CONSUMPTION	ACCESSIBLE ELONGATED WHITE WITH OPEN FRONT RESIN SEAT (TYPE 1). PROVIDE GRAB BARS.			
<u>UR-1</u> URINAL	TOTO OF APP. EQUIV.	UT447Y LOW CONSUMPTION TOP WASHOUT URINAL	ACCESSIBLE URINAL UNIT WITH TOTO TMUNNC-22 FLUSH VALVE. MOUNT FIRST UNIT ® 1-5"MAX A.F.F. WITH "JAY R SMITH" HANGER.			
<u>LAV-1</u> LAVATORY	DUPONT CORIAN	24" DEEP CORIAN COUNTER WITH CORIAN MODEL 816 ADA UNDERMOUNT BOWL WITH FRONT OVERFLOW. COLOR TO BE PRICE GROUP D' OR LESS.	POSITION BOWL # ADA LOCATION PER MANUFACTURERS INSTRUCTION, PROVIDE INTEGRAL BACKSPLASH & ADDED SIDESPLASH, COUNTER AND BOWL COLOR AND PATTERN TO BE SELECTED, AUTOMATIC SENSER FALLEDT = \$1,0.0A IS -1.28 TRANSPORTER POWEREDWITH BATTERY BACK UP, CHROME FINISH SCALD PROTECTION ON WATER SUPPLY INSULATE DRAIN & SUPPLY LINES WITH "TRUE BRO HANDILAY", VERIFY DIMENSION IN FIELD BEFORE ORDERING			
9-1 SINGLE BOWL SINK	DUPONT CORIAN	25" DEEP CORIAN COUNTER WITH CORIAN MODEL 804 UNDER HONT SINGLE SINK COLOR TO BE PRICE GROUP D'OR LESS.	PROVIDE INTEGRAL BACKSPLASH (ADDED SIDESPLASH, COUNTER AND BOWL COLOR AND PATTERN TO BE SELECTED, ADA COMPLIANT DELTA ISI FALCET WITH CHROME FINISH, SCALD PROTECTION ON WATER SUPPLY INSULATE DRAIN (SUPPLY LINES WITH "TRUE BROHADILAY".			
MS-1 MOP SINK	FIAT OR APP. EQUIV.	M9B2424	PROVIDE FIAT 1930-AA' SERVICE FAUCET, W/ VACUUM BREAKER, INTEGRAL STOPS, ADJUSTABLE WALL BRACE, 3/4" HOSE THREAD AND 1932-AA HOSE OR APPROVED EQUIV.			
EWC ELEC. WATER COOLER	ELKAY	EZTL8C	TWO STATION WALL MOUNT BARRIER FREE WATER COOLER WITH CONTROLS ON FRONT ONLY.			
WCO WALL CLEAN OUT	JOSAM OR APP. EQUIV.	5811Ø SERIES	ROUND STAINLESS STEEL ACCESS COVER			
ECO FLOOR CLEAN OUT	JOSAM OR APP. EQUIV.	56000 SERIES				
FD FLOOR DRAIN	JOSAM OR APP. EQUIV.	30000 SERIES WITH STRAINER	PROVIDE SATIN FINISH BRONZE TOP STRAINER			
HWH HOT WATER HEATER	BRADFORD WHITE OR APP. EQUIV.	M-1-2ØL6DS	ENERGY SAVER ELECTRIC-LOWBOY WITH 19 GAL CAPACITY. 20 GPH RECOVERY AT 90°F RIGE. ADD EXPANSION TANK AND 14P VALVE. 240 VOLT ELEMENT WITH 30 AMP BREAKER PROVIDE DRAINAGE PAN			
HB HOSE BIB RECESSED	WOODFORD	B65	ANTI-91PHON, AUTOMATIC DRAINED FREEZELESS RECESSED WALL HYDRANT. CHROME FINISH.			
WT WATER TANK	GOULD HYDRO PRO	* 0490-055	65 GALLON DIAPHRAGM PRESSURE TANK WITH STAND \$\frac{1200}{200}			

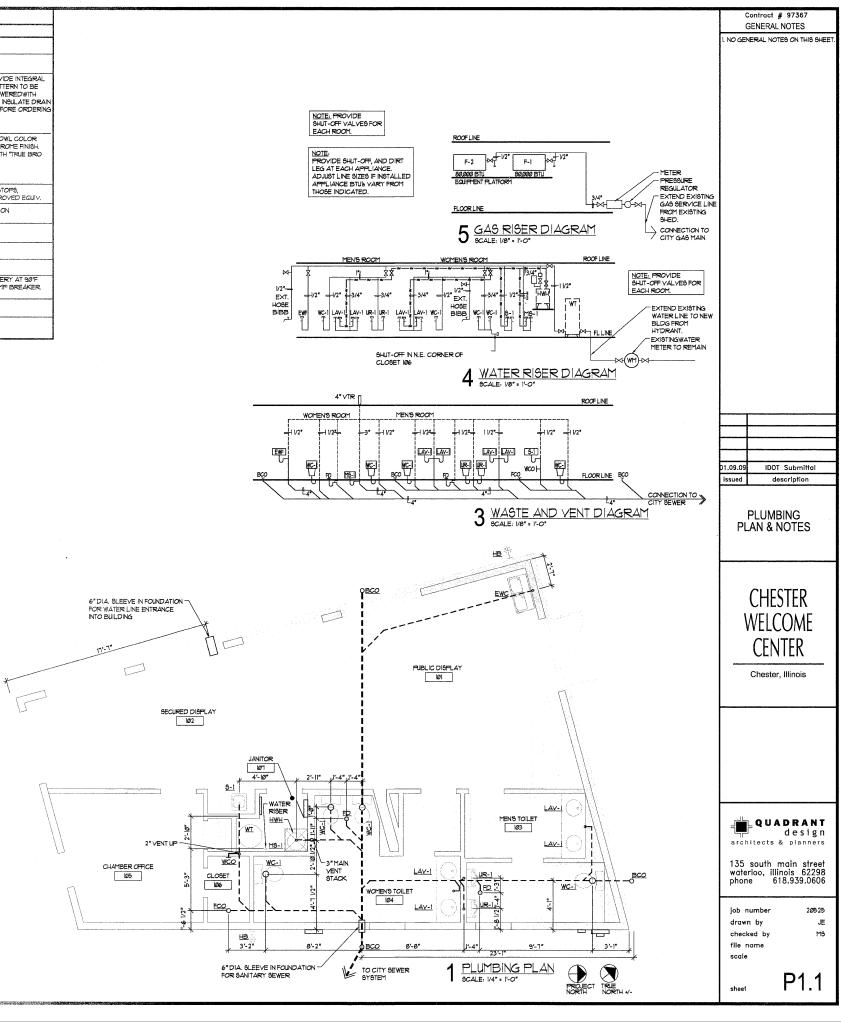

- THE CONTRACTOR SHALL NOTIFY THE STRUCTURAL ENGINEER IF THE CONTRACTOR DETERMINES OR SUSPECTS THAT ANY DETAILS, MATERIALS, MEANS OR METHODS INCLUDED IN THE STRUCTURAL SPECIFICATIONS OR STRUCTURAL DRAWINGS ARE INCORRECT, NEED TO BE CHANGED, INADEQUATE, UNIFEASIBLE OR DETRIMENTAL TO THE COMPLETED CONSTRUCTION. NOTIFICATION SHALL BE MADE AT THE EARLIEST POSSIBLE TIME AND, WHEN POSSIBLE, PRIOR TO ORDERING MATERIALS OR
- DEVIATION FROM THE STRUCTURAL SPECIFICATIONS AND STRUCTURAL DRAWINGS SHALL NOT BE MADE WITHOUT APPROVAL FROM THE STRUCTURAL ENGINEER.
- 3. DO NOT SCALE DIMENSIONS FROM STRUCTURAL DRAWINGS, (S SHEETS) WHEN SCALES ARE NOT SHOWN. WHEN SCALES AND DIMENSIONS ARE BOTH SHOWN FOR A DETAIL OR SHEET, DIMENSIONS SHALL TAKE PRECEDENCE WHEN IN CONFLICT WITH SCALE. ANY CONFLICT DISCOVERED BY THE CONTRACTOR SHALL BE REPORTED IN ACCORDANCE WITH NOTE 1. OF THIS SPECIFICATION SECTION.
- 4. HOLES FOR ANCHORS, DOWELS, ETC., SHALL NOT BE DRILLED THROUGH REINFORCING BARS WITHOUT APPROVAL OF THE STRUCTURAL ENGINEER
- NEITHER THE PRESENCE NOR LACK OF CONSTRUCTION OBSERVATION SHALL RELIEVE THE CONTRACTOR OF THE RESPONSIBILITY OF COMPLETING WORK IN FULL COMPLIANCE WITH THE STRUCTURAL SPECIFICATION AND STRUCTURAL DRAWNOS.

STRUCTURAL FOUNDATION AND EXCAVATION SPECIFICATION

- 1. NET BEARING CAPACITY = 1.800 PSF
- FOUNDATIONS SHALL BEAR ON UNDISTURBED NATURAL INORGANIC SOIL OR STRUCTURAL FILL OF BEARING CAPACITY CONFIRMED TO EQUAL OR EXCEED THE MINIMUM INDICATED IN NOTE 1. BOTTOMS OF FOOTINGS SHALL ALSO BE A MINIMUM OF TWELVE INCHES BELOW EXISTING NATURAL GRADE. BOTTOMS OF FOOTINGS SHALL BE DEEPINED AS NECESSARY TO SATIFY THESE REQUIREMENTS, OR UNSUITABLE SOIL SHALL BE REMOVED DOWN TO ACCEPTABLE SOIL AND REPLACED WITH LEAN CONCRETE OR CA6 PLACED IN LIFTS NOT TO EXCEED 4" AND COMPACTED TO 95 STANDARD
- 3. BOTTOMS OF FOUNDATIONS SHALL BE FREE OF LOOSE MATERIAL AND EXCAVATOR CLAW MARKS
- FOUNDATION CONCRETE SHALL BE PLACED BEFORE DETERIORATION OF THE SUBGRADE DUE TO WEATHER, GROUND WATER SEPPAGE, FOOT TRAFFIC, OR CONSTRUCTION OPERATIONS. ANY PORTIONS OF THE SUBGRADE PERMITTED TO DETERIORATE SHALL BE REMOYED AND REPLACED WITH COMPACTED CA6 OR LEAN CONCRETE WITHOUT ADDITIONAL COMPENSATION TO THE CONTRACTOR.
- COMPACTED GRANULAR BACKFILL SHALL BE CA6.
- 6. COMPACTED GRANULAR BACKFILL SHALL BE PLACED IN MAXIMUM LIFTS OF 8".
- 7. COMPACTED GRANULAR BACKFILL SHALL BE COMPACTED TO 95% STANDARD PROCTOR.
- B. THE CONTRACTOR SHALL BE RESPONSIBLE FOR DESIGN AND CONSTRUCTION OF TEMPORARY SHORING TEMPORARY SHORING SHALL BE INSTALLED AS REQUIRED TO PROTECT EXISTING STRUCTURES AND
- THE CONTRACTOR SHALL SUBMIT DESIGN DETAILS AND CALCULATIONS SEALED BY AN ILLINOIS LICENSED STRUCTURAL ENGINEER FOR TEMPORARY SHORING.

STRUCTURAL CONCRETE SPECIFICATIONS

- STRUCTURAL CONCRETE WORK ON THIS PROJECT SHALL BE CONFORM TO ALL REQUIREMENTS OF ACI 301-05, SPECIFICATION FOR STRUCTURAL CONCRETE, PUBLISHED BY THE AMERICAN CONCRETE INSTITUTE, FARMINGTON HILLS, MICHIGAN, EXCEPT AS MODIFIED BY THESE STRUCTURAL CONCRETE SPECIFICATIONS AND/OR STRUCTURAL DRAWINGS.
- THE FOLLOWING INFORMATION IS EITHER MODIFIES OR IS IN ADDITION TO ACI 301–05. ACI 301–05 AND ALL DOCUMENTS REFERENCED BY ACI 301–05 MUST BE REVIEWED FOR COMPLETE REQUIREMENTS FOR STRUCTURAL CONCRETE WORK.
- REFER TO GENERAL REQUIREMENTS OF STRUCTURAL SPECIFICATIONS. GENERAL REQUIREMENTS OF STRUCTURAL SPECIFICATIONS APPLY TO STRUCTURAL CONCRETE.
- STRUCTURAL CONCRETE SHALL BE DEFINED AS ALL CONCRETE CONSTRUCTION DESCRIBED OR DETAILED BY THE STRUCTURAL CONCRETE SPECIFICATIONS AND STRUCTURAL DRAWMOS.
- THE CONTRACTOR SHALL POSSESS AND BE FAMILIAR WITH ALL REFERENCED SPECIFICATIONS. A COMPLETE SET OF THE STRUCTURAL DRAWINGS AND ACI 301-05 SHALL BE MAINTAINED AT THE PROJECT SITE AND SHALL BE AVAILABLE TO ALL PARTIES (SUBCONTRACTORS, SUPERINTENDENTS, FOREMEN, ETC.) WHOSE UNDERSTANDING OF THE PROJECT REQUIREMENTS MAY AFFECT THE QUALITY OF STRUCTURAL CONCRETE CONSTRUCTION.

6 SUBMITTALS

- 6.1 THE CONTRACTOR SHALL SUBMIT TO THE STRUCTURAL ENGINEER THE METHODS AND PRODUCTS THAT WILL BE USED TO PROTECT AND CURE STRUCTURAL CONCRETE.
- 6.2 THE CONTRACTOR SHALL SUBMIT THE LOCATIONS, DETAILS AND MATERIALS DATA FOR ALL JOINTS IN STRUCTURAL CONCRETE THAT ARE NOT INCLUDED IN THE STRUCTURAL SPECIFICATIONS AND STRUCTURAL DRAWINGS, AND ARE PROPOSED BY THE CONTRACTOR.
- 6.3 SUBMITTALS, AS APPLICABLE IN COMPLIANCE WITH THE FOLLOWING SECTIONS OF ACI 301-05: 1.6.3.2E, 1.6.3.4.1C, 3.1.1.1, 3.1.1.2, 3.1.1.3, 3.3.2.2, 3.3.2.8, 4.1.2.1, 4.1.2.5, 4.1.2.9, 4.2.1.1, 5.1.2.2B, 5.1.2.3A

REINFORCEMENT

- 7.1 MINIMUM SPECIFIED YIELD STRENGTH OF REINFORCING BARS AND WELDED WIRE FABRIC . FY = 60.000 PSI.
- 7.2 WELDED WIRE FABRIC SHALL BE FLAT SHEETS, NOT FROM ROLLS. WELDED WIRE FABRIC SHALL BE SUPPORTED ON CHAIRS THAT LOCATE THE FABRIC AT MID-DEPTH OF SLABS UNLESS SHOWN OTHERWISE. CHAIRS SHALL BE SPACED CLOSE ENOUGH TO PREVENT BENDING AND MAINTAIN FLATNESS OF THE SHEETS. CHAIRS PLACED ON SOIL OR CRUSHED ROCK SHALL HAVE CONTINUOUS RUNNERS, NOT INDIVIDUAL FEET.
- 7.3 REINFORCING BARS AND FABRIC SHALL BE FIRMLY TIED IN PLACE AND NOT FLOATED IN UNLESS NOTED OTHERWISE.
- 7.4 CARE SHALL BE TAKEN IN THE LOCATION OF REINFORCEMENT TO AVOID CONFLICT WITH DRILLED ANCHORS.
- 7.5 REINFORCEMENT SHALL NOT BE WELDED WITHOUT APPROVAL OF THE STRUCTURAL
- CONCRETE REQUIREMENTS ACCORDING TO CLASSIFICATION.
 STRUCTURAL CONCRETE SHALL BE PROVIDED ACCORDING TO THE CLASSIFICATION INDICATED IN
 THE STRUCTURAL CONCRETE SCHEDULE. REQUIREMENTS ACCORDING TO CLASS ARE AS FOLLOWS:

	CLASS A	CLASS B
28 DAY COMPRESSIVE STRENGTH, F'C (PSI)	4,000	4,000
MINIMUM CEMENT CONTENT (LB/CY) WATER/CEMENTITIOUS RATIO	540 .45	540 .45
SLUMP WITHOUT HIGH RANGE WATER REDUCER (INCHES) +/- 1"	3	3
SLUMP WITH HIGH RANGE WATER REDUCER (INCHES) +/- 1 1/2"	5	5
AIR ENTRAINMENT EXPOSURE CONDITION *	MILD	SEVERE

* PROVIDE AIR ENTRAINMENT IN ACCORDANCE WITH TABLE 4.2.2.4 OF ACI 301-05, REPRINTED.

TABLE 4.2.2.4-AIR CONTENT: OF CONCRETE FOR VARIOUS SIZES OF COARSE AGGREGATE

	AIR CON	ITENT, PERCENT *		
OMINAL MAXIMUM SIZE OF GGREGATE, IN.	SEVERE EXPOSURE	MODERATE EXPOSURE	MILD EXPOSURE	
ESS THAN 3/8	9	7	5	
3/8	7.5	6	4.5	
1/2	7	5.5	4	
3/4	6	5	3.5	
1	6	4.5	3	
1-1/2	5.5	4.5	2.5	
2	5	4	2	
3	4.5	3.5	1.5	
2	4	7	4	

*MEASURED IN ACCORDANCE WITH ASTM C 231, C 173, OR C 138 AIR-CONTENT TOLERANCE IS ±1-1/2%.

Portland Cement Type Requirement per Concrete Class shall be as follows: Class A - Any Type

Class B and C: Type II, Type IP (MS), Type IS (MS), Type I (PM)(MS) or Type I (SM)(MS).

CHLORIDE CONTENT

- CALCIUM CHLORIDE OR ADMIXTURES CONTAINING WATER SOLUBLE CHLORIDE FROM OTHER THAN INCIDENTAL IMPURITIES SHALL NOT BE USED.
- 9.2 THE MAXIMUM WATER-SOLUBLE ION CONTENT, EXPRESSED AS A PERCENT OF THE CEMENT, CONTRIBUTED FROM ALL INGREDIENTS OF THE CONCRETE MIX, INCLUDING WATER, AGGREGATES, CEMENTITIOUS MATERIALS, AND ADMIXTURES, SHALL NOT EXCEED 0.10%

10. WATER ADDED AT JOB SITE

- 10.1 WATER MAY BE ADDED TO STRUCTURAL CONCRETE AT THE JOB SITE ONLY IN THE AMOUNT INDICATED ON THE BATCH TICKET.
- 10.2 IF NO AMOUNT OF JOB SITE WATER IS INDICATED ON THE BATCH TICKET NO WATER SHALL BE ADDED AT THE JOB SITE.
- 10.3 WHEN WATER IS ADDED AT THE JOB SITE, IT SHALL BE DONE SO AT THE CONTRACTORS RISK. A SLUMP TEST SHALL BE TAKEN AFTER WATER HAS BEEN ADDED. IF THE SLUMP EXCEDS THE LIMIT SET BY THE STRUCTURAL CONCRETE SPECIFICATION THE CONCRETE SHALL NOT
- 11. STRUCTURAL CONCRETE SHALL BE VIBRATED TO ENSURE CONSOLIDATION. VIBRATION SHALL NOT BE USED TO MOVE CONCRETE. CARE SHALL BE TAKEN TO PREVENT SEGREGATION AND LOSS OF AIR ENTRAINMENT CAUSED BY EXCESSIVE VIBRATION.
- 12. FINISHING UNFORMED SURFACES
- 12.1 DO NOT SPRINKLE WATER ONTO CONCRETE SURFACES.
- 12.2 DO NOT WORK BLEED WATER INTO CONCRETE SURFACES. WAIT UNTIL BLEED WATER HAS DISAPPEARED OR, IF BLEED WATER IS PRESENT WHEN FINISHING MUST BEGIN, REMOVE BLEED WATER BY BLOTTING.
- 12.3 DO NOT SPRINKLE DRYERS SUCH AS SAND/CEMENT MIXTURES ONTO CONCRETE SURFACE.
- 12.4 DO NOT USE STEEL TROWELS UNLESS INDICATED IN THE STRUCTURAL CONCRETE SCHEDULE FOR A SMOOTH FINISH.

13. PROTECTION AND CURING

- 13.1 IT IS THE RESPONSIBILITY OF THE CONTRACTOR TO BE AWARE OF PROBLEMS RESULTING FROM INADEQUATE PROTECTION AND CURING OF CONCRETE.
- 13.2 THE CONTRACTOR SHALL DETERMINE WHEN PROTECTION IS NECESSARY AND WHAT METHODS AND MATERIALS WILL BE USED. PROTECTION SHALL BE IN COMPLIANCE WITH SECTION 5.3.6.5 OF ACI 301-05.
- 13.3 CURING SHALL COMMENCE AS SOON AS NECESSARY TO PRESERVE MOISTURE AND SHALL BE CONTINUOUSLY MAINTAINED FOR A MINIMUM OF SEVEN DAYS, CURING SHALL BE IN ACCORDANCE WITH SECTION 5.3.6.1 OF ACI 301-05.

BATCH TICKET INFORMATION —
THE CONCRETE SUPPLIER SHALL INDICATE ON EACH BATCH TICKET THE AMOUNT OF WATER THAT
MAY BE ADDED AT THE JOB STIE, PER CUBIC YARD OF CONCRETE, WHICH WILL NOT RESULT IN A
WATER/CEMENTITIOUS RATIO IN EXCESS OF THAT SPECIFIED. THIS SHALL BE IN ADDITION TO THE INFORMATION REQUIRED BY ASTM C94/C 94M-99.

STRUCTURAL CONCRETE SCHEDULE STRUCTURAL MEMBER OR COMPONENT CONCRETE CLASS UNFORMED SURFACE FINISH BUILDING FOOTINGS BOARD STRIKE OFF INTERIOR SLABS ON GRADE STEEL TROWEL FINISH EXTERIOR WALLS В BROOM FINISH

STRUCTURAL STEEL SPECIFICATIONS

- STRUCTURAL STEEL WORK ON THIS PROJECT SHALL CONFORM TO ALL REQUIREMENTS OF PART 5 SPECIFICATIONS AND CODES OF THE MANUAL OF STEEL CONSTRUCTION, ALLOWABLE STRESS DESIGN, NINTH EDITION, AND TO THESE STRUCTURAL STEEL SPECIFICATIONS AND STRUCTURAL DRAWINGS.
- HOT ROLLED STRUCTURAL STEEL, PLATES AND BARS SHALL BE ASTM A572 GRADE 50 OR ASTM A992, UNLESS SHOWN OTHERWISE.
- HOT ROLLED STRUCTURAL STEEL ANGLES SHALL BE ASTM A36.
- 4. CAST IN PLACE ANCHOR BOLTS SHALL BE ASTM A307 UNLESS NOTED OTHERWISE.
- WELDING SHALL BE DONE WITH E70XX ELECTRODES.
- INDICATED STRUCTURAL STEEL SHALL BE HOT DIPPED GALVANIZED PER ALL REQUIREMENTS OF
- INDICATED STRUCTURAL STEEL HARDWARE SHALL BE HOT DIPPED GALVANIZED PER ALL REQUIREMENTS OF ASTM A153.

STRUCTURAL WOOD FRAMING SPECIFICATIONS

- STRUCTURAL FRAMING LUMBER SHALL BE NO. 2 S-P-F OR BETTER UNLESS OTHERWISE INDICATED IN THIS SPECIFICATION, OR IN THE SCHEDULES AND DETAILS ON THESE DRAWINGS. SHORT INDIVIDUAL PIECES OF BLOCKING SHALL BE FREE OF SPLITS, KNOTS, TWISTS, AND WARPS WHICH REDUCE THE STRENGTH OF MECHANICAL CONNECTIONS.
- 2 FRAMING ANCHORS SHALL BE FASTENED WITH THE TOTAL NUMBER OF FASTENERS WHICH THE ANCHOR CAN RECEIVE. THE TYPE AND SIZE OF FASTENERS SHALL BE AS REQUIRED BY THE MANUFACTURER. THE ANCHORS SHALL BE PLACED AND ALIGNED SO THAT ALL FASTENERS ARE FULLY EMBEDDED AND DO NOT CONFLICT WITH OTHER FASTENERS OR COMPONENTS. ANCHORS SHALL NOT BE INSTALLED AND THE ENGINEER SHALL BE CONTACTED IF PHYSICAL CONSTRAINTS PREVENT THE PROPER INSTALLATION OF ANCHORS POWER NAILING OF FRAMING ANCHORS WILL BE PERMITTED ONLY WHEN THE NAIL TYPE AND ING METHOD BOTH MEET THE REQUIREMENTS OF THE FRAMING ANCHOR MANUFACTURER.
- 3 THE MINIMUM HORIZONTAL OR VERTICAL DIMENSIONS OF ANY STRUCTURAL WOOD PANEL SHALL NOT BE LESS THAN 2'-0".
- 4 SHEATHING NAILS WHICH ARE NOT FULLY EMBEDDED INTO FRAMING SHALL BE REMEDIATED AS AND IF DEEMED NECESSARY BY THE ENGINEER. ADDITIONAL COMPENSATION WILL NOT BE PAID AND THE REMEDIATION SHALL BE COMPLETED AT THE CONTRACTORS EXPENSE.

PLATED WOOD TRUSS SPECIFICATION

- THE TRUSS FABRICATOR SHALL PROVIDE A FRAMING PLAN, A SHOP DRAWING FOR EACH TRUSS TYPE AND DESIGN CALCULATIONS. THE FRAMING PLAN, EACH TRUSS SHOP DRAWING AND DESIGN CALCULATIONS SHALL BE SEALED BY AN ILLINOIS LICENSED STRUCTURAL ENGINEER.
- 2 THE TRUSS SHOP DRAWINGS SHALL INDICATE THE LOCATION, SIZE, AND FASTENING DETAILS OF PERMANENT LATERAL BRACING OF TRUSS MEMBERS.
- 3 IF TRUSSES ARE NOT TO BE IMMEDIATELY INSTALLED, THEY SHALL BE STORED IN A IF TRUSSES ARE NOT TO BE IMMEDIATED IN TRUSTELLER, THEI STANLE BE STOKED IN A HORIZONTAL OR VERTICAL POSITION AS RECOMMENDED BY THE TRUSS PLATE MANUFACTURER. THEY SHALL NOT BE IN CONTACT WITH THE EARTH AND SHALL BE COVERED TO PREVENT CONTACT WITH WATER, SNOW OR ICE.
- 4 CONTRACTOR AND TRUSS FABRICATOR SHALL FIELD MEASURE AND COORDINATE TRUSS

WOOD DECK SPECIFICATION

- ALL SIMPSON'S SDS SCREWS SHALL HAVE A DOUBLE BARRIER COATING.
- 2 WOOD SHALL BE PRESSURE TREATED WITH ALKALINE COPPER QUATERNARY (ACQ) ACQ WITH NOT LESS THAN 0.25 PCF OR MORE THAN 0.30 PCF PRESERVATIVE RETENTION. ACQ PRESERVATIVE TREATMENT SHALL NOT CONTAIN AMMONIA.

 3 SUBMITTALS THE CONTRACTOR SHALL SUBMIT THE PRESSURE TREATED LUMBER MANUFACTURERS SPECIFICATIONS. THE SPECIFICATIONS SHALL INCLIDE THE AMOUNT OF PRESERVATIVE RETENTION, A LIST OF ALL CHEMICALS, AND EXPLICIT STATEMENT THAT

AMMONIA IS NOT USED.

THOUVENOT WADE & MOERCHEN. INC ENGINEERS ◆ SURVEYORS ◆ PLANNERS



☐ CORPORATE OFFICE 4940 OLD COLLINSVILLE RD. WANSEA, ILLINOIS 62226 TEL (618) 624-4488 FAX (618) 624-6688 corp@twm-inc.com

☑ WATERLOO OFFICE

113 SOUTH MAIN STREET WATERLOO, ILLINOIS 62298 TEL (618) 939-5050 FAX (618) 939-3938

□ EDWARDSVILLE OFFICE

1015B CENTURY DRIVE EDWARDSVILLE, ILLINOIS 62025 TEL (618) 656-4040 FAX (618) 656-4343

edwardsville@twm-inc.com ST. LOUIS OFFICE 1001 CRAIG ROAD, SUITE 260 ST. LOUIS, MISSOURI 63146 TEL (314) 236-5052

FAX (314) 872-2194 stlouis@twm-inc.com PROFESSIONAL REGISTRATIONS LICENSE NO. ILLINOIS PROFESSIONAL DESIGN FIRM 184-001220 ROFESSIONAL ENGINEERING CORP. PROFESSIONAL STRUCTURAL ENGR. CORP. 81-005202


LLINOIS PROF, LAND SURVEYING CORP. 048-000029 WISSOURI LAND SURVEYING CORP. NC 000346

STATEMENT OF RESPONSIBILITY hereby confirm that the document herein to be uthenticated by my seal is restricted to this shee nd I hereby disclaim any responsibility for all oth ravings, specifications, estimates, reports or othe ocuments or instruments relating to or intended is engineering or survey project.


L	L		
Γ	REV.	DATE	DESCRIPTION
l	Λ	12/16/08	REVISIONS PER IDOT COMMENTS
l	Δ		
l	\triangle		

rawn Y:	DJH		SH	EET	
esigned Y:	DJH		S	31	
HECKED Y:	KPC	OF	9	SHEETS	
PPROVED Y:	KPC	PROJEC	CT DI	SCRIPTIO	Ñ
ROJECT UMBER	050421				

SI ISSUED FOR REVIEW 🔲 ISSUED FOR BIDDING I ISSUED FOR CONSTR. II RECORD DRAWING

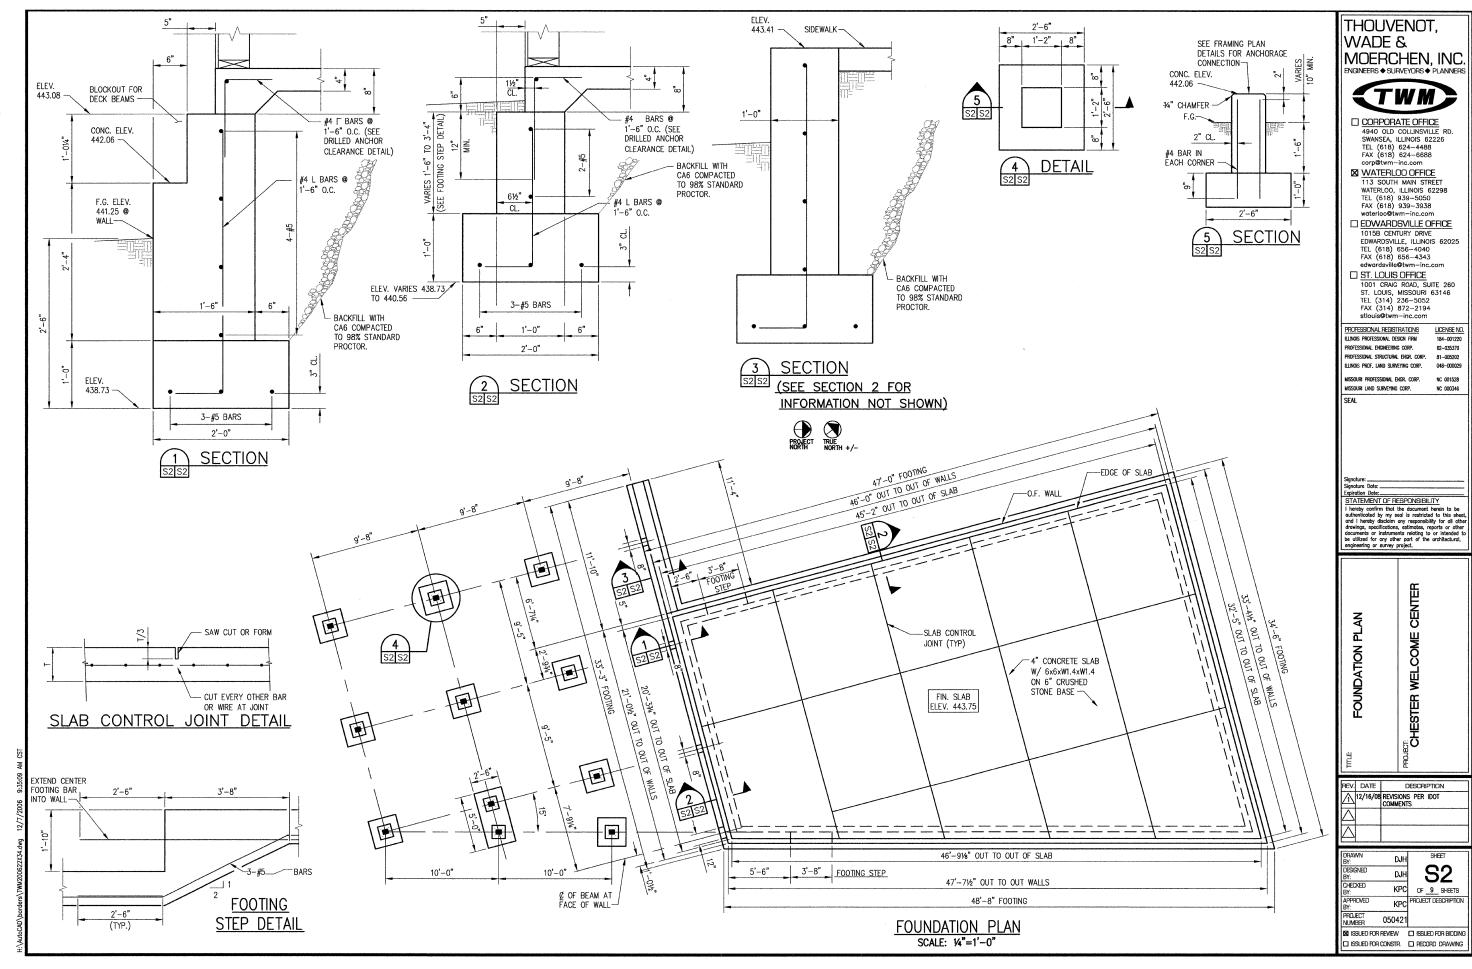

REV.		DESCRIPTION
Λ	12/16/08	REVISIONS PER IDOT COMMENTS
\triangle		
\triangle		

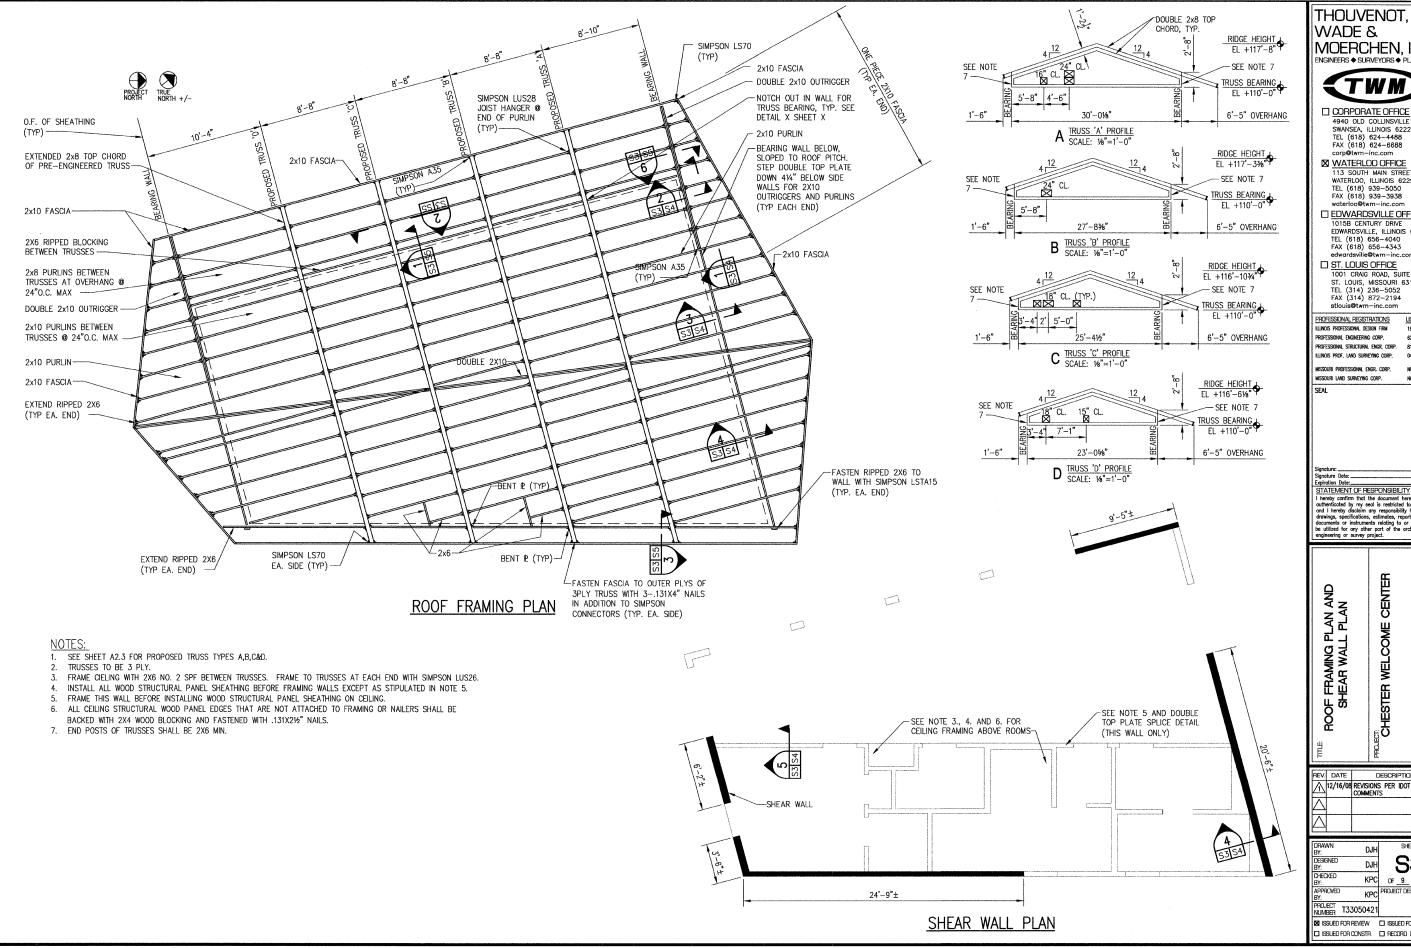

THOUVENOT, WADE & MOERCHEN, INC. ENGINEERS

SUBVEYORS

PLANNERS



4940 OLD COLLINSVILLE RD. SWANSEA, ILLINOIS 62226 TEL (618) 624-4488 FAX (618) 624-6688 corp@twm-inc.com

▼ WATERLOO OFFICE 113 SOUTH MAIN STREET WATERLOO, ILLINOIS 62298 TEL (618) 939-5050 FAX (618) 939-3938

EDWARDSVILLE OFFICE

1015B CENTURY DRIVE
EDWARDSVILLE, ILLINOIS 62025 TEL (618) 656-4040 FAX (618) 656-4343

ST. LOUIS OFFICE 1001 CRAIG ROAD, SUITE 260 ST. LOUIS, MISSOURI 63146 TEL (314) 236-5052 FAX (314) 872-2194


LICENSE NO. PROFESSIONAL ENGINEERING CORP. 62-035370 81-005202 ILLINOIS PROF. LAND SURVEYING CORP. 048--000029 MISSOURI PROFESSIONAL ENGR. CORP. NC 001528 issouri land surveying corp.


 \mathbb{R} CHESTER


<u> L'</u>			
REV.	DATE	DESCRIPTION	٦
A	12/16/08	REVISIONS PER IDOT COMMENTS	٦
			٦

S3 DJH KPC OF 9 SHEETS KPC PROJECT DESCRIPTION PROJECT T33050421

SSUED FOR CONSTR. 🔲 RECORD DRAWING

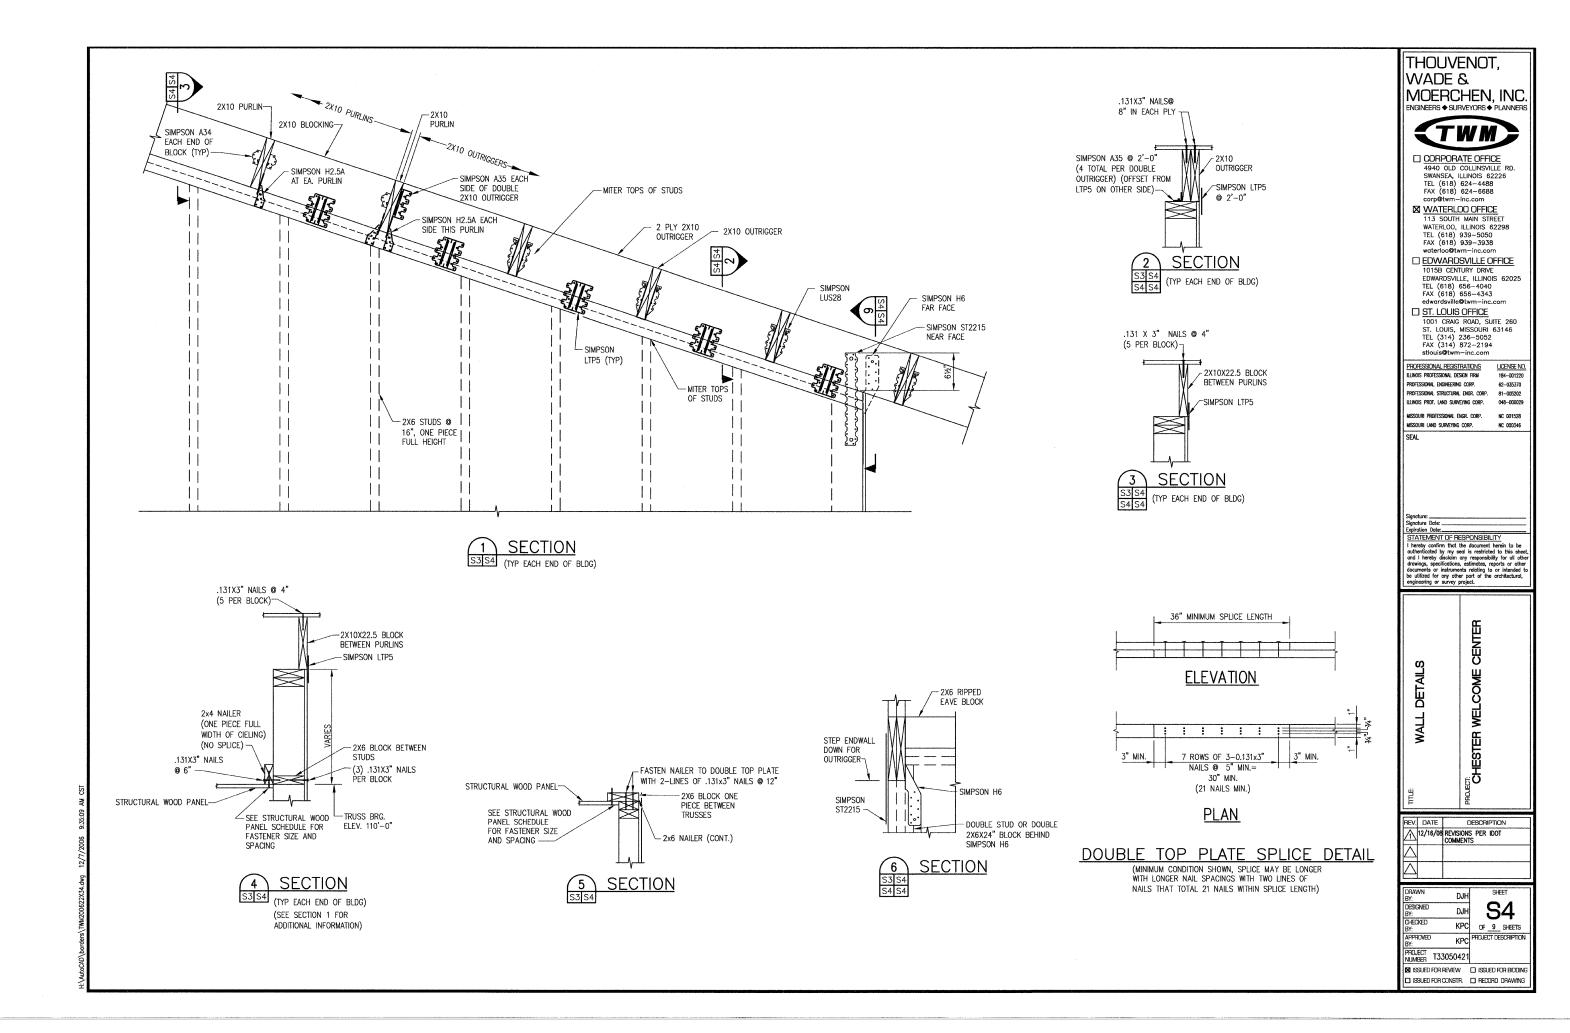

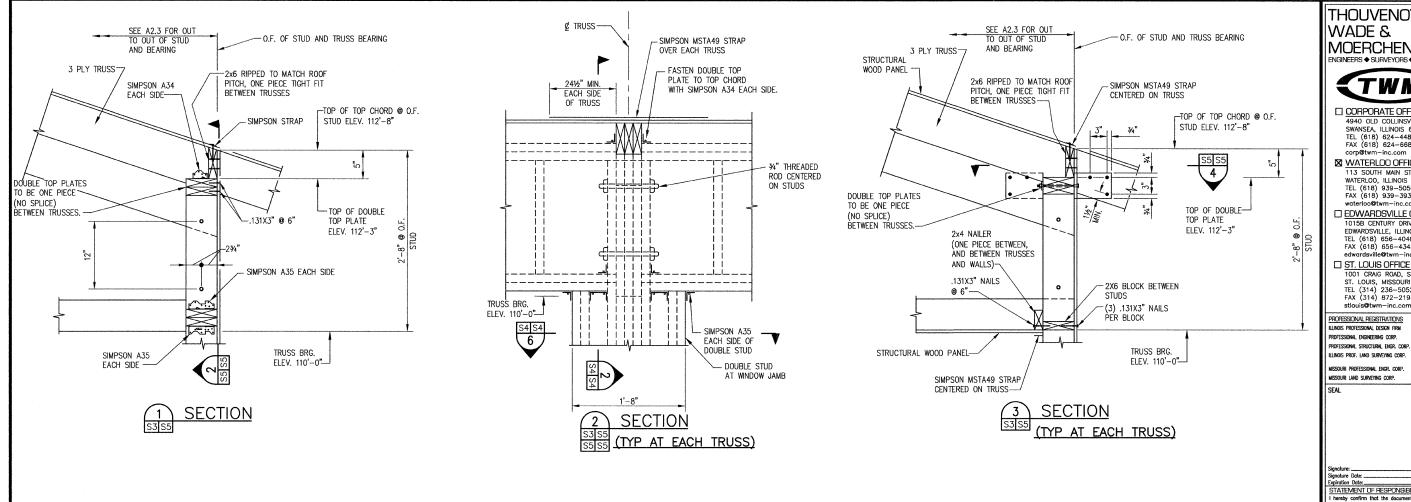

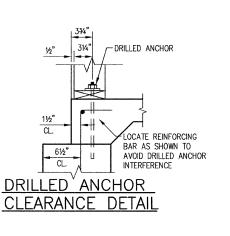



ILLINOIS PROF. LAND SURVEYING CORP. 048-000029 MISSOURI PROFESSIONAL ENGR. CORP. NC 001528 MISSOURI LAND SURVEYING CORP. xpiration Date:______ STATEMENT OF RESPONSIBILITY I herely confirm that the document herein to be outherstoated by my seal is restricted to this sheet, and I herely disclaim or yresponsibility for all other drawing, specifications, estimates, reports or other drawing, specifications, estimates, reports or other drawing and other d

stlouis@twm-inc.com


LICENSE NO.

62-035370


TITLE FRAMING DETAILS
PROJECT: CHESTER WELCOME CENTER

-	REV.	DATE	DESCRIPTION
ı	$\overline{\mathbb{A}}$	12/16/08	REVISIONS PER IDOT COMMENTS
1	\triangle		
ı	\triangle		

1	DRAWN BY:	DJH		SH	EET
1	DESIGNED BY:	DJH		S	5
1	CHECKED BY:	KPC	OF.	9	SHEETS
1	APPROVED BY:	KPC	PROJE	CT DE	SCRIPTION
	PROJECT NUMBER	T33050421			
	SSUED	FOR REVIEW	☐ ISSL	JED F	OR BIDDING
ı	☐ ISSUED	FOR CONSTR.	☐ REC	ORD	DRAWING

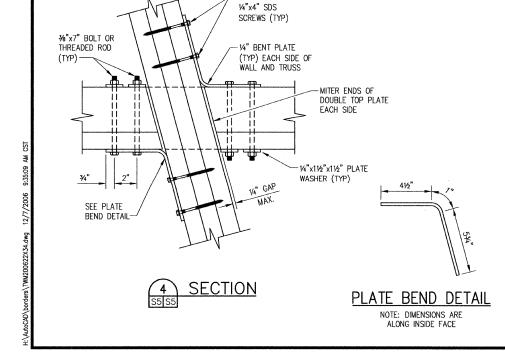

3-SIMPSON

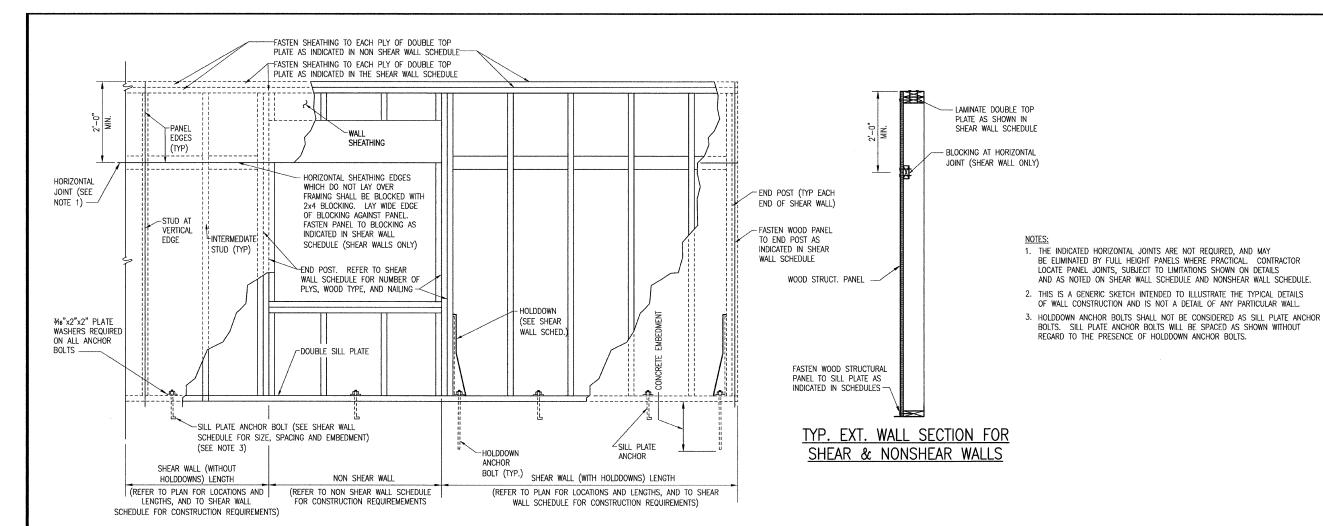

GENERIC PARTIAL WALL ELEVATION





4940 OLD COLLINSVILLE RI SWANSEA, ILLINOIS 62226 TEL (618) 624–4488 FAX (618) 624–6688 corp@twm-inc.com

WATERLOO OFFICE 113 SOUTH MAIN STREET WATERLOO, ILLINOIS 62298 TEL (618) 939−5050 FAX (618) 939−3938 waterloo@twm−inc.com

EDWARDSVILLE OFFICE

1015B CENTURY DRIVE
EDWARDSVILLE, ILLINOIS 62025
TEL (618) 656-4040
FAX (618) 656-4343

ST. LOUIS OFFICE

1001 CRAIG ROAD, SUITE 260
ST. LOUIS, MISSOURI 63146
TEL (314) 236-5052
FAX (314) 872-2194
stlouis@twm-inc.com

PFOFESSIONAL PEGISTRATIONS
LILINGIS PROFESSIONAL DESIGNE FIRM
PROFESSIONAL DISINEERING CORP.
62-055370
PROFESSIONAL STRICTURAL ENGIR CORP.
81-005202
LILINGIS PROFE. LAND SURVEYING CORP.
048-000029
MISSOURI PROFESSIONAL ENGIR. CORP.
MISSOURI PROFESSIONAL ENGIR. CORP.
MISSOURI PROFESSIONAL ENGIR. CORP.
MISSOURI LAND SURVEYING CORP.

Signature: _____

Sprious Date:
STATEVIENT OF RESPONSIBILITY

I hereby confirm that the document herein to be authenticated by my seal is restricted to this sheet, and I hereby disclaim any responsibility for all other drawings, specifications, setlanders, reports or other drawings, specifications, setlanders, reports or other drawings, specifications, setlanders, to enhance the contents of restruments reliefle to or illnesded to be applied to the architectural, engineering or survey project.

SHEAR WALL DETAILS
ROLECT:
CHESTER WELCOME CENTER

_			
REV.		DESCRIPTION	
$\overline{\Lambda}$	12/16/08	REVISIONS PER IDOT COMMENTS	

DRAWN BY:	DJH	SHEET
DESIGNED BY:	DJH	S6
CHECKED BY:	KPC	OF 9 SHEETS
APPROVED BY:	KPC	PROJECT DESCRIPTION
PROJECT NUMBER	T33050421	
1		

☑ ISSUED FOR REVIEW ☐ ISSUED FOR BIDDING
☐ ISSUED FOR CONSTR. ☐ RECORD DRAWING

									SHEAR WALL SCHEDULE						Holdown		Sill P	ate Anch	hor Bolts
Woo	d Structural		Studs			End Pos	ts	Bottom Plate	Wood Structural Panel Nail Sizes and Spacin	ngs	Other Nail S	Sizes & Spacing	1				1	(Note 6	j)
Pan	els (note 8)	Lumber		Lumber	Lumber	Number	Lumber	Lumber	To: Double Top Plate, Bottom Plate, Horizontal	To:	Double Top Plate	Bottom Plate	End	Manf.	Anchor	Conc.	Size	Max.	Conc.
Minimum	Min. Grade and	Size	Spacing	Grade and	Size	of Plys	Grade and	Grade and	Blocking, End Posts (Note 2) and Studs @	Intermediate	Ply to Ply	to Floor	Post	and	Bolt Size	Embed.			Embed.
Thickness	Span Rating			Species		(Note 3)	Species	Species	Vertical Edges	Studs	Fig.to Fig	Sheathing	Ply to Ply	Model		(Note 9)	'	Spacing	Embed.
	APA Rated							No. 2		.131"x3"	2 lines of .131"x3"			Simpson	3	, '			1
15/32"	Sheathing 24/0	2x6	16"	No.2 S-P-F	2x6	2	Stud S-P-F	Pressure	.131"x3" @ 4"	@ 12"	@ 8" (Note 4)	N.A.	(Note 3)	HTT22	J ₄ "	9"	1/2"	32"	(Note 6)
	Exposure 1							Treated S.P.		6	O - (,			1111122			<u> </u>		

- Shear Wall Schedule Notes:
 1. Size, grade and species of double top plate shall match studs.
- 2. Where 2 ply end posts are used, the panels shall be fastened to each ply with one line of nails at double the spacing shown in the Shear Wall Schedule.
- 3. Laminate plys of 2 ply end posts to each other with 1 line of .131"x3" @ 6".
- 4. Laminate plys of double top plate to each other with 2 lines of nails sized and spaced as shown in the Shear Wall Schedule.
- 5. In addition to the maximum sill plate anchor bolt spacing, there shall be a minimum of 2 sill plate anchor bolts per piece of plate.
- 6. Minimum concrete embedment for sill plate anchor bolts shall be 7" for cast -in-place anchor bolts and 5-1/2" for expansion anchor bolts.
- 7. The minimum horizontal or vertical dimension of any individual sheathing panel within a wall shall not be less than 2'-0" without permission of the structural engineer.
- 8. Review structural details for possible additional nailing requirements.
- 9. The hold down anchor bolts shall be drilled through the hold down and fastened with an adhesive. Care shall be taken to prepare the hole and install the anchor as required by the adhesive manufacturer.

					N	ONSHEAF	EXTERIOR	WALL SCHEDULE						
Wall	Woo	d Structural		Studs		Sill Plate		Nail s	izes and spacing	S			Sill Plate Ar	nchor Bolts
Description	Pan	els (note 9)	Lumber		Lumber	Lumber		Wall sheathing to	o:		Double	Bottom Plate	(Note	e 4)
	Minimum	Grade and	Size	Spacing	Grade and	Grade and	Double Top	Sill Plates, Sole Plates, and	Intermediate	Rim	Top Plate	to Floor	Diameter	Conc.
	Thickness	Span Rating			Species	Species	Plate (Note 2)	Studs @ Vertical Edges	Studs	Board	Ply to Ply	Sheathing	& Spacing	Embed.
Exterior Walls		APA Rated				No. 2					·		¹ / ₂ " A.B.	
other than Shear Walls	15/32"	Sheathing 24/0	2x6	16"	No. 2 S-P-F	Pressure	.131"x3" @ 6"	.131"x3" @ 6"	.131"x3" @ 12"	.131"x3" @ 6"	(Note 3)	.131"x3" @ 6"	@	(Note 5)
		Exposure 1				Treated S.P.							6" -0" max.	

Nonshear Exterior Wall Schedule Notes:

- 1. Size, grade and species of double top plate and sole plate shall match studs.
- 2. Where the wood structural panels lap over the top ply of the double top plate by 3/4" or more, the panels shall be fastened to each ply with one line of nails at double the spacing shown in the Nonshear Wall Schedule.
- 3. Laminate plys of double top plate to each other with 1 line of .131"x3" @ 12", except at the top plate splice, where the two plys will be nailed as shown in
- 4. There shall be a minimum of 2 sill plate anchor bolts per section of plate and anchor bolts shal be placed a minimum of 12" from each end of each
- 5. Minimum concrete embedment for sill plate anchor bolts shall be 7" for cast -in-place anchor bolts and 5-1/2" for expansion anchor bolts.
- 6. The minimum horizontal or vertical dimension of any individual sheathing panel within a wall shall not be less than 2' 0" without permission of the structural engineer.

RO	OF AND C	EILING STRU	JCTURAL WO	OD PANEL SCHEDULE	
	Minimum	Grade and		Nail sizes and spacings (note 1.)	
Location	Thickness	Span Rating	Diaphragm	Rafters, Trusses, Headers	Intermediate
			Boundry Nailing	Nailers, and Blocking @ Edges	Framing
	19/32 "	APA Rated			
Roof	or	Sheathing 24/0	.131"x3" @ 6"	.131"x3" @ 6"	.131"x3" @ 12"
	5/8"	Exposure 1			
		APA Rated			
Ceiling	15/32 "	Sheathing 24/0	.131"x3" @ 6"	.131"x3" @ 6"	.131"x3" @ 12"
	ŀ	Exposure 1			

Roof Sheathing Schedule Notes:

- 1. Refer to structural details for possible additional nailing requirements.
- 2. The minimum horizontal or vertical dimension of any individual sheathing panel shall not be less than 2'-0" without permission of the structural engineer.

THOUVENOT. WADE & MOERCHEN, INC.



☐ CORPORATE OFFICE 4940 OLD COLLINSVILLE RD. SWANSEA, ILLINOIS 62226 corp@twm-inc.com

☑ WATERLOO OFFICE 113 SOUTH MAIN STREET WATERLOO, ILLINOIS 62298 TEL (618) 939-5050 FAX (618) 939-3938

☐ EDWARDSVILLE OFFICE 1015B CENTURY DRIVE EDWARDSVILLE, ILLINOIS 62025 TEL (618) 656-4040 FAX (618) 656-4343

ST. LOUIS OFFICE

1001 CRAIG ROAD, SUITE 260
ST. LOUIS, MISSOURI 63146 TEL (314) 236-5052 FAX (314) 872-2194 stlouis@twm-inc.com

PROFESSIONAL REGISTRATIONS LICENSE NO. ILLINOIS PROFESSIONAL DESIGN FIRM 184-001220 PROFESSIONAL ENGINEERING CORP. 62–035370
PROFESSIONAL STRUCTURAL ENGR. CORP. 81–005202 MISSOURI PROFESSIONAL ENGR. CORP. NC 001528 MISSOURI LAND SURVEYING CORP. NC 000346

Signature:
Signature Date:
Expiration Date:

STATEMENT OF FIESPONSIBILITY


I hereby confirm that the document herein to be outhenticated by my see is restricted to this sheet, and I hereby disclaim any responsibility for all other drawings, specifications, estimates, reports or other documents or instruments relating to or intended to be utilized for any other part of the architectural, engineering or survey project.


THE SHEAR WALL SCHEDULE
PROJECT: CHESTER WELCOME CENTER

REV.		DESCRIPTION	
Λ	12/16/08	REVISIONS PER IDOT COMMENTS	

DRAWN BY:	DJH		SH	EET
DESIGNED BY:	DJH	9	3	7
CHECKED BY:	KPC	OF	9	SHEETS
APPROVED BY:	KPC	PROJEC	T DE	SCRIPTION
PROJECT NUMBER	T33050421			
ISSUED	FOR REVIEW	☐ ISSUE	EDR	OR BIDDING

IT ISSUED FOR CONSTR. IT RECORD DRAWING

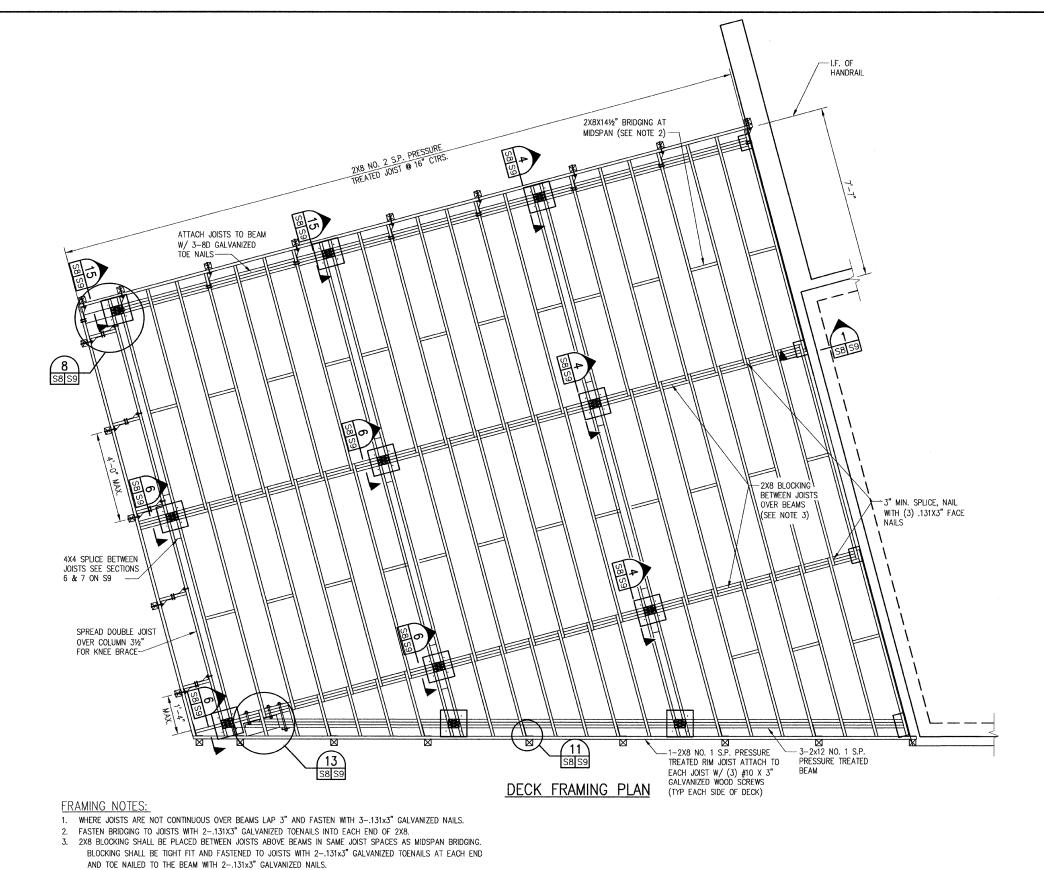

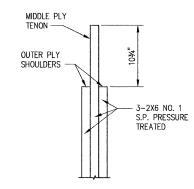


ELEVATION




- LAMINATE COLUMN PLYS WITH 2 LINES OF 16D GALVANIZED NAILS @ 12" EACH SIDE

SECTION

COLUMN DETAILS

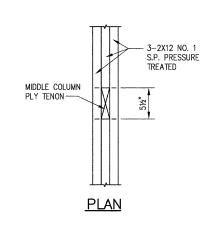

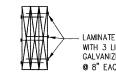

LAMINATE BEAM PLYS WITH 3 LINES OF 0.131 X 3 GALVANIZED NAILS @ 8" EACH SIDE

SECTION

BEAM DETAILS

THOUVENOT, WADE & MOERCHEN, INC. ENGINEERS & SURVEYORS & PLANNERS



4940 OLD COLLINSVILLE RD. SWANSEA, ILLINOIS 62226 TEL (618) 624-4488 FAX (618) 624-6688 corp@twm-inc.com

₩ WATERLOO OFFICE 113 SOUTH MAIN STREET WATERLOO, ILLINOIS 62298

eowdrasvilledriwm-inc.com

ST. LOUIS OFFICE

1001 CRAIG ROAD, SUITE 260
ST. LOUIS, MISSOURI 63146
TEL (314) 236-502
FAX (314) 872-2194

stlouis@twm-inc.com PROFESSIONAL REGISTRATIONS LICENSE NO. ILLINOIS PROFESSIONAL DESIGN FIRM PROFESSIONAL ENGINEERING CORP. 184-001220 62-035370 Professional Structural Engr. Corp. ILLINOIS PROF. LAND SURVEYING CORP. 048-000029

MISSOURI PROFESSIONAL ENGR. CORP. NC 001528 MISSOURI LAND SURVEYING CORP.

Signature Date:

STATEMENT OF FIESPONSIBILITY

I hereby confirm that the document herein to be outherhicated by my seal is restricted to this sheet, and I hereby disclaim any responsibility for all other drawings, specifications, estimates, reports or other documents or instruments relating to or intended to be utilized for any other part of the architectural, engineering or survey project.

THE DECK FRAMING PLAN	
PROJECT: CHESTER WELCOME CENTER	

ഥ			
REV.	DATE	DESCRIPTION	
Λ	12/16/08	REVISIONS PER IDOT COMMENTS	
$\overline{\triangle}$			
$\overline{\wedge}$			

DRAWN BY:	DJH		SH	EET
Designed By:	DJH		S	8
CHECKED BY:	KPC	OF	9	SHEETS
APPROVED BY:	KPC	PROJE	CT DE	SCRIPTION
PROJECT NUMBER	050421			
ISSUED FOR	REVIEW	☐ ISSL	ED F	OR BIDDIN
☐ ISSUED FOR	CONSTR.	☐ REO	ORD	DRAWING

