

189

03-06-2020 LETTING ITEM 189

FOR INDEX OF SHEETS, SEE SHEET NO. 2

STANDARDS


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001006	630301-09	701321-18
280001-07	666001-01	701326-04
406201-01	667101-02	701901-08
420001-09	701001-02	704001-08
482001-02	701006-05	725001-01
482011-03	701011-04	780001-05
515001-04	701201-05	781001-04
542401-03	701301-04	782006-01

DISTRICT 4 STANDARDS

205001	406301	606101
281001	406401	630101
406101	440001	667101
406201	540000	780001
406211		

DESIGN DESIGNATION
MINOR ARTERIAL

TRAFFIC DATA
FAP 574 (IL 41)
ESTIMATED ADT = 1800
SU = 15.28%
MU = 7.22%

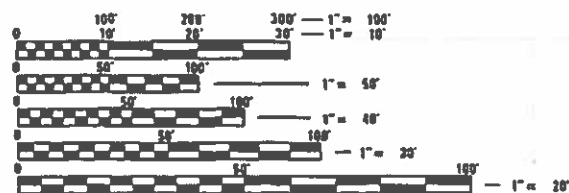

FULL SIZE PLANS HAVE BEEN PREPARED USING STANDARD ENGINEERING SCALES. REDUCED SIZED PLANS WILL NOT CONFORM TO STANDARD SCALES. IN MAKING MEASUREMENTS ON REDUCED PLANS, THE ABOVE SCALES MAY BE USED.

J.U.L.I.E.
JOINT UTILITY LOCATION INFORMATION FOR EXCAVATION
1-800-892-8123
OR 811

PROJECT ENGINEER: MIKE LEWIS (309)671-3454
PROJECT MANAGER: ELIAS ELDERZI (309)671-3482
CATALOG NO. 035274-00D
CONTRACT NO. 68C64


STATE OF ILLINOIS
DEPARTMENT OF TRANSPORTATION

PROPOSED
HIGHWAY PLANS

F.A.P. ROUTE 574 (IL 41)
SECTION (12)CR
PROJECT STP-VQDA (515)
CULVERT REPLACEMENT
FULTON COUNTY

C-94-083-15

Project Begins 60+00
Project Ends 25+20

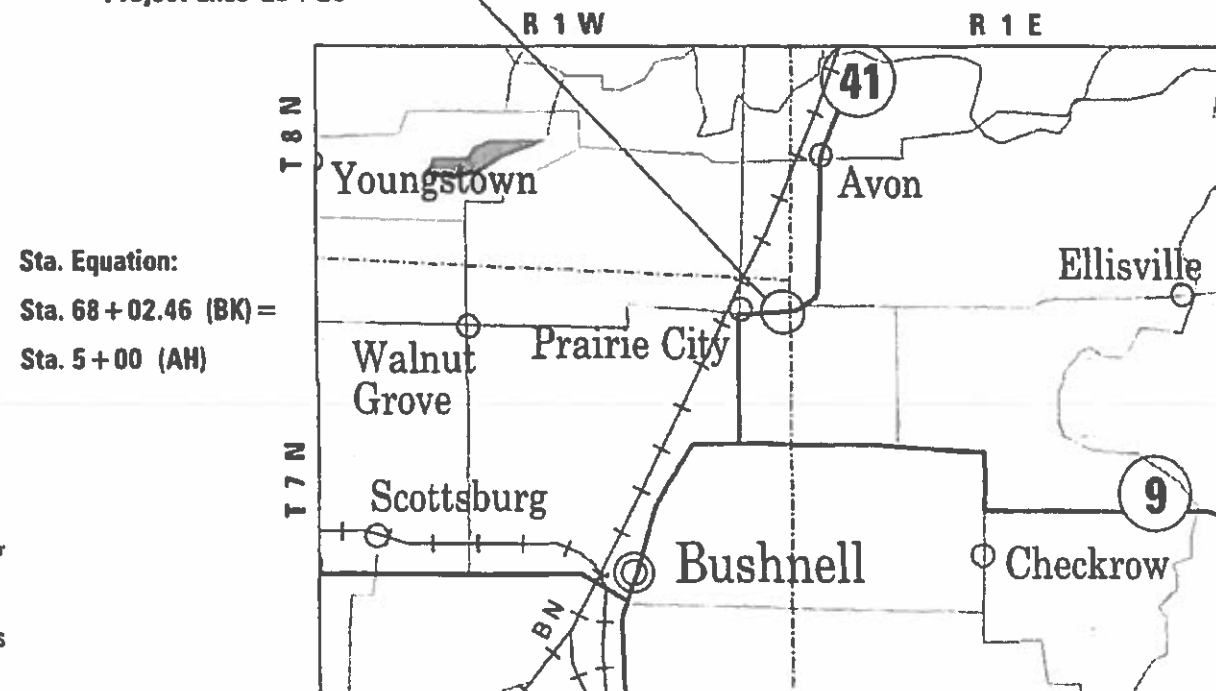


Sta. Equation:
Sta. 68+02.46 (BK) =
Sta. 5+00 (AH)

GROSS LENGTH = 2,822.46 FT. = 0.535 MILE
NET LENGTH = 2,822.46 FT. = 0.535 MILE

F.A.P. RTE	SECTION	COUNTY	TOTAL SHEETS	SHEET NO.
574	(12)CR	FULTON	202	1

* 202 + 2 = 204 TOTAL SHEETS
FULTON, McDONOUGH

D-94-045-15

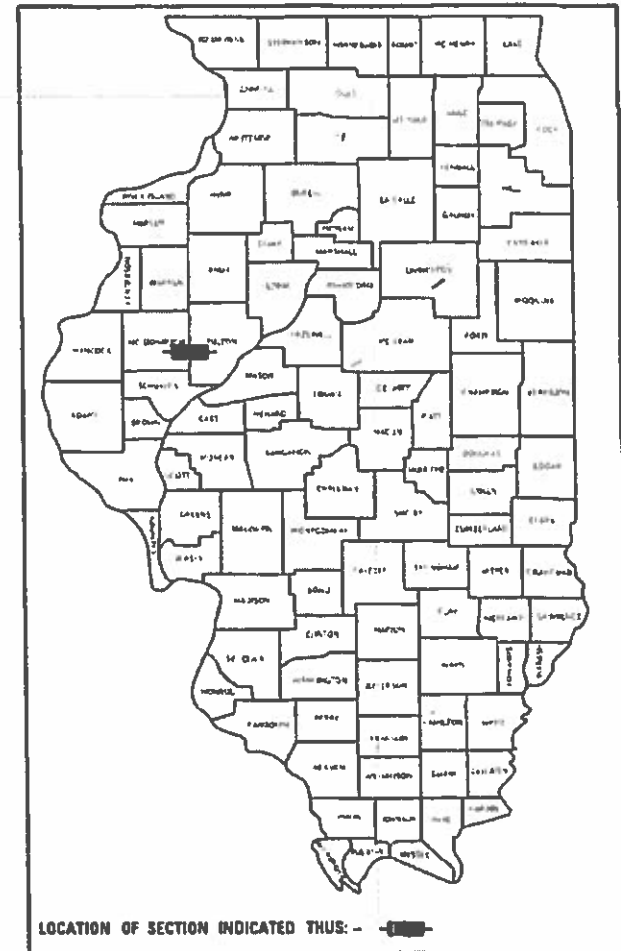

LOCATION OF SECTION INDICATED THUS: - [rectangle] -

Project Description:

This project improvement consists of the removal and replacement of existing culvert over Gallett Creek with a Triple 9' x 7' Box Culvert. Existing S.N. 029-1800 and Proposed S.N. 029-2501. In addition, the pavement will be widened & resurfaced with the placement of new guardrail. This job is located on IL 41, 0.09 miles south of CH 17.

STATE OF ILLINOIS
DEPARTMENT OF TRANSPORTATION

SUBMITTED Oct 18 2019
Keneth A. Harnett, RSP
REGIONAL ENGINEER

Debra L. [Signature]
ENGINEER OF DESIGN AND ENVIRONMENT

Paul P. [Signature]
DIRECTOR OF HIGHWAYS PROJECT IMPLEMENTATION

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OF THE STATE OF ILLINOIS

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COMMITMENTS

Commitments are not to be altered without the written approval of all parties to which the commitment was made.

AVAILABILITY OF ELECTRONIC FILES

Micro Station and GEOPAK files of this project will be made available to the Contractor after contract award. If there is a conflict between the electronic files and the printed contract plans and documents, the printed contract plans and documents shall take precedence over the electronic files. The Contractor shall accept all risk associated with using the electronic files and shall hold the Department harmless for any errors or omissions in the electronic files and the data contained therein. Errors or delays resulting from the use of the electronic files by the Contractor shall not result in an extension of time for any interim or final completion date or shall not be considered cause for additional compensation. The Contractor shall not use, share, or distribute these electronic files except for the purpose of constructing this contract. Any claims by third parties due to use or errors shall be the responsibility of the Contractor. The Contractor shall include this disclaimer with the transfer of these electronic files to any other parties and shall include appropriate language binding them to similar responsibilities.

TREE REMOVAL – UTILITY RELOCATION

Tree removal may be necessary prior to utility companies being able to relocate their facilities outside the construction limits. The Contractor should coordinate any contract tree removal activities with the utility companies to eliminate conflicts and potential delays caused by utility tree removal activities or incomplete utility relocations.

PLAN ELEVATIONS – U. S. G. S. MEAN SEA LEVEL DATUM

Use one of the following two options.

1. All elevations shown on the plans are established from U. S. G. S. mean sea level datum.
2. All elevations shown refer to U. S. G. S. datum at mean sea level unless otherwise noted.

PROPERTY OWNER ACCESS REQUIREMENTS

Access must be maintained to all existing properties during construction per Article 107.09 unless arrangements are made in writing by the Contractor with the property owners with a copy to the Engineer for short-term closures.

TREE REMOVAL

The District Four Tree Committee should be contacted and prior approval obtained for any tree removal beyond the limits/locations included in the plans.

CHANGEABLE MESSAGE BOARDS

Changeable message boards shall be installed on both ends of IL 41 for the entire duration of the project that states "Traffic Signal Ahead"/"Expect 2 (two) min wait on red".

AGGREGATE SHOULDERS, TYPE B

Aggregate Shoulders, Type B shall be required for all granular construction of side roads, entrances, and mailbox turnouts, whether or not portions of the surfaces thus constructed are to be covered with a bituminous surface, except where noted differently on the plans.

AGGREGATE FOR DRIVEWAY REPLACEMENT

The material used for construction of permanent aggregate driveways shall be gravel or crushed stone, as directed by the Engineer, to replace in kind the existing aggregate driveways.

No additional compensation shall be provided for this requirement but shall be considered as included in the cost of the pay item for the aggregate as specified on the plans.

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PLOT DATE = 2/4/2020	DATE -	REVISED -

**STATE OF ILLINOIS
DEPARTMENT OF TRANSPORTATION**

**INDEX OF SHEETS, GENERAL NOTES
& COMMITMENTS**

F.A.P. SITES	SECTION	COUNTY	TOTAL SHEETS	SHEET NO.
574	(12)CR		114	2
CONTRACT NO. 68C64				
SCALE:	SHEET	OF	SHEETS	STA. TO STA.

* FULTON / McDONOUGH

PAVEMENT STATIONING NUMBERS & PLACEMENT

The Contractor shall provide labor and materials required to imprint pavement station numbers in the finished surface of the pavement and/or overlay. The numbers shall be approximately 3/4 inch (20mm) wide, 5 inches (125 mm) high and 5/8 inch (15 mm) deep.

The pavement station numbers shall be installed as specified herein:

Interval – 200 feet (English stationing) or 100 meters (metric stationing)

Bottom of Numbers – 6 inches (150 mm) from the inside edge of the pavement marking

Location:

- * 2,3, & 5 Lane Pavements – right edge of pavement in direction of increasing stations
- * Multi-Lane Divided Roadways – outside edge of pavement in both directions
- * Ramps – along baseline edge of pavement

Position – stations shall be placed so they can be read from the adjacent shoulder

Format – English (Metric) pavement stations shall use this format "XXX (XX + X00)" where X represents the pavement station

This work will not be paid for separately, but will be considered included in the cost of the associated pavement and/or overlay pay items.

NO PASSING ZONE VERIFICATION

The resident shall contact Operations to verify the location of no passing zones prior to placement of centerline striping.

POLYMERIZED BITUMINOUS MATERIALS (TACK COAT) RATES

Surface Type	Residual Rate
Milled (HMA or PCC)	0.08 lb /sq ft
Existing Pavement	0.08 lb /sq ft
Fog Coat (between lifts)	0.08 lb /sq ft

ENVIRONMENTAL REVIEWS

Prior to the use of any proposed borrow areas, use areas (temporary access roads, detours, run-arounds, etc.) and/or waste areas, the Contractor shall file the required environmental resource request surveys according to Section 107.22 of the Standard Specifications. These surveys are required in order for the Department to conduct cultural and biological resource surveys for the proposed site.

Prior to any waste materials being removed from the construction site the required environmental resource surveys will need to be obtained and filed by the Contractor. Excess waste products removed from the construction site shall be disposed of as required in Section 202.03 of the Standard Specifications.

Any protruding metal bars shall be removed prior to the disposal of broken concrete at approved disposal sites.

The required environmental resource documentation shall include the following:

- * BDE Form 2289 (Environmental Survey Request)
- * BDE Form 2290 (Waste/Use Area Review)
- * A location map showing the size limits and location of the use area
- * Color photographs depicting the use area
- * Borrow Area Entry Agreement form–D4 PI0101

Please note that a minimum of four weeks shall be allowed for the District to obtain the required environmental clearances and six weeks for the required borrow site environmental clearances.

HOT-MIX ASPHALT MIXTURE REQUIREMENTS

Mixture Use(s):	Surface 1.5" (includes Shoulder Surface)	Polymerized HMA Binder 1"	HMA Base Course & Widening	Shoulders (Lower Lifts)	Shoulders (Surface Lift) & Incidental
AC/PG:	PG 64-22	SBS or SBR 76-22	PG 64-22	PG 64-22	PG 64-22
Design Air Voids:	4.0% @ N=50	4.0% @ N=50	4.0% @ N=50	4.0% @ N=50	4.0% @ N=50
Mixture Composition: (Mixture Gradation)	IL 9.5	IL 4.75	IL 19.0	IL 19.0	IL 9.5
Friction Aggregate:	Mix D	N.A.	N.A.	N.A.	Mix D
Quality Management Program:	QCQA	QCQA	QCQA	QCQA	QCQA

Note:
1) Individual lift thickness of each mix type will be no less than 3 times nominal maximum aggregate size and no more than 6 times nominal maximum aggregate size, unless otherwise approved by the Engineer.

2) For design purposes, mixture weight for all mixes is determined to be 112.0 lb/s.y./in., unless otherwise noted.

3) Sublot sizes for PFP and QCP mixes will be 1000 tons, unless otherwise agreed to by the Engineer and the paving contractor.

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DRAWN -	REVISED -	574						(12)CR	*	202	3	
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PLOT DATE = 10/18/2019	DATE -	REVISED -						ILLINOIS FED. AID PROJECT				

BUTT JOINT CUTTING TIME RESTRICTION

Butt joints shall not be milled more than three (3) days prior to placement of the HMA surface course.

PAVING SURFACE COURSE

Continuous paving operations on the main roadway shall be maintained at all times during the construction of the hot-mix asphalt surface. No interruptions for side roads, entrances, turn lanes, etc. will be allowed.

ORDERING LENGTH CONFIRMATION – DRAINAGE ITEMS

The Contractor shall consult with the Engineer in regard to the exact length of the box/pipe culverts, storm sewers, and/or pipe drains required prior to ordering these items.

ENGINEERS FIELD OFFICE

Add the following sentence to the end of paragraph 670.02 (i) and 670.04 (e):
All of the telephone lines provided shall have unpublished numbers.

RIGHT-OF-WAY MARKERS

When installing right-of-way markers, care shall be taken to not disturb any existing property/right-of-way pins. If a property/right-of-way pin is found at the location of a proposed right-of-way marker, the marker shall be placed one (1) foot in front of the pin.

JOB SPECIFIC NOTES

Existing Drains

– At locations where existing clean water drains are outlet into existing ditches, the drain shall be cut or extended to drain into the proposed ditch. This work shall be included in the unit cost for EARTH EXCAVATION.

Entrances

– Aggregate for temporary access shall be used during stage construction as directed by the Engineer. The Contractor will be responsible for maintaining 10' access during stage construction. The removal of the aggregate will be included in the cost of the AGGREGATE FOR TEMPORARY ACCESS pay item.

EARTH EXCAVATION

– Excavation required for BITUMINOUS SHOULDERS, AGGREGATE SHOULDERS, BITUMINOUS WIDENING & SUBBASE is measured and paid for as EARTH EXCAVATION.

PAVEMENT REMOVAL

– PAVEMENT REMOVAL shall include existing gutter, overlays and PCC pavement. The cost shall be included in the cost of PAVEMENT REMOVAL and no additional compensation will be allowed.

PERMANENT SURVEY MARKERS, TYPE II

A PERMANENT SURVEY MARKER, TYPE II shall be set at Sta. 14 + 00, offset 48' left.

A copy of all designations including the centerline, survey point, and elevation shall be sent to the Chief of Surveys, Illinois Department of Transportation, Region Three/District 4, Peoria, Illinois.

The supplying, drilling, setting of disks, professional services, labor and any other additional work required to perform this work shall be paid for under the pay item for PERMANENT SURVEY MARKERS, TYPE II.

Refer to District 4 CADD Standard 667101 for details.

Shoulder Resurfacing

1 1/2" of surface course shall be placed as the top lift for the mainline and shoulders. This will be paid for as HOT -MIX ASPHALT SURFACE COURSE, IL 9-5, MIX "D", N50.

Shoulders that are 3' to 4' in width shall be paved at the same time as the mainline paving and no additional compensation will be allowed. Shoulders that exceed 4' in width shall be paved separately.

HOT-MIX ASPHALT BASE COURSE WIDENING, 9"

The Contractor shall fill all pavement removal locations with the HMA material in the same day that it is removed. No removal locations will be allowed to remain overnight.

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AMEREN ILLINOIS (GAS)

ROUTE	OFFSET	LOCATION	TYPE OF UTILITY	TYPE OF CONFLICT	DISPOSITION
IL 41	45' LT	Sta. 13+00	3" Steel Gas	Earthwork / Ditch Cut	Relocate
IL 41	45' LT	Sta. 15+00 to 19+00	3" Steel Gas	Earthwork / Ditch Cut	Relocate

SPOON RIVER ELECTRIC CO-OP

ROUTE	OFFSET	LOCATION	TYPE OF UTILITY	TYPE OF CONFLICT	DISPOSITION
IL 41	28' LT	Sta. 15+66	Pole	Earthwork / Ditch Cut	Relocate
IL 41	29' LT	Sta. 18+92	Pole	Earthwork / Fill	Relocate
IL 41	30' LT	Sta. 22+32	Pole	Earthwork	Caution
IL 41	29' LT	Sta. 14+15	Pole	Earthwork / Ditch Cut	Relocate

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CODE NO.	ITEM	UNIT	TOTAL QUANTITY	CONSTRUCTION CODE	
				FULTON	
				0004	
				80% FED/20% STATE	
20100110	TREE REMOVAL (6 TO 15 UNITS DIAMETER)	UNIT	27	27	
20100500	TREE REMOVAL, ACRES	ACRE	0.25	0.25	
20200100	EARTH EXCAVATION	CU YD	6735	5735	
20700220	POROUS GRANULAR EMBANKMENT	CU YD	932	932	
21101615	TOPSOIL FURNISH & PLACE, 4"	SQ YD	10238	10238	
25000210	SEEDING, CLASS 2A	ACRE	2.25	2.25	
25000400	NITROGEN FERTILIZER NUTRIENT	POUND	190	190	
25000500	PHOSPHORUS FERTILIZER NUTRIENT	POUND	190	190	
25000600	POTASSIUM FERTILIZER NUTRIENT	POUND	190	190	
** 25000750	MOWING	ACRE	3.5	3.54	
25100115	MULCH, METHOD 2	ACRE	2.25	2.25	
25100630	EROSION CONTROL BLANKET	SQ YD	1799	1799	
25200200	SUPPLEMENTAL WATERING	UNIT	35	35	
28000250	TEMPORARY EROSION CONTROL SEEDING	POUND	423	423	

*100% STATE

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**STATE OF ILLINOIS
DEPARTMENT OF TRANSPORTATION**

SUMMARY OF QUANTITIES

F.A.P. RTE.	SECTION	COUNTY	TOTAL SHEETS	SHEET NO.
574	(12) CR	*	202	6
CONTRACT NO. 68C64				

ILLINOIS FED. AID PROJECT

• FULTON

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CODE NO.	ITEM	UNIT	TOTAL QUANTITY	CONSTRUCTION CODE	
				FULTON	
				0004	
				80% FED/20% STATE	
28000305	TEMPORARY DITCH CHECKS	FOOT	511	511	
28000400	PERIMETER EROSION BARRIER	FOOT	850	850	
28000500	INLET AND PIPE PROTECTION	EACH	2	2	
28100107	STONE RIPRAP, CLASS A4	SQ YD	849	849	
28200200	FILTER FABRIC	SQ YD	1236	1236	
30300112	AGGREGATE SUBGRADE IMPROVEMENT 12"	SQ YD	4467	4467	
35501320	HOT - MIX ASPHALT BASE COURSE, 9"	SQ YD	1750.4	1750.4	
35600712	HOT - MIX ASPHALT BASE COURSE WIDENING, 9"	SQ YD	639.2	639.2	
40200800	AGGREGATE SURFACE COURSE, TYPE B	TON	464.4	464.4	
40201000	AGGREGATE FOR TEMPORARY ACCESS	TON	131	131	
40600295	POLYMERIZED BITUMINOUS MATERIALS (TACK COAT)	POUND	10526	10526	
40600982	HOT - MIX ASPHALT SURFACE REMOVAL - BUTT JOINT	SQ YD	268	268	
40600990	TEMPORARY RAMP	SQ YD	55.5	55.5	
40603200	POLYMERIZED HOT-MIX ASPHALT BINDER COURSE, IL-4.75, N50	TON	308.1	308.1	

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STATE OF ILLINOIS
DEPARTMENT OF TRANSPORTATION

SUMMARY OF QUANTITIES

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574	(12) CR	*	202	7
CONTRACT NO. 68C64				

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				FULTON	80% FED/20% STATE
				0004	
40604060	HOT-MIX ASPHALT SURFACE COURSE, IL-9.5, MIX "D", N50	TON	760.2	760,2	
40800050	INCIDENTAL HOT - MIX ASPHALT SURFACING	TON	16.8	16.8	
44000100	PAVEMENT REMOVAL	SQ YD	2454	2454	
44000153	HOT - MIX ASPHALT SURFACE REMOVAL, 1"	SQ YD	5292	5292	
44000400	GUTTER REMOVAL	FOOT	50	50	
44200152	PAVEMENT PATCHING, TYPE I, 13 INCH	SQ YD	44	44	
44200156	PAVEMENT PATCHING, TYPE II, 13 INCH	SQ YD	50	50	
44200160	PAVEMENT PATCHING, TYPE III, 13 INCH	SQ YD	15	15	
44200162	PAVEMENT PATCHING, TYPE IV, 13 INCH	SQ YD	110	110	
44300200	STRIP REFLECTIVE CRACK CONTROL TREATMENT	FOOT	1438	1438	
48101200	AGGREGATE SHOULDERS, TYPE B	TON	41.4	41,4	
48101500	AGGREGATE SHOULDERS, TYPE B 6"	SQ YD	1047	1047	
48203023	HOT - MIX ASPHALT SHOULDERS, 6 1/2"	SQ YD	504	504	
48203033	HOT - MIX ASPHALT SHOULDERS, 9"	SQ YD	1171	1171	

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**STATE OF ILLINOIS
 DEPARTMENT OF TRANSPORTATION**

SUMMARY OF QUANTITIES

F.A.P. RTE.:	SECTION	COUNTY	TOTAL SHEETS	SHEET NO.
574	(12) CR	*	202	8
ILLINOIS LEED AID PROJECT			CONTRACT NO. 68C64	

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				0004	
				80% FED/20% STATE	
50102400	CONCRETE REMOVAL	CU YD	4.4	4.4	
50105220	PIPE CULVERT REMOVAL	FOOT	70	70	
50200450	REMOVAL AND DISPOSAL OF UNSUITABLE MATERIAL FOR STRUCTURES	CU YD	258	258	
50800205	REINFORCEMENT BARS, EPOXY COATED	POUND	70470	70470	
50800515	BAR SPLICERS	EACH	160	160	
51500100	NAME PLATES	EACH	1	1	
52200020	TEMPORARY SOIL RETENTION SYSTEM	SQ FT	1046	1046	
52200600	GEOTEXTILE RETAINING WALL	SQ FT	176	176	
54003000	CONCRETE BOX CULVERTS	CU YD	294.8	294.8	
54213450	END SECTIONS 15"	EACH	4	4	
542D0220	PIPE CULVERTS, CLASS D, TYPE 1 15"	FOOT	110	110	
60600095	CLASS SI CONCRETE (OUTLET)	CU YD	23.5	23.5	
* 63000001	STEEL PLATE BEAM GUARD RAIL, TYPE A, 6 FOOT POSTS	FOOT	412.5	412.5	
* 63000030	STONG POST GUARDRAIL ATTACHED TO CULVERT	FOOT	42	42	

*= SPECIALTY ITEM

USER NAME = everscl	DESIGNED -	REVISED -
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	DATE -	REVISED -

**STATE OF ILLINOIS
 DEPARTMENT OF TRANSPORTATION**

SUMMARY OF QUANTITIES

F.A.P. RTE.	SECTION	COUNTY	TOTAL SHEETS	SHEET NO.
574	(12) CR	-	202	9
CONTRACT NO. 68C64				

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				00 04	
				80% FED/20% STATE	
* 63100167	TRAFFIC BARRIER TERMINAL, TYPE 1 (SPECIAL) TANGENT	EACH	4	4	
63200310	GUARDRAIL REMOVAL	FOOT	713	713	
* 66600105	FURNISHING AND ERECTING RIGHT-OF-WAY MARKERS	EACH	13	13	
* 66700205	PERMANENT SURVEY MARKERS, TYPE I	EACH	5	5	
* 66700305	PERMANENT SURVEY MARKERS, TYPE II	EACH	1	1	
67000400	ENGINEER'S FIELD OFFICE, TYPE A	CAL MO	8	8	
67100100	MOBILIZATION	L SUM	1	1	
70100405	TRAFFIC CONTROL AND PROTECTION, STANDARD 701321	EACH	1	1	
70100450	TRAFFIC CONTROL AND PROTECTION, STANDARD 701201	L SUM	1	1	
70100460	TRAFFIC CONTROL AND PROTECTION, STANDARD 701306	L SUM	1	1	
70100500	TRAFFIC CONTROL AND PROTECTION, STANDARD 701326	L SUM	1	1	
70103815	TRAFFIC CONTROL SURVEILLANCE	CAL DA	15	15	
70106500	TEMPORARY BRIDGE TRAFFIC SIGNALS	EACH	1	1	
70106700	TEMPORARY RUMBLE STRIP	EACH	6	6	

*= SPECIALTY ITEM

USER NAME = everscl	DESIGNED -	REVISED -
PLOT SCALE = 100.0000' / 1in.	DRAWN -	REVISED -
PLOT DATE = 10/18/2019	CHECKED -	REVISED -
	DATE -	REVISED -

**STATE OF ILLINOIS
DEPARTMENT OF TRANSPORTATION**

SUMMARY OF QUANTITIES

F.A.P. RTE.	SECTION	COUNTY	TOTAL SHEETS	SHEET NO.
574	(12) CR	*	202	10
			CONTRACT NO. 68C64	

CODE NO.	ITEM	UNIT	TOTAL QUANTITY	CONSTRUCTION CODE	
				FULTON	80% FED/20% STATE
				0004	
70300100	SHORT-TERM PAVEMENT MARKING	FOOT	768	768	
70300150	SHORT TERM PAVEMENT MARKING REMOVAL	SO FT	86	86	
70300220	TEMPORARY PAVEMENT MARKING - LINE 4"	FOOT	4872	4872	
70300280	TEMPORARY PAVEMENT MARKING - LINE 24"	FOOT	48	48	
70400100	TEMPORARY CONCRETE BARRIER	FOOT	1212.5	1212.5	
70400200	RELOCATE TEMPORARY CONCRETE BARRIER	FOOT	775	775	
70600250	IMPACT ATTENUATORS, TEMPORARY (NON-REDIRECTIVE), TEST LEVEL 3	EACH	2	2	
70600251	IMPACT ATTENUATORS, TEMPORARY (NON- REDIRECTIVE, NARROW), TEST LEVEL 3	EACH	2	2	
70600350	IMPACT ATTENUATORS, RELOCATE (NON- REDIRECTIVE), TEST LEVEL 3	EACH	2	2	
* 72501000	TERMINAL MARKER - DIRECT APPLIED	EACH	4	4	
* 78009004	MODIFIED URETHANE PAVEMENT MARKING - LINE 4"	FOOT	8702	8702	
* 78200005	GUARDRAIL REFLECTORS, TYPE A	EACH	8	8	
X0327980	PAVEMENT MARKING REMOVAL - WATER BLASTING	SO FT	1720	1720	
X4400196	HOT - MIX ASPHALT SURFACE REMOVAL, SPECIAL	SO YD	136	136	

*= SPECIALTY ITEM

MODEL - D:\eul\...
 FILE NAME: ...
 PROJECTS\...
 ILLINOIS STATE...
 ILLINOIS STATE...
 ILLINOIS STATE...

USER NAME = everscl	DESIGNED -	REVISED -
PLOT SCALE = 100.0000' / 1in.	DRAWN -	REVISOR -
PLOT DATE = 10/18/2019	CHECKED -	REVISOR -
	DATE -	REVISOR -

**STATE OF ILLINOIS
DEPARTMENT OF TRANSPORTATION**

SUMMARY OF QUANTITIES

F.A.P. RTE.	SECTION	COUNTY	TOTAL SHEETS	SHEET NO.
574	(12) CR	*	202	11
CONTRACT NO. 68C64				
ILLINOIS FED. AID PROJECT				
* FULTON				

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CODE NO.	ITEM	UNIT	TOTAL QUANTITY	CONSTRUCTION CODE	
				FULTON	
				0004	
				80% FED/20% STATE	
X6062700	CONCRETE GUTTER, TYPE A (SPECIAL)	FOOT	466	466	
70107025	CHANGEABLE MESSAGE SIGN	CAL DA	200	200	
X7040125	PINNING TEMPORARY CONCRETE BARRIER	EACH	405	405	
XZ013798	CONSTRUCTION STATION LAYOUT	L SUM	1	1	
Z0001002	GUARDRAIL AGGREGATE EROSION CONTROL	TON	66	66	
Z0013798	CONSTRUCTION LAYOUT	L SUM	1	1	
Z0016600	DETOUR ROADWAY REMOVAL	SQ YD	933.4	933.4	
Z0022800	FENCE REMOVAL	FOOT	564	564	
Z0023200	FILLING DRAINAGE STRUCTURES	EACH	1	1	
Z0034105	MATERIAL TRANSFER DEVICE	TON	1068	1068	
* Z0054402	ROCK FILL - REPLACEMENT	TON	464	464	
∅ Z0076600	TRAINEES	HOUR	1000	1000	
∅ Z0076604	TRAINEES - TRAINING PROGRAM GRADUATES	HOUR	1000	1000	


*= SPECIALTY ITEM ∅ 0042

USER NAME = everscl	DESIGNED -	REVISED -
	DRAWN -	REVISED -
PLOT SCALE = 100.0000' / 1in.	CHECKED -	REVISED -
PLOT DATE = 10/18/2019	DATE -	REVISED -

**STATE OF ILLINOIS
 DEPARTMENT OF TRANSPORTATION**

SUMMARY OF QUANTITIES

F.A.P. RTE.:	SECTION	COUNTY	TOTAL SHEETS	SHEET NO.
574	(12) CR	*	202	12
CONTRACT NO. 68C64				

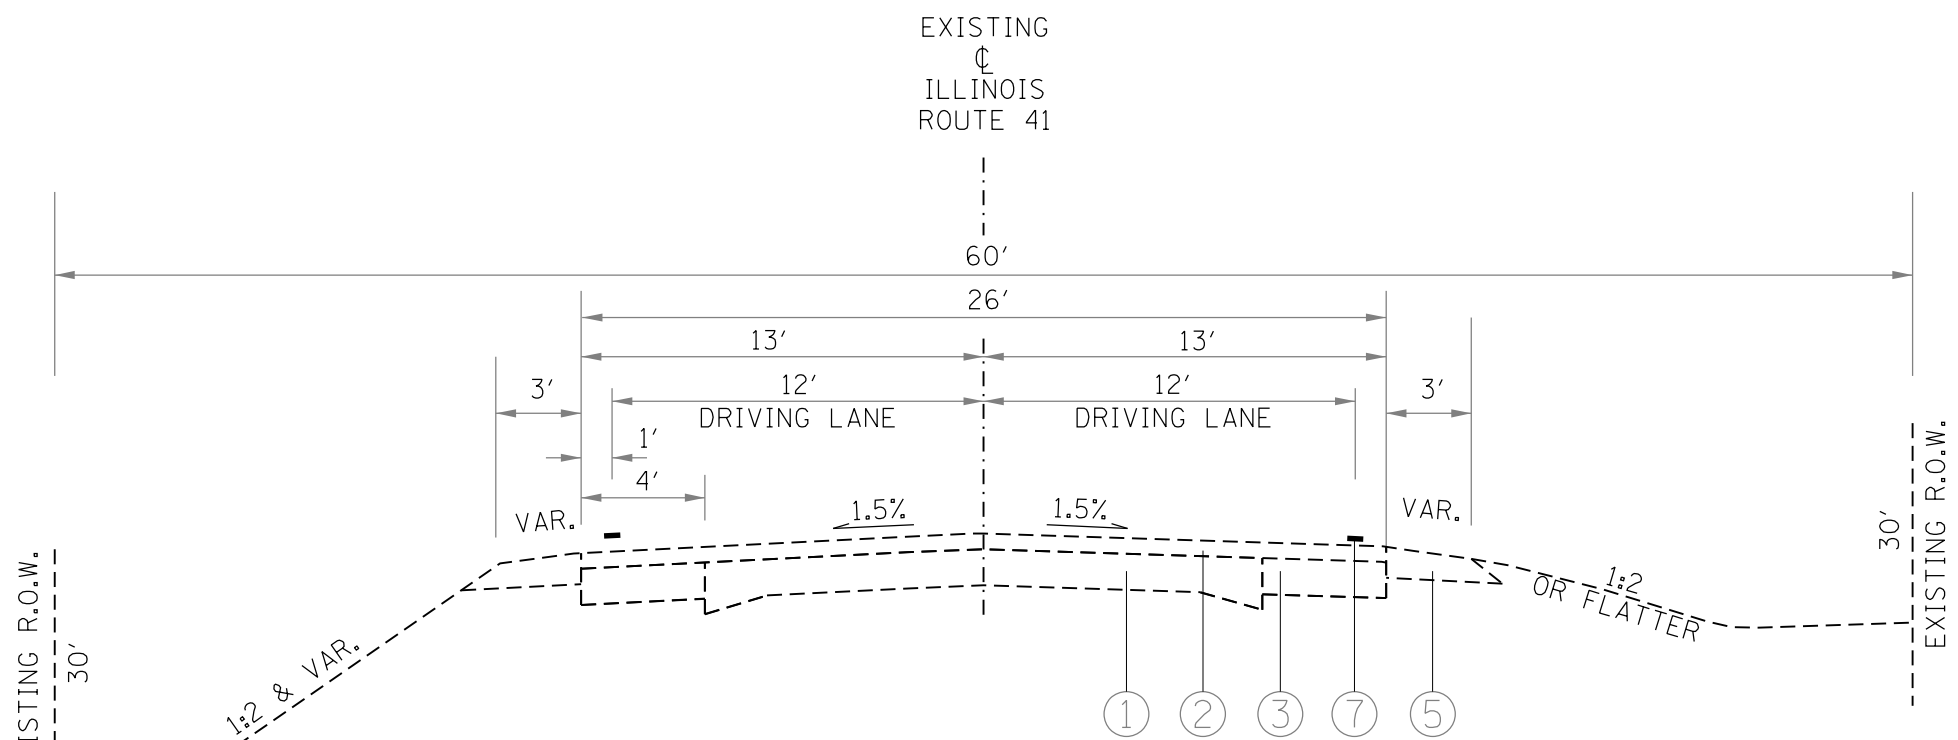


EXISTING TYPICAL SECTION
 STA 60+00 TO STA 6+32
 STA EQ 68+02.46(BK)=5+00(AH)

*SUPER ELEVATED FROM STA 61+00 TO 5+00


LEGEND

- ① EXISTING PCC PAVEMENT
- ② EXISTING HMA OVERLAY
- ③ EXISTING BASE COURSE WIDENING
- ④ EXISTING CONCRETE GUTTER
- ⑤ EXISTING AGGREGATE SHOULDERS
- ⑥ EXISTING GUARDRAIL
- ⑦ EXISTING PAVEMENT MARKING
- ⑩ PROPOSED HMA SURFACE COURSE, 1 1/2"
- ⑪ PROPOSED POLYMERIZED HMA BINDER COURSE, 1"
- ⑫ PROPOSED HMA BASE COURSE WIDENING, 9"
- ⑬ PROPOSED AGGREGATE SUBGRADE IMPROVEMENT, 12"
- ⑭ PROPOSED HMA SHOULDERS
- ⑮ PROPOSED AGGREGATE SHOULDERS, TY B
- ⑯ PROPOSED STEEL PLATE BEAM GUARDRAIL, TY A
- ⑰ PROPOSED GUARDRAIL AGGREGATE EROSION CONTROL
- ⑱ PROPOSED CONCRETE GUTTER, TY A (SPL)
- ⑲ PROPOSED HMA SURFACE REMOVAL, 1"
- ⑳ PROPOSED PAVEMENT MARKING
- ㉑ PROPOSED AGGREGATE SHOULDER, TY B 6"
- ㉒ PROPOSED AGGREGATE SURFACE COURSE, TY B
- ㉓ PROPOSED HMA REMOVAL (SPECIAL)
- ㉔ PROPOSED STRIP REFLECTIVE CRACK CONTROL TREATMENT
- ㉕ PROPOSED HMA BASE COURSE, 9"

FILE NAME =	USER NAME = everscd	DESIGNED -	REVISED -	STATE OF ILLINOIS DEPARTMENT OF TRANSPORTATION	ILLINOIS ROUTE 41 TYPICAL SECTIONS	F.A.P. RTE.	SECTION	COUNTY	TOTAL SHEETS	SHEET NO.	
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Default	PLOT SCALE = 100,0000' / in.	DATE -	REVISED -			CONTRACT NO. 68C64					
	PLOT DATE = 10/18/2019					SCALE: NOT TO SCALE	SHEET	OF	SHEETS	STA. 60+00	TO STA. 6+32

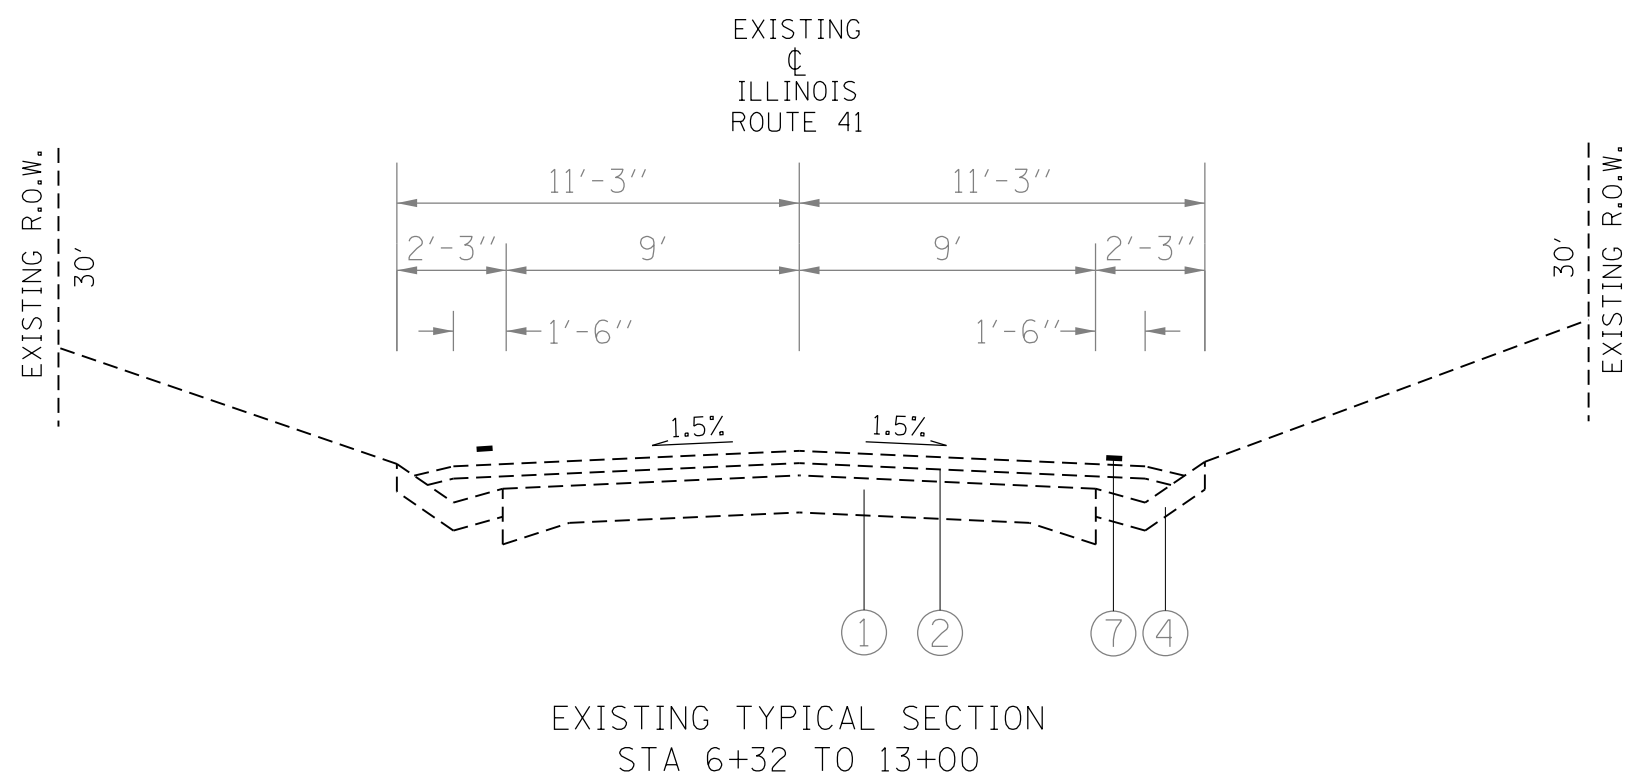


EXISTING TYPICAL SECTION
STA 6+32 TO 13+00

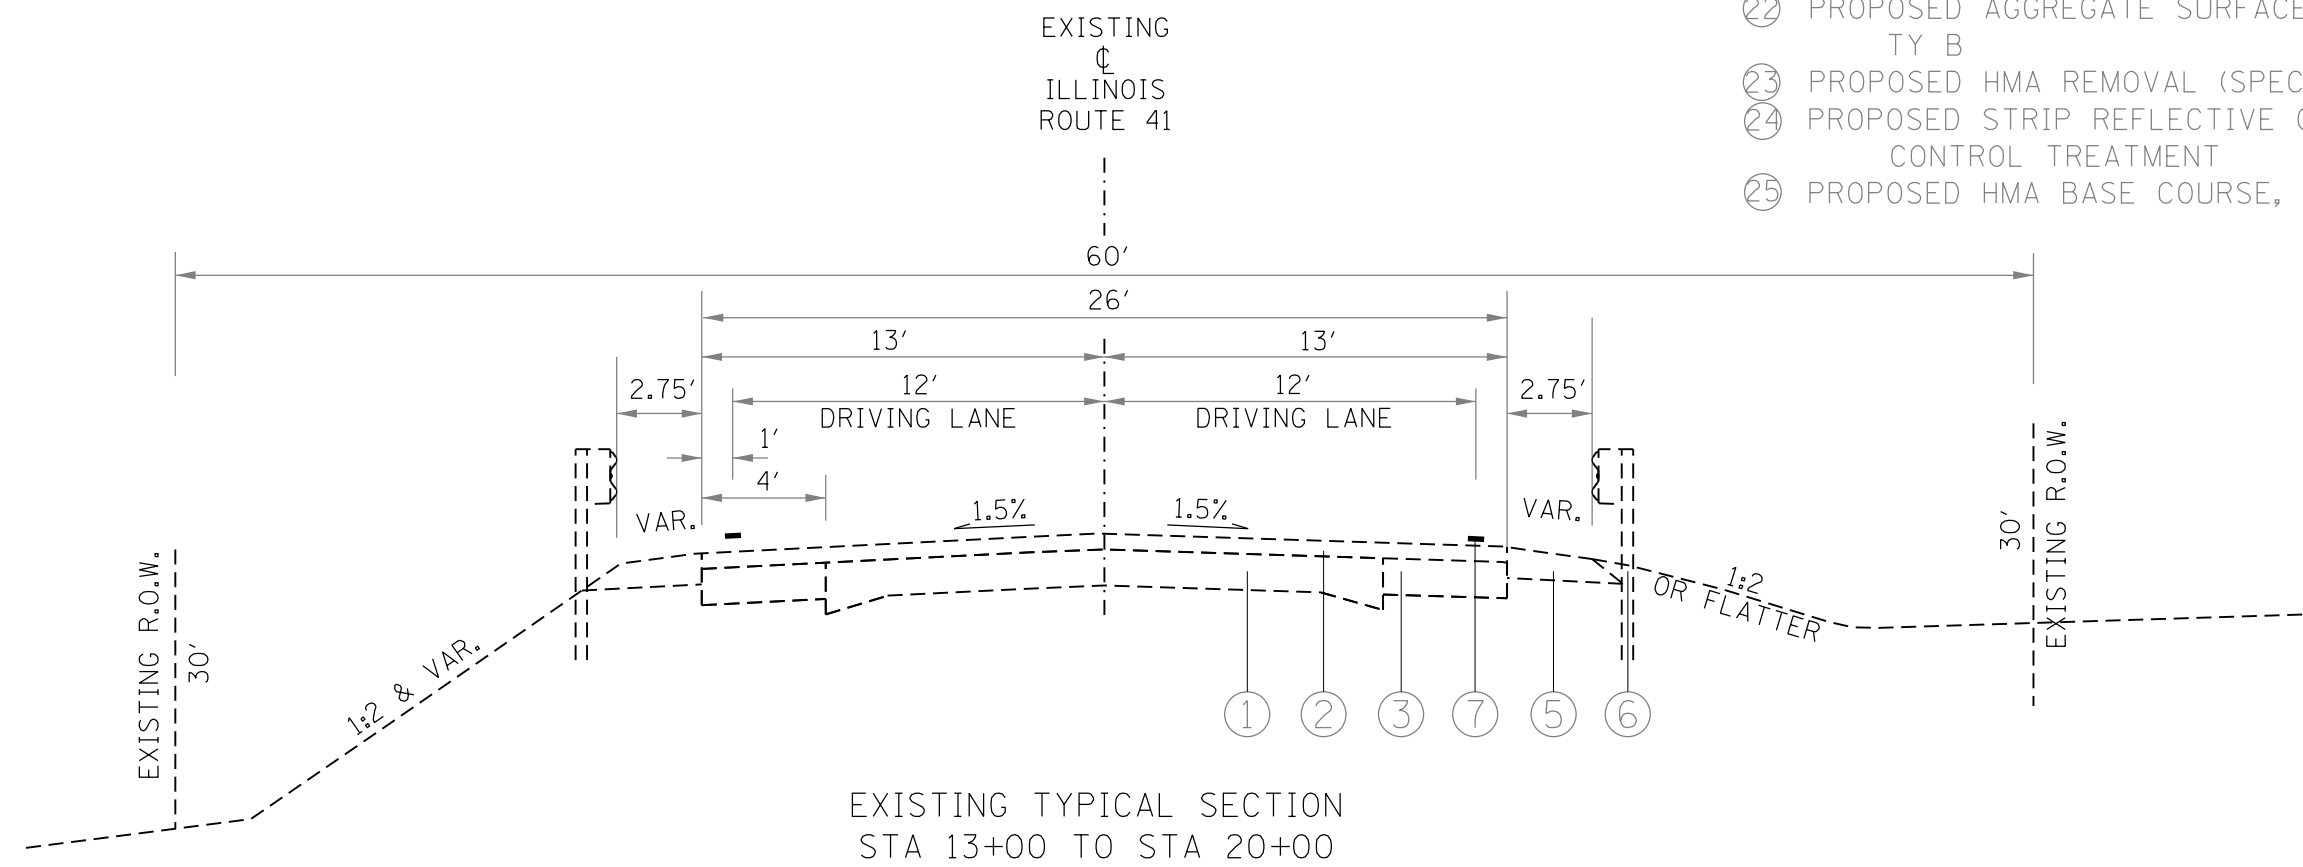

EXISTING TYPICAL SECTION
STA 13+00 TO STA 20+00


- LEGEND
- ① EXISTING PCC PAVEMENT
 - ② EXISTING HMA OVERLAY
 - ③ EXISTING BASE COURSE WIDENING
 - ④ EXISTING CONCRETE GUTTER
 - ⑤ EXISTING AGGREGATE SHOULDERS
 - ⑥ EXISTING GUARDRAIL
 - ⑦ EXISTING PAVEMENT MARKING
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 - ⑪ PROPOSED POLYMERIZED HMA BINDER COURSE, 1"
 - ⑫ PROPOSED HMA BASE COURSE WIDENING, 9"
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 - ⑱ PROPOSED CONCRETE GUTTER, TY A (SPL)
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 - ㉒ PROPOSED AGGREGATE SURFACE COURSE, TY B
 - ㉓ PROPOSED HMA REMOVAL (SPECIAL)
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 - ㉕ PROPOSED HMA BASE COURSE, 9"

FILE NAME =	USER NAME = everscd	DESIGNED -	REVISED -	STATE OF ILLINOIS DEPARTMENT OF TRANSPORTATION	ILLINOIS ROUTE 41 TYPICAL SECTIONS	F.A.P. RTE.	SECTION	COUNTY	TOTAL SHEETS	SHEET NO.
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Default	PLOT DATE = 10/18/2019	DATE -	REVISED -			CONTRACT NO. 68C64			ILLINOIS	FED. AID PROJECT
						SCALE: NOT TO SCALE	SHEET	OF	SHEETS	STA. 6+32

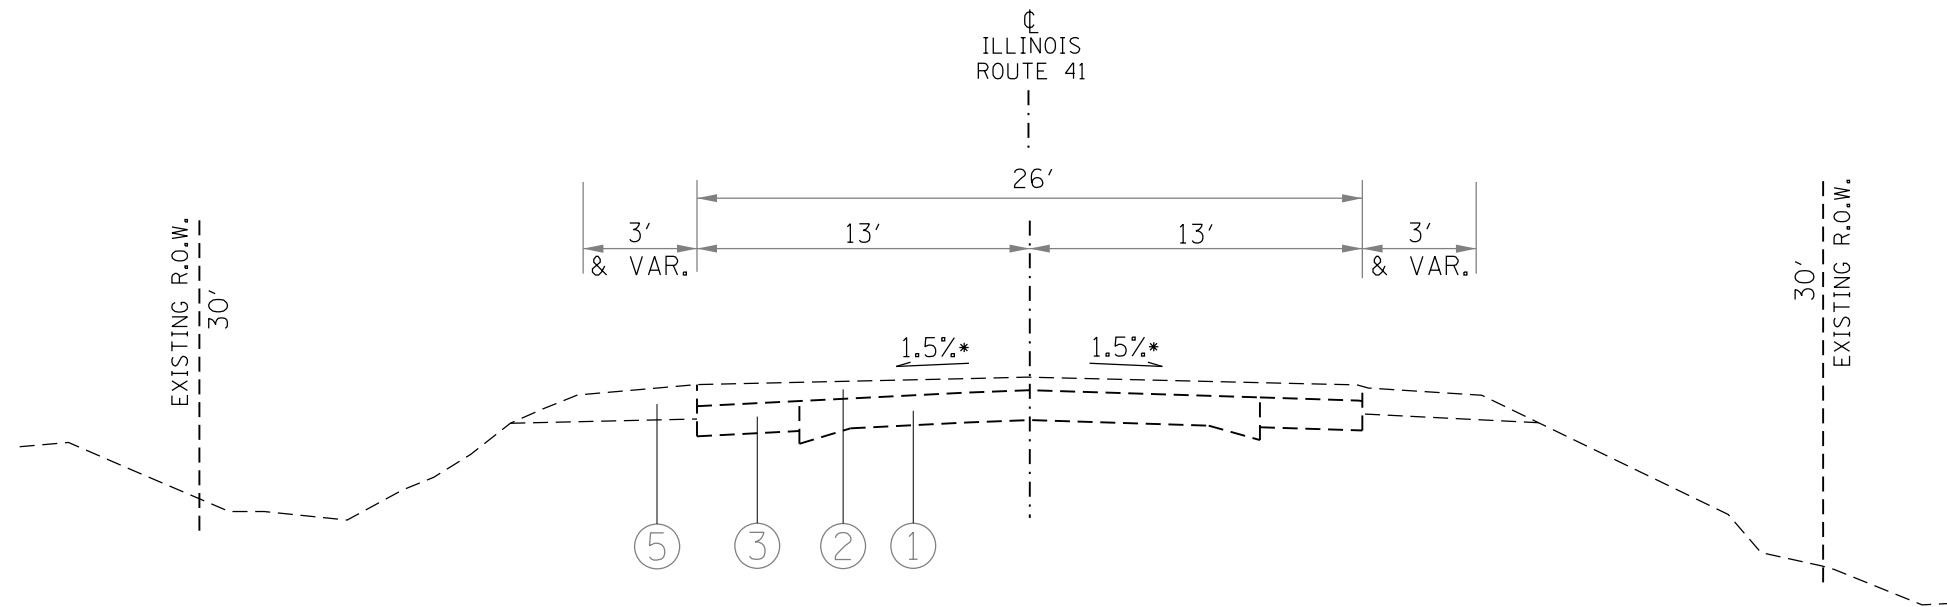

EXISTING TYPICAL SECTION
RT. STA. 20+00 TO 20+50
LT. STA. 20+00 TO 22+00

* Variable slope

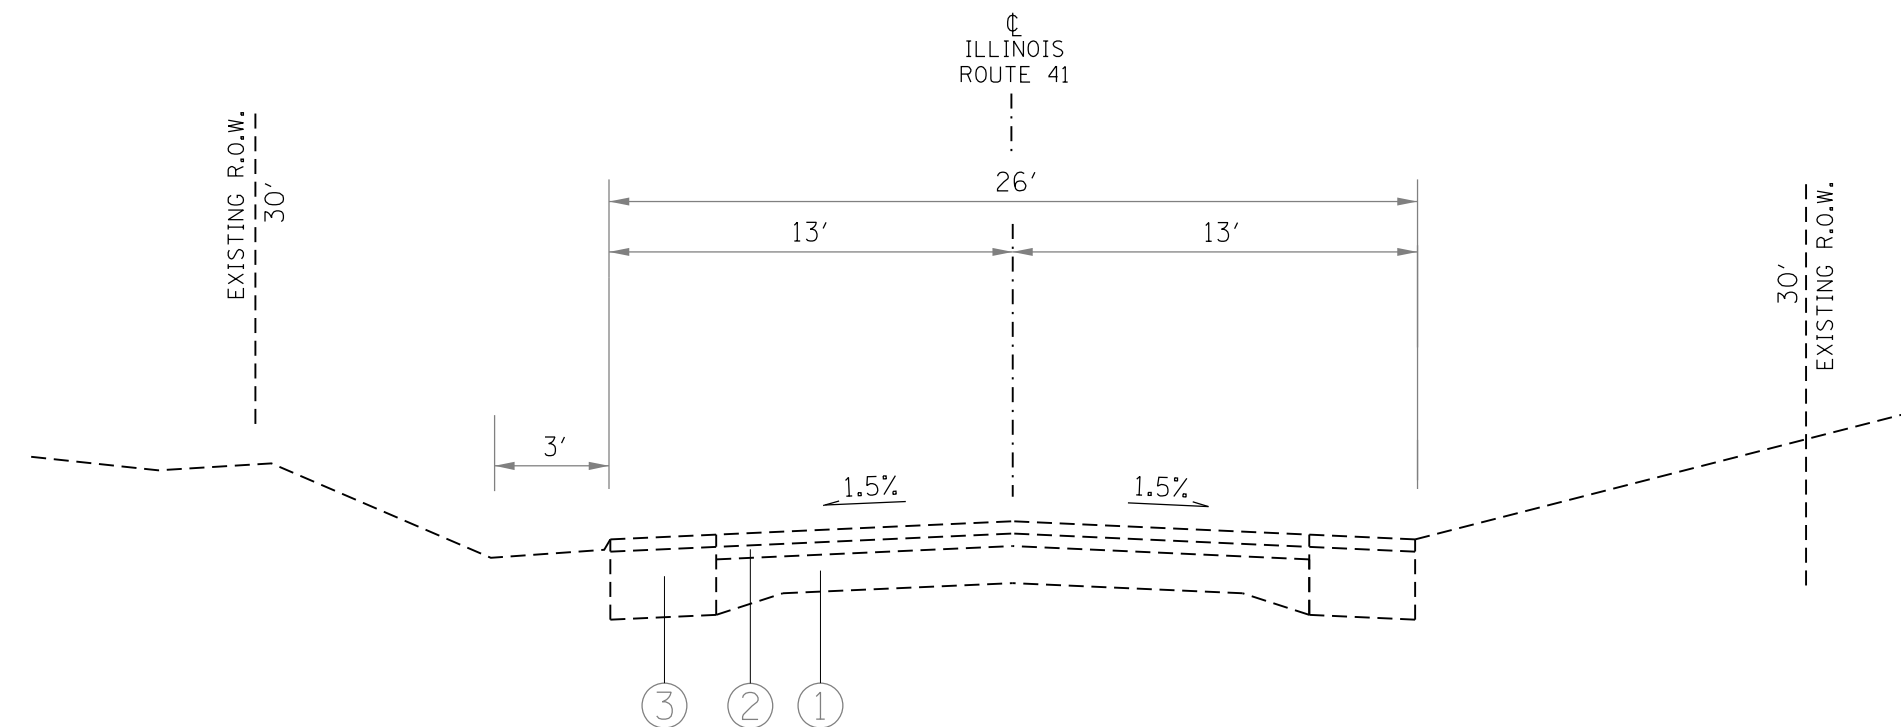

EXISTING TYPICAL SECTION
RT. STA. 20+50 TO 22+50
LT. STA. 22+00 TO 22+50

LEGEND

- ① EXISTING PCC PAVEMENT
- ② EXISTING HMA OVERLAY
- ③ EXISTING BASE COURSE WIDENING
- ④ EXISTING CONCRETE GUTTER
- ⑤ EXISTING AGGREGATE SHOULDERS
- ⑥ EXISTING GUARDRAIL
- ⑦ EXISTING PAVEMENT MARKING
- ⑩ PROPOSED HMA SURFACE COURSE, 1 1/2"
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- ⑮ PROPOSED AGGREGATE SHOULDERS, TY B
- ⑯ PROPOSED STEEL PLATE BEAM GUARDRAIL, TY A
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- ㉕ PROPOSED HMA BASE COURSE, 9"

FILE NAME =	USER NAME = everscd	DESIGNED -	REVISED -
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	PLOT DATE = 10/18/2019		

STATE OF ILLINOIS
DEPARTMENT OF TRANSPORTATION


ILLINOIS ROUTE 41
TYPICAL SECTIONS

SCALE: NOT TO SCALE SHEET OF SHEETS STA. 20+00 TO STA. 22+50

F.A.P. RTE.	SECTION	COUNTY	TOTAL SHEETS	SHEET NO.
574	(12)CR	-	202	15
CONTRACT NO. 68C64				
ILLINOIS FED. AID PROJECT				


LEGEND

- ① EXISTING PCC PAVEMENT
- ② EXISTING HMA OVERLAY
- ③ EXISTING BASE COURSE WIDENING
- ④ EXISTING CONCRETE GUTTER
- ⑤ EXISTING AGGREGATE SHOULDERS
- ⑥ EXISTING GUARDRAIL
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- ㉕ PROPOSED HMA BASE COURSE, 9"

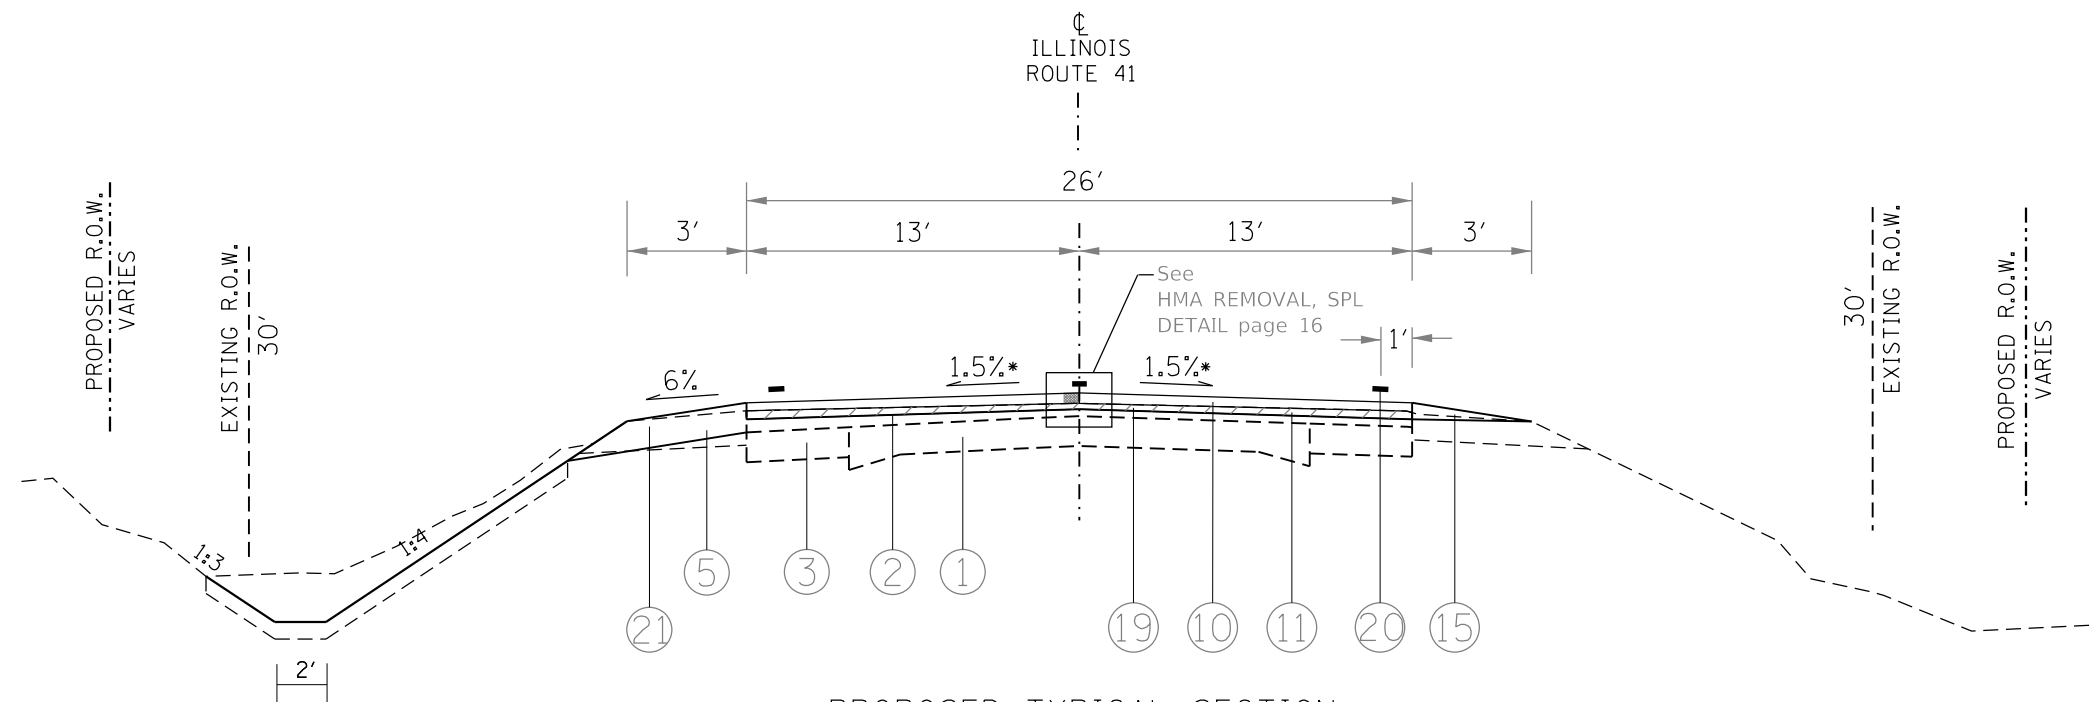


*MATCH EXISTING SLOPES THROUGH SUPER ELEVATED SECTIONS

PROPOSED TYPICAL SECTION
 LT STA 61+00 TO 6+25
 RT STA 61+00 TO 6+37
 STA EQ 68+02.46(BK)=5+00(AH)

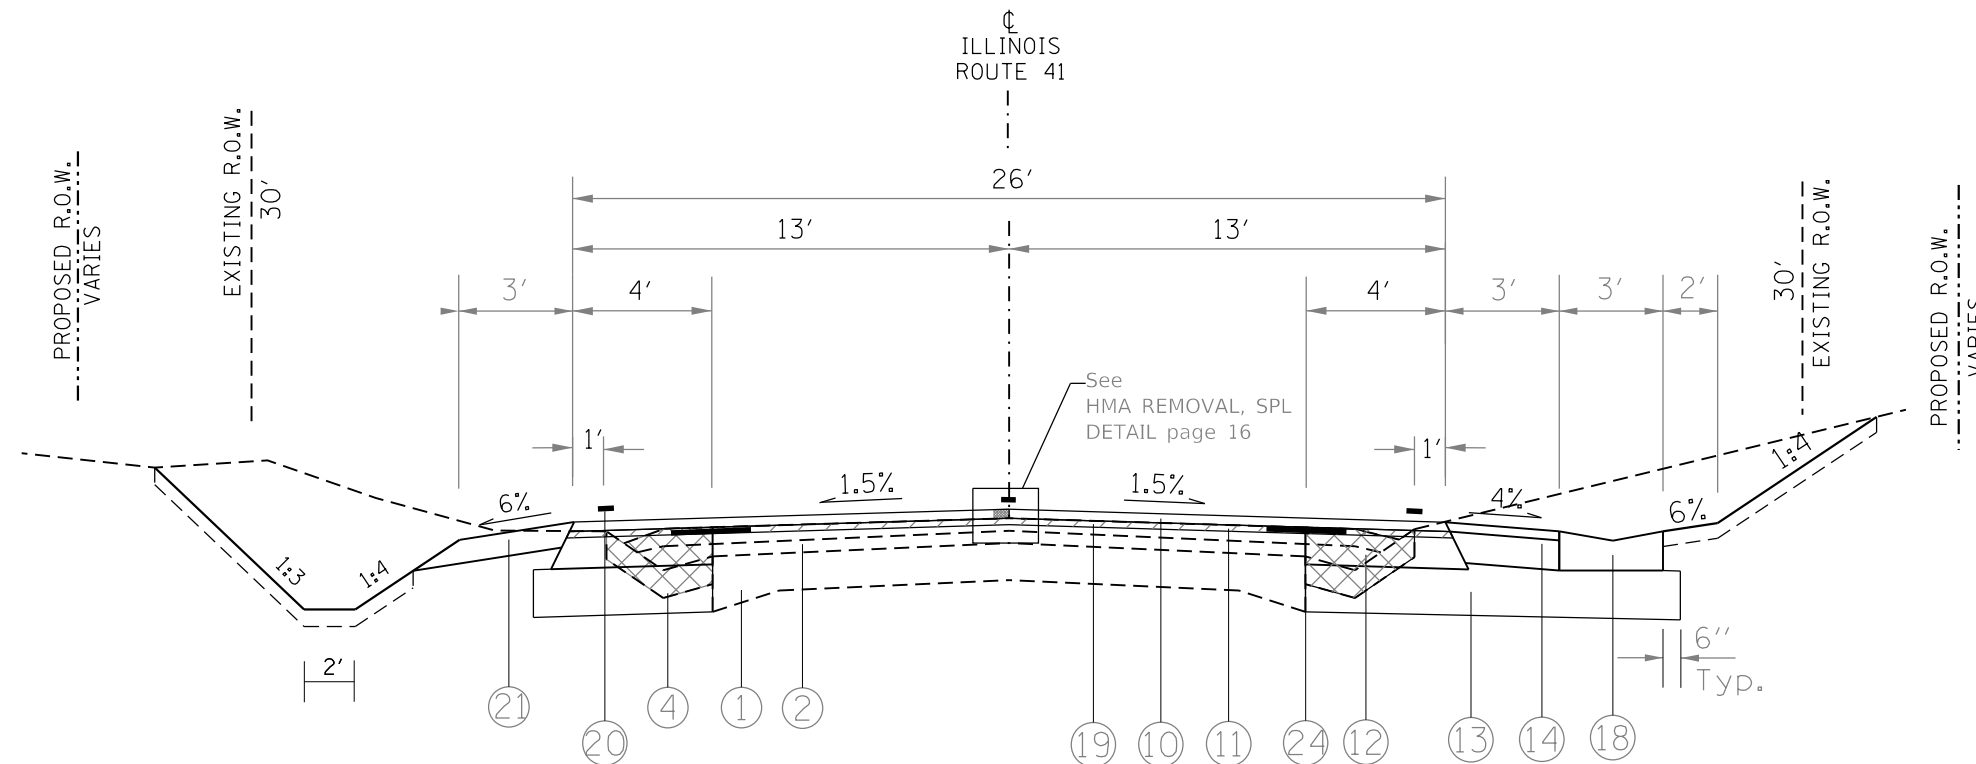

PROPOSED TYPICAL SECTION
 LT STA 6+25 TO 9+38
 RT STA 6+37 TO 9+38


REMOVAL LOCATIONS - SEE CROSS SECTIONS

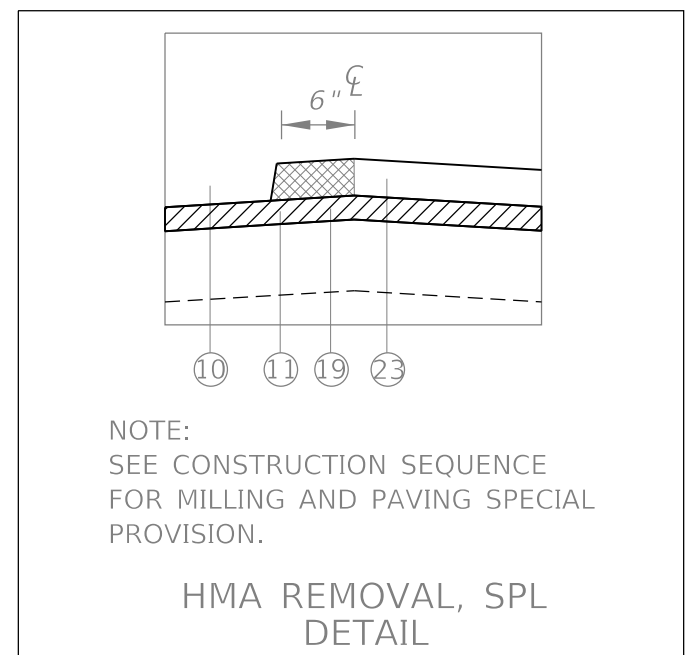


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PLOT SCALE = 100.0000' / 1" =	CHECKED -	REVISIONS -	REVISIONS -			CONTRACT NO. 68C64					
Default	DATE -	REVISIONS -	REVISIONS -			ILLINOIS FED. AID PROJECT					

LEGEND

- ① EXISTING PCC PAVEMENT
- ② EXISTING HMA OVERLAY
- ③ EXISTING BASE COURSE WIDENING
- ④ EXISTING CONCRETE GUTTER
- ⑤ EXISTING AGGREGATE SHOULDERS
- ⑥ EXISTING GUARDRAIL
- ⑦ EXISTING PAVEMENT MARKING
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- ㉕ PROPOSED HMA BASE COURSE, 9"

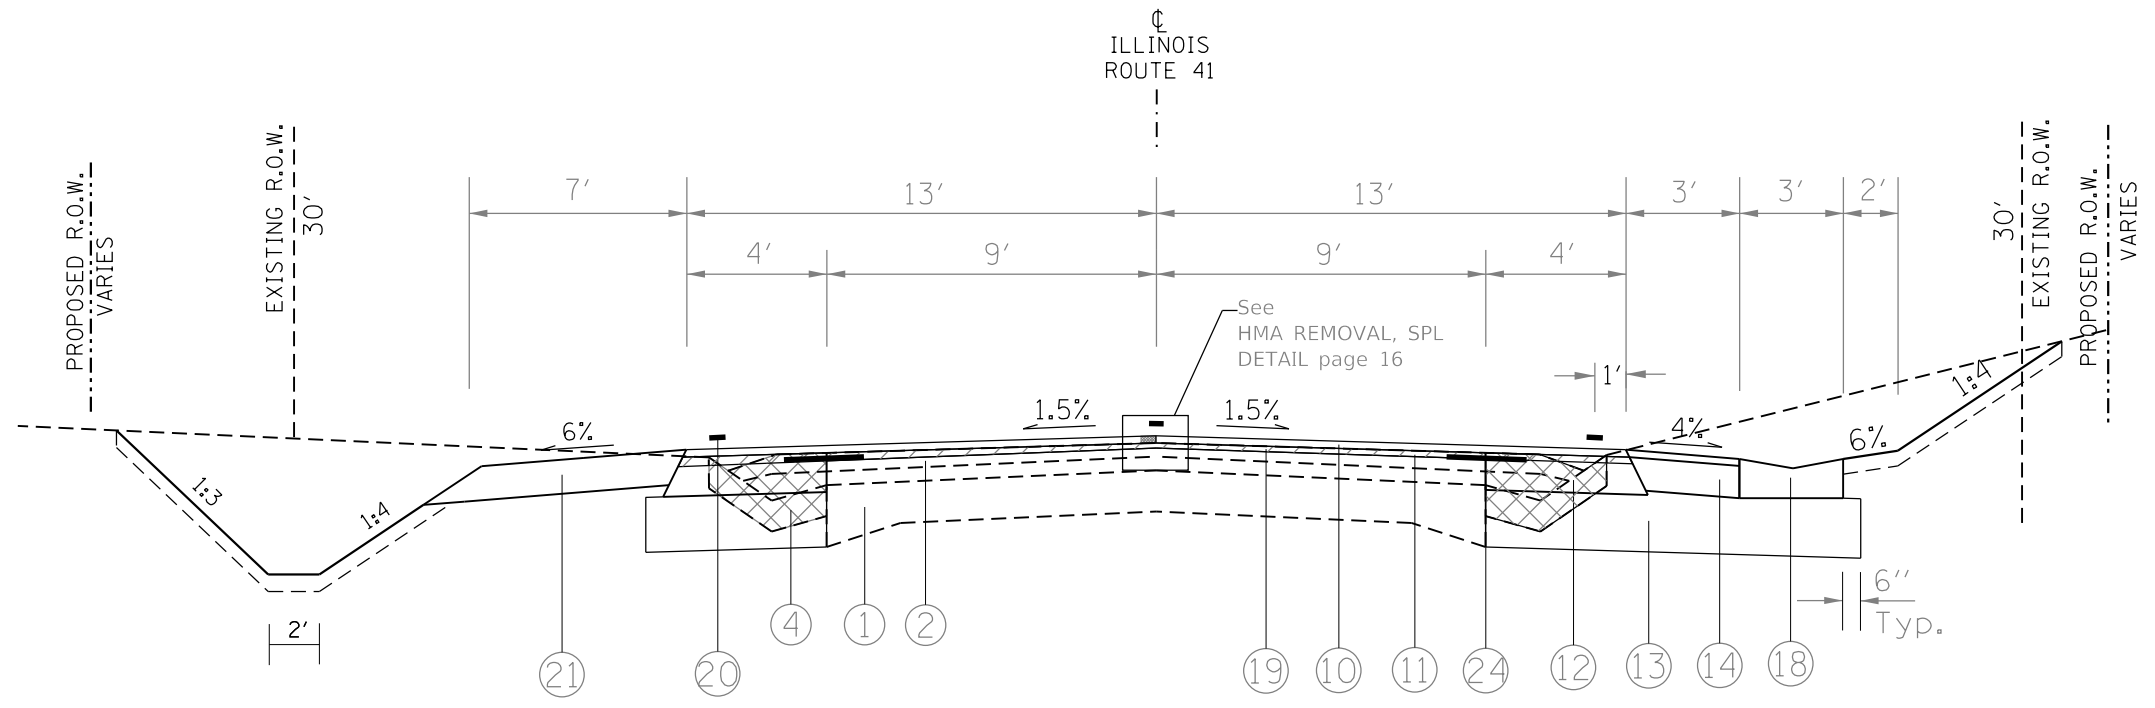


PROPOSED TYPICAL SECTION
STA 9+38 TO 11+60

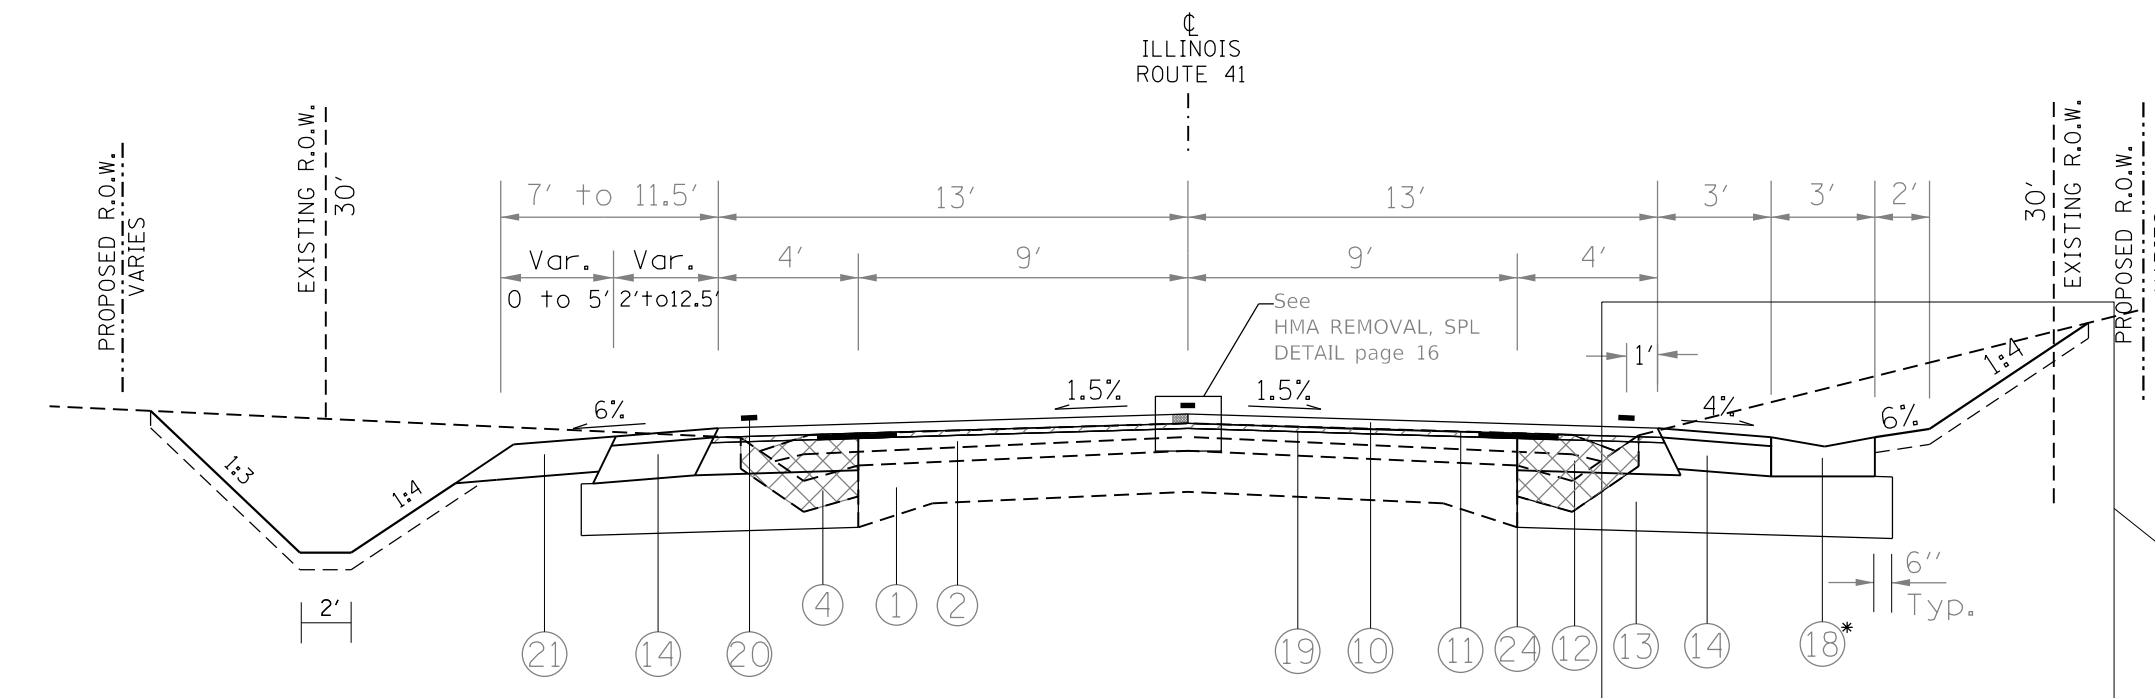


PROPOSED TYPICAL SECTION
STA 11+60 TO 13+50

REMOVAL LOCATIONS - SEE CROSS SECTIONS

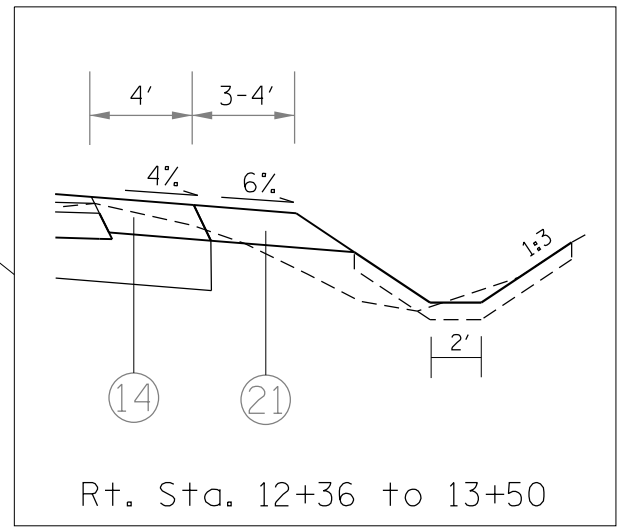

* Ends at Sta. 12+36

FILE NAME =	USER NAME = <i>everscl</i>	DESIGNED -	REVISED -	STATE OF ILLINOIS DEPARTMENT OF TRANSPORTATION	ILLINOIS ROUTE 41 TYPICAL SECTIONS	F.A.P. RTE. 574	SECTION 112CR	COUNTY	TOTAL SHEETS 202	SHEET NO. 17		
Default	Plot SCALE = 100.0000' / 1in.	CHECKED -	REVISED -			SCALE: NOT TO SCALE	SHEET OF SHEETS	STA. 9+38	TO STA. 13+50	CONTRACT NO. 68C64		
	PLOT DATE = 10/18/2019	DATE -	REVISED -			ILLINOIS FED. AID PROJECT						
• FULTON / McDONOUGH												

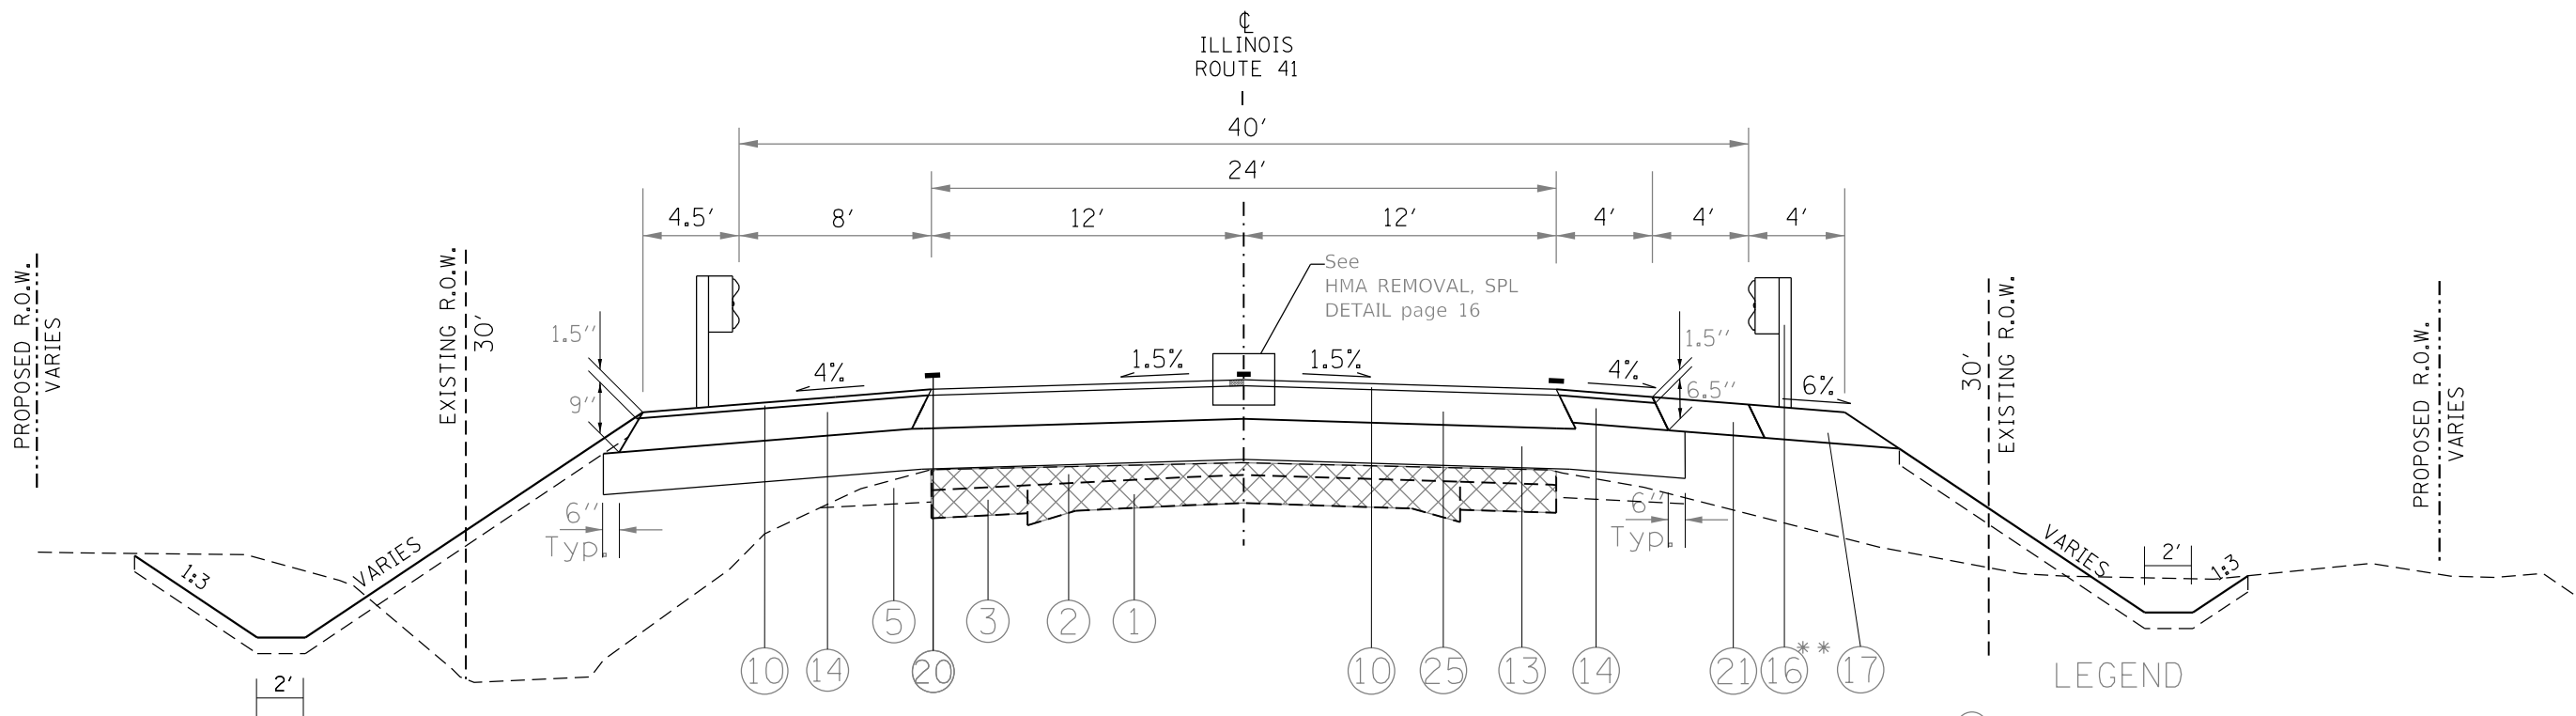


PROPOSED TYPICAL SECTION
STA 13+50 TO 19+50

REMOVAL LOCATIONS - SEE CROSS SECTIONS

** Guardrail & GR Aggregate Erosion Control:
Rt. Sta. 15+67.5 - 18+92.5
Lt. Sta. 16+75 - 20+00


- LEGEND
- ① EXISTING PCC PAVEMENT
 - ② EXISTING HMA OVERLAY
 - ③ EXISTING BASE COURSE WIDENING
 - ④ EXISTING CONCRETE GUTTER
 - ⑤ EXISTING AGGREGATE SHOULDERS
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 - ㉕ PROPOSED HMA BASE COURSE, 9"

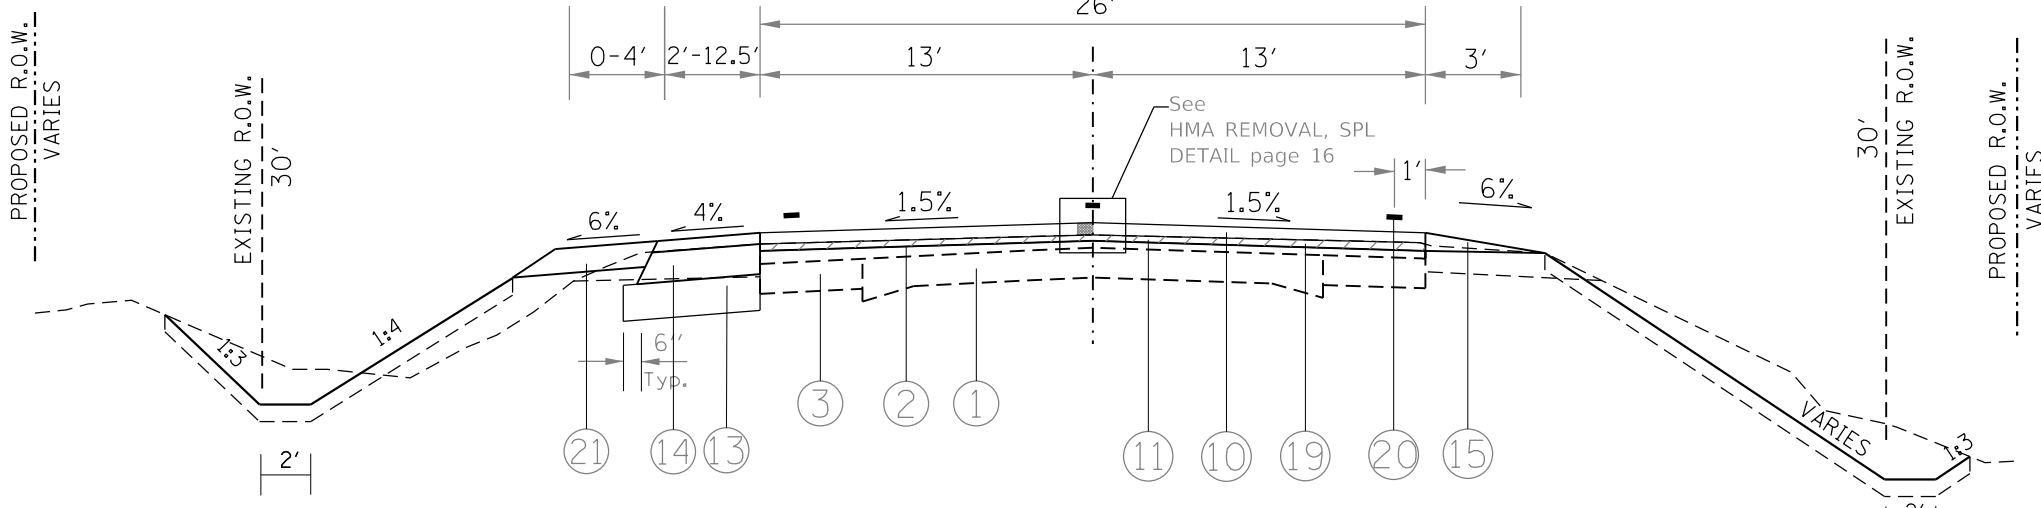


PROPOSED TYPICAL SECTION
RT. STA. 19+50 TO 20+50
LT. STA. 19+50 TO 22+00

REMOVAL LOCATIONS - SEE CROSS SECTIONS

FILE NAME =	USER NAME = ever scl	DESIGNED -	REVISED -	STATE OF ILLINOIS DEPARTMENT OF TRANSPORTATION	ILLINOIS ROUTE 41 TYPICAL SECTIONS	F.A.P. RTÉ.	SECTION	COUNTY	TOTAL SHEETS	SHEET NO.	
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Default	PLOT SCALE = 100.0000' / 1" =	DATE -	REVISED -			CONTRACT NO. 68C64					
	PLOT DATE = 10/18/2019					ILLINOIS FED. AID PROJECT					

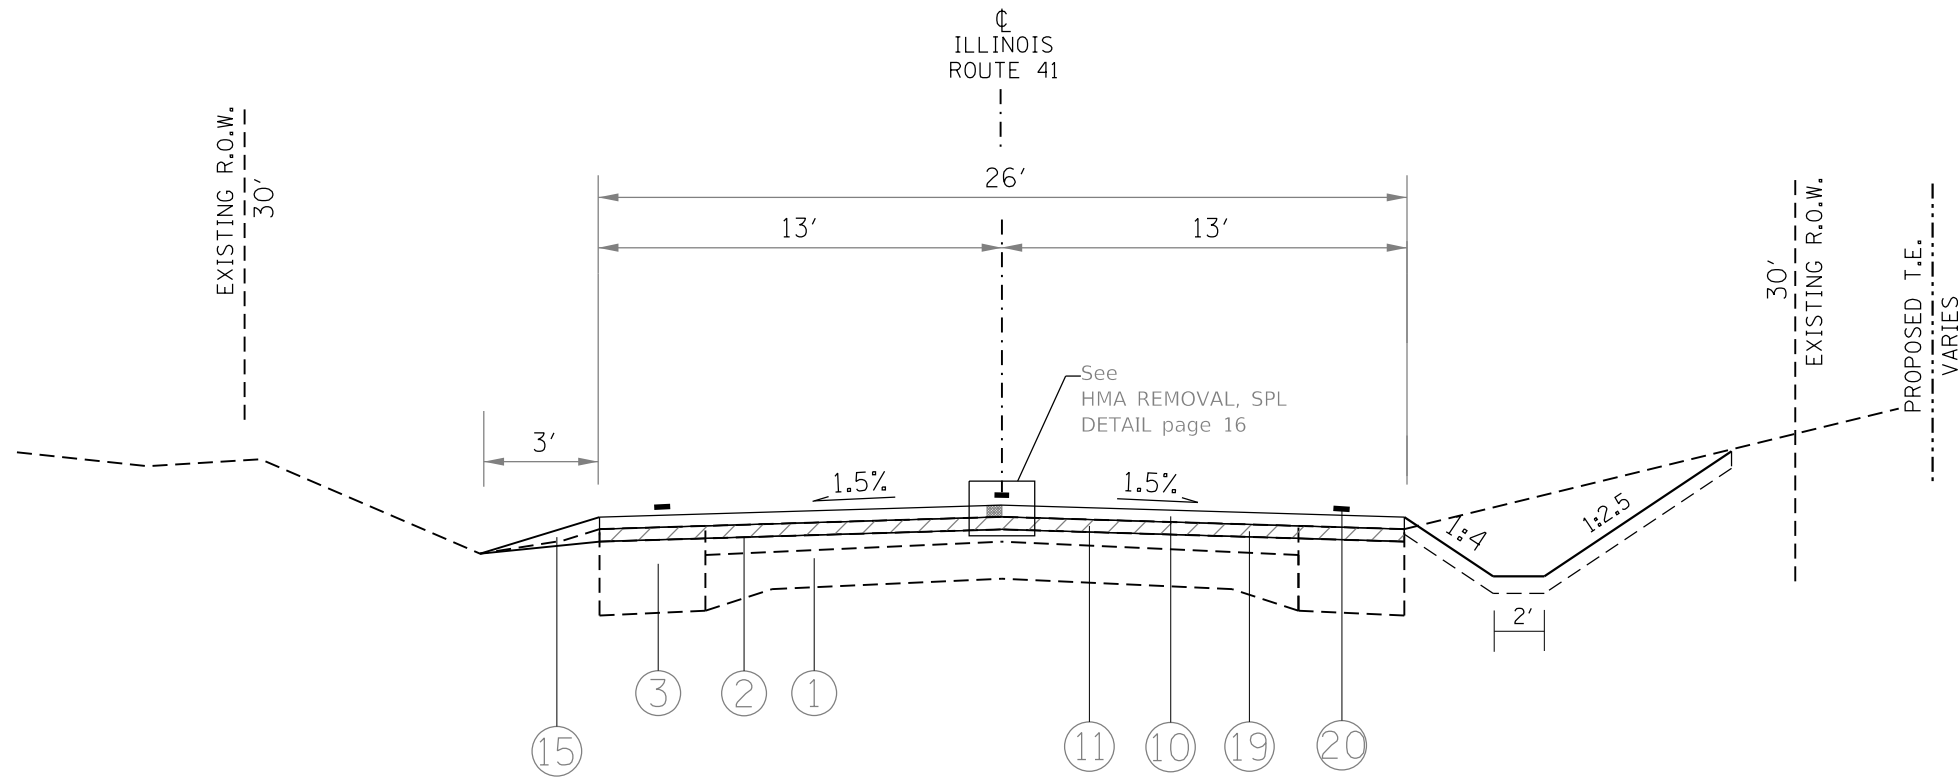

PROPOSED TYPICAL SECTION
 RT. STA 20+50 TO 22+50
 LT. STA. 22+00 TO 22+50

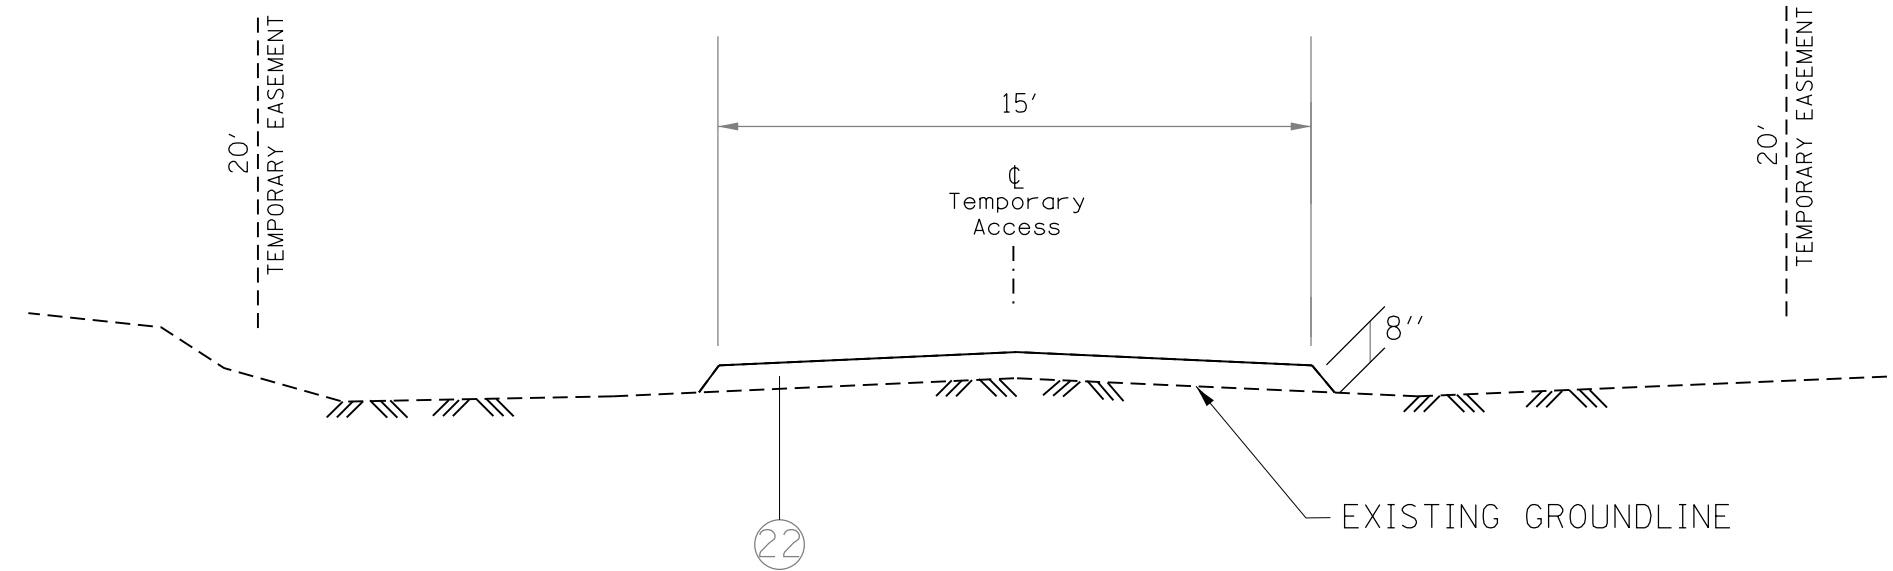

PROPOSED TYPICAL SECTION
 TEMPORARY ACCESS
 RT. STA. 24+75 TO 25+25
 ACCESS STATION 0+00 TO 7+10

LEGEND

- ① EXISTING PCC PAVEMENT
- ② EXISTING HMA OVERLAY
- ③ EXISTING BASE COURSE WIDENING
- ④ EXISTING CONCRETE GUTTER
- ⑤ EXISTING AGGREGATE SHOULDERS
- ⑥ EXISTING GUARDRAIL
- ⑦ EXISTING PAVEMENT MARKING

- ⑩ PROPOSED HMA SURFACE COURSE, 1 1/2"
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- ㉑ PROPOSED AGGREGATE SHOULDER, TY B 6"
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FILE NAME =	USER NAME = everscl	DESIGNED -	REVISED -	STATE OF ILLINOIS DEPARTMENT OF TRANSPORTATION	ILLINOIS ROUTE 41 TYPICAL SECTIONS	F.A.P. RTE.	SECTION	COUNTY	TOTAL SHEETS	SHEET NO.
pw:\planroom\dot\illinois\gov\PWIDOT\Documents\IDOT\Office\District 4\Projects\D4_68C64\CADData\CADdrawings\con\bi\DRAWN\C64-shi-details.dgn	PLLOT SCALE = 100.0000' / 1" =	CHECKED -	REVISED -			574	112CR	-	202	19
Default	PLLOT DATE = 10/18/2019	DATE -	REVISED -			CONTRACT NO. 68C64			ILLINOIS FED. AID PROJECT	
						SCALE: NOT TO SCALE	SHEET OF SHEETS	STA. 22+00	TO STA. 25+25	• FULTON / McDONOUGH

IL 41	STA	NORTHING	EASTING
POT	55+00	1,440,146.9815	2,217,500.5057
PI	60+00	1,440,116.2137	2,217,999.5582
PC	61+16.51	1,440,109.0441	2,218,115.8491
PI	64+14	1,440,090.7379	2,218,412.7751
PT	67+06.39	1,440,166.9320	2,218,700.3418
STA EQN	STA 68+02.46 (BK) = STA 5+00 (AH)		
PI	5+00	1,440,191.5386	2,218,793.2104
PI	29+00	1,440,822.9674	2,221,176.3071

GEOPAK CHAIN IS ENTIRECHAREV2





County Rd	STA	NORTHING	EASTING
POT	7+96.72	1,440,100.6100	2,219,213.4880
POT	9+37.18	1,440,241.0530	2,219,216.0070
POT	10+00.00	1,440,303.8619	2,219,217.1335

BENCHMARK 1:
RR SPIKE IN SOUTH FACE OF POWER POLE N SIDE OF IL 41.
1ST POLE WEST OF CREEK CROSSING AND 2ND POLE
NW OF A FARM HOUSE 176E,
STA 15+64.50, 25.6' LT, ELEV 637.933.

DATUM
NAD 1983
GEOID G12AUS
US STATE PLANE 1983
IL WEST ZONE
VERTICAL DATUM NAVD 88

BENCHMARK 2:
RR SPIKE IN SOUTH FACE OF PP NORTH SIDE OF IL 41.
2ND POLE EAST OF CREEK CROSSING AND
NE OF A FARM HOUSE 176 E.
STA 22+33.6, 28.8 FT LT, ELEV 638.563.

PROP. CURVE REVISED CUR2
PI STA. = 64+14.00
 $\Delta = 18^\circ 22' 05''$ (LT)
D = 3° 06' 50"
R = 1,840.00'
T = 297.49'
L = 589.87'
E = 23.89'
e = _____
T.R. = _____
S.E. RUN = _____
P.C. STA. = 61+16.51
P.T. STA. = 67+06.39

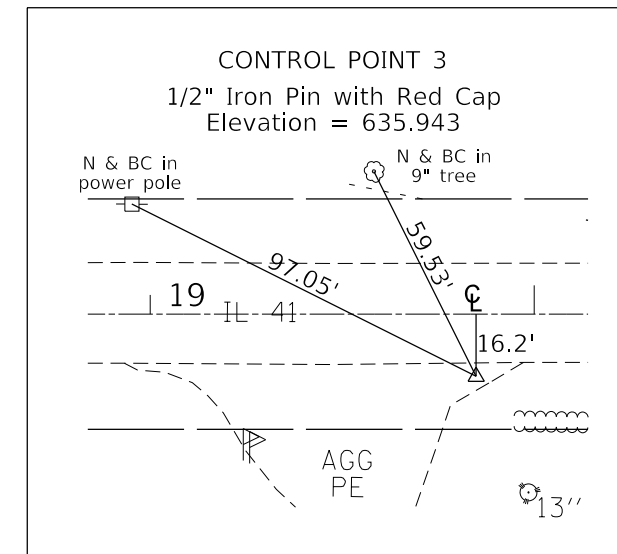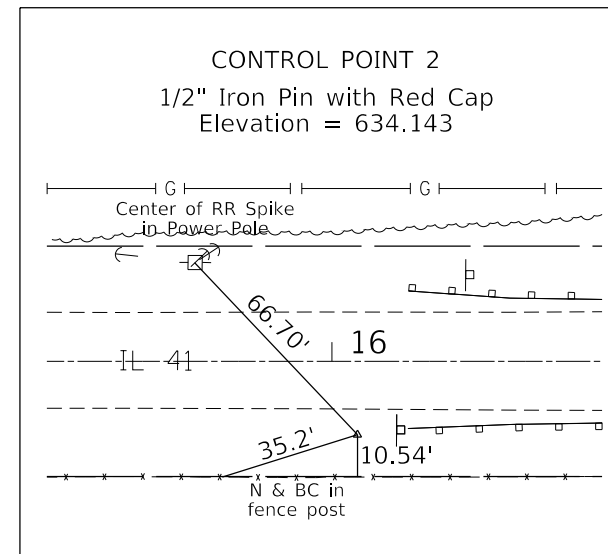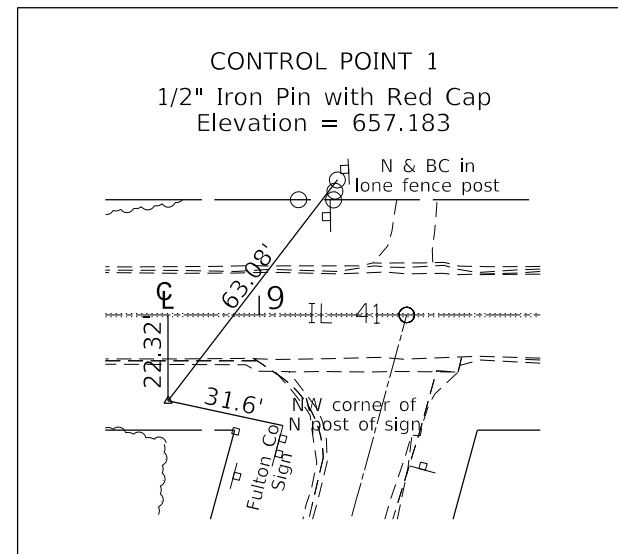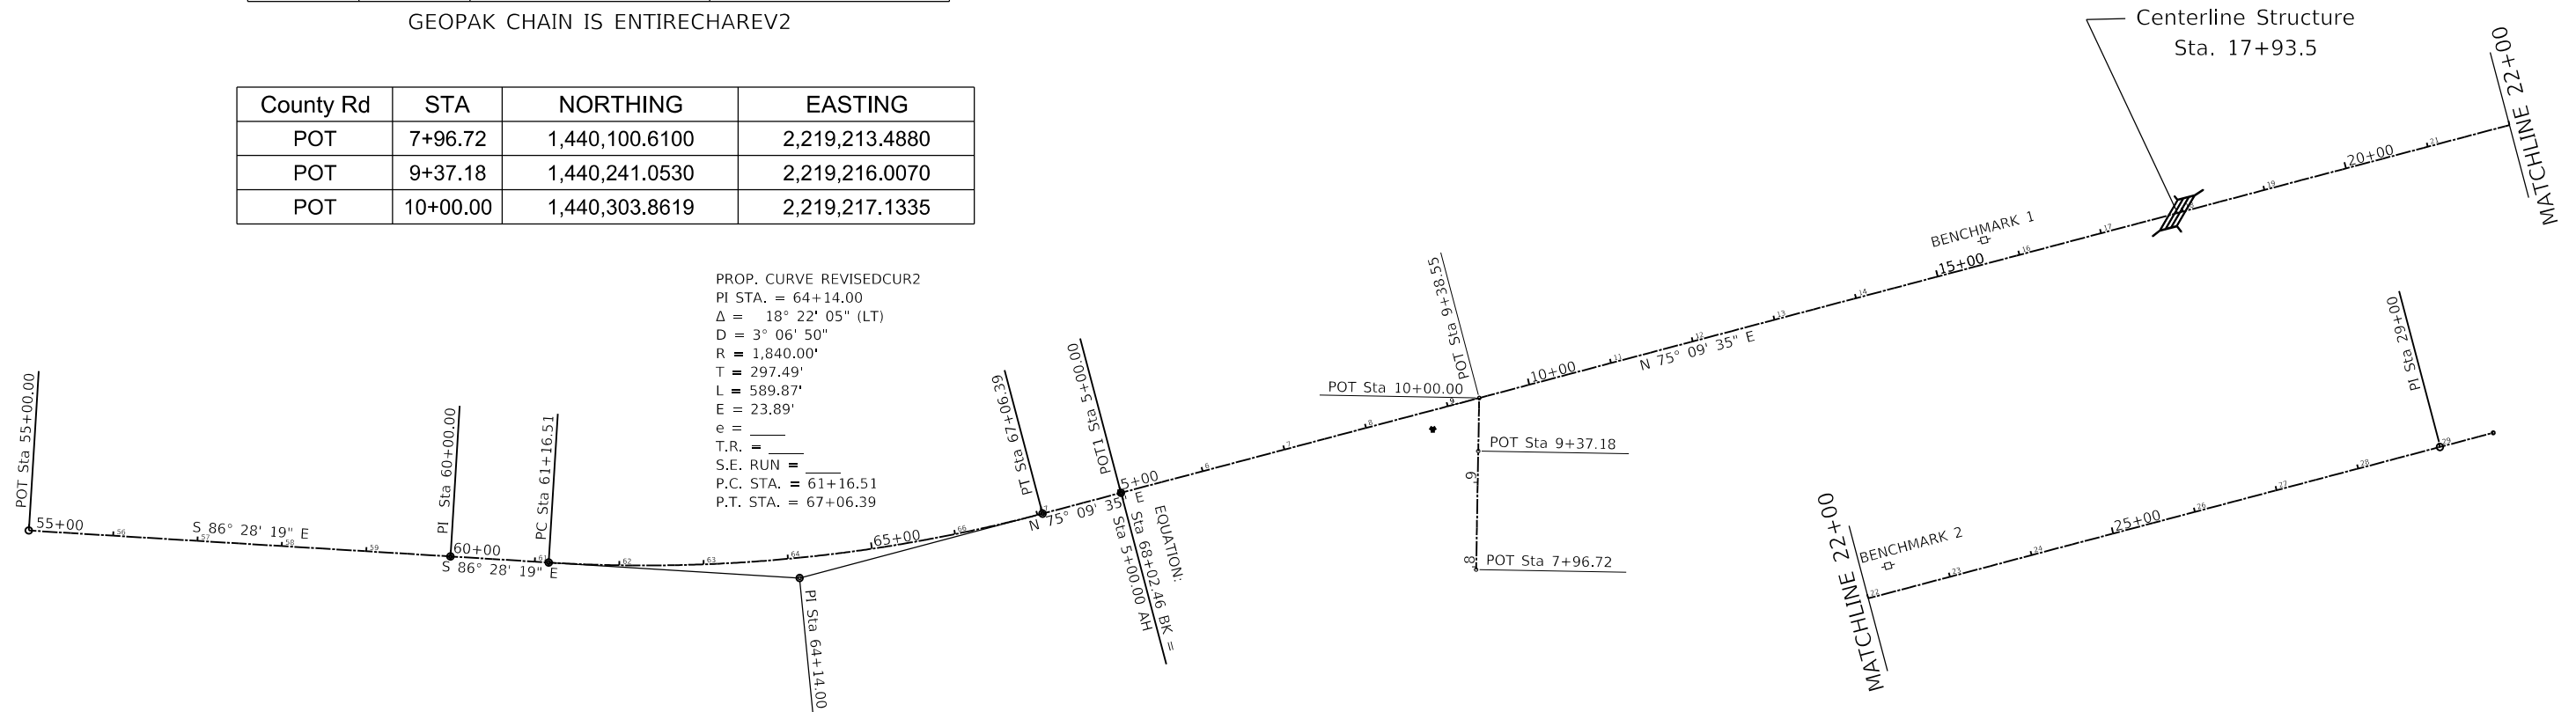

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Default	PLOT DATE = 10/18/2019	DATE -	REVISED -

STATE OF ILLINOIS
DEPARTMENT OF TRANSPORTATION

ALIGNMENTS, TIES & BENCHMARKS

SCALE: NOT TO SCALE SHEET OF SHEETS STA. 55+00 TO STA. 30+00

F.A.P. RTE.	SECTION	COUNTY	TOTAL SHEETS	SHEET NO.
574	112CR		202	20
CONTRACT NO. 68C64				
ILLINOIS FED. AID PROJECT				

Resurfacing Table

LOCATION	LENGTH	WIDTH	AREA	HMA SURFACE REMOVAL-BUTT JOINT	HMA SURFACE REMOVAL 1"	POLYMERIZED BITUMINOUS MATERIALS (TACK COAT)	HMA SURFACE COURSE MIX D, N50 1.5"	POLYMERIZED HMA BINDER COURSE IL-4.75 N50 1"	HMA SHOULDERS 9"	HMA SHOULDERS 6.5"	MATERIAL TRANSFER DEVICE
	FT	FT	SQ YD	SQ YD	SQ YD	LB	TON	TON	SQ YD	SQ YD	TON
IL-41 MAINLINE											
McDonough County											
Right Stations											
61+00.00 TO 61+30.00	30.00	13.00	43.33	43.33		63.90	3.78	2.43			6.21
61+30.00 TO 68+02.46	672.46	13.00	971.33		971.33	1432.34	84.73	54.39			139.12
Sta. Eqn. 68+02.46 (BK) = 5+00 (AH)											
5+00.00 TO 6+37.00	137.00	13.00	197.89		197.89	291.81	17.26	11.08			28.34
6+37.00 TO 9+38.00	301.00	13.00	434.78		434.78	713.37	46.35	24.35		100.33	70.70
Left Stations											
61+00.00 TO 61+30.00	30.00	13.00	43.33	43.33		63.90	3.78	2.43			6.21
61+30.00 TO 68+02.46	672.46	13.00	971.33		971.33	1432.34	84.73	54.39			139.12
Sta. Eqn. 68+02.46 (BK) = 5+00 (AH)											
5+00.00 TO 6+25.00	125.00	13.00	180.56		180.56	266.25	15.75	10.11			25.86
6+25.00 TO 9+38.00	313.00	13.00	452.11		452.11	666.69	39.44	25.32			64.76
SIDERoads											
County Highway	30.00	22.00	150.39	36.67	113.72	216.56	12.63	8.42			21.05
<i>McDonough County Sub Total</i>			<i>3445.05</i>	<i>123.34</i>	<i>3321.71</i>	<i>5147.16</i>	<i>308.46</i>	<i>192.92</i>	<i>0</i>	<i>100</i>	<i>501.38</i>
Fulton County											
Right Stations											
9+38.00 TO 13+50.00	412.00	13.00	595.11	14.44	595.11	976.44	63.45	33.33		137.33	96.77
13+50.00 TO 19+50.00	600.00	12.00	800.00			798.00	92.40			266.67	92.40
19+50.00 TO 22+20.00	270.00	13.00	390.00	14.44	390.00	575.10	34.02	21.84			55.86
22+20.00 TO 22+50.00	30.00	13.00	43.33	43.33		63.90	3.78	2.43			6.21
Left Stations											
9+38.00 TO 13+50.00	412.00	13.00	595.11	14.44	595.11	1005.92	66.89	33.33	178.28		100.21
13+50.00 TO 19+50.00	600.00	12.00	800.00			1206.00	140.00		833.33		140.00
19+50.00 TO 22+20.00	270.00	13.00	390.00	14.44	390.00	689.73	47.39	21.84	159.21		69.23
22+20.00 TO 22+50.00	30.00	13.00	43.33	43.33		63.90	3.78	2.43			6.21
<i>Fulton County Sub Total</i>			<i>3656.89</i>	<i>144.44</i>	<i>1970.22</i>	<i>5379.00</i>	<i>451.71</i>	<i>115.19</i>	<i>1171</i>	<i>404</i>	<i>566.90</i>
TOTAL				268	5292	10526	760.17	308.11	1171	504	1068.27

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PLOT DATE = 10/18/2019	DATE -	REVISED -

**STATE OF ILLINOIS
DEPARTMENT OF TRANSPORTATION**

SCHEDULE OF QUANTITIES			
SCALE:	SHEET	OF SHEETS	STA. TO STA.

F.A.P. RTE.	SECTION	COUNTY	TOTAL SHEETS	SHEET NO.
574	(12)CR	*	202	21
CONTRACT NO. 68C64				
ILLINOIS FED. AID PROJECT				
* FULTON / McDONOUGH				

TREE REMOVAL (6 to 15 UNITS)	
LOCATION	UNIT
Fulton County	
Rt. Sta. 16+80	6
Rt. Sta. 17+05	11
Rt. Sta. 17+20	10
TOTAL	27

TREE REMOVAL, ACRE	
LOCATION	ACRES
Fulton County	
Lt. Sta. 18+00 to 19+00	0.25
TOTAL	0.25

MOWING	
LOCATION	ACRES
McDonough County	1.25
Fulton County	2.25
TOTAL	3.5

EROSION CONTROL BLANKET	
LOCATION	SQ YD
Fulton County	
Lt. Sta. 16+00 to 18+00	867.54
Rt. Sta. 16+00 to 17+50	532.26
Rt. Sta. 17+80 to 19+50	398.91
TOTAL	1799

SUPPLEMENTAL WATERING	
LOCATION	UNIT
McDonough County	13.00
Fulton County	22.00
TOTAL	35.00

PERIMETER EROSION BARRIER	
LOCATION	FOOT
McDonough County	
Rt. Sta. 6+00 to 9+37.45	337
Fulton County	
Rt. Sta. 9+37.45 to 12+00	263
Lt. Sta. 19+00 to 21+50	250
TOTAL	850

EARTHWORK TABLE				
LOCATION	EARTH EXCAVATION CU YD	FOR INFORMATION ONLY		EARTHWORK BALANCE CU YD
		EARTH EXCAVATION (W/SHRINKAGE) CU YD	EMBANKMENT CU YD	
McDonough County				
Right Stations				
61+00 to 68+02	28.4	21.3	1.0	20.3
5+00 to 9+37.45	293.2	219.9	6.2	213.7
Left Stations				
61+00 to 68+02	793.1	594.8	1.0	593.8
5+00 to 9+37.45	1034.3	775.7	0.0	775.7
Fulton County				
Right Stations				
9+37.45 to 15+50	743.5	557.6	47.0	510.6
15+50 to 21+50	1229.0	921.8	414.0	507.8
Left Stations				
9+37.45 to 15+50	1454.2	1090.7	15.0	1075.7
15+50 to 21+50	1158.6	869.0	788.0	80.9
TOTAL	6735	5051	1272	3779

TEMPORARY DITCH CHECKS							
Beginning & Ending Station	Length	7%	4%	3%	1%	Total Ditch Checks	FOOT
McDonough County							
Left Side							
Sta 60+00 to 6+00	902.5				6	6	42
Sta 6+00 to 9+37.45	337.45		9			9	63
Right Side							
Sta 60+00 to 9+37.45	1239.5				8	8	56
Fulton County							
Left Side							
Sta 9+37.45 to 17+80	842.5		22			22	154
Sta. 17+80 to 19+00	120				1	1	7
Right Side							
Sta 9+37.45 to 12+00	262.5		7			7	49
Sta 12+00 to 17+80	580			12		12	84
Sta 17+80 to 19+00	170	8				8	56
TOTAL						73	511

POROUS GRANULAR EMBANKMENT	
LOCATION	CU YD
Box Culvert Sta. 17+93.5	932.1
TOTAL	932.1

LOCATION	WIDTH FT	LENGTH FT	STONE RIPRAP CLASS A4	FILTER FABRIC
			SQ YD	SQ YD
Fulton County				
Lt. Sta. 17+50 to 19+00	64	150	661.1	855
Rt. Sta. 16+40 to 18+00	60	160	645.0	839
TOTAL			1306.1	1694

Note: STONE RIPRAP CLASS A4 and FILTER FABRIC quantity includes quantity from Culvert details.

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STATE OF ILLINOIS
DEPARTMENT OF TRANSPORTATION

SCHEDULE OF QUANTITIES

SCALE: SHEET OF SHEETS STA. TO STA.

F.A.P. RTE.	SECTION	COUNTY	TOTAL SHEETS	SHEET NO.
574	(12)CR		202	22
CONTRACT NO. 68C64				
ILLINOIS FED. AID PROJECT				
* FULTON / McDONOUGH				

SEEDING SCHEDULE

LOCATION			PLAN AREA	TOPSOIL FURNISH & PLACE, 4"	SEEDING, CLASS 2A	NITROGEN FERTILIZER NUTRIENT (90 LBS/ACRE)	PHOSPHORUS FERTILIZER NUTRIENT (90 LBS/ACRE)	POTASSIUM FERTILIZER NUTRIENT (90 LBS/ACRE)	MULCH, METHOD 2	TEMPORARY EROSION CONTROL SEEDING
Sta.	to	Sta.	(SQ FT)	(SQ YD)	(ACRE)	(POUND)	(POUND)	(POUND)	(ACRE)	(POUND)
Main Line (IL-41)										
McDonough County										
Left Station										
60+00	TO	68+02.46	13,783.16	1,608.04	0.33	29.90	29.90	29.90	0.33	66.45
5+00		9+37.45	9,774.60	1,140.37	0.24	21.21	21.21	21.21	0.24	47.12
Right Station										
60+00	TO	68+00	1,276.72	148.95	0.03	2.77	2.77	2.77	0.03	6.15
68+00	TO	9+37.45	2,540.33	296.37	0.06	5.51	5.51	5.51	0.06	12.25
McDonough County Line Road										
10+30	TO	10+60	180.00	21.00	0.00	0.39	0.39	0.39	0.00	0.87
<i>McDonough County Sub Total</i>			<i>27,374.81</i>	<i>3,214.73</i>	<i>0.66</i>	<i>59.78</i>	<i>59.78</i>	<i>59.78</i>	<i>0.66</i>	<i>132.84</i>
Fulton County										
Left Station										
9+37.45	TO	18+00	21,686.92	2,530.14	0.52	47.05	47.05	47.05	0.52	104.55
18+00	TO	22+50	4,884.63	569.87	0.12	10.60	10.60	10.60	0.12	23.55
Right Station										
9+37.45	TO	17+50	15,619.98	1,822.33	0.38	33.89	33.89	33.89	0.38	75.30
17+90	TO	19+50	4,149.43	484.10	0.10	9.00	9.00	9.00	0.10	20.00
17+50	TO	22+50	2,571.30	299.99	0.06	5.58	5.58	5.58	0.06	12.40
24+75	TO	25+20	11,286.16	1,316.72	0.27	24.48	24.48	24.48	0.27	54.41
<i>Fulton County Sub Total</i>			<i>60,198.42</i>	<i>7,023.15</i>	<i>1.45</i>	<i>130.60</i>	<i>130.60</i>	<i>130.60</i>	<i>1.45</i>	<i>290.21</i>
TOTALS				10238	2.12	190.37	190.37	190.37	2.12	423.05

INLET & PIPE PROTECTION	
LOCATION	EACH
McDonough County Lt. Sta. 9+38	1.00
Fulton County Rt. Sta. 25+20	1.00
TOTAL	2.00

HMA BASE COURSE, 9"	
LOCATION	SQ YD
Fulton County	
Sta. 13+50 to 19+50	1600.00
McDonough / Fulton County Line Road	150.4
TOTAL	1750.4

AGGREGATE SUBGRADE IMPROVEMENT 12"	
LOCATION	SQ YD
IL 9	
McDonough County	
Rt. Sta. 6+37 to 9+37.45	350.53
Lt. Sta. 6+25 to 9+37.45	182.26
Fulton County	
Rt. Sta. 9+37.45 to 13+50	481.31
Lt. Sta. 9+37.45 to 11+50	118.08
Lt. Sta. 11+50 to 13+50	272.22
Sta. 13+50 to 19+50	2833.33
Lt. Sta. 19+50 to 22+00	229.17
TOTAL	4467

HMA BASE COURSE WIDENING, 9"	
LOCATION	SQ YD
McDonough County	
Rt. Sta. 6+37 to 9+37.45	133.53
Lt. Sta. 6+25 to 9+37.45	138.87
Fulton County	
Rt. Sta. 9+37.45 to 13+50	183.36
Lt. Sta. 9+37.45 to 13+50	183.36
TOTAL	639.2

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**STATE OF ILLINOIS
DEPARTMENT OF TRANSPORTATION**

SCHEDULE OF QUANTITIES

SCALE: SHEET OF SHEETS STA. TO STA.

F.A.P. RTE.	SECTION	COUNTY	TOTAL SHEETS	SHEET NO.
574	(12)CR	*	202	23
CONTRACT NO. 68C64				
ILLINOIS FED. AID PROJECT				
* FULTON / McDONOUGH				

Proposed Entrance Quantities						
Station	Type	Width	Area	Material	INCIDENTAL HMA SURFACING (6") TON	AGGREGATE SURFACE COURSE TYPE B TON
		FOOT	SY			
McDonough County						
Lt. Sta. 9+39	FE	12.0	30.0	agg		39.2
Fulton County						
Rt. Sta. 19+50	PE	30.0	50.0	agg	16.8	
Rt. Sta. 25+00	FE	30.0	933.4	agg		425.23
TOTAL					16.8	464.4

CLASS D PATCHES, 13"				
	Type I	Type II	Type III	Type IV
	SQ YD	SQ YD	SQ YD	SQ YD
McDonough County				
Westbound	12.00	12.00		30.00
Eastbound	12.00	12.00		30.00
<i>McDonough County Total</i>	<i>24.00</i>	<i>24.00</i>	<i>0.00</i>	<i>60.00</i>
Fulton County				
Westbound	12.00	10.00	15.00	25.00
Eastbound	8.00	16.00		25.00
<i>Fulton County Total</i>	<i>20.00</i>	<i>26.00</i>	<i>15.00</i>	<i>50.00</i>
TOTAL	44.00	50.00	15.00	110.00

TEMPORARY RAMP	
LOCATION	SQ YD
McDonough County	
Sta. 61+00	14.4
Fulton County	
Sta. 13+50	13.3
Sta. 19+50	13.3
Sta. 22+50	14.5
TOTAL	55.5

AGGREGATE FOR TEMPORARY ACCESS	
LOCATION	TON
Fulton County	
Lt. Sta 9 + 38	14.6
Rt. Sta 11 + 00	53.6
Rt. Sta 19 + 50	62.6
TOTAL	130.7

For Information Only

CLASS D PATCHES, 13"				
McDonough County	Length	Width	SQ YD	Type
Westbound	30	9	30.00	IV
	4	9	4.00	I
	4	9	4.00	I
	6	9	6.00	II
	4	9	4.00	I
	6	9	6.00	II
Eastbound	30	9	30.00	IV
	4	9	4.00	I
	4	9	4.00	I
	6	9	6.00	II
	4	9	4.00	I
	6	9	6.00	II
TOTAL			108	

PAVEMENT REMOVAL	
LOCATION	SQ YD
McDonough County	
Rt. Sta. 6+37 to 9+00	116.89
Lt. Sta. 6+25 to 9+37.45	138.87
Fulton County	
Lt. Sta. 9+37.45 to 13+50	183.36
Rt. Sta. 9+38.5 (County Line Road)	103.61
Rt. Sta. 9+50 to 13+50	177.78
Sta. 13+50 to 19+50	1733.33
TOTAL	2454

GUTTER REMOVAL	
LOCATION	FOOT
McDonough County	
Lt. Sta. 6+05 to 6+30	25
Fulton County	
Rt. Sta. 14+11 to 14+36	25
TOTAL	50

For Information Only

CLASS D PATCHES, 13"				
Fulton County	Length	Width	SQ YD	Type
Westbound	25	9	25.00	IV
	15	9	15.00	III
	4	9	4.00	I
	4	9	4.00	I
	4	9	4.00	I
	10	9	10.00	II
Eastbound	25	9	25.00	IV
	6	9	6.00	II
	4	9	4.00	I
	4	9	4.00	I
	10	9	10.00	II
TOTAL			111	

AGGREGATE SHOULDERS, TYPE B	
LOCATION	TON
McDonough County	
Rt. Sta. 60+00 to 6+37.8	35.7
Fulton County	
Rt. Sta. 19+50 to 20+50	3.8
Lt. Sta. 22+00 to 22+50	1.9
TOTAL	41.4

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**STATE OF ILLINOIS
DEPARTMENT OF TRANSPORTATION**

SCHEDULE OF QUANTITIES

SCALE: SHEET OF SHEETS STA. TO STA.

F.A.P. RTE.	SECTION	COUNTY	TOTAL SHEETS	SHEET NO.
574	(12)CR		202	24
CONTRACT NO. 68C64				

ILLINOIS FED. AID PROJECT
* FULTON / McDONOUGH

IMPACT ATTENUATORS, RELOCATE (NON-REDIRECTIVE) TEST LEVEL 3	
LOCATION	EACH
Fulton County	
STAGE II	
Sta. 11+60	1
Sta. 21+37	1
TOTAL	2.0

GUARDRAIL REFLECTORS, TYPE A	
LOCATION	EACH
Fulton County	
Lt. Sta. 16+75 to 20+00	4
Rt. Sta. 15+67.5 to 18+92.5	4
TOTAL	8

CONCRETE GUTTER, TYPE A (SPECIAL)	
LOCATION	FOOT
McDonough County	
Rt. Sta. 6+37.5 to 9+37.45	300
Fulton County	
Rt. Sta. 9+37.45 to 10+38	101
Rt. Sta. 11+35 to 12+00	65
TOTAL	466

IMPACT ATTENUATORS, TEMPORARY (NON-REDIRECTIVE, NARROW) TEST LEVEL 3	
LOCATION	EACH
Fulton County	
STAGE II	
Sta. 17+00	1
Sta. 19+37.5	1
TOTAL	2.0

PAVEMENT MARKING REMOVAL - WATER BLAST		
TEMPORARY PAVEMENT MARKING TYPE	TOTAL LENGTH FOOT	AREA SQ. FT.
Fulton County		
STAGE I		
LINE 4"	2430	810
LINE 24"	24	48
STAGE II		
LINE 4"	2442	814
LINE 24"	24	48
TOTAL		1720

CHANGEABLE MESSAGE SIGN	
LOCATION	CAL DAY
McDonough County	100
Fulton County	100
TOTAL	200

LOCATION	EACH
Fulton County	
Lt. Sta. 16+75	1
Lt. Sta. 20+00	1
Rt. Sta. 15+67.5	1
Rt. Sta. 18+92.5	1
TOTAL	4

HOT-MIX ASPHALT SURFACE REMOVAL (SPECIAL)	
LOCATION	SQ YD
McDonough County	
Sta. 61+00 to 9+38	63
Fulton County	
Sta. 9+38 to 22+50	73
TOTAL	136

PINNING TEMPORARY CONCRETE BARRIER	
LOCATION	EACH
Fulton County	
STAGE I	
Sta. 13+25 to 19+75	156
End Sections	18
STAGE II	
Sta. 13+25 to 19+75	156
Sta. 17+00 to 19+38	57
End Sections	18
TOTAL	405

			MOD URETHANE PAVT MARKING		
			4" SOLID WHITE	4" DASHED YELLOW	4" SOLID YELLOW
LOCATION	STATION TO STATION	LENGTH	FOOT	FOOT	FOOT
McDonough County					
	60+00.00 TO 68+02.46	802.46	1604.9	200.6	1604.9
Sta. Eqn. 68+02.46 (BK) = 5+00 (AH)					
	5+00 TO 9+37	437.45	874.9	109.4	874.9
Fulton County					
	9+37 TO 22+50	1312.55	2625.1	328.1	363.0
SIDEROADS					
County Highway			116.0	-	-
TOTAL			5221	638	2843
				8702	

CONSTRUCTION STATION LAYOUT	
LOCATION	L SUM
McDonough County	0.5
Fulton County	0.5
TOTAL	1

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**STATE OF ILLINOIS
DEPARTMENT OF TRANSPORTATION**

SCHEDULE OF QUANTITIES				
SCALE:	SHEET	OF	SHEETS	STA. TO STA.

F.A.P. RTE.	SECTION	COUNTY	TOTAL SHEETS	SHEET NO.
574	(12)CR	*	202	27
CONTRACT NO. 68C64				
ILLINOIS FED. AID PROJECT				
* FULTON / McDONOUGH				

GUARDRAIL AGGREGATE EROSION CONTROL	
LOCATION	TON
Fulton County	
Rt. Sta. 15+67.5 to 18+92.5	65.80
TOTAL	66

FILLING DRAINAGE STRUCTURES		
LOCATION	TYPE	EACH
Fulton County		
Sta. 17+50	Double 6'x7'	1
TOTAL		1

CONSTRUCTION LAYOUT	
LOCATION	L SUM
McDonough County	0.5
Fulton County	0.5
TOTAL	1


STRIP REFLECTIVE CRACK CONTROL TREATMENT	
LOCATION	FOOT
McDonough County	
Rt. Sta. 6+37 to 9+37.45	300.45
Lt. Sta. 6+25 to 9+37.45	312.45
Fulton County	
Rt. Sta. 9+37.45 to 13+50	412.55
Lt. Sta. 9+37.45 to 13+50	412.55
TOTAL	1438.0

DETOUR ROADWAY REMOVAL	
LOCATION	SQ YD
Fulton County	
Rt. Sta 25 + 00	933.4
TOTAL	933.4

FENCE REMOVAL	
LOCATION	FOOT
Fulton County	
Rt. Sta. 11+20 to 14+00	280
Rt. Sta. 14+56 to 17+40	284
TOTAL	564

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USER NAME = eversct	DESIGNED -	REVISED -	STATE OF ILLINOIS DEPARTMENT OF TRANSPORTATION	SCHEDULE OF QUANTITIES				F.A.P. RTE.	SECTION	COUNTY	TOTAL SHEETS	SHEET NO.
PLOT SCALE = 100,0000 ' / in.	DRAWN -	REVISED -						574	(12)CR	*	202	28
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	DATE -	REVISED -		ILLINOIS FED. AID PROJECT				* FULTON / McDONOUGH				

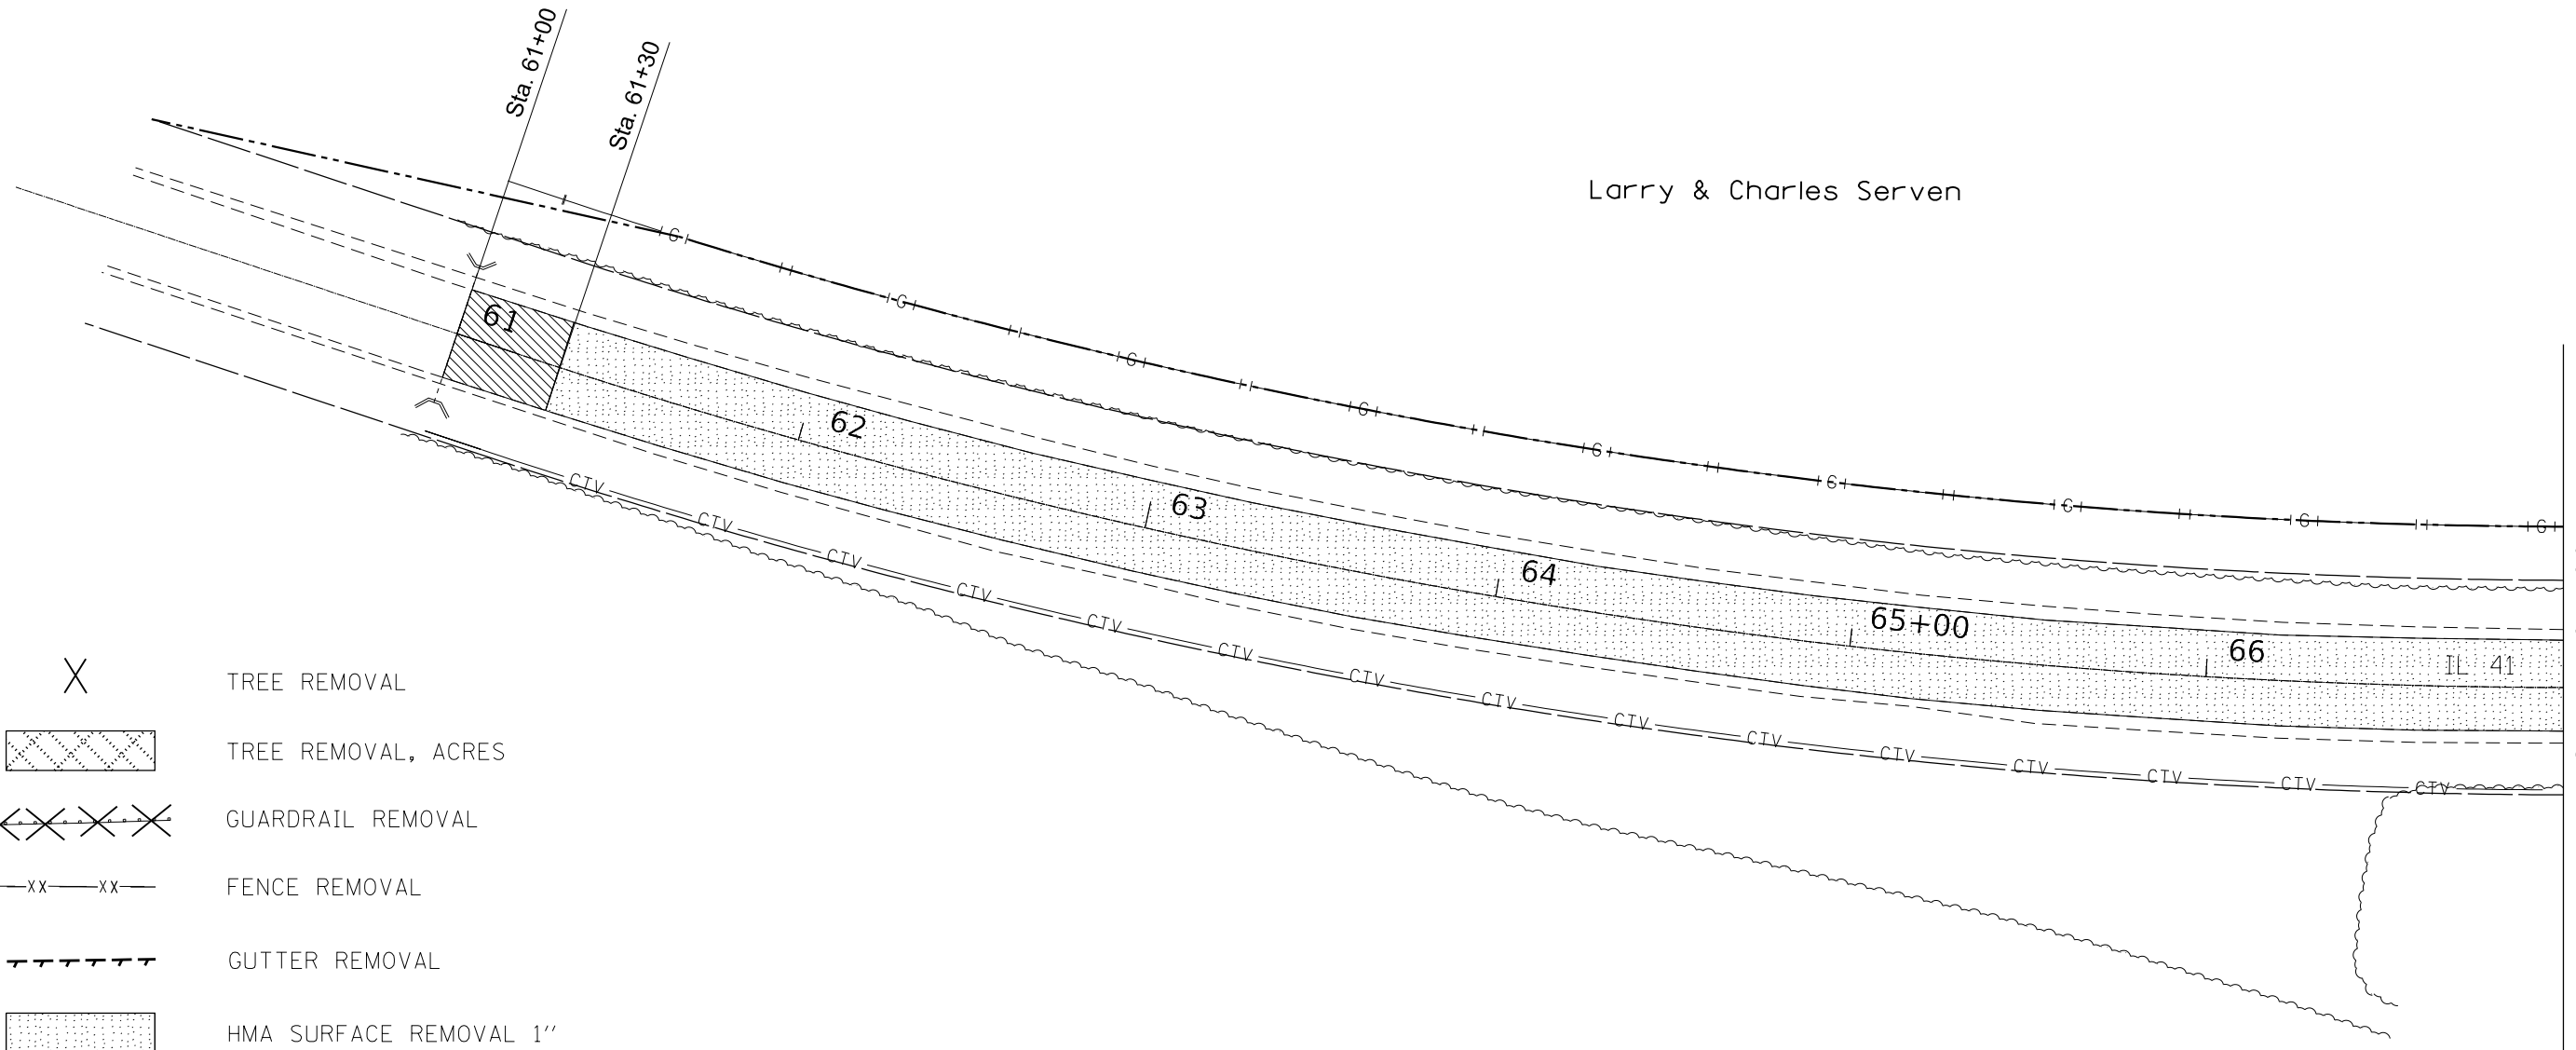

- X
 TREE REMOVAL
- TREE REMOVAL, ACRES
- GUARDRAIL REMOVAL
- FENCE REMOVAL
- GUTTER REMOVAL
- HMA SURFACE REMOVAL 1"
- PAVEMENT REMOVAL
- HMA SURFACE REMOVAL, BUTT JOINT

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**STATE OF ILLINOIS
DEPARTMENT OF TRANSPORTATION**

REMOVAL PLANS


SCALE: SHEET OF SHEETS STA. 61+00 TO STA. 67+00

F.A.P. RTE.	SECTION	COUNTY	TOTAL SHEETS	SHEET NO.
574	(12)CR	*	202	29
CONTRACT NO. 68C64				

ILLINOIS FED. AID PROJECT
* FULTON / McDONOUGH



MATCHLINE 67+00

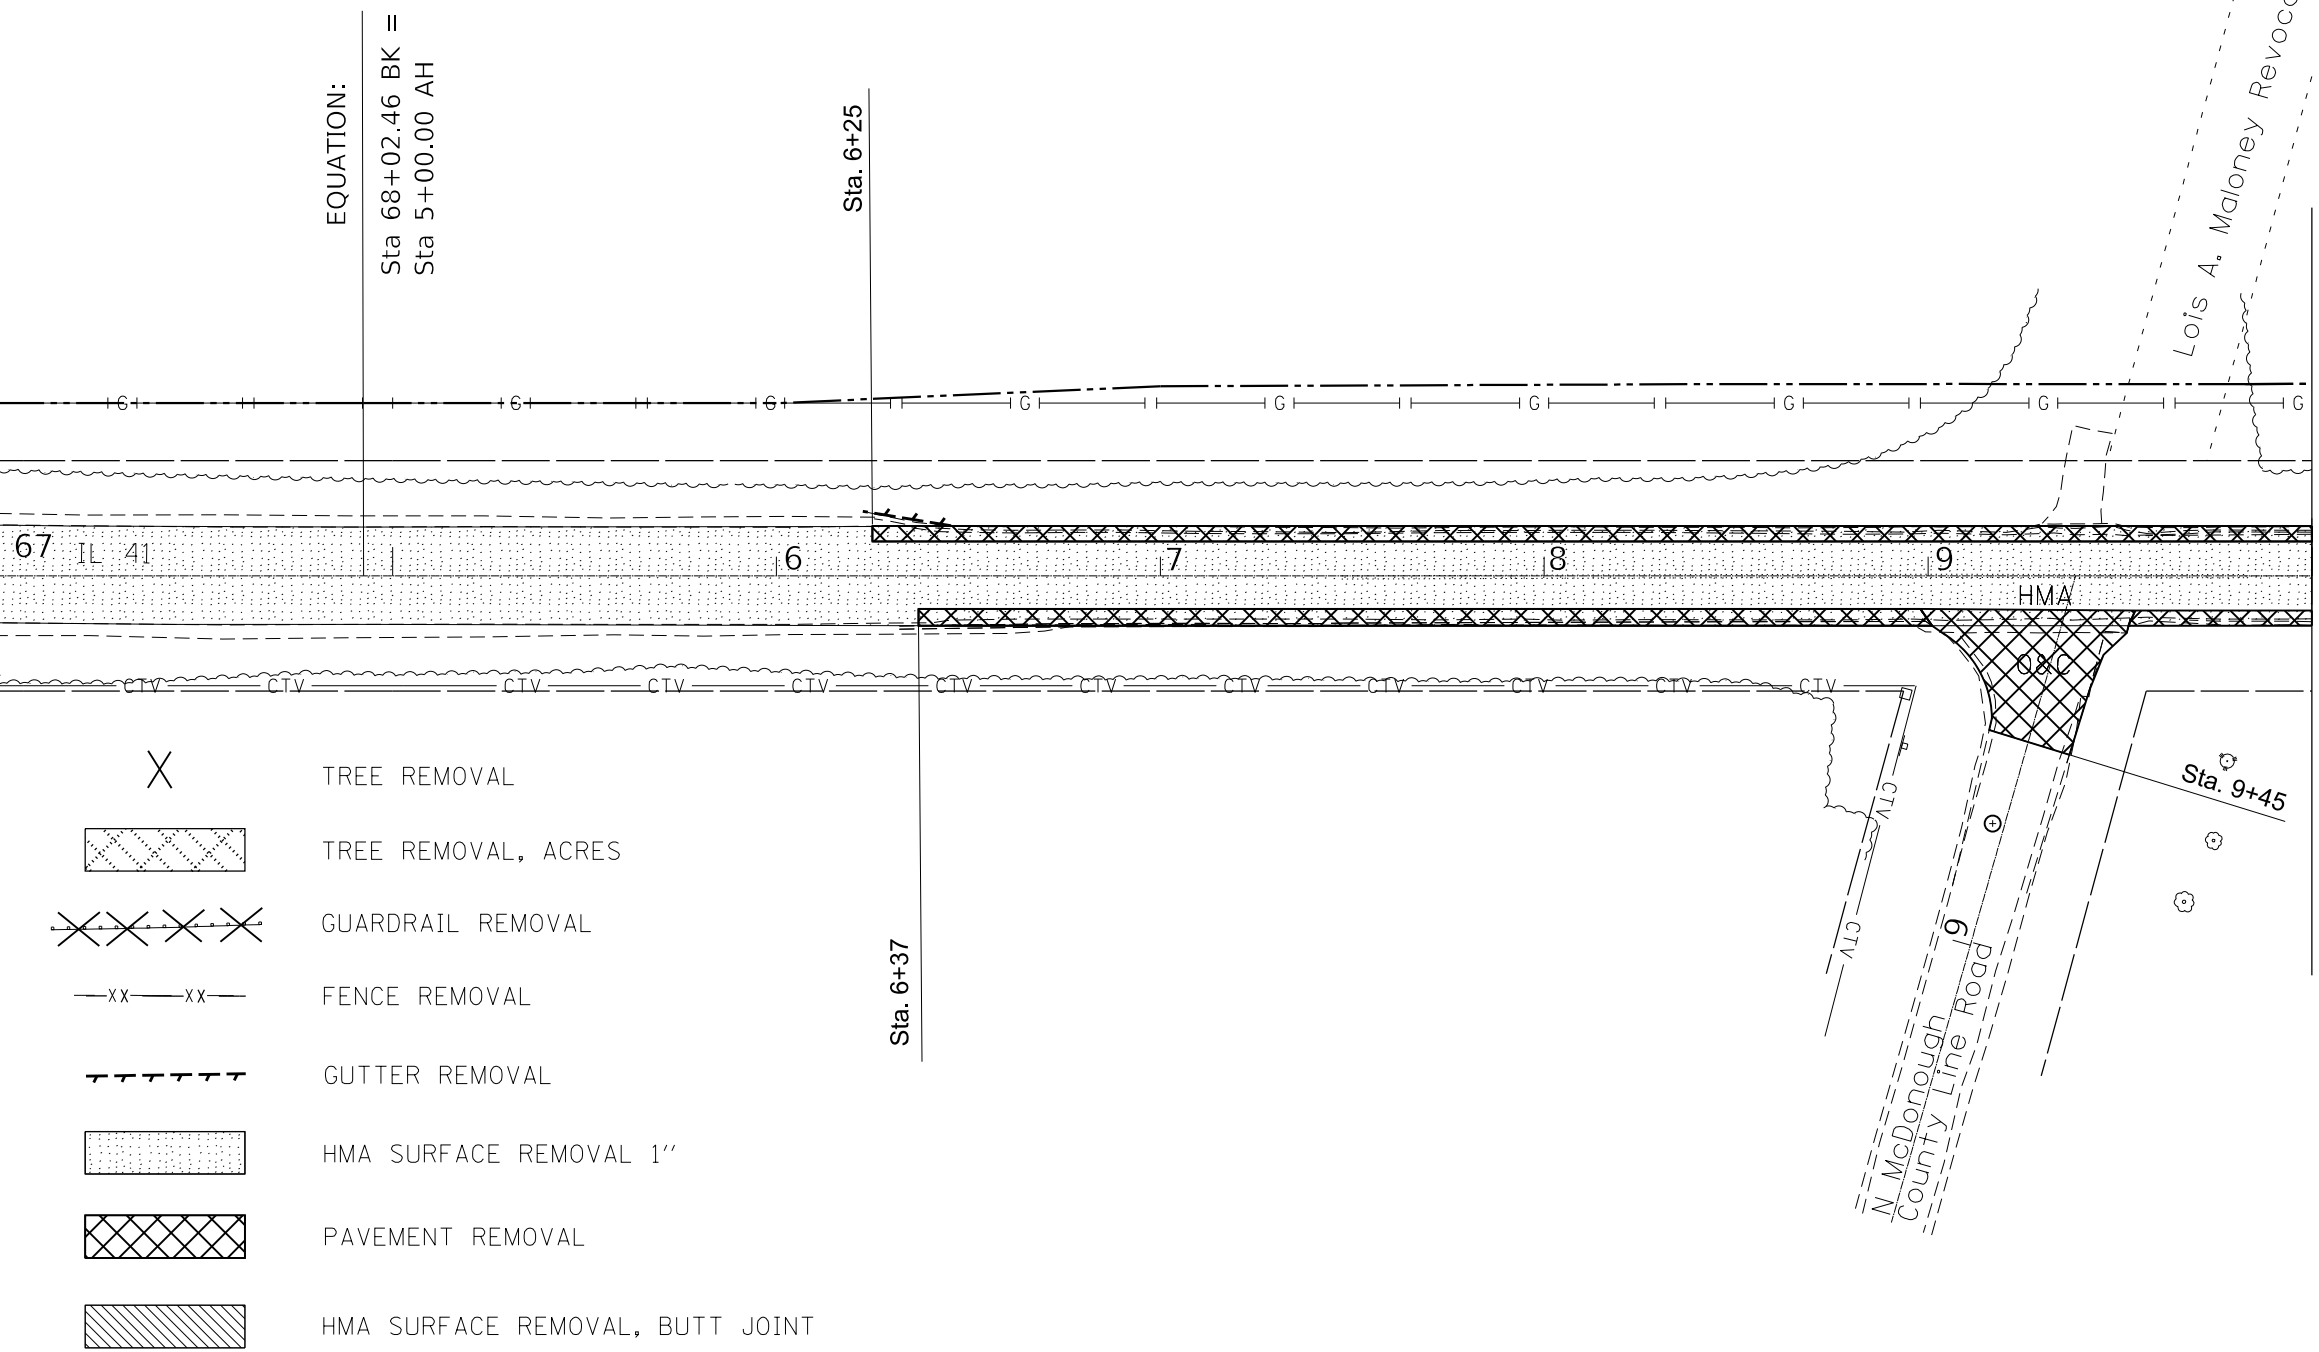

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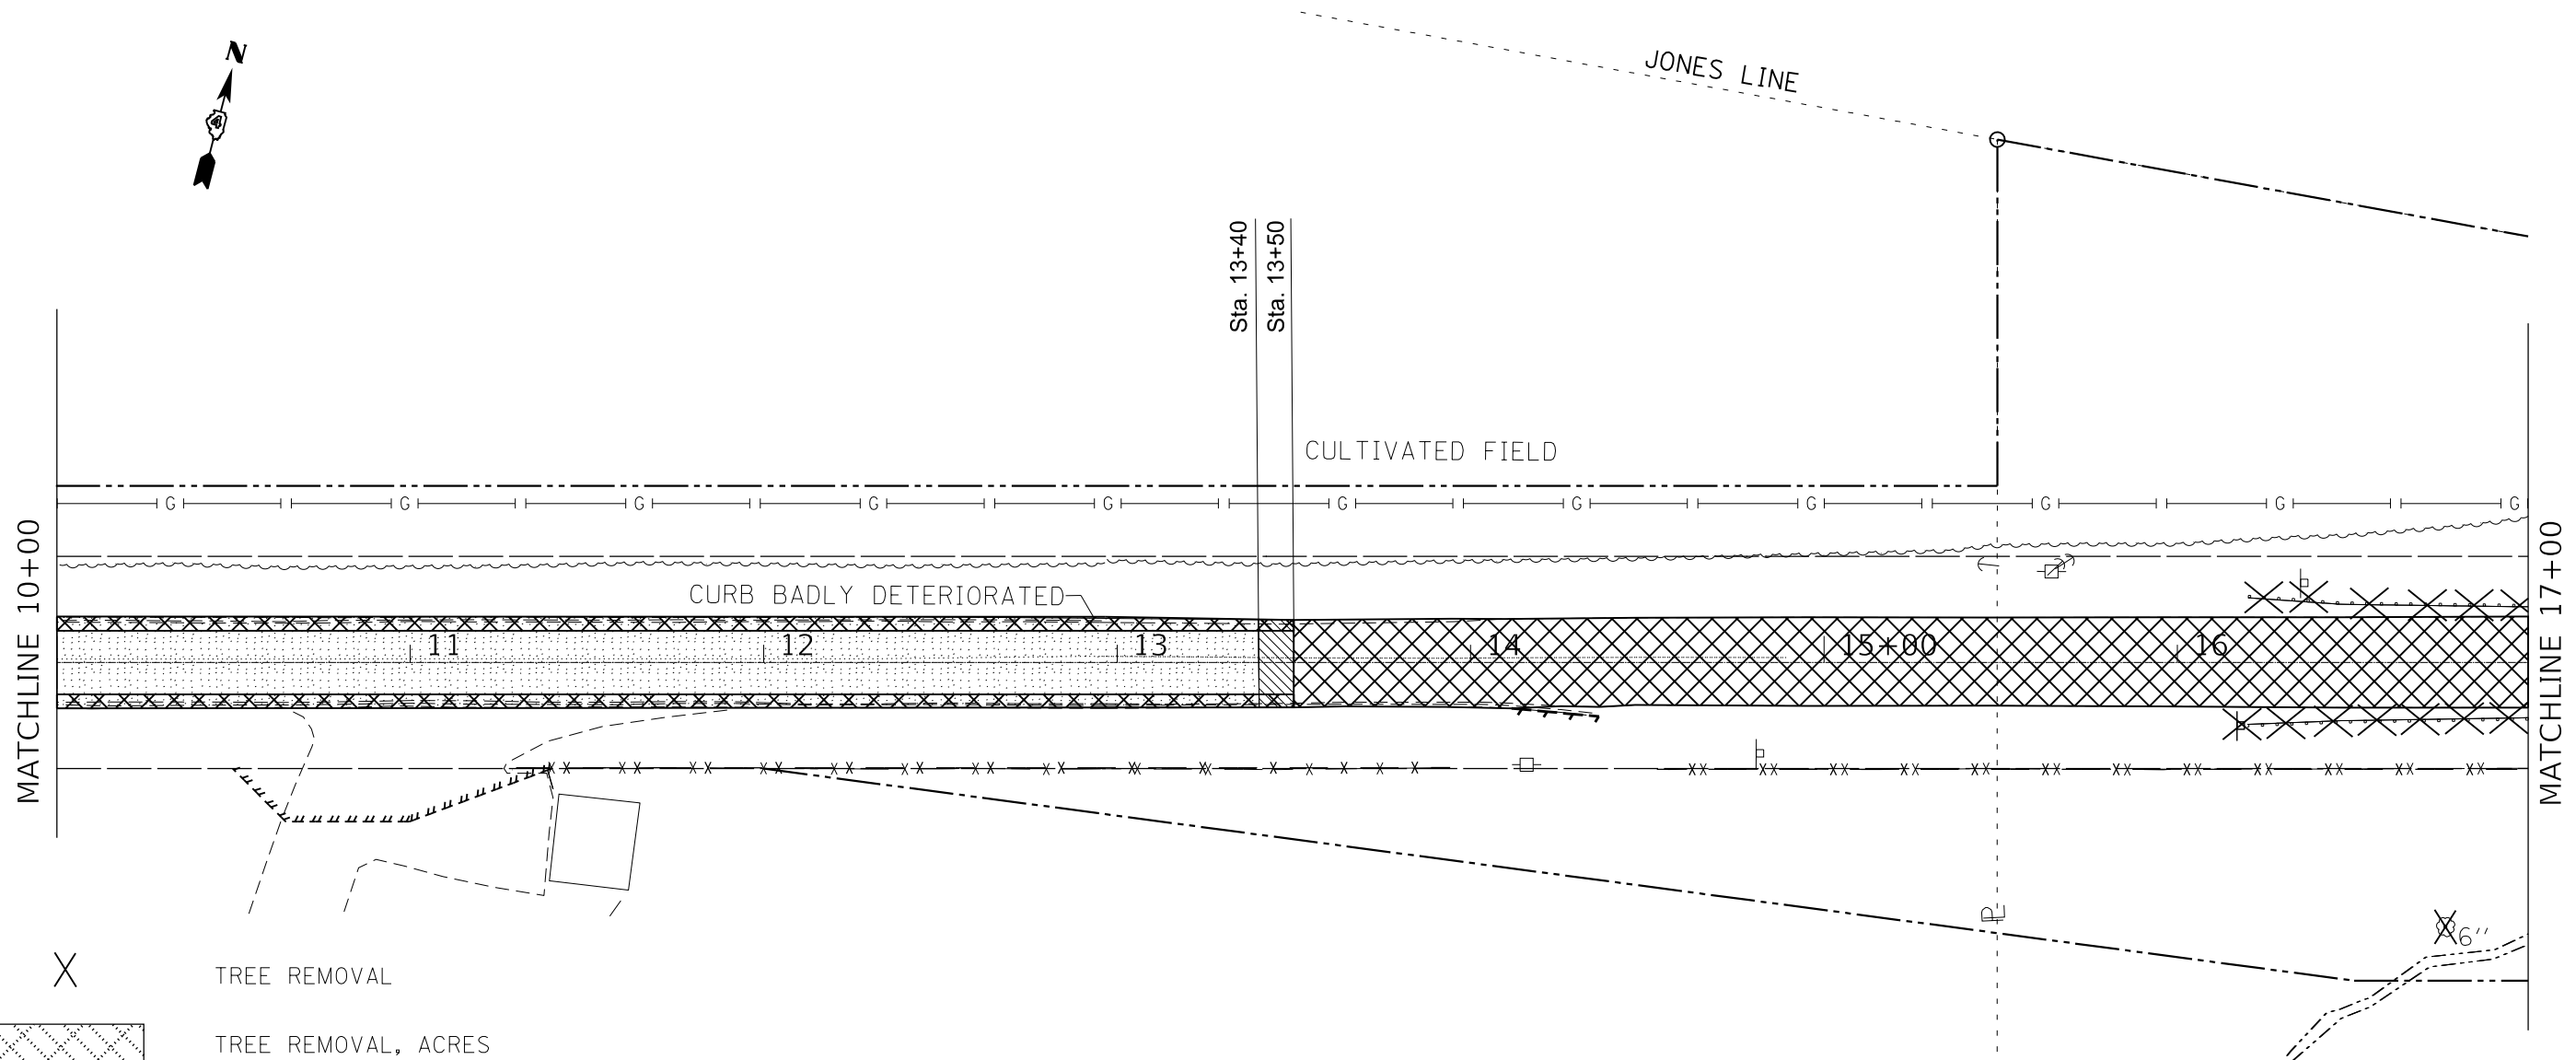
**STATE OF ILLINOIS
DEPARTMENT OF TRANSPORTATION**

REMOVAL PLANS

SCALE: SHEET OF SHEETS STA. 67+00 TO STA. 10+00

F.A.P. RTE.	SECTION	COUNTY	TOTAL SHEETS	SHEET NO.
574	(12)CR	*	202	30
CONTRACT NO. 68C64				

ILLINOIS FED. AID PROJECT
FULTON / McDONOUGH



- X TREE REMOVAL
- [Cross-hatched box] TREE REMOVAL, ACRES
- [X-X-X-X] GUARDRAIL REMOVAL
- XX-XX- FENCE REMOVAL
- [Dashed line] GUTTER REMOVAL
- [Dotted box] HMA SURFACE REMOVAL 1"
- [Cross-hatched box] PAVEMENT REMOVAL
- [Diagonal hatched box] HMA SURFACE REMOVAL, BUTT JOINT

Brady & Toni Mason

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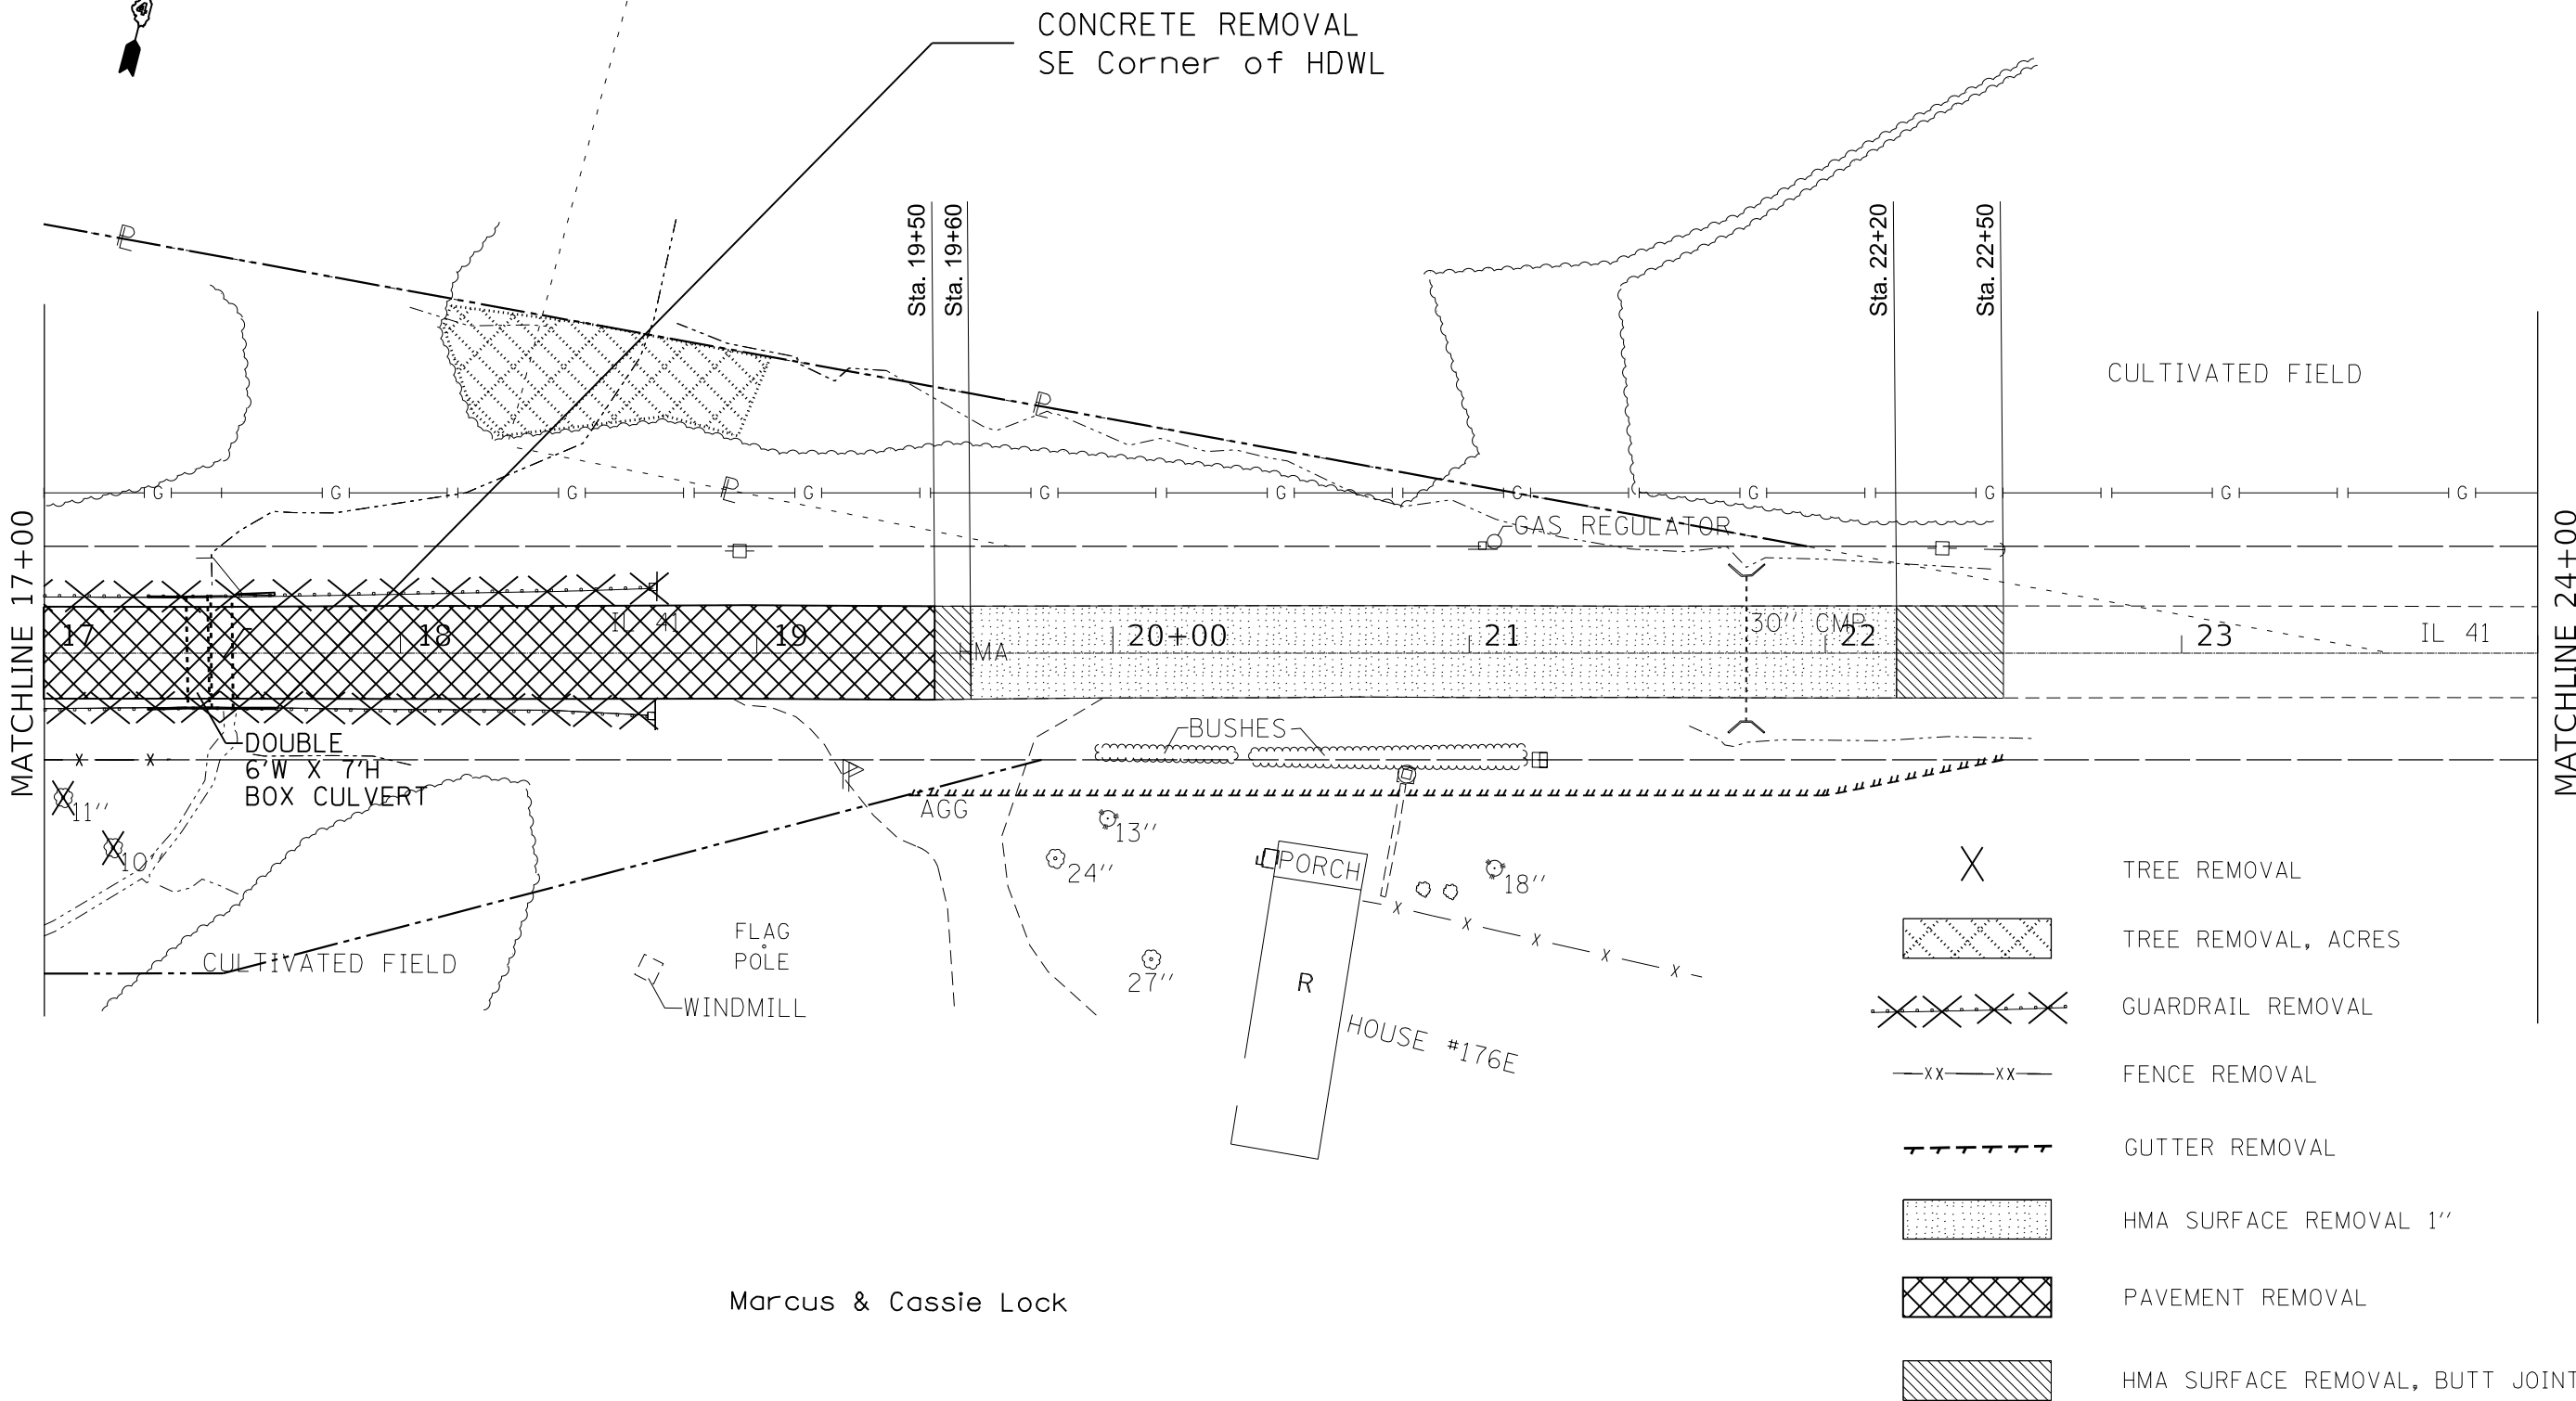
**STATE OF ILLINOIS
DEPARTMENT OF TRANSPORTATION**

REMOVAL PLANS

SCALE: SHEET OF SHEETS STA. 10+00 TO STA. 17+00

F.A.P. RTE.	SECTION	COUNTY	TOTAL SHEETS	SHEET NO.
574	(12)CR	*	202	31
CONTRACT NO. 68C64				

ILLINOIS FED. AID PROJECT
* FULTON / McDONOUGH



- X TREE REMOVAL
- [Cross-hatched box] TREE REMOVAL, ACRES
- [X-X-X-X] GUARDRAIL REMOVAL
- XX-XX- FENCE REMOVAL
- [Dashed line] GUTTER REMOVAL
- [Dotted box] HMA SURFACE REMOVAL 1"
- [Cross-hatched box] PAVEMENT REMOVAL
- [Diagonal hatched box] HMA SURFACE REMOVAL, BUTT JOINT

Marcus & Cassie Lock

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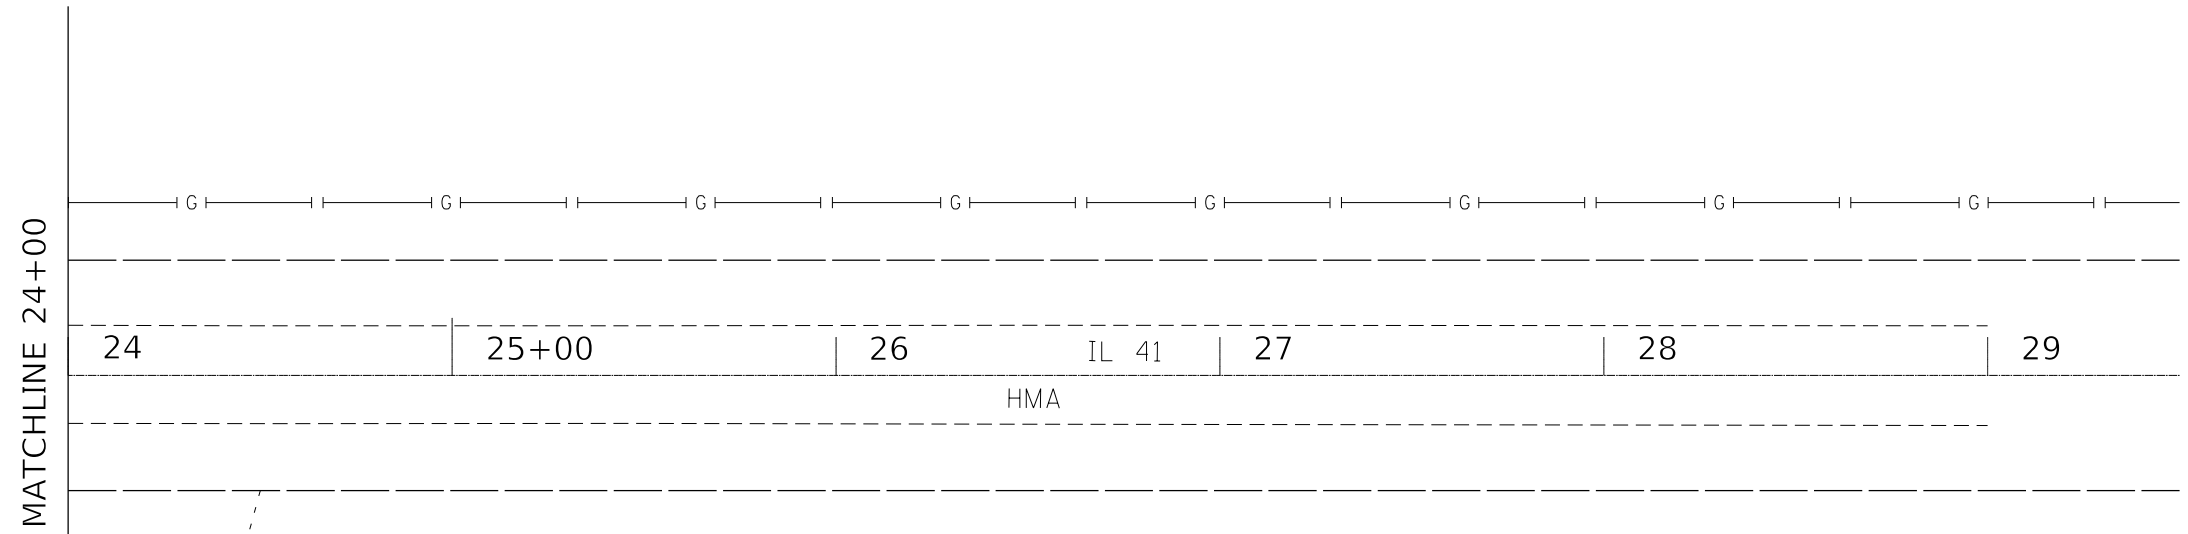
**STATE OF ILLINOIS
DEPARTMENT OF TRANSPORTATION**









REMOVAL PLANS

SCALE: SHEET OF SHEETS STA. 17+00 TO STA. 24+00

F.A.P. RTE.	SECTION	COUNTY	TOTAL SHEETS	SHEET NO.
574	(12)CR	*	202	32
CONTRACT NO. 68C64				

ILLINOIS FED. AID PROJECT
* FULTON / McDONOUGH

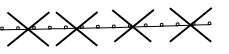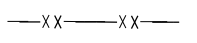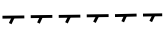

-  TREE REMOVAL
-  TREE REMOVAL, ACRES
-  GUARDRAIL REMOVAL
-  FENCE REMOVAL
-  GUTTER REMOVAL
-  HMA SURFACE REMOVAL 1"
-  PAVEMENT REMOVAL
-  HMA SURFACE REMOVAL, BUTT JOINT

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**STATE OF ILLINOIS
DEPARTMENT OF TRANSPORTATION**

REMOVAL PLANS

SCALE: SHEET OF SHEETS STA. 24+00 TO STA. 29+00



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574	(12)CR	*	202	33
CONTRACT NO. 68C64				

ILLINOIS FED. AID PROJECT
* FULTON / McDONOUGH

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	GRADES CHECKED		
	STRUCTURE NOTATIONS CHECKED		
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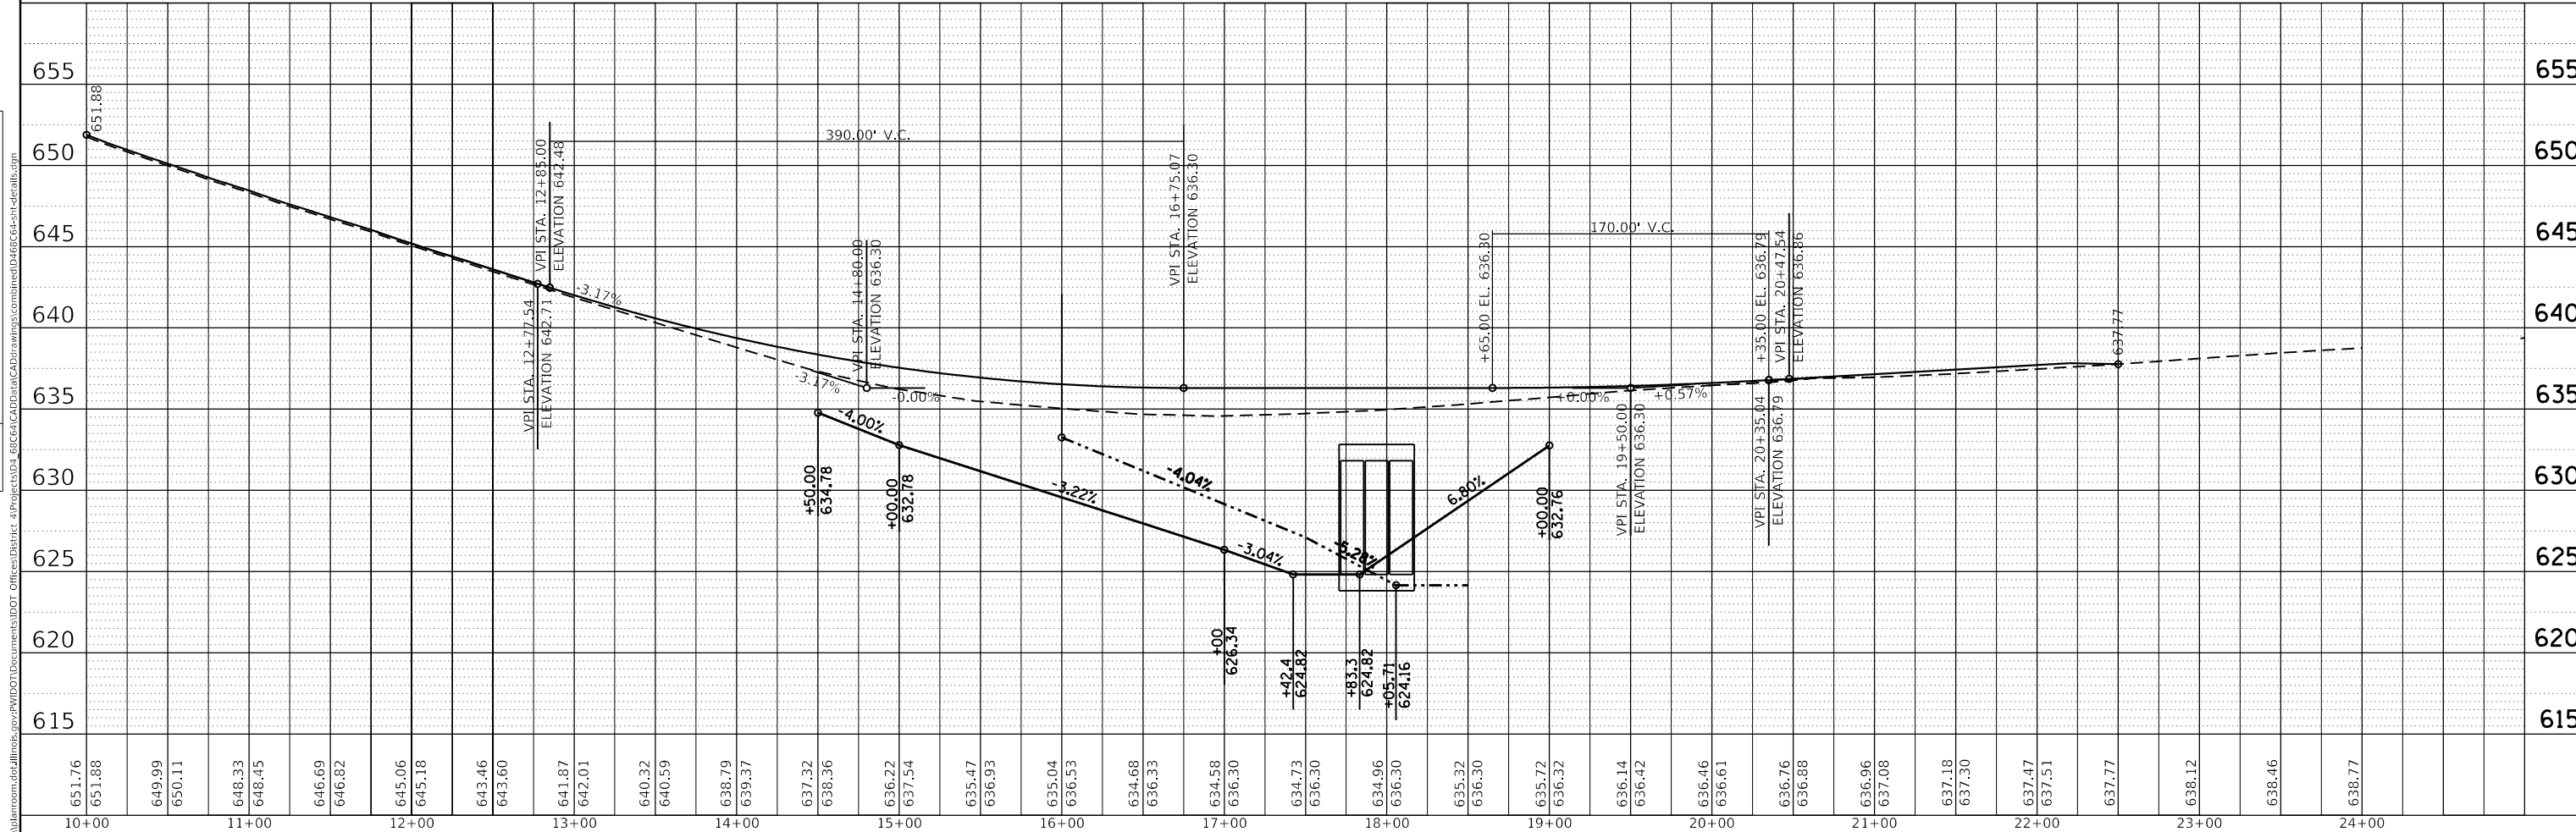
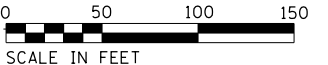
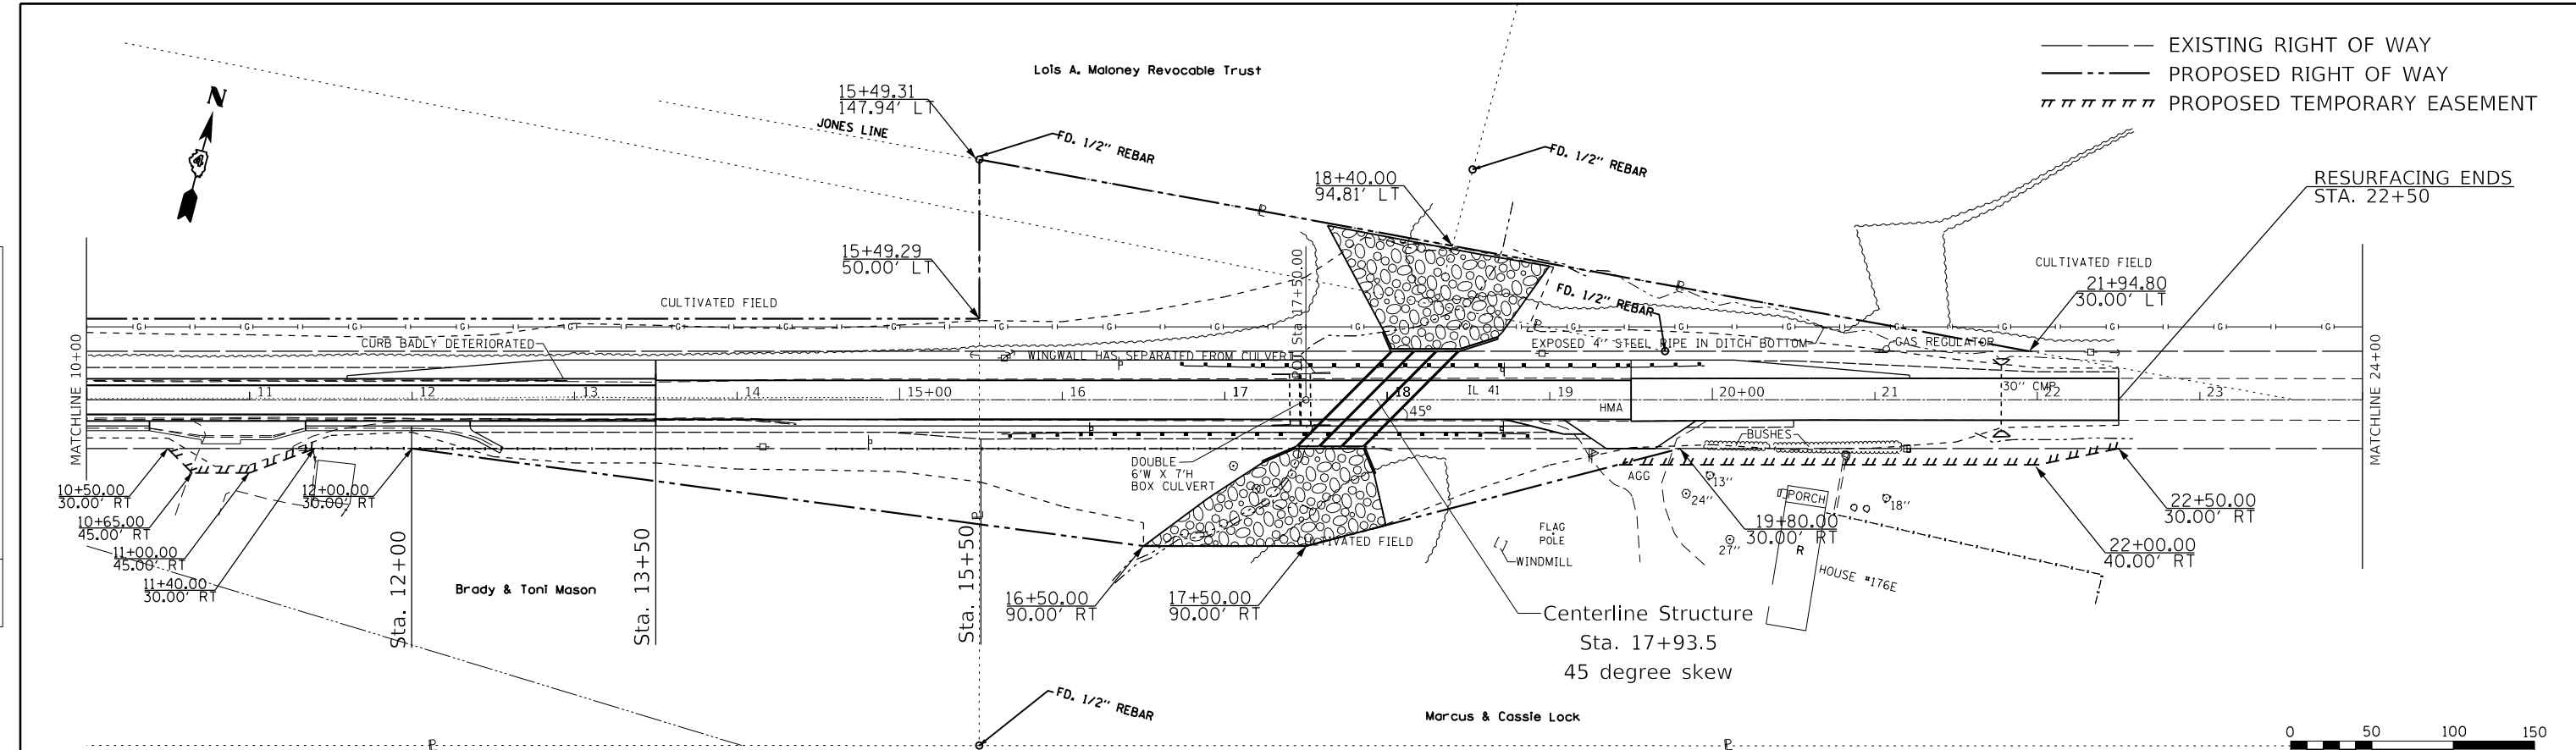
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PLOT DATE = 10/18/2019	DATE -	REVISED -					ILLINOIS FED. AID PROJECT				FULTON / McDONOUGH				

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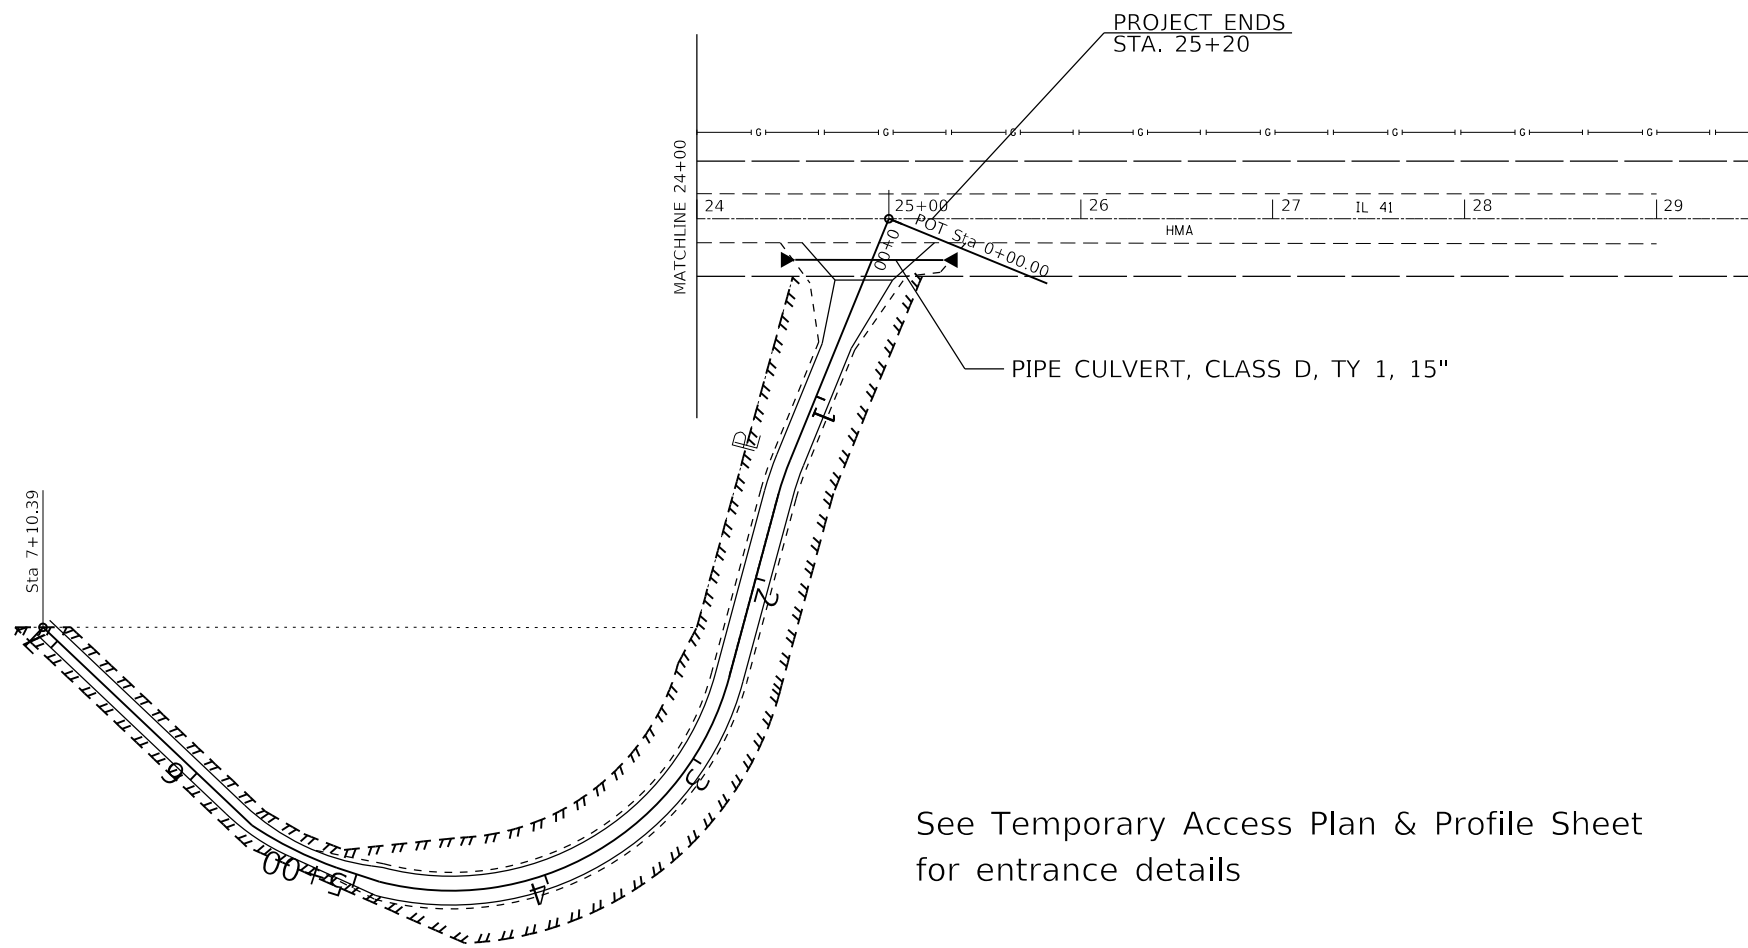
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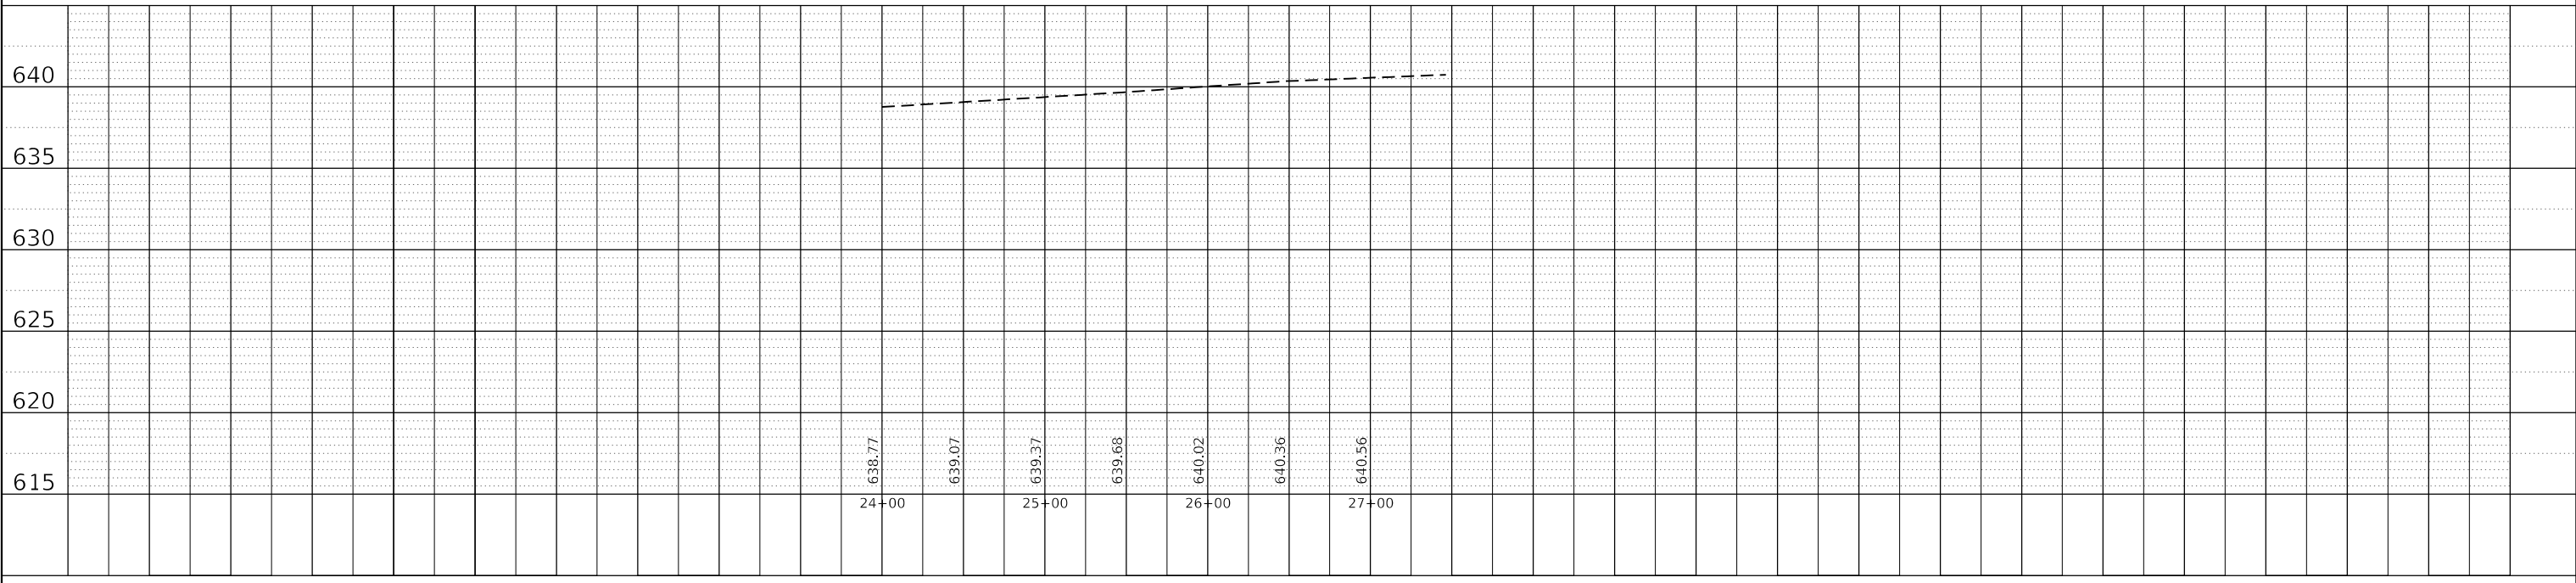
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PLAN	SURVEYED	DATE
	BY	
NOTE BOOK	ALIGNED CHECKED	
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PROFILE	SURVEYED	DATE
	BY	
NOTE BOOK	GRADES CHECKED	
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See Temporary Access Plan & Profile Sheet for entrance details

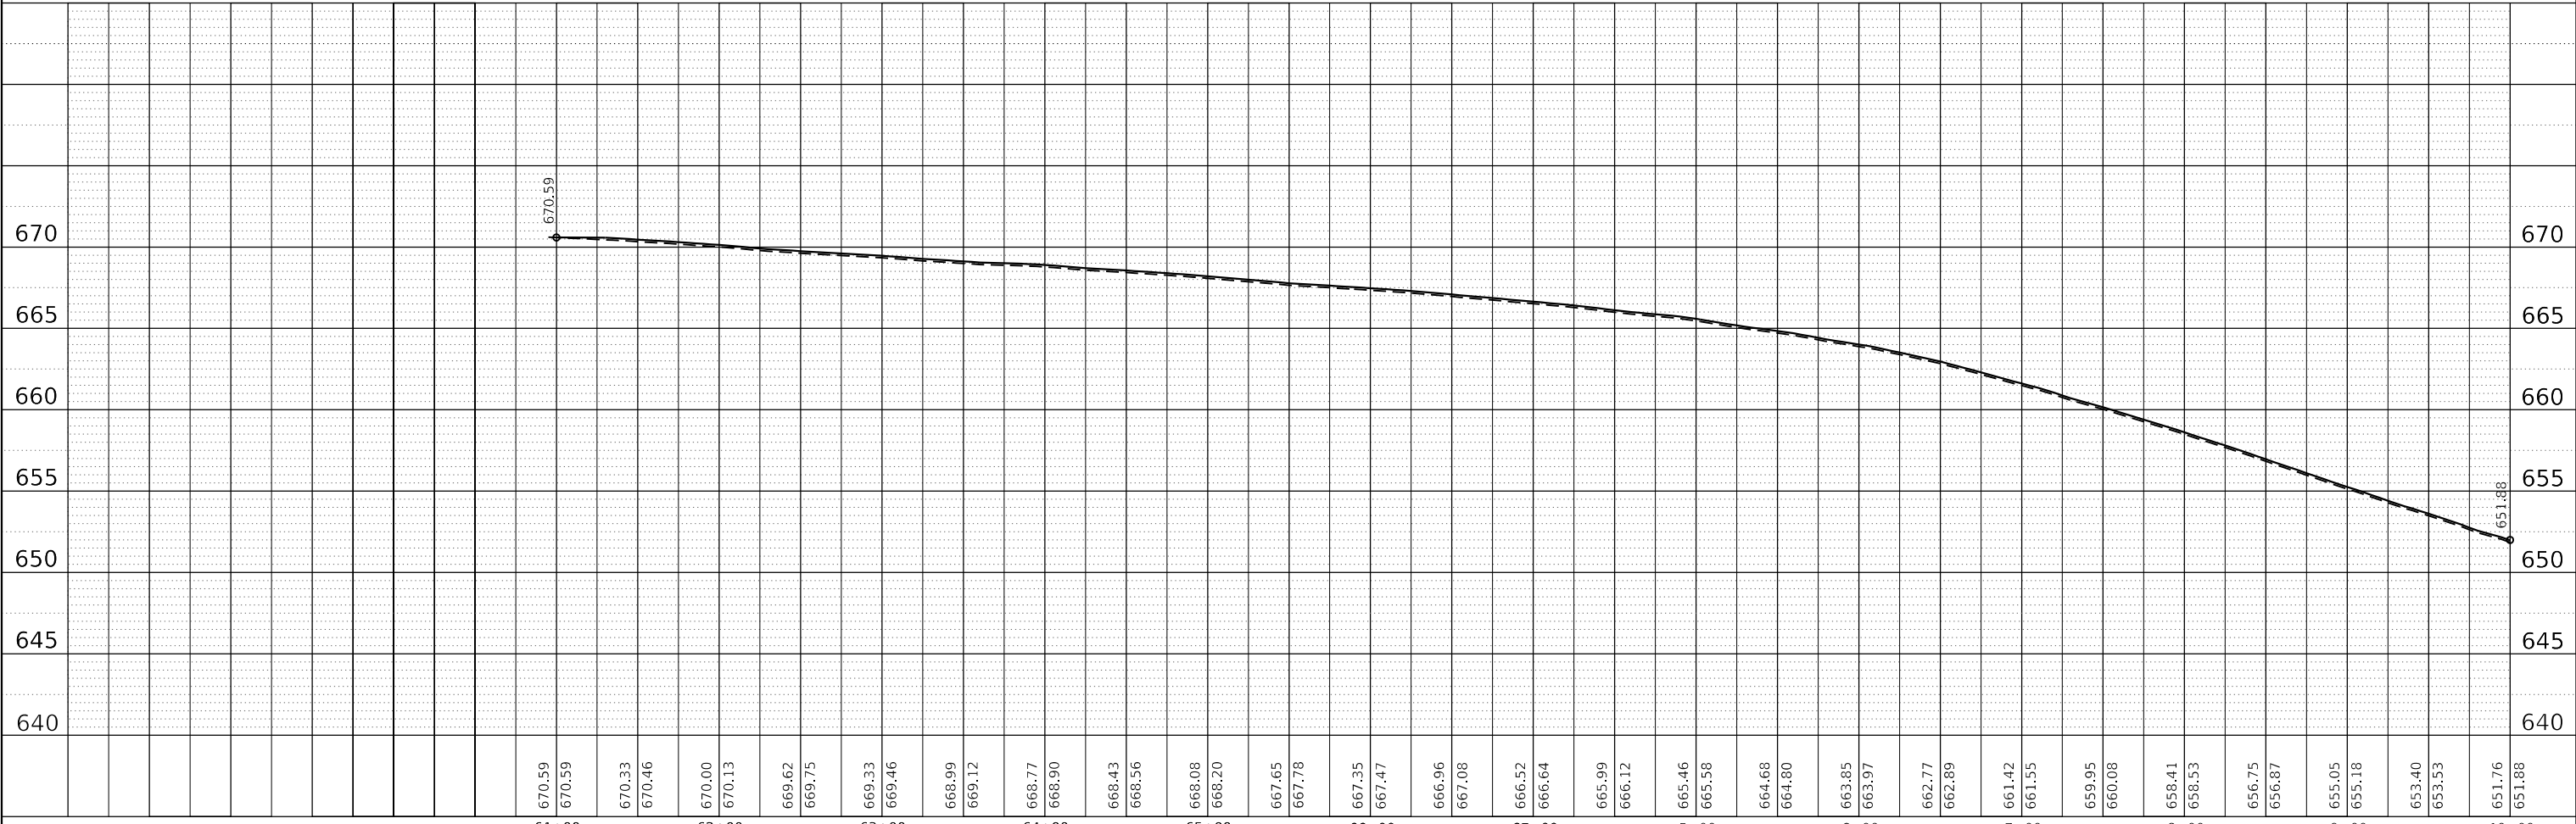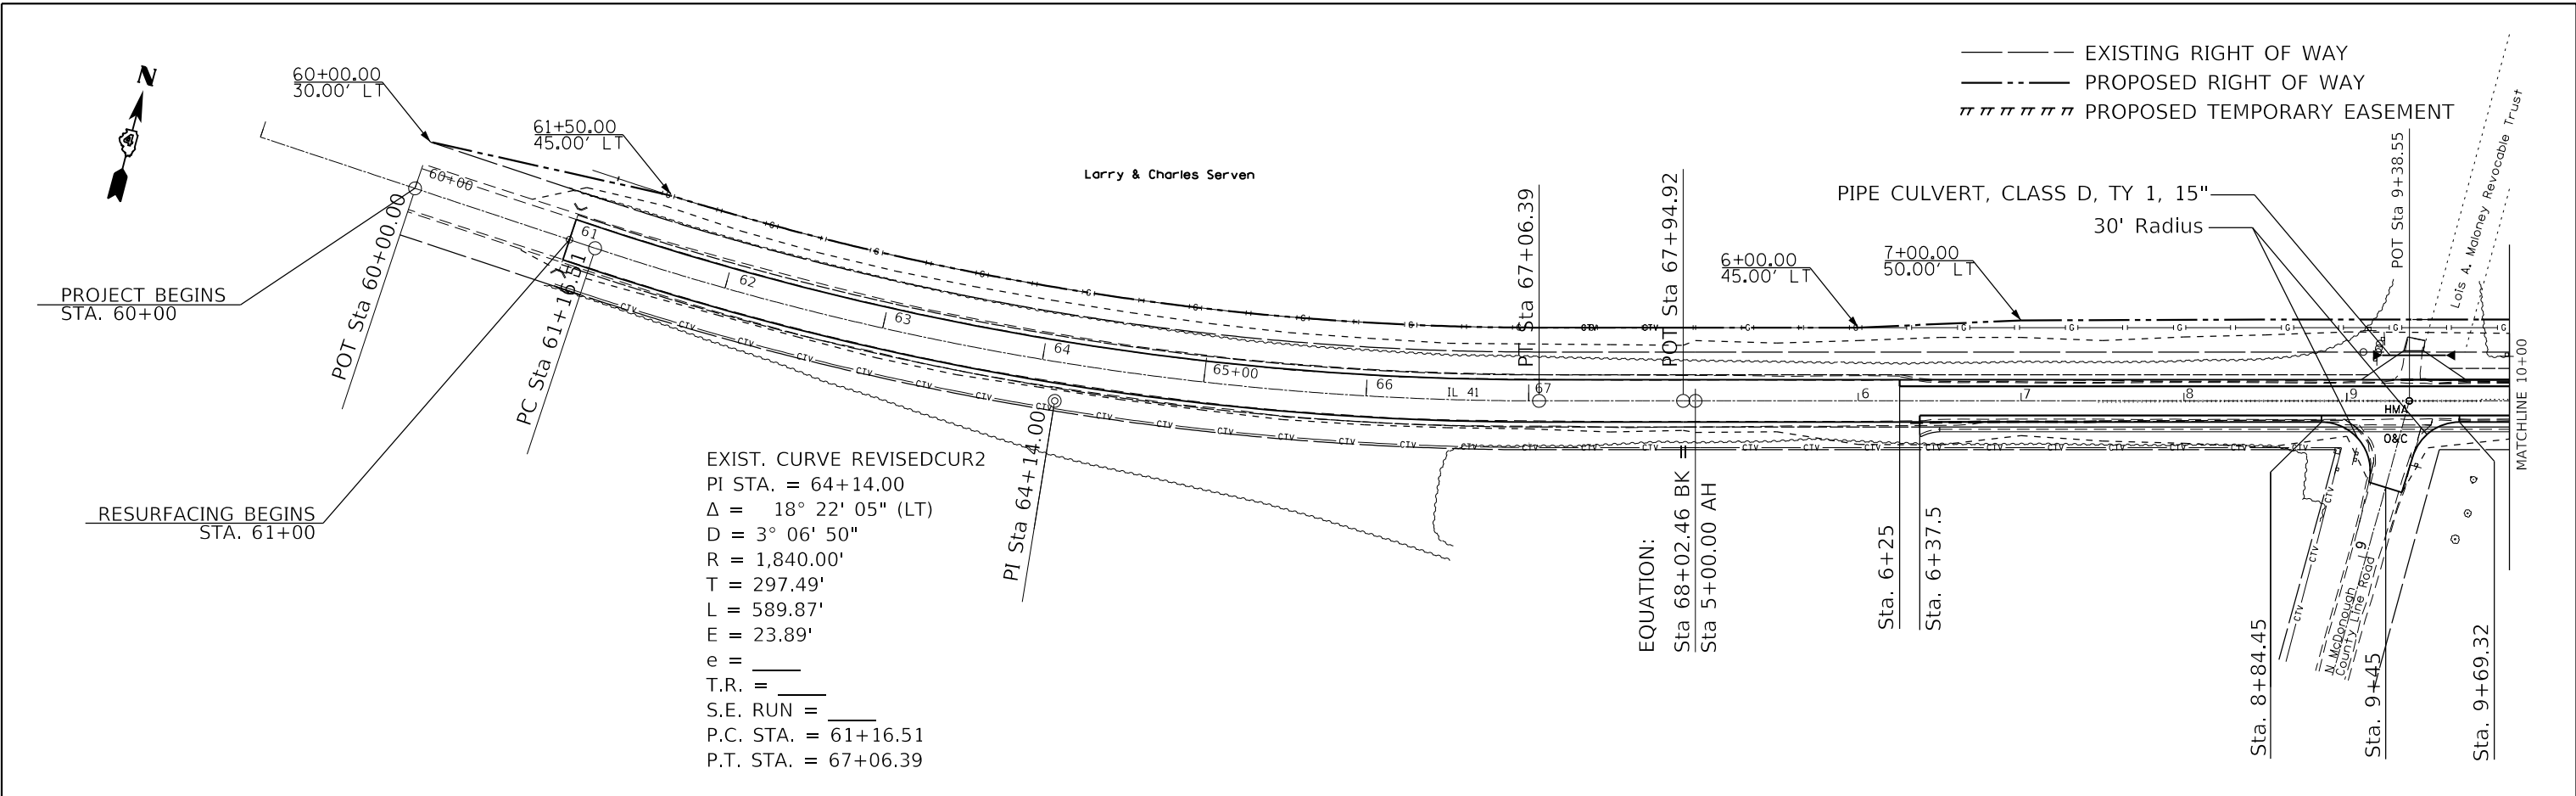

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**STATE OF ILLINOIS
DEPARTMENT OF TRANSPORTATION**


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SCALE:	SHEET	OF	SHEETS
			STA. 24+00 TO STA. 29+00

F.A.P. RTE.	SECTION	COUNTY	TOTAL SHEETS	SHEET NO.
574	12 (CR)	*	202	36
CONTRACT NO. 68C64				
ILLINOIS FED. AID PROJECT				


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DETOUR ROADWAY REMOVAL
 8400.8593 Sq. ft. = 933.3 SY



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	DATE -	REVISED -

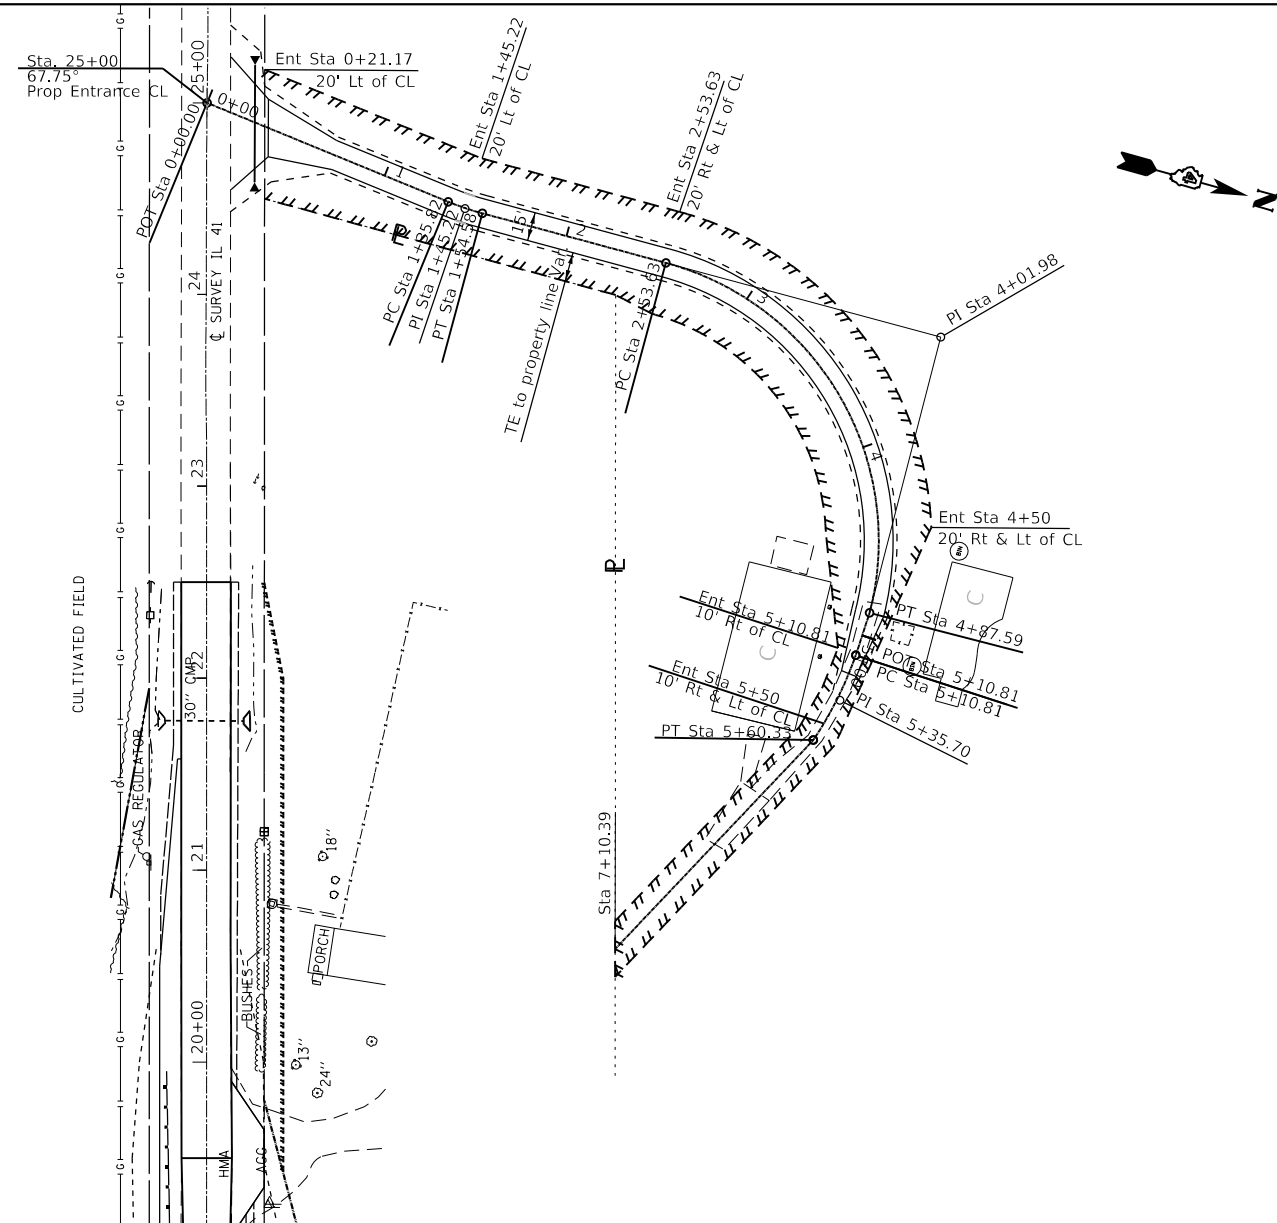STATE OF ILLINOIS
 DEPARTMENT OF TRANSPORTATION

TEMPORARY ACCESS PLAN & PROFILE		F.A.P. RTE. 574	SECTION 12(CR)	COUNTY *	TOTAL SHEETS 202	SHEET NO. 37
SCALE:	SHEET	OF	SHEETS	STA. 0+00	TO STA. 5+15	

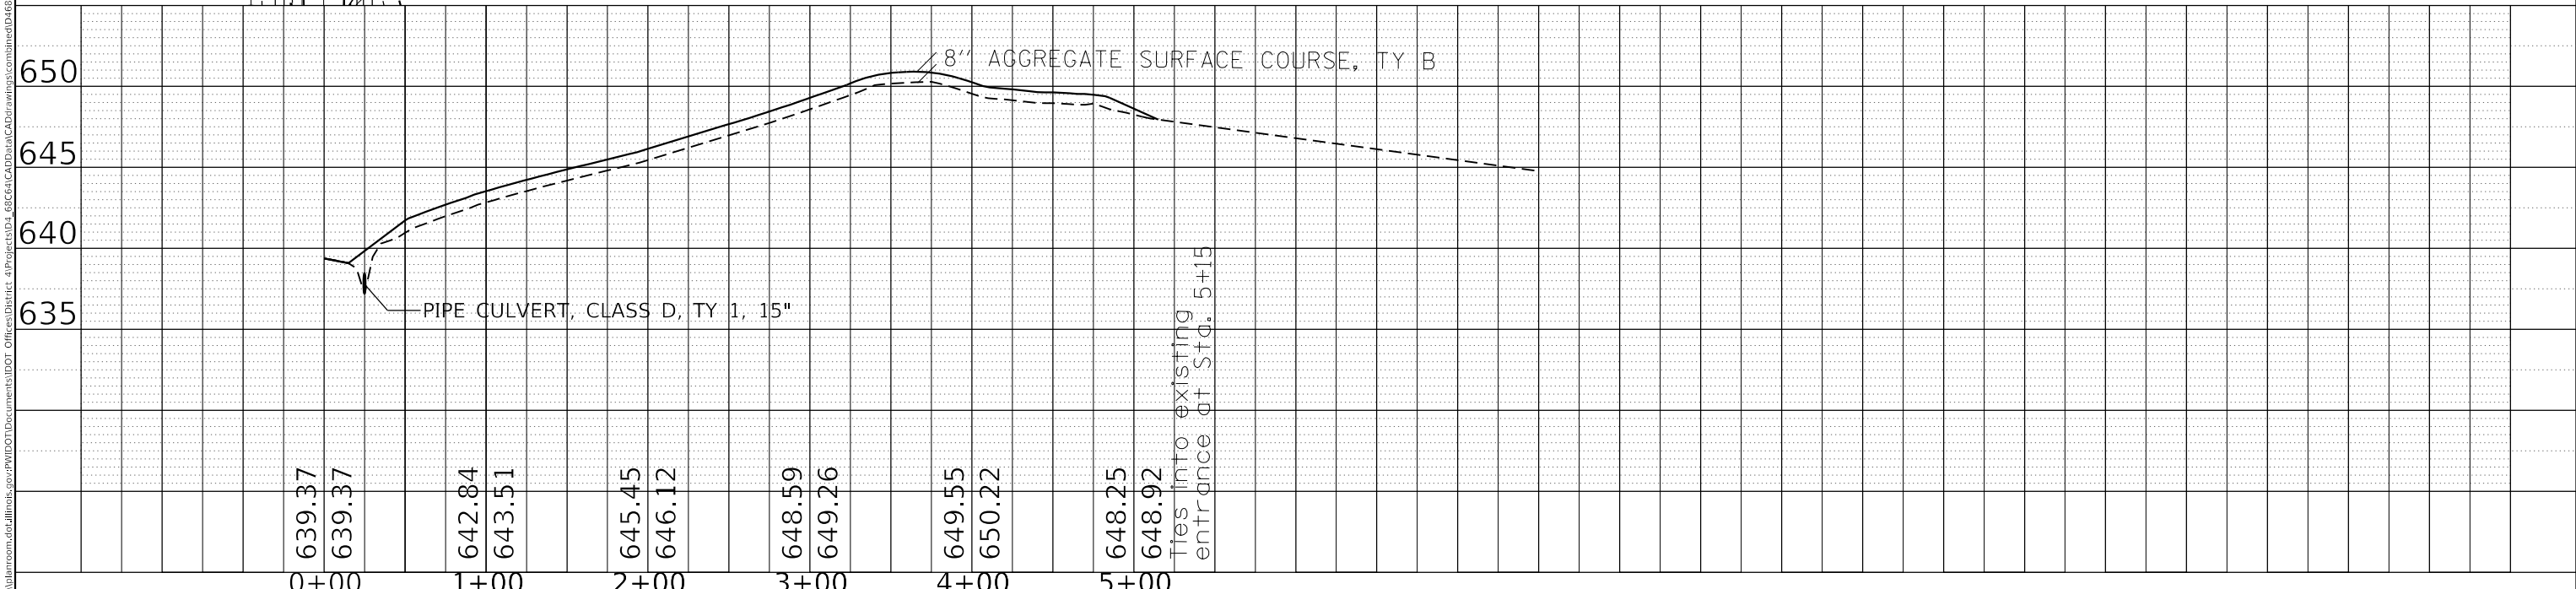ILLINOIS FED. AID PROJECT		CONTRACT NO. 68C64	
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SUGGESTED STAGE CONSTRUCTION SEQUENCE

STAGE I	INSTALL NECESSARY TRAFFIC CONTROL AND TEMPORARY SIGNALS PER STAGING PLAN. INSTALL TEMPORARY CONCRETE BARRIER , DRUMS AND STRIPING PER STAGING PLAN. REMOVE STAGE I PAVEMENT AS SHOWN IN THE PLANS. COMPLETE NORTH PORTION OF THE PROPOSED STRUCTURE, PAVEMENT, EARTHWORK, TOPSOIL AND SEEDING FOR STAGE II TRAFFIC. PLACE 9" OF PROPOSED HMA BASE COURSE AND 9" OF HMA SHOULDER FROM STA. 6+25 TO STA. 21+22. RELOCATE TEMPORARY CONCRETE BARRIER AND DRUMS FOR STAGE II TRAFFIC .	USE TRAFFIC CONTROL STANDARD 701321
STAGE II	REMOVE STAGE II EXISTING PAVEMENT . COMPLETE SOUTH PORTION OF THE PROPOSED STRUCTURE, PAVEMENT, EARTHWORK, TOPSOIL AND SEEDING FOR STAGE III TRAFFIC. PLACE 9" OF PROPOSED HMA BASE COURSE AND 6.5" HMA SHOULDERS FROM STA 6+37 TO STA 20+00. INSTALL GUARDRAIL ON SOUTH SIDE OF STRUCTURE. REMOVE TEMPORARY CONCRETE BARRIER AND TRAFFIC SIGNAL. INSTALL GUARDRAIL ON NORTH SIDE OF STRUCTURE.	USE TRAFFIC CONTROL STANDARD 701006 & 701321
STAGE III	MILL EXISTING PAVEMENT INCLUDING PROPOSED 4' WIDENING FROM STA 61+00 TO 13+50 AND STA 19+50 TO 22+50 PLACE 1" OF POLYMERIZED LEVELING BINDER STA 61+00 TO 13+50 AND STA 19+50 TO 22+50 PLACE TOP LIFT (1.5") OF HMA SURFACE COURSE STA 61+00 TO 22+50 COMPLETE PLACING AGGREGATE SHOULDERS, EARTHWORK AND PROPOSED STRIPING.	USE TRAFFIC CONTROL STANDARD 701006, 701301, 701306, 701311 & 701011

NOTE: THE CONTRACTOR HAVE THE OPTIONS OF GRADING AND DITCHING FROM STA. 61+00 TO STA. 6+25 BEFORE THE START OF STAGE I & II OR AFTER STAGE I & II ARE COMPLETE.

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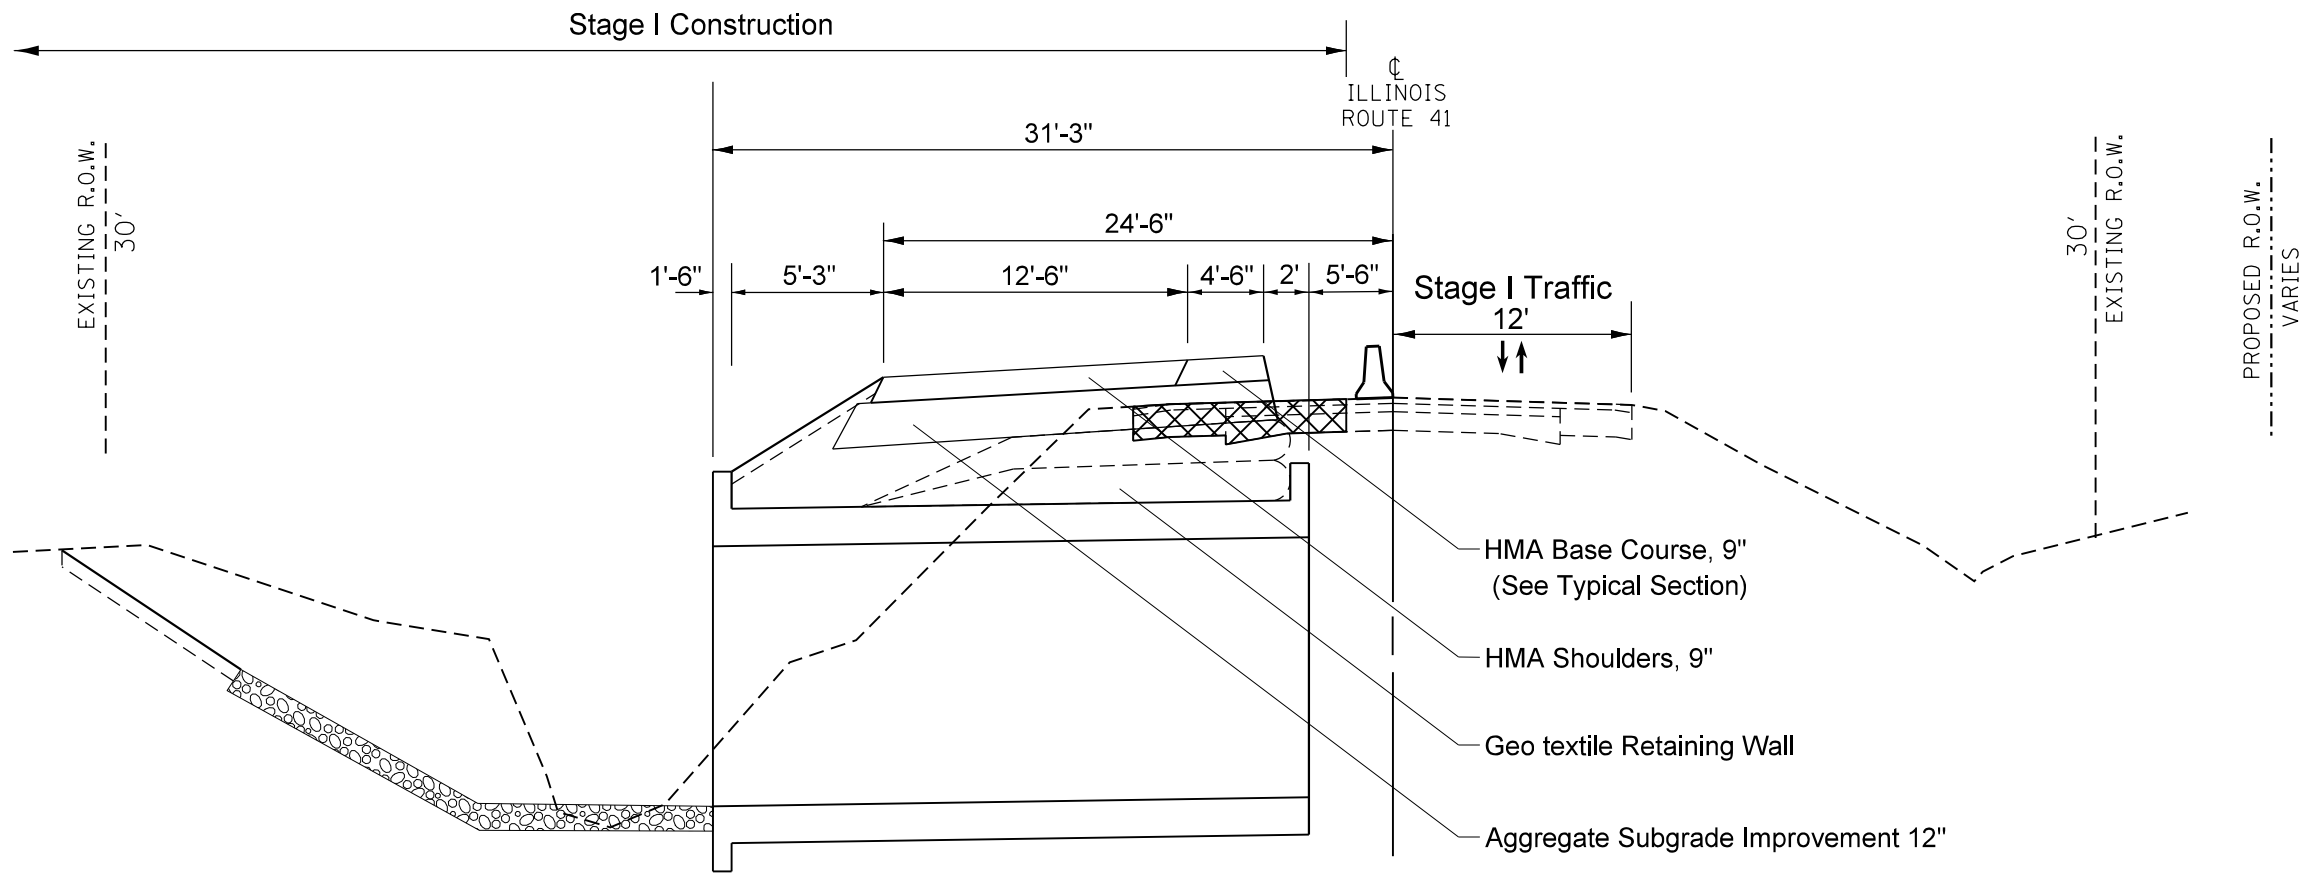
**STATE OF ILLINOIS
DEPARTMENT OF TRANSPORTATION**

Stage Construction Sequence


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F.A.P. RTE.	SECTION	COUNTY	TOTAL SHEETS	SHEET NO.
574	(12)CR	*	114	38
			CONTRACT NO. 68C64	

ILLINOIS FED. AID PROJECT
* FULTON / McDONOUGH



STA. 13+50 TO 19+50

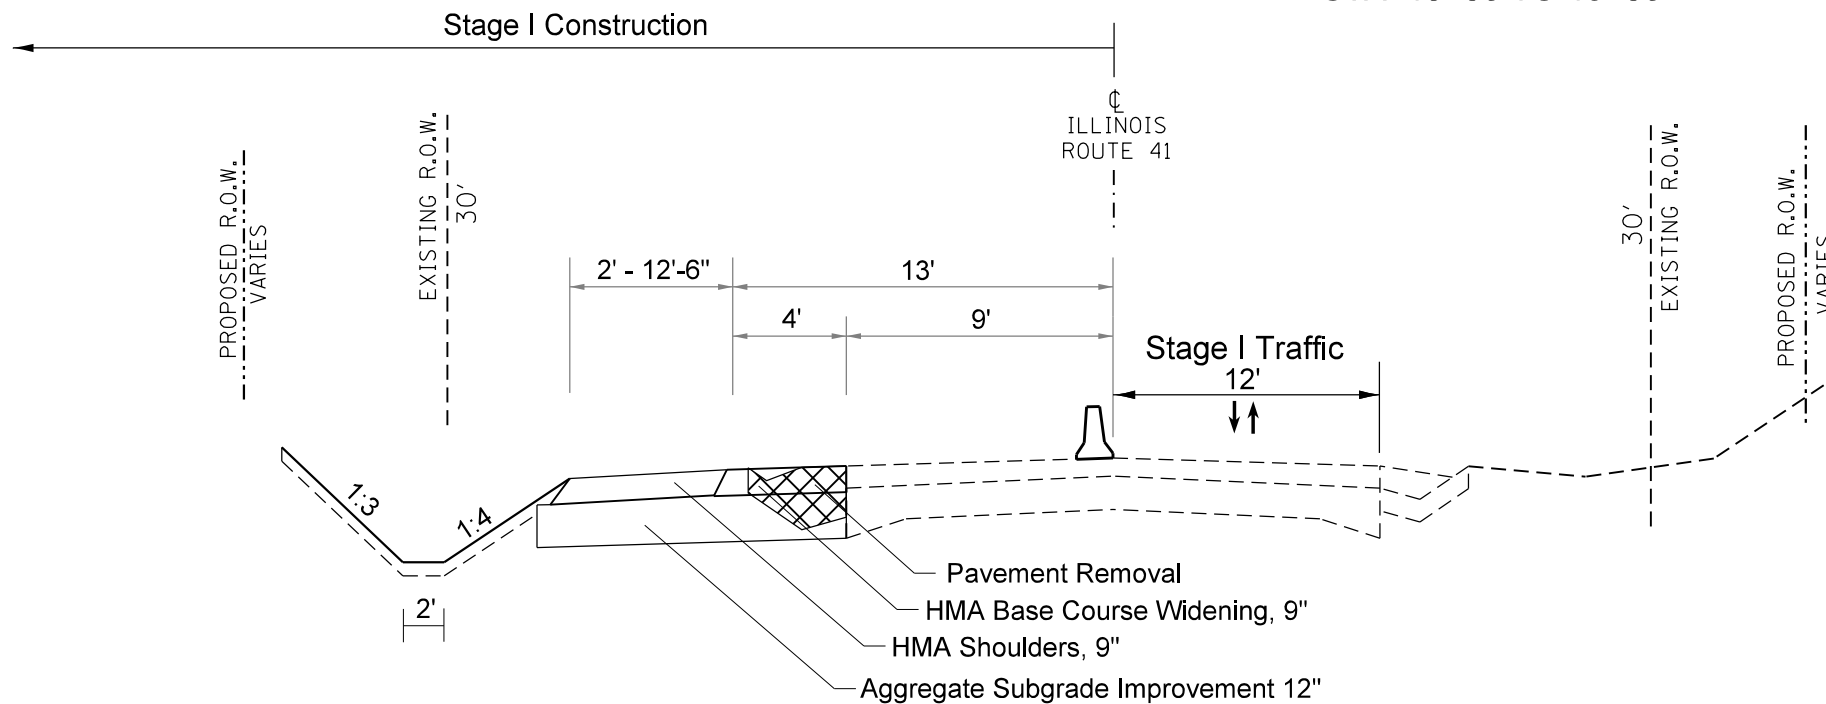

STA. 11+60 TO 13+50
STA. 19+50 TO 21+22

Removal location

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STATE OF ILLINOIS
DEPARTMENT OF TRANSPORTATION


Typical Section
Stage I

SCALE: SHEET OF SHEETS STA. 13+50 TO STA. 21+22

F.A.P. RTE.	SECTION	COUNTY	TOTAL SHEETS	SHEET NO.
574	(12)CR	*	114	39
CONTRACT NO. 68C64				
ILLINOIS FED. AID PROJECT * FULTON / McDONOUGH				

PROPOSED R.O.W. VARIES

EXISTING R.O.W. 30'

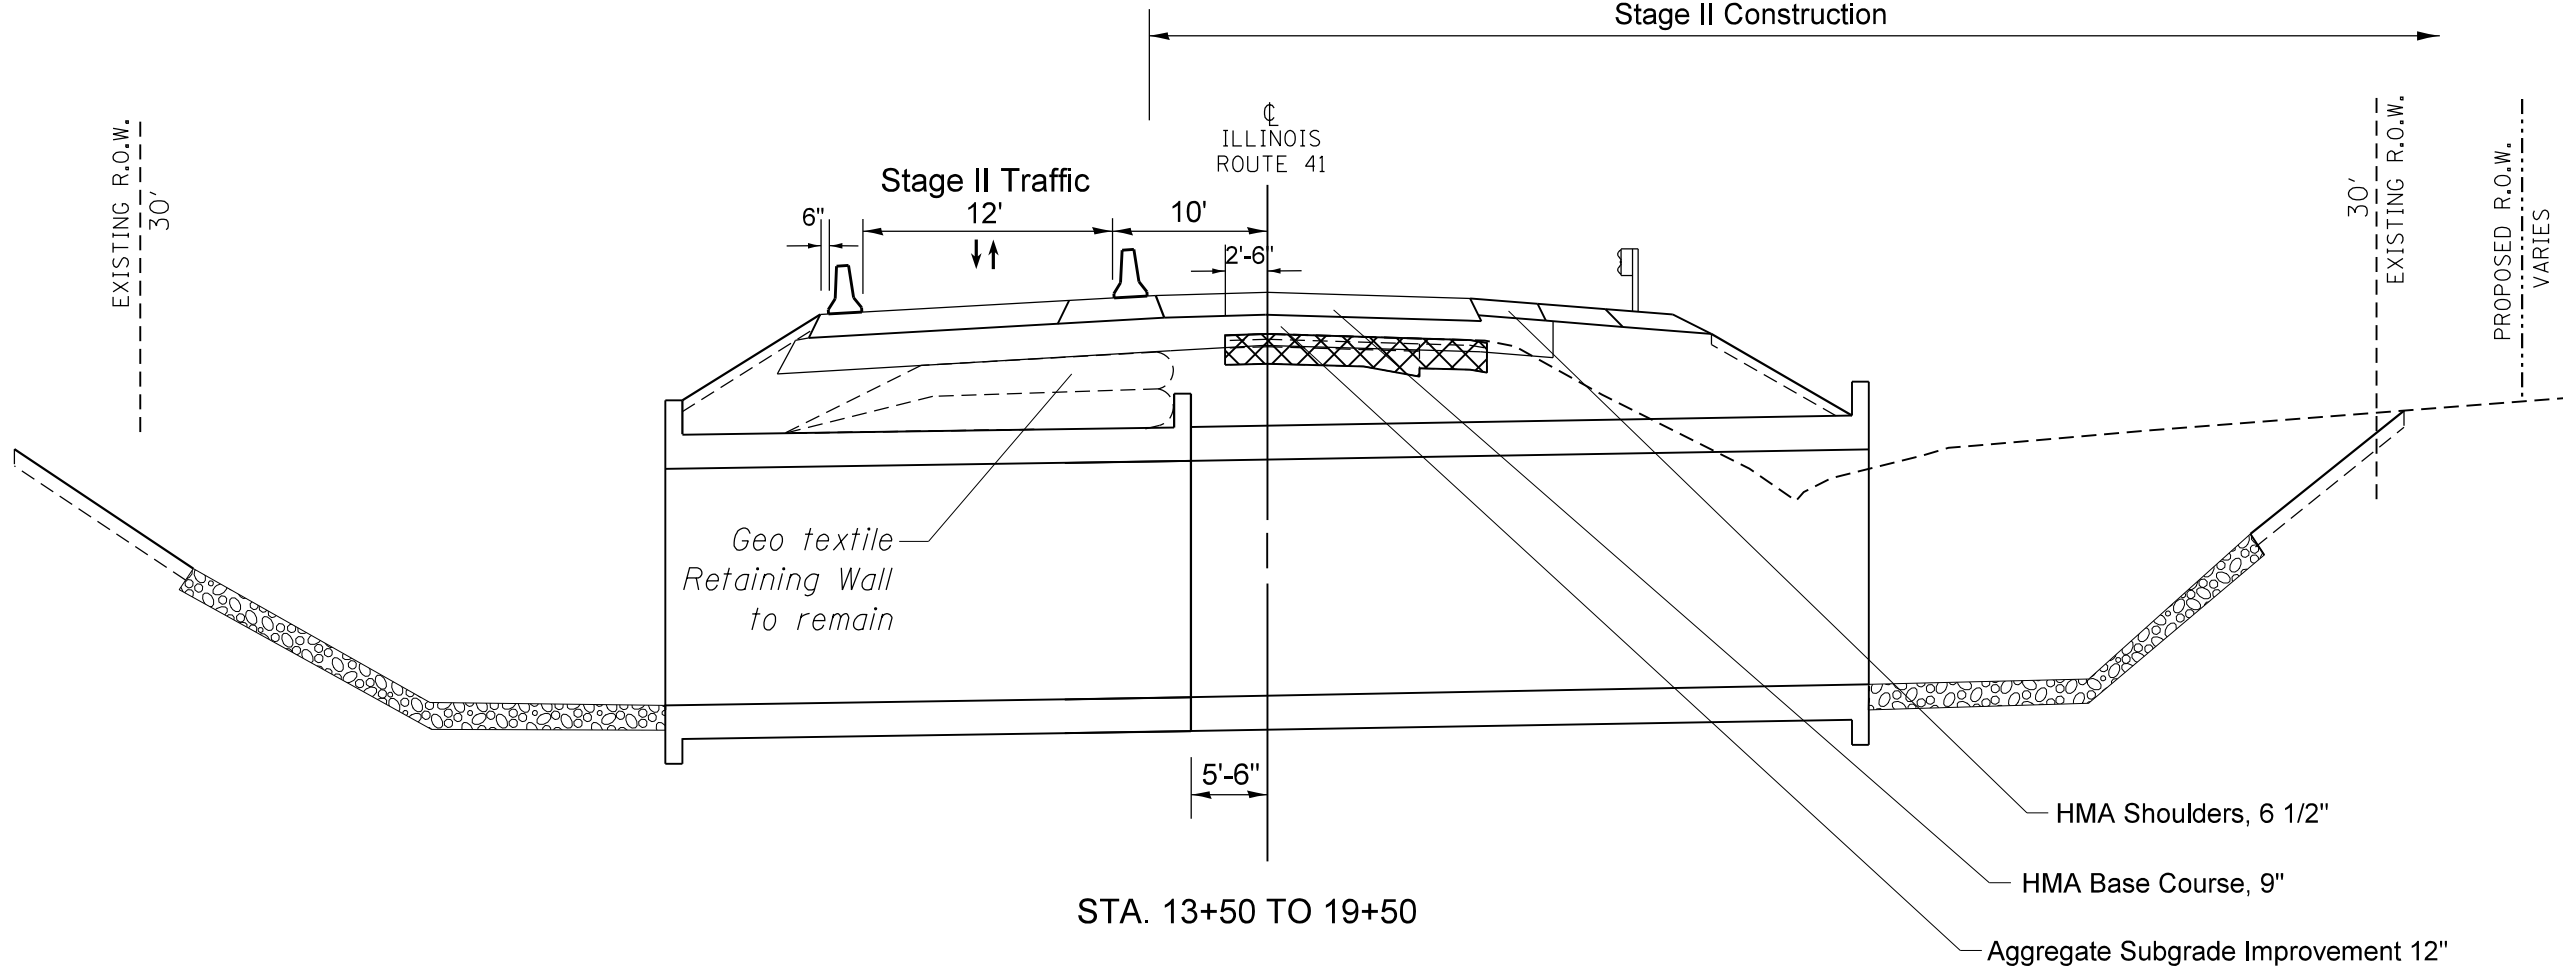


STA. 13+50 TO 19+50

Stage II Construction

ILLINOIS ROUTE 41

PROPOSED R.O.W. VARIES

EXISTING R.O.W. 30'

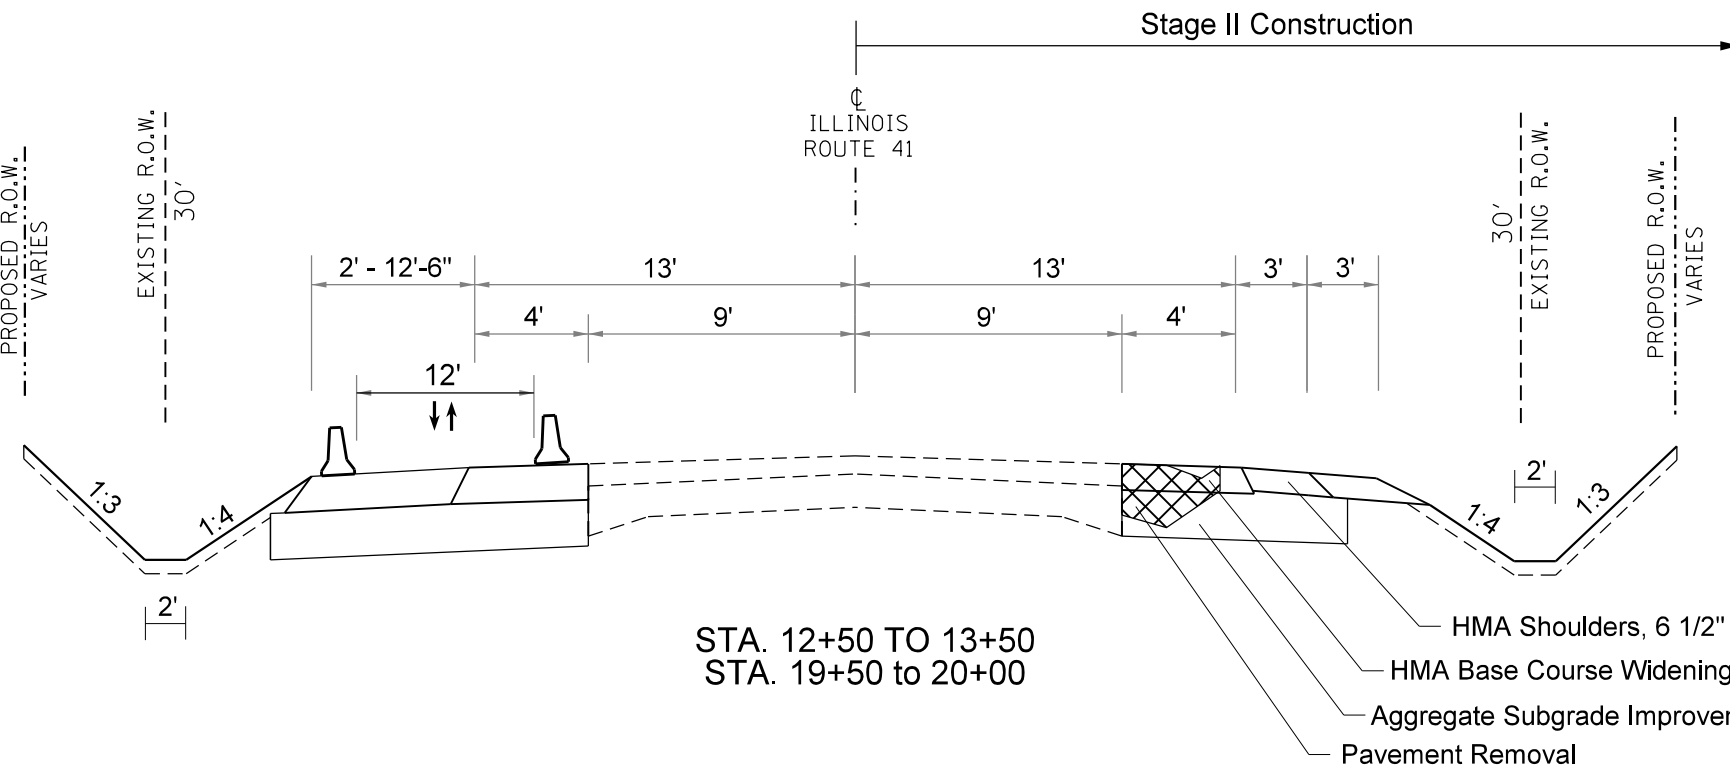

STA. 12+50 TO 13+50
STA. 19+50 TO 20+00

⊠ Removal location

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PROJECT: ILLINOIS DOT
OFFICE: ILLINOIS DOT
DATE: 2/1/2020

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	DRAWN -	REVISED -
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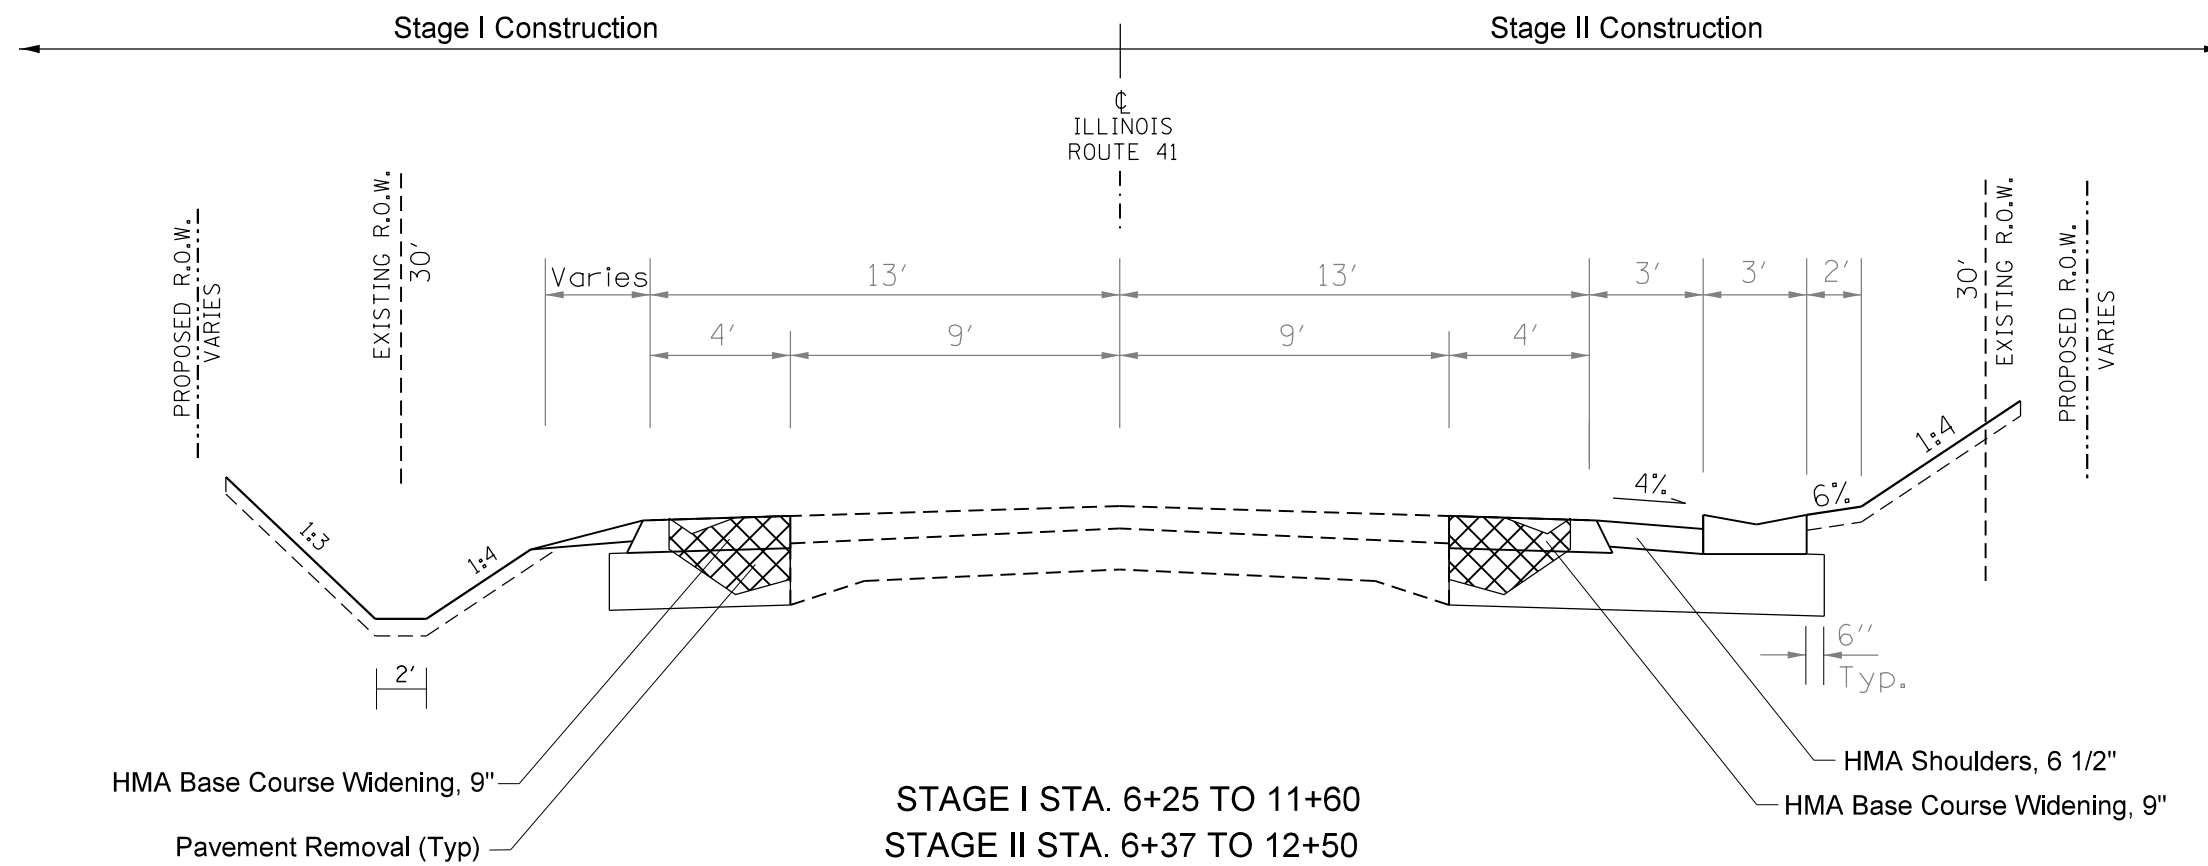
STATE OF ILLINOIS
DEPARTMENT OF TRANSPORTATION

SCALE:		SHEET	OF	SHEETS	STA. 13+50	TO STA. 20+00
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Typical Section
Stage II

F.A.P. RTE. 574	SECTION (12)CR	COUNTY *	TOTAL SHEETS 114	SHEET NO. 40
CONTRACT NO. 68C64				

ILLINOIS FED. AID PROJECT
* FULTON / McDONOUGH



 Removal location

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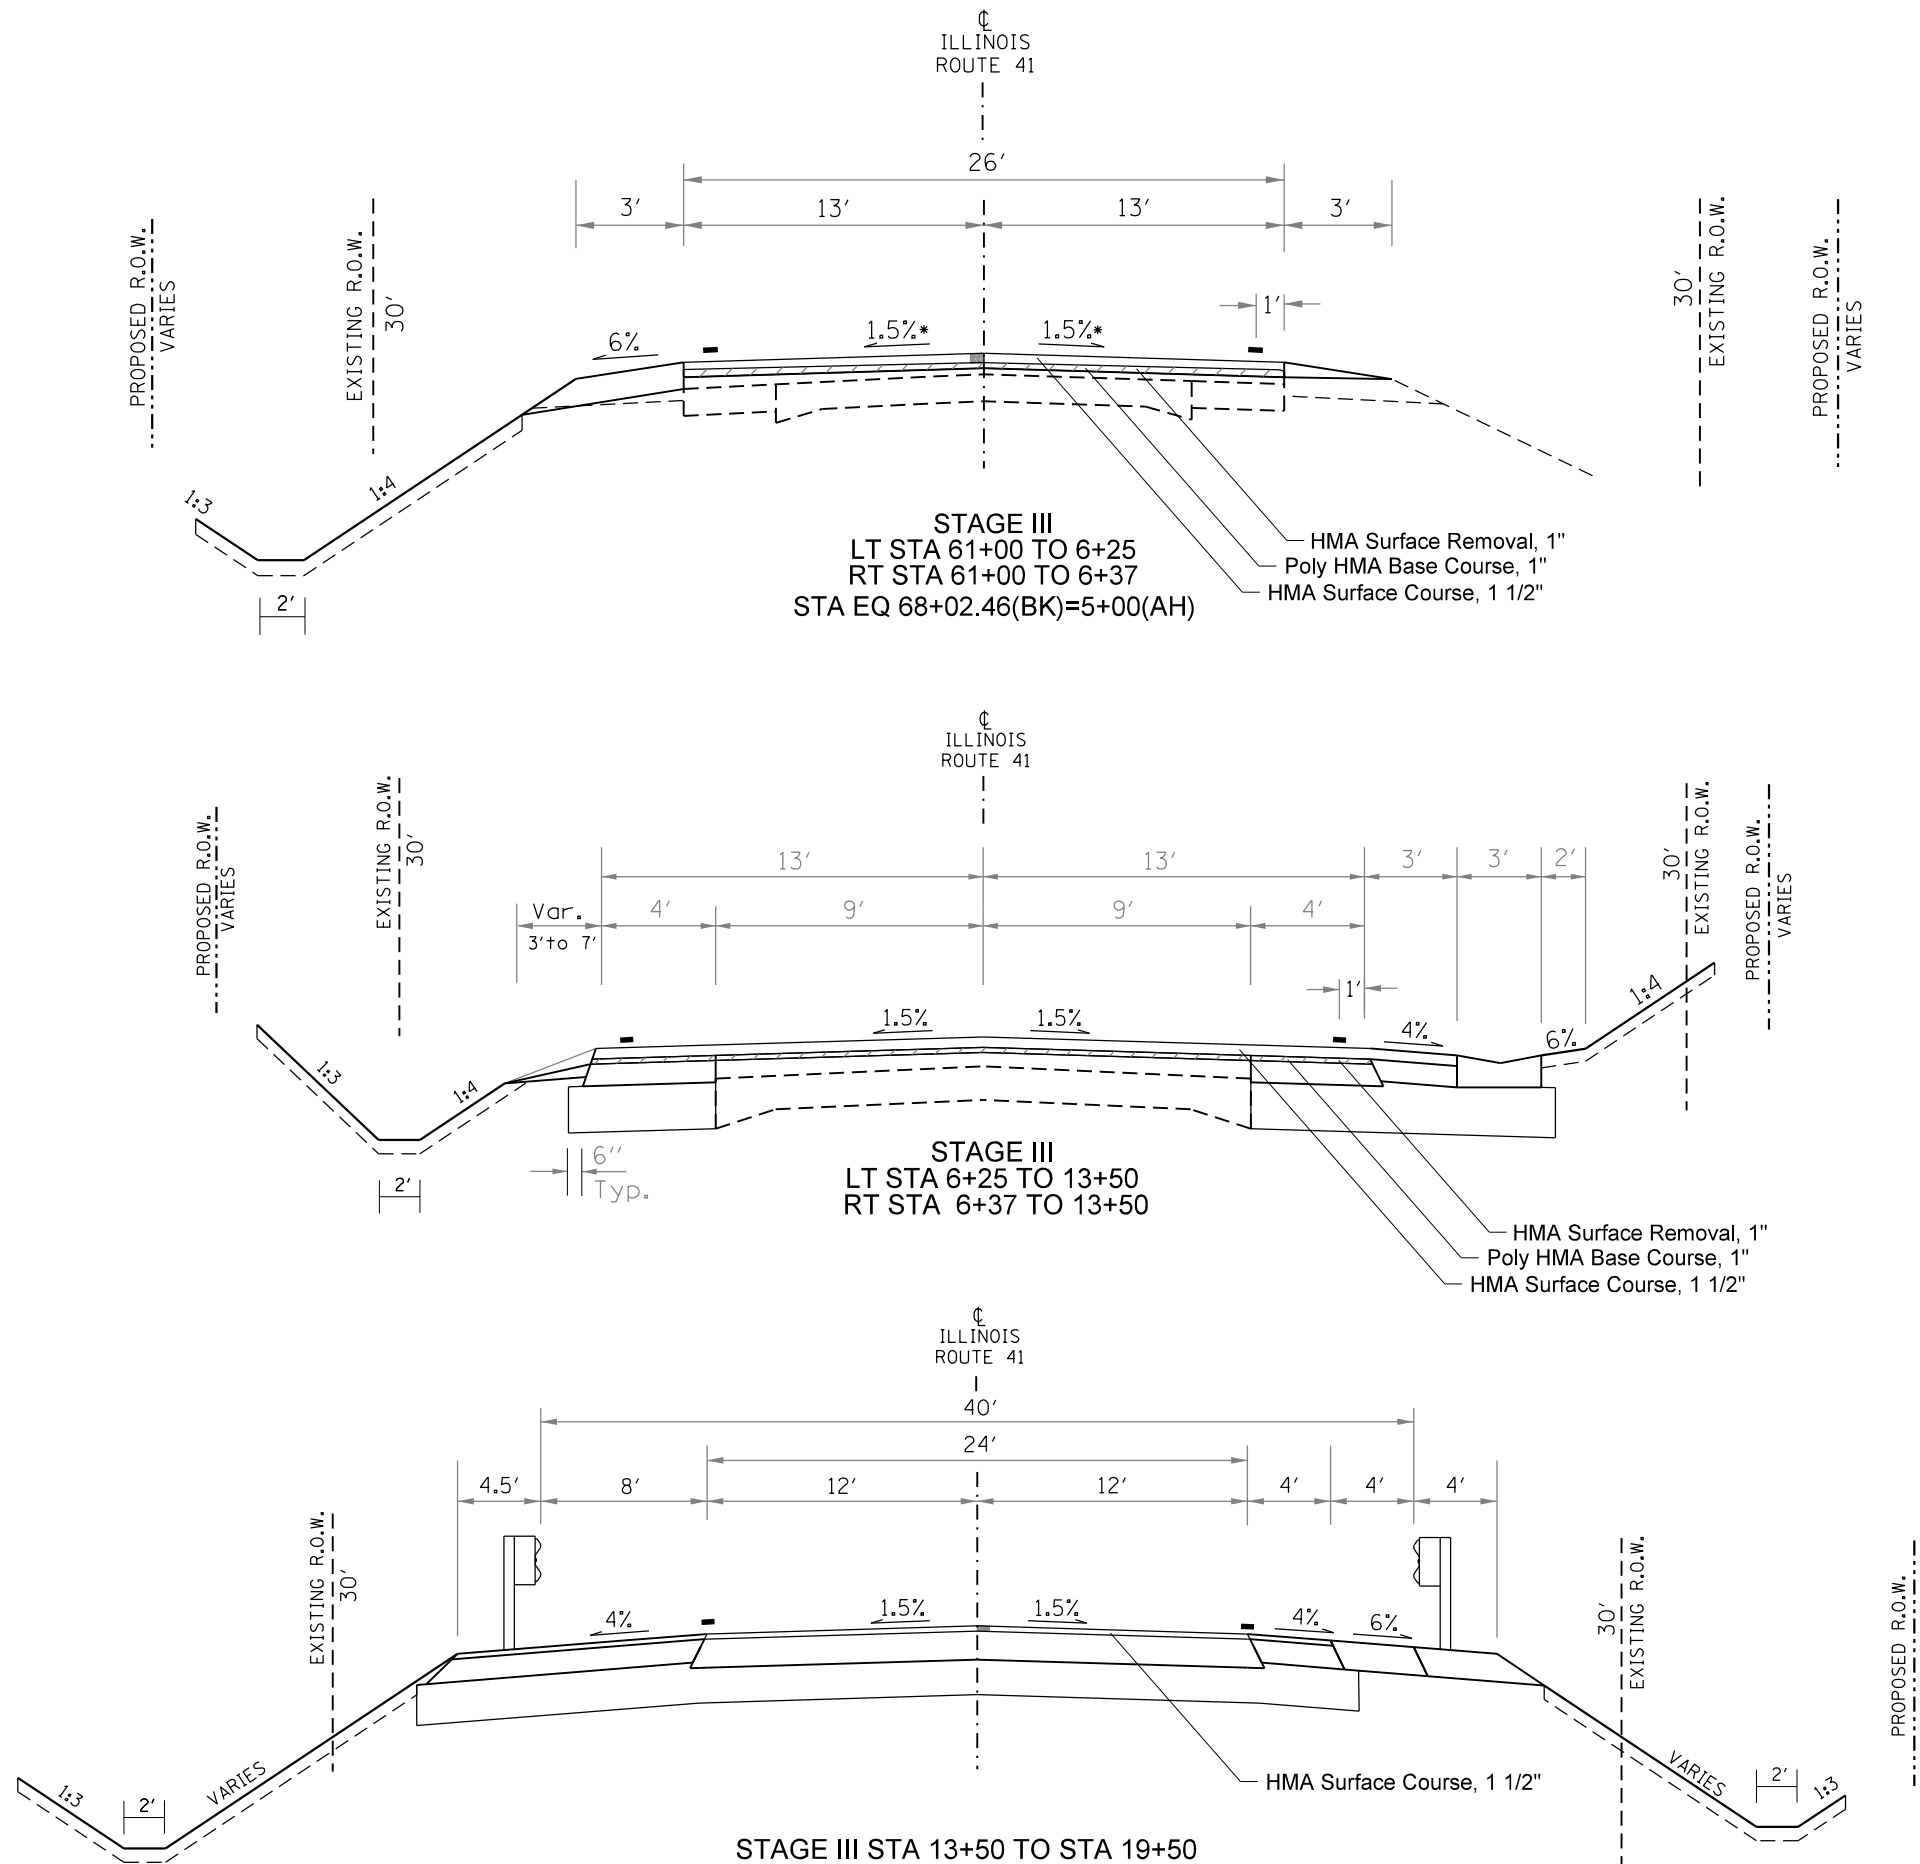
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PLOT DATE = 2/1/2020	DATE -	REVISED -

**STATE OF ILLINOIS
DEPARTMENT OF TRANSPORTATION**

**Typical Section
Stage I & II**

SCALE: SHEET OF SHEETS STA. 6+25 TO STA. 12+50

F.A.P. RTE.	SECTION	COUNTY	TOTAL SHEETS	SHEET NO.
574	(12)CR	*	114	41
CONTRACT NO. 68C64				
ILLINOIS FED. AID PROJECT * FULTON / McDONOUGH				



MODEL: Default
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	DRAWN -	REVISED -
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PLOT DATE = 2/1/2020	DATE -	REVISED -









STATE OF ILLINOIS
DEPARTMENT OF TRANSPORTATION

SCALE:		SHEET OF SHEETS		STA. 6+25	TO STA. 19+50
Typical Section		Stage III			

F.A.P. RTE.	SECTION	COUNTY	TOTAL SHEETS	SHEET NO.
574	(12)CR	*	114	42
CONTRACT NO. 68C64				

ILLINOIS FED. AID PROJECT
 FULTON / McDONOUGH

LEGEND:

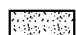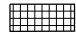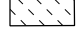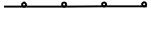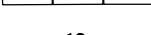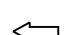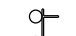-  Aggregate for Temporary Access
-  Pavement Removal
-  Construction this Stage
-  Drum with steady burning light, 50' c.c.
-  Temporary Concrete Barrier
-  Traffic Signal (with Retro-reflective backplate)
-  Open Traffic Lane
-  Type III Barricade with flashing lights

① **TEMPORARY CONCRETE BARRIER**
Barrier wall markers
at 25' cts. See Standards
704001 & 782006.

② **IMPACT ATTENUATORS, TEMPORARY**
(NON-REDIRECTIVE), TEST LEVEL 3

GENERAL NOTES:


Advisory speed limit shall be 40 mph.

Existing or temporary pavement markings shall be on both sides of open lane.

Traffic Control Shall conform to Standard 701321 and as shown
on the Traffic Control plans. Temporary Rumble Strips shall be placed in
accordance with Standard 701326.

All traffic signal operations shall conform to the MUTCD. There shall be a minimum
of 2 signal heads per approach. Retro-reflective backplates shall be installed on
each signal head. All signal heads shall be furnished with 12" LEDs.

All approaches shall be equipped with vehicle detection (microwave radar or temporary loops.)

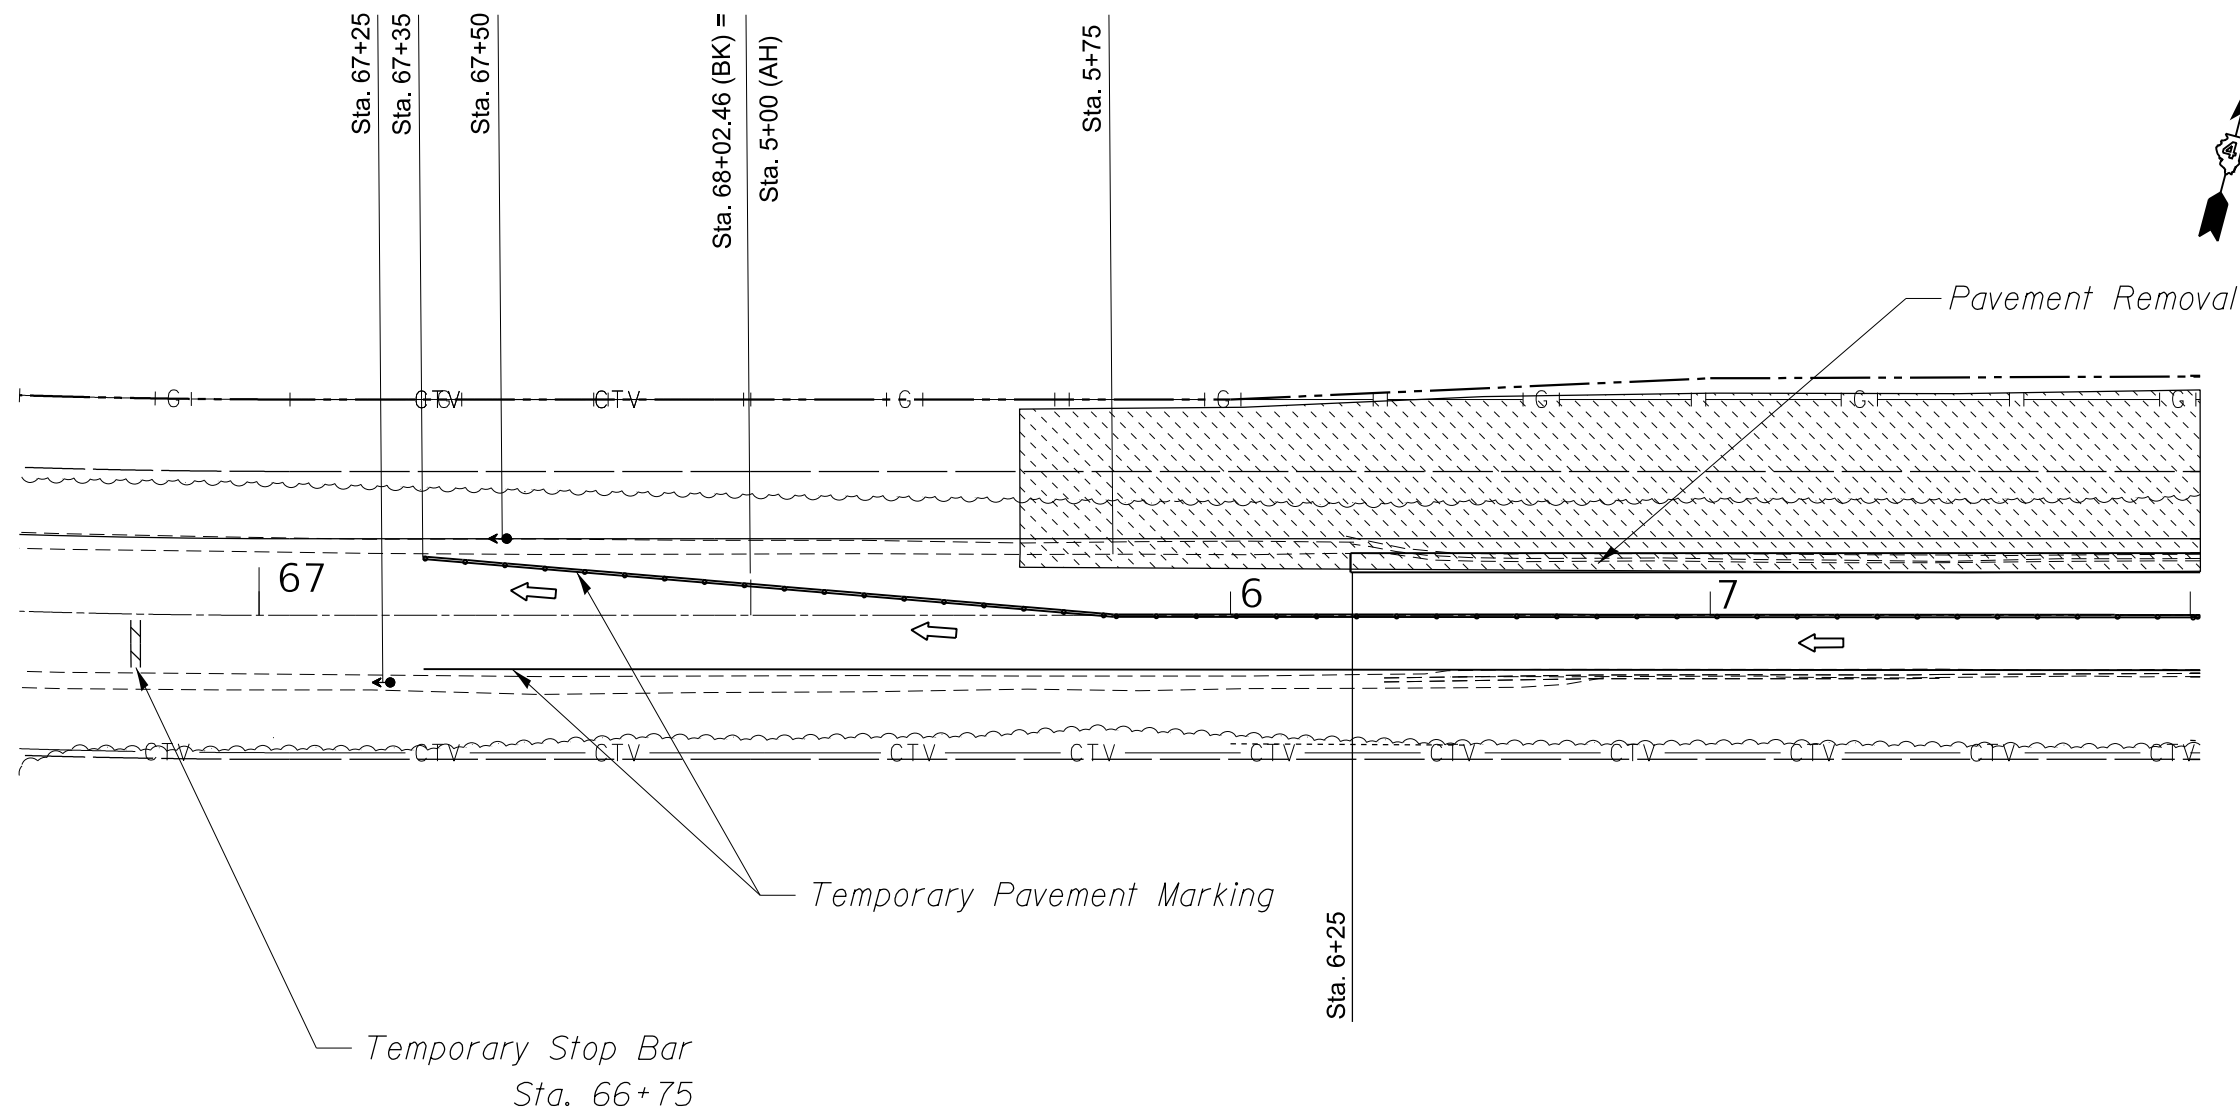

MATCHLINE 14+00

MODEL: Default
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	DRAWN -	REVISED -
PLOT SCALE = 100,0000 ' / in.	CHECKED -	REVISED -
PLOT DATE = 2/1/2020	DATE -	REVISED -

**STATE OF ILLINOIS
DEPARTMENT OF TRANSPORTATION**









Stage 1 Construction

SCALE: SHEET OF SHEETS STA. 66+00 TO STA. 8+00

F.A.P. RTE.	SECTION	COUNTY	TOTAL SHEETS	SHEET NO.
574	(12)CR	*	114	42A
CONTRACT NO. 68C64				

ILLINOIS FED. AID PROJECT
* FULTON / McDONOUGH

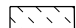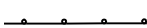LEGEND:

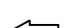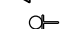-  Aggregate for Temporary Access
-  Pavement Removal
-  Construction this Stage
-  Drum with steady burning light, 50' c.c.
-  Temporary Concrete Barrier
-  Traffic Signal (with Retro-reflective backplate)
-  Open Traffic Lane
-  Type III Barricade with flashing lights

- ① TEMPORARY CONCRETE BARRIER
Barrier wall markers
at 25' cts. See Standards
704001 & 782006.
- ② IMPACT ATTENUATORS, TEMPORARY
(NON-REDIRECTIVE), TEST LEVEL 3



GENERAL NOTES:

Advisory speed limit shall be 40 mph.

Existing or temporary pavement markings shall be on both sides of open lane.

Traffic Control Shall conform to Standard 701321 and as shown on the Traffic Control plans. Temporary Rumble Strips shall be placed in accordance with Standard 701326.

All traffic signal operations shall conform to the MUTCD. There shall be a minimum of 2 signal heads per approach. Retro-reflective backplates shall be installed on each signal head. All signal heads shall be furnished with 12" LEDs. All approaches shall be equipped with vehicle detection (microwave radar or temporary loops.)

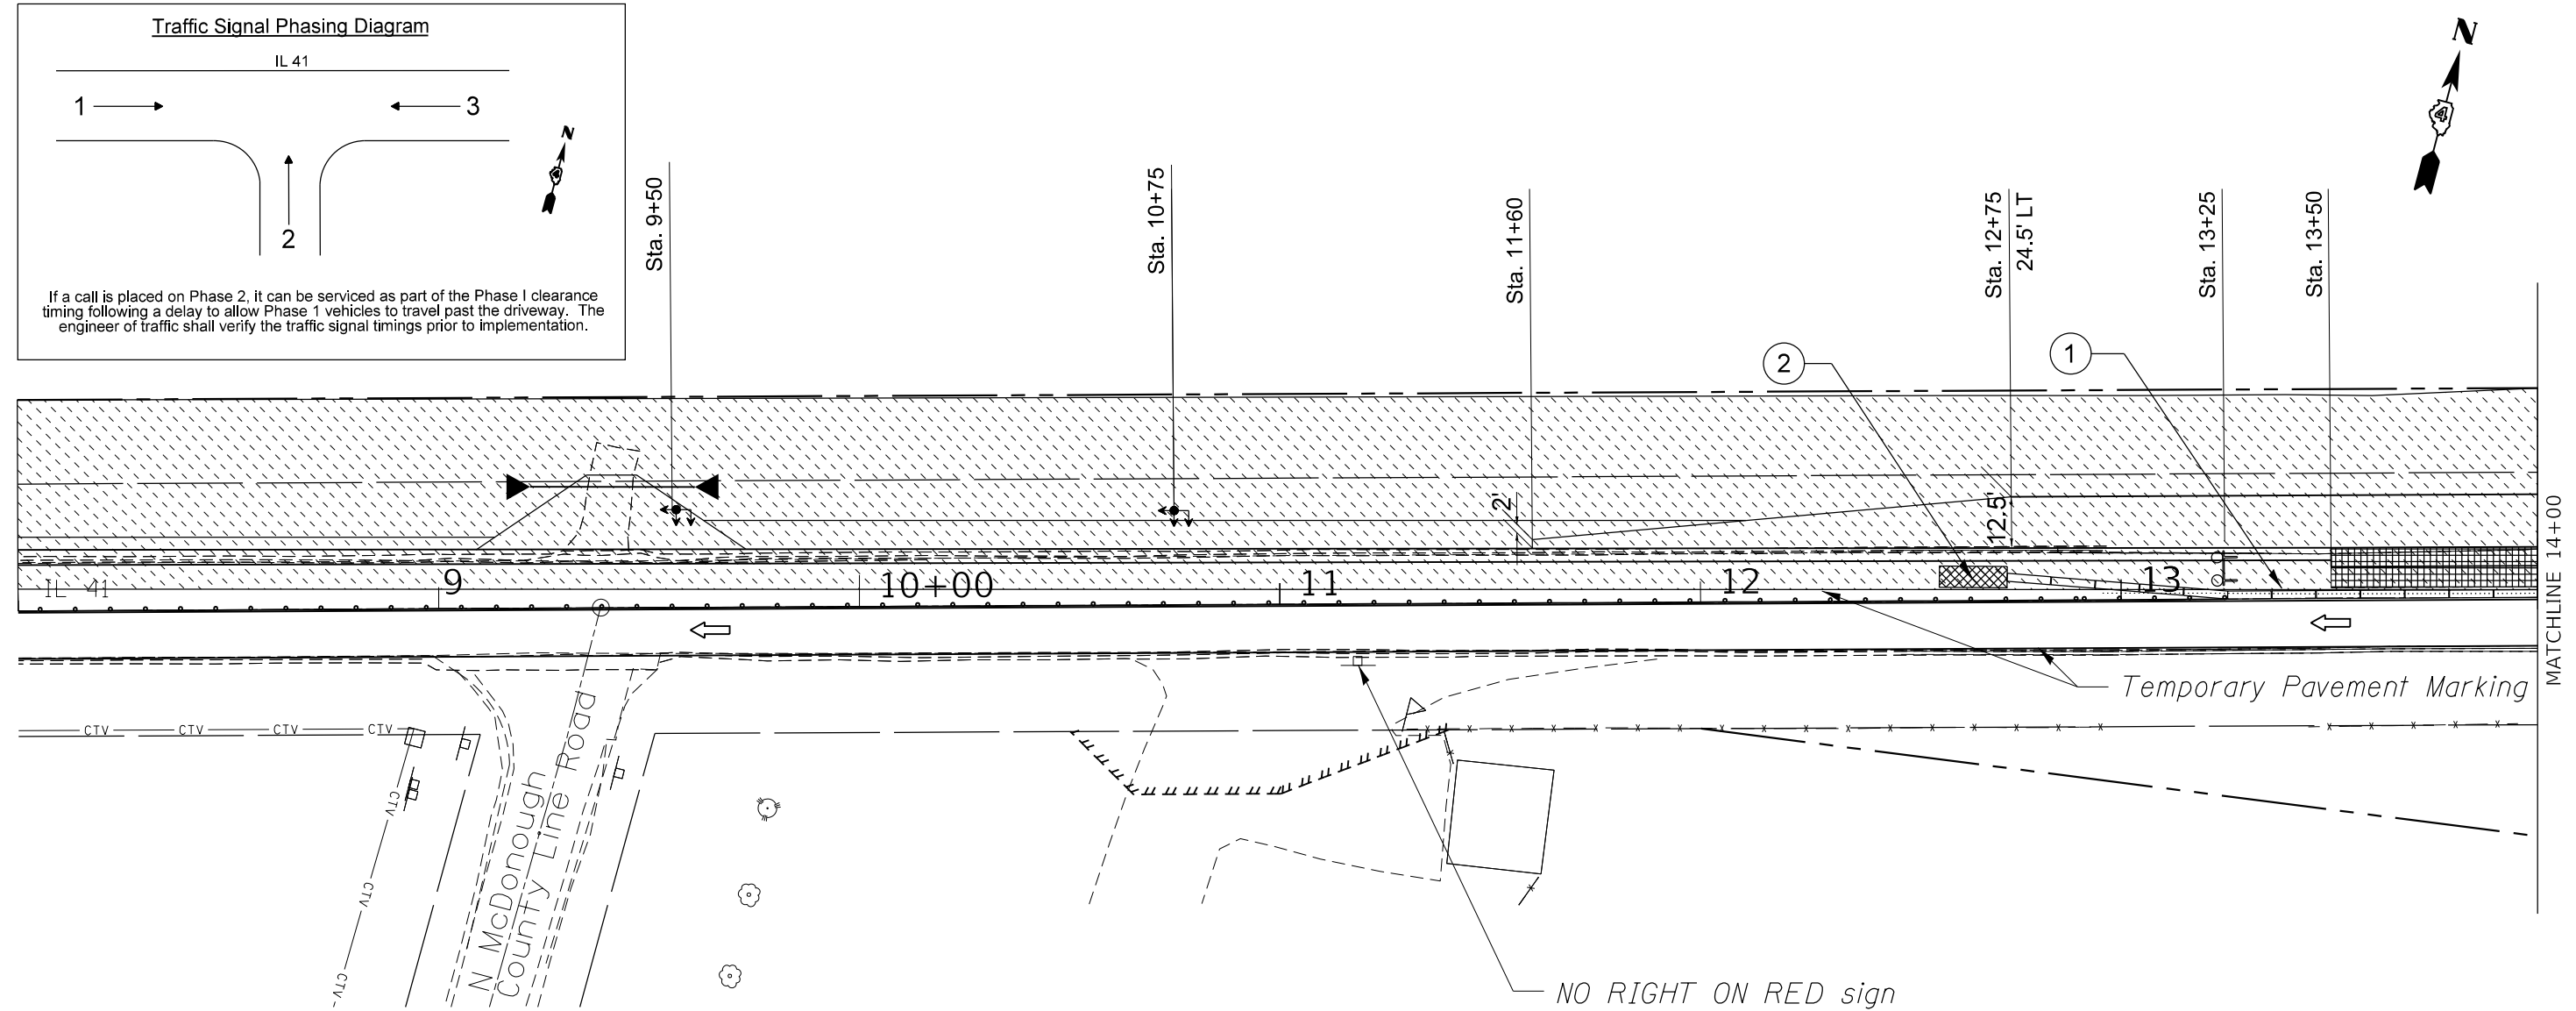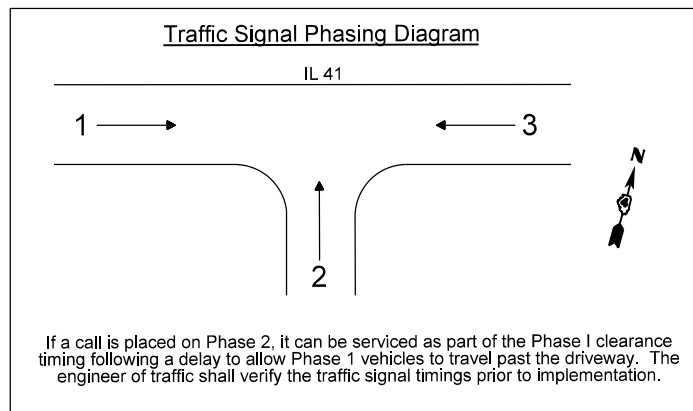

MODEL: Default
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PLOT SCALE = 100,0000' / in.	DRAWN -	REVISED -
PLOT DATE = 2/1/2020	CHECKED -	REVISED -
	DATE -	REVISED -

**STATE OF ILLINOIS
DEPARTMENT OF TRANSPORTATION**







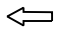

Stage I Construction

SCALE: SHEET OF SHEETS STA. 8+00 TO STA. 14+00

F.A.P. RTE.	SECTION	COUNTY	TOTAL SHEETS	SHEET NO.
574	(12)CR	*	114	43
CONTRACT NO. 68C64				

ILLINOIS FED. AID PROJECT
* FULTON / McDONOUGH

LEGEND:

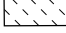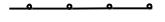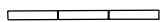-  Aggregate for Temporary Access
-  Pavement Removal
-  Construction this Stage
-  Drum with steady burning light, 50' c.c.
-  Temporary Concrete Barrier
-  Traffic Signal (with Retro-reflective backplate)
-  Open Traffic Lane
-  Type III Barricade with flashing lights

- ① TEMPORARY CONCRETE BARRIER
Barrier wall markers
at 25' cts. See Standards
704001 & 782006.
- ② IMPACT ATTENUATORS, TEMPORARY
(NON-REDIRECTIVE), TEST LEVEL 3


GENERAL NOTES:

Advisory speed limit shall be 40 mph.

Existing or temporary pavement markings shall be on both sides of open lane.

Traffic Control Shall conform to Standard 701321 and as shown on the Traffic Control plans. Temporary Rumble Strips shall be placed in accordance with Standard 701326.

All traffic signal operations shall conform to the MUTCD. There shall be a minimum of 2 signal heads per approach. Retro-reflective backplates shall be installed on each signal head. All signal heads shall be furnished with 12" LEDs.
All approaches shall be equipped with vehicle detection (microwave radar or temporary loops.)

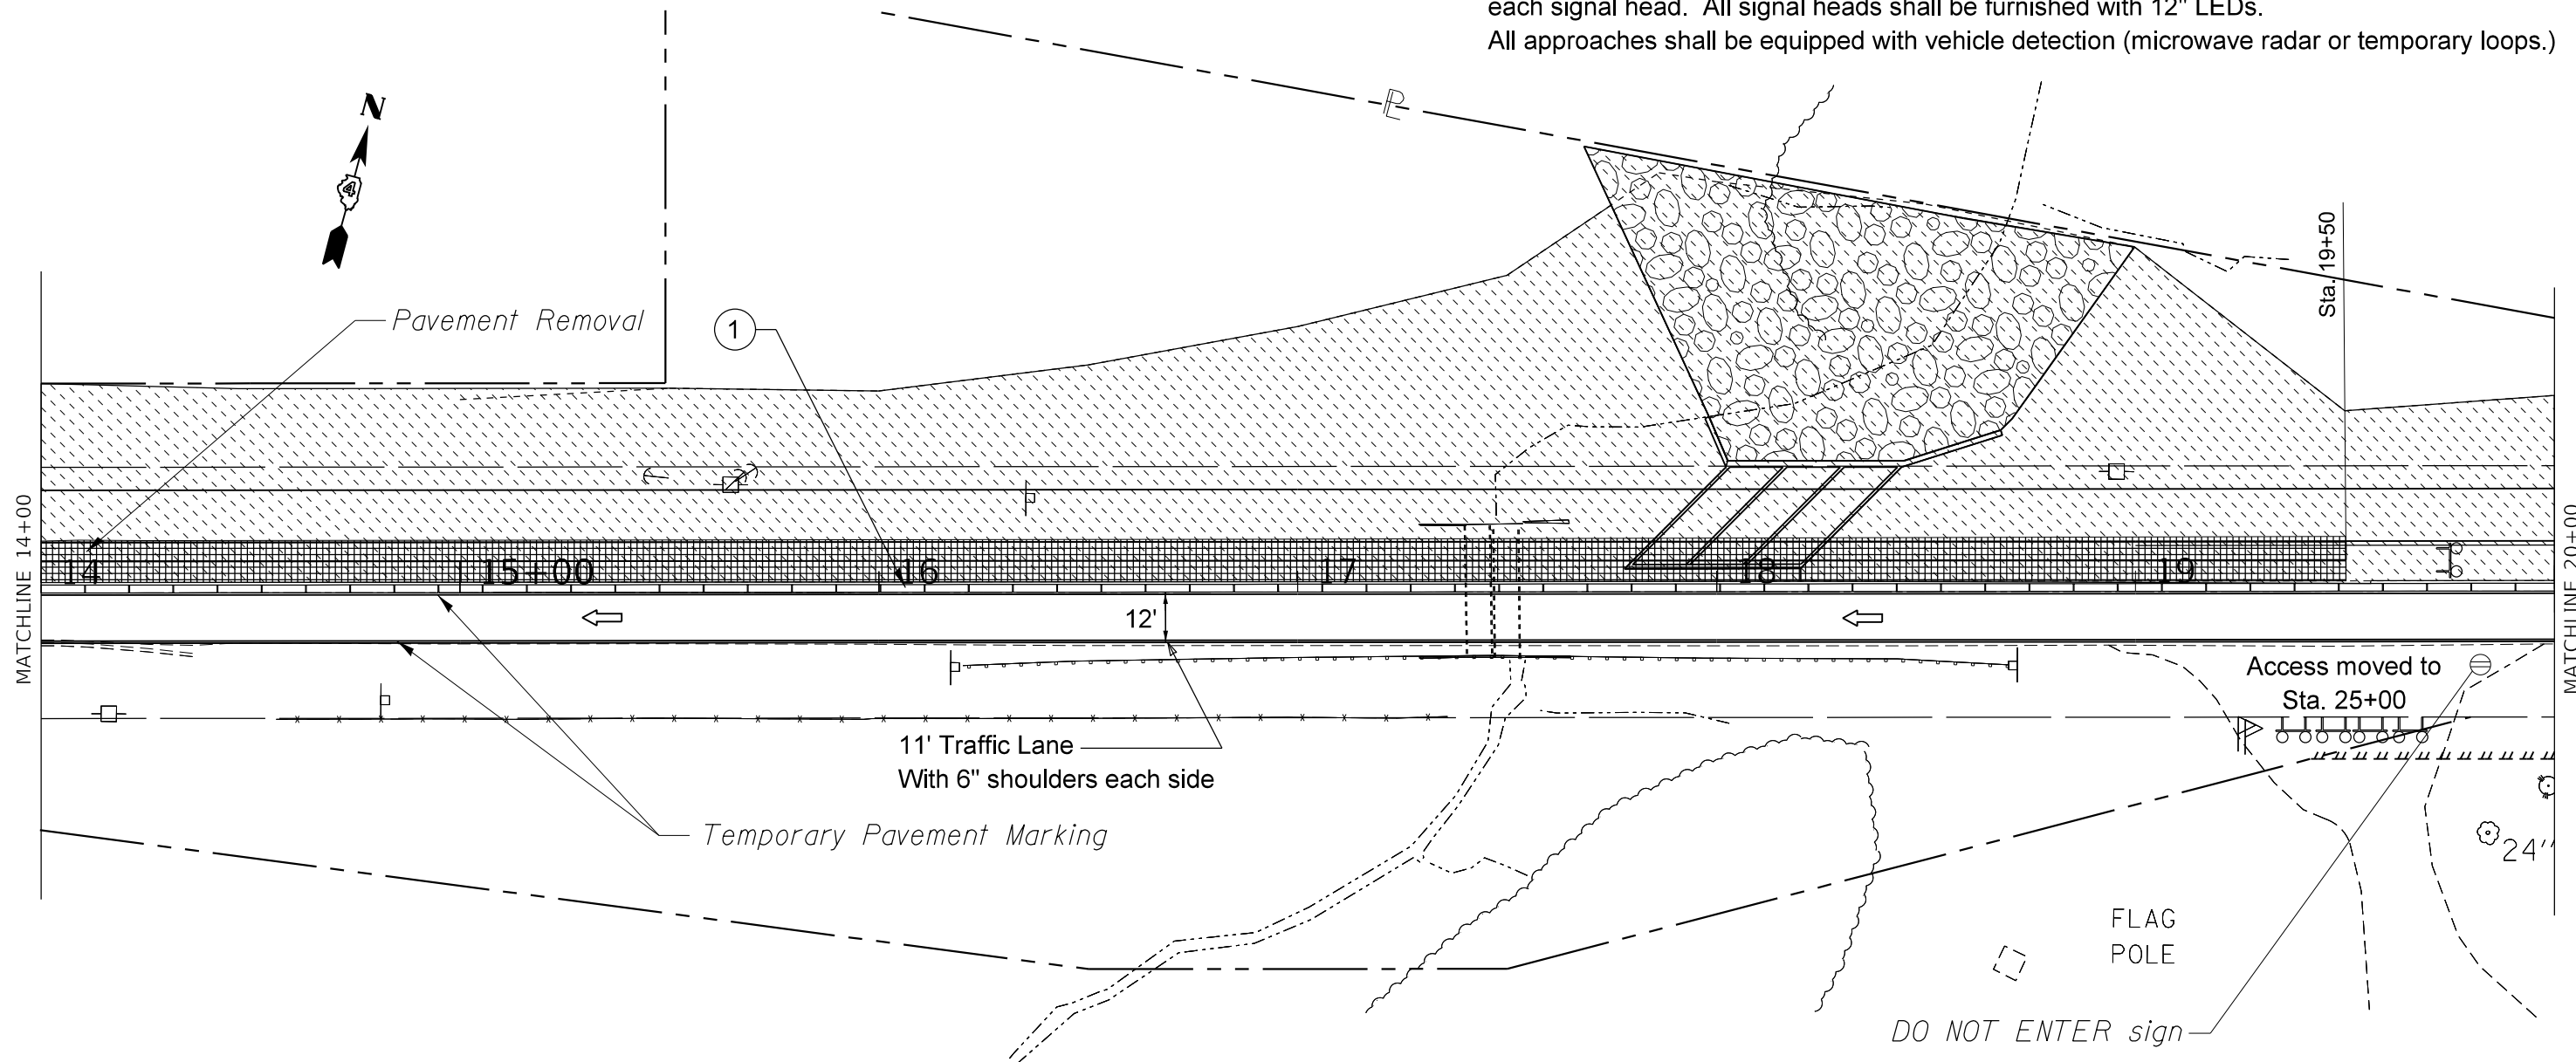

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
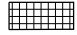

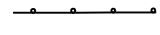




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	DRAWN -	REVISED -
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PLOT DATE = 2/1/2020	DATE -	REVISED -

**STATE OF ILLINOIS
DEPARTMENT OF TRANSPORTATION**

Stage I Construction			
SCALE:	SHEET	OF SHEETS	STA. 14+00 TO STA. 20+00

F.A.P. RTE.	SECTION	COUNTY	TOTAL SHEETS	SHEET NO.
574	(12)CR	-	114	44
CONTRACT NO. 68C64				
ILLINOIS FED. AID PROJECT * FULTON / McDONOUGH				

LEGEND:

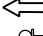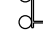-  Aggregate for Temporary Access
-  Pavement Removal
-  Construction this Stage
-  Drum with steady burning light, 50' c.c.
-  Temporary Concrete Barrier
-  Traffic Signal (with Retro-reflective backplate)
-  Open Traffic Lane
-  Type III Barricade with flashing lights

- ① TEMPORARY CONCRETE BARRIER
Barrier wall markers
at 25' cts. See Standards
704001 & 782006.
- ② IMPACT ATTENUATORS, TEMPORARY
(NON-REDIRECTIVE), TEST LEVEL 3

GENERAL NOTES:


Advisory speed limit shall be 40 mph.

Existing or temporary pavement markings shall be on both sides of open lane.

Traffic Control Shall conform to Standard 701321 and as shown on the Traffic Control plans. Temporary Rumble Strips shall be placed in accordance with Standard 701326.

All traffic signal operations shall conform to the MUTCD. There shall be a minimum of 2 signal heads per approach. Retro-reflective backplates shall be installed on each signal head. All signal heads shall be furnished with 12" LEDs.

All approaches shall be equipped with vehicle detection (microwave radar or temporary loops.)

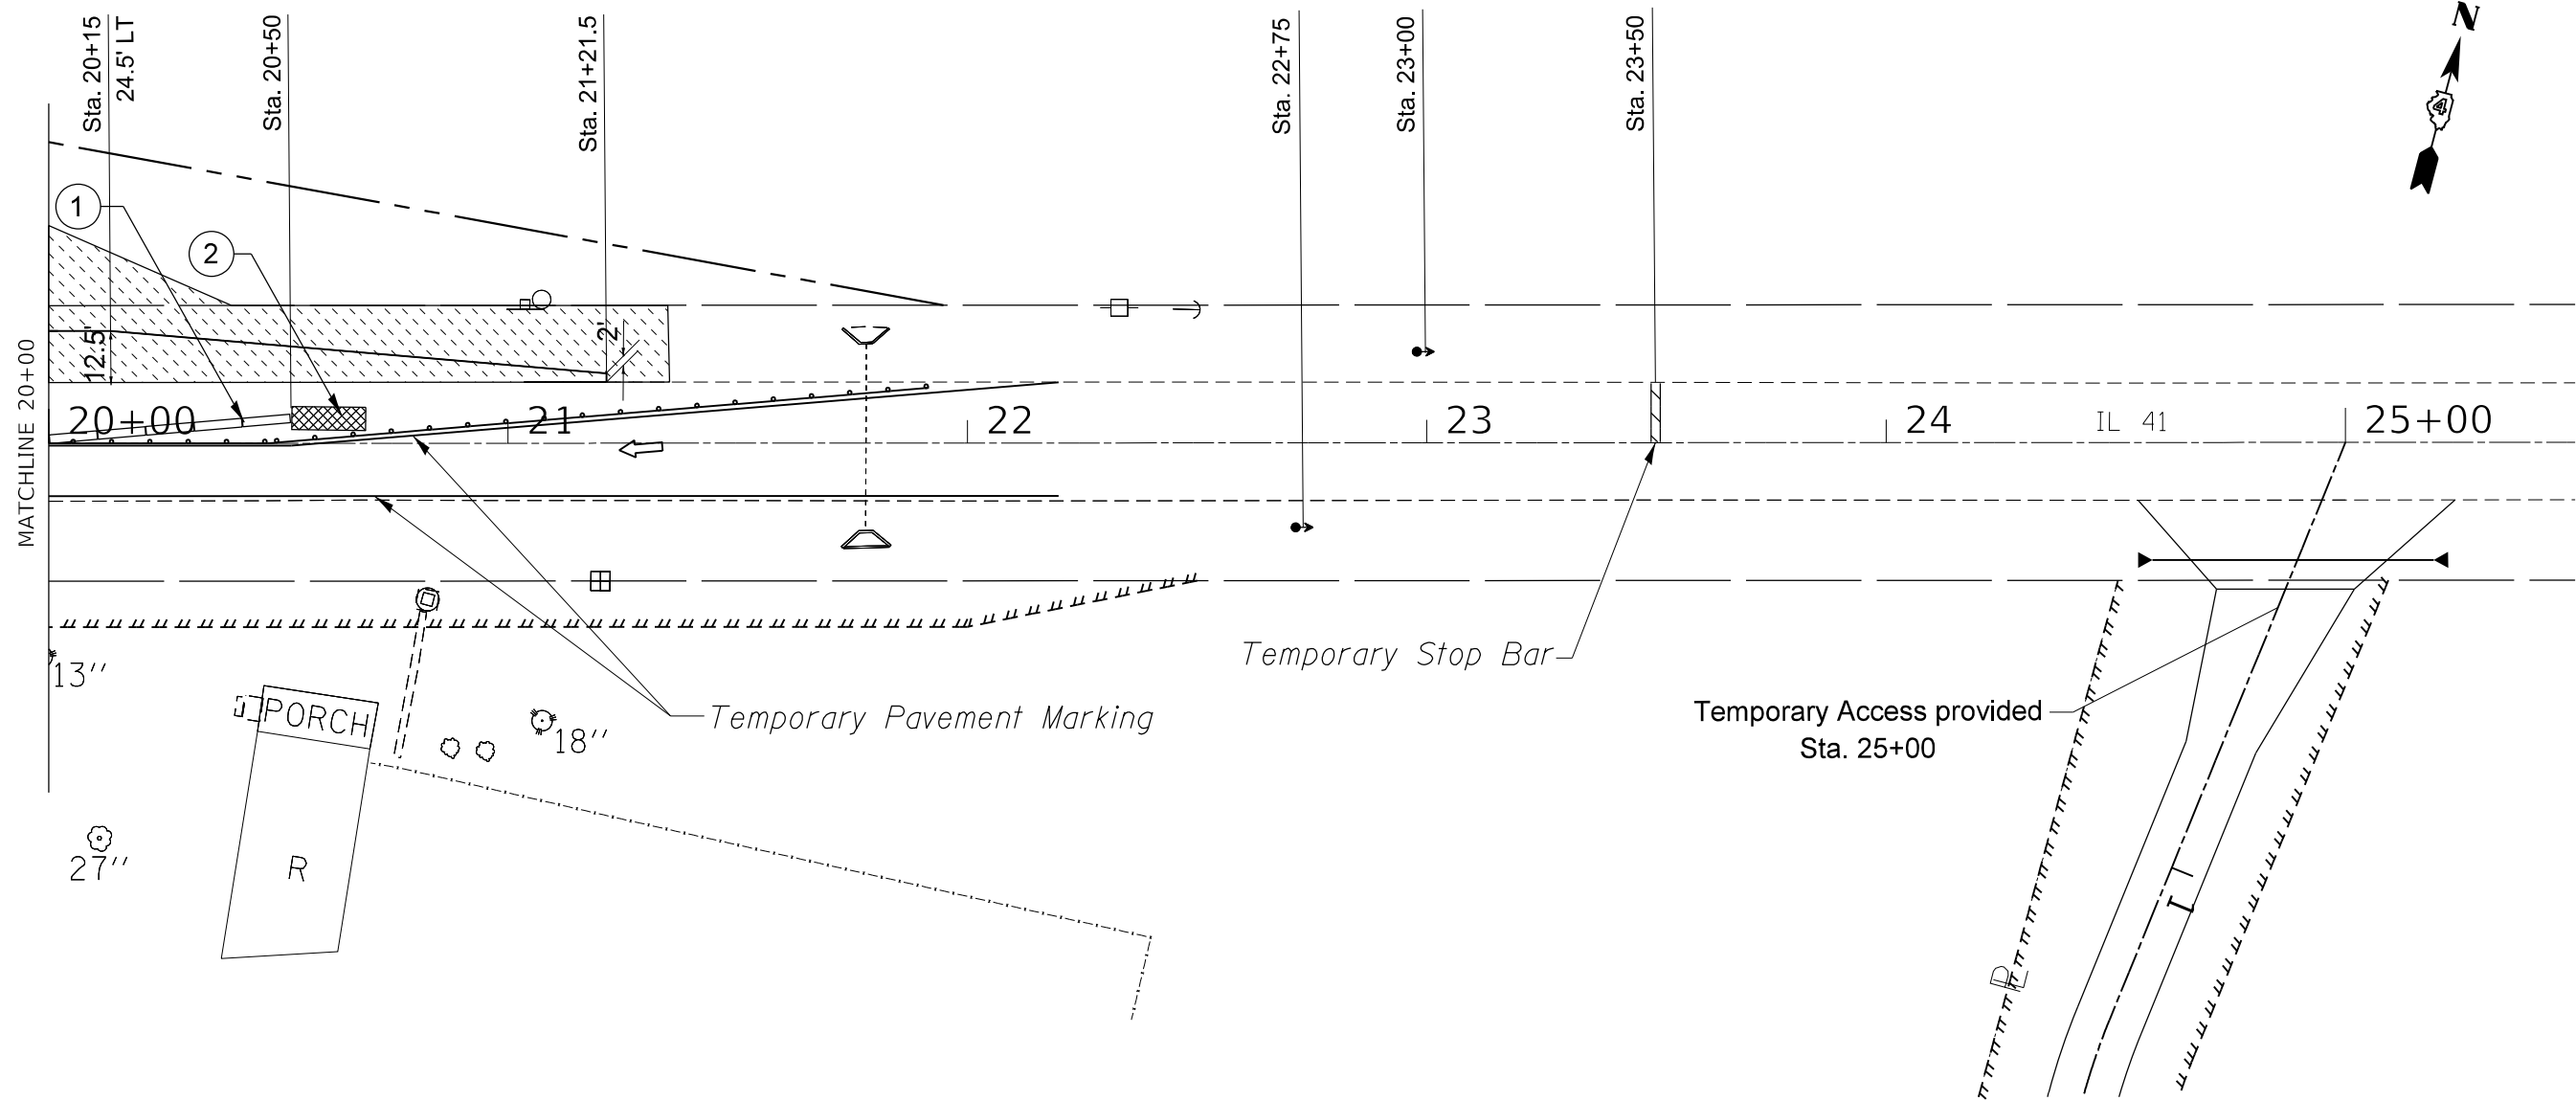

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 DATE: 2/1/2020

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PLOT SCALE = 100,0000' / in.	DRAWN -	REVISED -
PLOT DATE = 2/1/2020	CHECKED -	REVISED -
	DATE -	REVISED -

**STATE OF ILLINOIS
DEPARTMENT OF TRANSPORTATION**







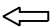

Stage I Construction

SCALE: SHEET OF SHEETS STA. 20+00 TO STA. 26+00

F.A.P. RTE.	SECTION	COUNTY	TOTAL SHEETS	SHEET NO.
574	(12)CR	*	114	45
CONTRACT NO. 68C64				

ILLINOIS FED. AID PROJECT
* FULTON / McDONOUGH

LEGEND:

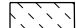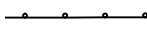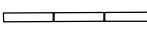-  Aggregate for Temporary Access
-  Pavement Removal
-  Construction this Stage
-  Drum with steady burning light, 50' c.c.
-  Temporary Concrete Barrier
-  Traffic Signal (with Retro-reflective backplate)
-  Open Traffic Lane
-  Type III Barricade with flashing lights

① **TEMPORARY CONCRETE BARRIER**
Barrier wall markers
at 25' cts. See Standards
704001 & 782006.

② **IMPACT ATTENUATORS, TEMPORARY**
(NON-REDIRECTIVE), TEST LEVEL 3

GENERAL NOTES:


Advisory speed limit shall be 40 mph.

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each signal head. All signal heads shall be furnished with 12" LEDs.

All approaches shall be equipped with vehicle detection (microwave radar or temporary loops.)



MATCHLINE 14+00

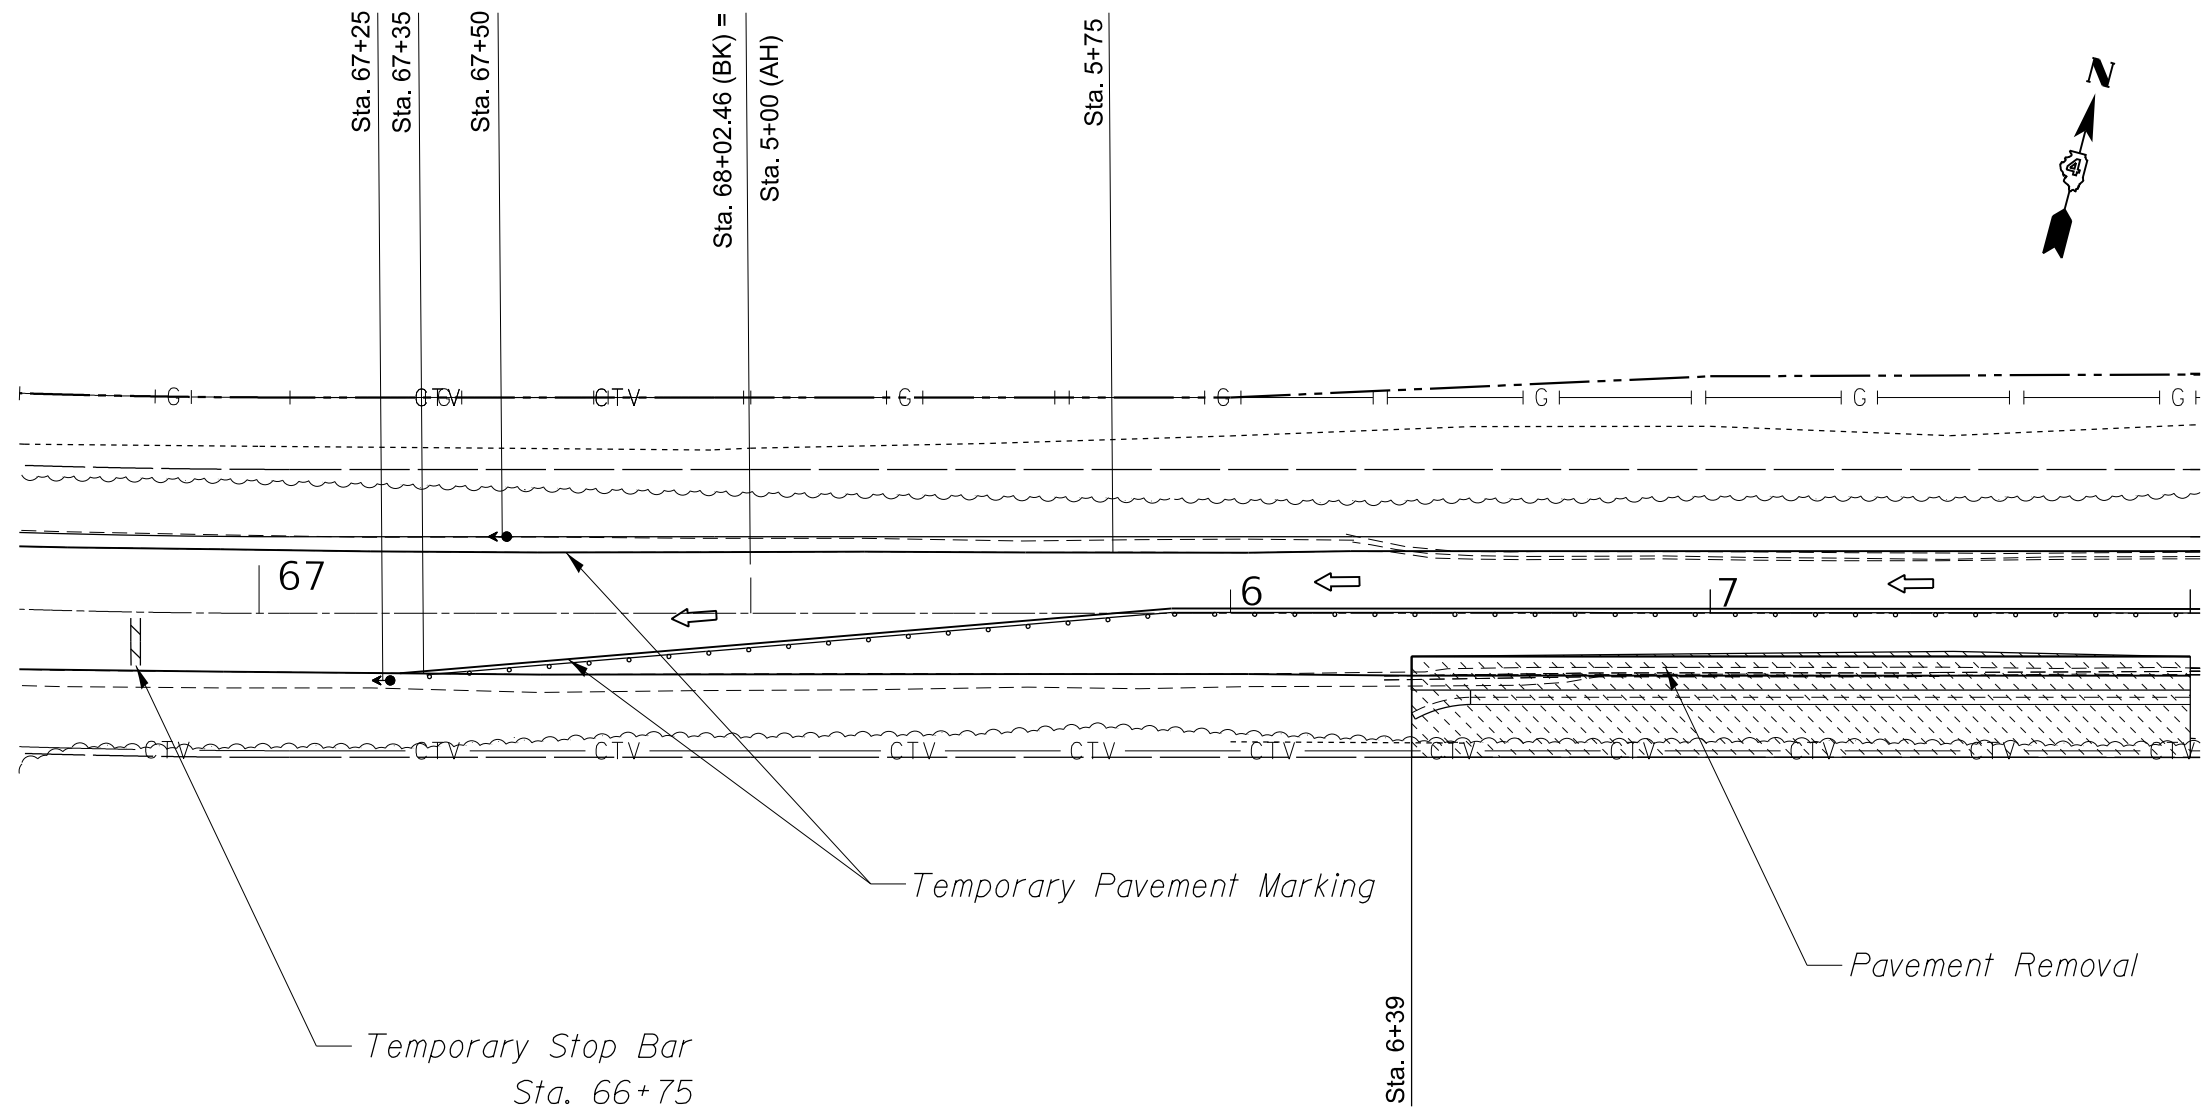MODEL: Default
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	DRAWN -	REVISED -
PLOT SCALE = 100,0000' / in.	CHECKED -	REVISED -
PLOT DATE = 2/1/2020	DATE -	REVISED -

**STATE OF ILLINOIS
DEPARTMENT OF TRANSPORTATION**









Stage II Construction

SCALE: SHEET OF SHEETS STA. 66+00 TO STA. 8+00

F.A.P. RTE.	SECTION	COUNTY	TOTAL SHEETS	SHEET NO.
574	(12)CR	*	114	45A
CONTRACT NO. 68C64				

ILLINOIS FED. AID PROJECT
* FULTON / McDONOUGH

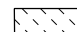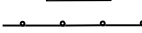LEGEND:

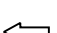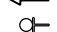-  Aggregate for Temporary Access
-  Pavement Removal
-  Construction this Stage
-  Drum with steady burning light, 50' c.c.
-  Temporary Concrete Barrier
-  Traffic Signal (with Retro-reflective backplate)
-  Open Traffic Lane
-  Type III Barricade with flashing lights

① TEMPORARY CONCRETE BARRIER
Barrier wall markers
at 25' cts. See Standards
704001 & 782006.

② IMPACT ATTENUATORS, TEMPORARY
(NON-REDIRECTIVE), TEST LEVEL 3

GENERAL NOTES:


Advisory speed limit shall be 40 mph.

Existing or temporary pavement markings shall be on both sides of open lane.

Traffic Control Shall conform to Standard 701321 and as shown
on the Traffic Control plans. Temporary Rumble Strips shall be placed in
accordance with Standard 701326.

All traffic signal operations shall conform to the MUTCD. There shall be a minimum
of 2 signal heads per approach. Retro-reflective backplates shall be installed on
each signal head. All signal heads shall be furnished with 12" LEDs.

All approaches shall be equipped with vehicle detection (microwave radar or temporary loops.)

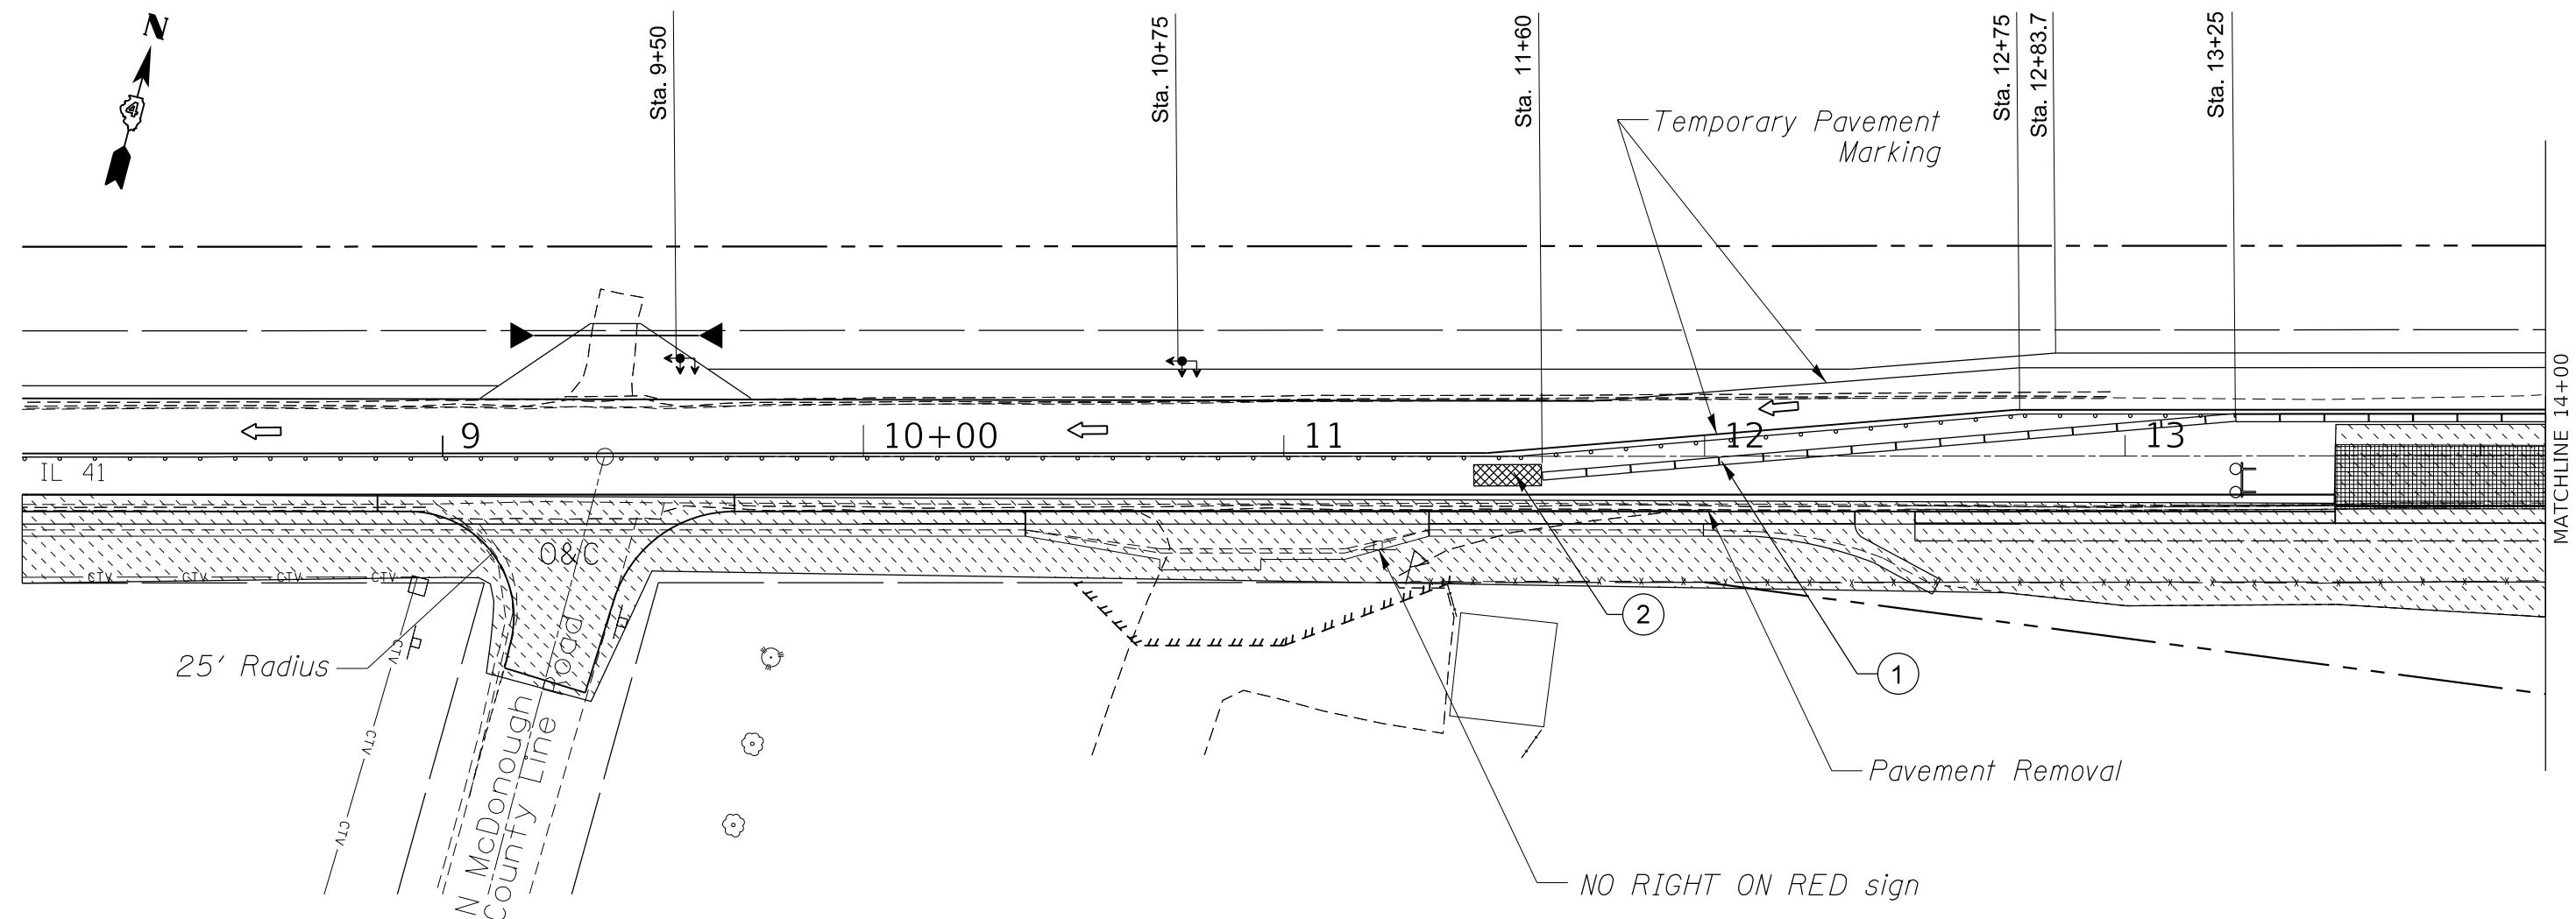

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	DRAWN -	REVISED -
PLOT SCALE = 100,0000' / in.	CHECKED -	REVISED -
PLOT DATE = 2/1/2020	DATE -	REVISED -

**STATE OF ILLINOIS
DEPARTMENT OF TRANSPORTATION**









Stage II Construction

SCALE: SHEET OF SHEETS STA. 8+00 TO STA. 14+00

F.A.P. RTE.	SECTION	COUNTY	TOTAL SHEETS	SHEET NO.
574	(12)CR	+	114	46
CONTRACT NO. 68C64				

ILLINOIS FED. AID PROJECT
* FULTON / McDONOUGH

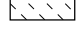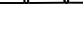LEGEND:

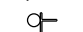-  Aggregate for Temporary Access
-  Pavement Removal
-  Construction this Stage
-  Drum with steady burning light, 50' c.c.
-  Temporary Concrete Barrier
-  Traffic Signal (with Retro-reflective backplate)
-  Open Traffic Lane
-  Type III Barricade with flashing lights

- ① TEMPORARY CONCRETE BARRIER
Barrier wall markers
at 25' cts. See Standards
704001 & 782006.
- ② IMPACT ATTENUATORS, TEMPORARY
(NON-REDIRECTIVE), TEST LEVEL 3
- ③ IMPACT ATTENUATORS, TEMPORARY
(NON-REDIRECTIVE, NARROW), TEST LEVEL 3

GENERAL NOTES:


Advisory speed limit shall be 40 mph.

Existing or temporary pavement markings shall be on both sides of open lane.

Traffic Control Shall conform to Standard 701321 and as shown on the Traffic Control plans. Temporary Rumble Strips shall be placed in accordance with Standard 701326.

All traffic signal operations shall conform to the MUTCD. There shall be a minimum of 2 signal heads per approach. Retro-reflective backplates shall be installed on each signal head. All signal heads shall be furnished with 12" LEDs.

All approaches shall be equipped with vehicle detection (microwave radar or temporary loops.)

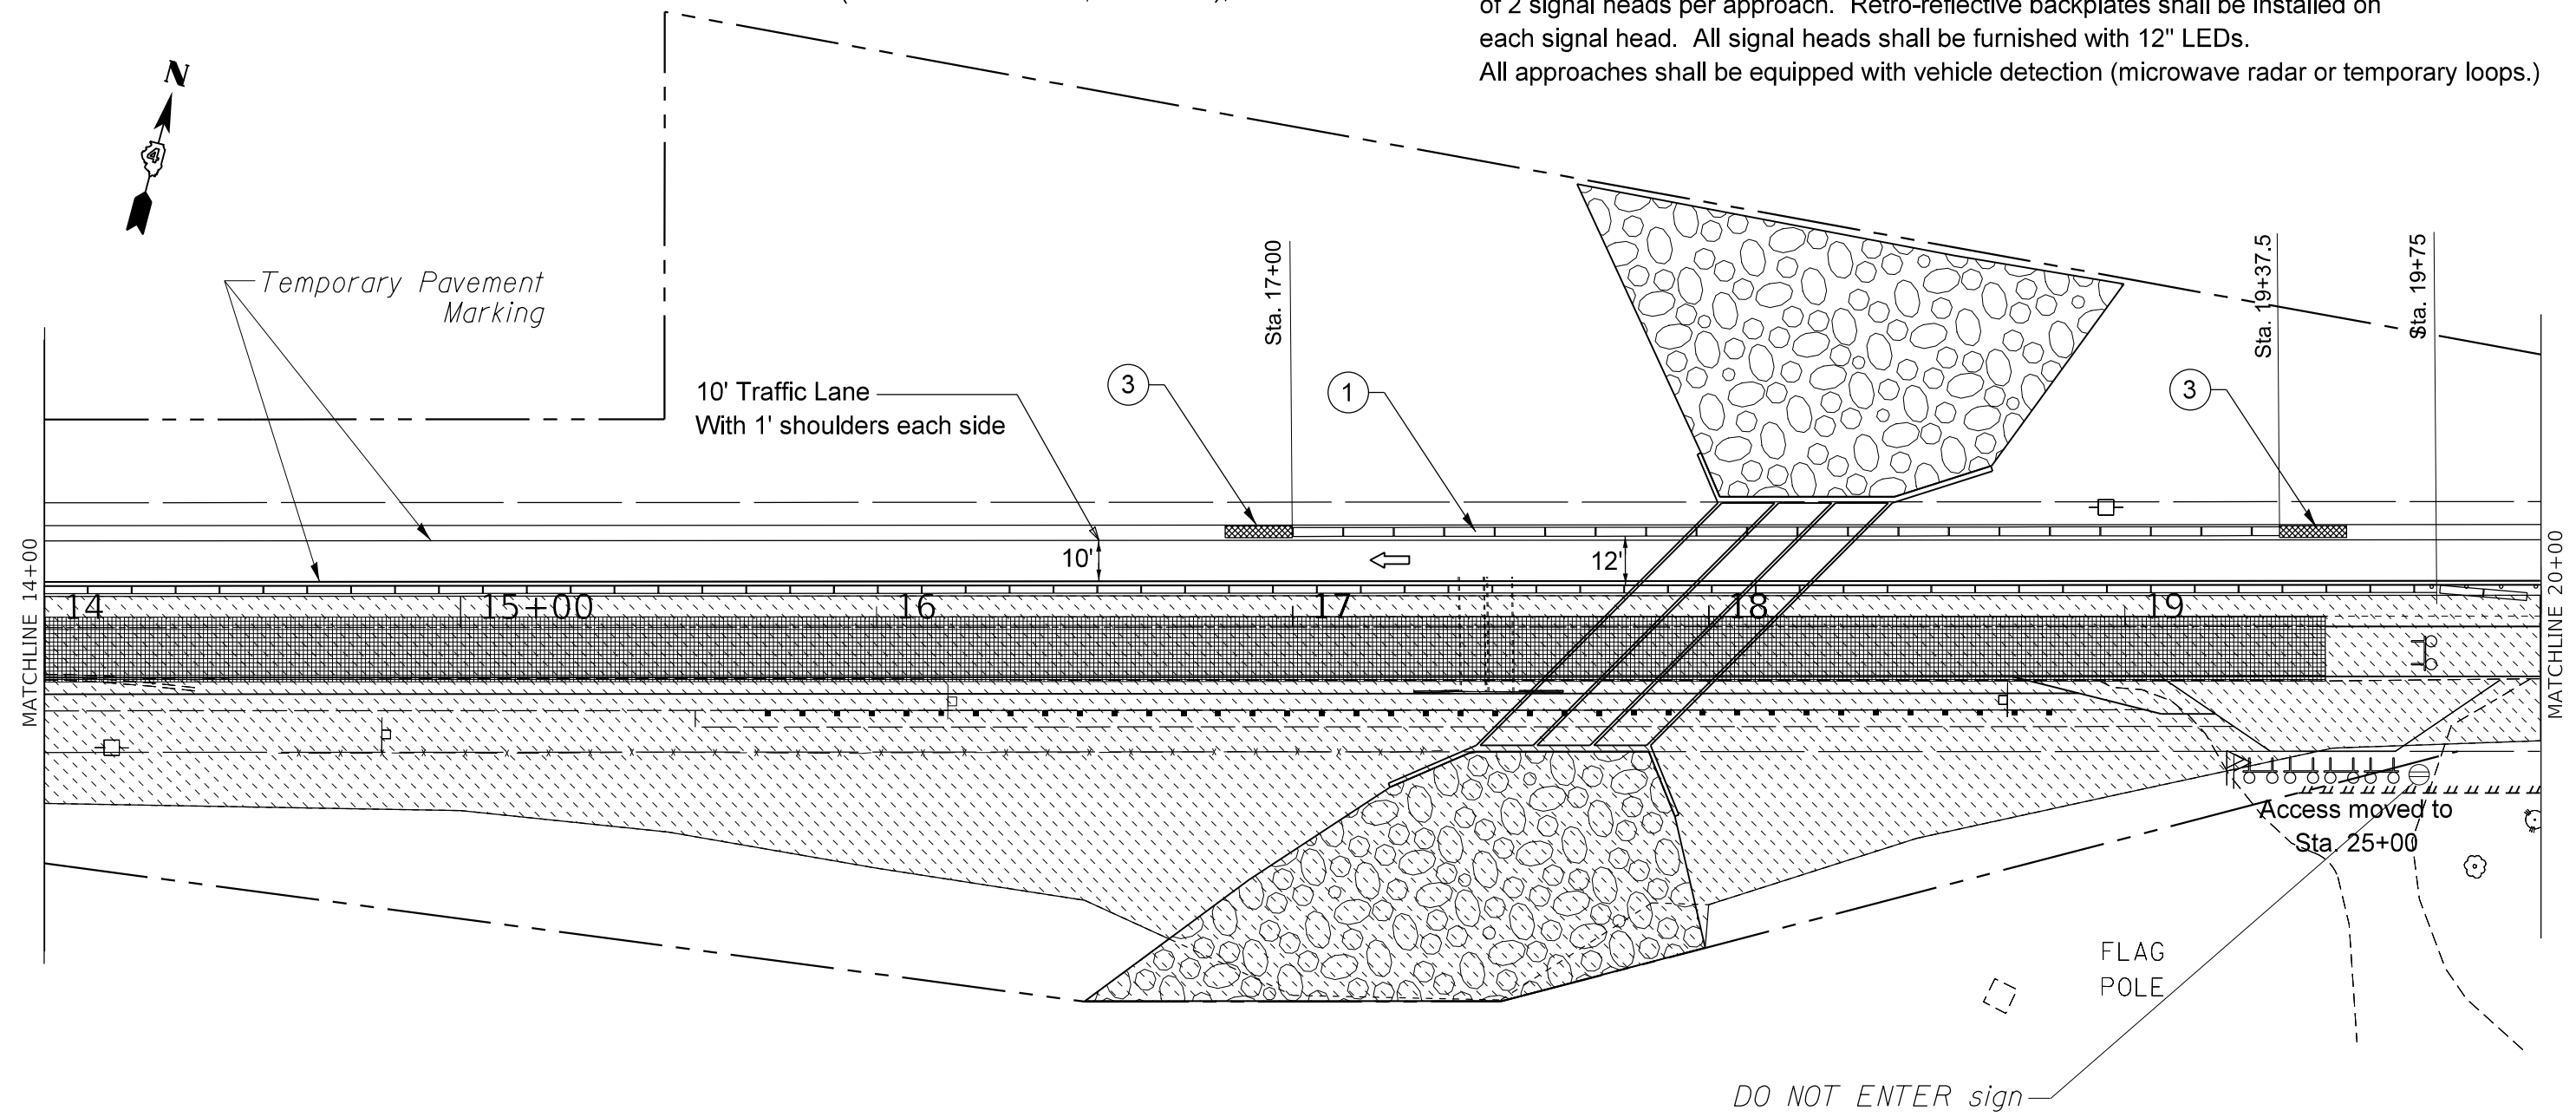

MODEL: Default
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







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DRAWN -	REVISED -	
PLOT SCALE = 100,0000' / in.	CHECKED -	REVISED -
PLOT DATE = 2/1/2020	DATE -	REVISED -

**STATE OF ILLINOIS
DEPARTMENT OF TRANSPORTATION**

Stage II Construction			
SCALE:	SHEET	OF	SHEETS
	STA. 14+00		TO STA. 20+00

F.A.P. RTE.	SECTION	COUNTY	TOTAL SHEETS	SHEET NO.
574	(12)CR		114	47
CONTRACT NO. 68C64				
ILLINOIS FED. AID PROJECT * FULTON / McDONOUGH				

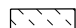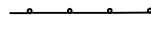LEGEND:

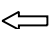-  Aggregate for Temporary Access
-  Pavement Removal
-  Construction this Stage
-  Drum with steady burning light, 50' c.c.
-  Temporary Concrete Barrier
-  Traffic Signal (with Retro-reflective backplate)
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① TEMPORARY CONCRETE BARRIER
Barrier wall markers
at 25' cts. See Standards
704001 & 782006.

② IMPACT ATTENUATORS, TEMPORARY
(NON-REDIRECTIVE), TEST LEVEL 3

GENERAL NOTES:


Advisory speed limit shall be 40 mph.

Existing or temporary pavement markings shall be on both sides of open lane.

Traffic Control Shall conform to Standard 701321 and as shown on the Traffic Control plans. Temporary Rumble Strips shall be placed in accordance with Standard 701326.

All traffic signal operations shall conform to the MUTCD. There shall be a minimum of 2 signal heads per approach. Retro-reflective backplates shall be installed on each signal head. All signal heads shall be furnished with 12" LEDs.

All approaches shall be equipped with vehicle detection (microwave radar or temporary loops.)

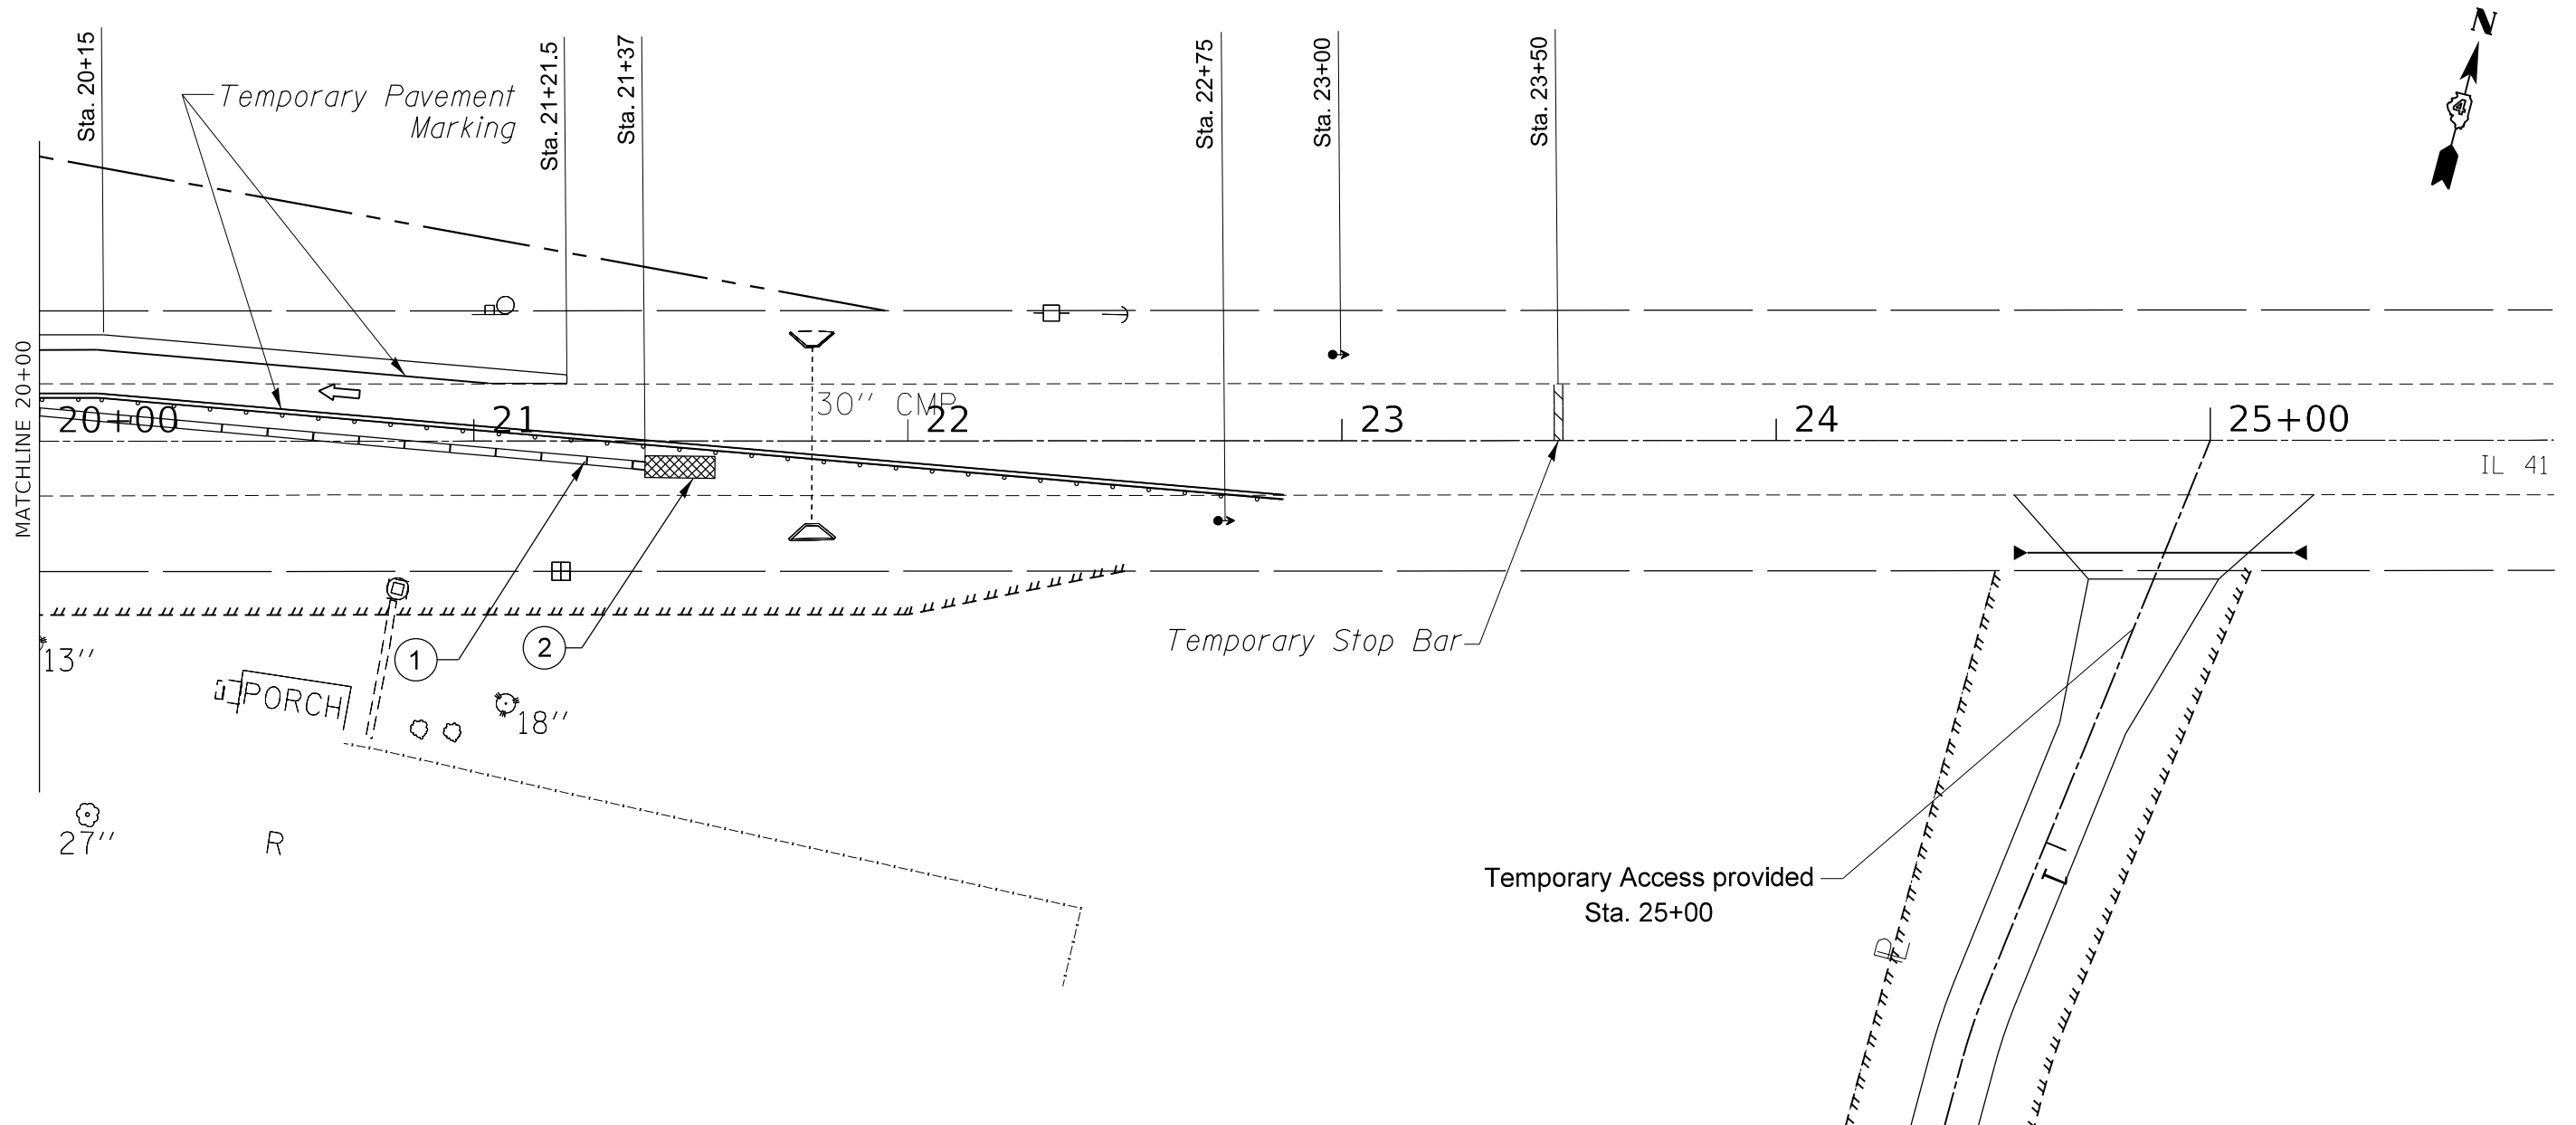

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 DATE: 2/3/2020

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PLOT SCALE = 100.0000' / in.	DRAWN -	REVISED -
PLOT DATE = 2/3/2020	CHECKED -	REVISED -
	DATE -	REVISED -

**STATE OF ILLINOIS
DEPARTMENT OF TRANSPORTATION**

Stage II Construction

SCALE: SHEET OF SHEETS STA. 20+00 TO STA. 26+00

F.A.P. RTE.	SECTION	COUNTY	TOTAL SHEETS	SHEET NO.
574	(12)CR	-	114	48
CONTRACT NO. 68C64				

ILLINOIS FED. AID PROJECT
FULTON / McDONOUGH





Benchmark: R.R. spike in South face of North power pole east of S.N. 029-1000, Sta. 15+64.50, 25.6' Lt., Elev. 637.933.

Existing Structure: S.N. 029-1000 was built in 1924 under S.B.I. Rte. 41, Section 11. The existing structure is a double 6'x7' barrel culvert with attached L-type wingwalls that are parallel to the roadway. Existing structure to remain in place and filled with flowable fill. Stage construction shall be used during construction.


No Salvage.

Notes:

Filter fabric shall be placed at the bottom of the excavation. Rockfill shall be used to backfill the excavation and capped with 6 inches of porous granular embankment (CA7 or CA11).

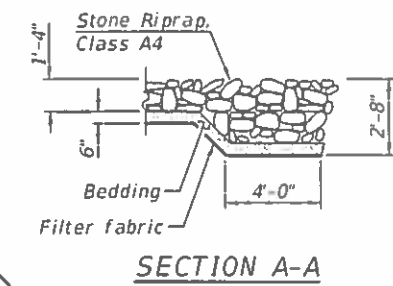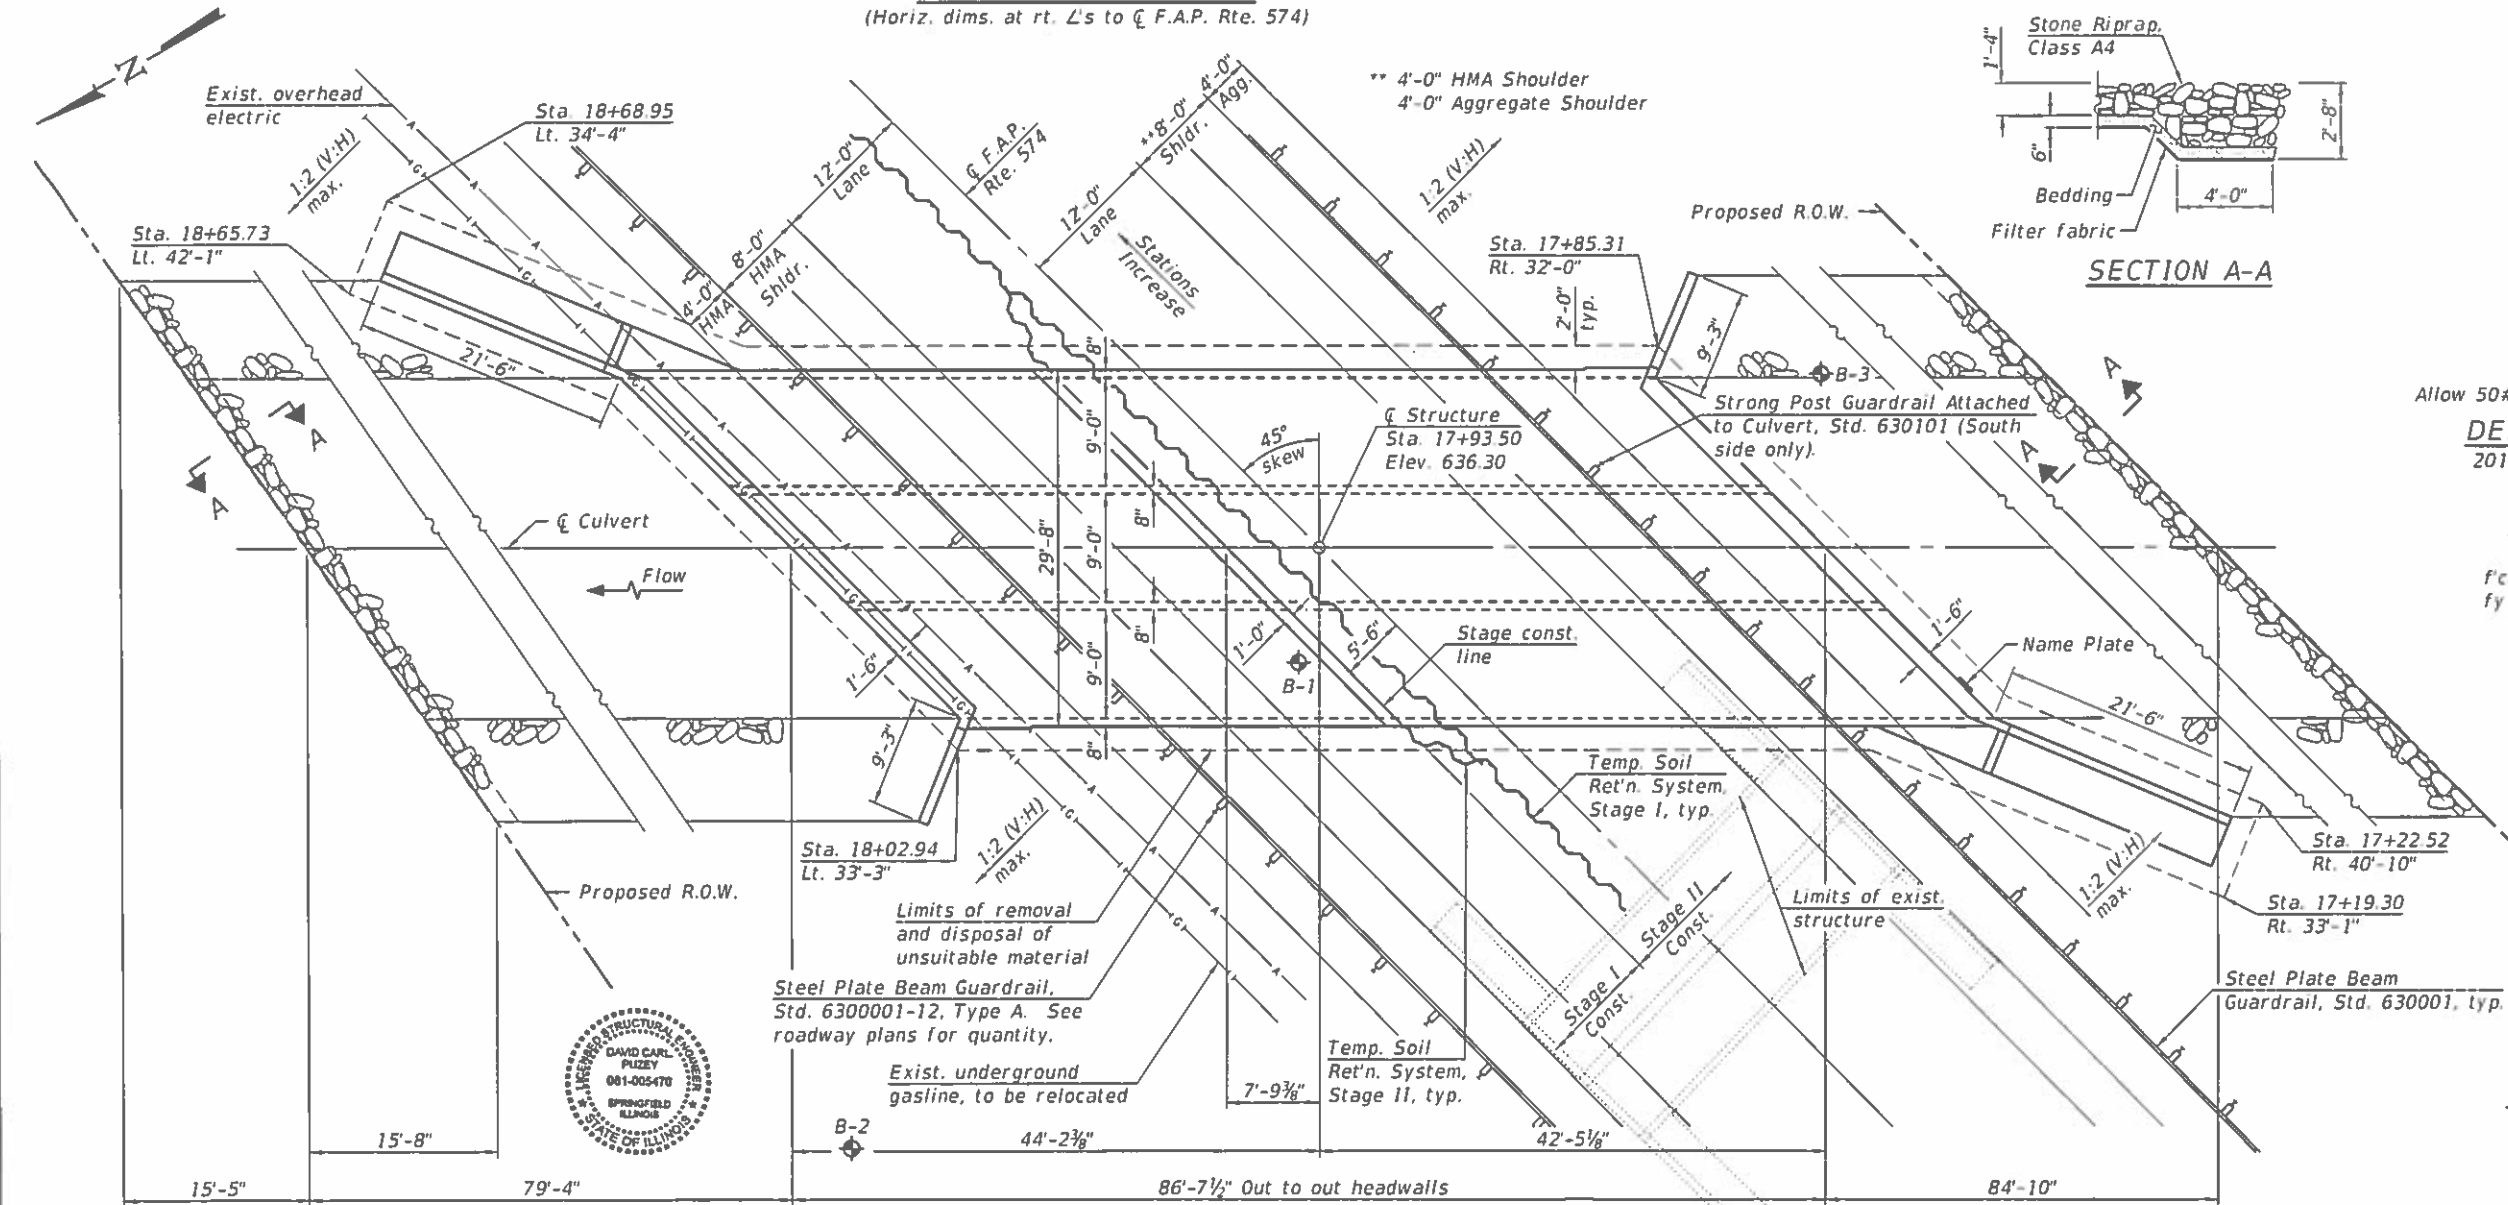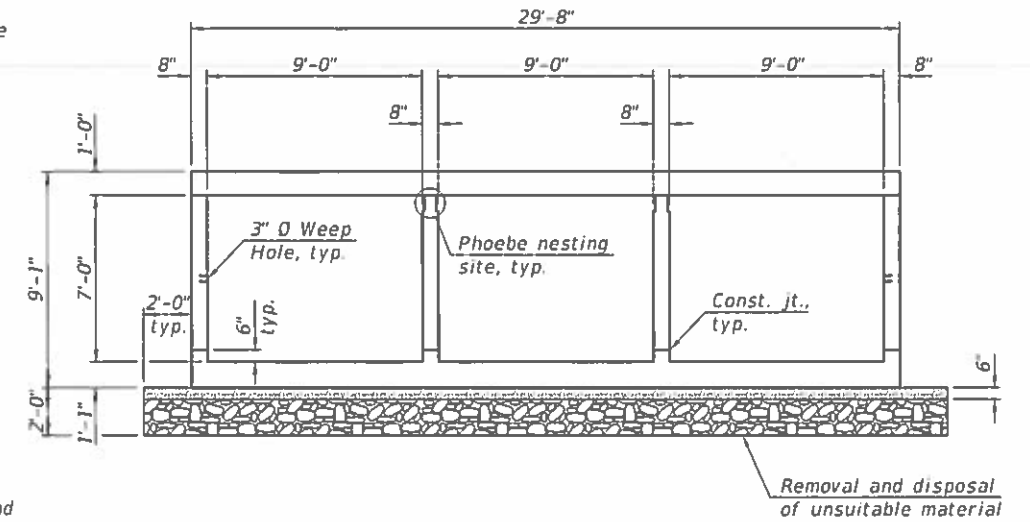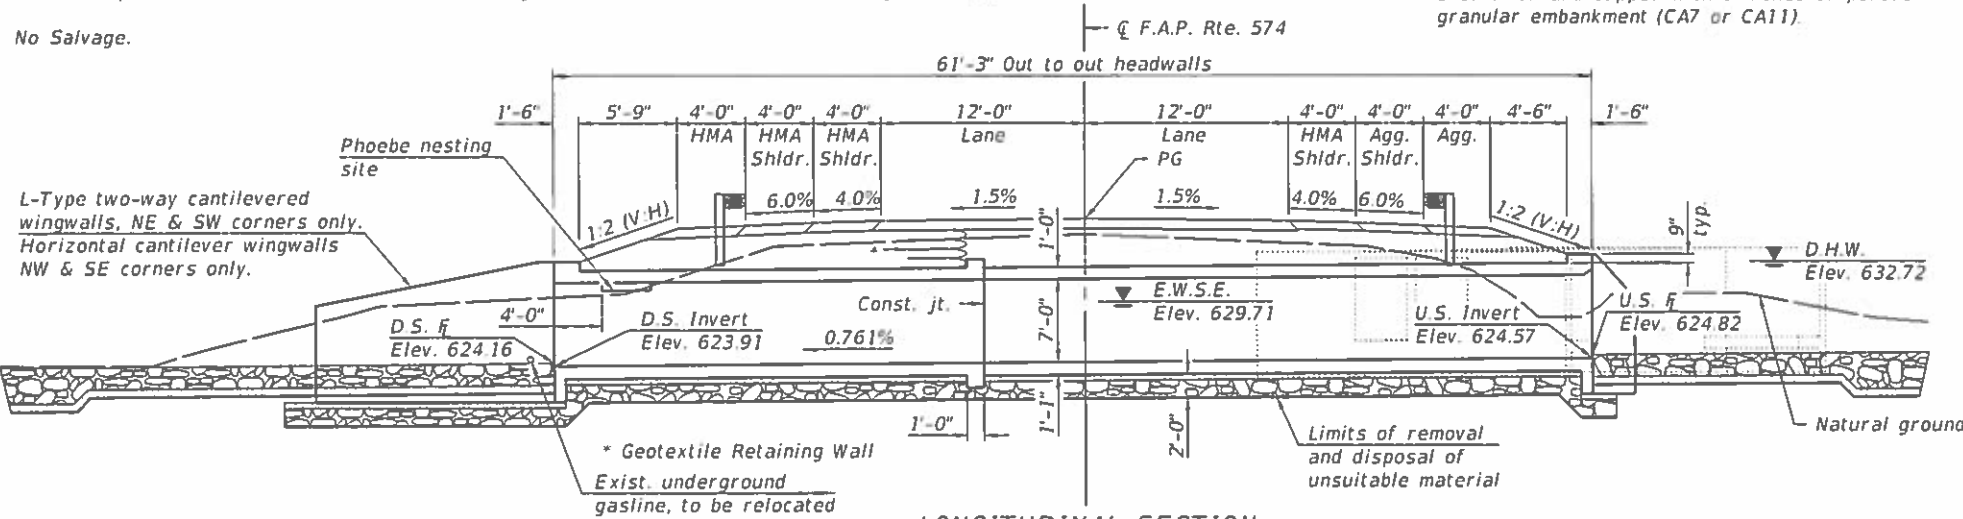

LOADING HL-93
 Allow 50#/sq. ft. for future wearing surface.
DESIGN SPECIFICATIONS
 2017 AASHTO LRFD Bridge Design Specifications, 8th Edition
DESIGN STRESSES
FIELD UNITS
 $f_c = 3,500$ psi
 $f_y = 60,000$ psi (Reinforcement)

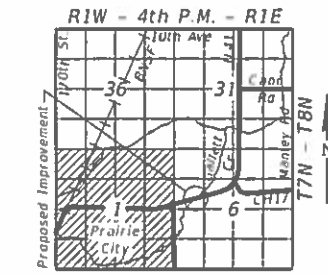


GENERAL PLAN & ELEVATION
IL 41 OVER GALLETT CREEK
F.A.P. RTE. 574 - SECTION (12)CR
FULTON COUNTY
17+93.50
STRUCTURE NO. 029-2501

DESIGNED - HAMEED SALIH	EXAMINED - [Signature]	DATE - 12/2/2019	STATE OF ILLINOIS DEPARTMENT OF TRANSPORTATION		F.A.P. RTE. 574	SECTION (12)CR	COUNTY FULTON	TOTAL SHEETS 202	SHEET NO. 49
CHECKED - RAY BHANUJHI	PASSED - [Signature]	REVISED -	SHEET 1 OF 14 SHEETS		CONTRACT NO. 68C64				
DRAWN - DENNIS A. POP	ENGINEER OF BRIDGES AND STRUCTURES				ILLINOIS FED AID PROJECT				
CHECKED - GRAHSS	ENGINEER OF BRIDGES AND STRUCTURES								

MODEL: 0292501.68C64-001 FILE NAME: pw:\p\planroom\dot\illinois.gov\FWIDOT\Documents\DOT Offices\Bureau of Bridges and Structures\Projects\0292501\CAADD Plans\0292501-68C64.dgn 12/2/2019 10:35:15 AM

GENERAL NOTES

Layout of the slope protection system may be varied to suit ground conditions in the field as directed by the Engineer.
Reinforcement bars designated (E) shall be epoxy coated.
Precast alternate is not allowed.

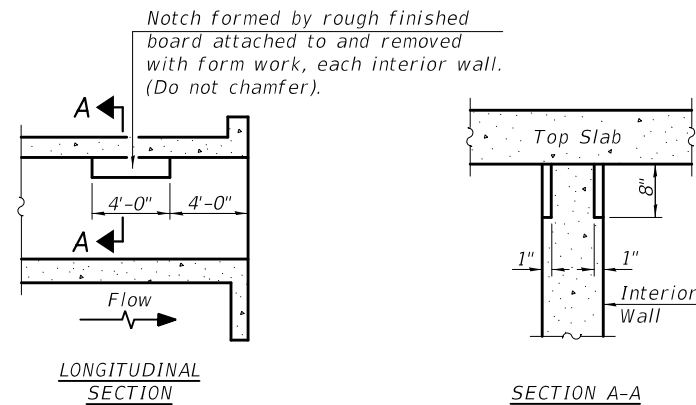

PHOEBE NESTING
SITE DETAILS
(Downstream End Only)


WATERWAY INFORMATION

Drainage Area = 1.92 Sq. Mi. Low Grade Elev. 636.30 @ Sta. 16+75 to 18+90

Flood	Freq. Yr.	Q C.F.S.	Opening Ft ²		Nat. H.W.E.	Head - Ft.		Headwater El.	
			Exist.	Prop.		Exist.	Prop.	Exist.	Prop.
	10	517	68	189	632.0	1.4	0.0	633.4	632.0
Design	50	819	77	189	632.8	2.3	0.4	635.1	633.2
Base	100	958	80	189	633.0	2.3	0.6	635.3	633.6
Existing Overtopping	25	688	74	N/A	632.5	2.2	N/A	634.7	N/A
Proposed Overtopping	N/A	N/A	N/A	N/A	N/A	N/A	N/A	N/A	N/A
Max. Calc.	500	1,290	84	189	633.5	2.1	1.1	635.6	634.6

INDEX OF SHEETS

- 1 General Plan & Elevation
- 2 General Data
- 3 Stage Construction Details
- 4 Geotextile Retaining Wall
- 5 Temporary Concrete Barrier for Stage Construction
- 6 Culvert Details - Top Slab
- 7 Culvert Details - Bottom Slab
- 8 Culvert Details
- 9 L-Type Two-Way Cantilevered Wingwalls
- 10 Horizontal Cantilever Wingwalls
- 11 Culvert Details
- 12 Bar Splicer Assembly and Mechanical Splicer Details
- 13-14 Soil Boring Logs

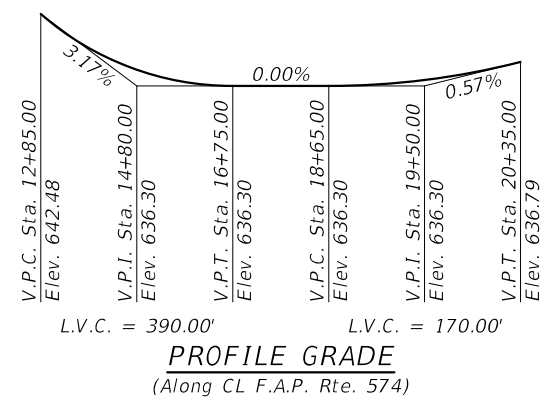



PROFILE GRADE
(Along CL F.A.P. Rte. 574)

TOTAL BILL OF MATERIAL

ITEM	UNIT	TOTAL
Removal and Disposal of Unsuitable Material for Structures	Cu. Yd.	258
Stone Riprap, Class A4	Sq. Yd.	849
Filter Fabric	Sq. Yd.	1236
Reinforcement Bars, Epoxy Coated	Pound	70470
Bar Splicers	Each	160
Name Plates	Each	1
Temporary Soil Retention System	Sq. Ft.	1046
Concrete Box Culverts	Cu. Yd.	294.8
Rock Fill	Ton	464
Strong Post Guardrail Attached to Culvert	Foot	42
Geotextile Retaining Wall	Sq. Ft.	176
Concrete Removal	Cu. Yd.	4.4

MODEL: 0292501-68C64-002
FILE NAME: p:\planroom\dot.illinois.gov\p\DOT\Documents\DOT Offices\Bureau of Bridges and Structures\Projects\0292501-68C64.dgn

DESIGNED - HAMEED S. SALIH	EXAMINED
CHECKED - RAY AHANCHI	PASSED
DRAWN - DENNIS A. POP	
CHECKED - G.R.A. / H.S.S.	

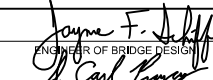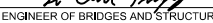DATE - DECEMBER 2, 2019

 ENGINEER OF BRIDGE DESIGN

 ENGINEER OF BRIDGES AND STRUCTURES

REVISIONS	DATE
REVISIONS	DATE
REVISIONS	DATE



STATE OF ILLINOIS
DEPARTMENT OF TRANSPORTATION

GENERAL DATA
STRUCTURE NO. 029-2501



SHEET 2 OF 14 SHEETS

F.A.P. RTE.	SECTION	COUNTY	TOTAL SHEETS	SHEET NO.
574	(12)CR	FULTON	202	50
CONTRACT NO. 68C64				
ILLINOIS FED. AID PROJECT				

Notes:
 Horizontal dimensions on Longitudinal Sections are perpendicular to ζ Roadway.
 Temporary pipes shall be placed in the north end of the existing structure to provide drainage during Stage II Construction. Contractor to determine water diversion location. Once new structure has been completed, the temporary pipes and existing structure cells are to be filled with flowable fill, see Roadway plans.

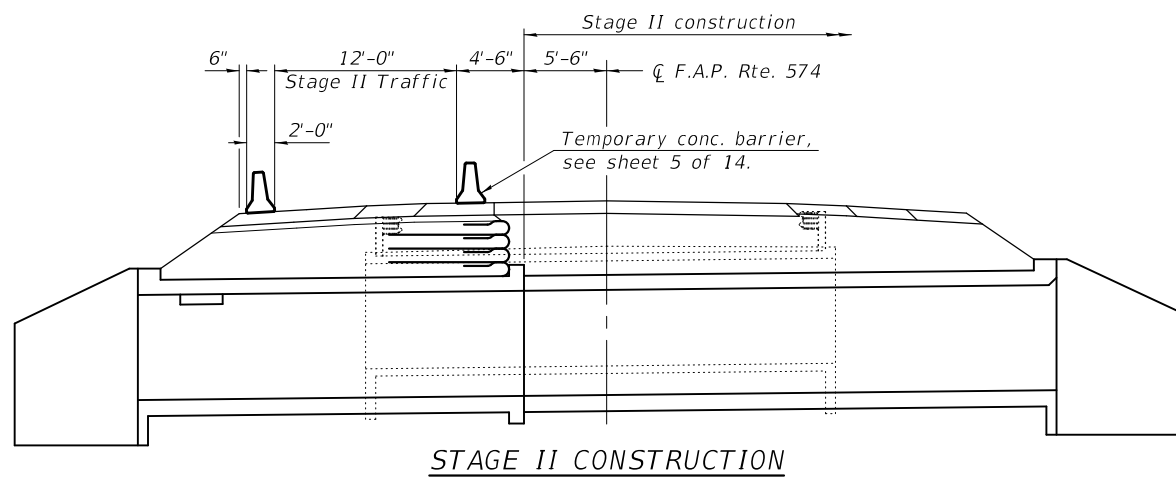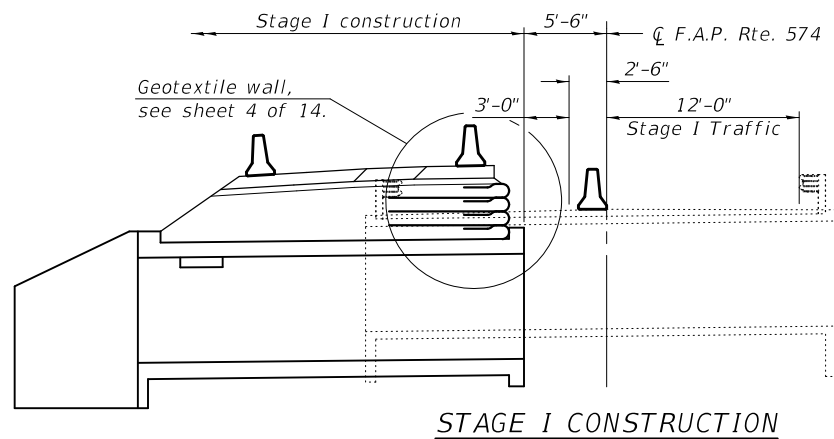

Removal Note: Existing Southeast wingwall to be removed entirely prior to stage II construction. Cost will be paid for as Concrete Removal.

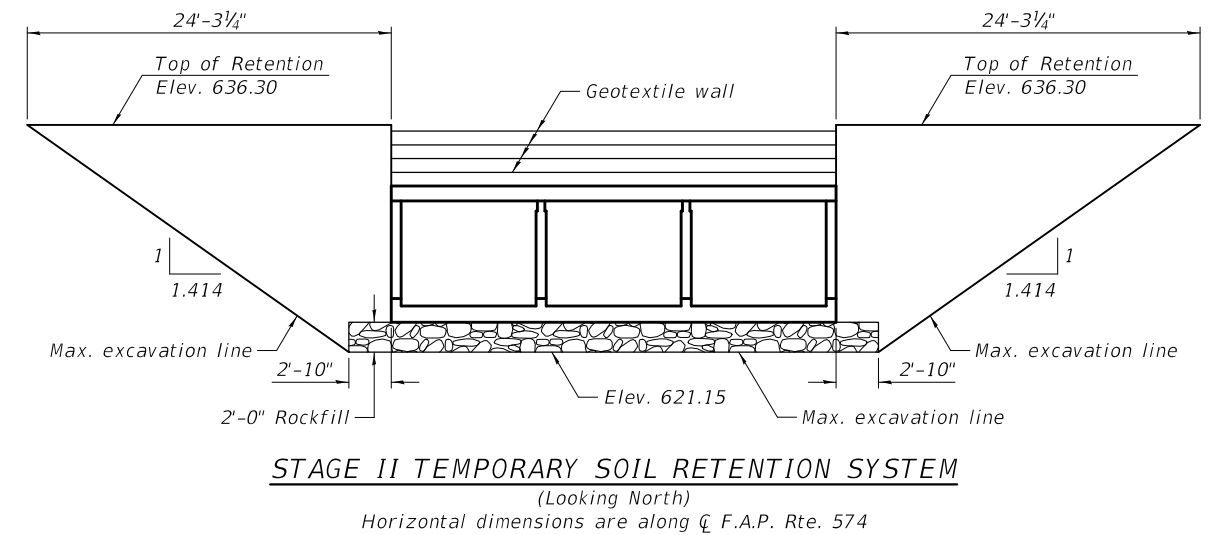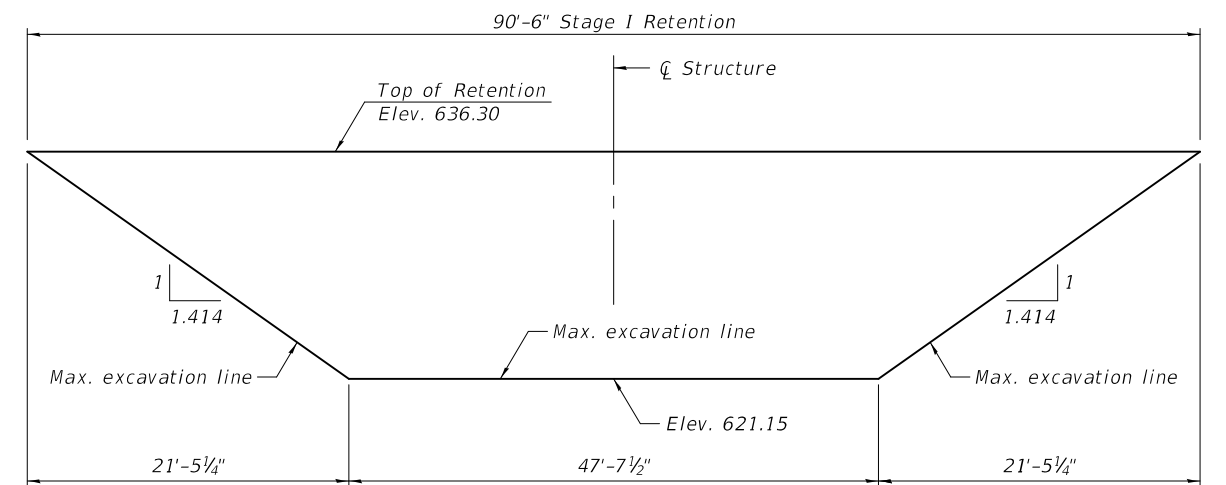

A cantilevered sheet piling design does not appear feasible and additional members or other retention systems may be necessary. The Contractor shall submit a temporary soil retention system design including plan details and calculations for review and acceptance by the Engineer.

MODEL: 0292501-68C64-003
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DESIGNED -	HAMEED S. SALIH
CHECKED -	RAY AHANCHI
DRAWN -	DENNIS A. POP
CHECKED -	G.R.A. / H.S.S.

EXAMINED	<i>Joanne F. Salih</i> ENGINEER OF BRIDGE DESIGN
PASSED	<i>Carl Ringer</i> ENGINEER OF BRIDGES AND STRUCTURES


DATE -	DECEMBER 2, 2019
REVISED -	
REVISED -	

**STATE OF ILLINOIS
 DEPARTMENT OF TRANSPORTATION**

**STAGE CONSTRUCTION DETAILS
 STRUCTURE NO. 029-2501**


SHEET 3 OF 14 SHEETS

F.A.P. RTE.	SECTION	COUNTY	TOTAL SHEETS	SHEET NO.
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CONTRACT NO. 68C64				
		ILLINOIS	FED. AID PROJECT	

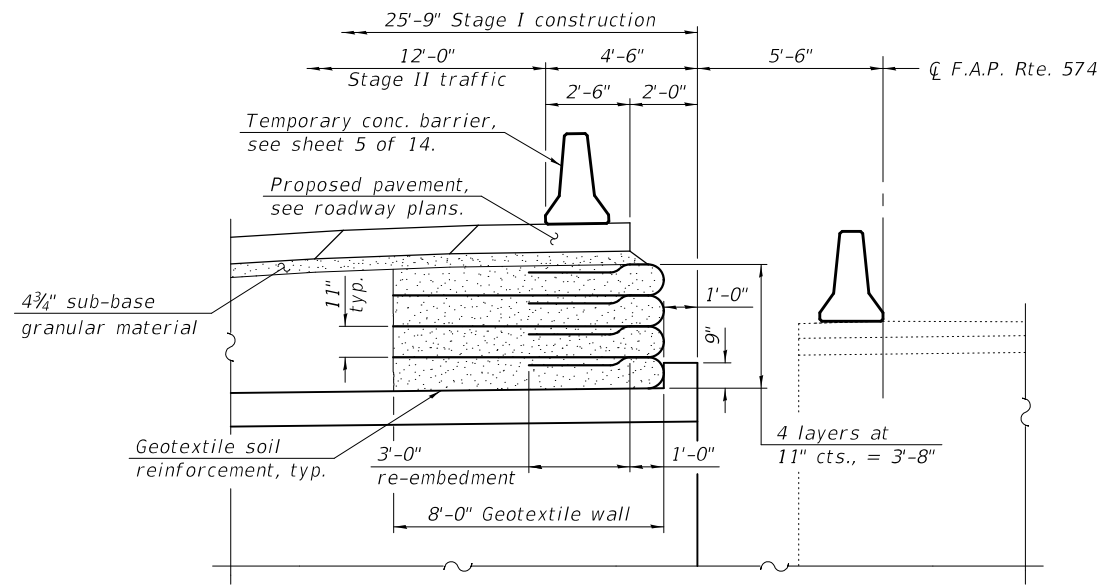

SECTION A-A


Horizontal dimensions are at Rt. L's to C.F.A.P. Rte. 574.

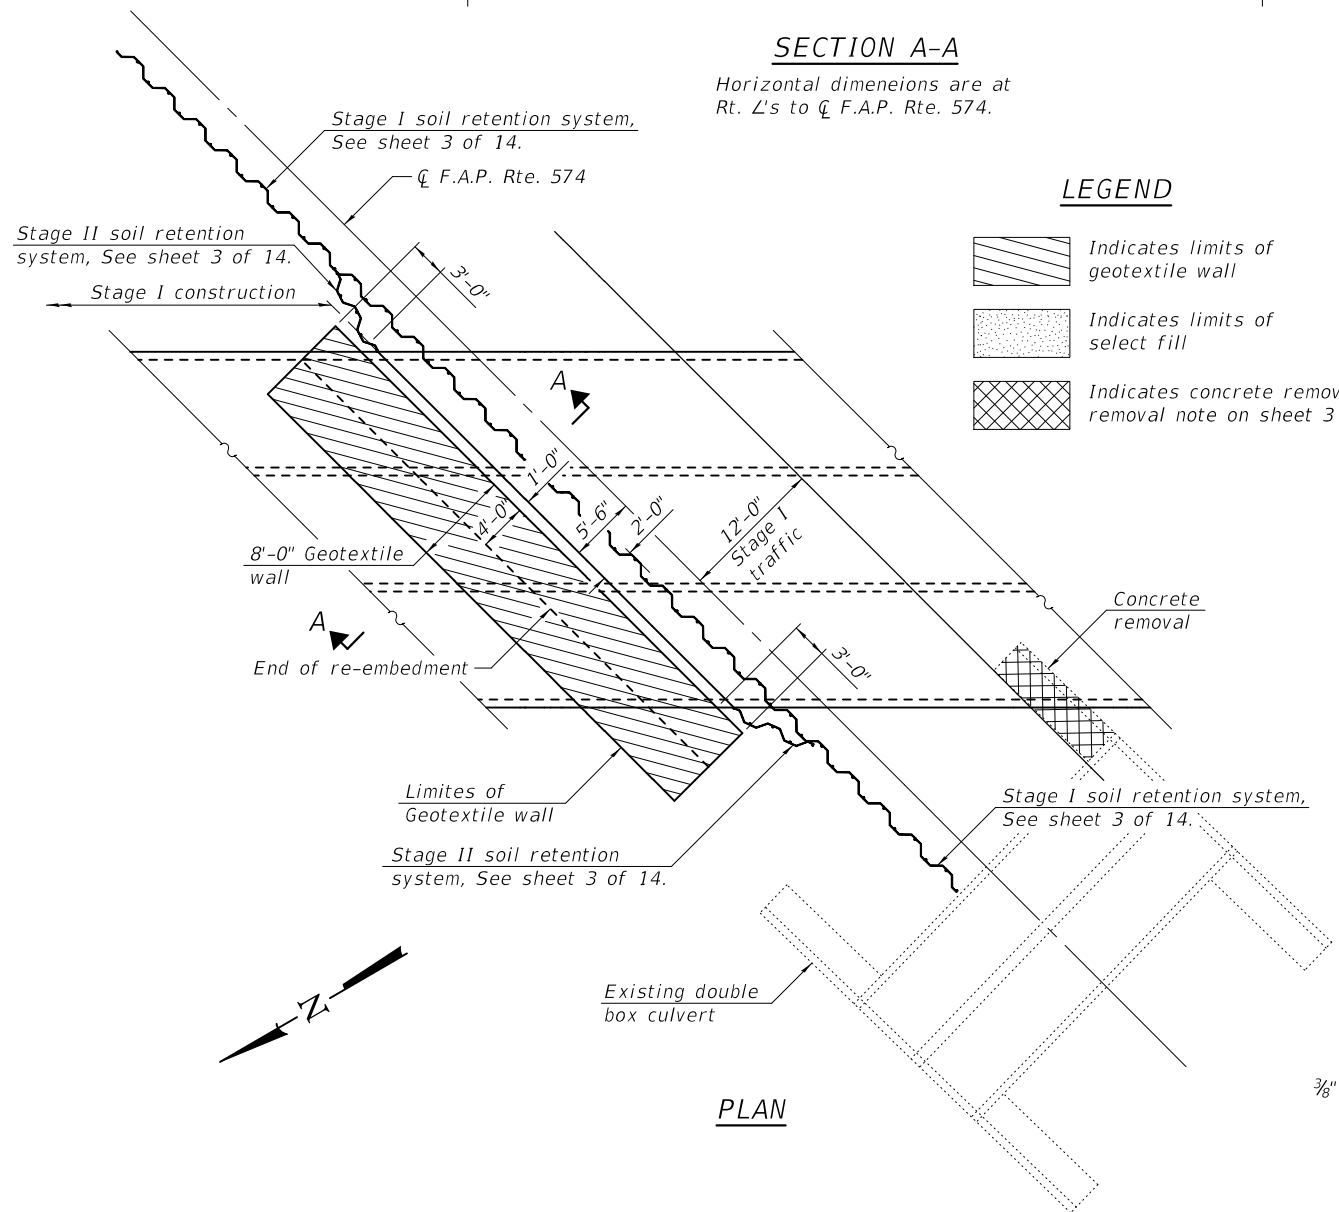

PLAN

LEGEND


- Indicates limits of geotextile wall
- Indicates limits of select fill
- Indicates concrete removal, see removal note on sheet 3 of 14.

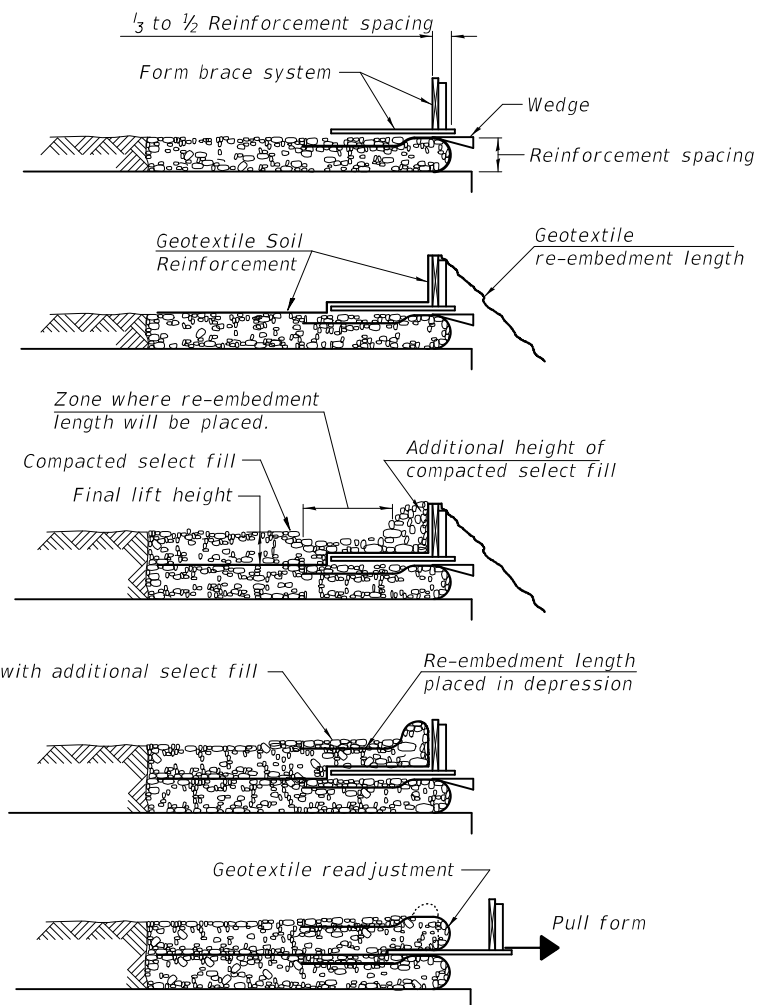


GEOTEXTILE WALL CONSTRUCTION SEQUENCE

1. Place form brace system on completed reinforcement level; back from the finished fabric face a distance of $\frac{1}{3}$ to $\frac{1}{2}$ the geotextile reinforcement spacing.
2. Position fabric so that the required geotextile re-embedment length extends over the top of the form brace and the design reinforcement width is placed with no slack against the previous level.
3. Compact select fill material in lifts to final lift height, create (± 3 ") depression in zone where re-embedment length will be located and place additional height of compacted select fill against form brace.
4. Fold geotextile re-embedment length back over form brace into zone where depression was made in select fill and place additional select fill (± 3 ") to embed geotextile and bring to final lift height.
5. Pull form brace outward allowing geotextile face to slightly readjust to form tight round face level with plan reinforcement spacing.

Note:
The geotextile soil reinforcement shall have a minimum allowable tensile strength (T min.) of 14 lb./in. as determined by the procedure described in the Special Provision. The computations supporting the determination of (T min.) shall be submitted to the engineer for approval.

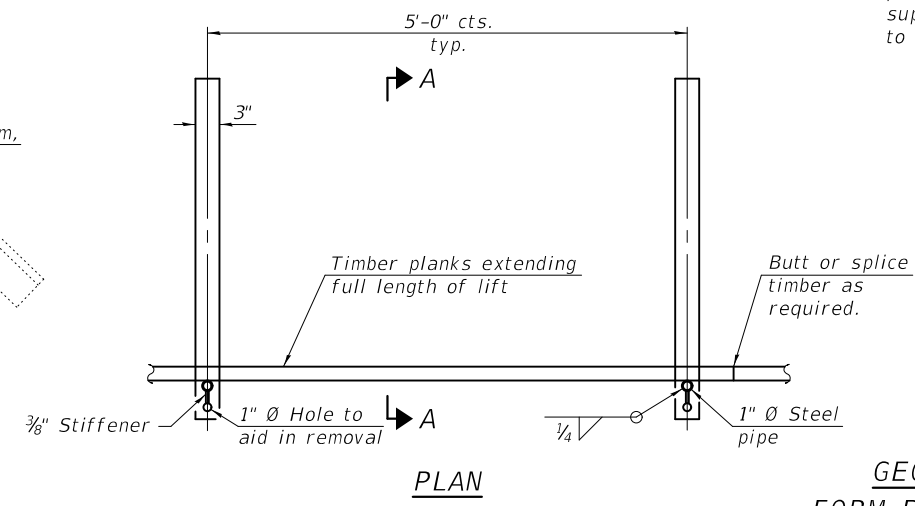

PLAN

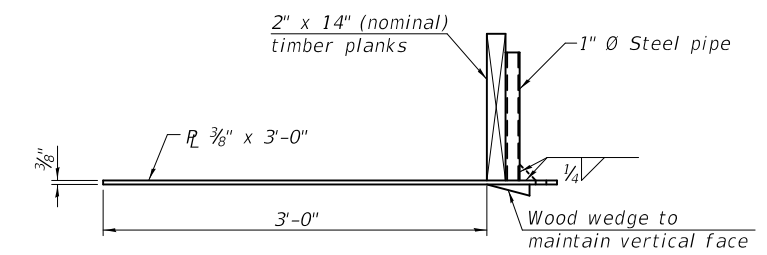

SECTION A-A

GEOTEXTILE FORM BRACE DETAIL

Note:
This is a suggested detail, the Contractor is responsible for the design of the form brace system to be used.

MODEL: 0292501-68C64-004
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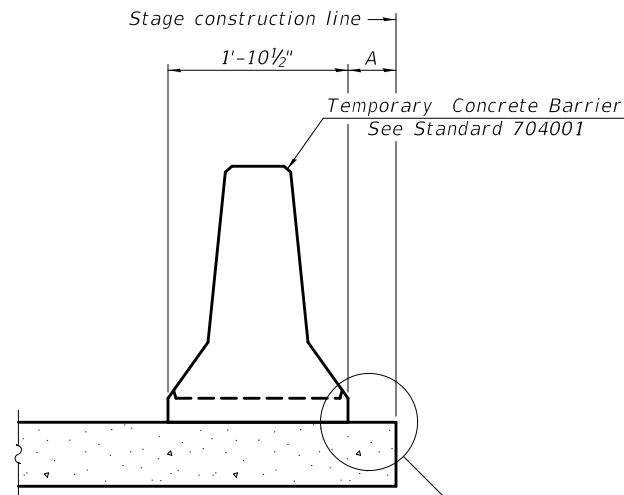
DESIGNED - HAMEED S. SALIH	EXAMINED	DATE - DECEMBER 2, 2019
CHECKED - RAY AHANCHI	PASSED	REVISIONS
DRAWN - DENNIS A. POP		REVISIONS
CHECKED - G.R.A. / H.S.S.		

**STATE OF ILLINOIS
DEPARTMENT OF TRANSPORTATION**

**GEOTEXTILE RETAINING WALL
STRUCTURE NO. 029-2501**


SHEET 4 OF 14 SHEETS

F.A.P. RTE.	SECTION	COUNTY	TOTAL SHEETS	SHEET NO.
574	(12)CR	FULTON	202	52
CONTRACT NO. 68C64				
ILLINOIS FED. AID PROJECT				



When "A" is 3'-1" or less, the temporary concrete barrier shall be restrained to the new slab according to Detail I, II or III. No restraint is required when "A" is greater than 3'-1".

NEW SLAB OR NEW DECK BEAM

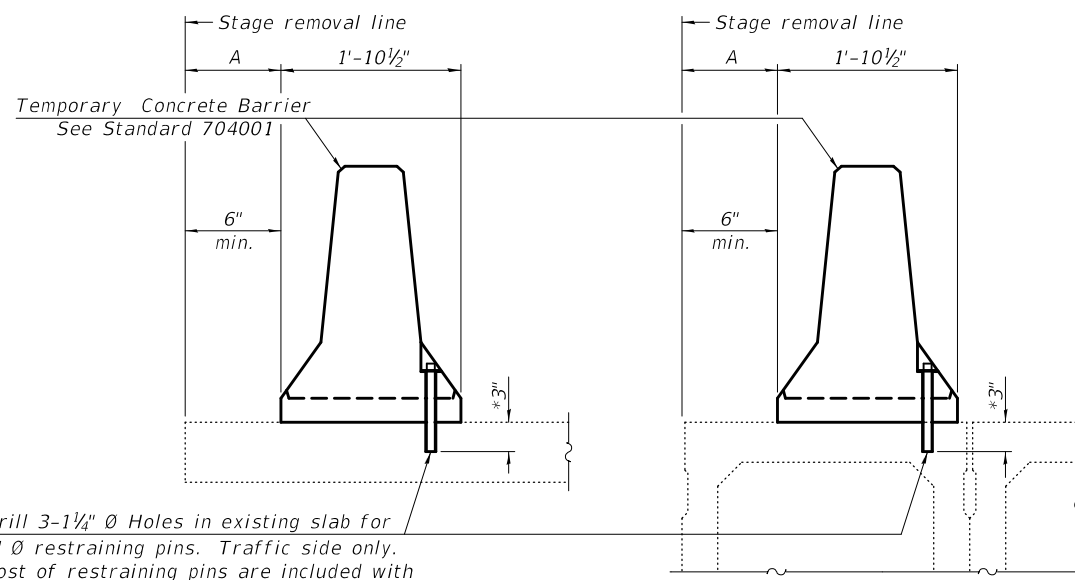


Drill 3-1/4" Ø Holes in existing slab for 1" Ø restraining pins. Traffic side only. Cost of restraining pins are included with Temporary Concrete Barrier. No restraint is required when "A" is greater than 3'-1".

EXISTING SLAB


* When hot-mix asphalt wearing surface is present, embedment shall be 3" plus the wearing surface depth.

EXISTING DECK BEAM

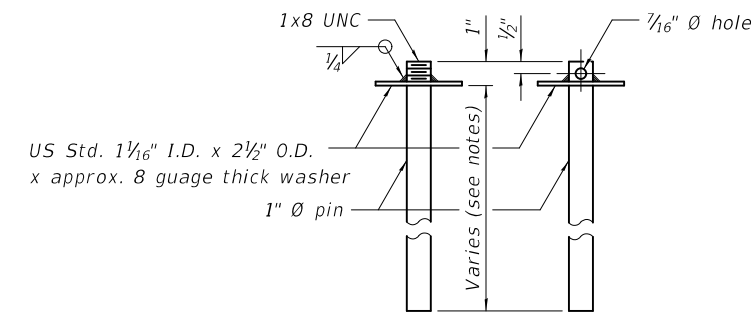


RESTRAINING PIN


SECTIONS THRU SLAB OR DECK BEAM

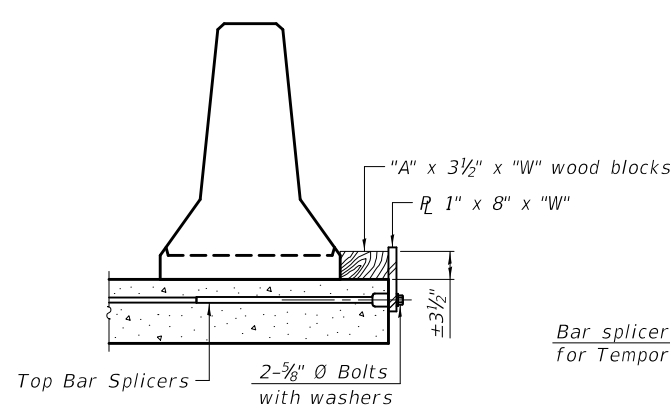


DETAIL I

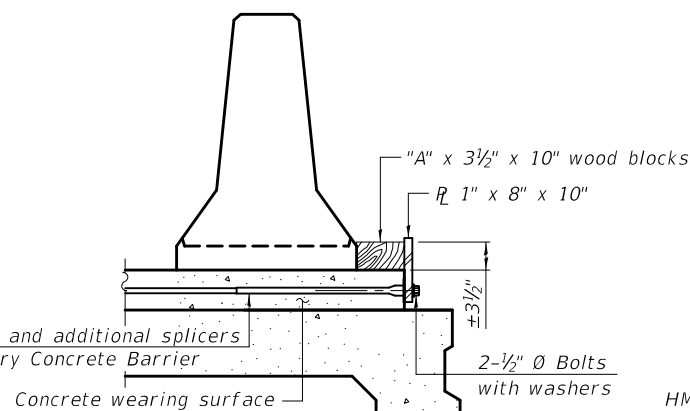


DETAIL II

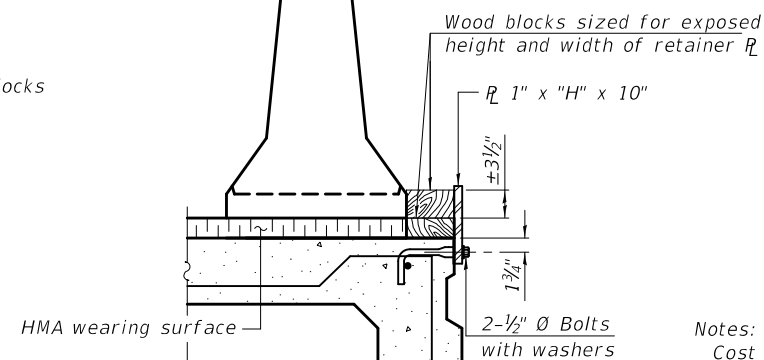


DETAIL III

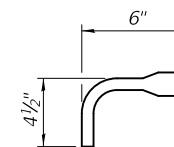

BAR SPLICER FOR #4 BAR - DETAIL III

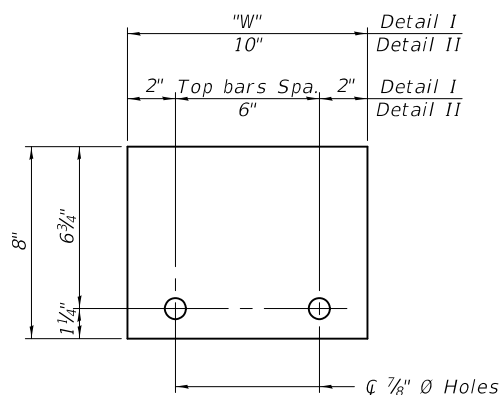

STEEL RETAINER 1" x 8" x "W"
(Detail I and II)

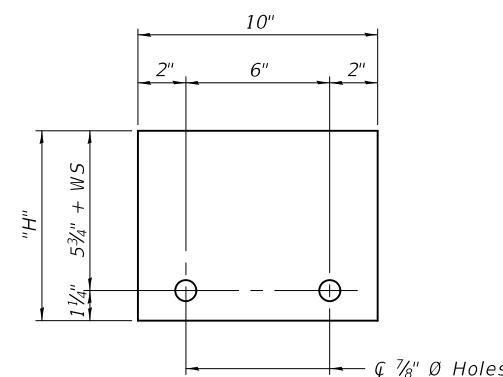

STEEL RETAINER 1" x "H" x 10"
(Detail III)

Notes:
 Cost of retainer assembly is included with Temporary Concrete Barrier.
 A retainer assembly shall be located at the approximate \bar{c} of each temporary concrete barrier.
 The retainer plate shall not be removed until the concrete on the adjacent stage is ready to be poured. For Detail III applications the retainer plate shall not be removed until just prior to placing the adjacent beam.
 When the 'A' dimension is less than 1 1/2', the wood block shall be omitted and the barrier shall be placed in direct contact with the steel retainer plate. For deck beam applications the minimum required 'A' distance is 6" to accommodate the shear key clamping device.

Detail I - Installation for a new bridge deck or bridge slab.
 Detail II - Installation for a new deck beam with an initial concrete wearing surface. Additional bar splicers shall be provided at 6'-0" centers and paired with the bar splicers of the concrete wearing surface reinforcement to accommodate the installation of the retainer assemblies. The cost of the additional bar splicers is included with the concrete wearing surface.
 Detail III - Installation for a new deck beam with no initial wearing surface or with an initial hot-mix asphalt (HMA) wearing surface present. The deck beam directly beneath the temporary concrete barrier shall be fabricated with bar splicer inserts in the side of the beam, as detailed, to accommodate the installation of the retainer assemblies. A pair of bar splicers, 6" apart, shall be placed at 6'-0" centers along the length of the beam. The cost of the bar splicers is included with the deck beam.

MODEL: 0292501-68C64-005
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R-27 8-11-2017

DESIGNED - HAMEED S. SALIH	EXAMINED
CHECKED - RAY AHANCHI	PASSED
DRAWN - DENNIS A. POP	
CHECKED - G.R.A. / H.S.S.	

DATE - DECEMBER 2, 2019
 ENGINEER OF BRIDGES AND STRUCTURES



REVISIONS	
REVISIONS	

STATE OF ILLINOIS
 DEPARTMENT OF TRANSPORTATION

TEMPORARY CONCRETE BARRIER FOR STAGE CONSTRUCTION
 STRUCTURE NO. 029-2501

SHEET 5 OF 14 SHEETS

F.A.P. RTE.	SECTION	COUNTY	TOTAL SHEETS	SHEET NO.
574	(12)CR	FULTON	202	53
CONTRACT NO. 68C64				
ILLINOIS FED. AID PROJECT				

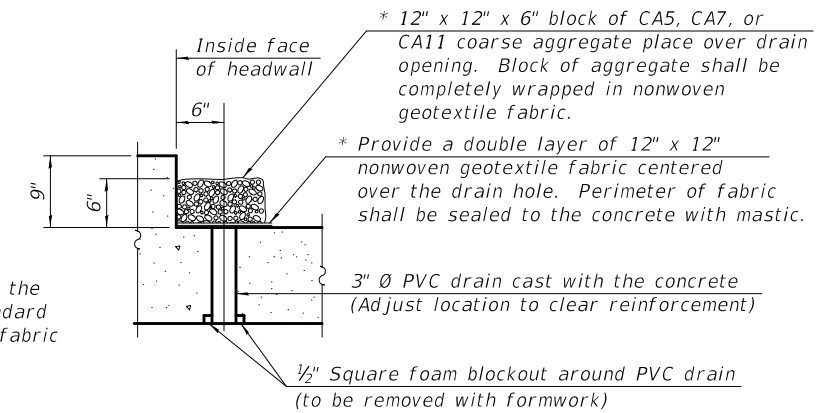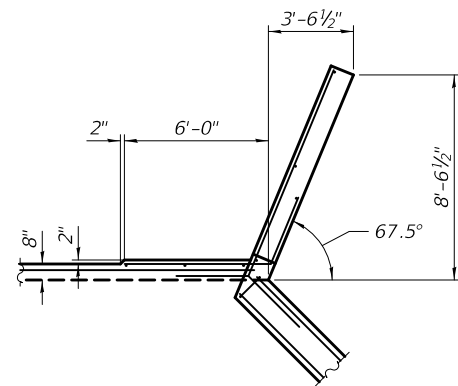

* Nonwoven geotextile fabric shall conform to the requirements of Article 1080.01 of the Standard Specifications. The minimum weight of the fabric shall be 6 ounces per square yard


* 12" x 12" x 6" block of CA5, CA7, or CA11 coarse aggregate place over drain opening. Block of aggregate shall be completely wrapped in nonwoven geotextile fabric.
 * Provide a double layer of 12" x 12" nonwoven geotextile fabric centered over the drain hole. Perimeter of fabric shall be sealed to the concrete with mastic.

3" Ø PVC drain cast with the concrete (Adjust location to clear reinforcement)

1/2" Square foam blockout around PVC drain (to be removed with formwork)

DRAIN DETAIL

(All costs associated with furnishing and constructing the above drain detail will not be measured for payment but shall be included in the contract unit price for the associated work.)

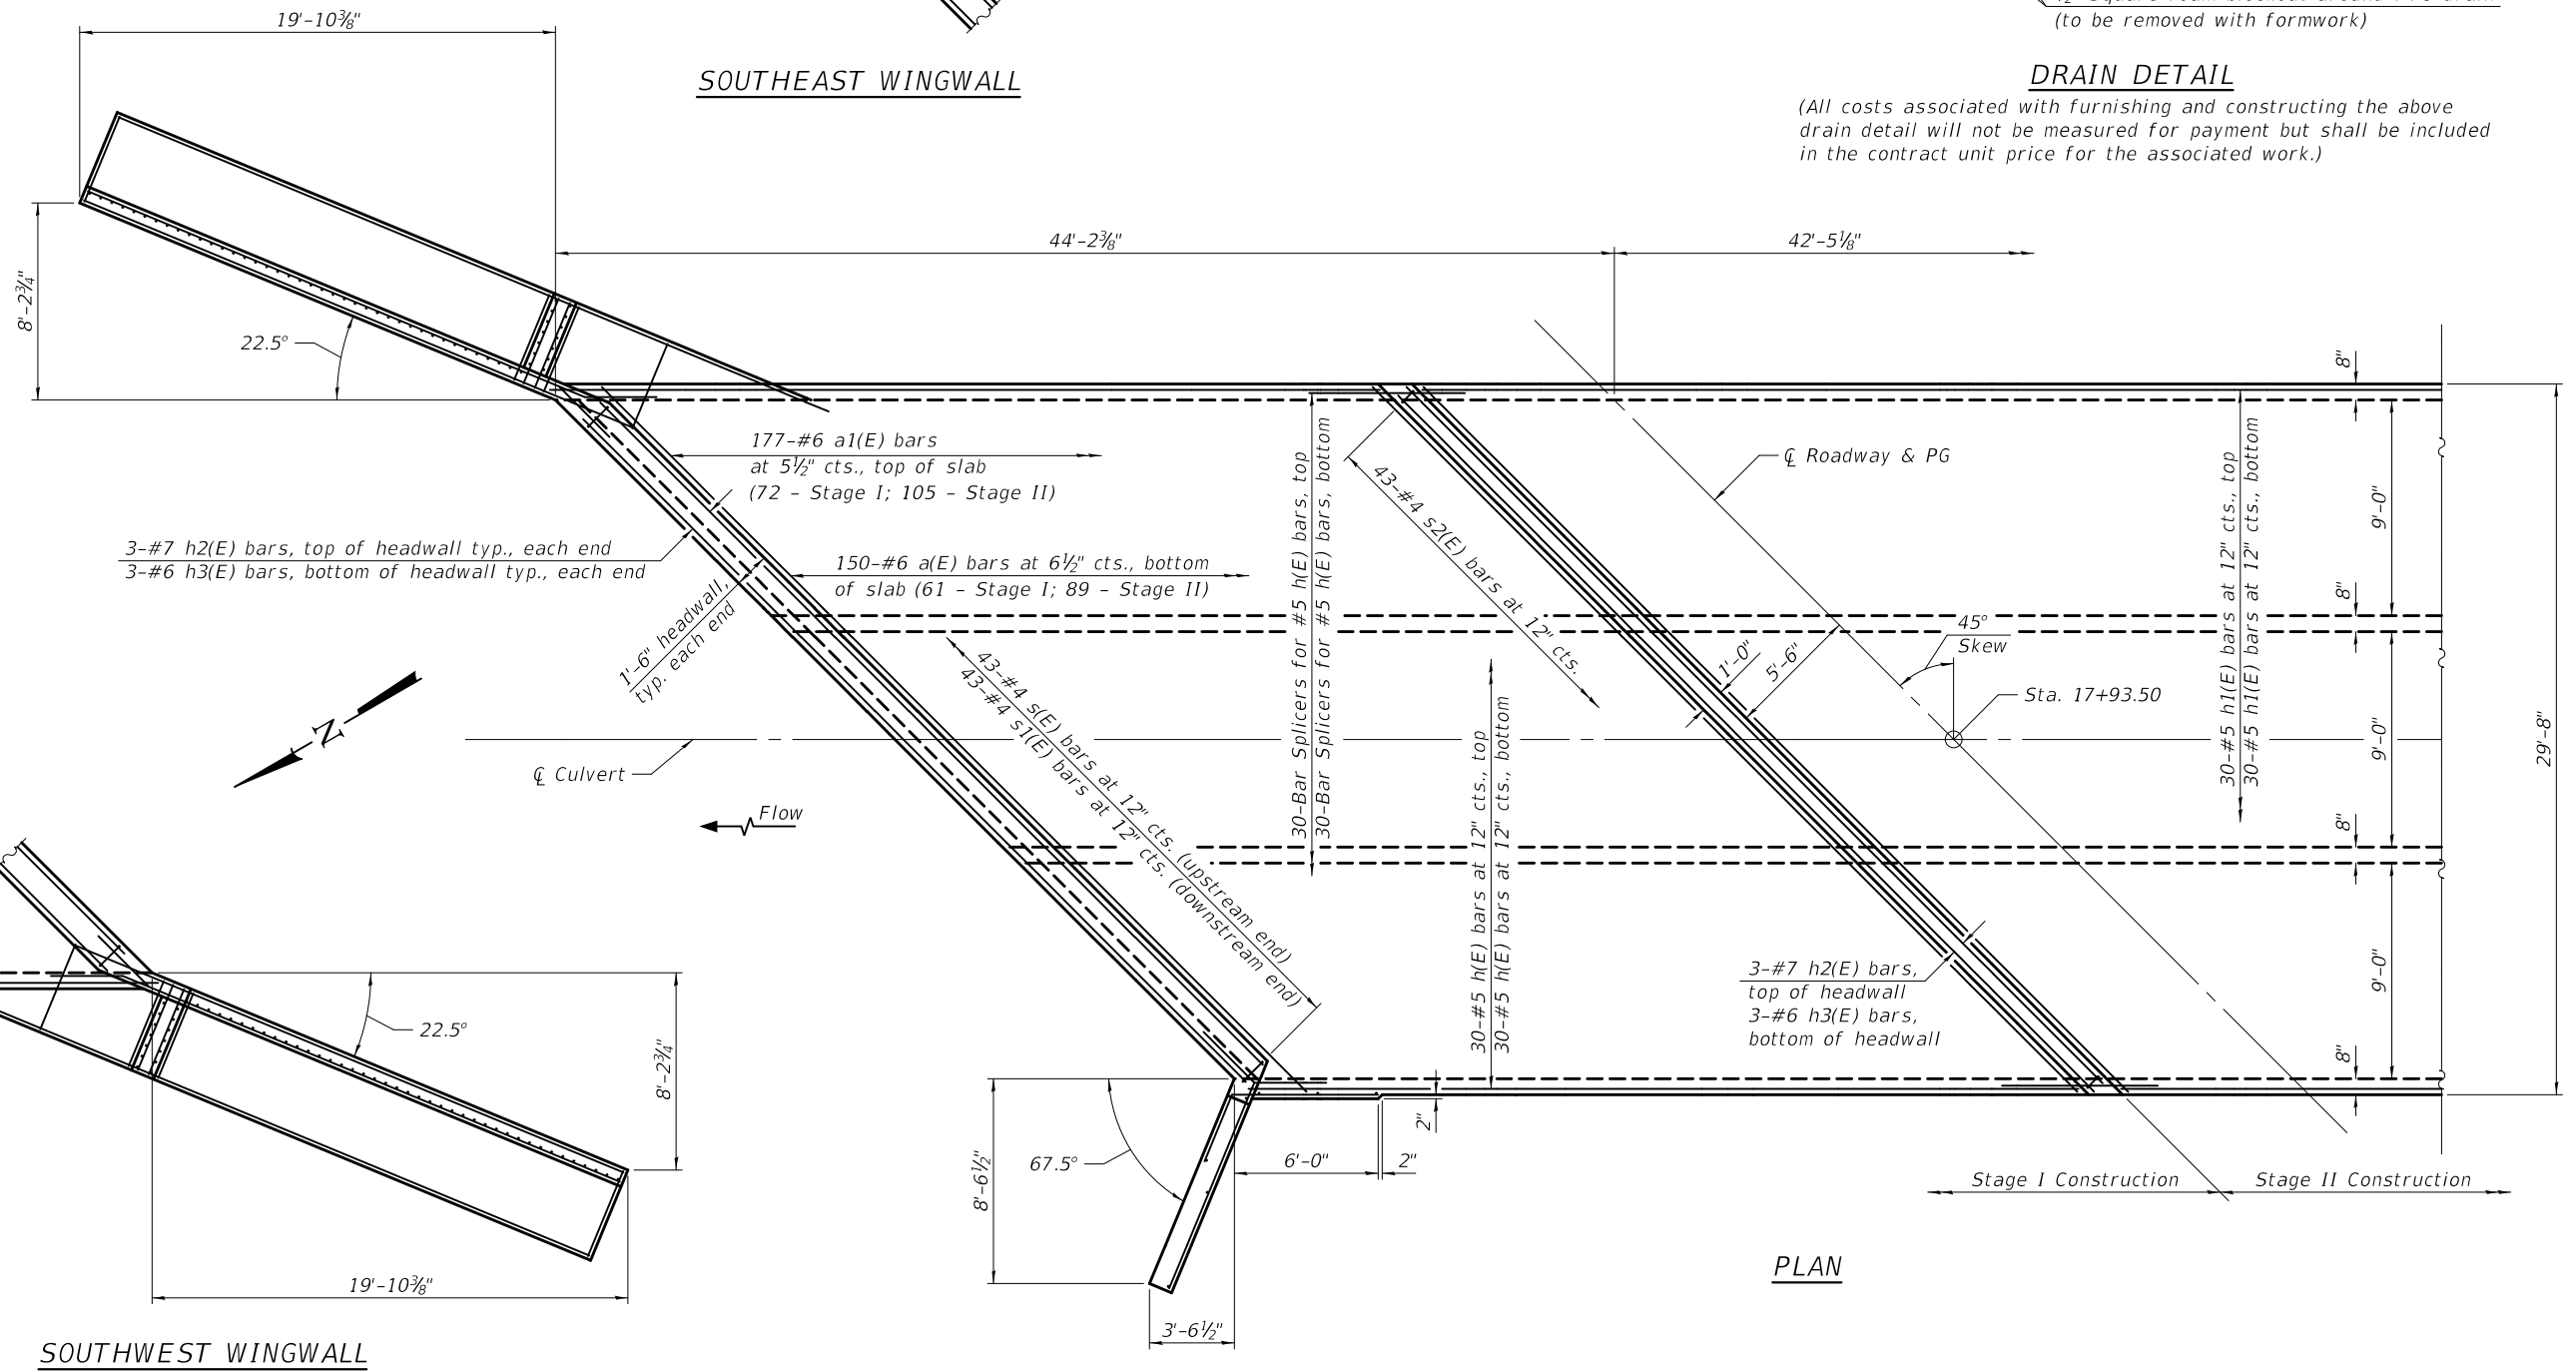

PLAN

SOUTHWEST WINGWALL

SOUTHEAST WINGWALL

MODEL: 0292501-68C64-006 FILE NAME: pw:\planroom\dot.illinois.gov\pww\DOT\Documents\Projects\0292501\CADD Plans\0292501-68C64.dgn

DESIGNED - HAMEED S. SALIH	EXAMINED
CHECKED - RAY AHANCHI	PASSED
DRAWN - DENNIS A. POP	
CHECKED - G.R.A. / H.S.S.	

DATE - DECEMBER 2, 2019

REVISOR: *Jaime F. Salih*
 ENGINEER OF BRIDGE DESIGN

REVISOR: *Carl King*
 ENGINEER OF BRIDGES AND STRUCTURES


**STATE OF ILLINOIS
 DEPARTMENT OF TRANSPORTATION**

**CULVERT DETAILS - TOP SLAB
 STRUCTURE NO. 029-2501**

SHEET 6 OF 14 SHEETS

F.A.P. RTE.	SECTION	COUNTY	TOTAL SHEETS	SHEET NO.
574	(12)CR	FULTON	202	54
CONTRACT NO. 68C64				
ILLINOIS FED. AID PROJECT				

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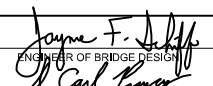


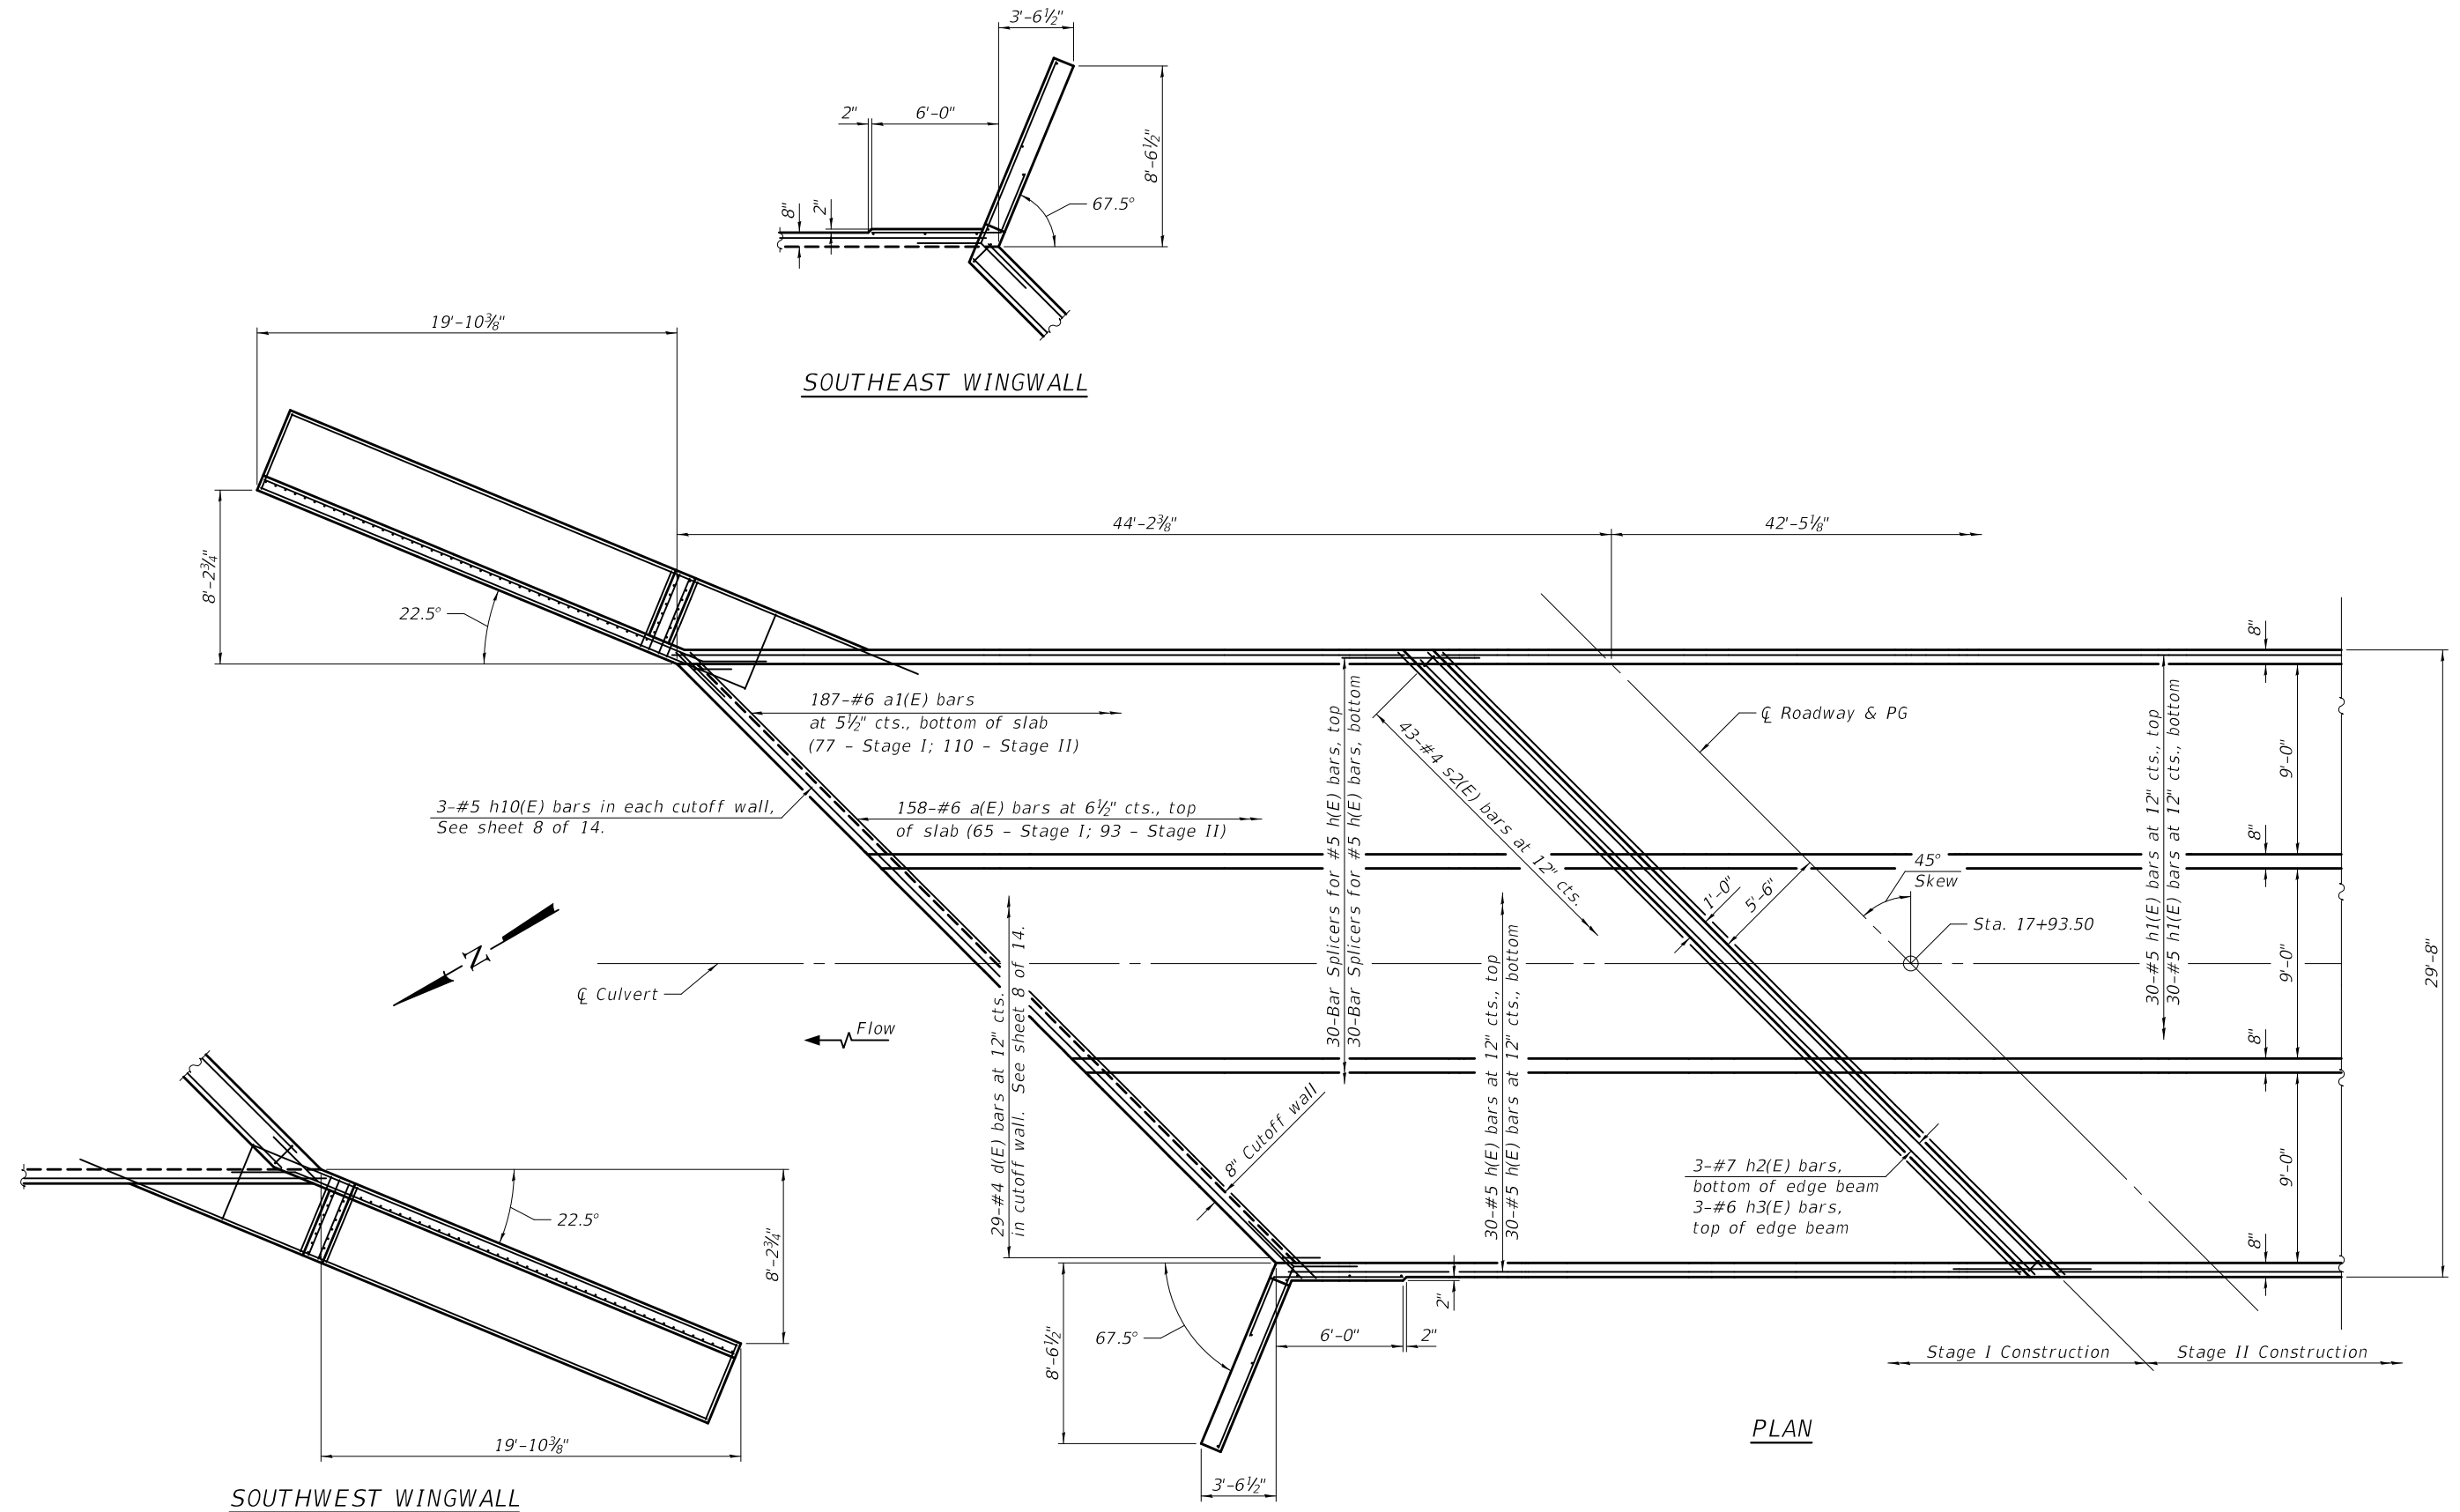SOUTHWEST WINGWALL

SOUTHEAST WINGWALL

PLAN

DESIGNED -	HAMEED S. SALIH
CHECKED -	RAY AHANCHI
DRAWN -	DENNIS A. POP
CHECKED -	G.R.A. / H.S.S.

EXAMINED	 ENGINEER OF BRIDGE DESIGN
PASSED	
ENGINEER OF BRIDGES AND STRUCTURES	


DATE -	DECEMBER 2, 2019
REVISED -	
REVISED -	

**STATE OF ILLINOIS
 DEPARTMENT OF TRANSPORTATION**


**CULVERT DETAILS - BOTTOM SLAB
 STRUCTURE NO. 029-2501**

F.A.P. RTE.	SECTION	COUNTY	TOTAL SHEETS	SHEET NO.
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CONTRACT NO. 68C64				
		ILLINOIS	FED. AID PROJECT	


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LONGITUDINAL SECTION
(Looking East)

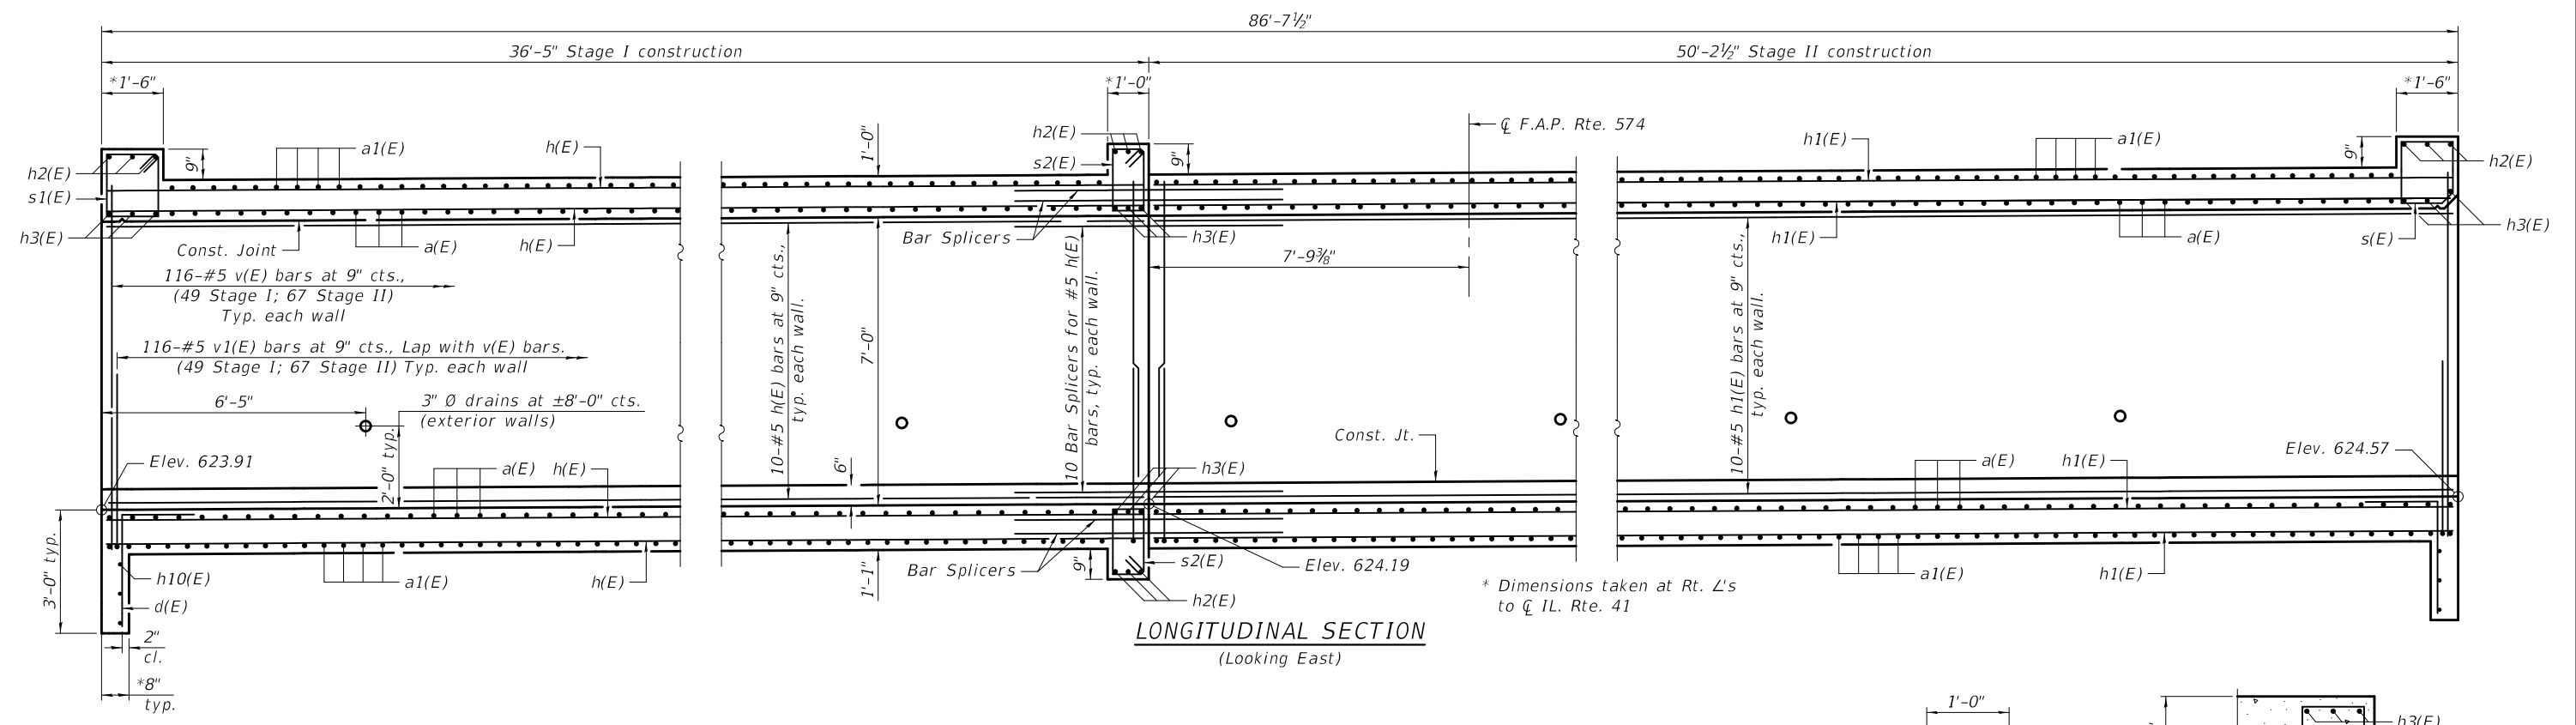

SECTION THRU BARREL
(Horizontal dimensions at Rt. L's unless otherwise noted)

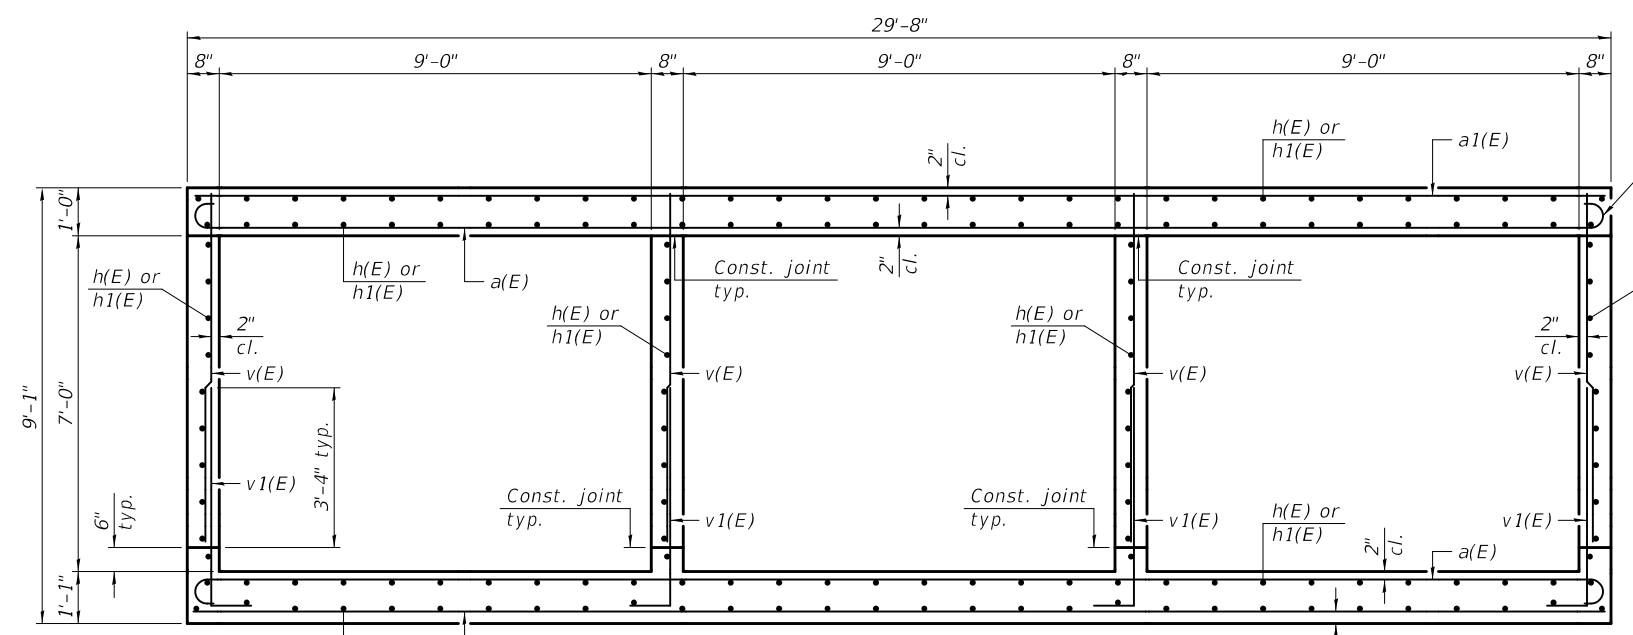

SECTION THRU HEADWALL

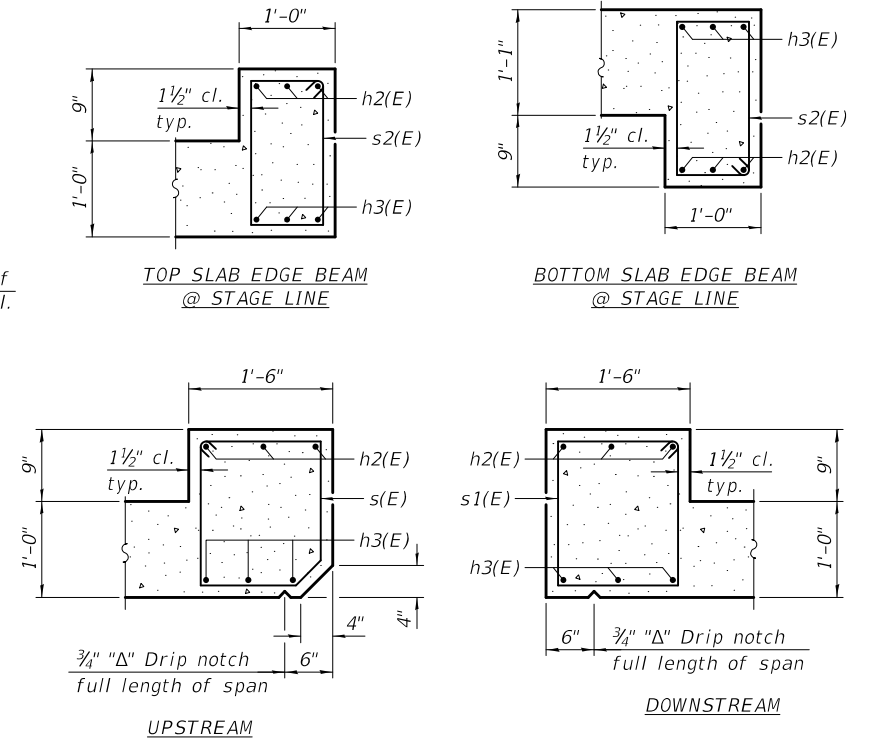DESIGNED - HAMEED S. SALIH	EXAMINED
CHECKED - RAY AHANCHI	PASSED
DRAWN - DENNIS A. POP	
CHECKED - G.R.A. / H.S.S.	

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Joanne F. Salih
 ENGINEER OF BRIDGE DESIGN

Carl Kasper
 ENGINEER OF BRIDGES AND STRUCTURES


DATE - DECEMBER 2, 2019
REVISED -
REVISED -

STATE OF ILLINOIS
 DEPARTMENT OF TRANSPORTATION

CULVERT DETAILS
 STRUCTURE NO. 029-2501

SHEET 8 OF 14 SHEETS


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574	(12)CR	FULTON	202	56
CONTRACT NO. 68C64				
ILLINOIS FED. AID PROJECT				

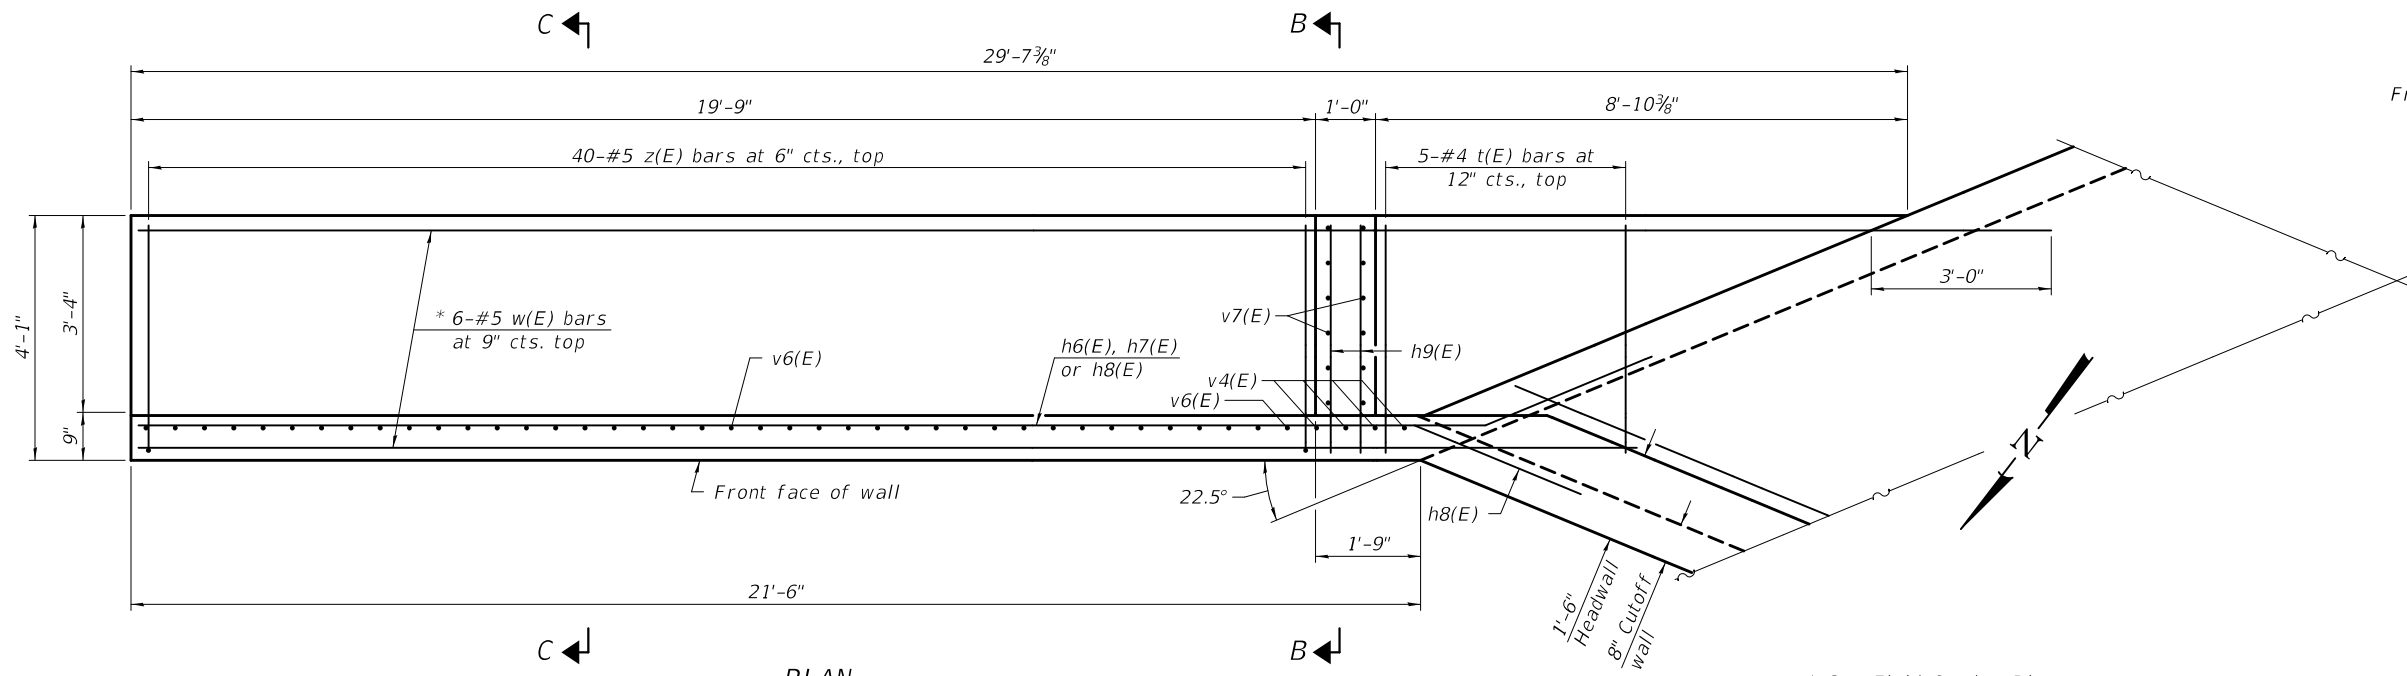


PLAN
(Northeast wingwall shown; Southwest wingwall similar by 180° rotation)

* See Field Cutting Diagram on sheet 11 of 14.


** See Field Cutting Diagram on sheet 11 of 14.

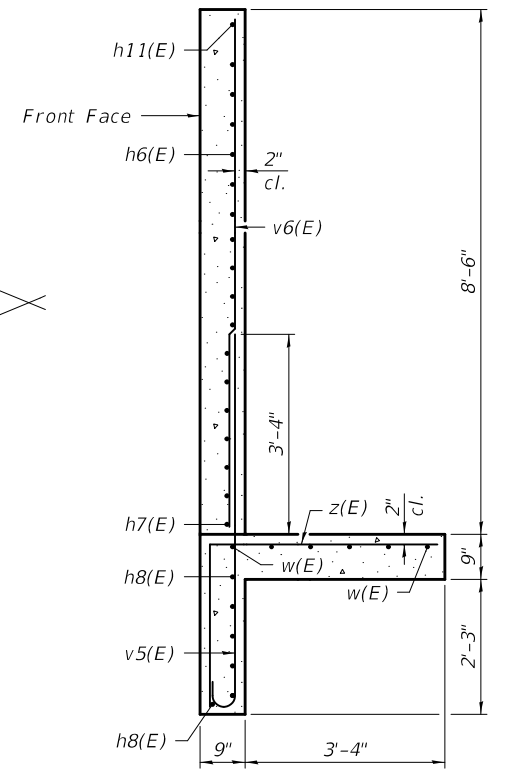

SECTION C-C

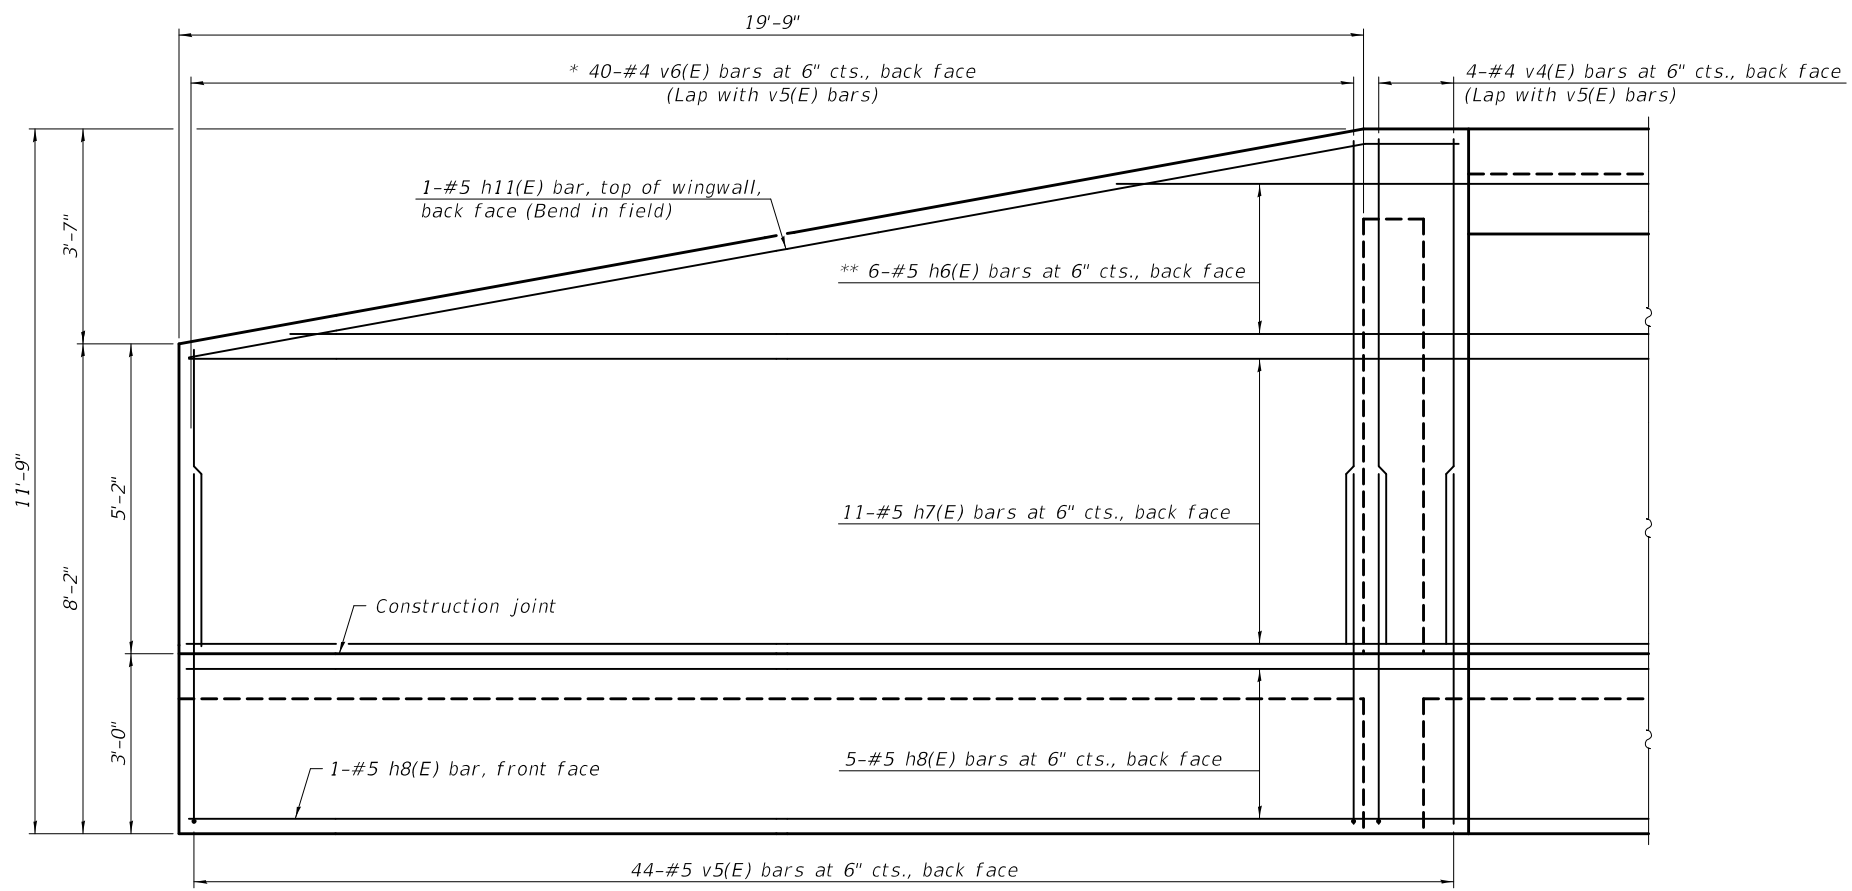

ELEVATION

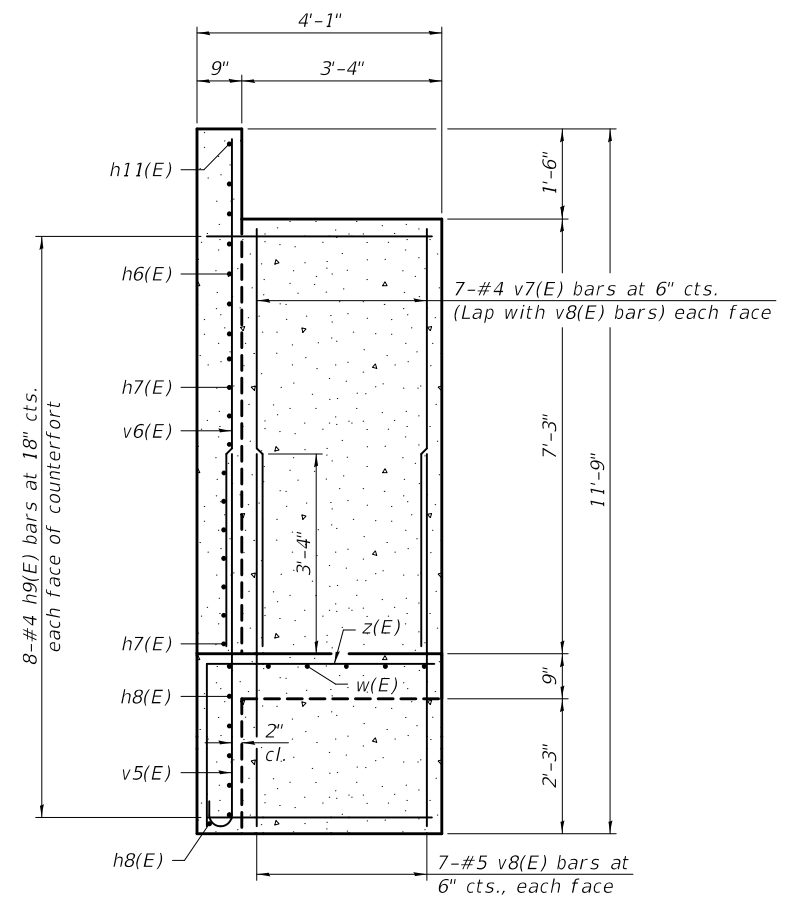

SECTION B-B

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DESIGNED - HAMEED S. SALIH	EXAMINED - <i>Joanne F. Salih</i>	DATE - DECEMBER 2, 2019
CHECKED - RAY AHANCHI	PASSED - <i>Carl Perry</i>	REVISOR -
DRAWN - DENNIS A. POP	ENGINEER OF BRIDGE DESIGN	REVISOR -
CHECKED - G.R.A. / H.S.S.	ENGINEER OF BRIDGES AND STRUCTURES	

**STATE OF ILLINOIS
DEPARTMENT OF TRANSPORTATION**


**L-TYPE TWO-WAY CANTILEVER WINGWALLS
STRUCTURE NO. 029-2501**

F.A.P. RTE. 574	SECTION (12)CR	COUNTY FULTON	TOTAL SHEETS 202	SHEET NO. 57
CONTRACT NO. 68C64				
ILLINOIS FED. AID PROJECT				


SHEET 9 OF 14 SHEETS

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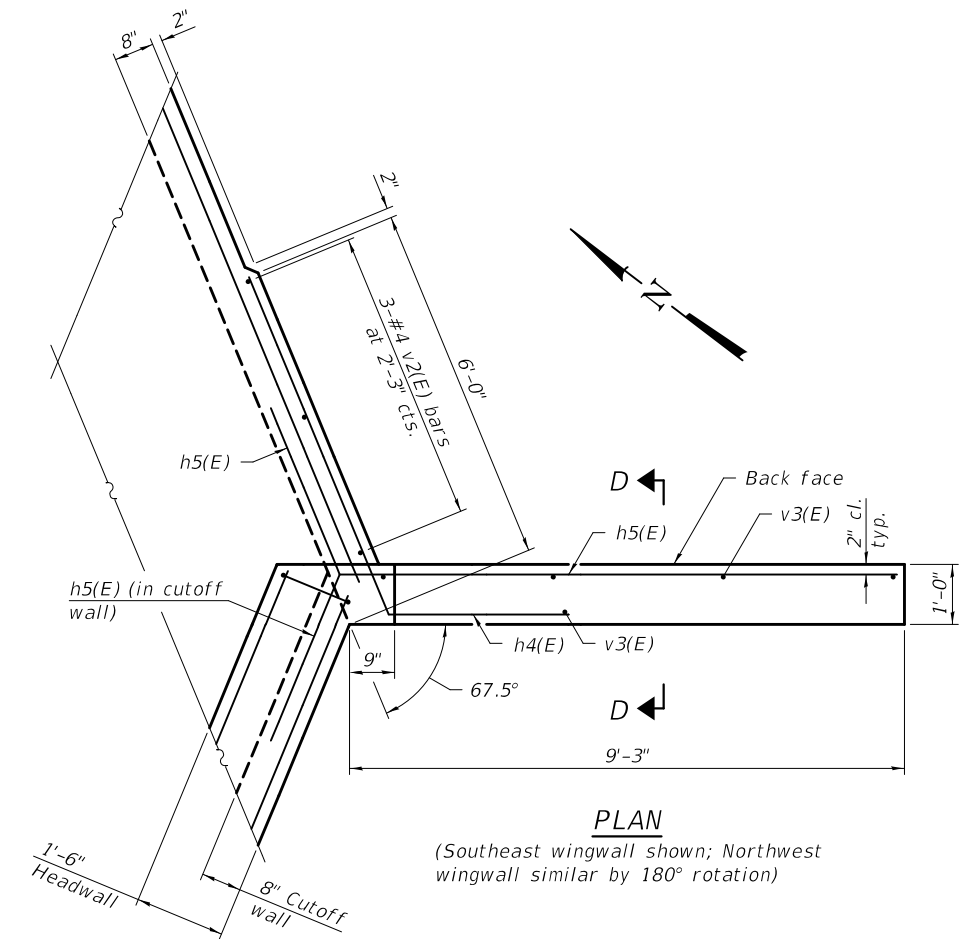
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ELEVATION

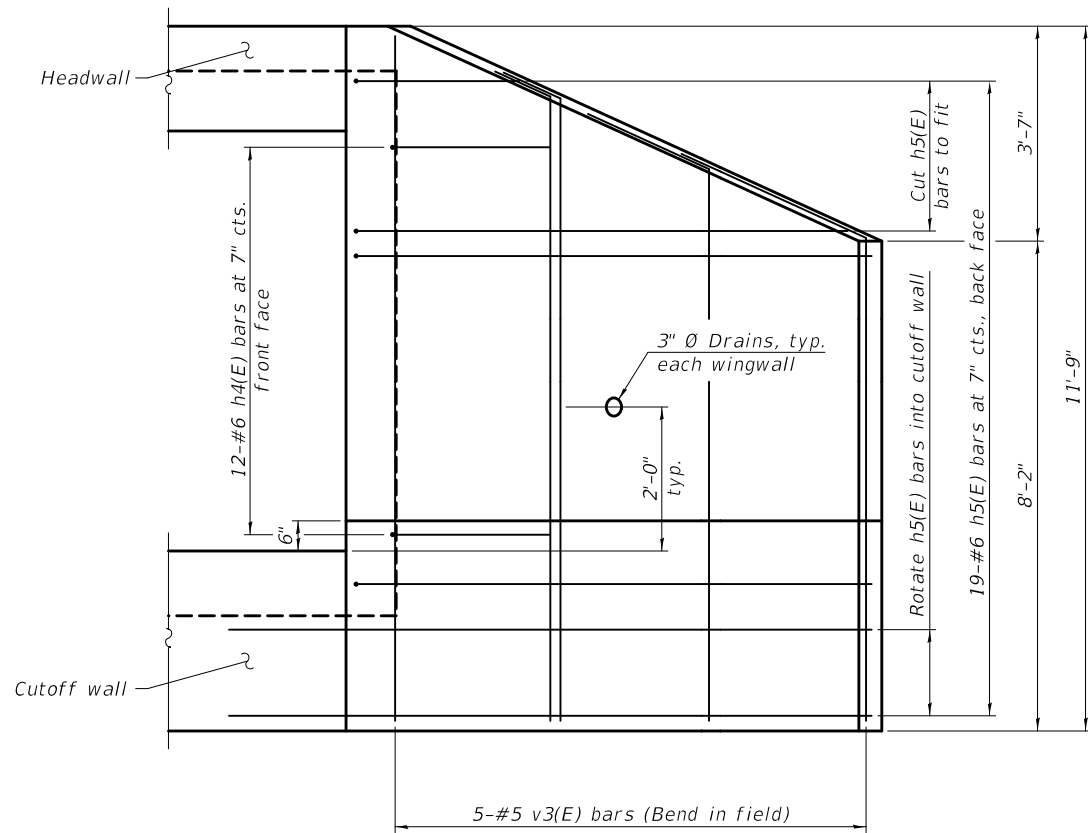

SECTION D-D

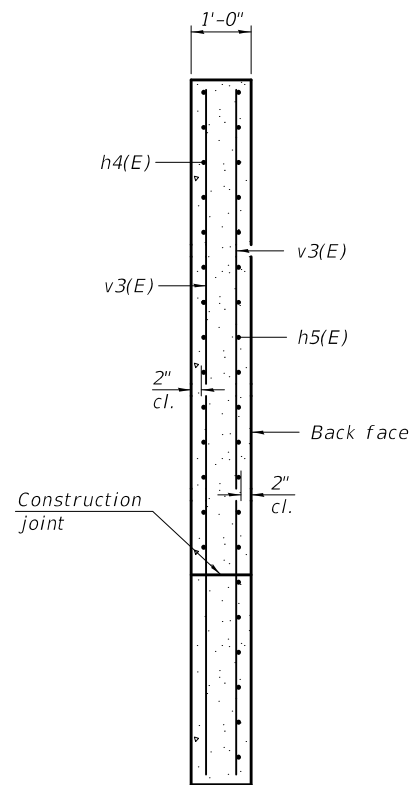

PLAN
 (Southeast wingwall shown; Northwest wingwall similar by 180° rotation)

DESIGNED -	HAMEED S. SALIH
CHECKED -	RAY AHANCHI
DRAWN -	DENNIS A. POP
CHECKED -	G.R.A. / H.S.S.

EXAMINED	<i>Jaime F. Salih</i> ENGINEER OF BRIDGE DESIGN
PASSED	<i>Carl Popper</i> ENGINEER OF BRIDGES AND STRUCTURES

DATE -	DECEMBER 2, 2019
REVISED -	
REVISED -	








**STATE OF ILLINOIS
 DEPARTMENT OF TRANSPORTATION**

**HORIZONTAL CANTILEVER WINGWALLS
 STRUCTURE NO. 029-2501**

SHEET 10 OF 14 SHEETS

F.A.P. RTE.	SECTION	COUNTY	TOTAL SHEETS	SHEET NO.
574	(12)CR	FULTON	202	58
CONTRACT NO. 68C64				
ILLINOIS FED. AID PROJECT				

MODEL: 0292501-68C64-011
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BILL OF MATERIAL

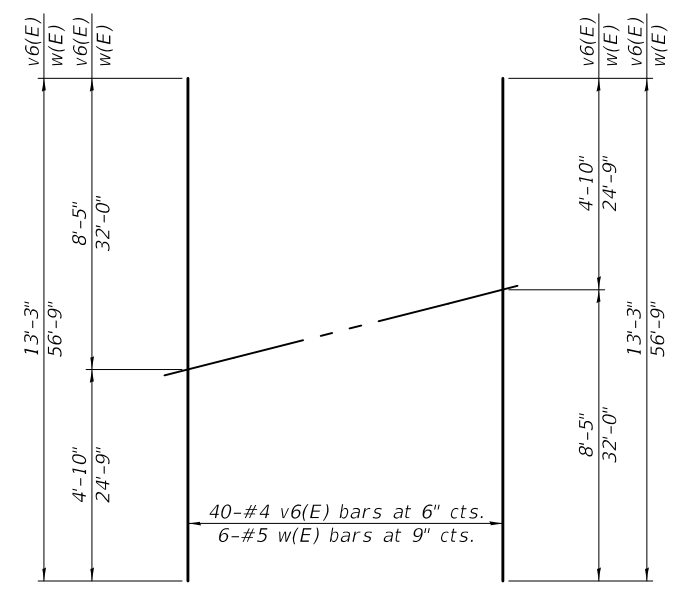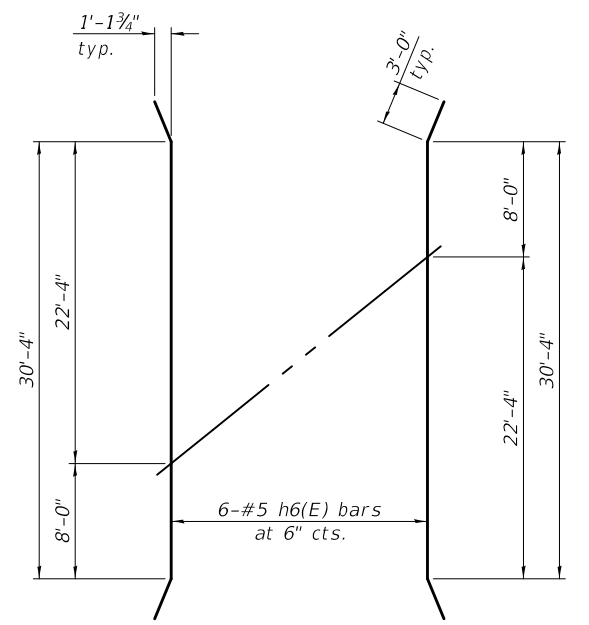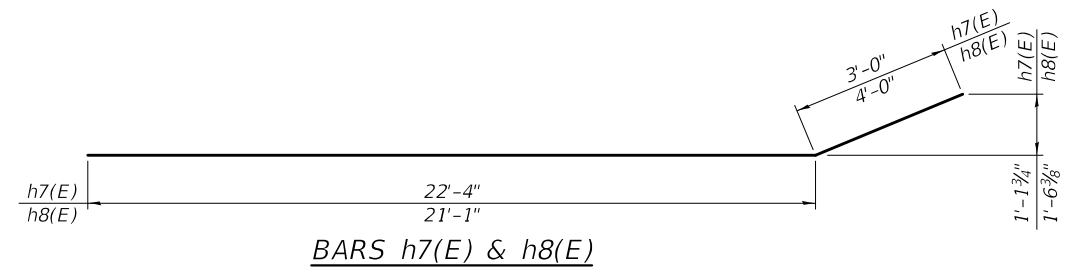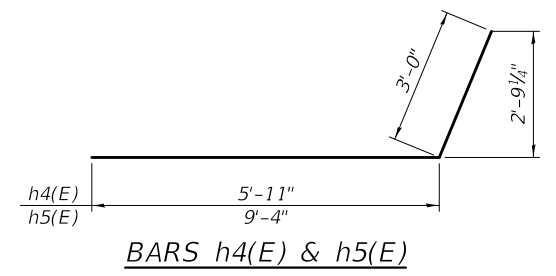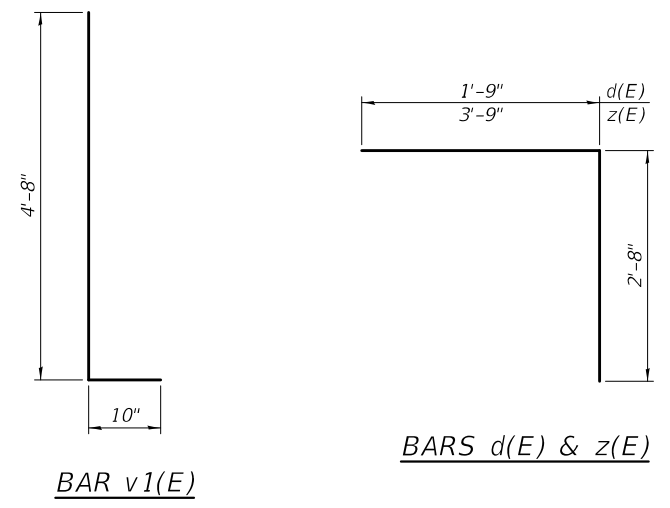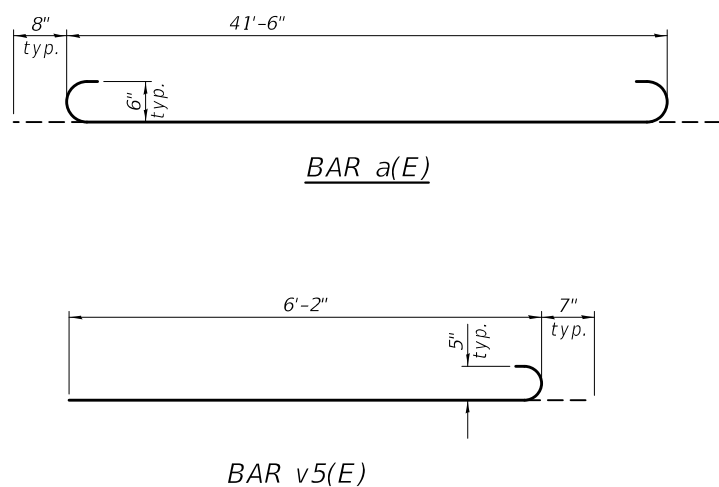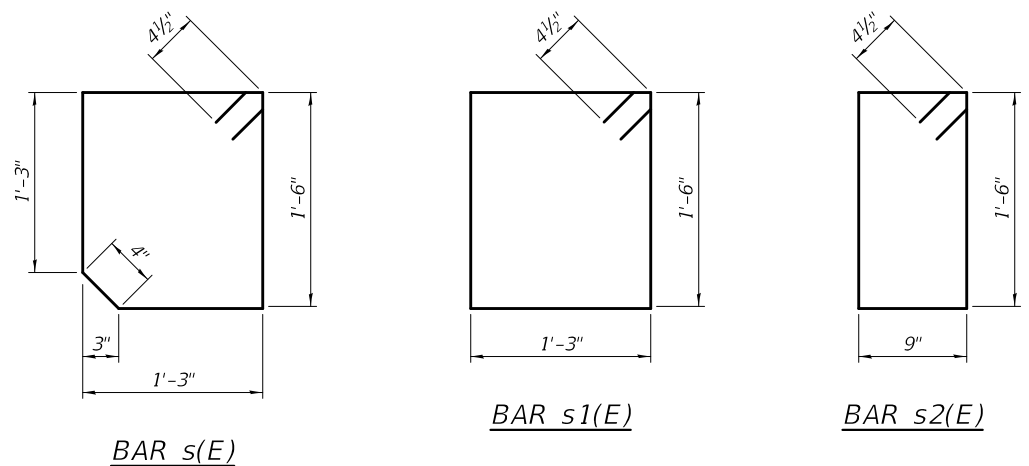Bar	No.	Size	Length	Shape
a(E)	308	#6	42'-10"	U
a1(E)	364	#6	41'-6"	—
d(E)	58	#4	4'-5"	L
h(E)	160	#5	36'-0"	—
h1(E)	160	#5	49'-9"	—
h2(E)	12	#7	41'-6"	—
h3(E)	12	#6	41'-6"	—
h4(E)	24	#6	8'-11"	L
h5(E)	38	#6	12'-4"	L
h6(E)	6	#5	36'-4"	—
h7(E)	22	#5	25'-4"	—
h8(E)	12	#5	25'-1"	—
h9(E)	32	#4	3'-9"	—
h10(E)	6	#5	41'-6"	—
h11(E)	2	#5	21'-6"	—
s(E)	43	#4	6'-1"	U
s1(E)	43	#4	6'-3"	U
s2(E)	86	#4	5'-3"	U
t(E)	10	#4	3'-9"	—
v(E)	464	#5	7'-2"	—
v1(E)	464	#5	5'-6"	L
v2(E)	6	#4	7'-8"	—
v3(E)	10	#5	11'-5"	—
v4(E)	8	#4	8'-6"	—
v5(E)	88	#5	6'-9"	—
v6(E)	40	#4	13'-3"	—
v7(E)	28	#4	7'-0"	—
v8(E)	28	#5	6'-2"	—
w(E)	6	#5	56'-9"	—
z(E)	80	#5	6'-5"	L
Concrete Box Culverts			Cu. Yd.	294.8
Reinforcement Bars, Epoxy Coated			Pound	70820

DESIGNED - HAMEED S. SALIH
 CHECKED - RAY AHANCHI
 DRAWN - DENNIS A. POP
 CHECKED - G.R.A. / H.S.S.

EXAMINED
 PASSED
 ENGINEER OF BRIDGES AND STRUCTURES


DATE - DECEMBER 2, 2019
 REVISED -
 REVISED -

STATE OF ILLINOIS
 DEPARTMENT OF TRANSPORTATION

CULVERT DETAILS
 STRUCTURE NO. 029-2501

SHEET 11 OF 14 SHEETS

F.A.P. RTE. SECTION COUNTY TOTAL SHEETS SHEET NO.
 574 (12)CR FULTON 202 59
 ILLINOIS FED. AID PROJECT CONTRACT NO. 68C64

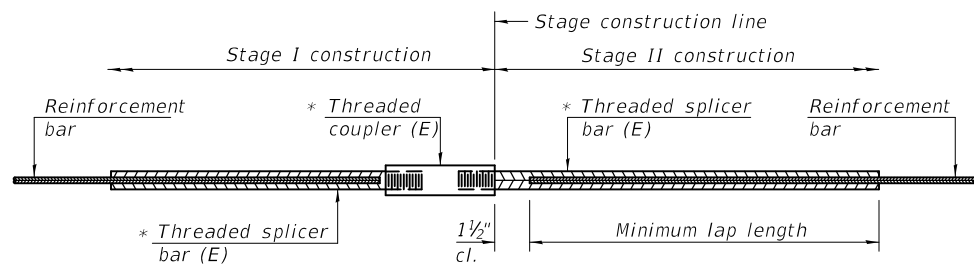


STANDARD BAR SPLICER ASSEMBLY

Threaded splicer bar length = min. lap length + 1 1/2" + thread length


* Epoxy not required on Bar Splicer Assembly components used in conjunction with black bars.

Location	Bar size	No. assemblies required	Minimum lap length
Top Slab	#5	60	3'-4"
Walls	#5	40	3'-7"
Bottom Slab	#5	60	3'-4"

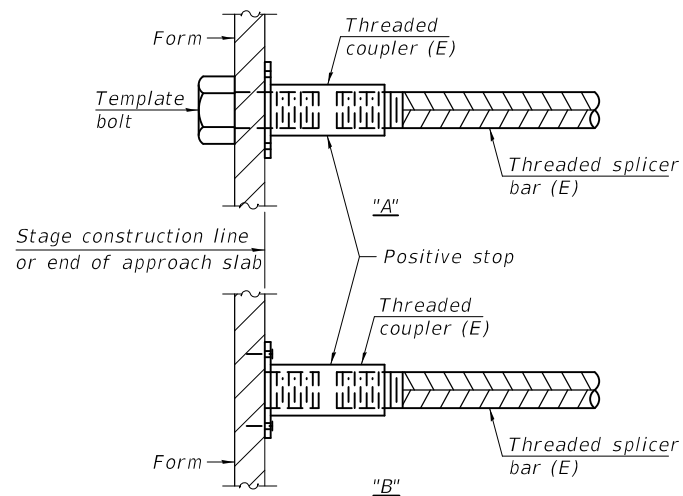


INSTALLATION AND SETTING METHODS

"A" : Set bar splicer assembly by means of a template bolt.
 "B" : Set bar splicer assembly by nailing to wood forms or cementing to steel forms.
 (E) : Indicates epoxy coating.

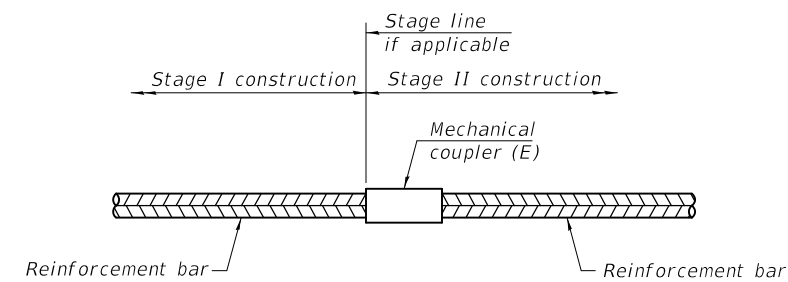

STANDARD MECHANICAL SPLICER

Location	Bar size	No. assemblies required

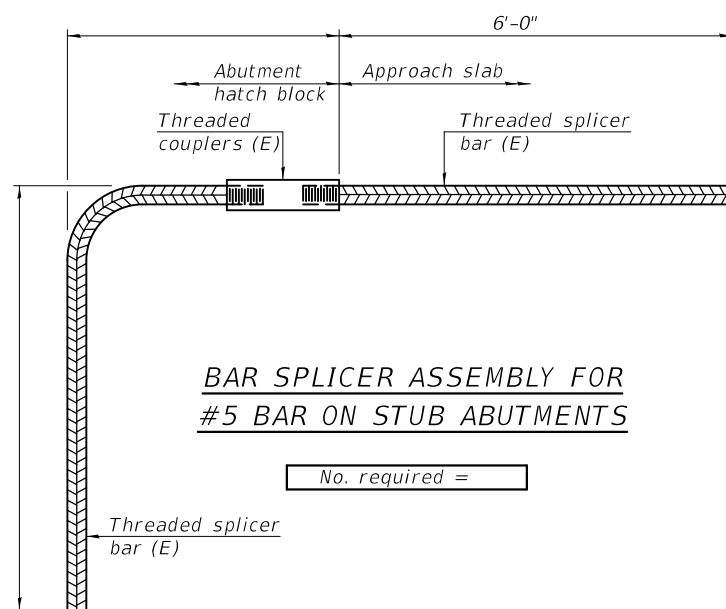

BAR SPLICER ASSEMBLY FOR #5 BAR ON STUB ABUTMENTS

No. required =

NOTES

Splicer bars shall be deformed with threaded ends and have a minimum 60 ksi yield strength.
 All reinforcement shall be lapped and tied to the splicer bars.
 Bar splicer assemblies shall be epoxy coated according to the requirements for reinforcement bars. See Section 508 of the Standard Specifications.
 See approved list of bar splicer assemblies and mechanical splicers for alternatives.

MODEL: 0292501-68C64-012
 FILE NAME: pw:\planroom-dot.illinois.gov\PW\DOT\Documents\DOT Offices\Bureau of Bridges and Structures\Projects\0292501-68C64.dgn

BSD-1

2-17-2017

DESIGNED - HAMEED S. SALIH	EXAMINED
CHECKED - RAY AHANCHI	PASSED
DRAWN - DENNIS A. POP	
CHECKED - G.R.A. / H.S.S.	

DATE - DECEMBER 2, 2019
 ENGINEER OF BRIDGE DESIGN
 ENGINEER OF BRIDGES AND STRUCTURES

REVISD -
REVISD -





STATE OF ILLINOIS
 DEPARTMENT OF TRANSPORTATION

BAR SPLICER ASSEMBLY AND MECHANICAL SPLICER DETAILS
 STRUCTURE NO. 029-2501

SHEET 12 OF 14 SHEETS

F.A.P. RTE.	SECTION	COUNTY	TOTAL SHEETS	SHEET NO.
574	(12)CR	FULTON	202	60
CONTRACT NO. 68C64				
ILLINOIS FED. AID PROJECT				

EXISTING CULVERT DETAIL

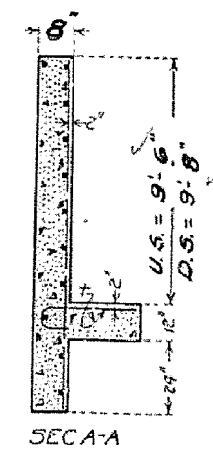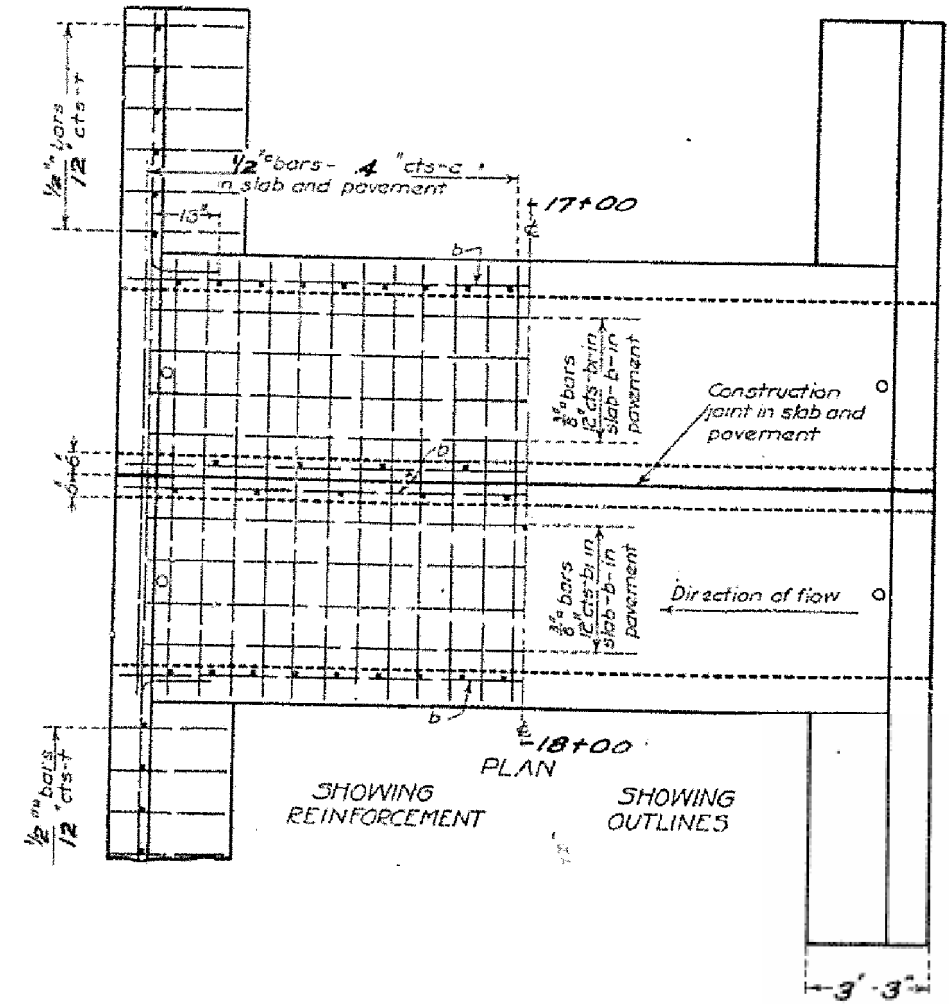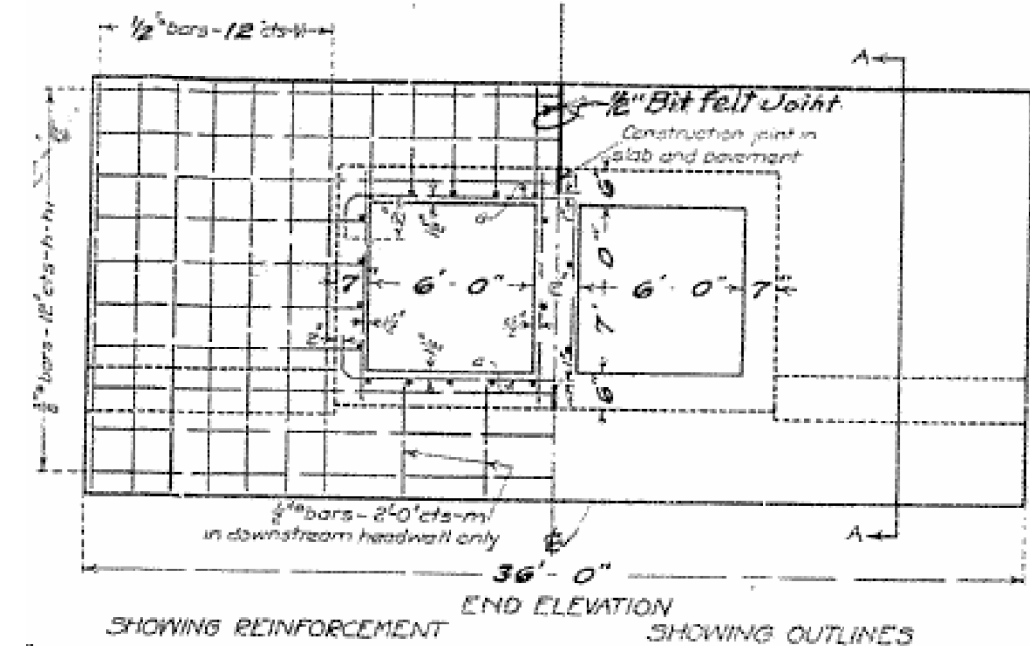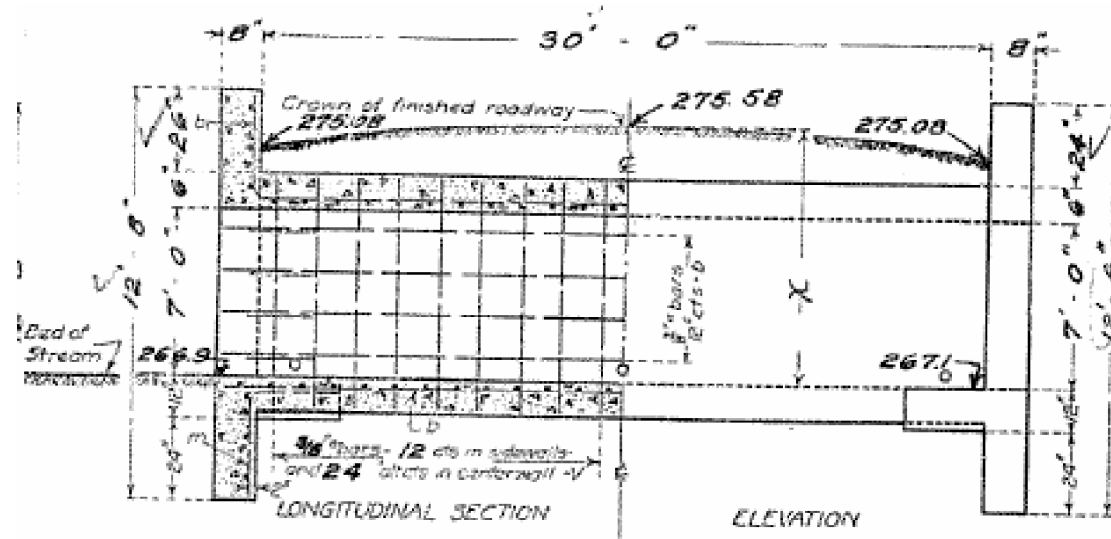

BILL OF MATERIAL


BARS	NO.	SIZE	LENGTH
v	90	3/8"	7'-9"
v	48	1/2"	12'-0"
h	24	3/8"	19'-0"
h	28	3/8"	12'-6"
a	188	1/2"	16'-0"
b	64	3/8"	16'-6"
b	28	3/8"	18'-6"
t	48	3/8"	5'-9"
m	7	1/2"	5'-0"
Reinforcing Steel-Lbs			4630
Concrete-Cu.Yd.			56.0

Class A Concrete to be used throughout Proportions-1 2 1/2 4

Sta. 17+61
State Bond Issue
Route 41
Section 11
Fulton County


FOR INFORMATION ONLY

CULVERT DETAIL

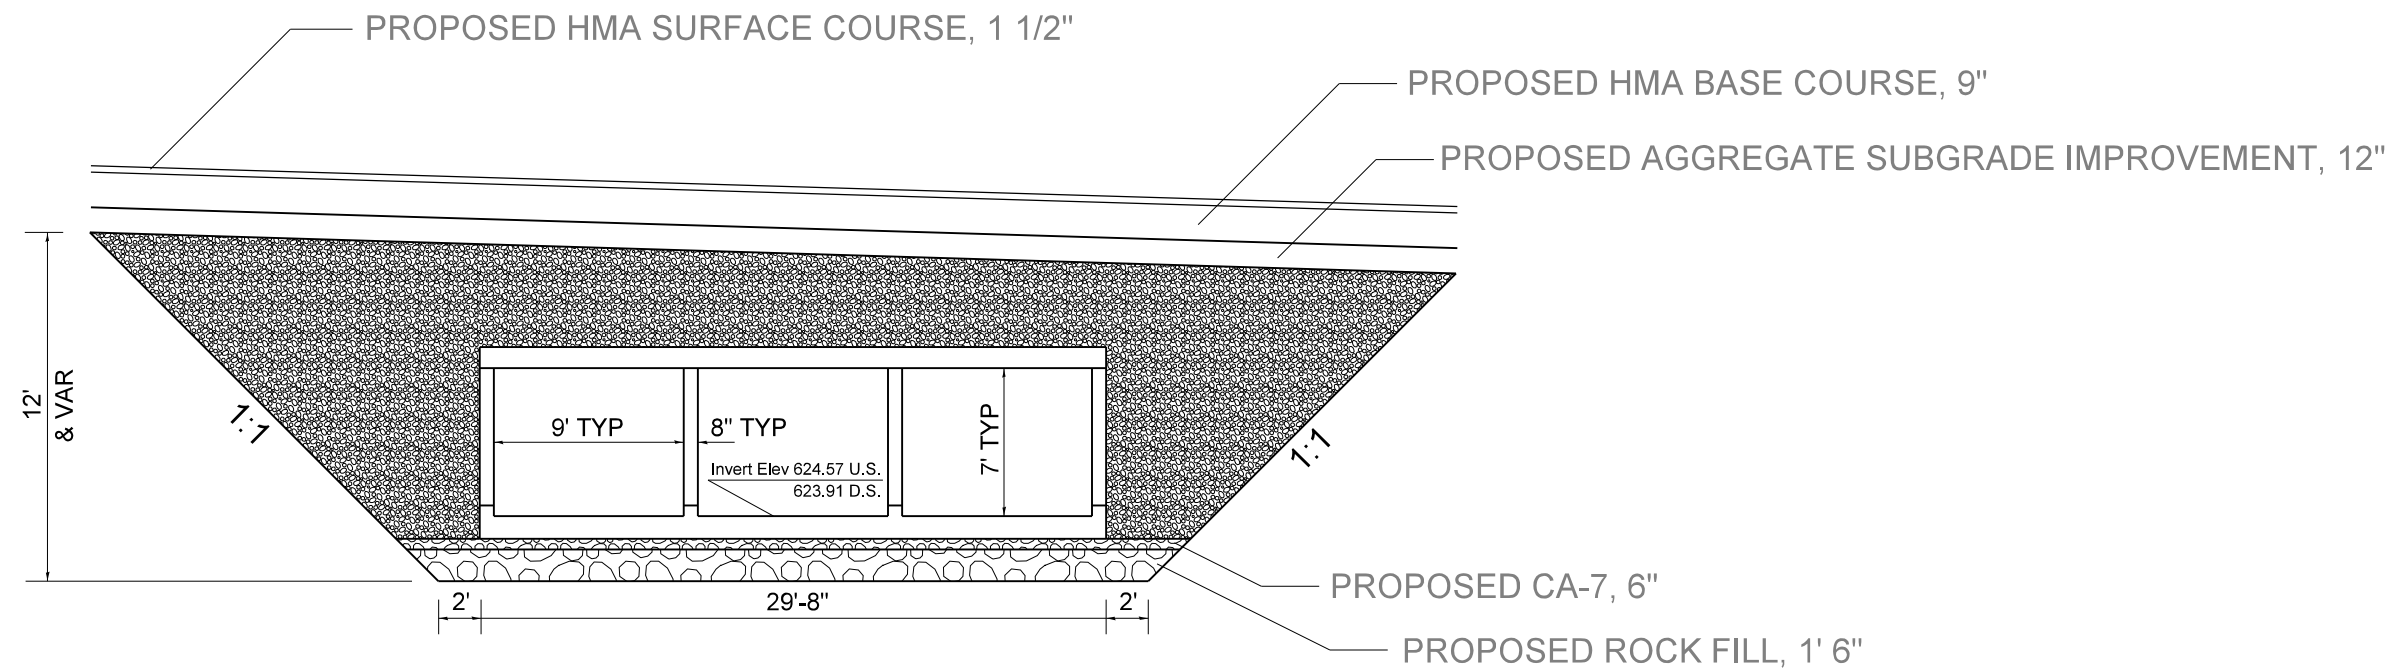

SECTION THRU THE CULVERT

 POROUS GRANULAR EMBANKMENT
(CA-7 or CA-11 capped with 1" thick CA-10)

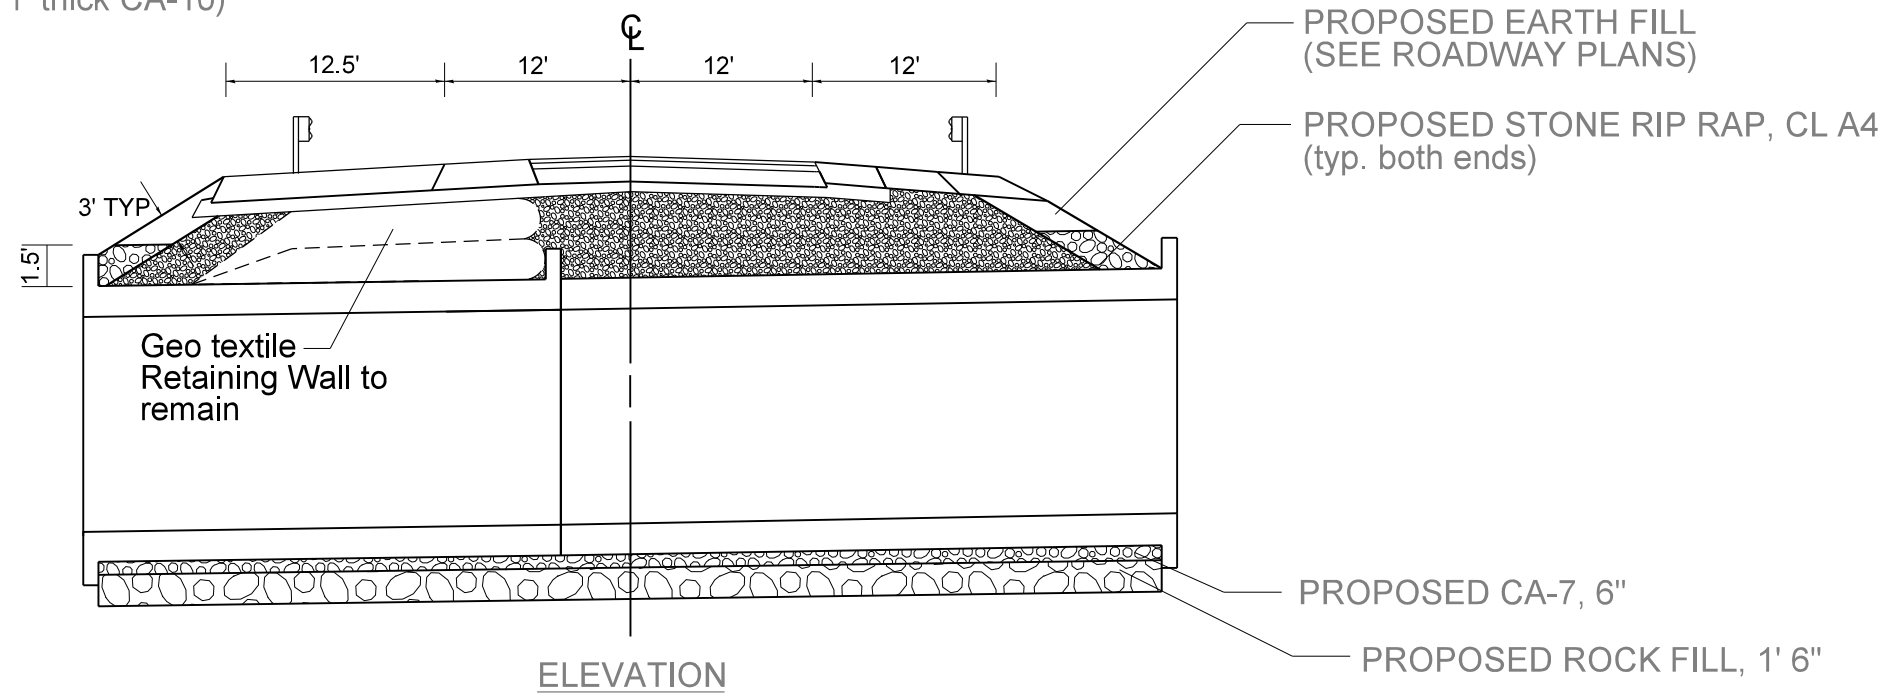

ELEVATION

Not to Scale



STATE OF ILLINOIS
DEPARTMENT OF TRANSPORTATION

NOT TO SCALE

CULVERT BACKFILL DETAIL

F.A.P. RTE.	SECTION	COUNTY	TOTAL SHEETS	SHEET NO.
574	(12)CR	•	202	64
FED. ROAD DIST. NO.			ILLINOIS FED. AID PROJECT	
			CONTRACT NO. 68C64	

FULTON / McDONOUGH

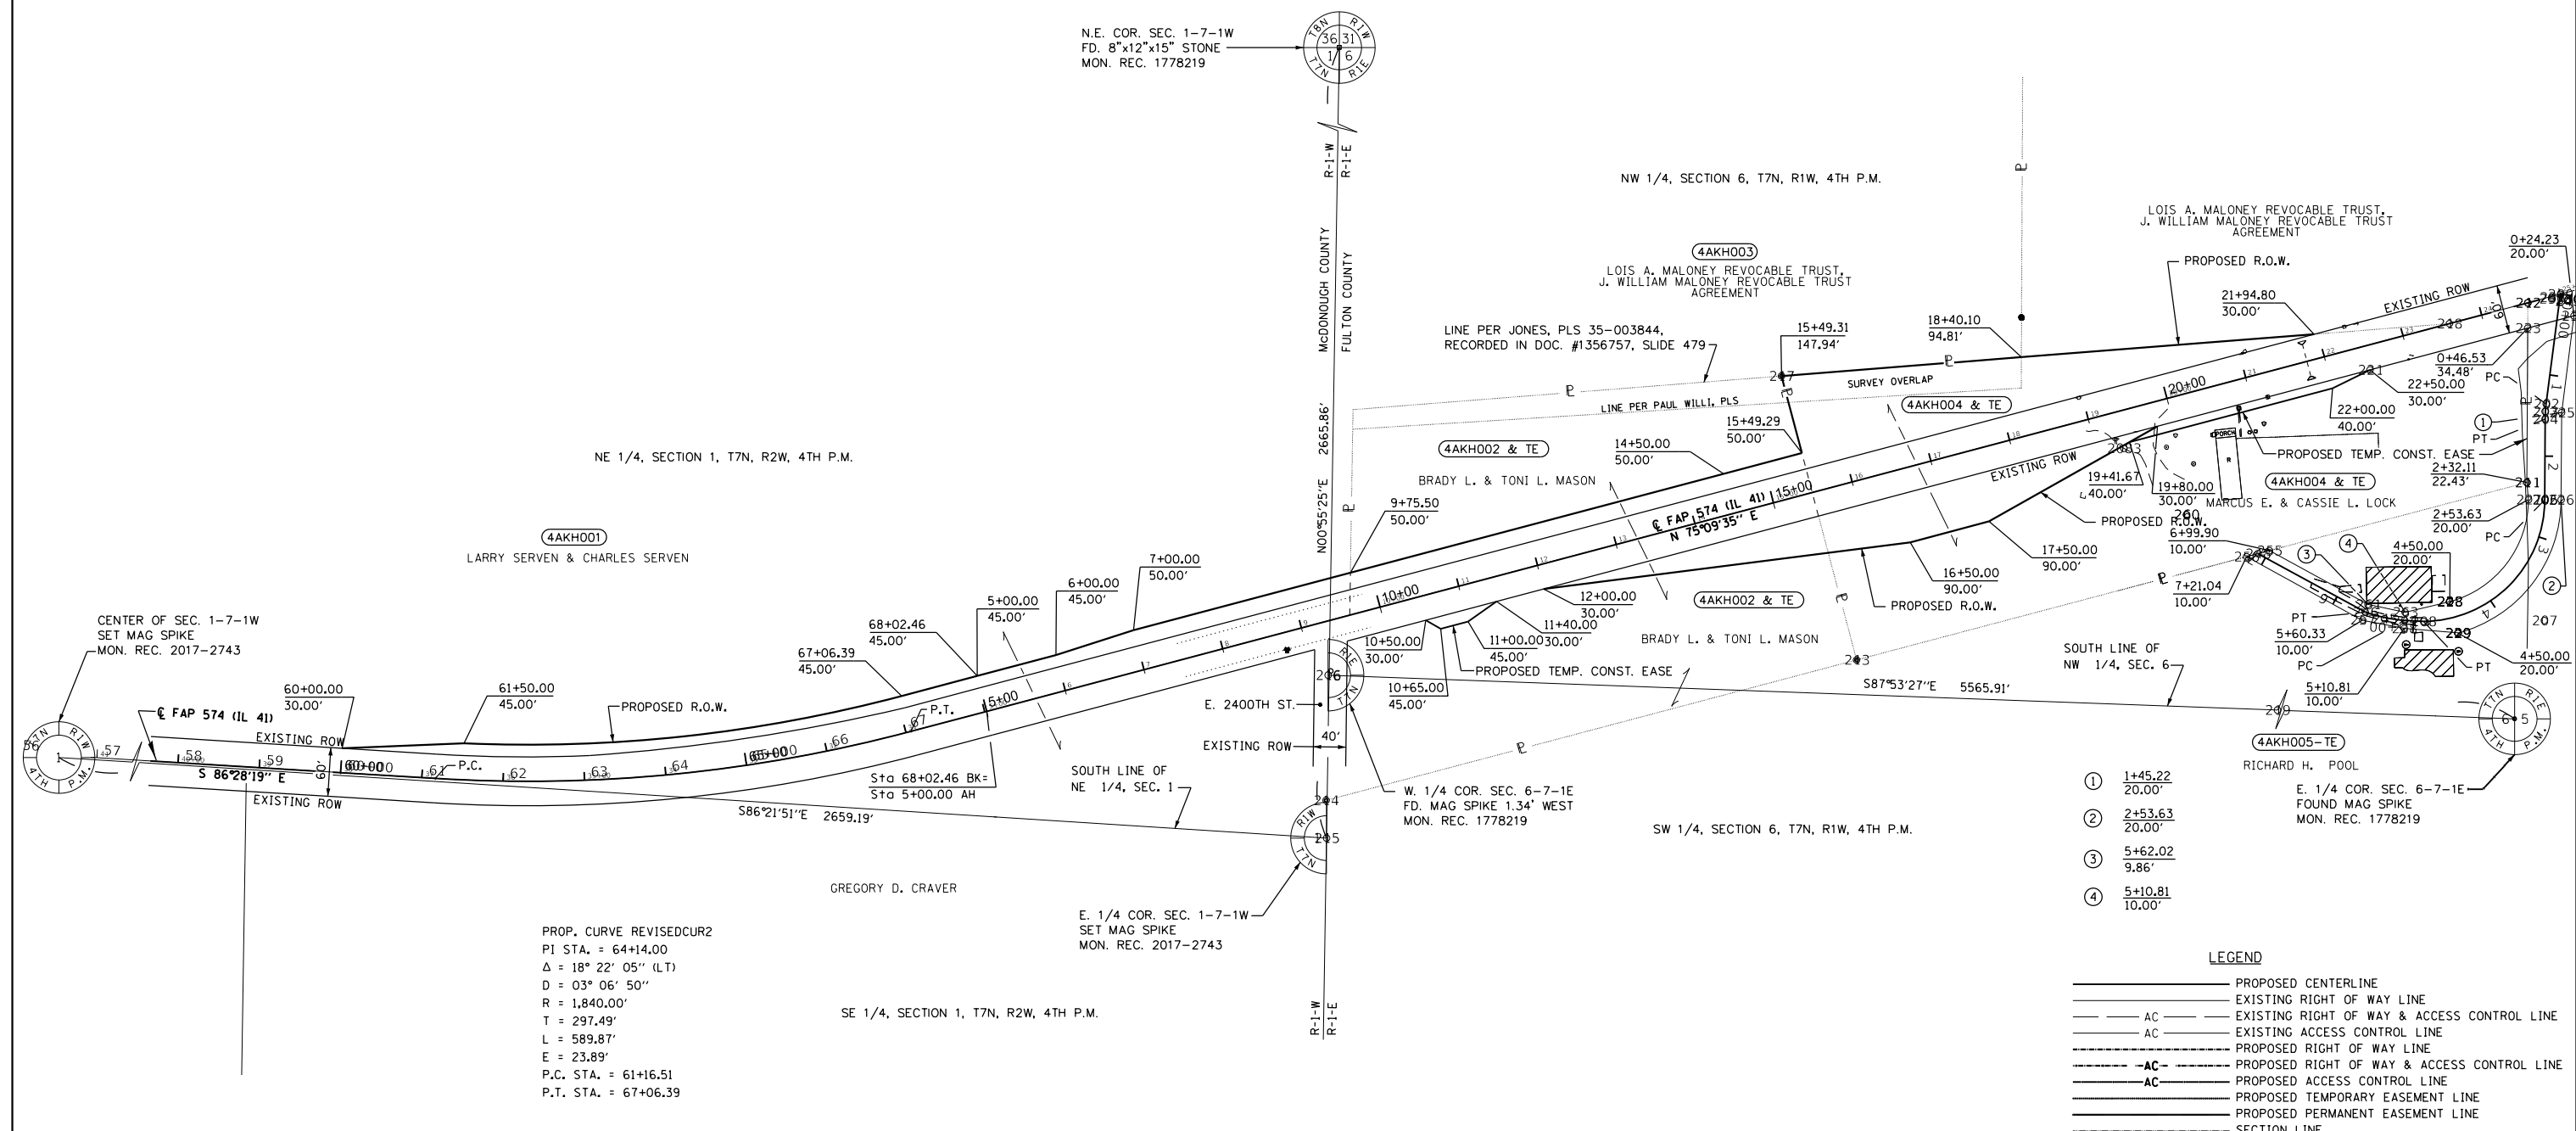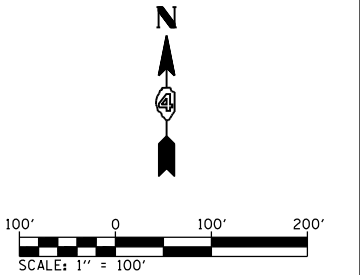

PROP. CURVE REVISED CUR2
 PI STA. = 64+14.00
 $\Delta = 18^\circ 22' 05''$ (LT)
 $D = 03^\circ 06' 50''$
 $R = 1,840.00'$
 $T = 297.49'$
 $L = 589.87'$
 $E = 23.89'$
 P.C. STA. = 61+16.51
 P.T. STA. = 67+06.39

PROP. ENT CURV1 PI STA. = 1+45.22 $\Delta = 7^\circ 09' 57''$ (LT) $D = 38^\circ 11' 45''$ $R = 150.01'$ $T = 9.39'$ $L = 18.76'$ $E = 0.29'$ P.C. STA. = 1+35.82 P.T. STA. = 1+54.58	PROP. ENT CURV2 PI STA. = 4+01.98 $\Delta = 89^\circ 21' 59''$ (RT) $D = 38^\circ 11' 50''$ $R = 150.00'$ $T = 148.35'$ $L = 233.96'$ $E = 60.97'$ P.C. STA. = 2+53.63 P.T. STA. = 4+87.59	PROP. ENT CURV6 PI STA. = 5+35.70 $\Delta = 14^\circ 16' 51''$ (RT) $D = 28^\circ 49' 56''$ $R = 198.72'$ $T = 24.89'$ $L = 49.53'$ $E = 1.55'$ P.C. STA. = 5+10.81 P.T. STA. = 5+60.34
--	---	--

- ① 1+45.22
20.00'
- ② 2+53.63
20.00'
- ③ 5+62.02
9.86'
- ④ 5+10.81
10.00'

LEGEND


—————	PROPOSED CENTERLINE
—————	EXISTING RIGHT OF WAY LINE
—————	EXISTING RIGHT OF WAY & ACCESS CONTROL LINE
—————	EXISTING ACCESS CONTROL LINE
—————	PROPOSED RIGHT OF WAY LINE
—————	PROPOSED RIGHT OF WAY & ACCESS CONTROL LINE
—————	PROPOSED ACCESS CONTROL LINE
—————	PROPOSED TEMPORARY EASEMENT LINE
—————	PROPOSED PERMANENT EASEMENT LINE
—————	SECTION LINE
—————	QUARTER SECTION LINE
—————	PROPERTY LINE

FOR OLD ROW SEE:
 PLAN FILE 11 SHEETS 16&17

11 56

PLAT FILE 518

FILE NAME: D468C64-sht-details.dgn	USER NAME = everscl	DESIGNED - KEF	REVISED -	STATE OF ILLINOIS DEPARTMENT OF TRANSPORTATION	RIGHT OF WAY PLANS		F.A.P. R.T.E. 574	SECTION (12) CR	COUNTY McDONOUGH FULTON	TOTAL SHEETS 202	SHEET NO. 65
	PLOT SCALE = 200.0000' / in.	CHECKED - CSB	REVISED -		PROJECT SHEET NO. 1 OF 1 SHEETS	JOB NO. R-94-009-16	CAT.# 035274-00	CONTRACT NO. 68C64		FED. ROAD DIST. NO.	ILLINOIS FED. AID PROJECT
PLOT DATE = 10/17/2019	DATE - 02/2018	REVISED -	REVISED -	SCALE: 1" = 100'	STA. 60+50.00 TO STA. 25+00.00						

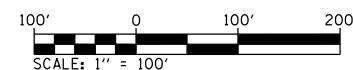

BEARINGS ARE BASED ON STATE PLANE
COORDINATE SYSTEM NAD 88 (2011) IL
WEST ZONE, COMBINED FACTOR OF 0.999920.

PROP. ENT CURV1
PI STA. = 1+45.22
Δ = 7° 09' 57" (LT)
D = 38° 11' 45"
R = 150.01'
T = 9.39'
L = 18.76'
E = 0.29'
P.C. STA. = 1+35.82
P.T. STA. = 1+54.58

PROP. ENT CURV2
PI STA. = 4+01.98
Δ = 89° 21' 59" (RT)
D = 38° 11' 50"
R = 150.00'
T = 148.35'
L = 233.96'
E = 60.97'
P.C. STA. = 2+53.63
P.T. STA. = 4+87.59

PROP. ENT CURV6
PI STA. = 5+35.70
Δ = 14° 16' 51" (RT)
D = 28° 49' 56"
R = 198.72'
T = 24.89'
L = 49.53'
E = 1.55'
P.C. STA. = 5+10.81
P.T. STA. = 5+60.34


FAP 574 (IL 41) STA 25+00.00=
TEMPORARY ENTRANCE STA 0+00.00
DEFLECTION ANGLE 67°45'00"

P.O.C.
NE CORNER OF
TRACT 5 AS SHOWN
IN DOCUMENT NUMBER
1356757 IN FULTON COUNTY
RECORDER'S OFFICE

LEGEND:

- FOUND IRON PIN/PIPE
- 5/8" IRON PIN W/ CAP
- ▬ PROPERTY LINE
- () RECORD DISTANCE

- Ⓐ 5+10.81
10.00'
- Ⓑ 5+60.33
10.00'

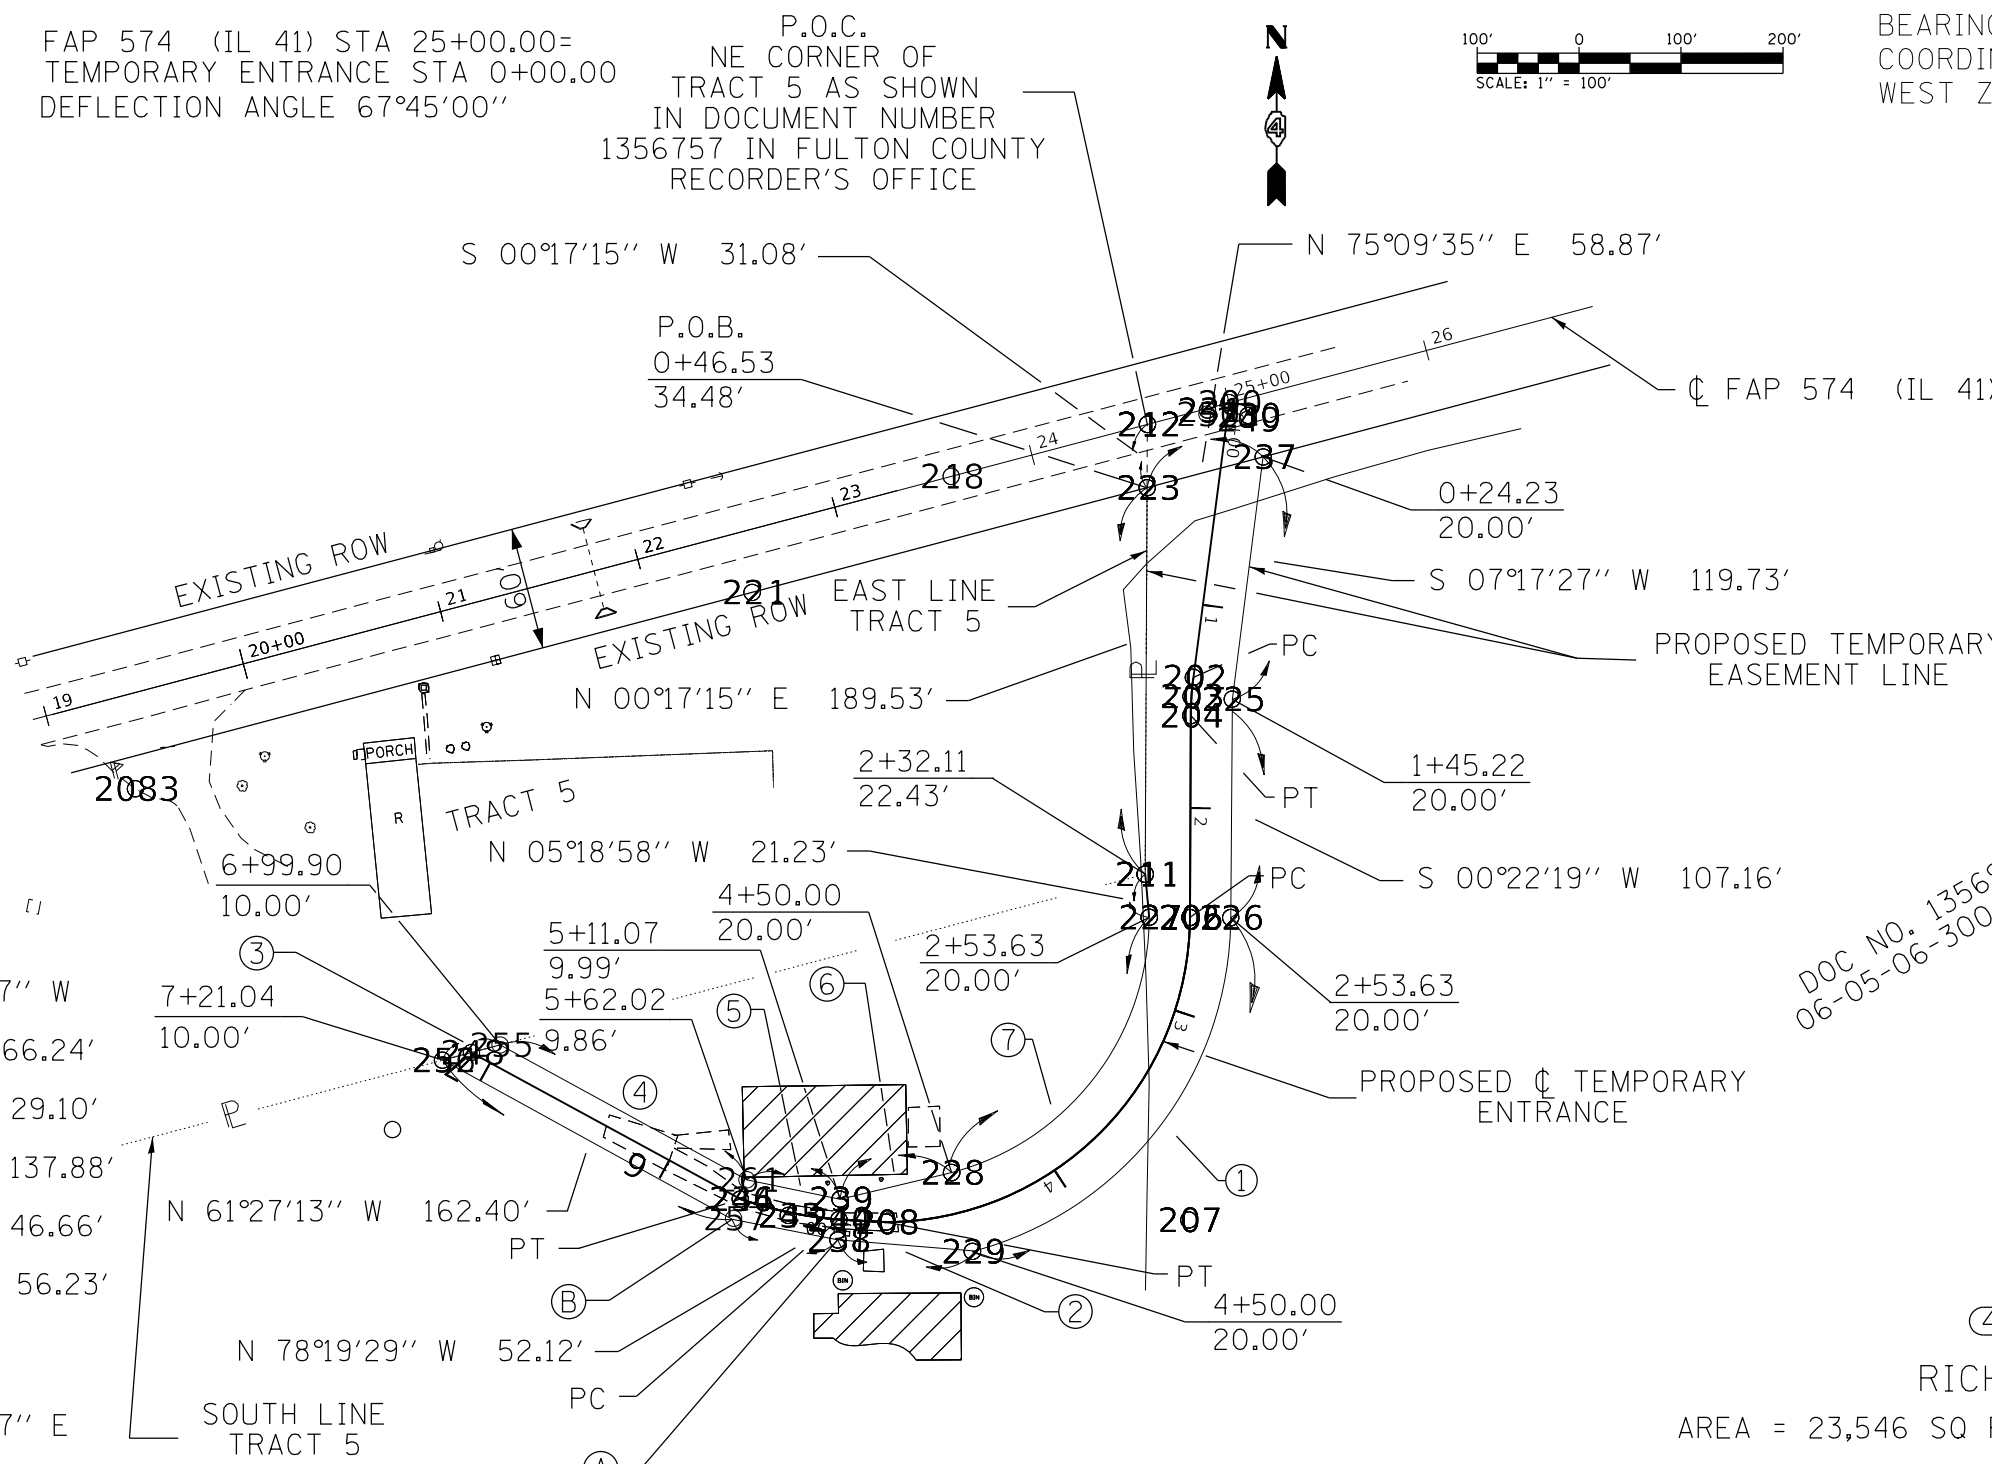

DOC No. 135690
06-05-06-300-002

4AKH005-TE

RICHARD H. POOL

AREA = 23,546 SQ FT +/-, OR 0.541 ACRES, +/-
A PART OF THE NORTHWEST QUARTER OF SECTION 06,
TOWNSHIP 07 NORTH, RANGE 01 EAST OF THE 4TH P.M.

FULTON COUNTY

TEMPORARY EASEMENT PLAT

FAP RTE. 574 (IL 41)
SHEET 1 OF 1
SCALE: 1" = 100'
SEPTEMBER 04, 2018

CONSTRUCTION SECTION: (12)CR
JOB NO. R-94-009-16
CATALOG NO. 035274-00

- ① R= 170.00'
L= 222.52'
LC= 207.00'
BRG= S 37°44'27" W
- ② N 85°04'22" W 66.24'
- ③ N 75°10'33" E 29.10'
- ④ S 61°20'34" E 137.88'
- ⑤ S 78°14'45" E 46.66'
- ⑥ N 76°36'38" E 56.23'
- ⑦ R= 130.00'
L= 170.19'
LC= 158.29'
BRG= N 37°44'27" E

THIS IS TO CERTIFY THAT THIS IS A TRUE AND CORRECT PLAT OF
SURVEY MADE UNDER MY DIRECTION FOR THE ILLINOIS DEPARTMENT
OF TRANSPORTATION. THIS PROFESSIONAL SERVICE CONFORMS TO THE
CURRENT ILLINOIS MINIMUM STANDARDS FOR A BOUNDARY SURVEY.

PAUL C. FIELDS - ILLINOIS PROFESSIONAL
LAND SURVEYOR NUMBER 35-3548
MY LICENSE EXPIRES 11/30/2018


REVISED:

BY	DATE				
	COMPUTED	CHECKED	INKED	INK CHECKED	
R.O.W. PLAT	NOTE BOOK	NO.			
CAD DRAWING: D368300-sh+parcel001a.dgn PROJECT: FILE:					

CONTRACT NO: 68C64

SLOPE STEPS DETAIL


TYPICAL CROSS-SECTION EMBANKMENT CONSTRUCTION ON SIDEHILL

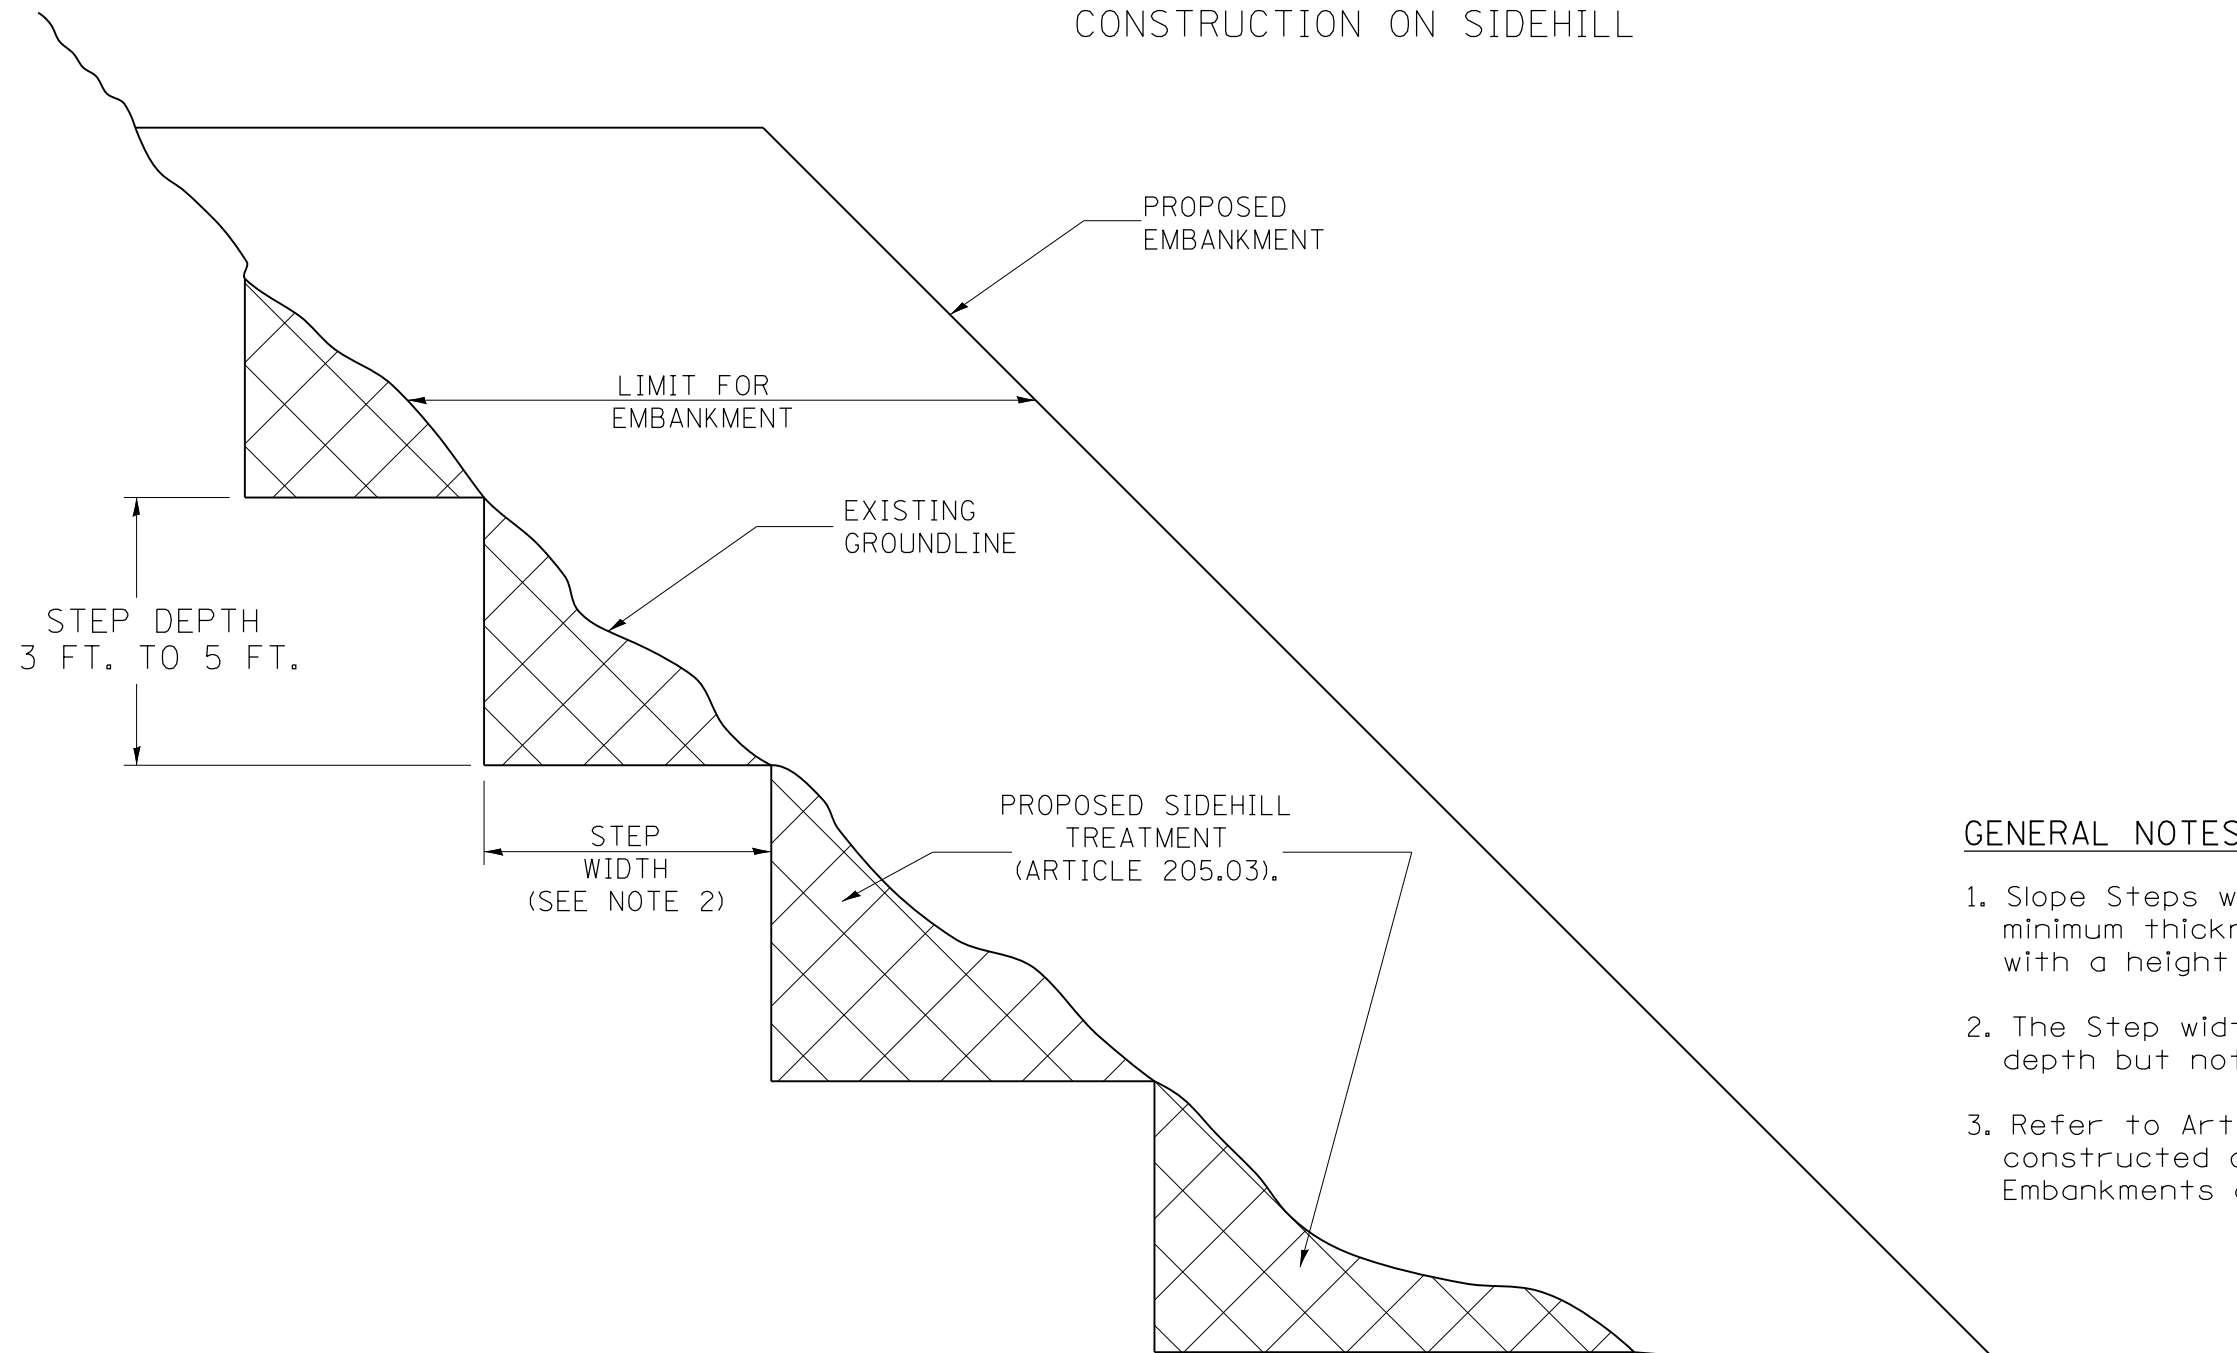

GENERAL NOTES:

1. Slope Steps will be required for all 12(300) minimum thickness "sliver fills" and on all fills with a height of 10 feet or greater.
2. The Step width shall be twice the Step depth but not less than 6 feet.
3. Refer to Article 205.03 for Embankment to be constructed on Hillside or Slopes, or if existing Embankments are to be widened.

REPLACEMENT MATERIAL:

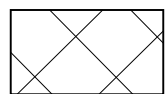

STANDARD EMBANKMENT
(IN ACCORDANCE WITH
205 OF THE STANDARD SPECIFICATION).

All dimensions are in inches (millimeters) unless otherwise noted.

1-1-97	RENUM. L-5.03, NEW REVISION BOX, REVISED TITLE BOX, REVISED GENERAL NOTES.	T.P.		
10-16-06	REVISED TO 2007 SPEC.	M.A.		
5-30-18	MINOR CORRECTION	R.D.		

**STATE OF ILLINOIS
DEPARTMENT OF TRANSPORTATION**


SLOPE STEPS DETAIL

NOT TO SCALE

CADD STD. 205001-D4

F.A.P. RTE.	SECTION	COUNTY	TOTAL SHEETS	SHEET NO.
574	(12)CR	•	202	67
FED. ROAD DIST. NO. ILLINOIS FED. AID PROJECT			CONTRACT NO. 68C64	


**CASE 1
(DITCH)**

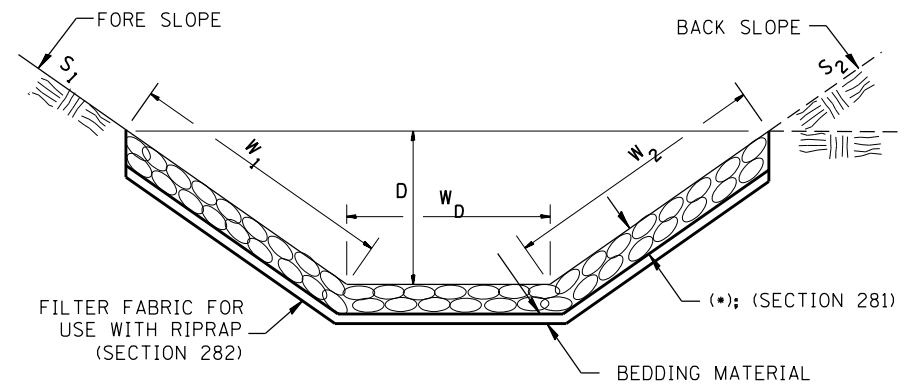

(*)				
LOCATION	WIDTH (1)	LENGTH	RIPRAP	FABRIC
STA TO STA	lin ft (m)	lin ft (m)	tons (m tons)	sq yds (m ²)
TOTAL				

(1) WIDTH = $W_1 + W_2 + W_D$


**CASE 2
(CULVERT & SLOPE)**

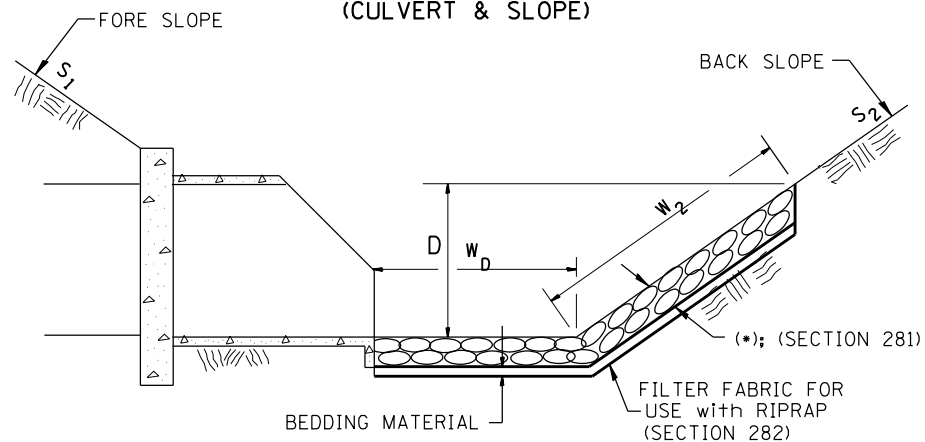

(*)				
LOCATION	WIDTH (1)	LENGTH	RIPRAP	FABRIC
STA TO STA	lin ft (m)	lin ft (m)	tons (m tons)	sq yds (m ²)
TOTAL				

(1) WIDTH = $W_2 + W_D$

**CASE 3
(CULVERT)**

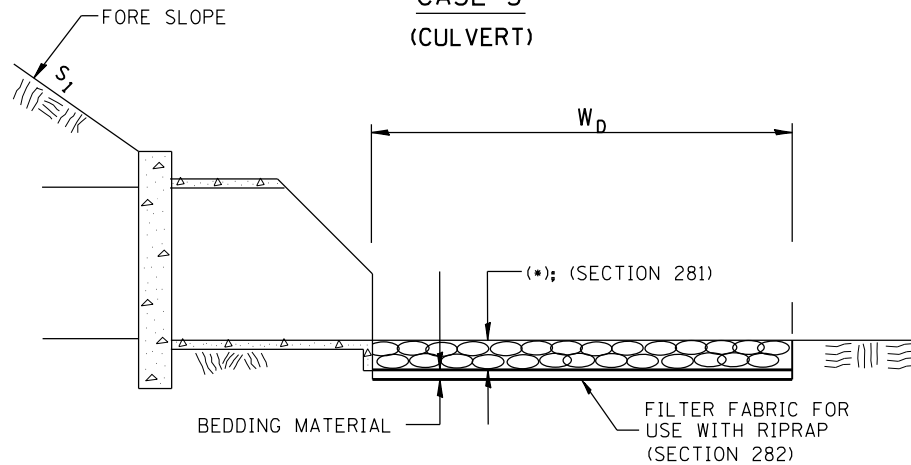

(*)				
LOCATION	WIDTH (1)	LENGTH	RIPRAP	FABRIC
STA TO STA	lin ft (m)	lin ft (m)	sq yds (m ²)	sq yds (m ²)
Lt. Sta. 17+50 to 19+00	64	150	661.1	661.1
Rt. Sta. 16+40 to 18+00	60	160	645.0	645.0
TOTAL			1306.1	1306.1

(1) WIDTH = W_D

All slope ratios are expressed as units of vertical displacement to units of horizontal displacement (V:H).

All dimensions are in inches (millimeters) unless otherwise noted.

1-1-97	RENUM. A-12.02, NEW REVISION BOX	T.P.
12-1-97	CORRECT FILTER FABRIC LEADER ARROW	J.A.
10-16-06	REVISED TO 2007 SPEC.	M.A.
9-6-12	REMOVED A DESIGNER NOTE AND MADE MINOR CHANGES	R.D.


**STATE OF ILLINOIS
DEPARTMENT OF TRANSPORTATION**

RIPRAP DITCH FOR EROSION PROTECTION

NOT TO SCALE

CADD STD. 281001-D4

F.A.P. RTE.	SECTION	COUNTY	TOTAL SHEETS	SHEET NO.
574	(12)CR	FULTON	202	68
CONTRACT NO.			68C64	
FED. ROAD DIST. NO.	ILLINOIS FED. AID PROJECT			

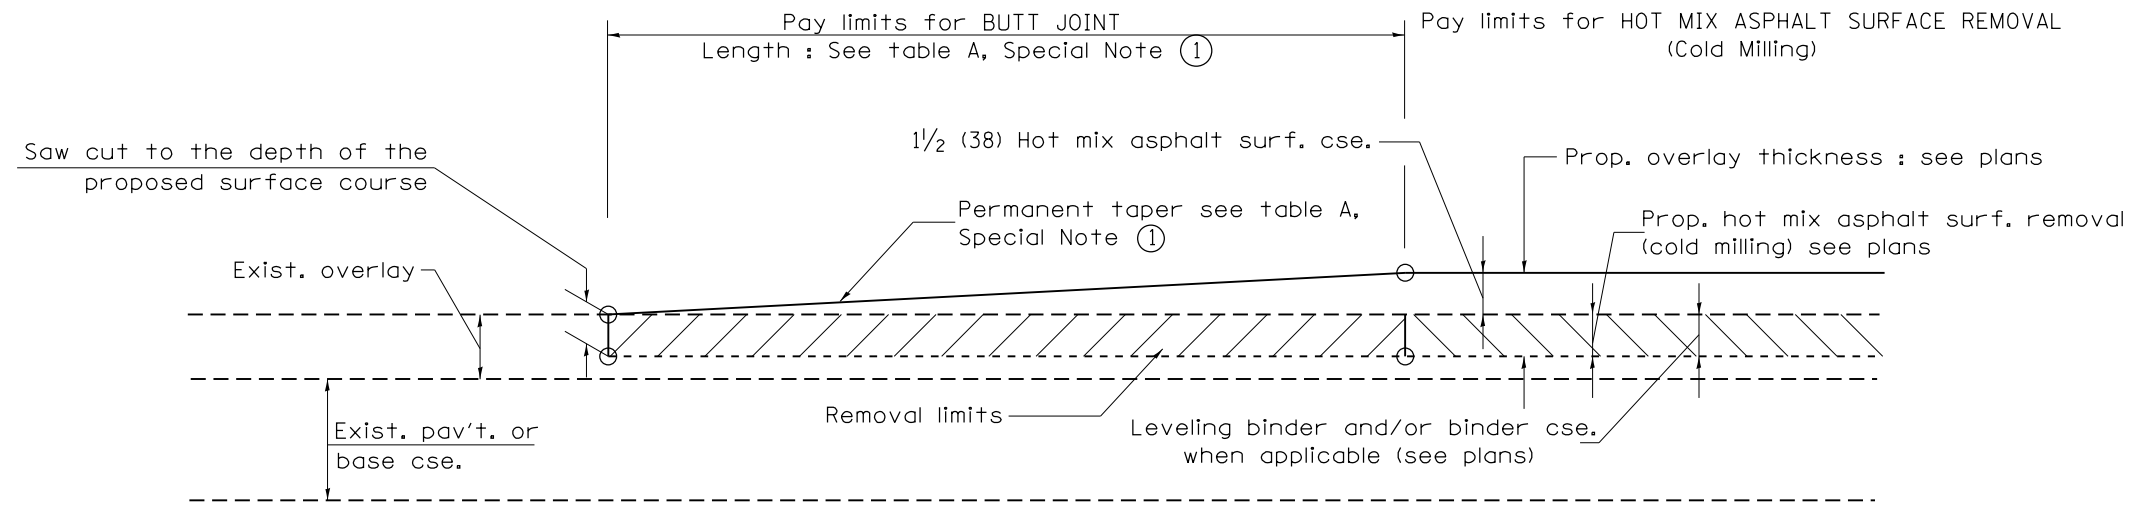


CASE 1 : WITH HOT MIX ASPHALT SURFACE REMOVAL (COLD MILLING)

**TABLE A
TAPER RATES**

SPECIAL NOTE NUMBER	ELEMENT	MAINLINE INTERSTATES & 4-LANE EXPRESSWAYS	ALL OTHERS
①	BUTT JOINT TAPER RATE	1:480	1:240
②	TEMPORARY RAMP TAPER RATE	1:80	1:40

GENERAL NOTES

1. The work shall be done in accordance with Article 406.08 and the Special Provision for Butt Joints.
2. The pavement surface to be removed may be either bituminous or P.C. concrete. The work shall be performed in accordance with Article 440.04 and the Special Provisions for Butt Joints.
3. The saw cut joints shall be primed just prior to the placing of bituminous material. The work will be in accordance with the applicable portions of Article 406.05.
4. The length of butt joint is based on the taper rate times change in cold milling depth within the butt joint pay limits, unless otherwise indicated.
5. Temporary ramps are paid for separately and not included in the cost of the butt joints.

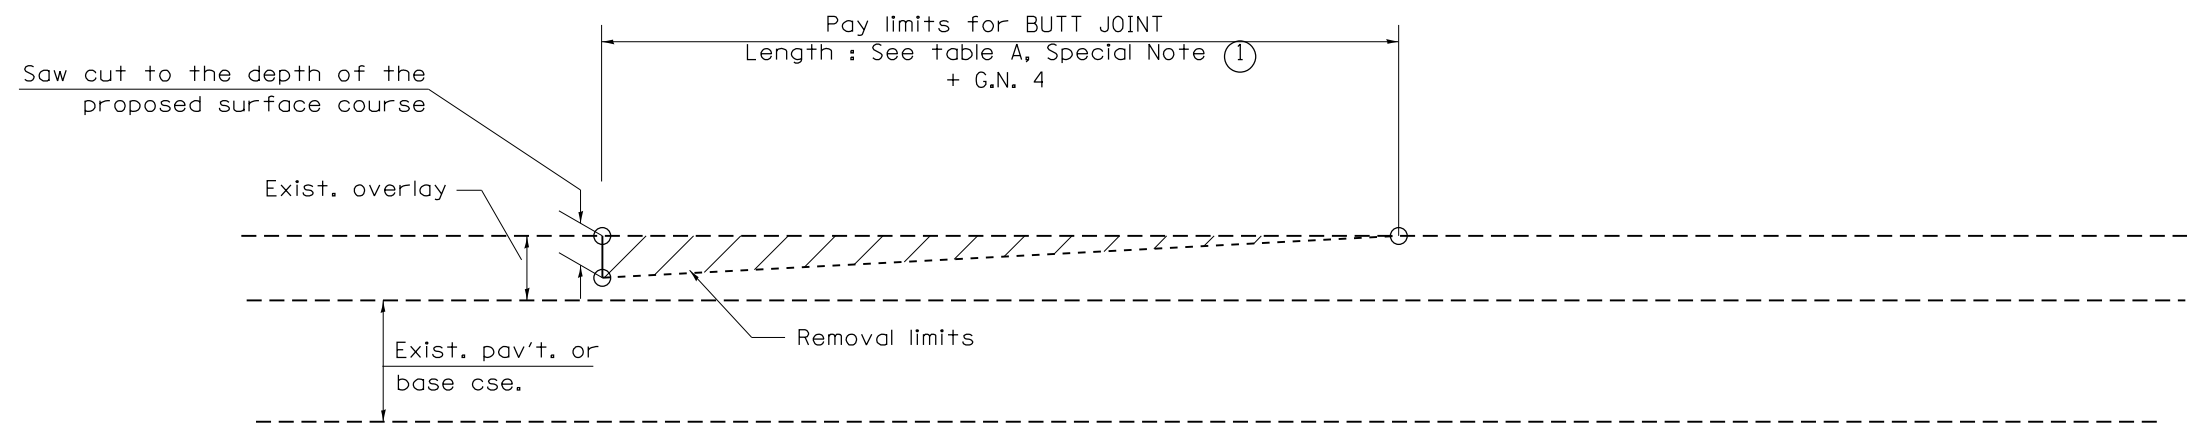

CASE 2 : NO HOT MIX ASPHALT SURFACE REMOVAL (COLD MILLING)

All dimensions are in inches (millimeters) unless otherwise noted.


01-01-97	RENUM. C-23.01, NEW REVISION BOX	T.P.	08-21-13	MAJOR MODIFICATIONS	R.D.	STATE OF ILLINOIS DEPARTMENT OF TRANSPORTATION	BUTT JOINTS	F.A.P. RTE.	SECTION	COUNTY	TOTAL SHEETS	SHEET NO.
04-01-97	CORRECTION TO DEPTH	J.A.	02-29-16	MINOR CORRECTIONS	R.D.			574	(12)CR	*	202	69
09-15-05	REVISED DESIGNER NOTE	M.M.A.	04-12-16	MINOR CORRECTIONS	R.D.			CONTRACT NO. 68C64				
10-16-06	REVISED TO 2007 SPEC.	M.A.	02-14-17	ADDED NOTE 5	R.D.			SHT. 1 OF 3 CADD STD. 406101-D4				

NOT TO SCALE


SHT. 1 OF 3
CADD STD. 406101-D4

FED. ROAD DIST. NO. ILLINOIS FED. AID PROJECT

FULTON / McDONOUGH

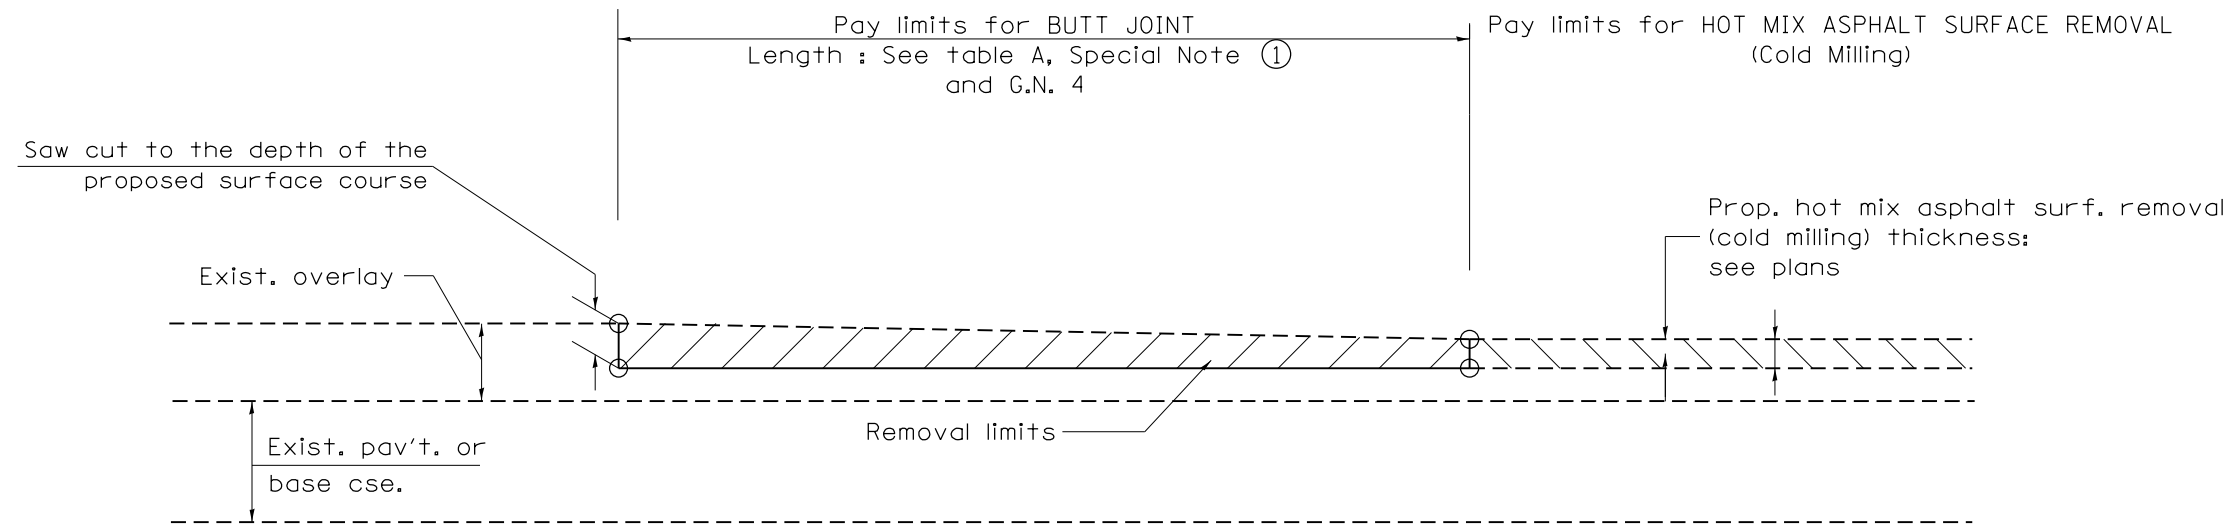


**CASE 3 : HOT MIX ASPHALT SURFACE REMOVAL (COLD MILLING)
TIE-IN TO EXISTING BITUMINOUS TAPER**

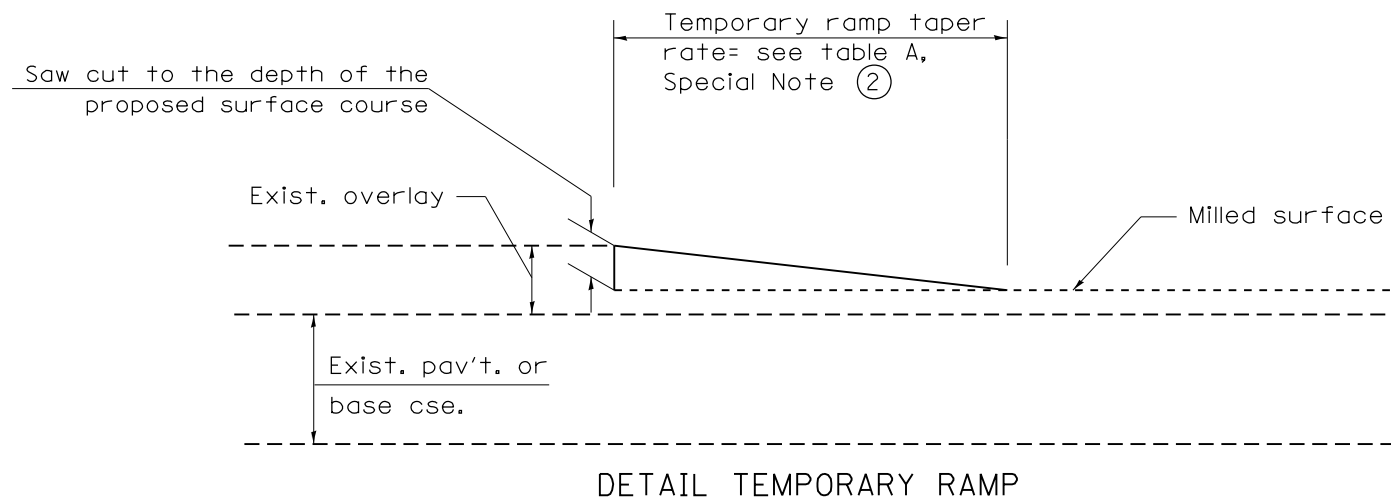

All dimensions are in inches (millimeters) unless otherwise noted.

				STATE OF ILLINOIS DEPARTMENT OF TRANSPORTATION		BUTT JOINTS		SHT. 2 OF 3 CADD STD. 406101-D4		<table border="1"> <tr> <th>F.A.P. RTE.</th> <th>SECTION</th> <th>COUNTY</th> <th>TOTAL SHEETS</th> <th>SHEET NO.</th> </tr> <tr> <td>574</td> <td>(12)CR</td> <td>*</td> <td>202</td> <td>70</td> </tr> </table>		F.A.P. RTE.	SECTION	COUNTY	TOTAL SHEETS	SHEET NO.	574	(12)CR	*	202	70
F.A.P. RTE.	SECTION	COUNTY	TOTAL SHEETS	SHEET NO.																	
574	(12)CR	*	202	70																	
						NOT TO SCALE				<table border="1"> <tr> <td colspan="2">FED. ROAD DIST. NO.</td> <td colspan="2">ILLINOIS FED. AID PROJECT</td> <td colspan="2">CONTRACT NO. 68C64</td> </tr> </table>		FED. ROAD DIST. NO.		ILLINOIS FED. AID PROJECT		CONTRACT NO. 68C64					
FED. ROAD DIST. NO.		ILLINOIS FED. AID PROJECT		CONTRACT NO. 68C64																	

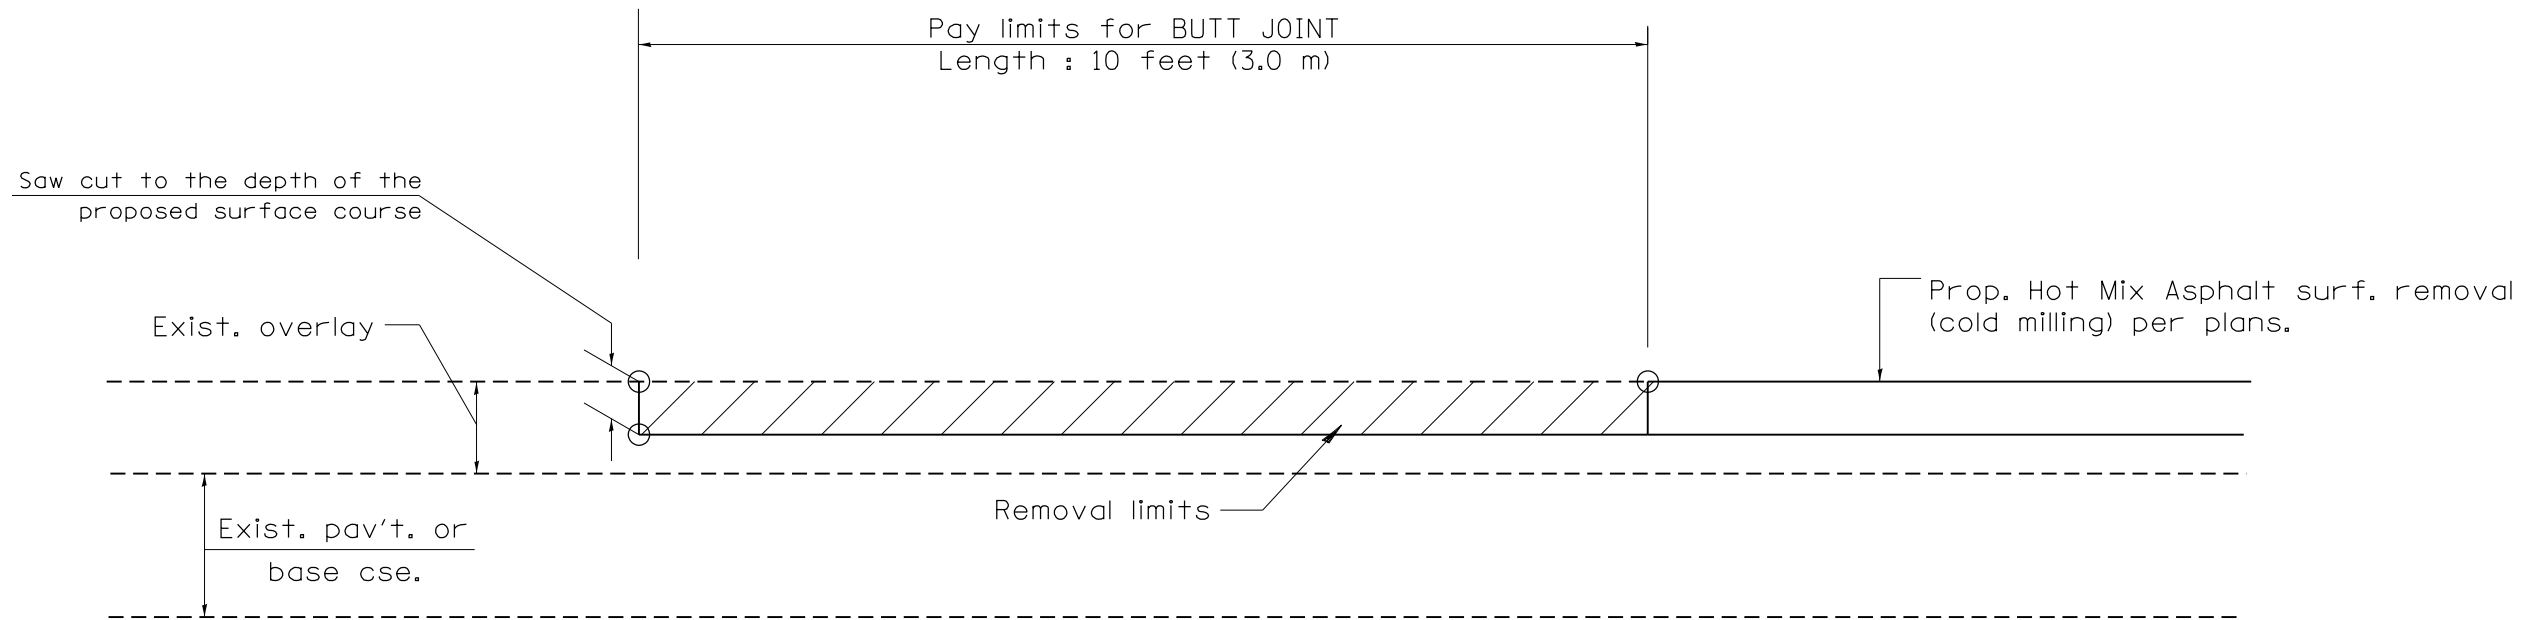

CASE 4 : SINGLE LIFT OVERLAY WITH EQUIVALENT DEPTH
HOT MIX ASPHALT SURFACE REMOVAL (COLD MILLING)
TIE-IN TO EXISTING BITUMINOUS TAPER

All dimensions are in inches (millimeters) unless otherwise noted.

**STATE OF ILLINOIS
DEPARTMENT OF TRANSPORTATION**


BUTT JOINTS

NOT TO SCALE


SHT. 3 OF 3
CADD STD. 406101-D4

F.A.P. RTE.	SECTION	COUNTY	TOTAL SHEETS	SHEET NO.
574	(12)CR	*	202	71
FED. ROAD DIST. NO. ILLINOIS FED. AID PROJECT			CONTRACT NO. 68C64	


• FULTON / McDONOUGH

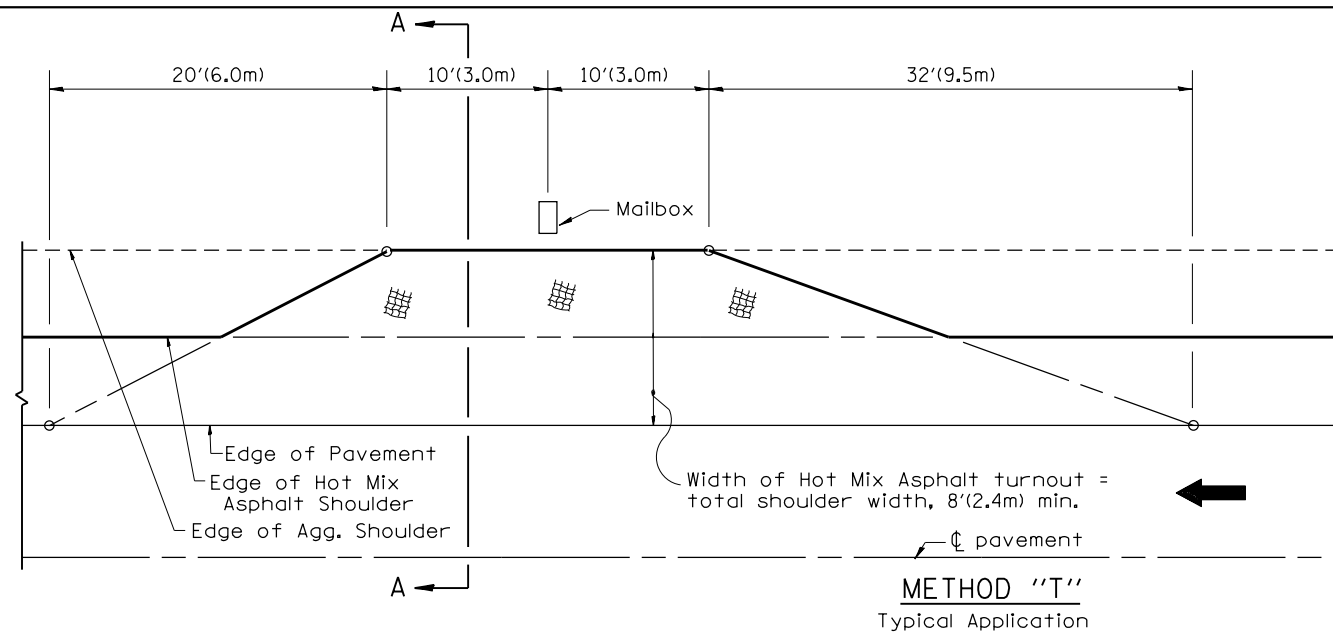


METHOD "T"
Typical Application

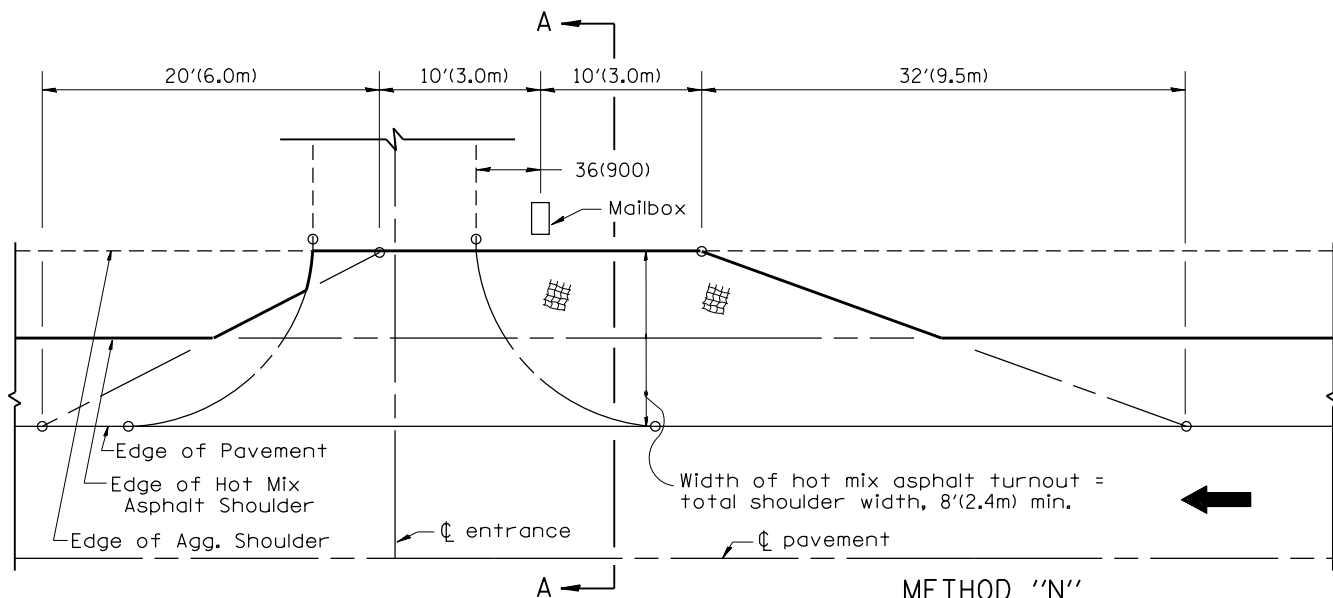


METHOD "N"
Mailbox on near side of entrance

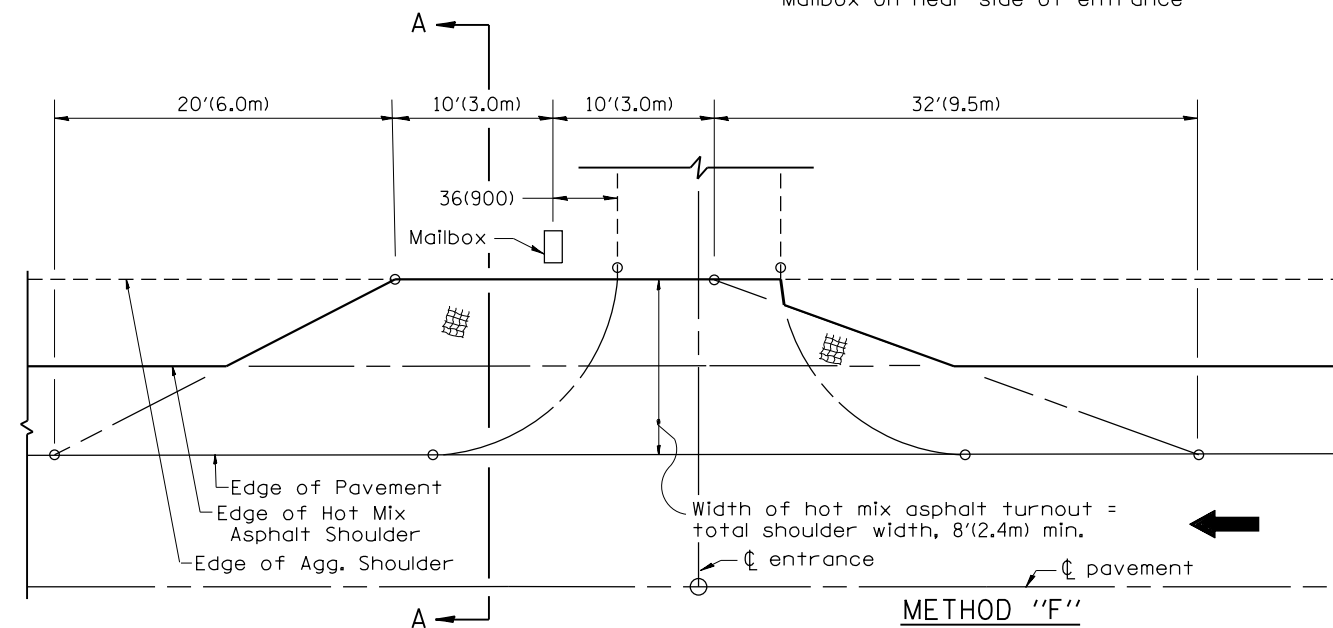

METHOD "F"
Mailbox on far side of entrance

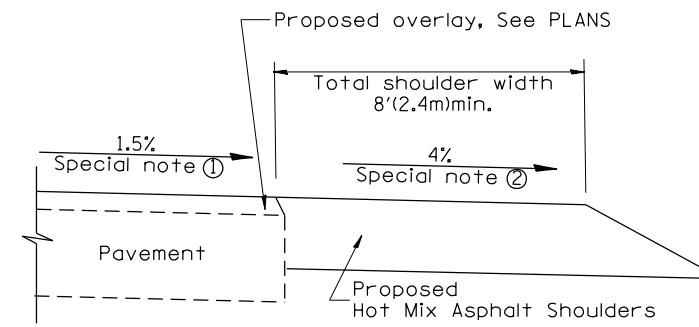

SECTION A-A

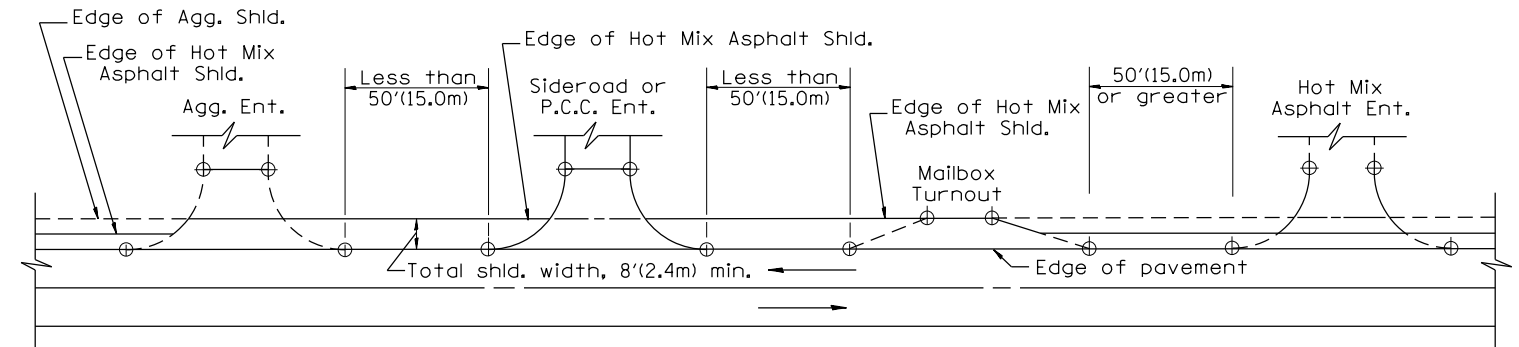

DETAIL A

SHOULDER TREATMENT FOR CLOSELY SPACED SIDEROADS, ENTRANCES, AND/OR MAILBOX TURNOUTS

GENERAL NOTES

- Mailbox turnouts shall slope away from the pavement edge at a rate equal to the shoulder slope. See SECTION A-A.
- The total shoulder width, 8'(2.4m) minimum, shall be paved between sideroads entrances and/or mailbox turnouts at locations where the distance between radius or taper control points is less than 50'(15.0m). See DETAIL A.
- Mailboxes shall be mounted such that the face of the mailbox is 6(150) to 12(300) and the post a minimum of 24(600) from the edge of the turnout surfacing.

SPECIAL NOTES

- The mainline pavement cross-slope is 1.5% for tangent alignment. See PLANS for cross-slope on superelevated horizontal curves.
- The shoulder slope shall control the turnout slope. The standard cross-slope is 4% for tangent alignment. Through superelevated curves, the maximum pavement-shoulder breakover should not be greater than 10% for shoulders 6'(1.8m) and wider and 12% for shoulders 4'(1.2m) and less. Where 12(300) paved shoulders are provided, the breakover should be at the edge of the paved shoulder rather than at the pavement edge.

All dimensions are in inches (millimeters) unless otherwise noted.

01-01-97	RENUM. C-90.01, NEW REVISION BOX	T.P.
07-01-97	REVISE DESIGNER NOTES	J.A.
09-15-05	REVISED DESIGNER NOTE	M.M.A.
10-16-06	REVISED TO 2007 SPEC.	M.A.

**STATE OF ILLINOIS
DEPARTMENT OF TRANSPORTATION**

MAILBOX TURNOUTS FOR "3R" PROJECTS





NOT TO SCALE

CADD STD. 406201-D4



F.A.P. RTE.	SECTION	COUNTY	TOTAL SHEETS	SHEET NO.
574	(12)CR	*	202	72
CONTRACT NO. 68C64				

FED. ROAD DIST. NO. ILLINOIS FED. AID PROJECT

FULTON / McDONOUGH

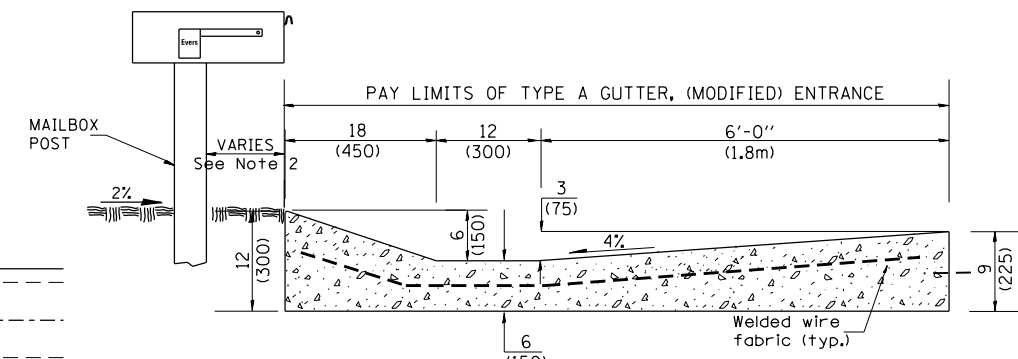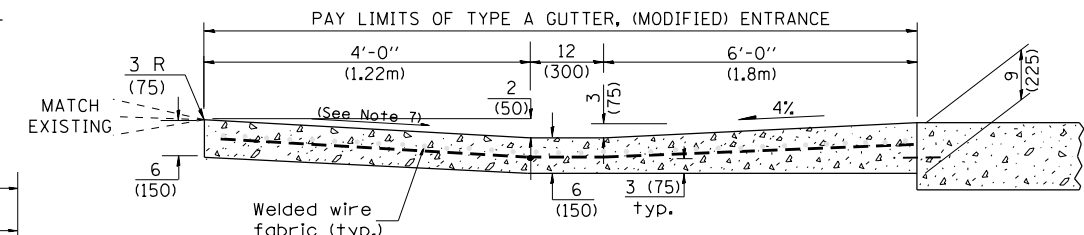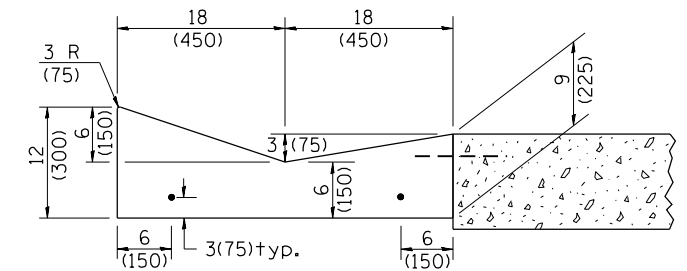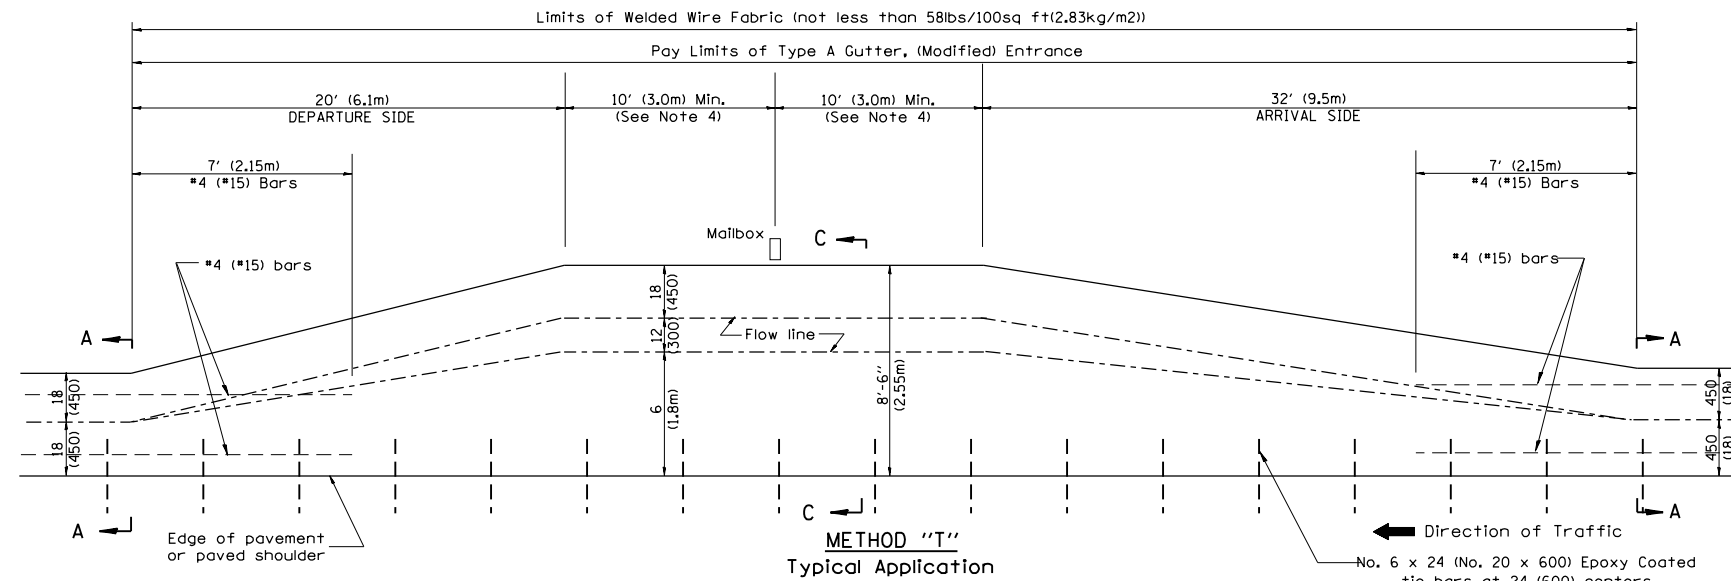


QUANTITY CALCULATION			
LOCATION	LENGTH	CU YD / FT	CU M / M
Arrival Side	32 ft (9.5 m)	0.14	0.35
Section B-B	12 ft (3.6 m) Min.	0.23	0.57
Section C-C	20 ft (6.0 m) Min.	0.20	0.50
Departure Side	20 ft (6.1 m)	0.14	0.35

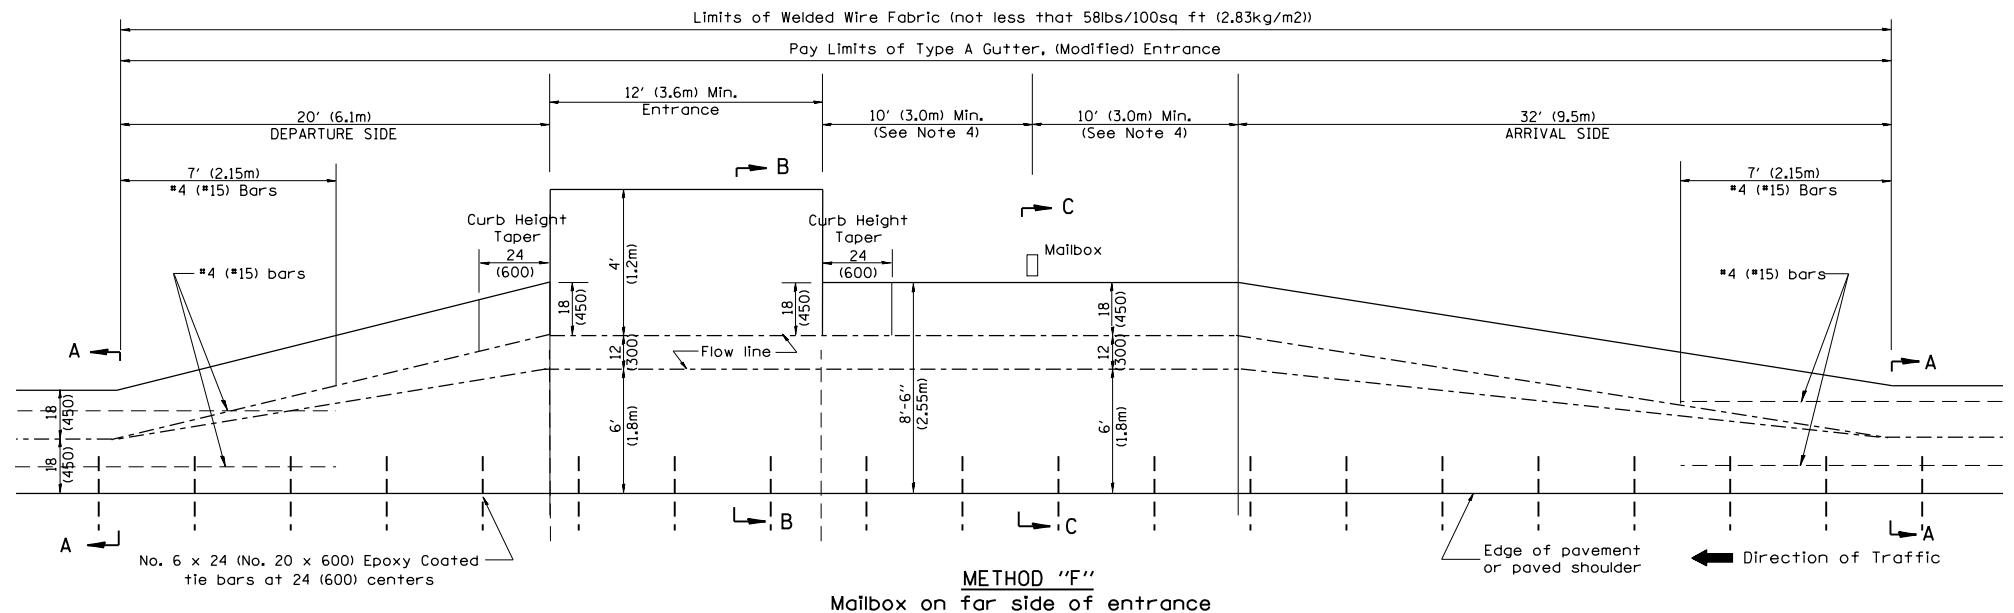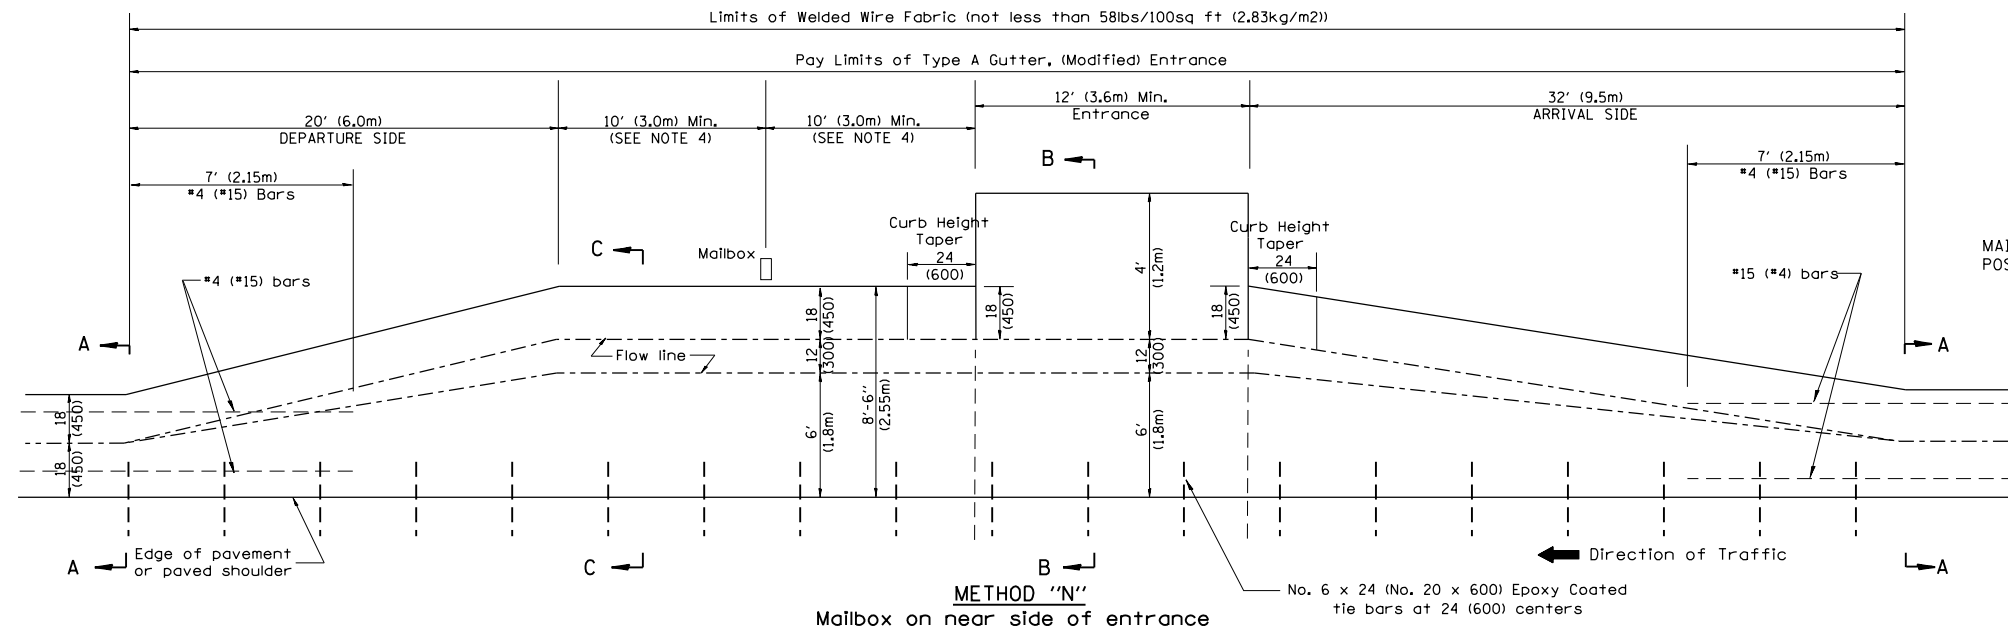

GENERAL NOTES

1. See plans for turnout slopes on super elevated horizontal curves.
2. Mailboxes shall be mounted such that the face of the mailbox is vertically above the back of the gutter.
3. The mailbox turnout shall be saw cut at approximately 10'-0" (3.0m) centers.
4. If more than one mailbox is present, this dimension shall be measured from the end box in each direction.
5. Refer to the plans for entrance width, length and surface type.
6. The cross slope is to be constructed as given in the plans from back of turnout to where driveway matches existing.
7. Slope may be increased from 4% (min.) to 6% (max.) in order to match the existing.

All dimensions are in inches (millimeters) unless otherwise noted.

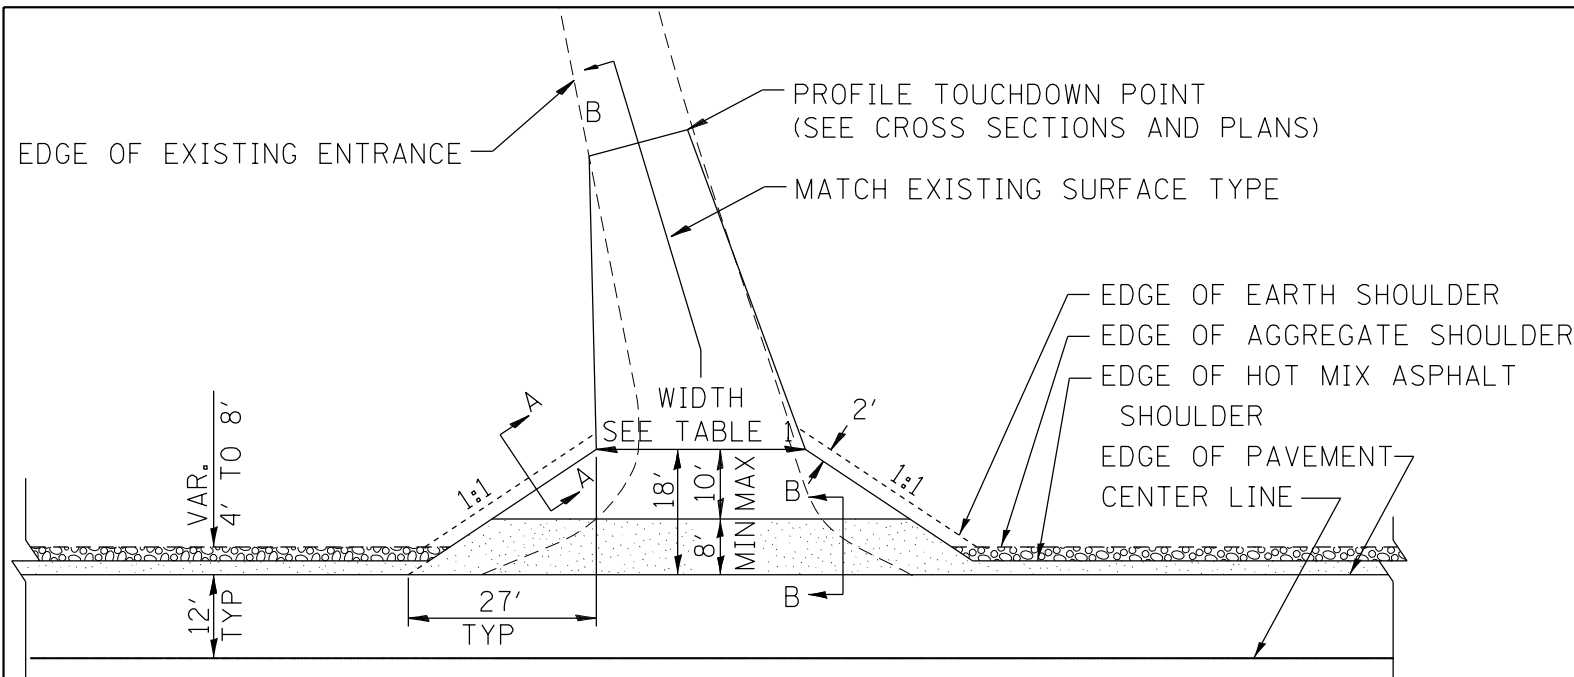


HOT MIX ASPHALT SHOULDER, 8"
 AGGREGATE SHOULDER, TYPE B, 6"

PLAN


COMMERCIAL / FARM-RELATED ENTRANCE

TABLE 1					
RURAL ENTRANCE DESIGN					
ELEMENT	NON-COMMERCIAL		NON-COMMERCIAL W/ LARGE FARM EQUIPMENT	COMMERCIAL	
	12'(3.6m) Min.	24'(7.2m) Max.	20' (6.1m)Min.	30'(9.0m)Max.	
WIDTH (W)	12'(3.6m) Min.	24'(7.2m) Max.	20' (6.1m)Min.	30'(9.0m)Max.	14'(4.3m) Min., 24'(7.2m) Max., 24'(7.2m) Min., 35'(10.7m) Max.
FLARE	1:1.5				
MAX. GRADE (G)	12%		12%		10%


SURFACE TYPE			
INCIDENTAL HOT MIX ASPHALT SURFACING	6"	—	8"
AGGREGATE SURFACE COURSE	6"	8"	—
PCC DRIVEWAY PAVEMENT	6"	—	7"

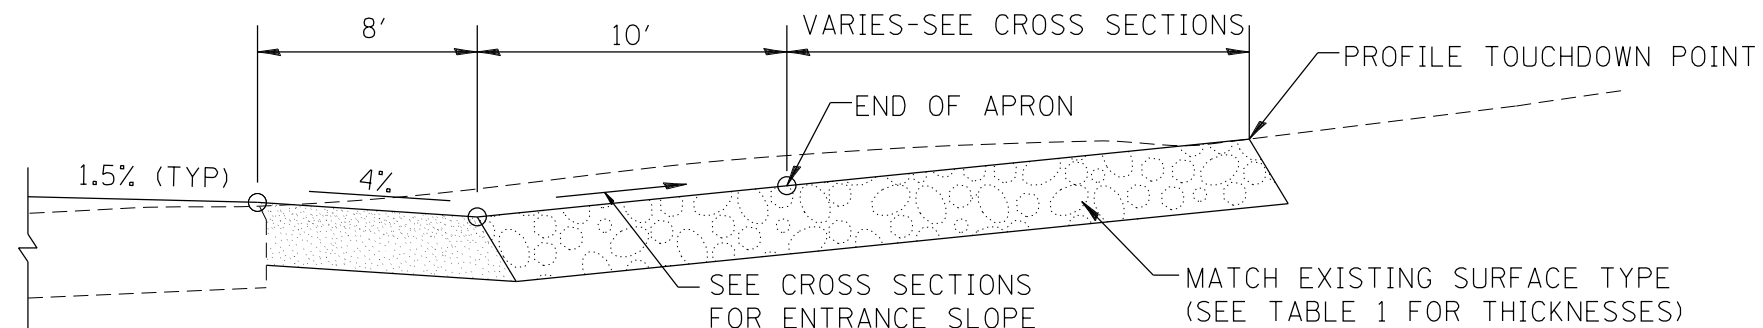

SECTION B-B
RECONSTRUCTED RURAL ENTRANCE
(EXISTING ENTRANCE HIGHER THAN APRON)

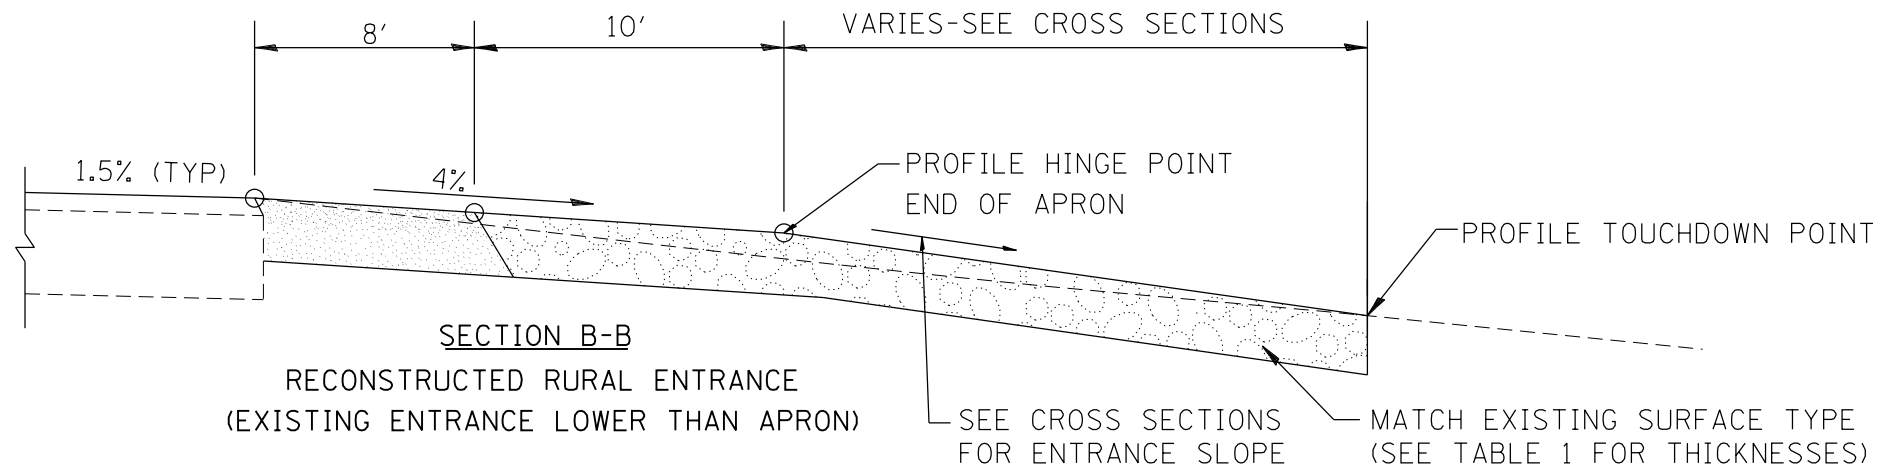

SECTION B-B
RECONSTRUCTED RURAL ENTRANCE
(EXISTING ENTRANCE LOWER THAN APRON)

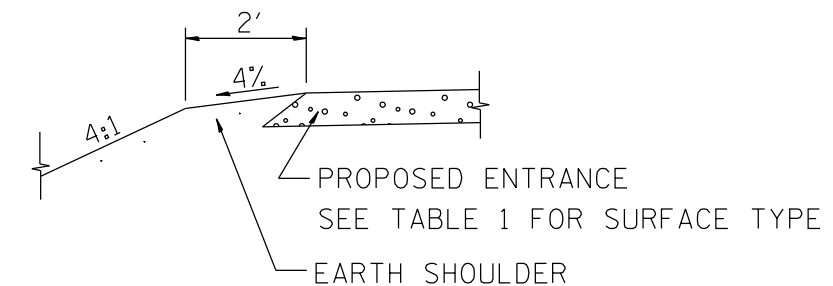

SECTION A-A
SHOULDER TREATMENT FOR RURAL ENTRANCES

GENERAL NOTES

- ENTRANCES SHALL SLOPE AWAY FROM THE PAVEMENT AT A RATE EQUAL TO THE SHOULDER SLOPE FOR A MINIMUM DISTANCE OF 8'.
- A MINIMUM 8' PAVED SHOULDER SHALL BE CONSTRUCTED BETWEEN LOCATIONS WHERE THE RURAL ENTRANCE IS LESS THAN 50' FROM AN ADJACENT SIDEROAD, ENTRANCE OR MAILBOX TURNOUT.
- A TAPER RATE OF 5:1 IS DESIRABLE WHEN TRANSITING FROM THE RURAL ENTRANCE WIDTH SHOWN IN TABLE 1, TO THE EXISTING ENTRANCE WIDTH.

All dimensions are in inches (millimeters) unless otherwise noted.

01-01-97	RENUM. C-103.06, NEW REVISION BOX	T.P.	10-16-06	REVISED TO 2007 SPEC.	M.A.
07-01-97	REVISE DESIGNER NOTES	J.A.	9-15-15	UPDATED TABLE 1	R.D.
01-17-03	ADJUST DESIGN, CHANGE ENTRANCE	JATR	2-29-16	MINOR CORRECTIONS	R.D.
09-15-05	RADIUS FOR FLARE	M.M.A.	5-9-17	CHANGED TAPER RATE	R.D.


**STATE OF ILLINOIS
DEPARTMENT OF TRANSPORTATION**

RURAL ENTRANCES FOR "3R" PROJECTS


NOT TO SCALE

SHT. 1 OF 2
CADD STD. 406301-D4


F.A.P. RTE.	SECTION	COUNTY	TOTAL SHEETS	SHEET NO.
574	(12)CR	*	202	74
FED. ROAD DIST. NO. ILLINOIS FED. AID PROJECT			CONTRACT NO. 68C64	

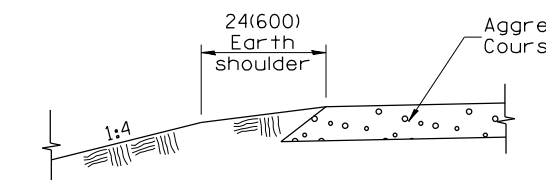


SECTION A-A
SHOULDER TREATMENT FOR AGGREGATE ENTRANCES

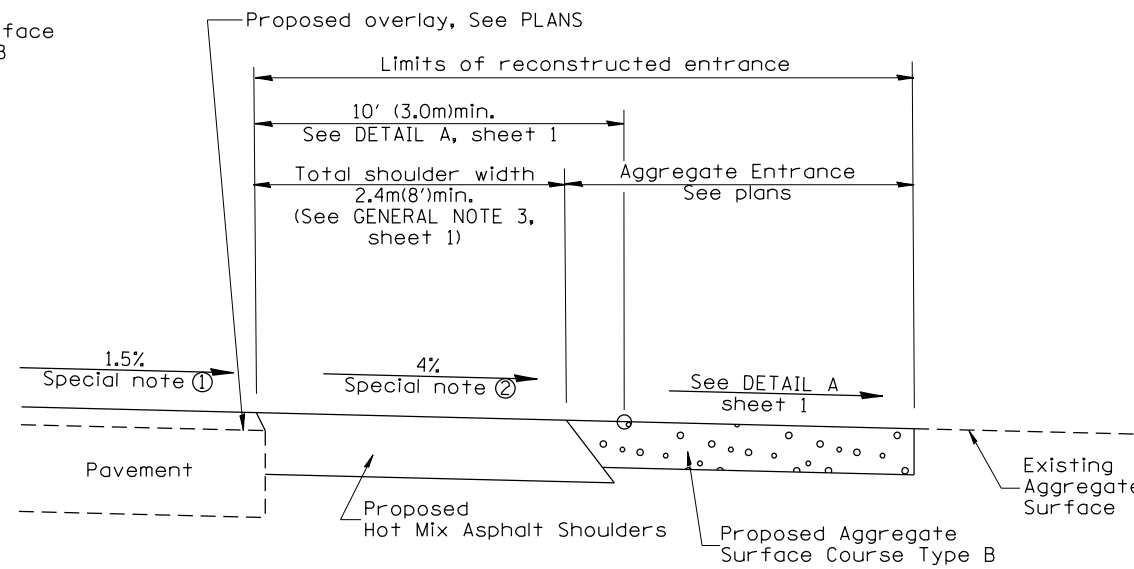


SECTION B-B
RECONSTRUCTED AGGREGATE ENTRANCE

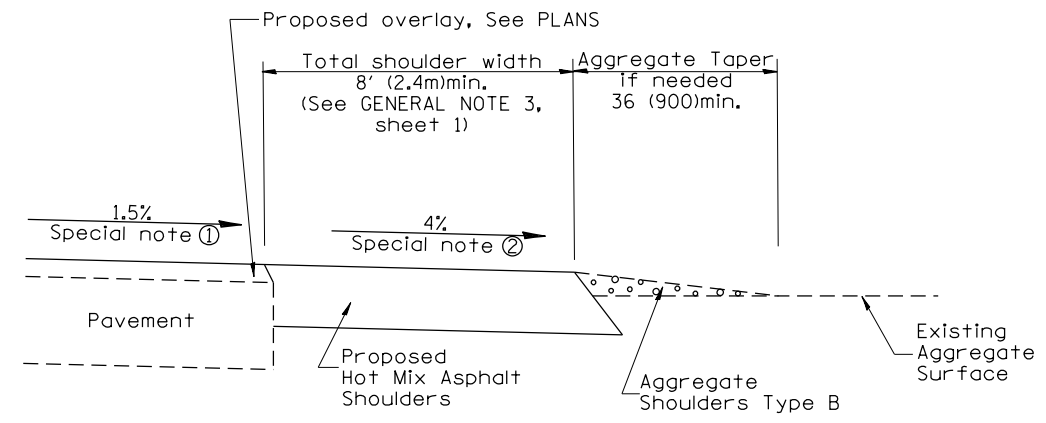


SECTION B-B
EXISTING AGGREGATE ENTRANCE

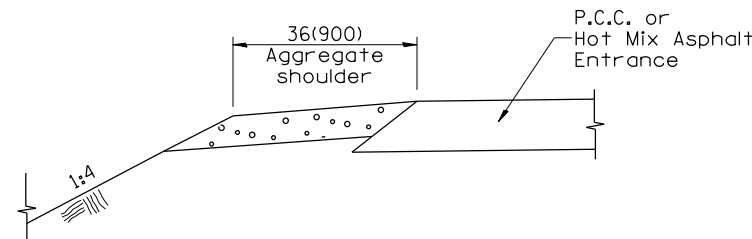


SECTION C-C
SHOULDER TREATMENT FOR P.C.C. OR HOT MIX ASPHALT ENTRANCES

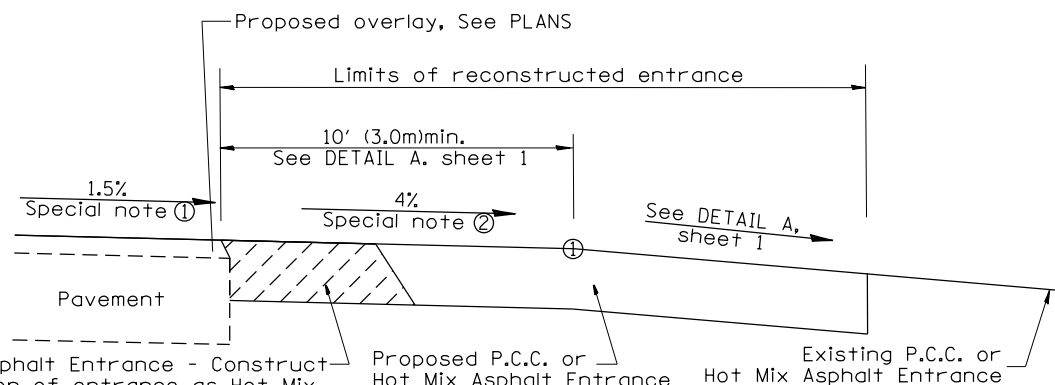

SECTION D-D
RECONSTRUCTED P.C.C. OR HOT MIX ASPHALT ENTRANCE

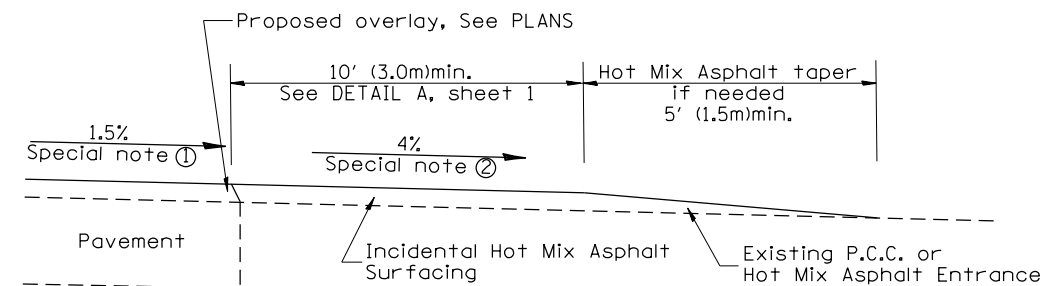

SECTION D-D
EXISTING P.C.C. OR HOT MIX ASPHALT ENTRANCE

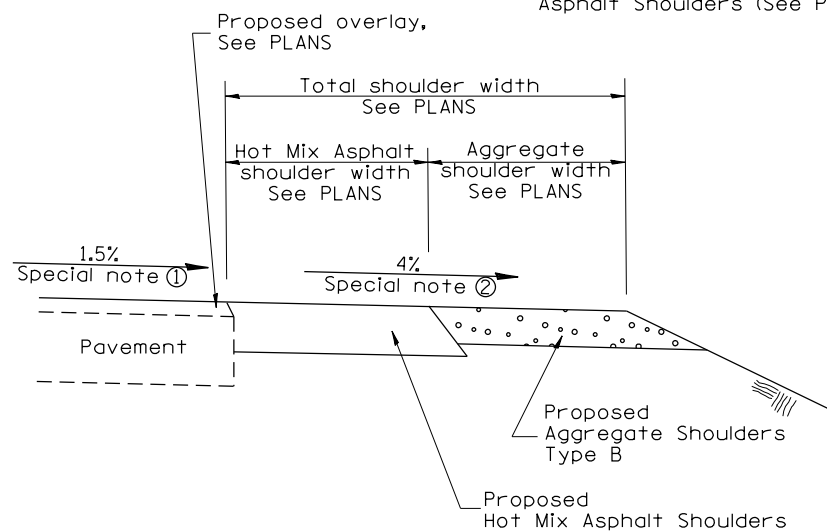


SECTION E-E
MAINLINE SHOULDER TREATMENT

SPECIAL NOTES


- ① The mainline pavement cross-slope is 1.5% for tangent alignment. See PLANS for cross-slope on super-elevated horizontal curves.
- ② The shoulder slope shall control the entrance profile for a distance of 10' (3.0m) minimum from the pavement edge. The shoulder cross-slope is 4% for tangent alignment. Through super-elevated curves, the maximum pavement-shoulder breakover should not be greater than 10% for shoulders 6' (1.8m) and wider and 12% for shoulders 4' (1.2m) and less. Where 12' (366cm) paved shoulders are provided, the breakover should be at the edge of the paved shoulder rather than at the pavement edge.

All dimensions are in inches (millimeters) unless otherwise noted.


STATE OF ILLINOIS DEPARTMENT OF TRANSPORTATION				RURAL ENTRANCES FOR "3R" PROJECTS				F.A.P. RTE.	SECTION	COUNTY	TOTAL SHEETS	SHEET NO.
				NOT TO SCALE				574	(12)CR	*	202	75
				SHT. 2 OF 2 CADD STD. 406301-D4				CONTRACT NO. 68C64				
								ILLINOIS FED. AID PROJECT				
								FULTON / McDONOUGH				

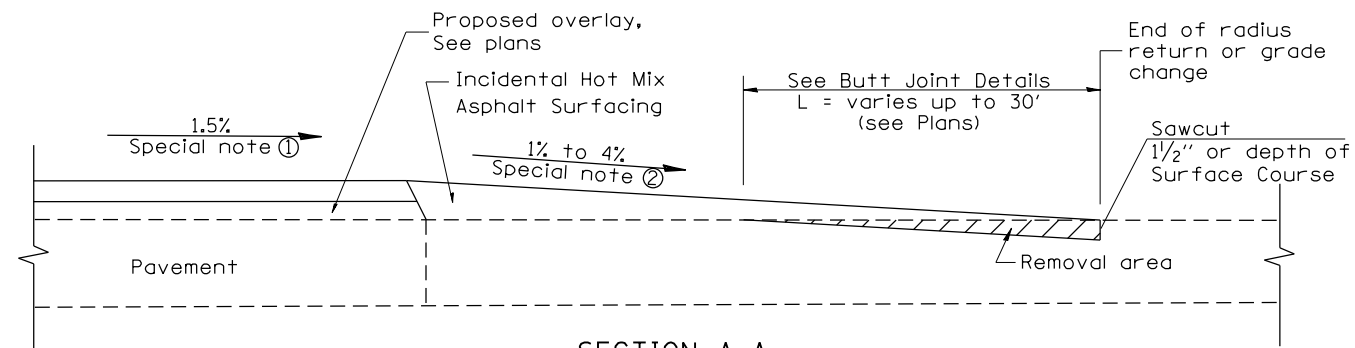


SECTION A-A
EXISTING PCC OR HOT MIX ASPHALT SIDEROAD

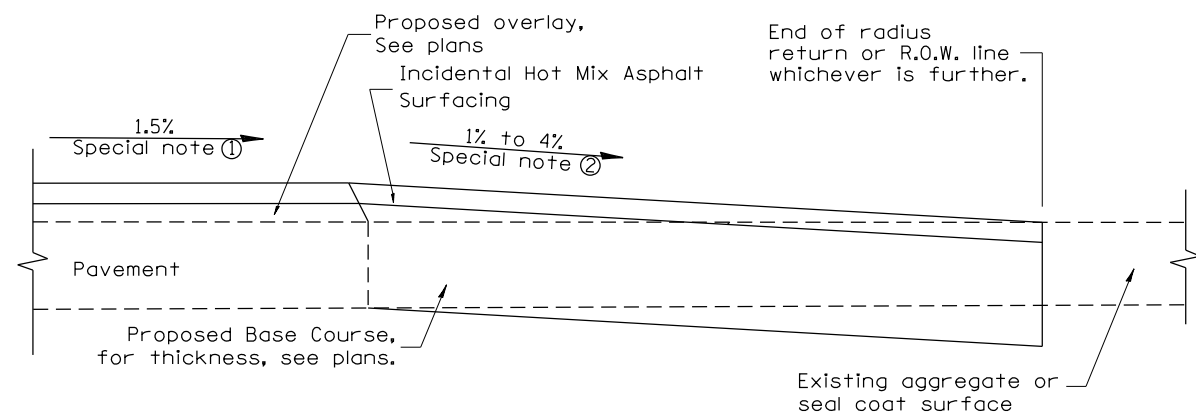


SECTION A-A
EXISTING AGGREGATE OR SEAL COAT SIDEROAD

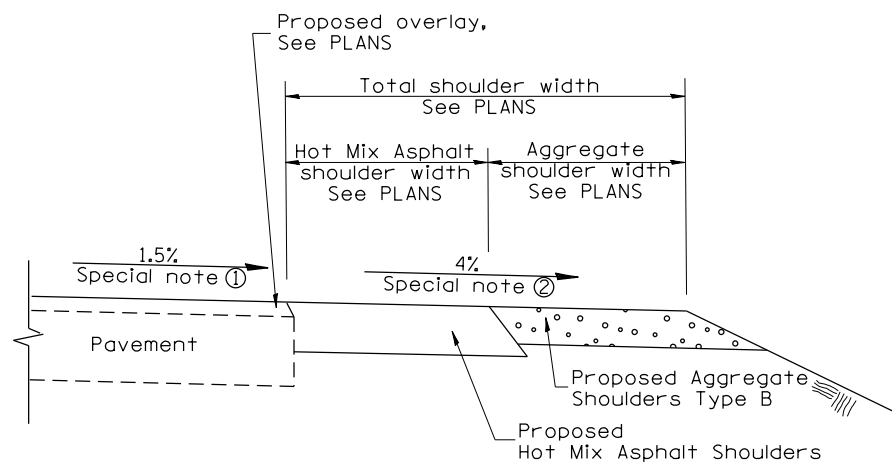

SECTION B-B
MAINLINE SHOULDER TREATMENT

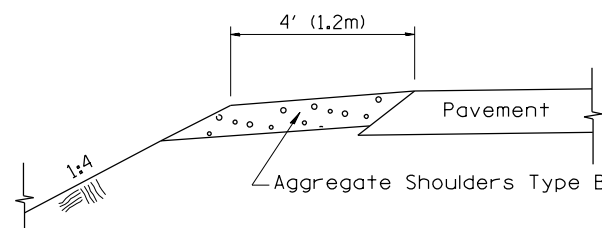

SECTION C-C
SIDEROAD SHOULDER TREATMENT

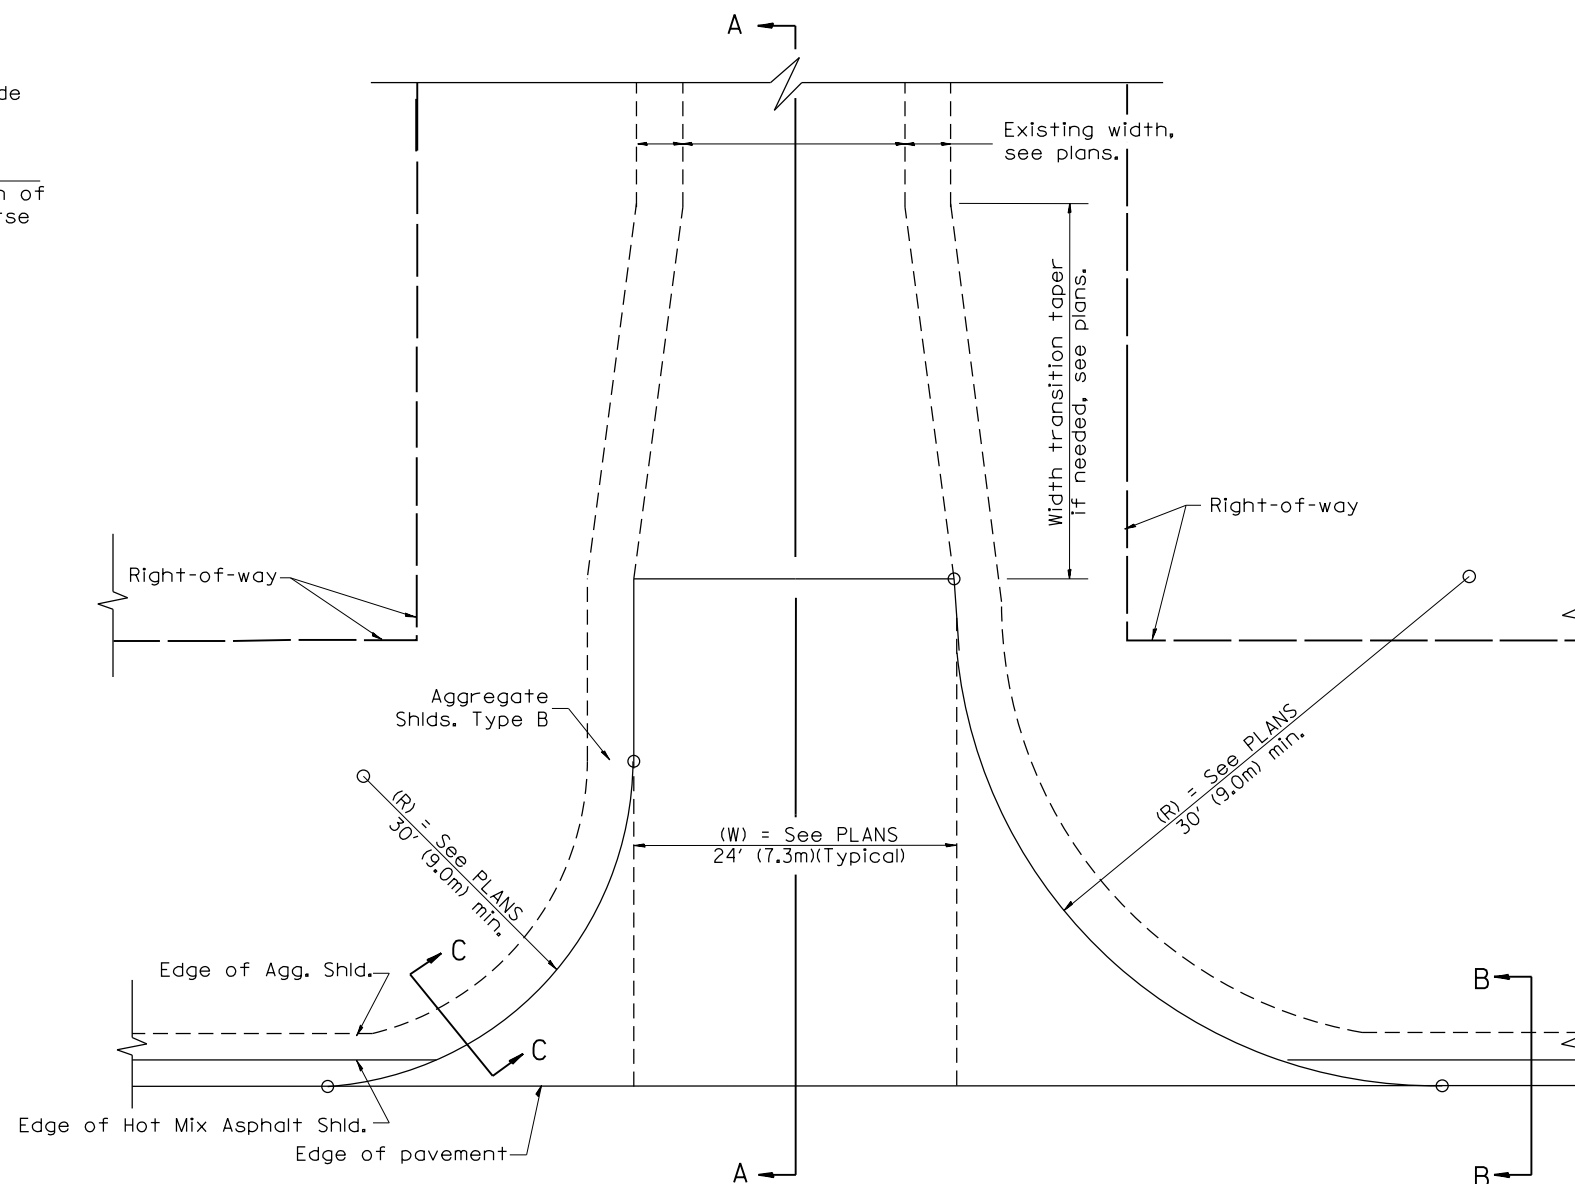

PLAN

SPECIAL NOTES

- ① The mainline pavement cross-slope is 1.5% for tangent alignment. See Plans for cross-slope on superelevated horizontal curves.
- ② The sideroad profile should drain away from the mainline at 1% to 4% for 50' (15.0m) to 100' (30.0m), or as a minimum to the end of the radius return. When the sideroad is on the high side of a mainline superelevated curve, - 2% maximum should be provided in order to minimize breakover at the pavement edge. See plans for sideroad profiles.

01-01-97	RENUM. C-105.02, NEW REVISION BOX	T.P.	02-14-17	MINOR REVISIONS	R.D.
07-01-97	REVISE DESIGNER NOTES	J.A.			
09-15-05	REVISED DESIGNER NOTE	M.M.A.			
10-16-06	REVISED TO 2007 SPEC.	M.A.			

STATE OF ILLINOIS
DEPARTMENT OF TRANSPORTATION


RURAL SIDEROADS FOR "3R" PROJECTS

NOT TO SCALE

CADD STD. 406401-D4

All dimensions are in inches (millimeters) unless otherwise noted.


F.A.P. RTE.	SECTION	COUNTY	TOTAL SHEETS	SHEET NO.
574	(12)CR	*	202	76
FED. ROAD DIST. NO. ILLINOIS FED. AID PROJECT			CONTRACT NO. 68C64	

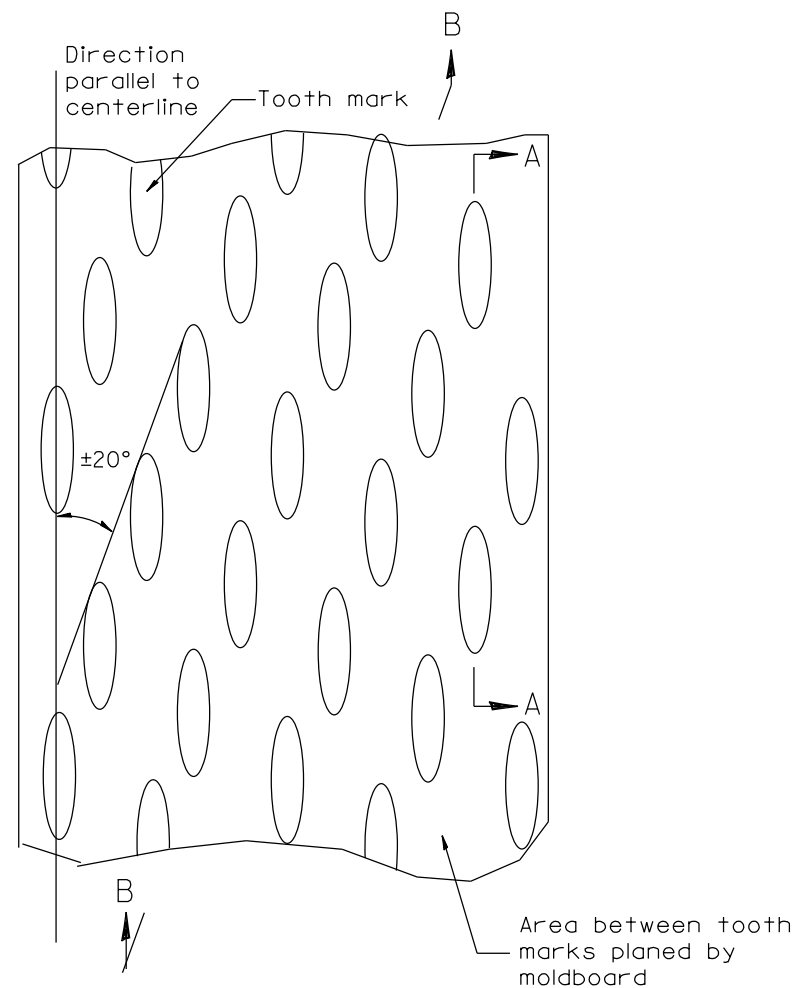


PLAN

General notes:

1. Coldmilling shall consist of two processes: Cutting with carbide teeth mounted on a rotating drum, and planing with a moldboard mounted immediately behind the cutting drum.
2. Other similar patterns will be acceptable if they consist of a smooth, flat, planed surface interspersed with a pattern of discontinuous longitudinal striations.

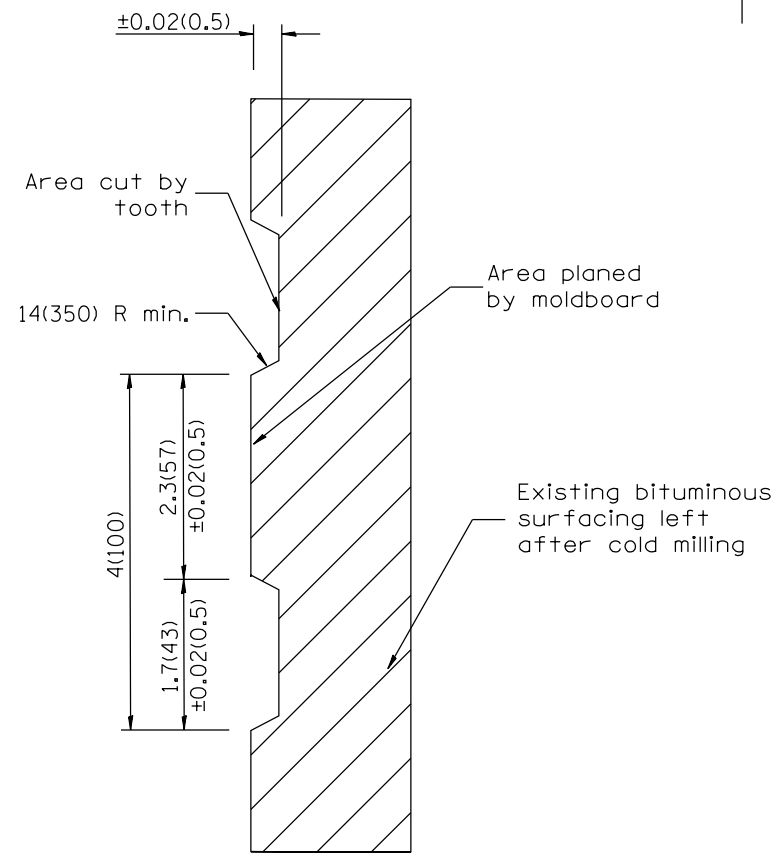

SECTION A-A

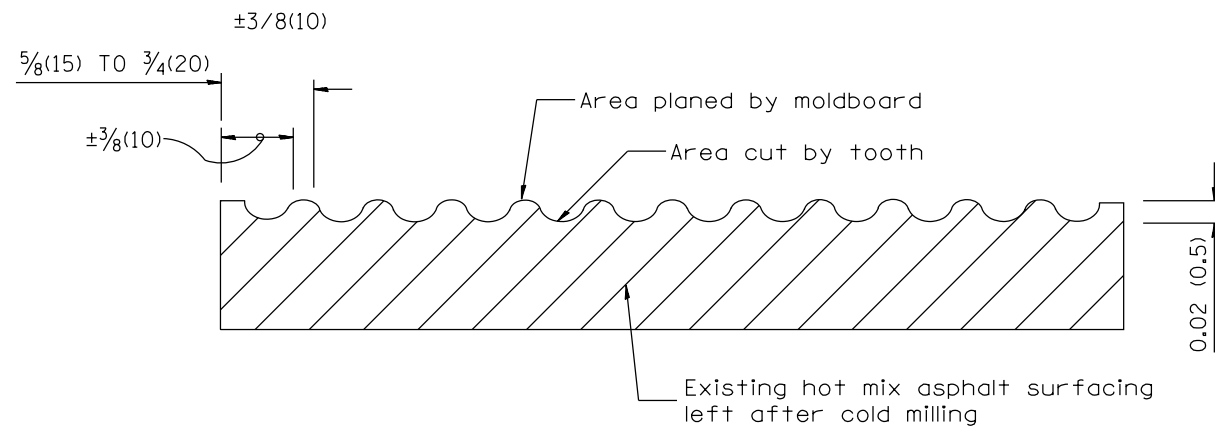

SECTION B-B PROJECTED
PERPENDICULAR TO CENTERLINE

All dimensions are in inches (millimeters) unless otherwise noted.

01-01-97	RENUM. C-104.01, NEW REVISION BOX	T.P.
04-20-98	REMOVED MILLING DETAIL FROM STANDARD	J.A.
09-08-98	CORRECT NOTE LEADER PLACEMENT	R.W.
10-16-06	REVISED TO 2007 SPEC.	M.A.

STATE OF ILLINOIS
DEPARTMENT OF TRANSPORTATION


HOT MIX ASPHALT SURFACE REMOVAL (COLD MILLING)

NOT TO SCALE

CADD STD. 440001-D4

F.A.P. RTE.	SECTION	COUNTY	TOTAL SHEETS	SHEET NO.
574	(12)CR	*	202	77
FED. ROAD DIST. NO. ILLINOIS FED. AID PROJECT			CONTRACT NO. 68C64	

ROADWAY PROFILE VIEW

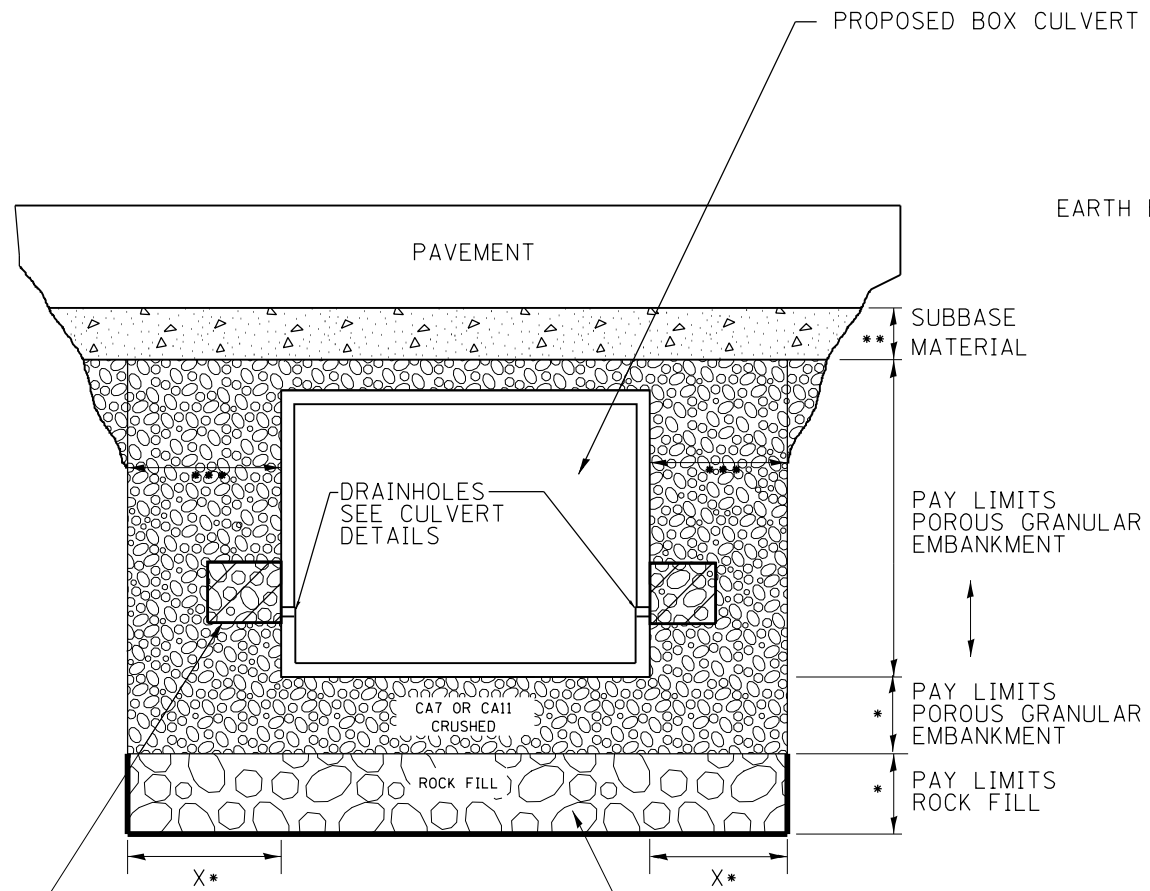


2' x 2' x 2' DEPOSIT OF CA 5, 7, OR 11 IN FABRIC ENVELOPE IN ACCORDANCE WITH ARTICLE 502.10 OF THE STANDARD SPECIFICATIONS (TYPICAL)

(IF UNDERCUT IS REQUIRED) PROPOSED REMOVAL & DISPOSAL OF UNSUITABLE, AND REPLACE WITH ROCK FILL WITH GEOTECHNICAL FABRIC FOR GROUND STABILIZATION. PAID FOR BY RESPECTIVE PAY ITEMS.

- * IF APPLICABLE, SEE UNDERCUT DETAIL FOR DEPTHS AND WIDTHS. IF THERE IS NO UNDERCUT, X = 2 FEET AND SEE NOTE 3 THIS SHEET.
- ** SUBBASE SHALL BE 6" MINIMUM LAYER OF CA6 CRUSHED STONE OR OTHER MATERIAL AS SPECIFIED IN THE PLANS.
- *** PAY LIMITS OF POROUS GRANULAR EMBANKMENT SHALL BE 2 FEET UNLESS OTHERWISE SHOWN IN THE PLANS.

ROADWAY CROSS SECTION VIEW

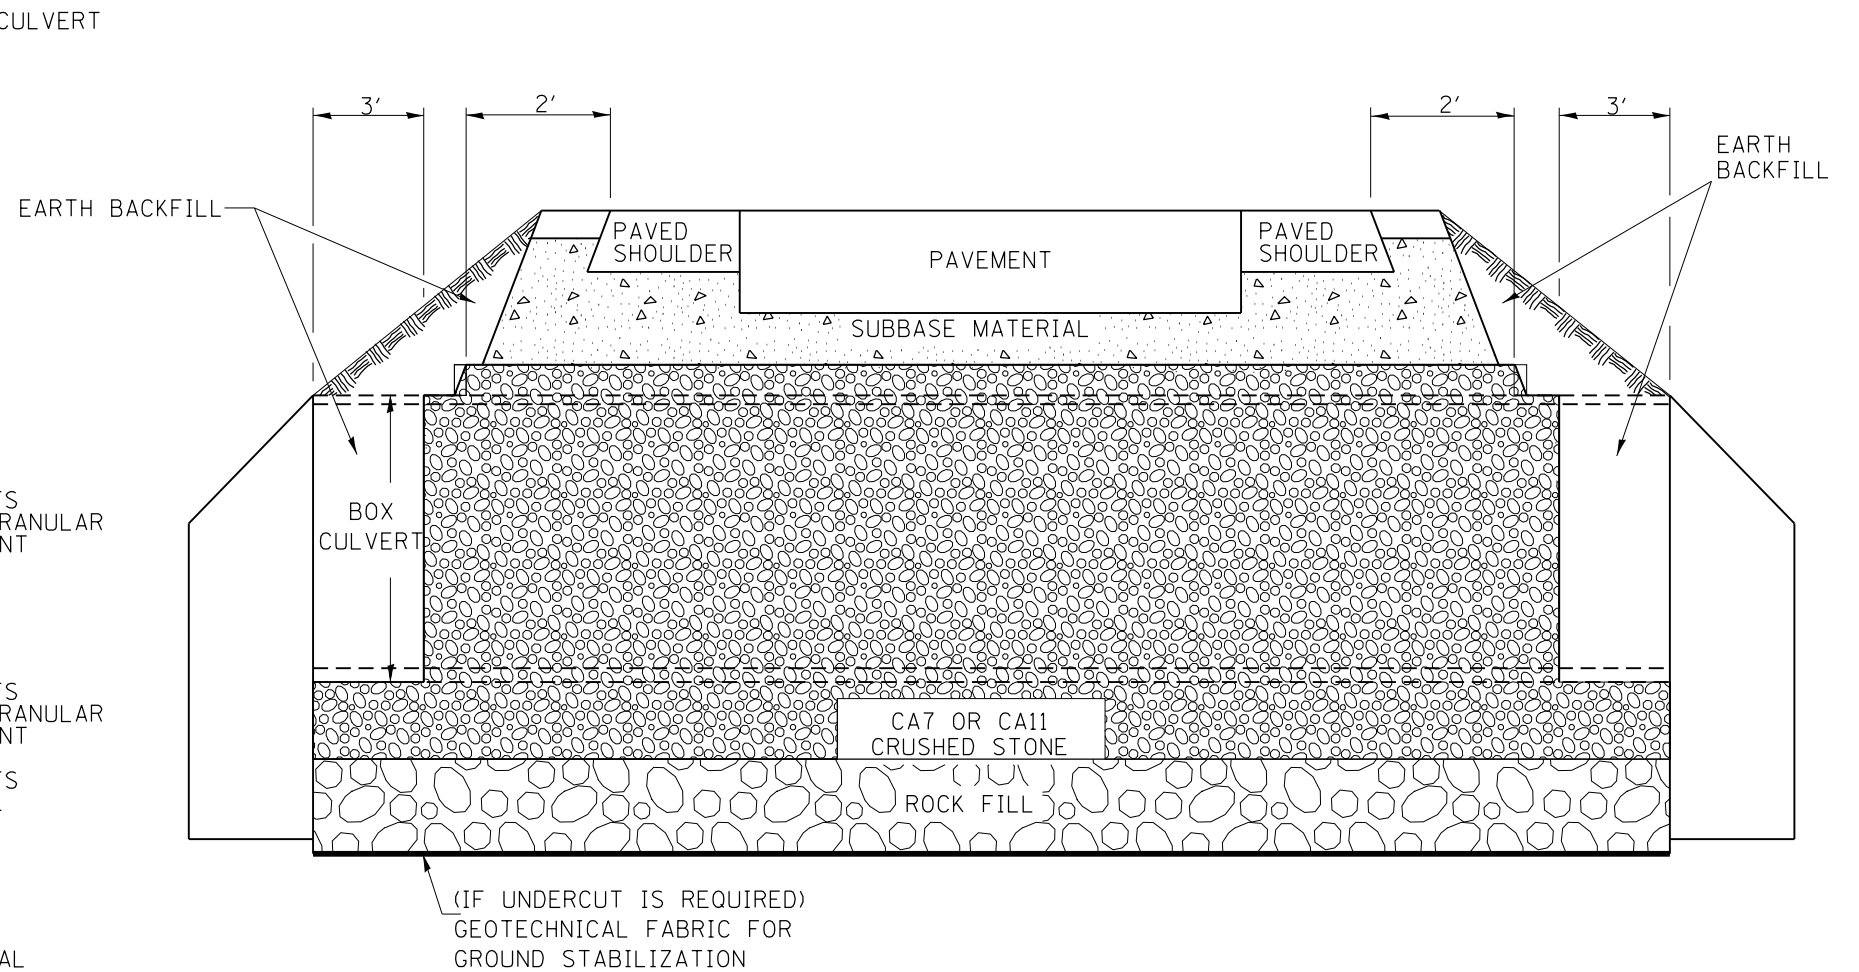


NOTES:

1. EXCEPT AS SPECIFIED IN THIS DETAIL, THE PLACEMENT AND COMPACTION OF BACKFILL SHALL BE IN ACCORDANCE WITH ARTICLE 502.10 OF THE STANDARD SPECIFICATIONS.
2. POROUS GRANULAR EMBANKMENT SHALL BE PLACED IN ACCORDANCE WITH SECTION 207 OF THE STANDARD SPECIFICATIONS.
3. IF NO UNDERCUT IS REQUIRED, A 6" MINIMUM LAYER OF POROUS GRANULAR EMBANKMENT SHALL BE PLACED BELOW THE ELEVATION OF THE BOTTOM OF BOX CULVERT.

All dimensions are in inches (millimeters) unless otherwise noted.


6-12-12	CREATED NEW STD.	R.D.															
STATE OF ILLINOIS DEPARTMENT OF TRANSPORTATION										DETAIL OF EXCAVATION AND BACKFILL FOR BOX CULVERTS			F.A.P. RTE.	SECTION	COUNTY	TOTAL SHEETS	SHEET NO.
										NOT TO SCALE			574	(12)CR	*	202	78
										CADD STD. 540000-D4			CONTRACT NO. 68C64				
													ILLINOIS FED. AID PROJECT				
													• FULTON / McDONOUGH				

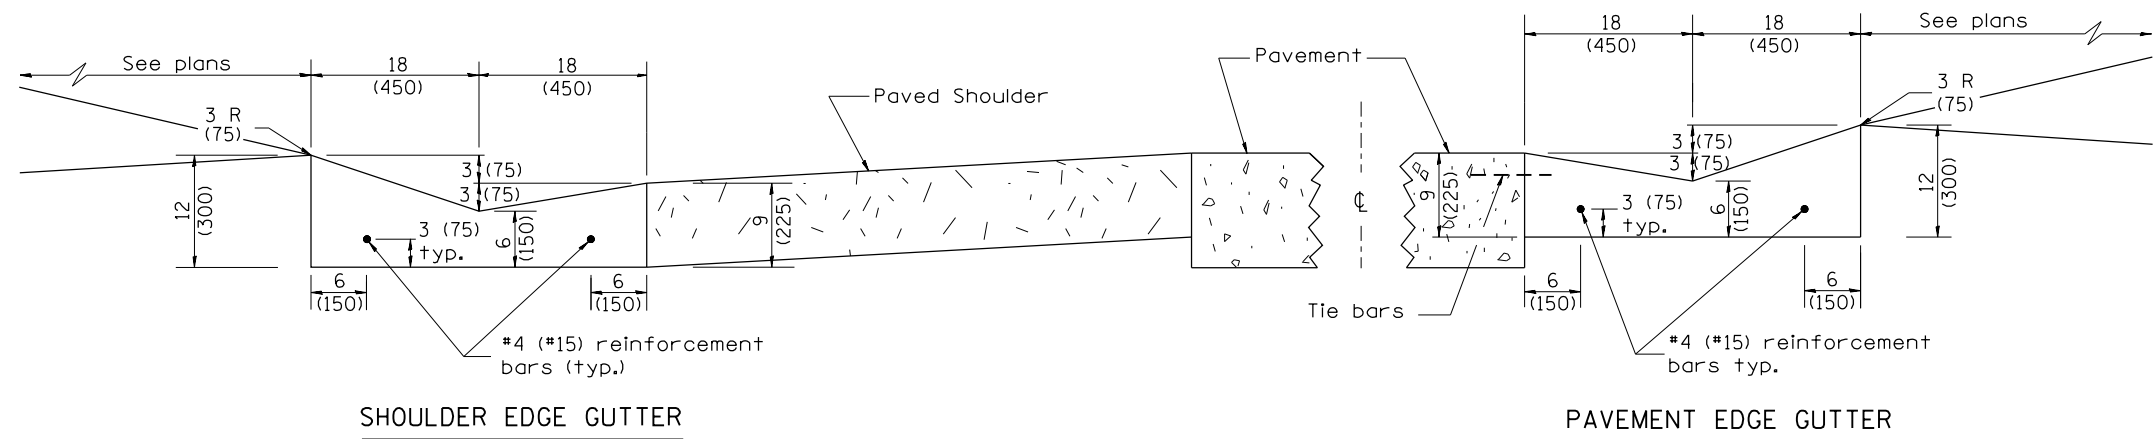


SHOULDER EDGE GUTTER

PAVEMENT EDGE GUTTER

CONCRETE GUTTER, TYPE A, (SPECIAL)

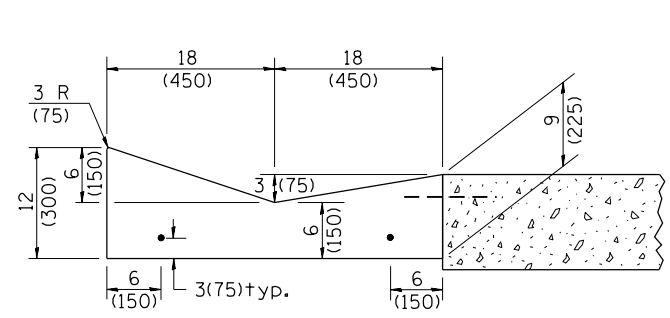


SECTION A-A

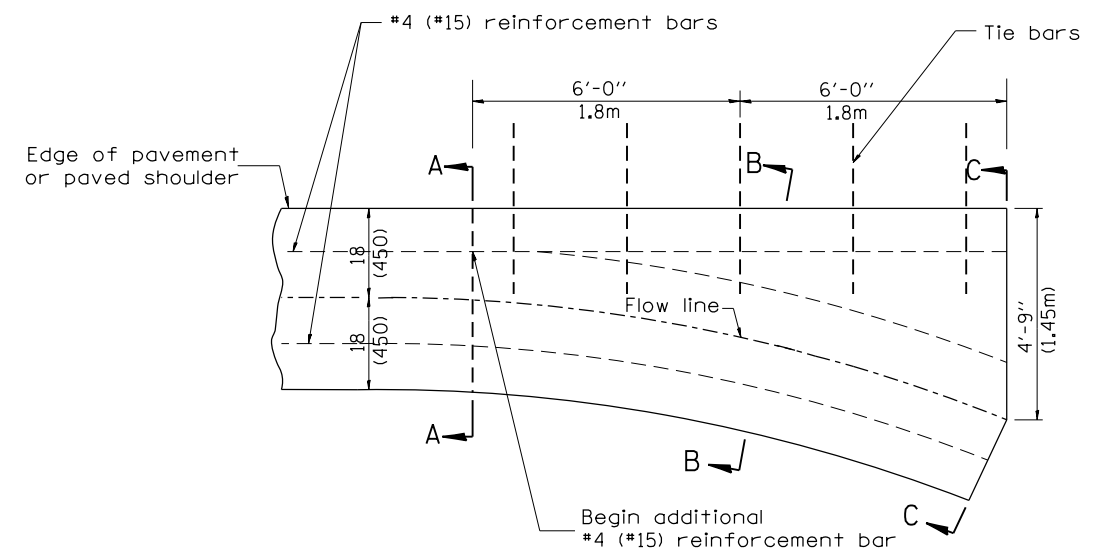


PLAN

QUANTITY
Section C-C to A-A= 1.2 cu. yd.
(0.92 m³) concrete.

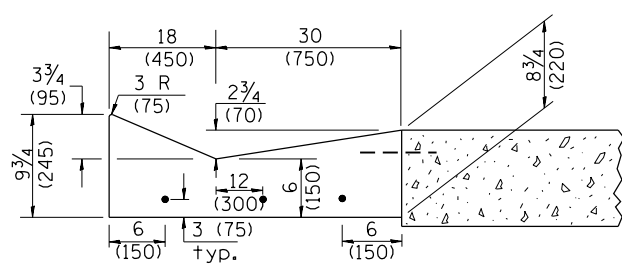

SECTION B-B

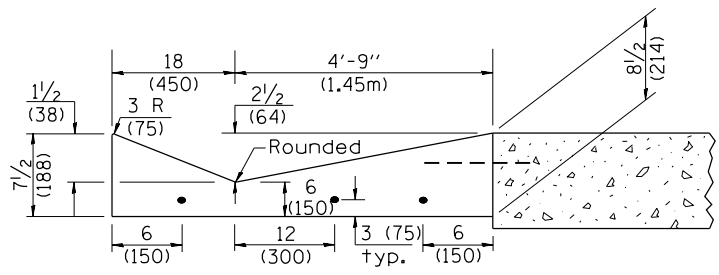

SECTION C-C

INLET

GENERAL NOTES:

1. CONCRETE GUTTER, TYPE A, (SPECIAL) shall conform to the applicable portions of Section 606.
2. Tie bars shall be No. 6 (No. 20) at 24" (600mm) centers unless otherwise shown.
3. Gutter, gutter inlets, gutter outlets, and gutter entrances shall be tied to rigid pavement in accordance with details shown on Standard 420001.
4. Joints shall be constructed in accordance with Article 606.06.
5. Welded wire fabric shall conform to Article 1006.10(c)(1), and shall not be less than 58 lbs/100 sq.ft. (2.83 kg/m²).

QUANTITIES
CALC. BY: _____ DATE: _____
CHECKED BY: _____ DATE: _____

QUANTITY CALCULATIONS ARE ON FILE AT THE DISTRICT 4 OFFICE; BUREAU OF PROJECT IMPLEMENTATION; DOCUMENTATION SECTION

01-01-97	RENUM. A-1.02, NEW REVISION BOX, ELIMINATED	T.P.	01-10-07	REVISED QUANTITY	M.A.
	EXPANSION ANCHOR TIES		11-16-07	REVISED QUANTITY	M.A.
02-28-02	ENTRANCE TYPICALS REVISED	M.A.	02-15-11	CHANGED MODIFIED TO SPECIAL	R.D.
10-16-06	REVISED TO 2007 SPEC.	M.A.			

**STATE OF ILLINOIS
DEPARTMENT OF TRANSPORTATION**


**CONCRETE GUTTER, TYPE A, (SPECIAL)
(INLET, OUTLET & ENTRANCE)**

NOT TO SCALE


SHT. 1 OF 3
CADD STD. 606101-D4

All dimensions are in inches (millimeters) unless otherwise noted.


F.A.P. RTE.	SECTION	COUNTY	TOTAL SHEETS	SHEET NO.
574	(12)CR	*	202	79
FED. ROAD DIST. NO. ILLINOIS FED. AID PROJECT			CONTRACT NO. 68C64	

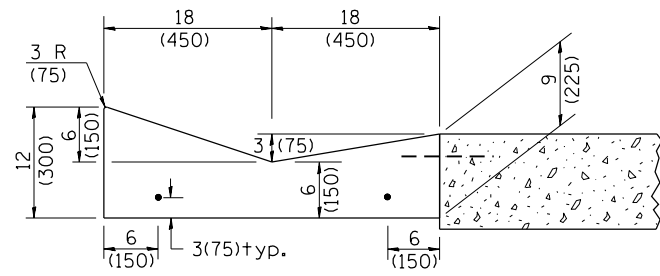


SECTION A-A

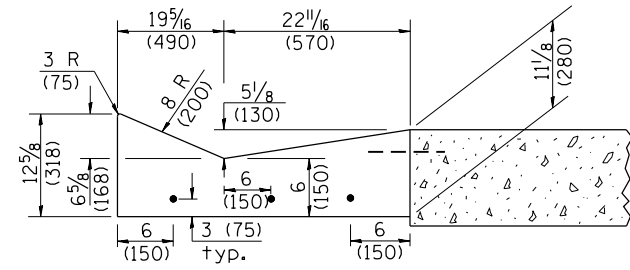


SECTION B-B

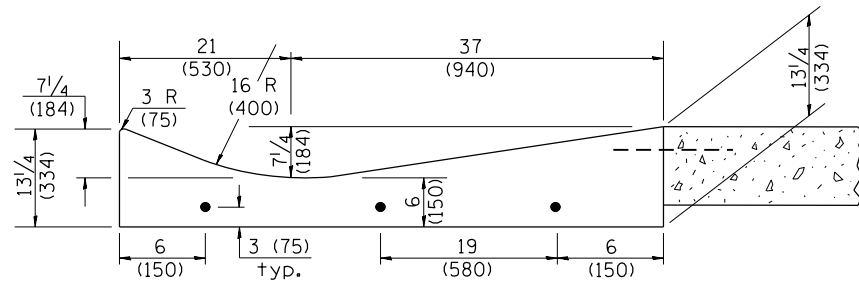

SECTION C-C

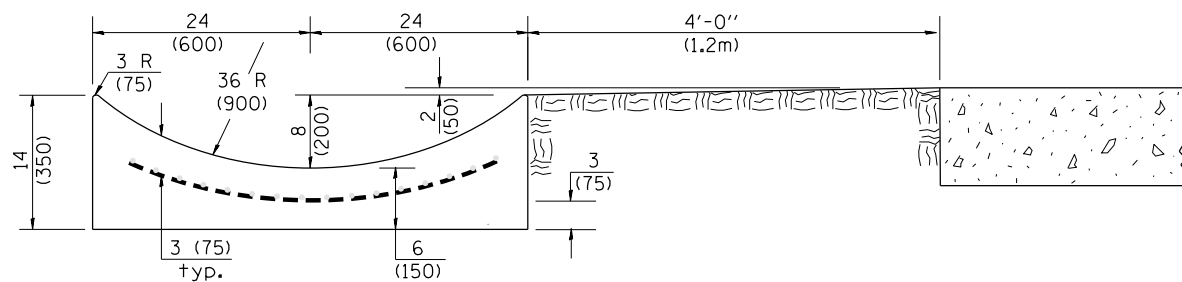


SECTION E-E

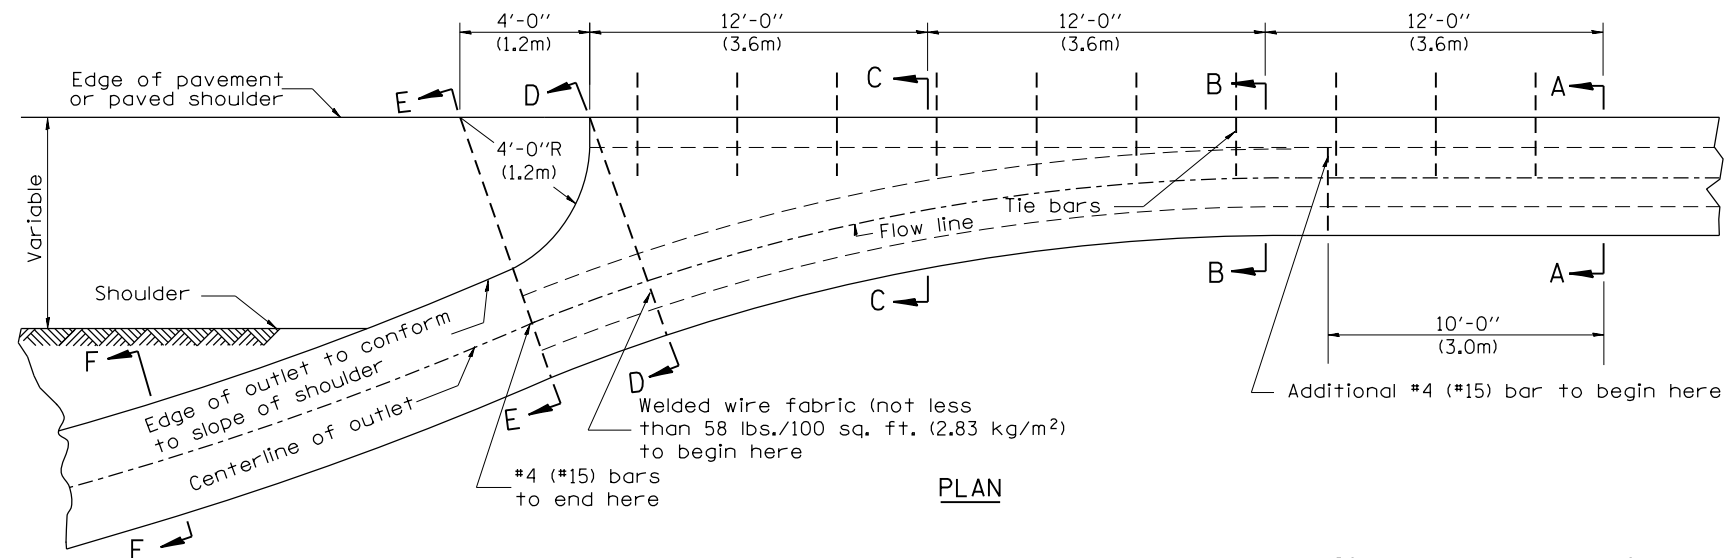


PLAN

QUANTITY
 Section A-A to E-E = 4.5 cu. yd. (3.36 m³) concrete.
 Section E-E to F-F = 0.10 cu. yd./ft. (0.26 m³/m) concrete.


If the average grade of pavement for the distance from section A-A to section D-D exceeds 2%, this distance shall be increased 6 ft. (1.8 m) for each 1% increase in grade. A quantity adjustment is required.

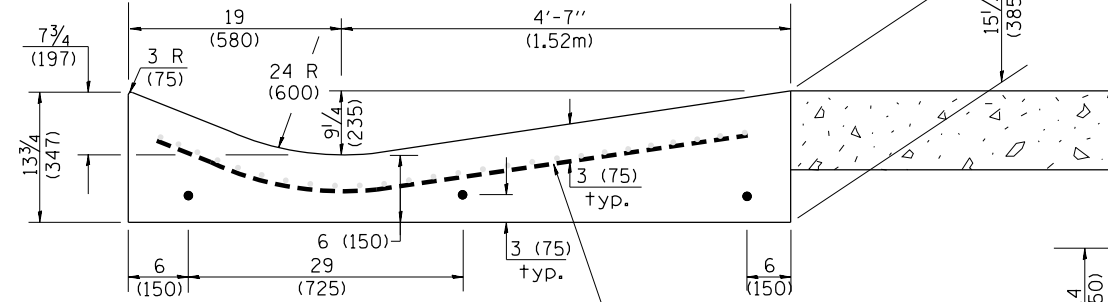


SECTION D-D

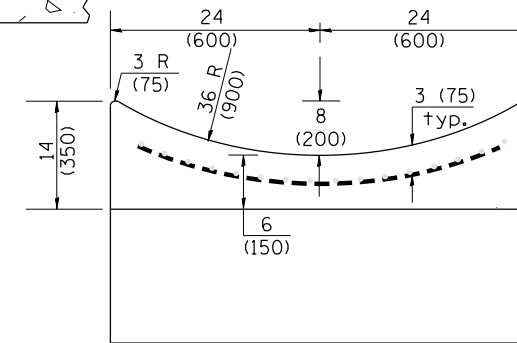

SECTION F-F

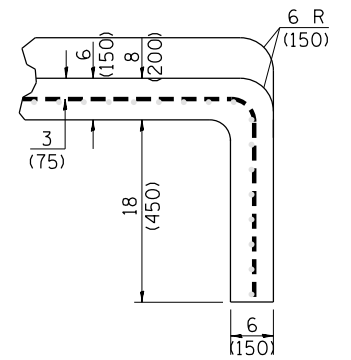

SECTIONS AT END OF OUTLET
(CURTAIN WALL)

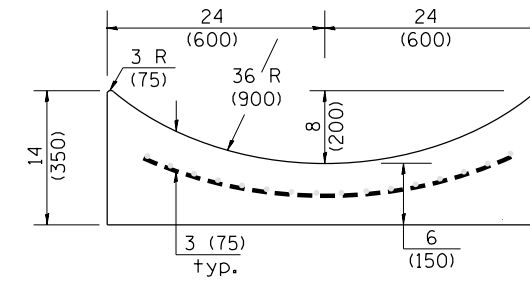

QUANTITY
 Curtain Wall = 0.1 cu. yd. (0.08 m³) concrete.

QUANTITIES
 CALC. BY: _____ DATE: _____
 CHECKED BY: _____ DATE: _____
 QUANTITY CALCULATIONS ARE ON FILE AT THE DISTRICT 4 OFFICE; BUREAU OF PROJECT IMPLEMENTATION; DOCUMENTATION SECTION

OUTLET

STATE OF ILLINOIS
 DEPARTMENT OF TRANSPORTATION

CONCRETE GUTTER, TYPE A, (SPECIAL)
 (INLET, OUTLET & ENTRANCE)


NOT TO SCALE

SHT. 2 OF 3
 CADD STD. 606101-D4


All dimensions are in inches (millimeters) unless otherwise noted.

F.A.P. RTE.	SECTION	COUNTY	TOTAL SHEETS	SHEET NO.
574	(12)CR		202	80
CONTRACT NO. 68C64				

FED. ROAD DIST. NO. ILLINOIS FED. AID PROJECT FULTON / McDONOUGH

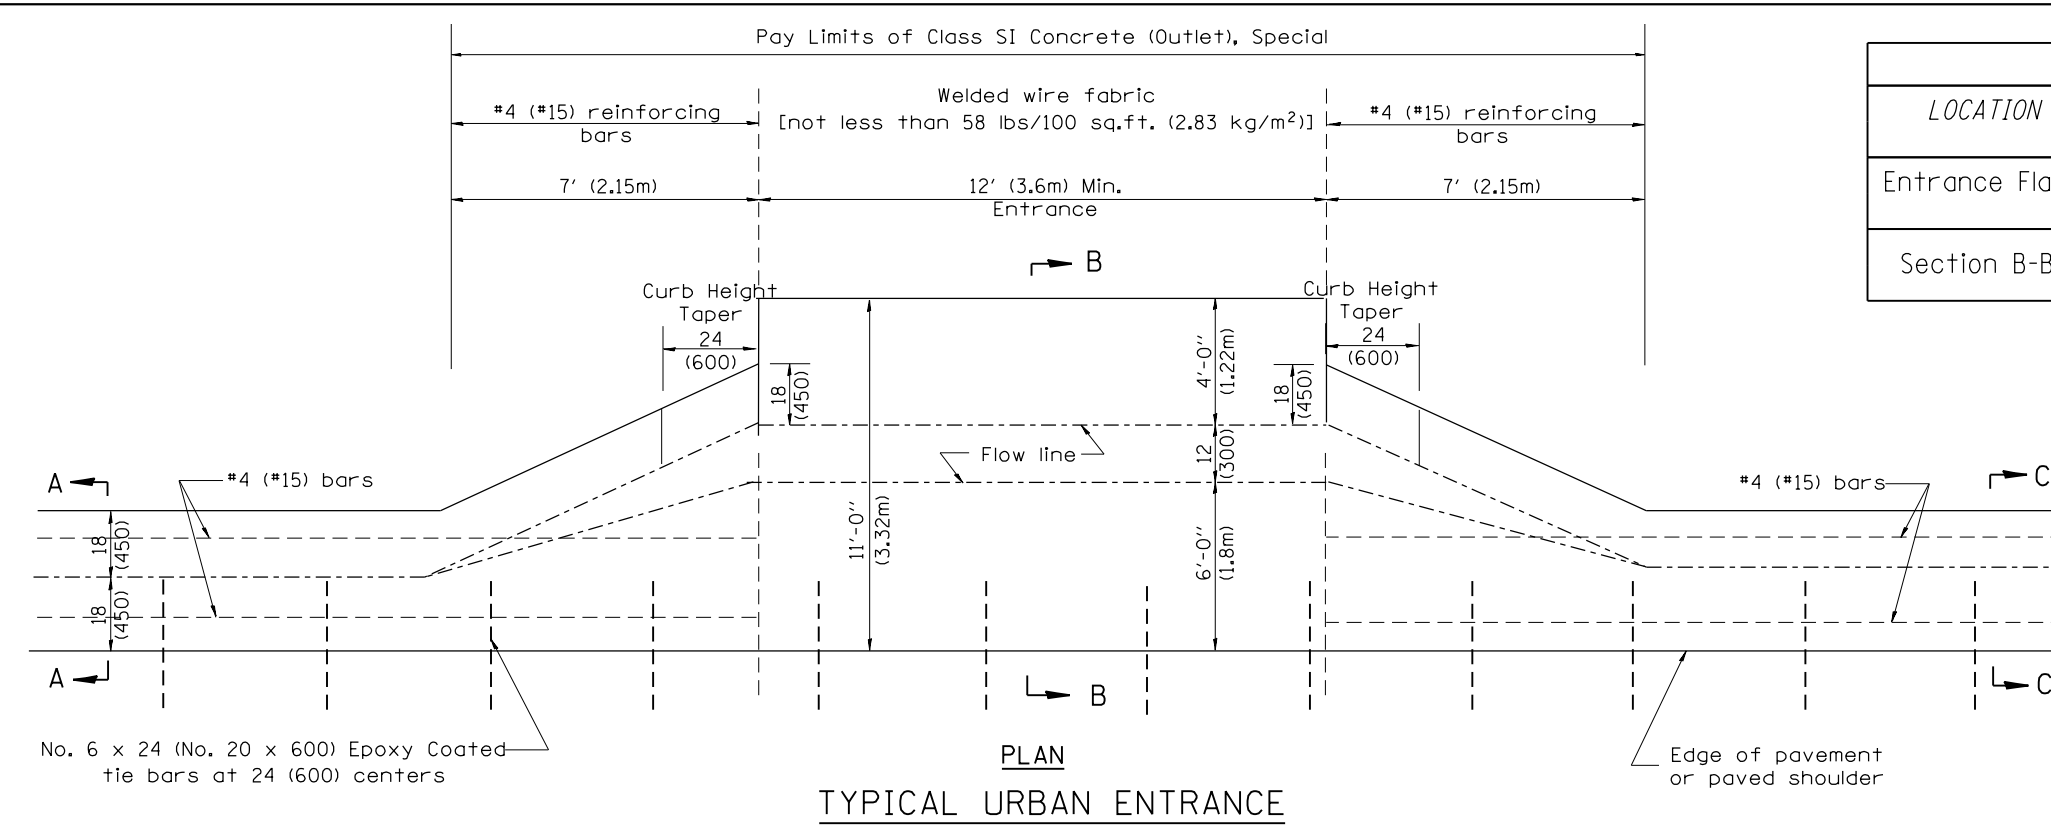

No. 6 x 24 (No. 20 x 600) Epoxy Coated tie bars at 24 (600) centers

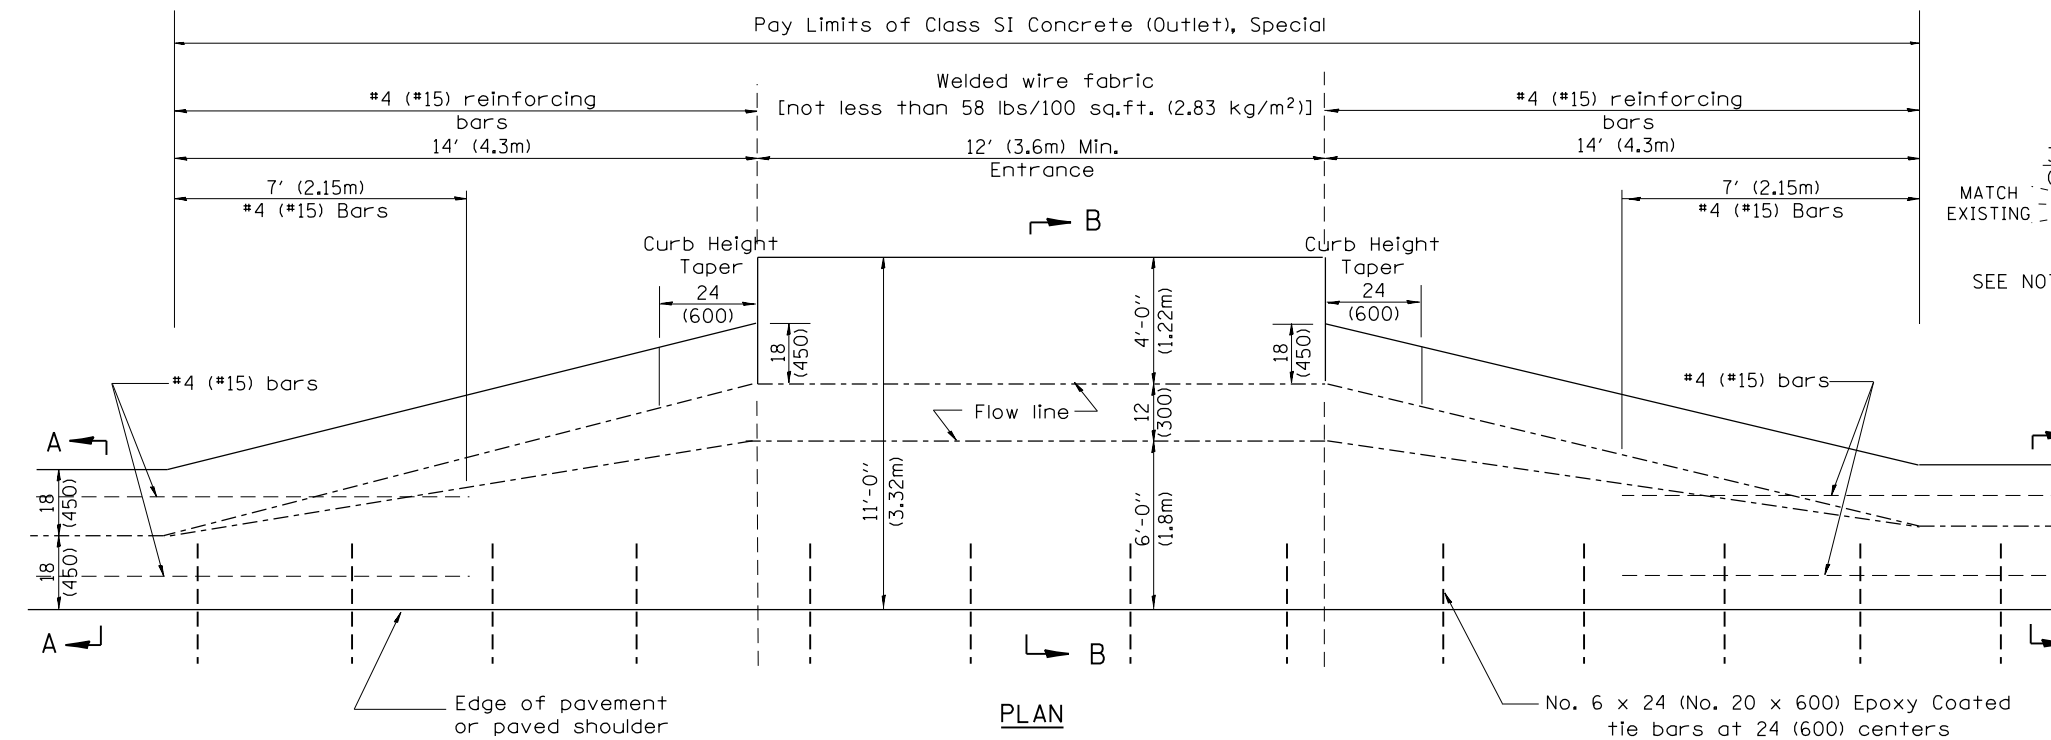



QUANTITIES

CALC. BY: _____ DATE: _____

CHECKED BY: _____ DATE: _____

QUANTITY CALCULATIONS ARE ON FILE AT THE DISTRICT 4 OFFICE; BUREAU OF PROJECT IMPLEMENTATION; DOCUMENTATION SECTION

QUANTITY CALCULATION			
LOCATION	LENGTH	NON-COMMERCIAL 6 (150)	COMMERCIAL ENTRANCE 8 (200)
Entrance Flare	7 Ft (2.15 m) Urban 14 Ft (4.30 m) Rural	0.15 Cu Yd / Ft (0.37 Cu M / M)	0.18 Cu Yd / Ft (0.45 Cu M / M)
Section B-B	See Plans	0.23 Cu Yd / Ft (0.57 Cu M / M)	0.28 Cu Yd / Ft (0.70 Cu M / M)

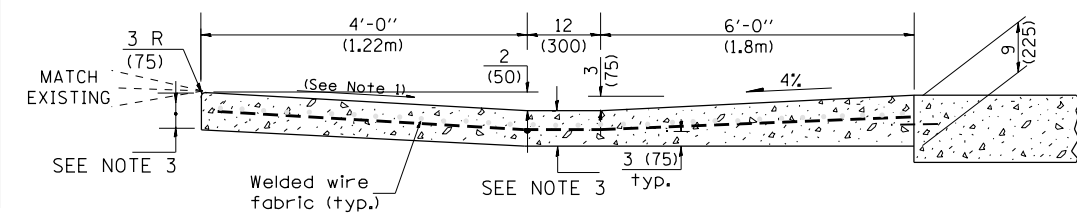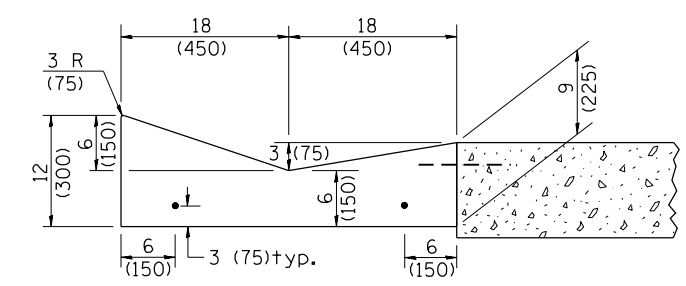

- GENERAL NOTES**
- Slope may be increased from 4% (min.) to 6% (max.) in order to match the existing.
 - The cross-slope is to be constructed as given in the plans from back turnout to where driveway matches existing.
 - For Non-Commercial Entrances the driveway thickness shall be 6 (150). For Commercial Entrances the driveway thickness shall be 8 (200).

All dimensions are in inches (millimeters) unless otherwise noted.


STATE OF ILLINOIS
DEPARTMENT OF TRANSPORTATION

CONCRETE GUTTER, TYPE A, (SPECIAL)
(INLET, OUTLET & ENTRANCE)


SHT. 3 OF 3
CADD STD. 606101-D4

F.A.P. RTE.	SECTION	COUNTY	TOTAL SHEETS	SHEET NO.
574	(12)CR	*	202	81
CONTRACT NO. 68C64				

NOT TO SCALE

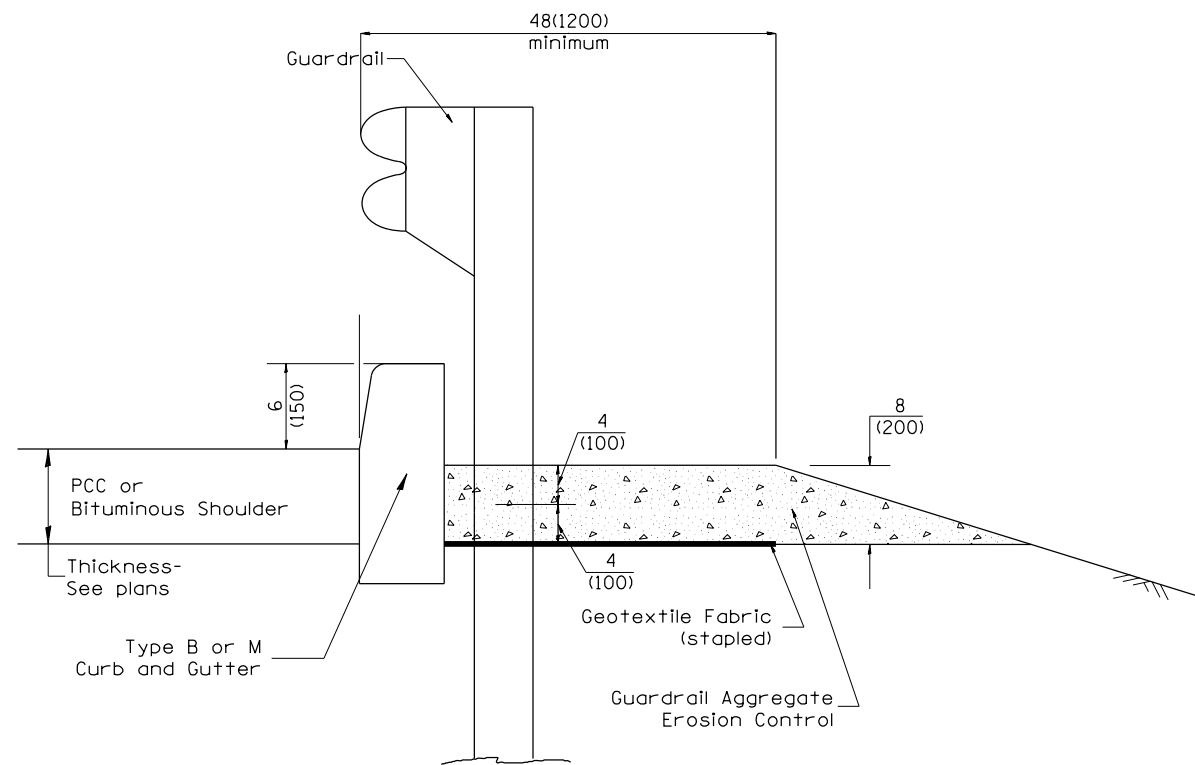


TYPICAL SECTION WITH EROSION CONTROL CURB

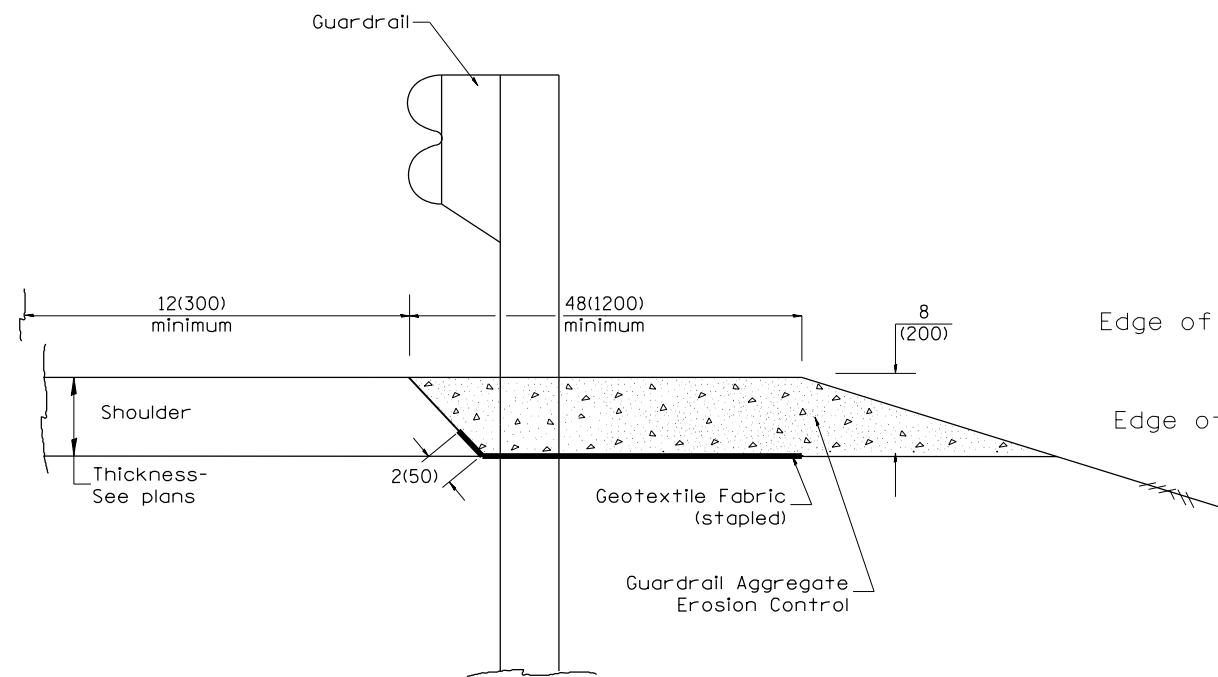

TYPICAL SECTION WITHOUT EROSION CONTROL CURB

GENERAL NOTES: GUARDRAIL AGGREGATE EROSION CONTROL

1. This work shall consist of grading as needed, furnishing and installing geotextile fabric and staples, and furnishing, placing and shaping crushed aggregate around and behind Steel Plate Beam Guardrail posts in accordance with Plan Details.
2. Before placing the aggregate and the Geotextile Fabric, weeds and grass shall be removed from the area to be covered.
3. After the area has been prepared, and in a dry condition, the Geotextile fabric shall be placed with a 12(300) minimum overlap. A knife cut for guardrail post installation is necessary.
4. The aggregate shall be deposited, compacted and shaped by either mechanical or hand methods, in a manner reasonably true to line and grade.
5. The Contractor shall have the option of placing the guardrail before or after the Geotextile Fabric and Aggregate are in place. If the guardrail is placed after the Geotextile Fabric and Aggregate, then any voids must be filled and the aggregate returned to line and grade.
6. Materials shall meet the following requirements:
 - A. The crushed aggregate shall be CA1 gradation in accordance with Article 1004.01(c) of the Standard Specifications.
 - B. The Geotextile Fabric shall be nonwoven fabric in accordance with Article 1080.02 of the Standard Specifications.

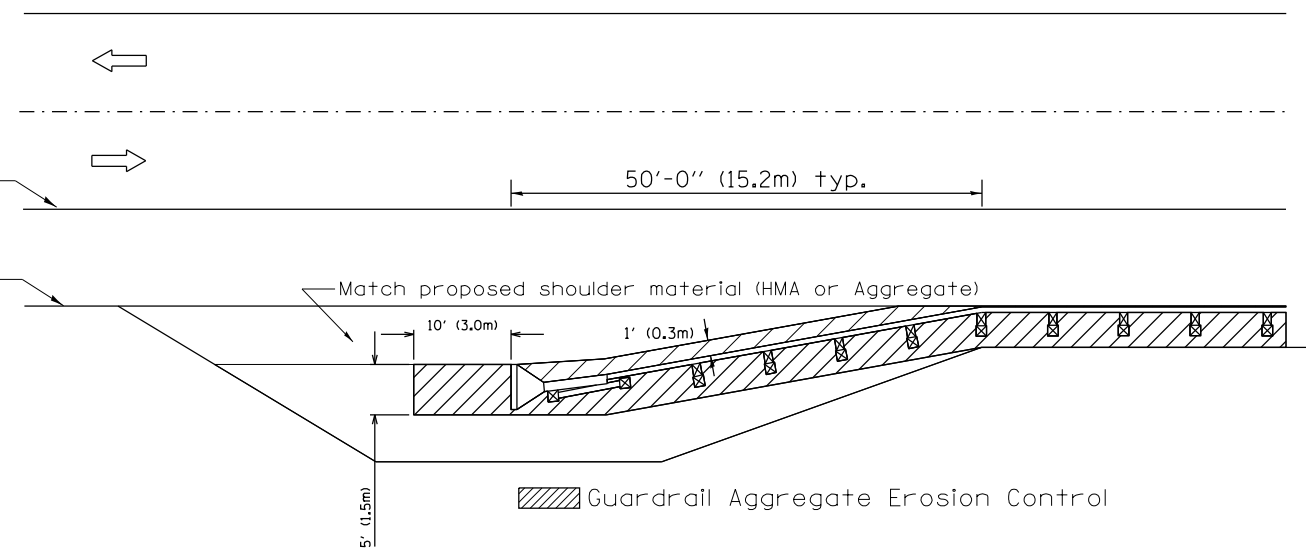

All dimensions are in inches (millimeters) unless otherwise noted.

01-01-97	RENUM. C-22.01, NEW REVISION BOX	T.P.	03-07-11	ADDED DETAIL SHOWING PLAN VIEW	R.D.
03-01-97	CORRECT STD. NUMBERS IN NOTES PG. 2	J.A.	08-10-12	REVISED CURB "B" AND AGGREGATE	R.D.
11-03-00	CORRECTION TO NOTES	M.A.	07-15-15	ADDRESSED SHOULDER INLET CURB	R.D.
10-16-06	REVISED TO 2007 SPEC.	M.A.	01-26-17	REVISED	R.D.



**STATE OF ILLINOIS
DEPARTMENT OF TRANSPORTATION**

GUARDRAIL EROSION CONTROL TREATMENTS


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SHT. 1 OF 2
CADD STD. 630101-D4


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574	(12)CR	*	202	82
FED. ROAD DIST. NO. ILLINOIS FED. AID PROJECT			CONTRACT NO. 68C64	

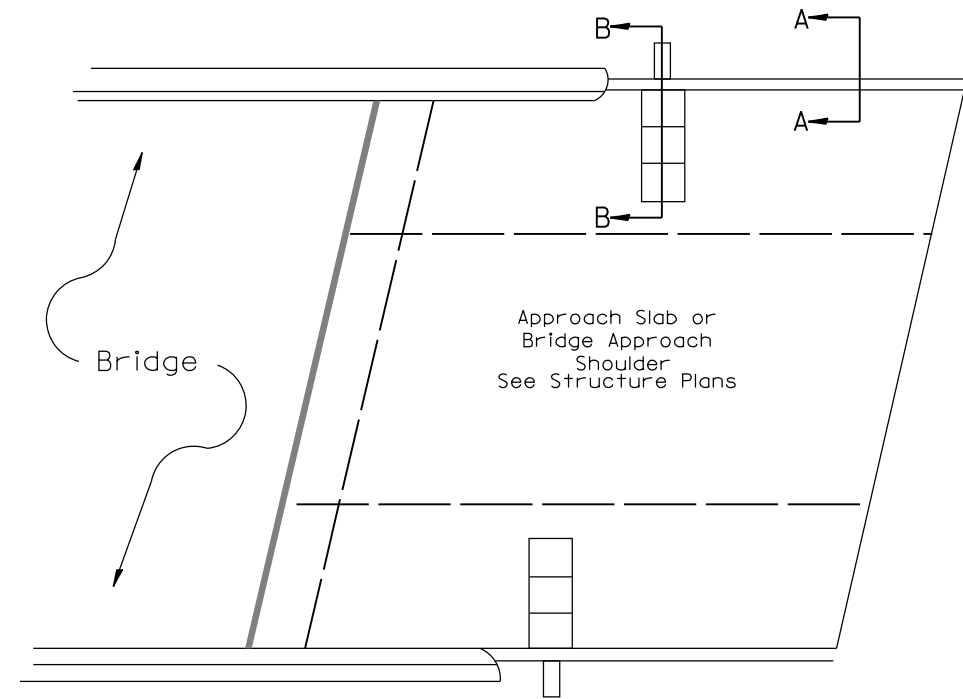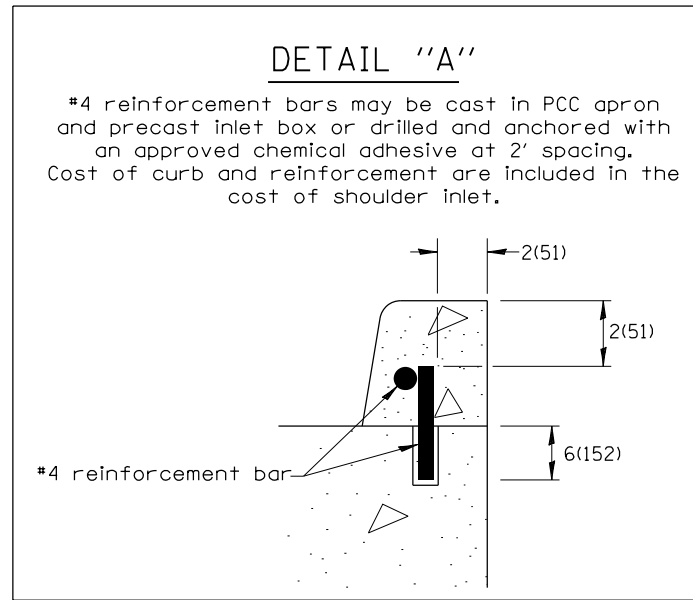

PLAN VIEW
APPROACH SLAB OR SHOULDER PLACEMENT

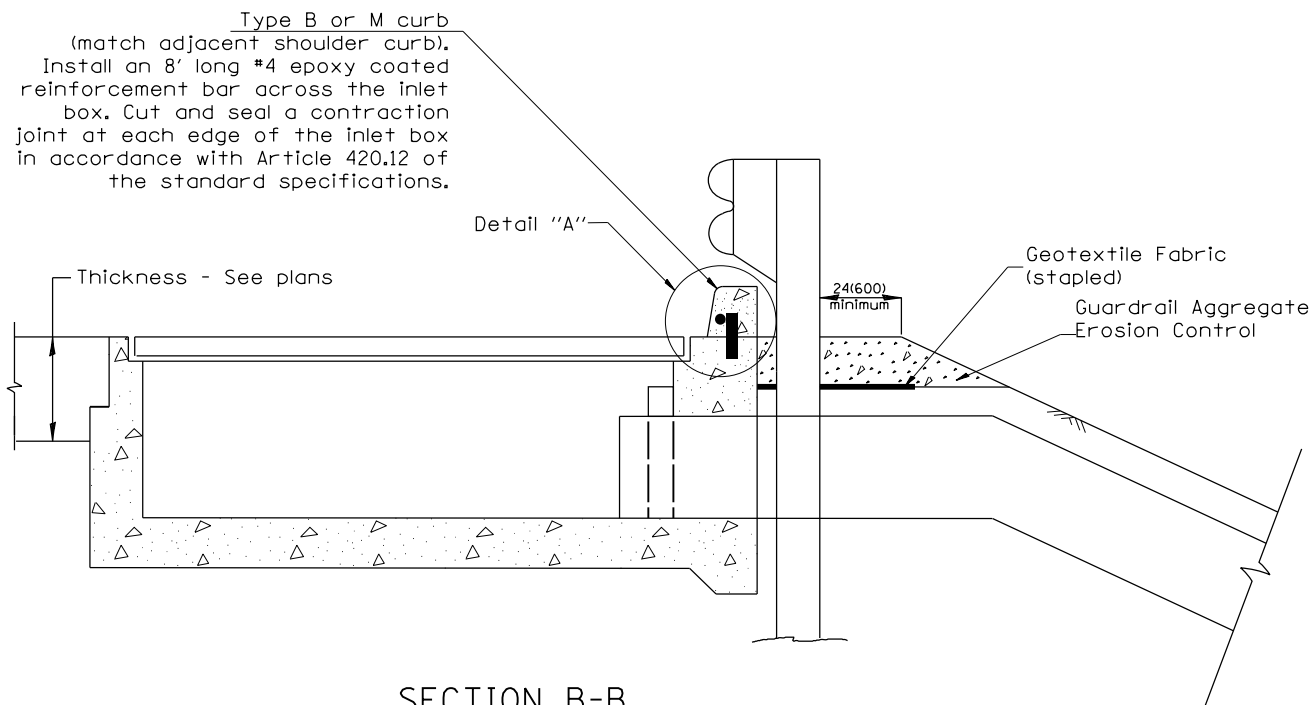

SECTION B-B
TYPICAL SECTION AT INLETS
TYPE E, F & G (HIGHWAY STANDARD 610001)

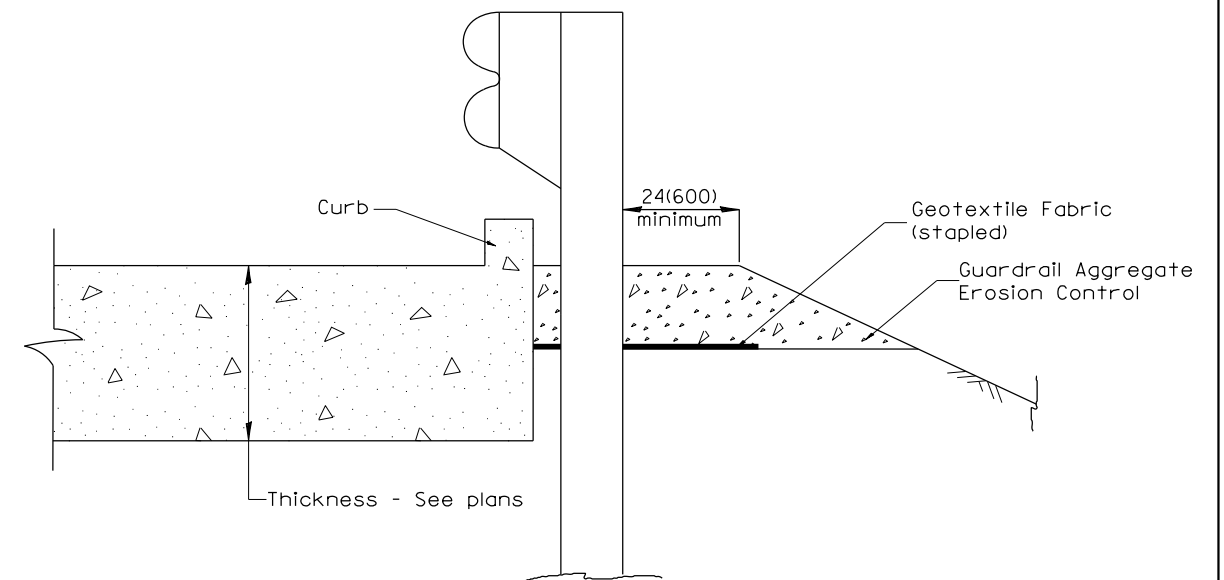


SECTION A-A
TYPICAL SECTION WITH BRIDGE APPROACH CURB

All dimensions are in inches (millimeters) unless otherwise noted.

STATE OF ILLINOIS DEPARTMENT OF TRANSPORTATION				GUARDRAIL EROSION CONTROL TREATMENTS				F.A.P. RTE.	SECTION	COUNTY	TOTAL SHEETS	SHEET NO.
				NOT TO SCALE				574	(12)CR	*	202	83
				SHT. 2 OF 2 CADD STD. 630101-D4				CONTRACT NO. 68C64				
								ILLINOIS FED. AID PROJECT				
								* FULTON / McDONOUGH				

PERMANENT SURVEY TIES


- Permanent Survey Tie
- Section Corner, 1/4 Corner, or other land corner.

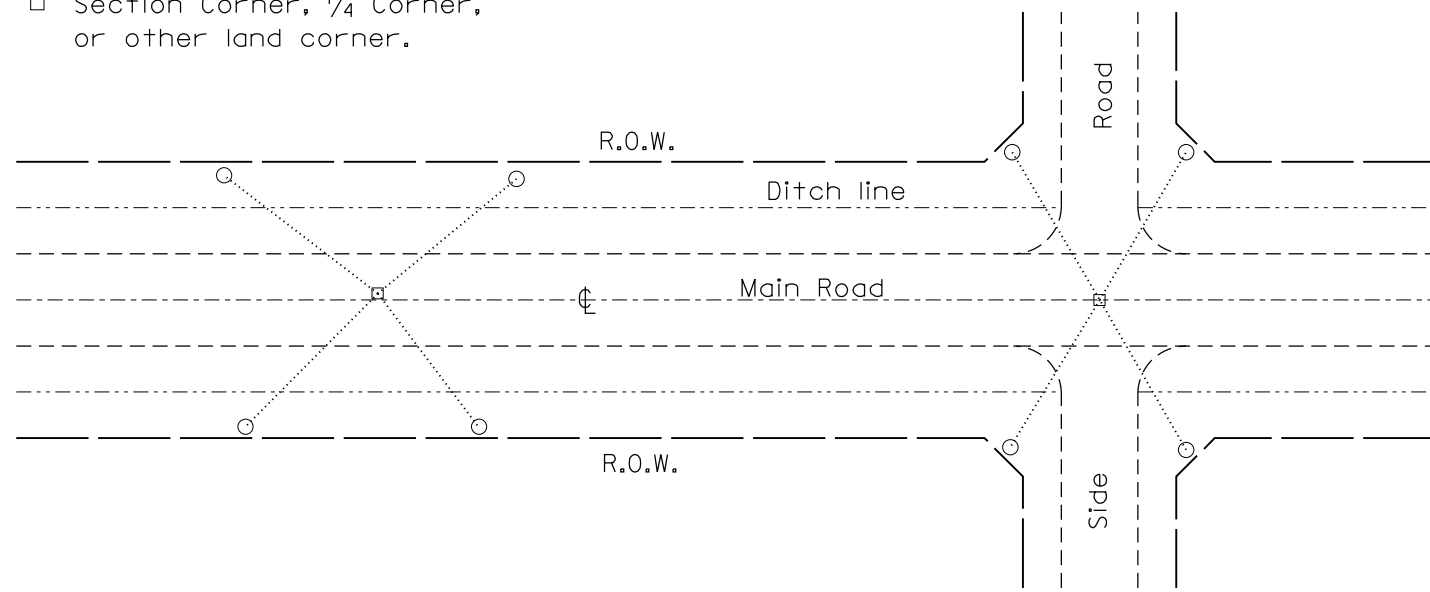


TYPICAL APPLICATION

GENERAL NOTES


1. The marker shall be cast in place of Class SI Concrete.
2. Tie marker shall be installed after the final seeding has been completed unless otherwise specified by the Engineer.
3. The tie distances to the section corner shall be measured and recorded by the surveyor setting the PSM. All ties shall be turned over to the IDOT Chief of Surveys or Chief of Plats after recordation.
4. All documentation shall be performed by a PLS

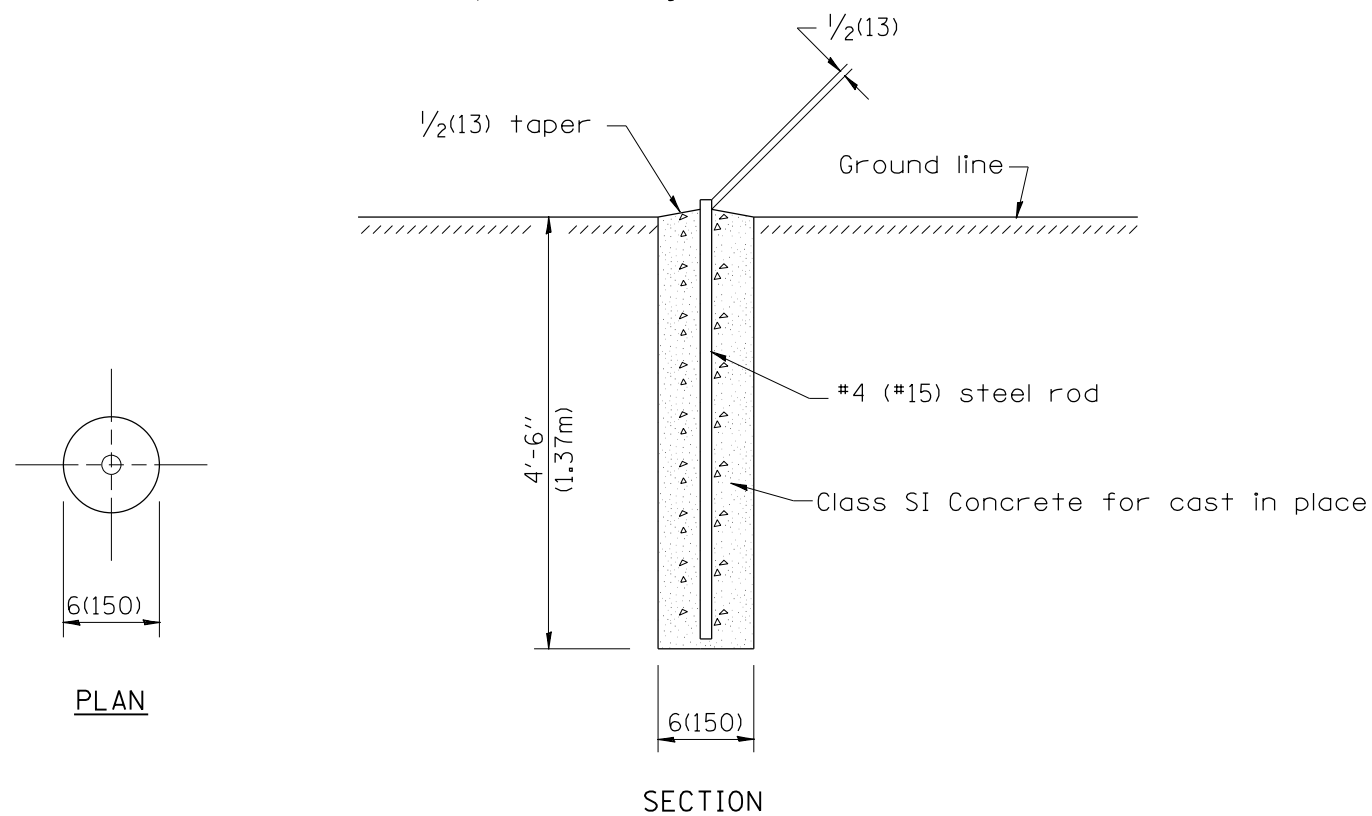

PERMANENT SURVEY MARKERS

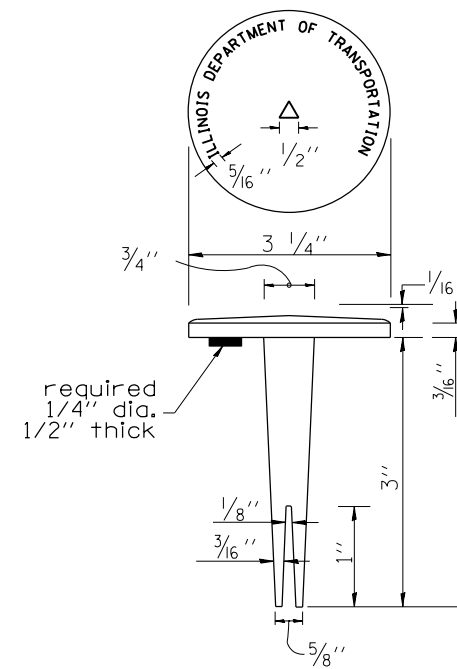

BRASS TABLET

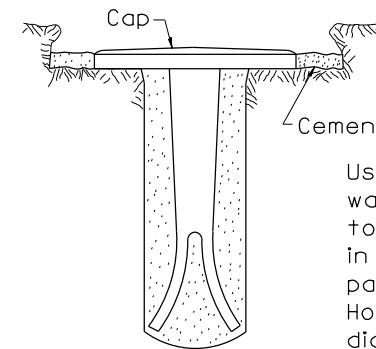


Tablet constructed in rock ledge or concrete.

TYPE I

GENERAL NOTES

1. All type II markers shall be cast in place, and precast markers will not be allowed.
2. Two permanent magnets, each having a diameter of 3/4 (19) and a thickness of 1/4 (6), or equivalent, shall be attached to the underside of the tablet with an approved epoxy bonding agent.
3. The location of the markers shall be in accordance with the plans in general, the markers will be placed at the P.T.'s, P.C.'s, and P.I.'s located within the R.O.W. of horizontal curves and spaces along the tangents in a way that a minimum of two markers are always inter-visible, and not to exceed 1000' (300m).
4. The markers shall be placed under the direction of the Engineer and shall be installed in a workmanlike manner in order that there will be no further settlement or horizontal shifting. The monuments shall be placed in a way that the survey point will fall within the portion of the plaque provided for that purpose.
5. The project designation, the centerline station, the survey point, and the elevation shall be permanently marked by the use of metal dies after marker has been installed.

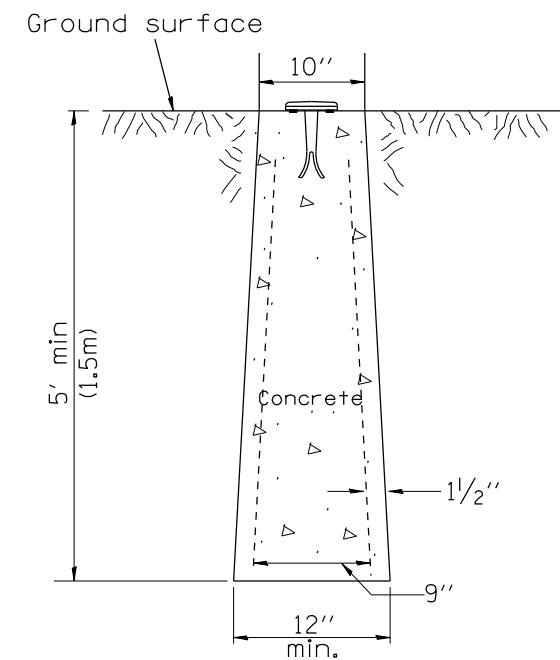

**TYPE II
CAST-IN-PLACE MARKER**

All dimensions are in inches (millimeters) unless otherwise noted.

01-01-97	RENUM. D-3.01, NEW REVISION BOX, REVISED	T.P.	10-16-06	REVISED TO 2007 SPEC.	M.A.
	TITLE BOX, ADD DESIGNER NOTE		01-04-11	REVISED FOR CORRECTIONS	R.D.
07-07-98	ADD DESIGNER NOTE	J.A.	08-21-13	CHANGED MIN. DIAMETER	R.D.
05-24-06	REMOVED GEN. NOTE UNDER TIES	M.A.	08-25-15	REVISED MATERIAL	R.D.

**STATE OF ILLINOIS
DEPARTMENT OF TRANSPORTATION**


**PERMANENT SURVEY TIE &
PERMANENT SURVEY MARKERS TY.I - TY.II**

NOT TO SCALE

CADD STD. 667101-D4

F.A.P. RTE.	SECTION	COUNTY	TOTAL SHEETS	SHEET NO.
574	(12)CR	*	202	84
CONTRACT NO. 68C64				

FED. ROAD DIST. NO. ILLINOIS FED. AID PROJECT
• FULTON / McDONOUGH

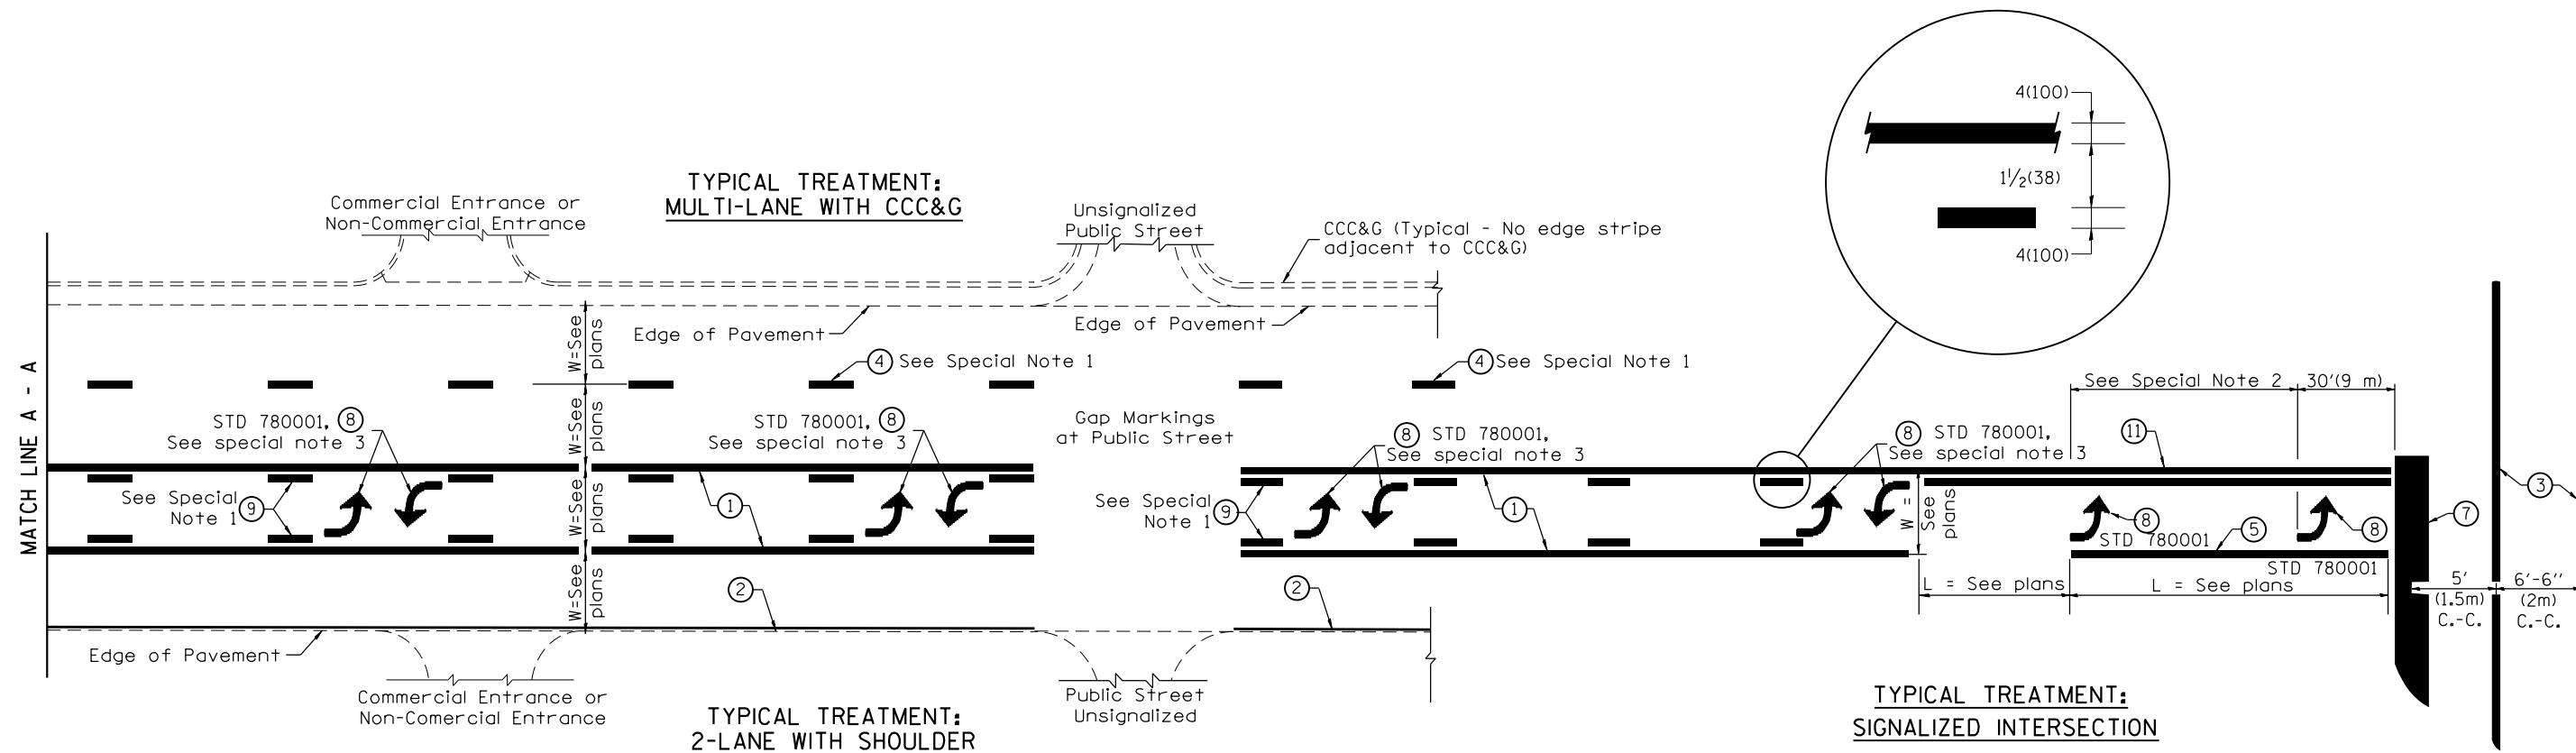

FLUSH PAVED MEDIAN: TWO-WAY LEFT TURN LANE WITH ONE-WAY LEFT TURN LANE AT SIGNALIZED INTERSECTION

TYPICAL PAVEMENT MARKING LEGEND

(Note: This is a District Standard Legend. Some elements may not apply to specific project.)

- ① 4(100) Solid (Yellow)
- ② 4(100) Solid (White)
- ③ 2-6(150) Crosswalk @ 6'-6" (2m)min C.-C. (White)
2-8(200) Crosswalk @ 6'-6" (2m)min C.-C. (White) (When traffic signals are present.)
- ④ 6(150) Skip-Dash (White) (See Special Note 1)
- ⑤ 8(200) Solid (White)
- ⑥ 12(300) Diagonal (White) (Item ⑥ is shown on Std. 780001)
- ⑦ 24(600) Stop Bar (White)
- ⑧ Letters & Arrows (See Std. 780001 and Special Notes 2 & 3)
- ⑨ 4(100) Skip-Dash (Yellow) (See Special Note 1)
- ⑩ 12(300) Diagonal (Yellow) (See Table A) ⑩
- ⑪ 4(100) Double Solid (Yellow) ⑪

SPECIAL NOTES

1. Skip-Dash markings will be centered between both ends of city blocks and shall be placed in alignment transversely across the pavement.
2. The following shall apply to arrows located in one-way left turn lanes:
 - A. A minimum of two (2) arrows is required.
 - B. The maximum spacing between arrows is 80' (24 m).
 - C. Arrows shall be evenly spaced if three (3) or more are required.
3. The following shall apply to arrow pairs located in two-way left turn lanes:
 - A. A minimum of two (2) arrow pairs is required.
 - B. The maximum spacing between arrow pairs is 200' (61 m).
 - C. Arrow pairs shall be evenly spaced if three (3) or more are required.
 - D. The spacing between Bi Directional Left Turn Arrows is 33' (10 m).

GENERAL NOTES

1. Refer to State Standard 780001 for additional Pavement Markings including letters & arrows.
2. See Plans for Pavement Markings adjacent to curbed islands and medians, and through lane reductions.
3. Refer to Article 780.13 for letter, number and symbol areas (sq. ft.)
4. Areas are grooved 1" beyond each edge for the following symbols:
Through Arrow= 14.8 sq. ft.
Large Left or Right Arrow= 21.9 sq. ft.
2 Arrow Combination Left (or Right) and Through= 34.9 sq. ft.
Wrong Way Arrow= 29.5 sq. ft.
Railroad Crossing Symbol= 69.8 sq. ft.
(For further information, refer to BDE Special Provision: Grooving for Recessed Pavement Markings)

01-01-97	RENUM. F-8.03, NEW REVISION BOX	T.P.	10-16-06	REVISED TO 2007 SPEC.	
02-07-97	ADD BI DIRECTIONAL DIMENSION	J.A.	2/29/16	ADDED GROOVING AREAS	R.D.
10-97	CORRECT BI DIRECTIONAL DIMENSION	J.A.	07-16-19	SPELLING CORRECTIONS	R.D.
08-02	ADD CROSSWALK DMNS. WITH T.S.	M.A.			

**STATE OF ILLINOIS
DEPARTMENT OF TRANSPORTATION**


NOT TO SCALE

TYPICAL PAVEMENT MARKINGS

SHT. 1 OF 2
CADD STD. 780001-D4

F.A.P. RTE.	SECTION	COUNTY	TOTAL SHEETS	SHEET NO.
574	(12)CR	*	202	85
CONTRACT NO. 68C64				


FED. ROAD DIST. NO. ILLINOIS FED. AID PROJECT FULTON / McDONOUGH

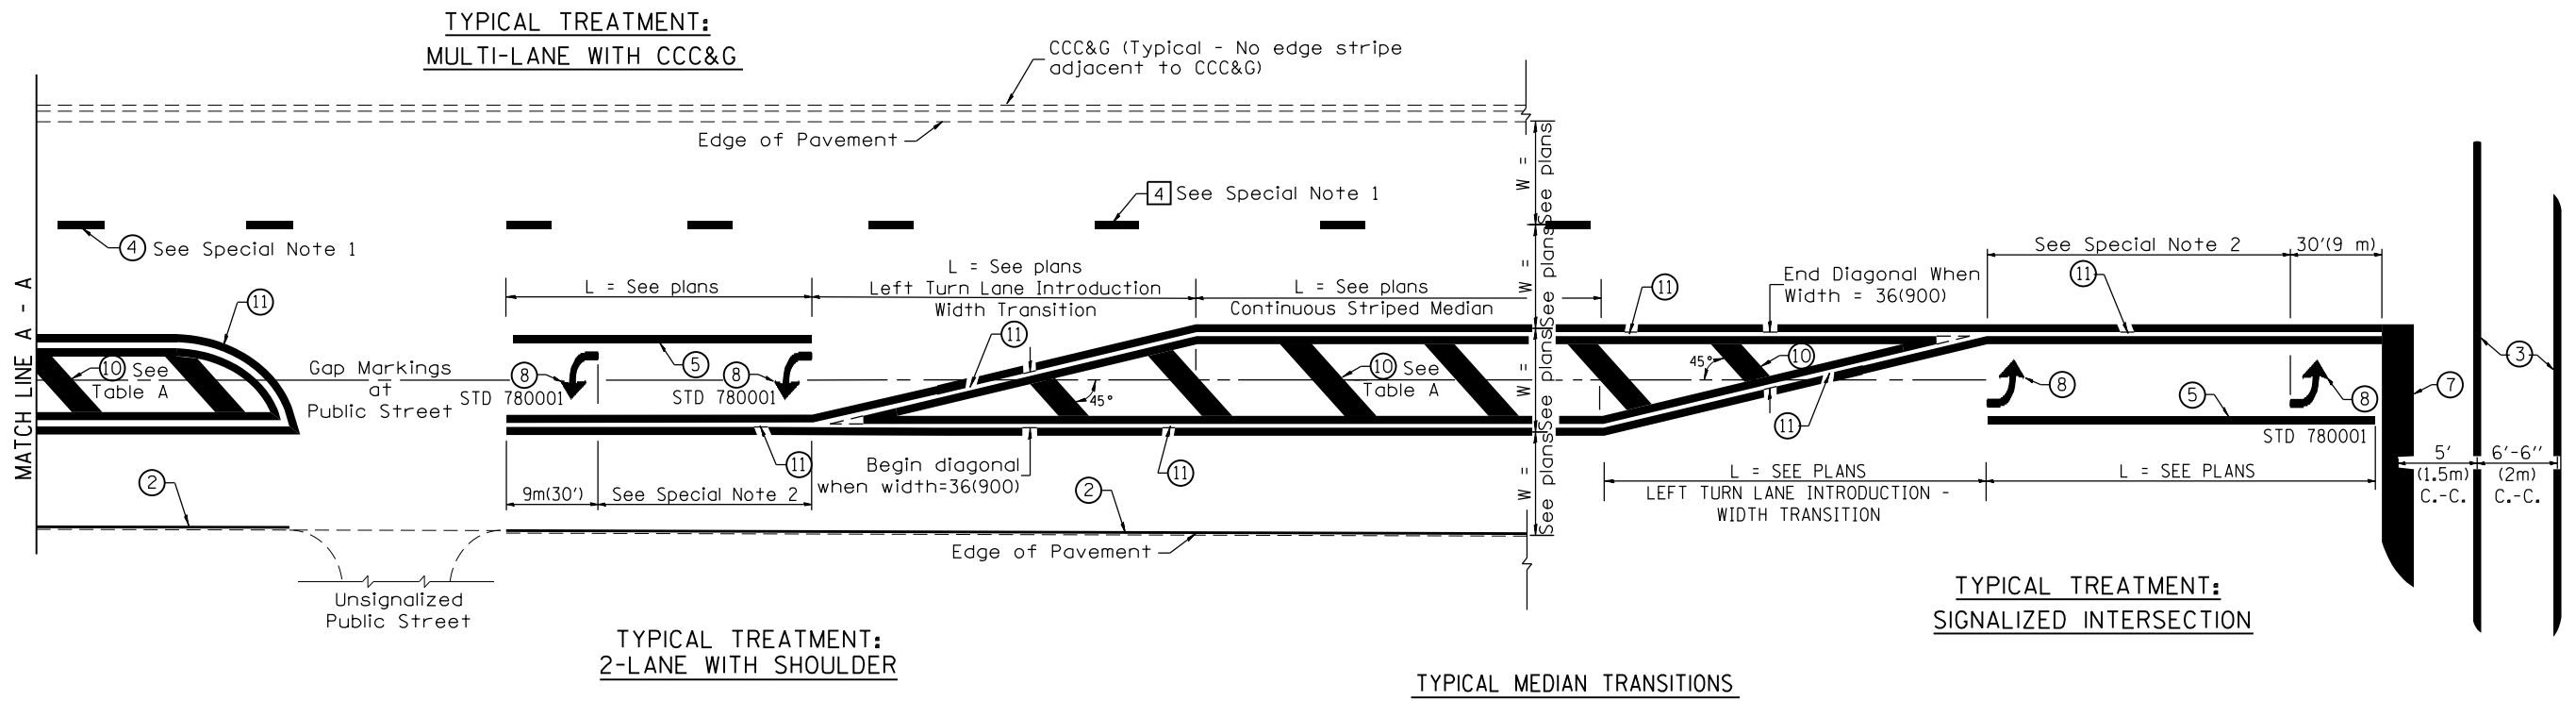

FLUSH PAVED MEDIAN: RESTRICTED LEFT TURN LANE

TABLE A
RECOMMENDED SPACING BETWEEN DIAGONAL LINES

SPEED LIMIT RANGE	INTERSECTION CHANNELIZATION (Includes Width Transitions for Median and Left Turn Lane Introductions)	
	CONTINUOUS	
Less Than 30 mph (50 km/h)	50' (15m)	15' (5m)
30 - 45 mph (50 - 70 km/h)	75' (23m)	20' (6m)
Over 45 mph (70 km/h)	150' (46m)	30' (9m)

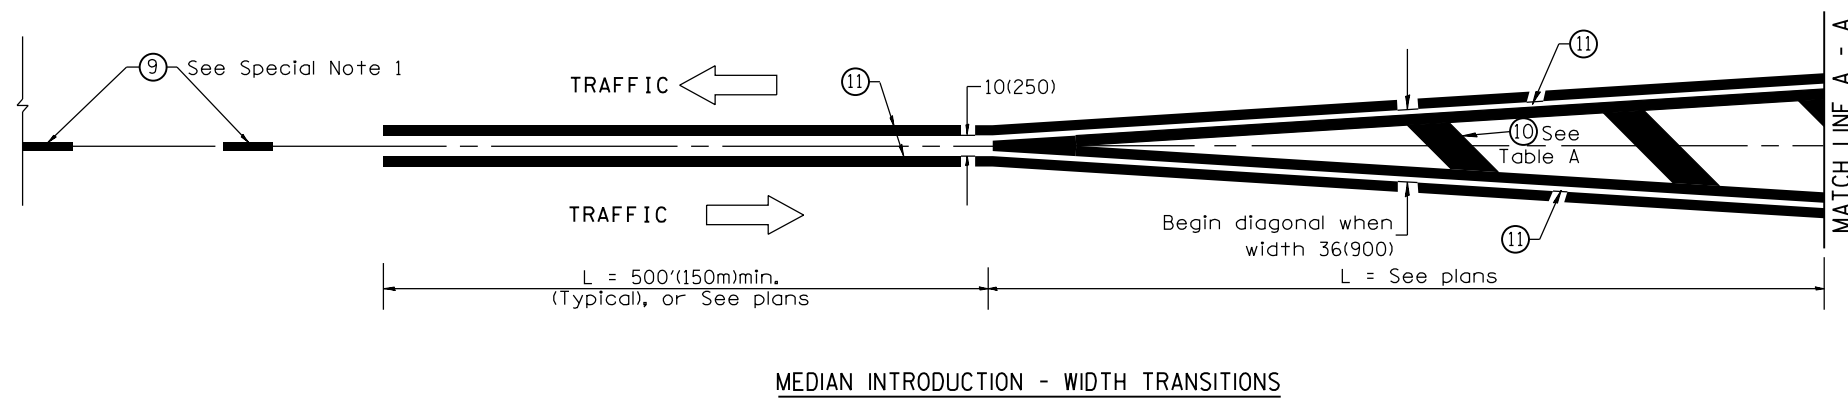


All dimensions are in inches (millimeters) unless otherwise noted.

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NOTE BOOK	PLOTTED		
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**STATE OF ILLINOIS
DEPARTMENT OF TRANSPORTATION**


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CONTRACT NO. 68C64				
ILLINOIS FED. AID PROJECT			* FULTON / McDONOUGH	

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**STATE OF ILLINOIS
 DEPARTMENT OF TRANSPORTATION**

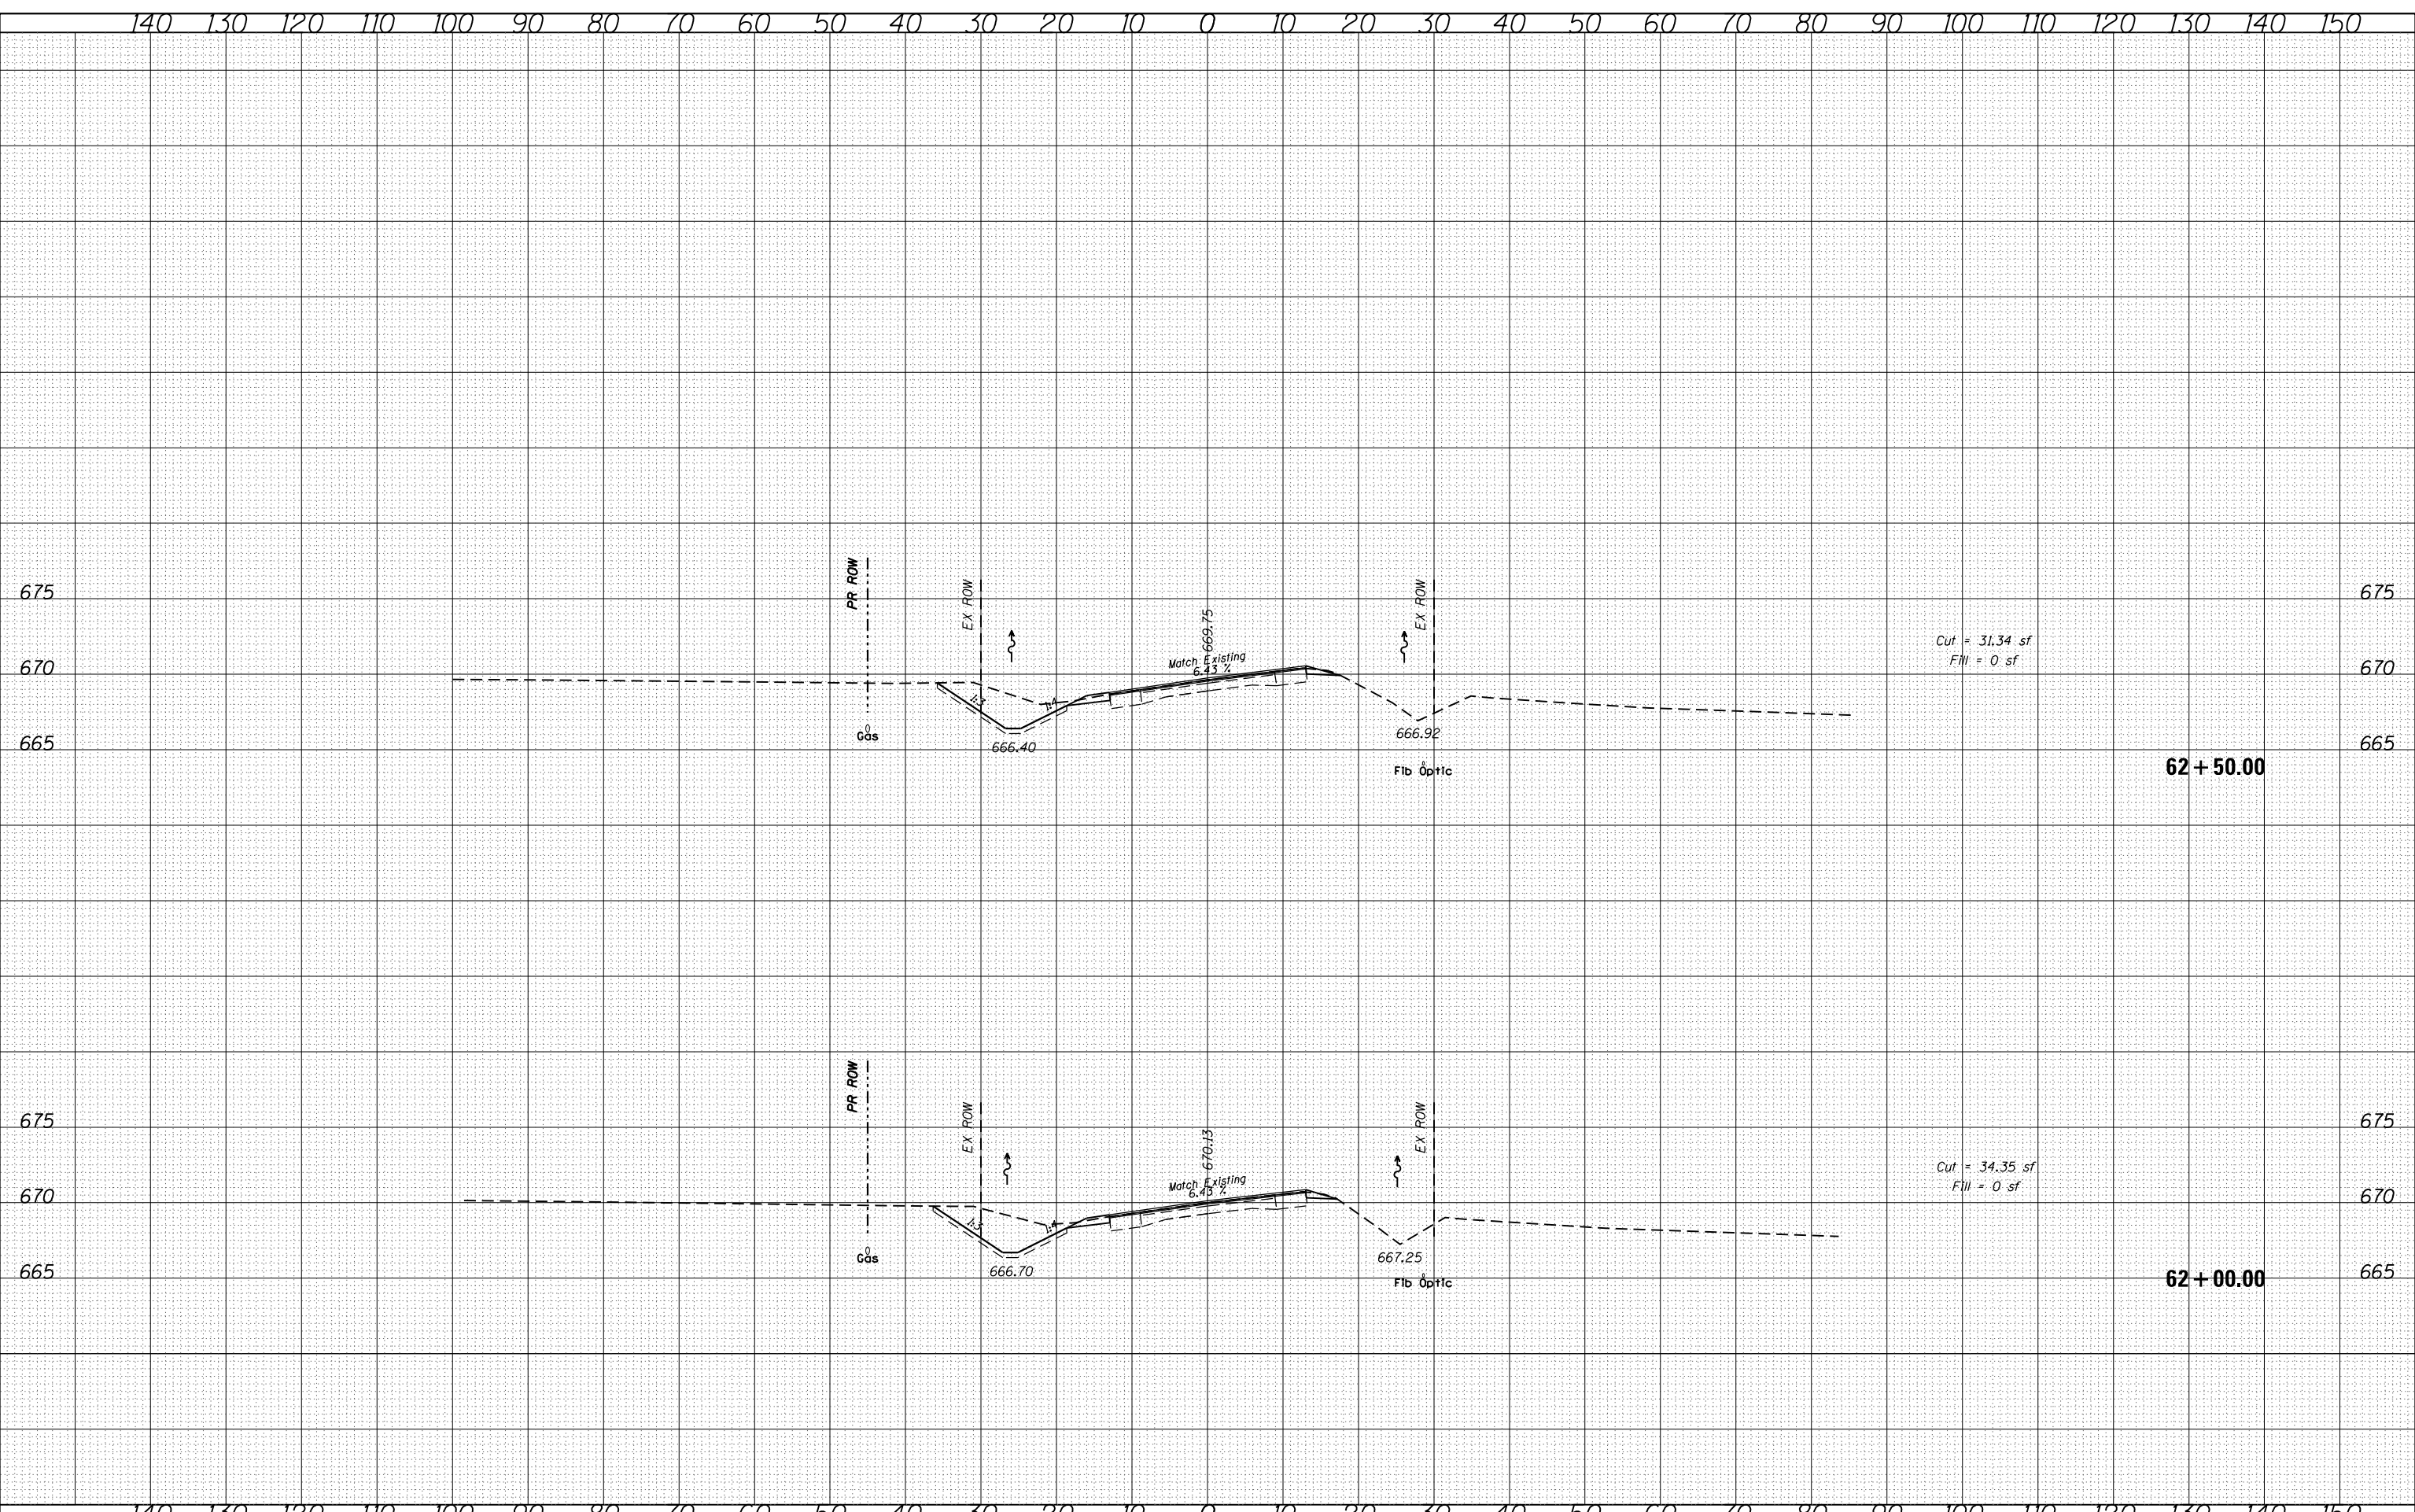**IL 41
 CROSS SECTIONS**


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CONTRACT NO. 68C64			ILLINOIS FED. AID PROJECT	

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**STATE OF ILLINOIS
DEPARTMENT OF TRANSPORTATION**

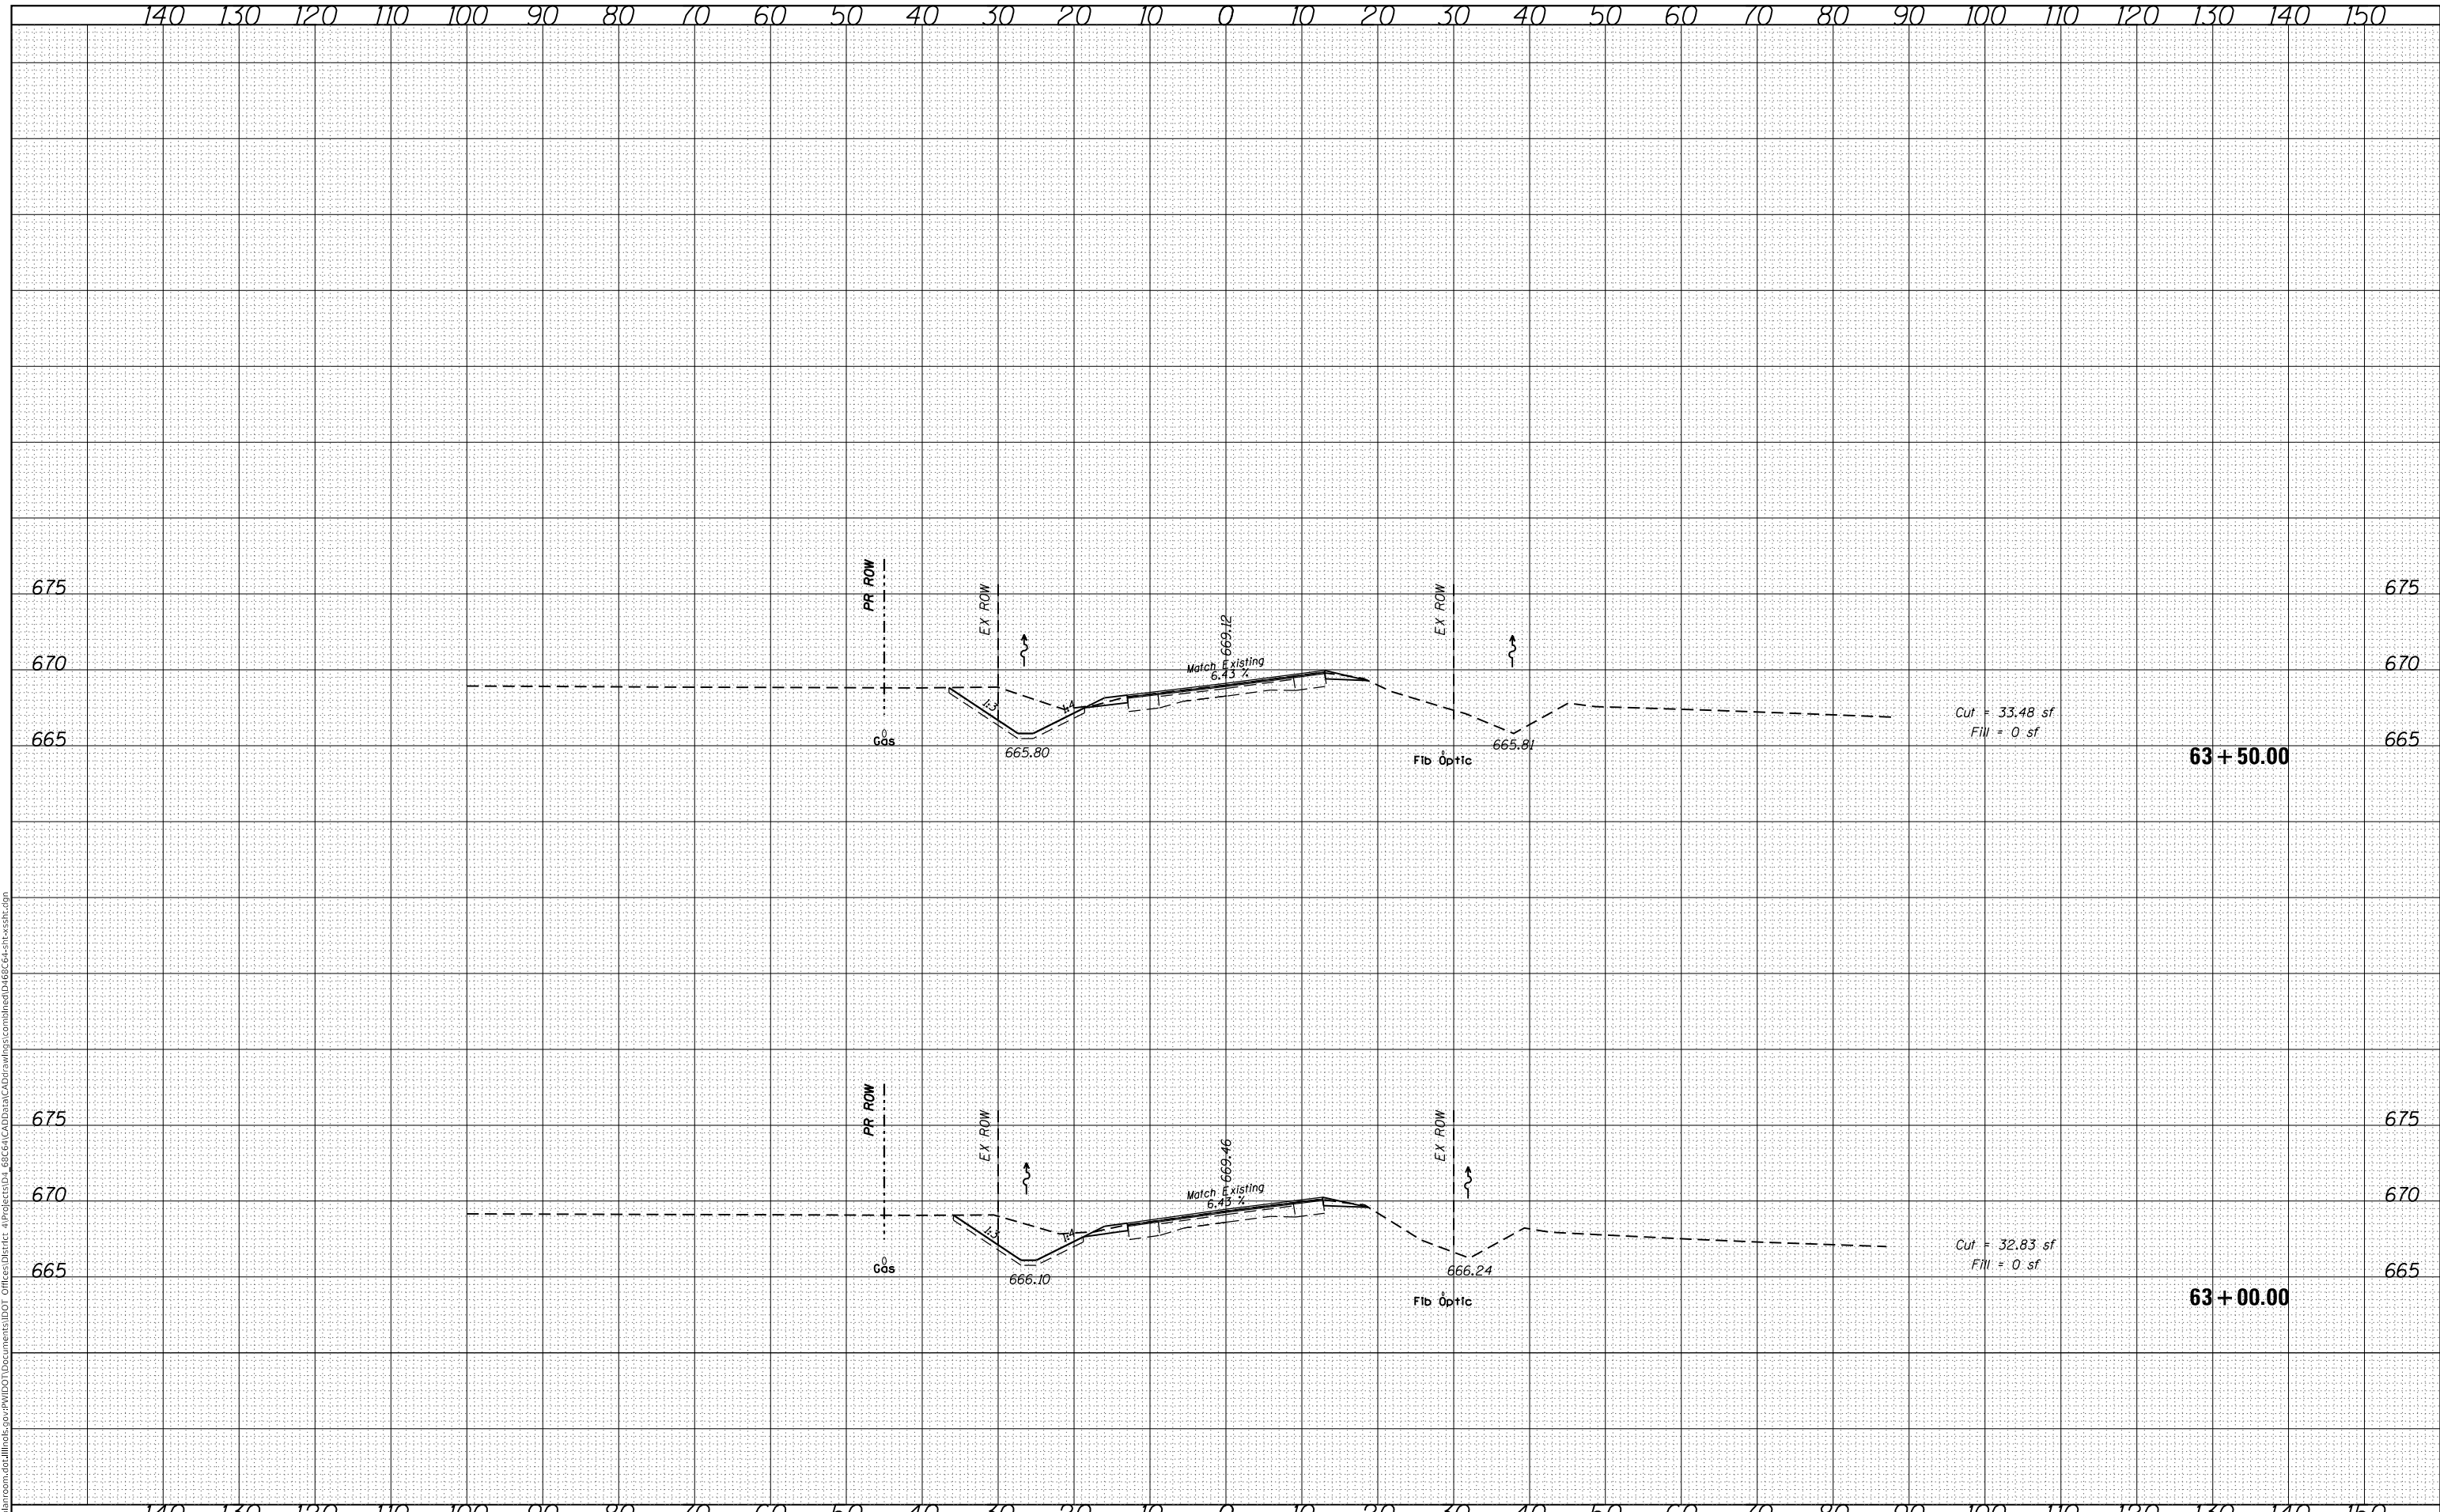**IL 41
CROSS SECTIONS**


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CONTRACT NO. 68C64				
ILLINOIS FED. AID PROJECT				

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**STATE OF ILLINOIS
DEPARTMENT OF TRANSPORTATION**

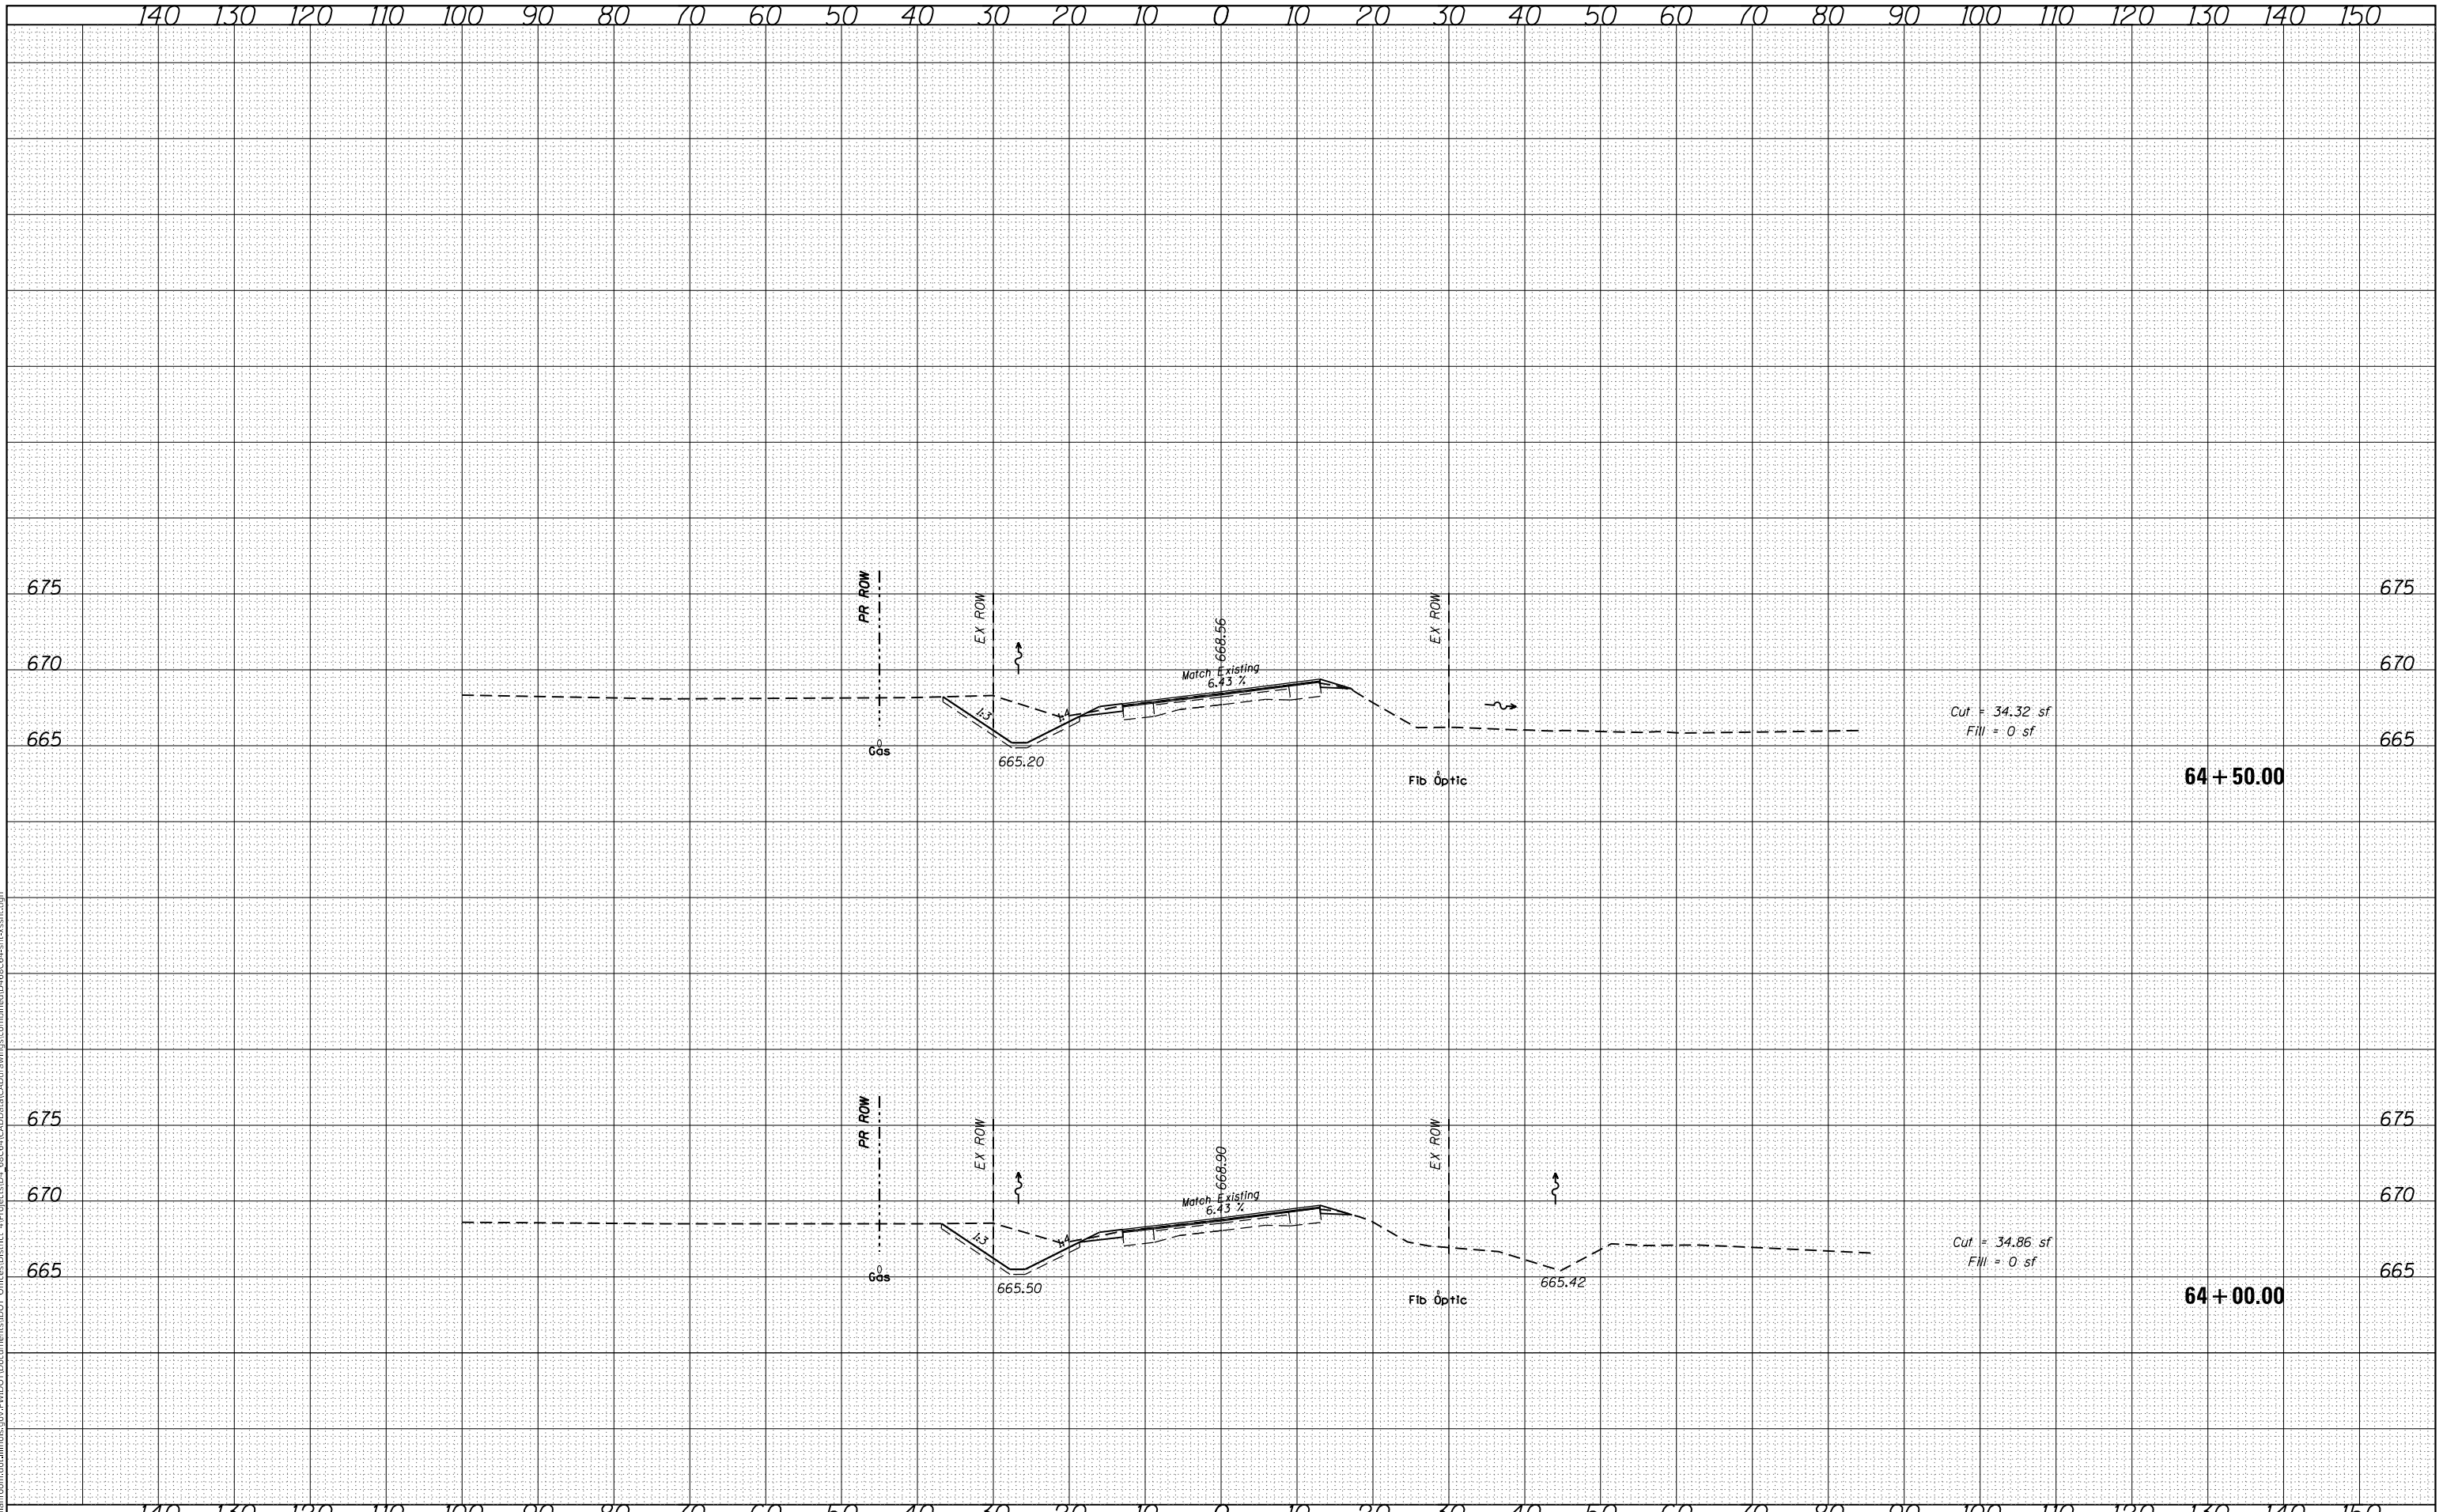**IL 41
CROSS SECTIONS**


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CONTRACT NO. 68C64				
ILLINOIS FED. AID PROJECT				

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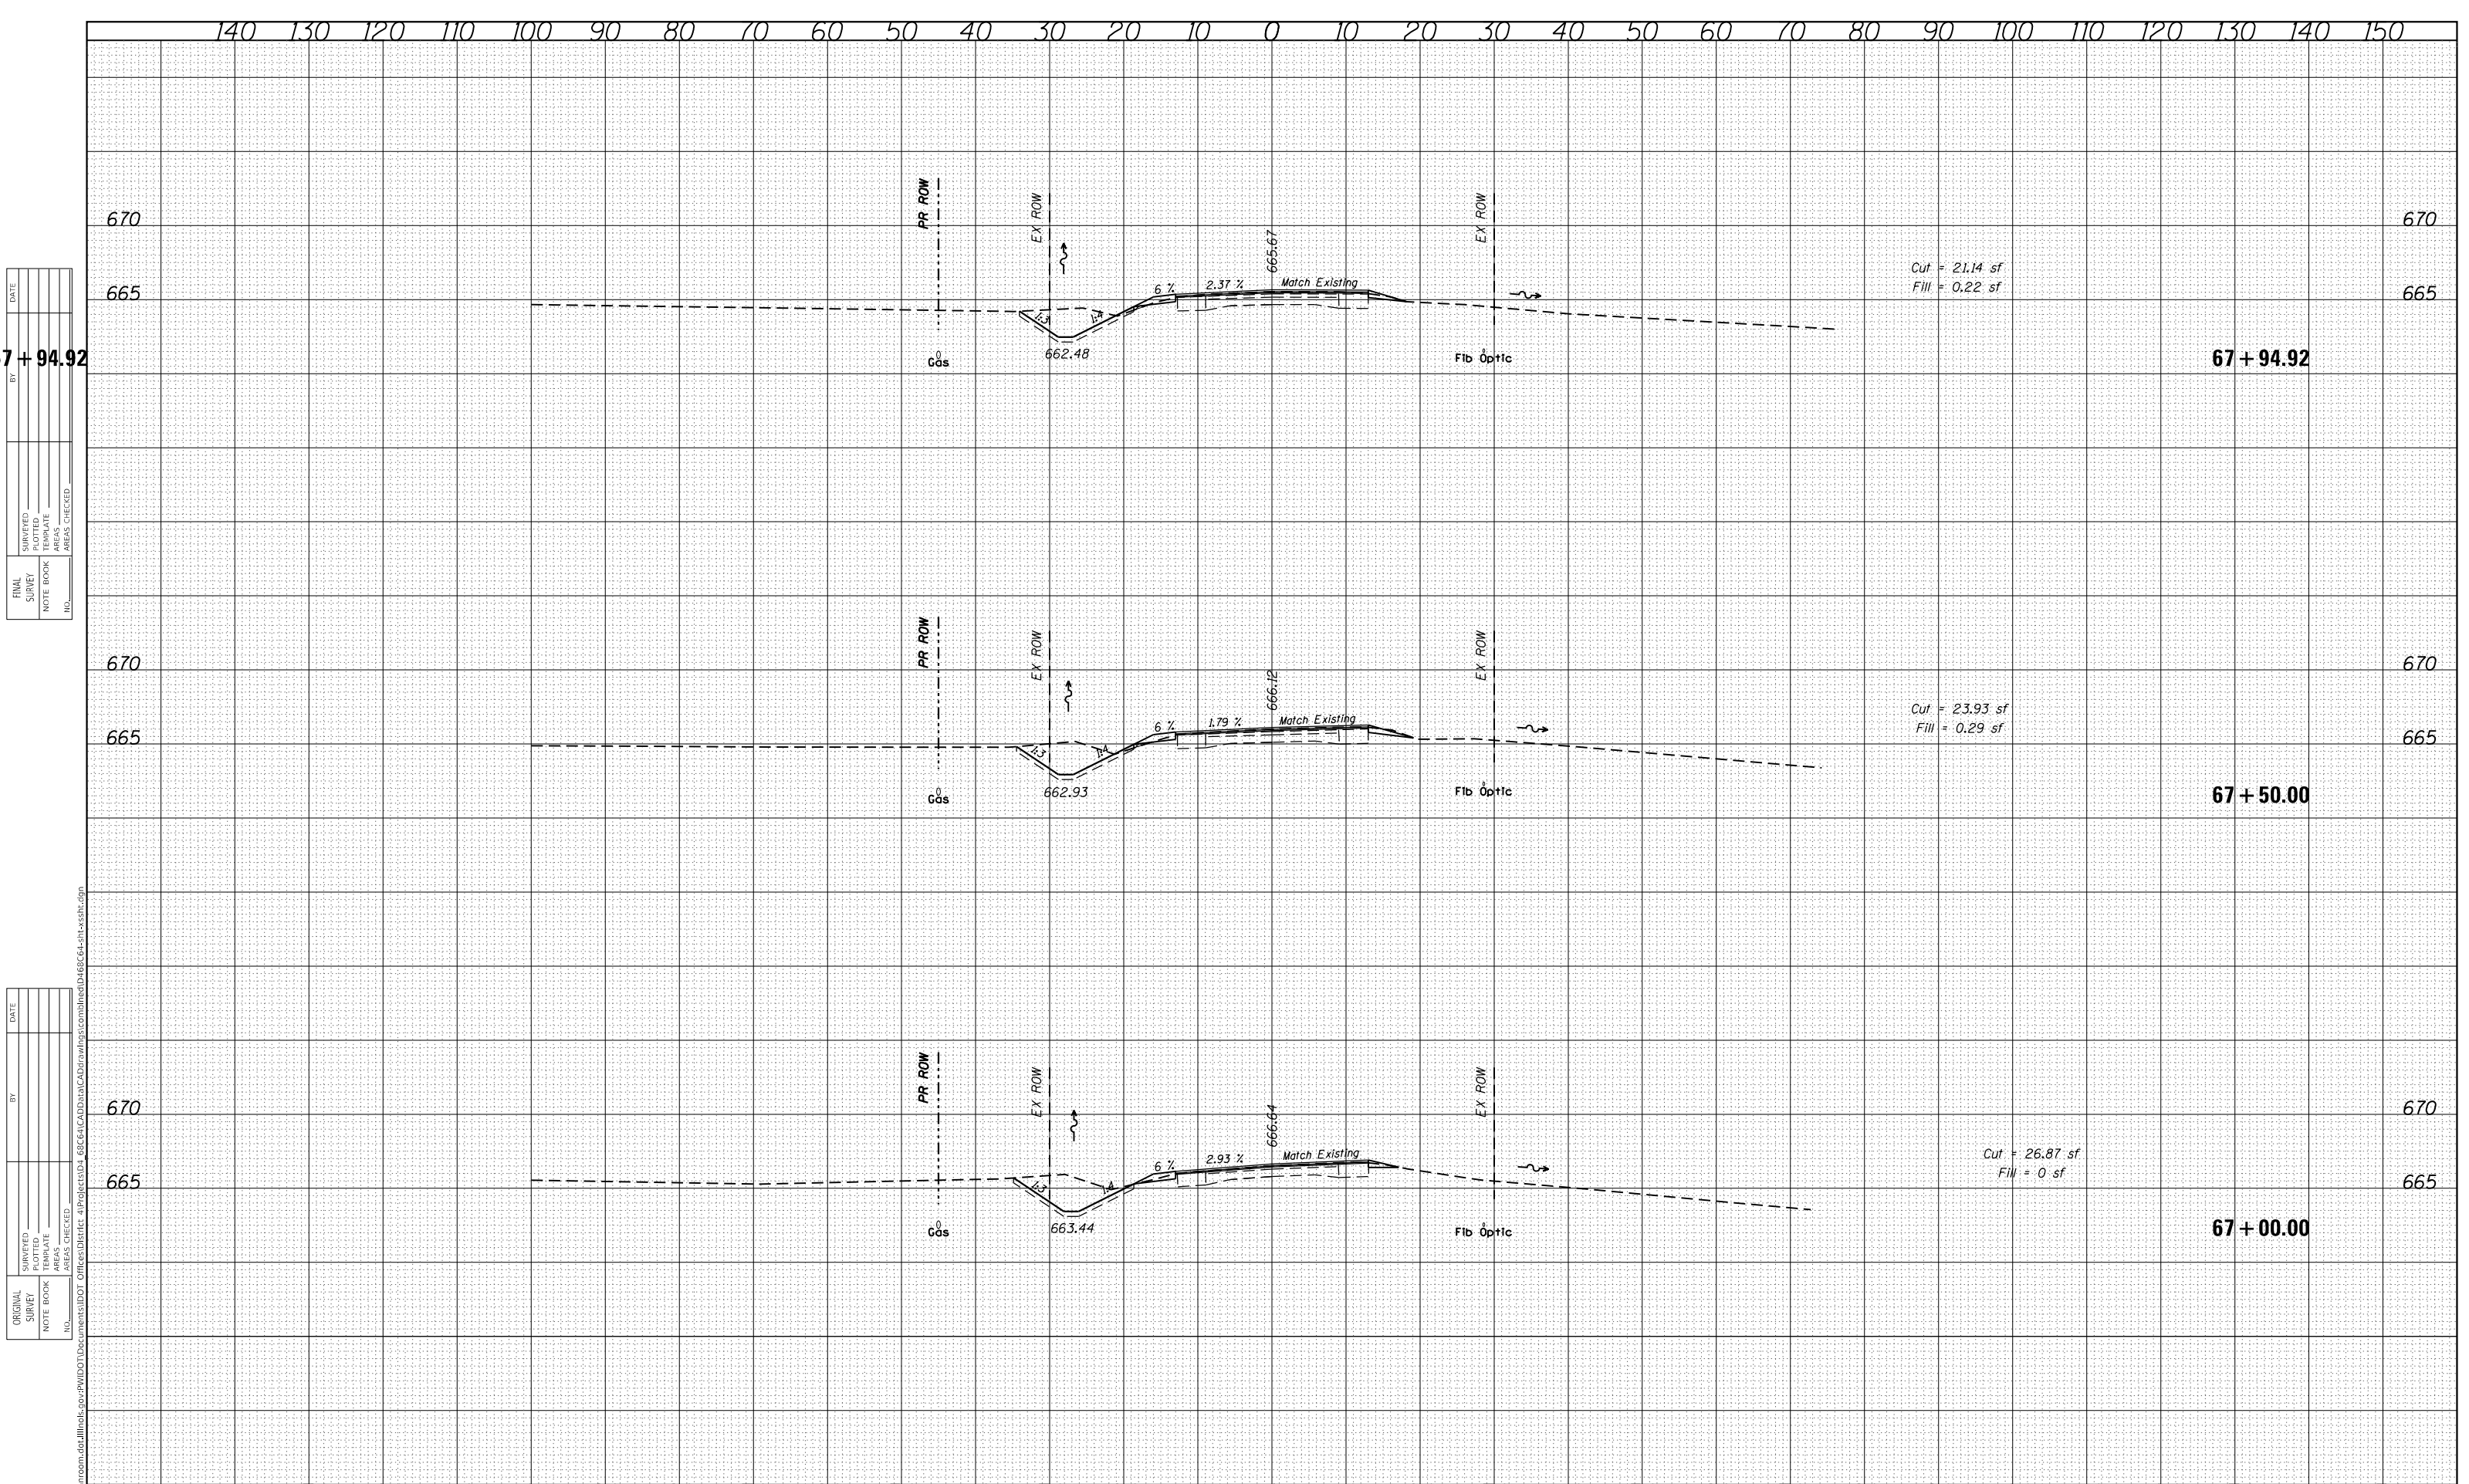
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**STATE OF ILLINOIS
 DEPARTMENT OF TRANSPORTATION**

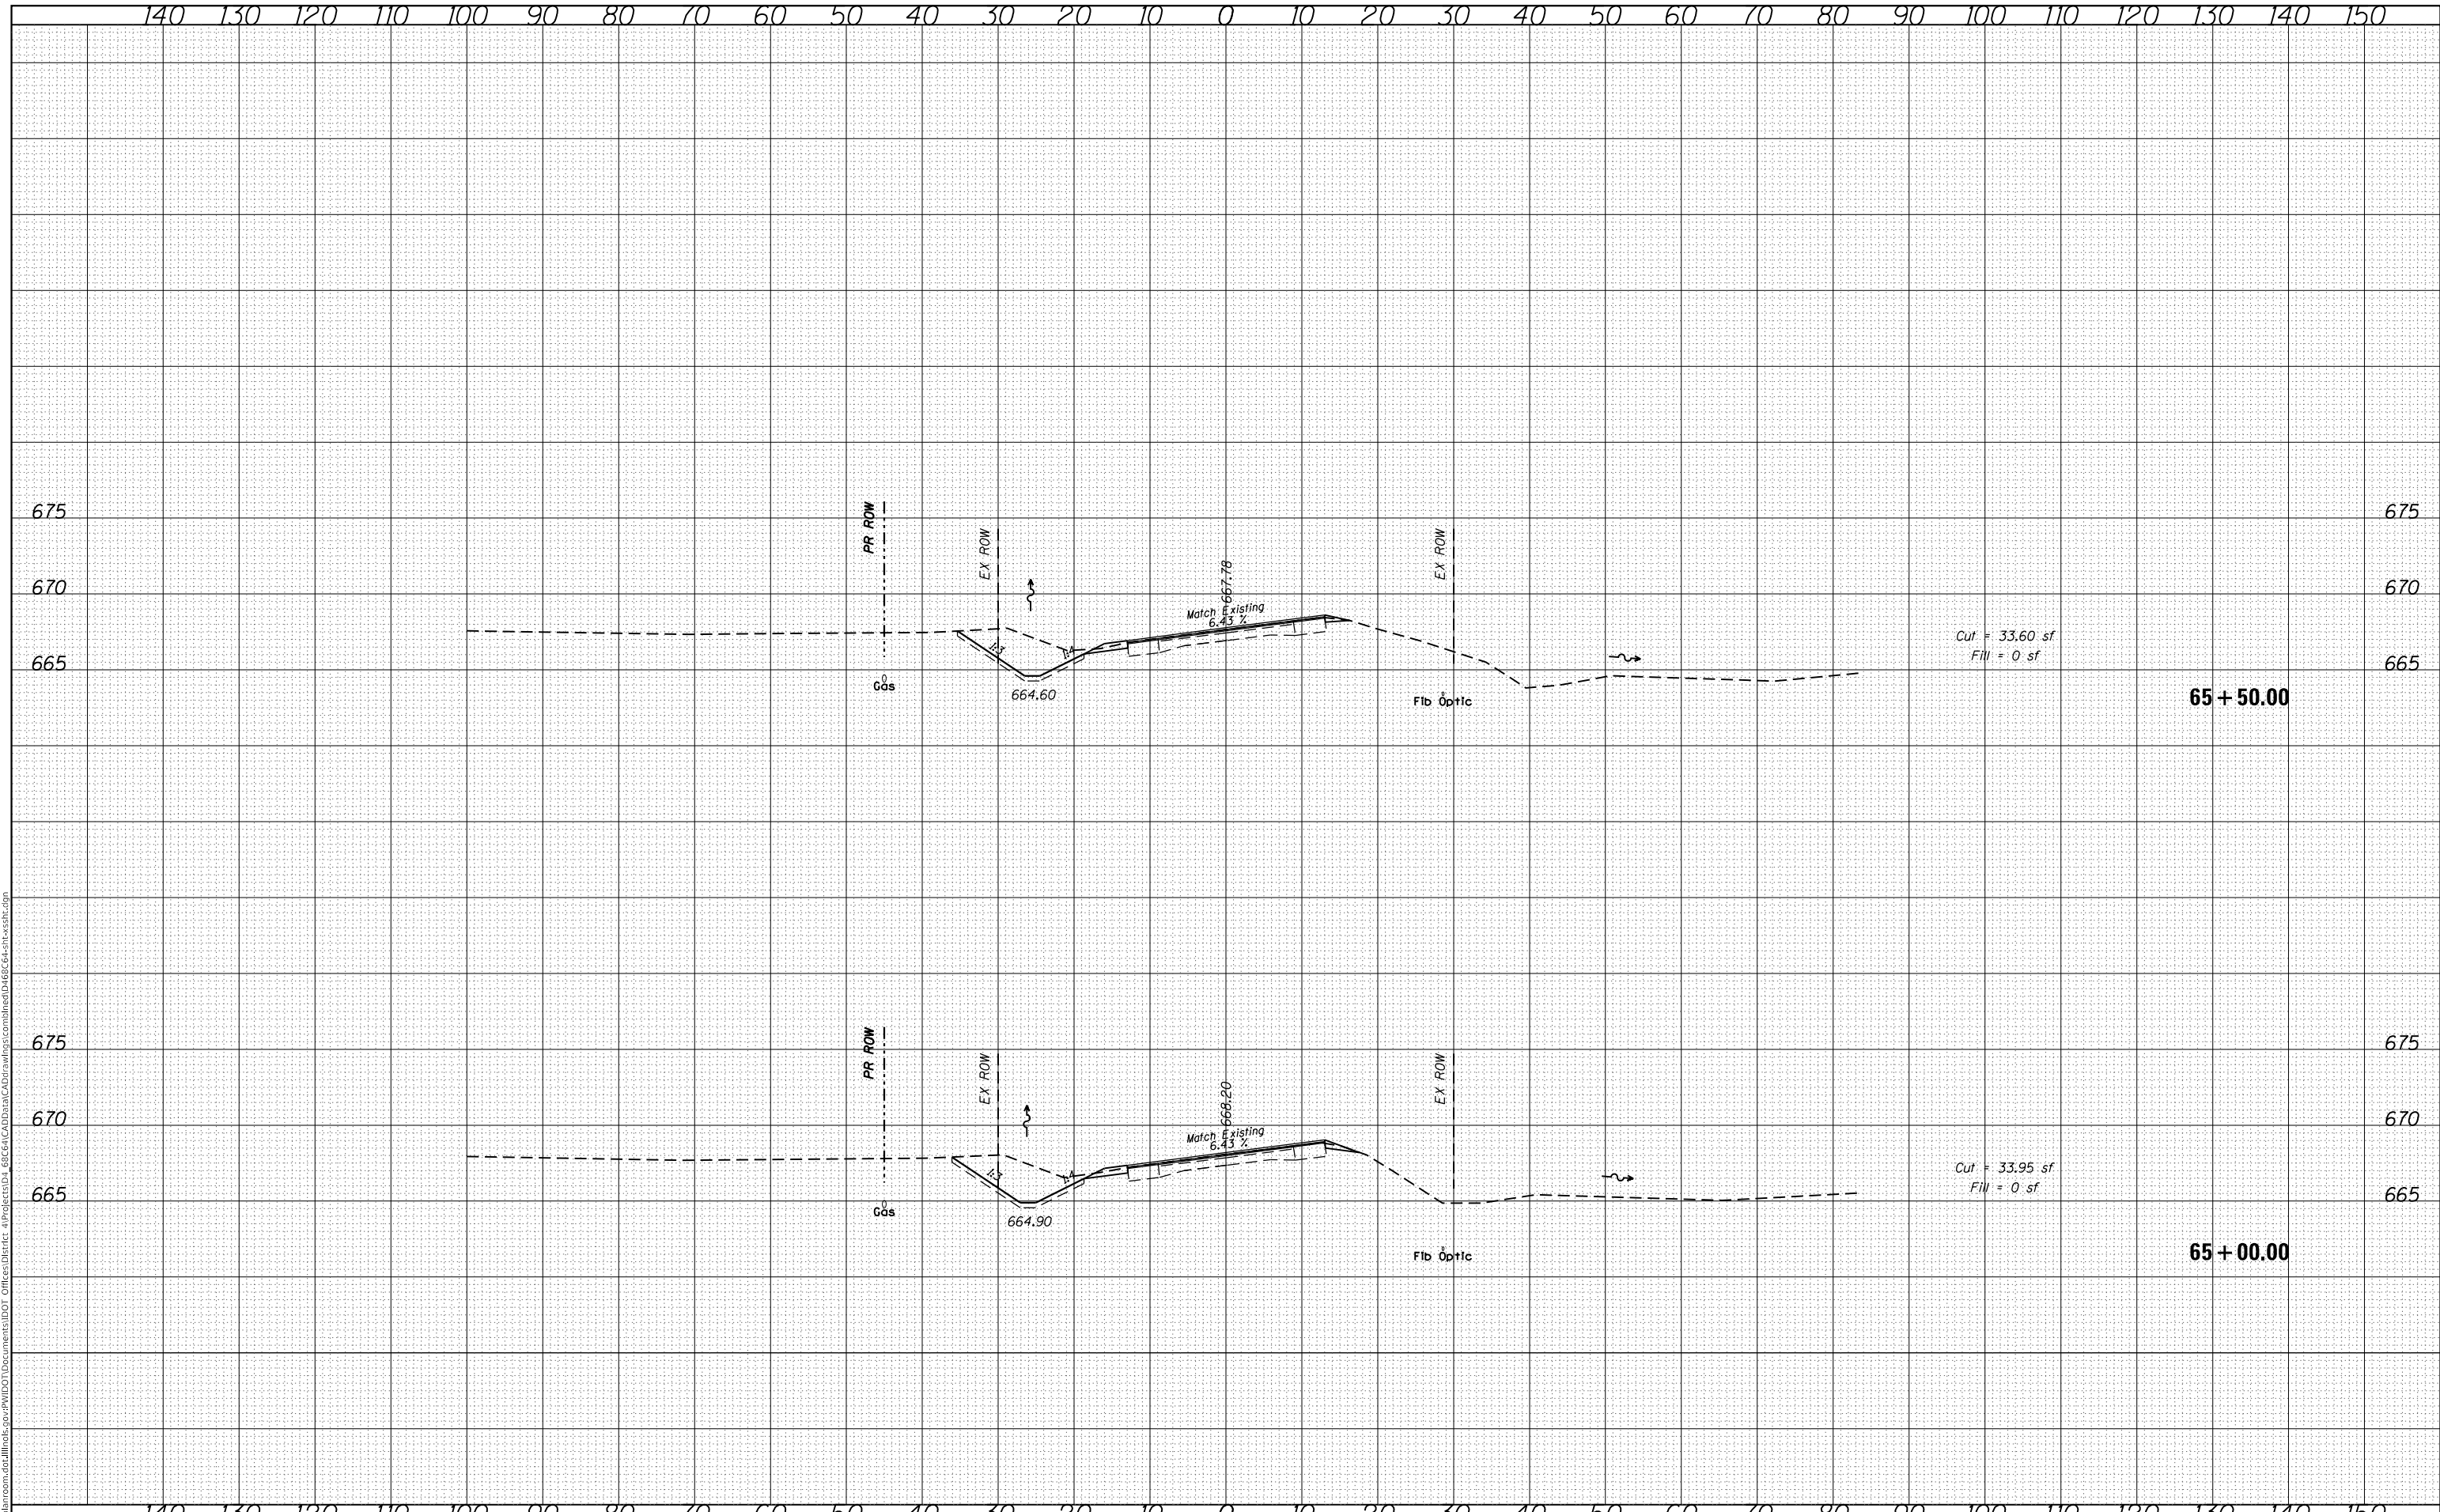SCALE: SHEET OF SHEETS STA. 66+00.00 TO STA. 66+50.00

**IL 41
 CROSS SECTIONS**

F.A.P. RTE.	SECTION	COUNTY	TOTAL SHEETS	SHEET NO.
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CONTRACT NO. 68C64				
ILLINOIS		FED. AID PROJECT		

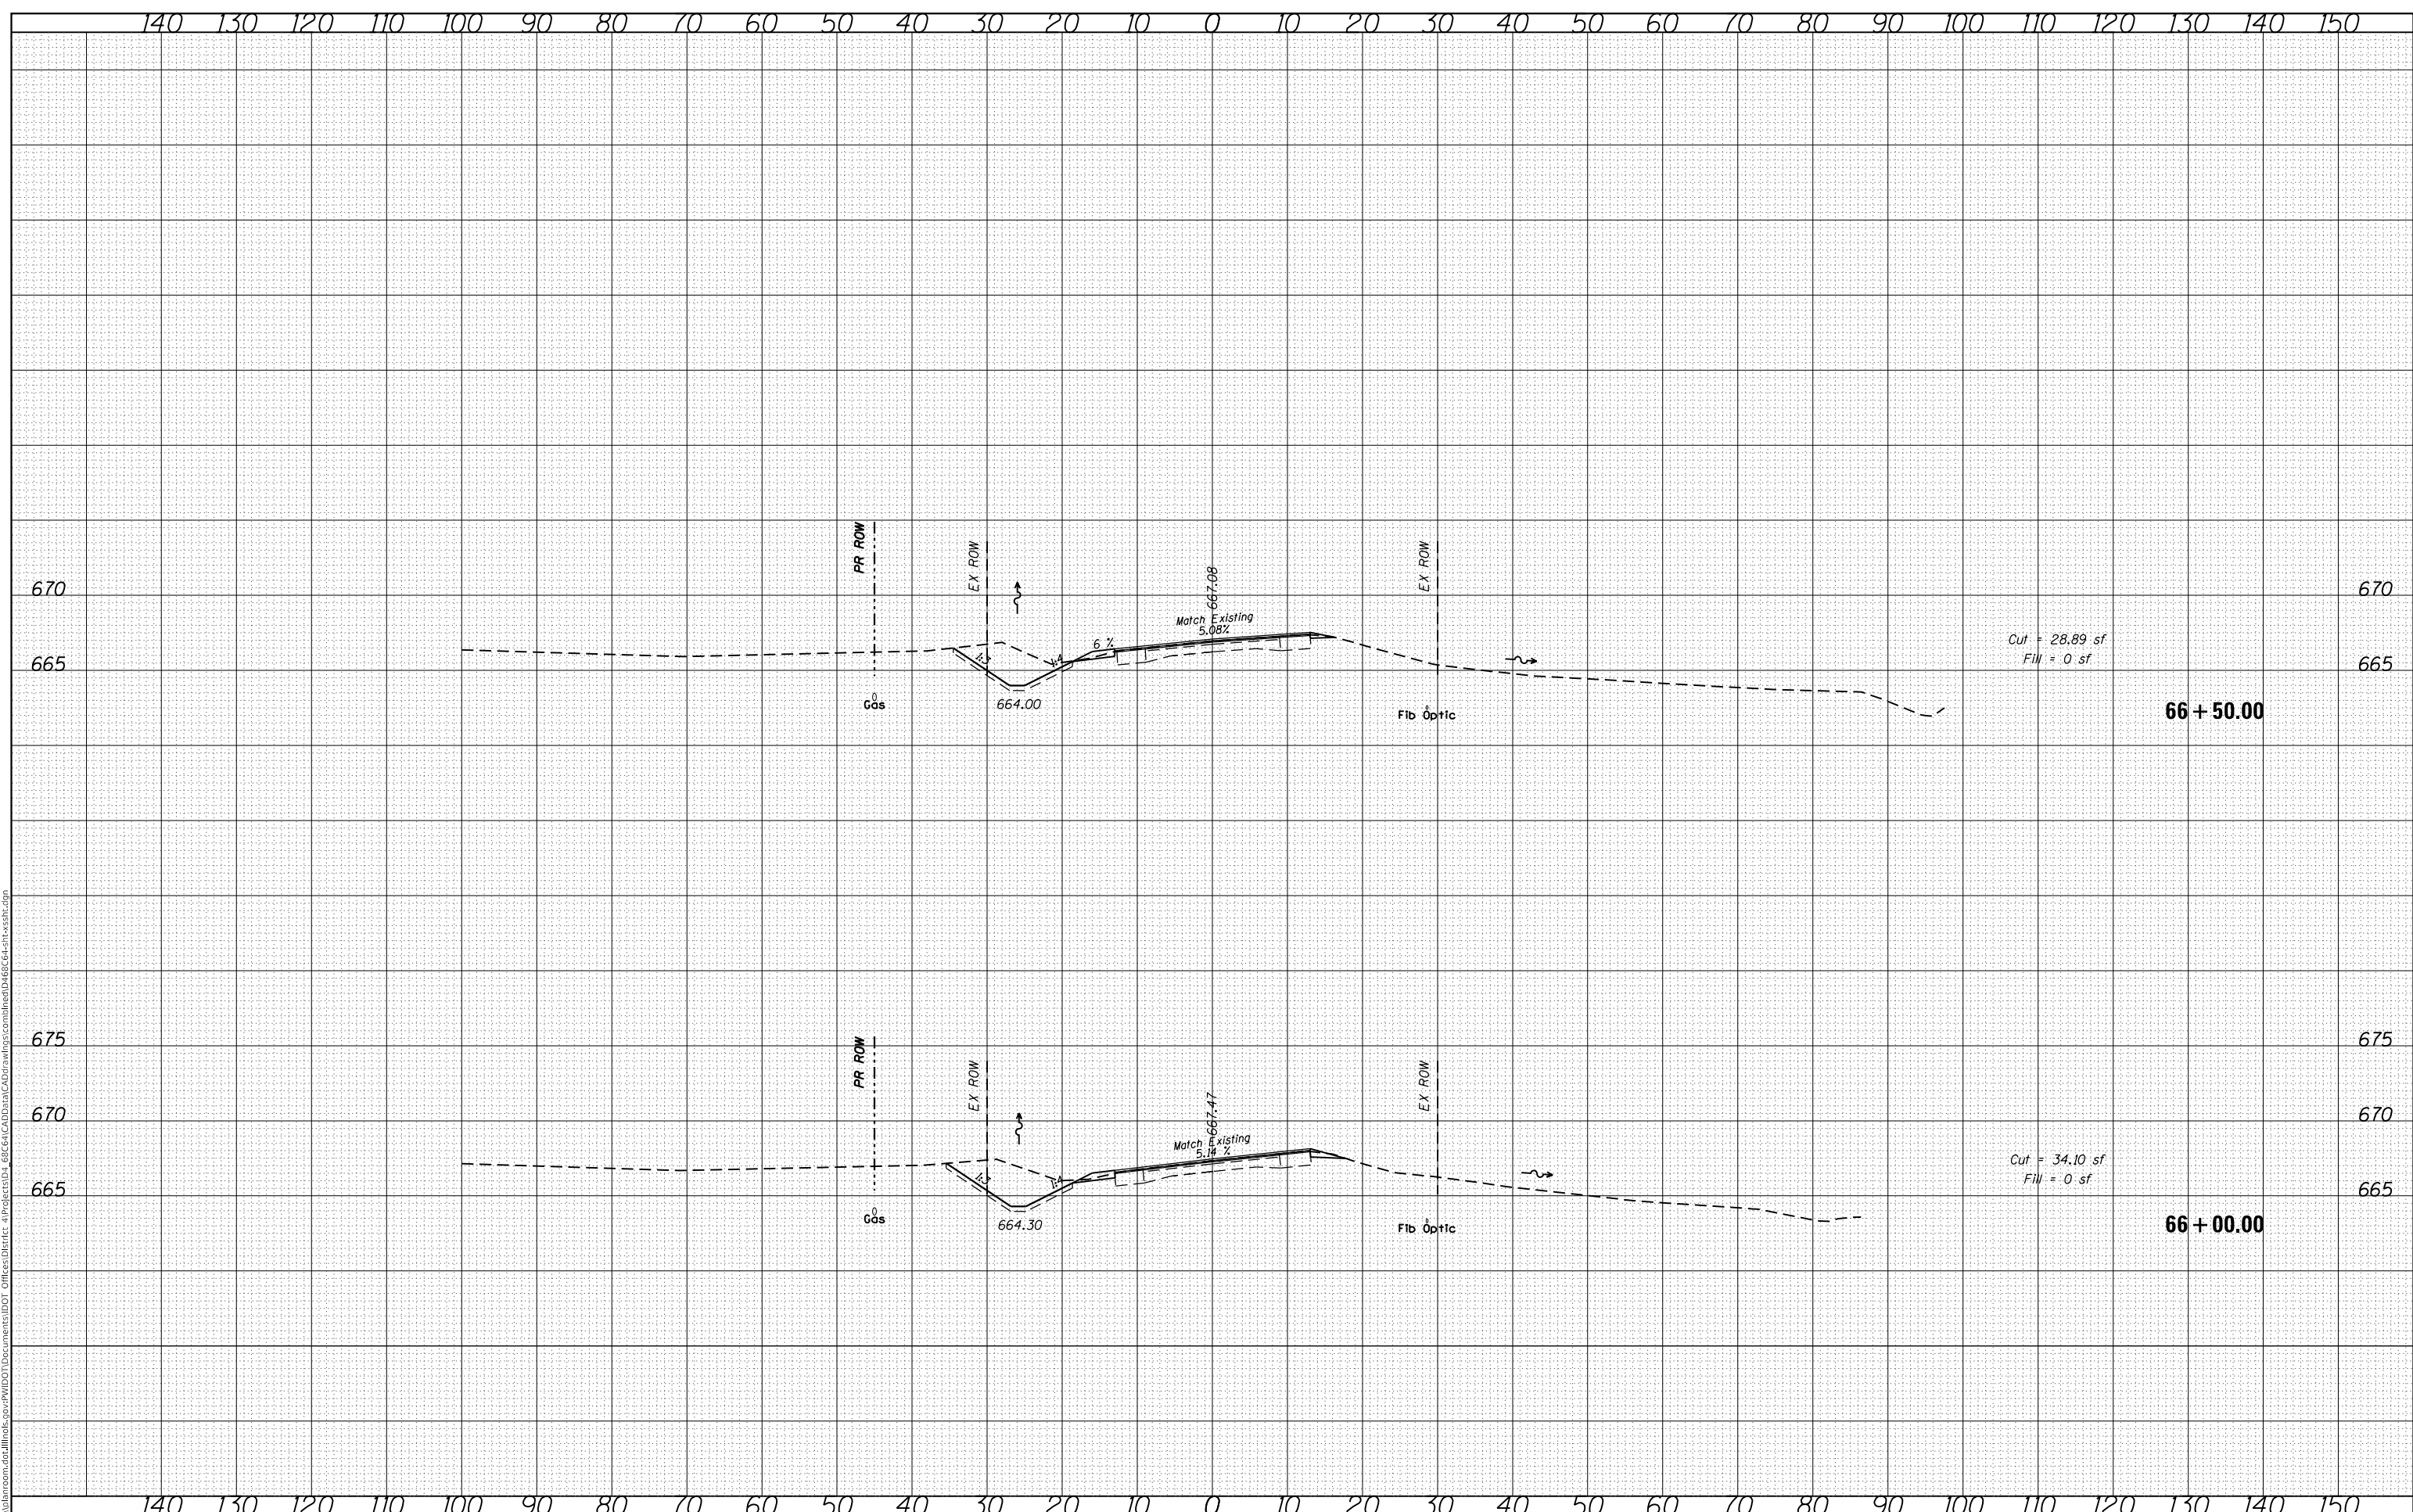

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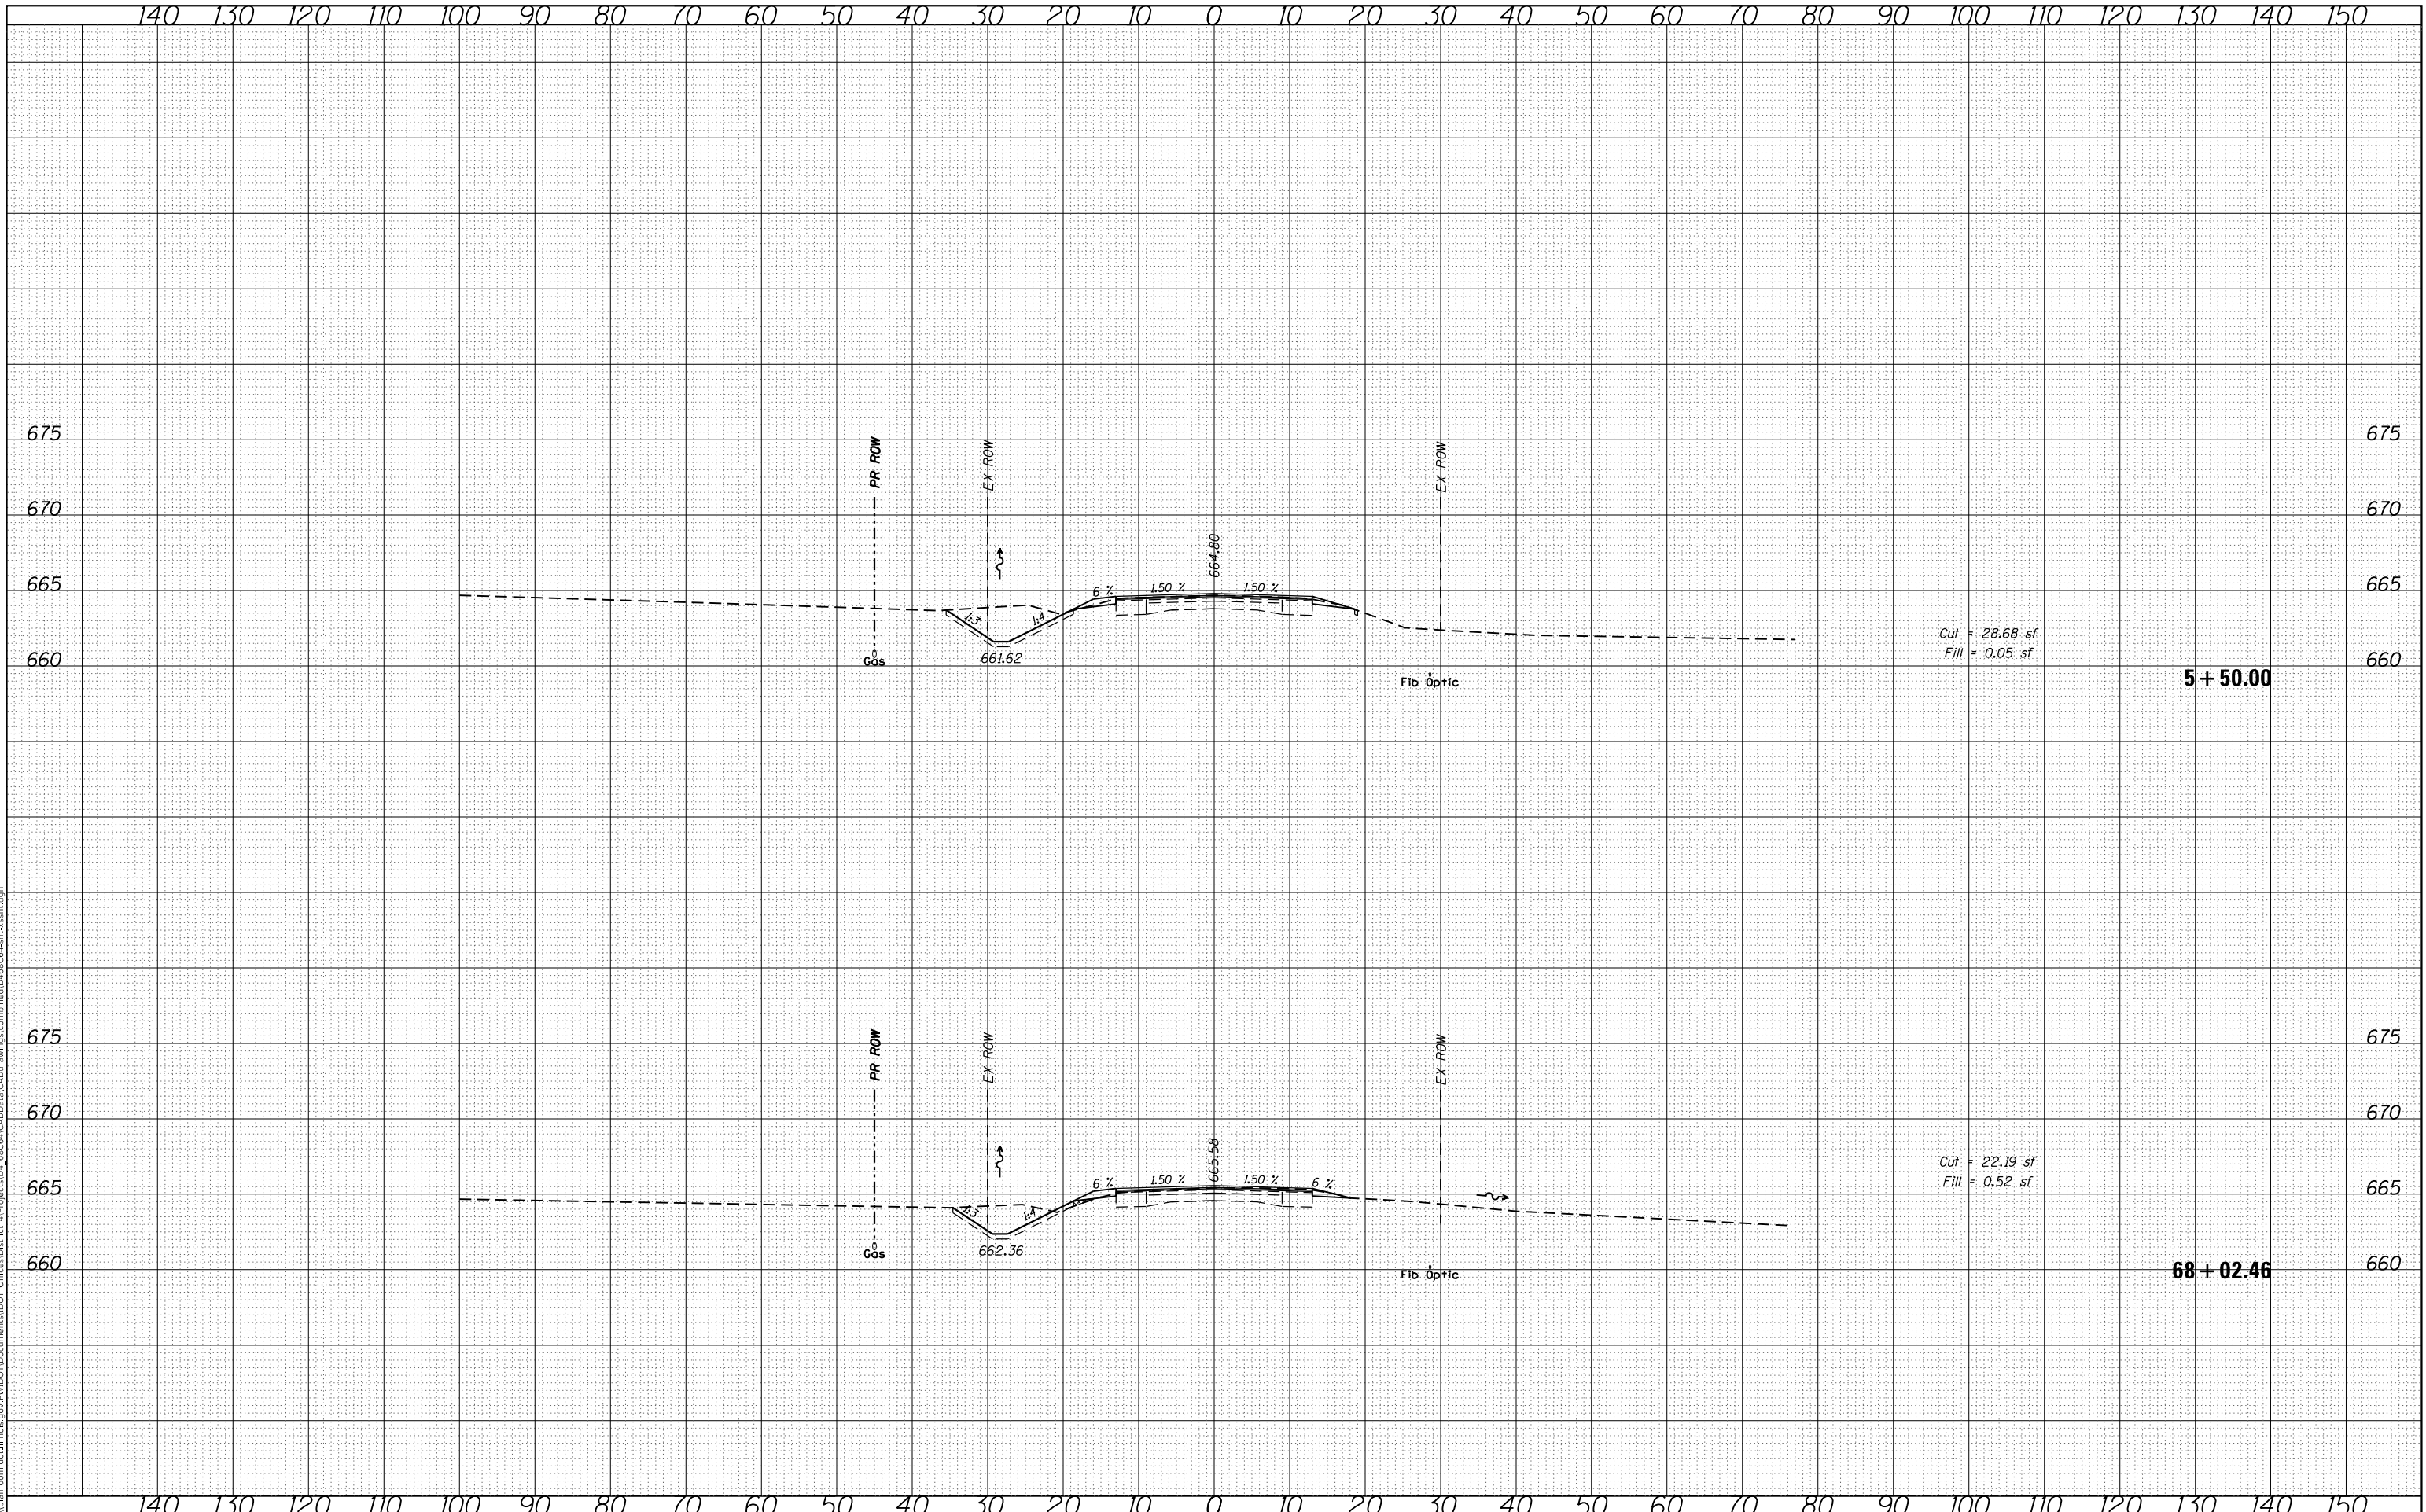
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**STATE OF ILLINOIS
DEPARTMENT OF TRANSPORTATION**

**IL 41
CROSS SECTIONS**

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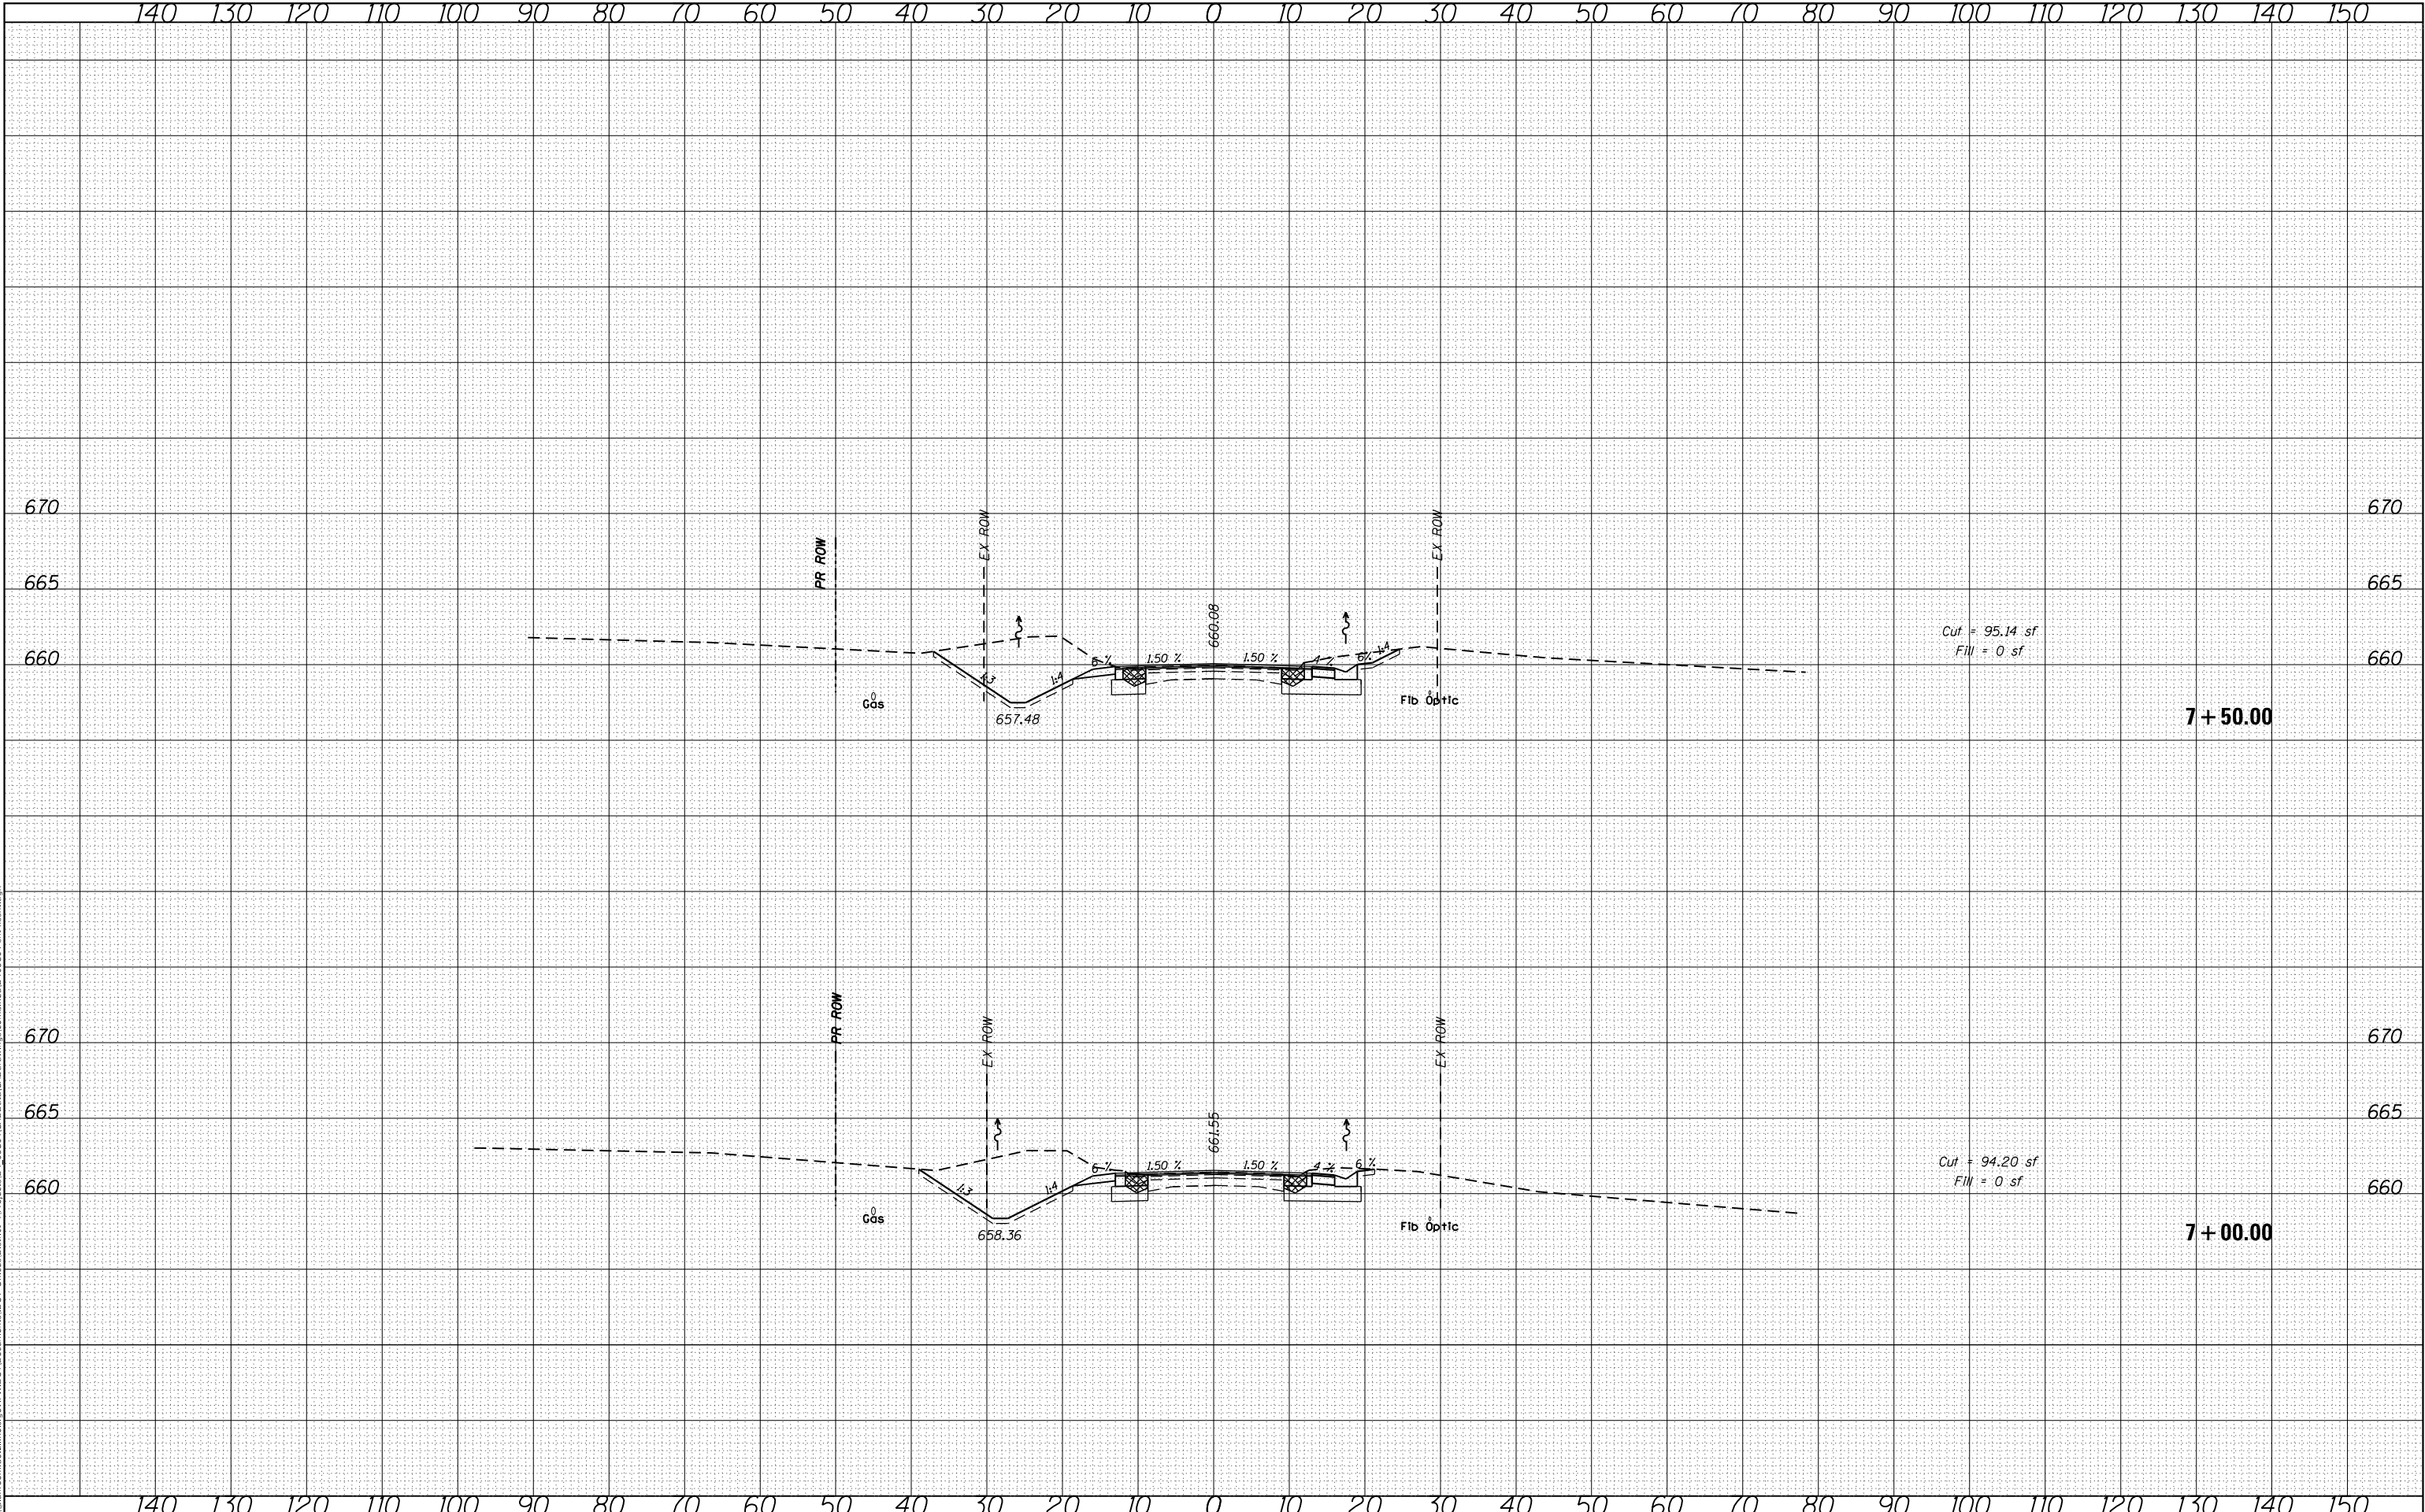
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ILLINOIS		FED. AID PROJECT	*	

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**STATE OF ILLINOIS
DEPARTMENT OF TRANSPORTATION**


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CROSS SECTIONS**

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F.A.P. RTE.	SECTION	COUNTY	TOTAL SHEETS	SHEET NO.
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CONTRACT NO. 68C64				
ILLINOIS FED. AID PROJECT				

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**STATE OF ILLINOIS
DEPARTMENT OF TRANSPORTATION**

**IL 41
CROSS SECTIONS**


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				CONTRACT NO. 68C64
		ILLINOIS	FED. AID PROJECT	
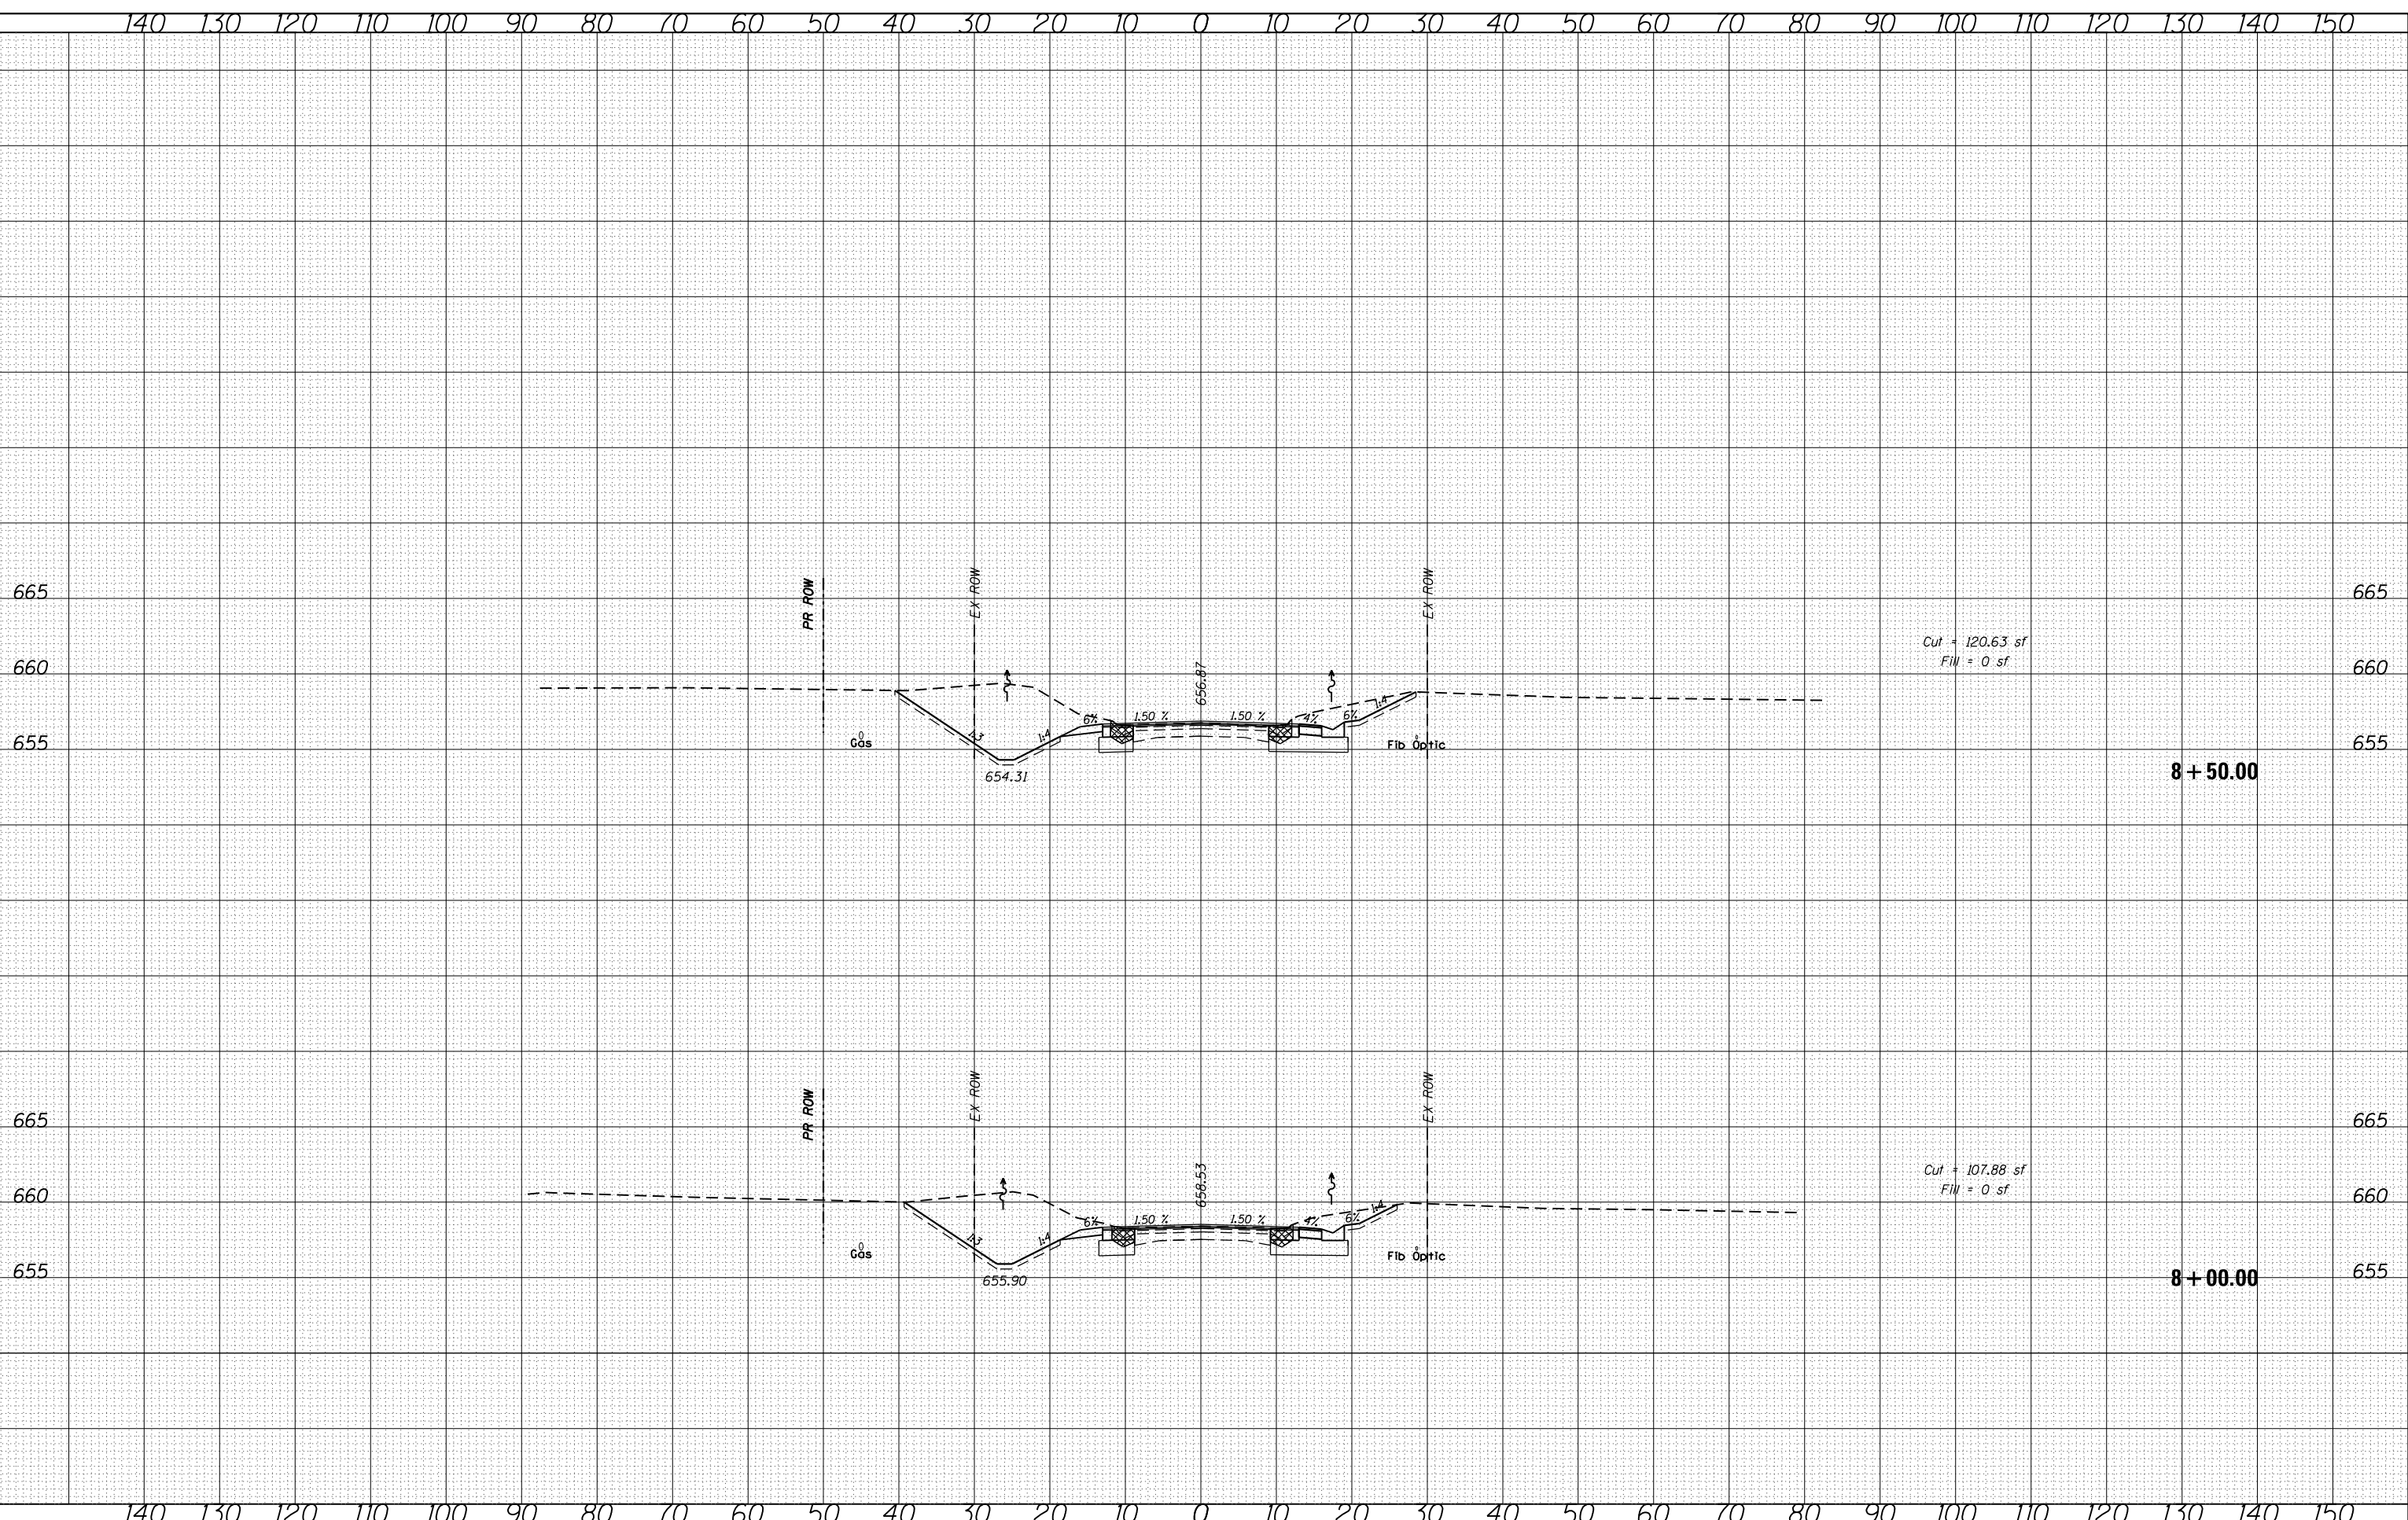
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PLOT DATE = 10/17/2019	DATE -	REVISIED -

**STATE OF ILLINOIS
DEPARTMENT OF TRANSPORTATION**

**IL 41
CROSS SECTIONS**

SCALE: SHEET OF SHEETS STA. 9+00.00 TO STA. 9+50.00
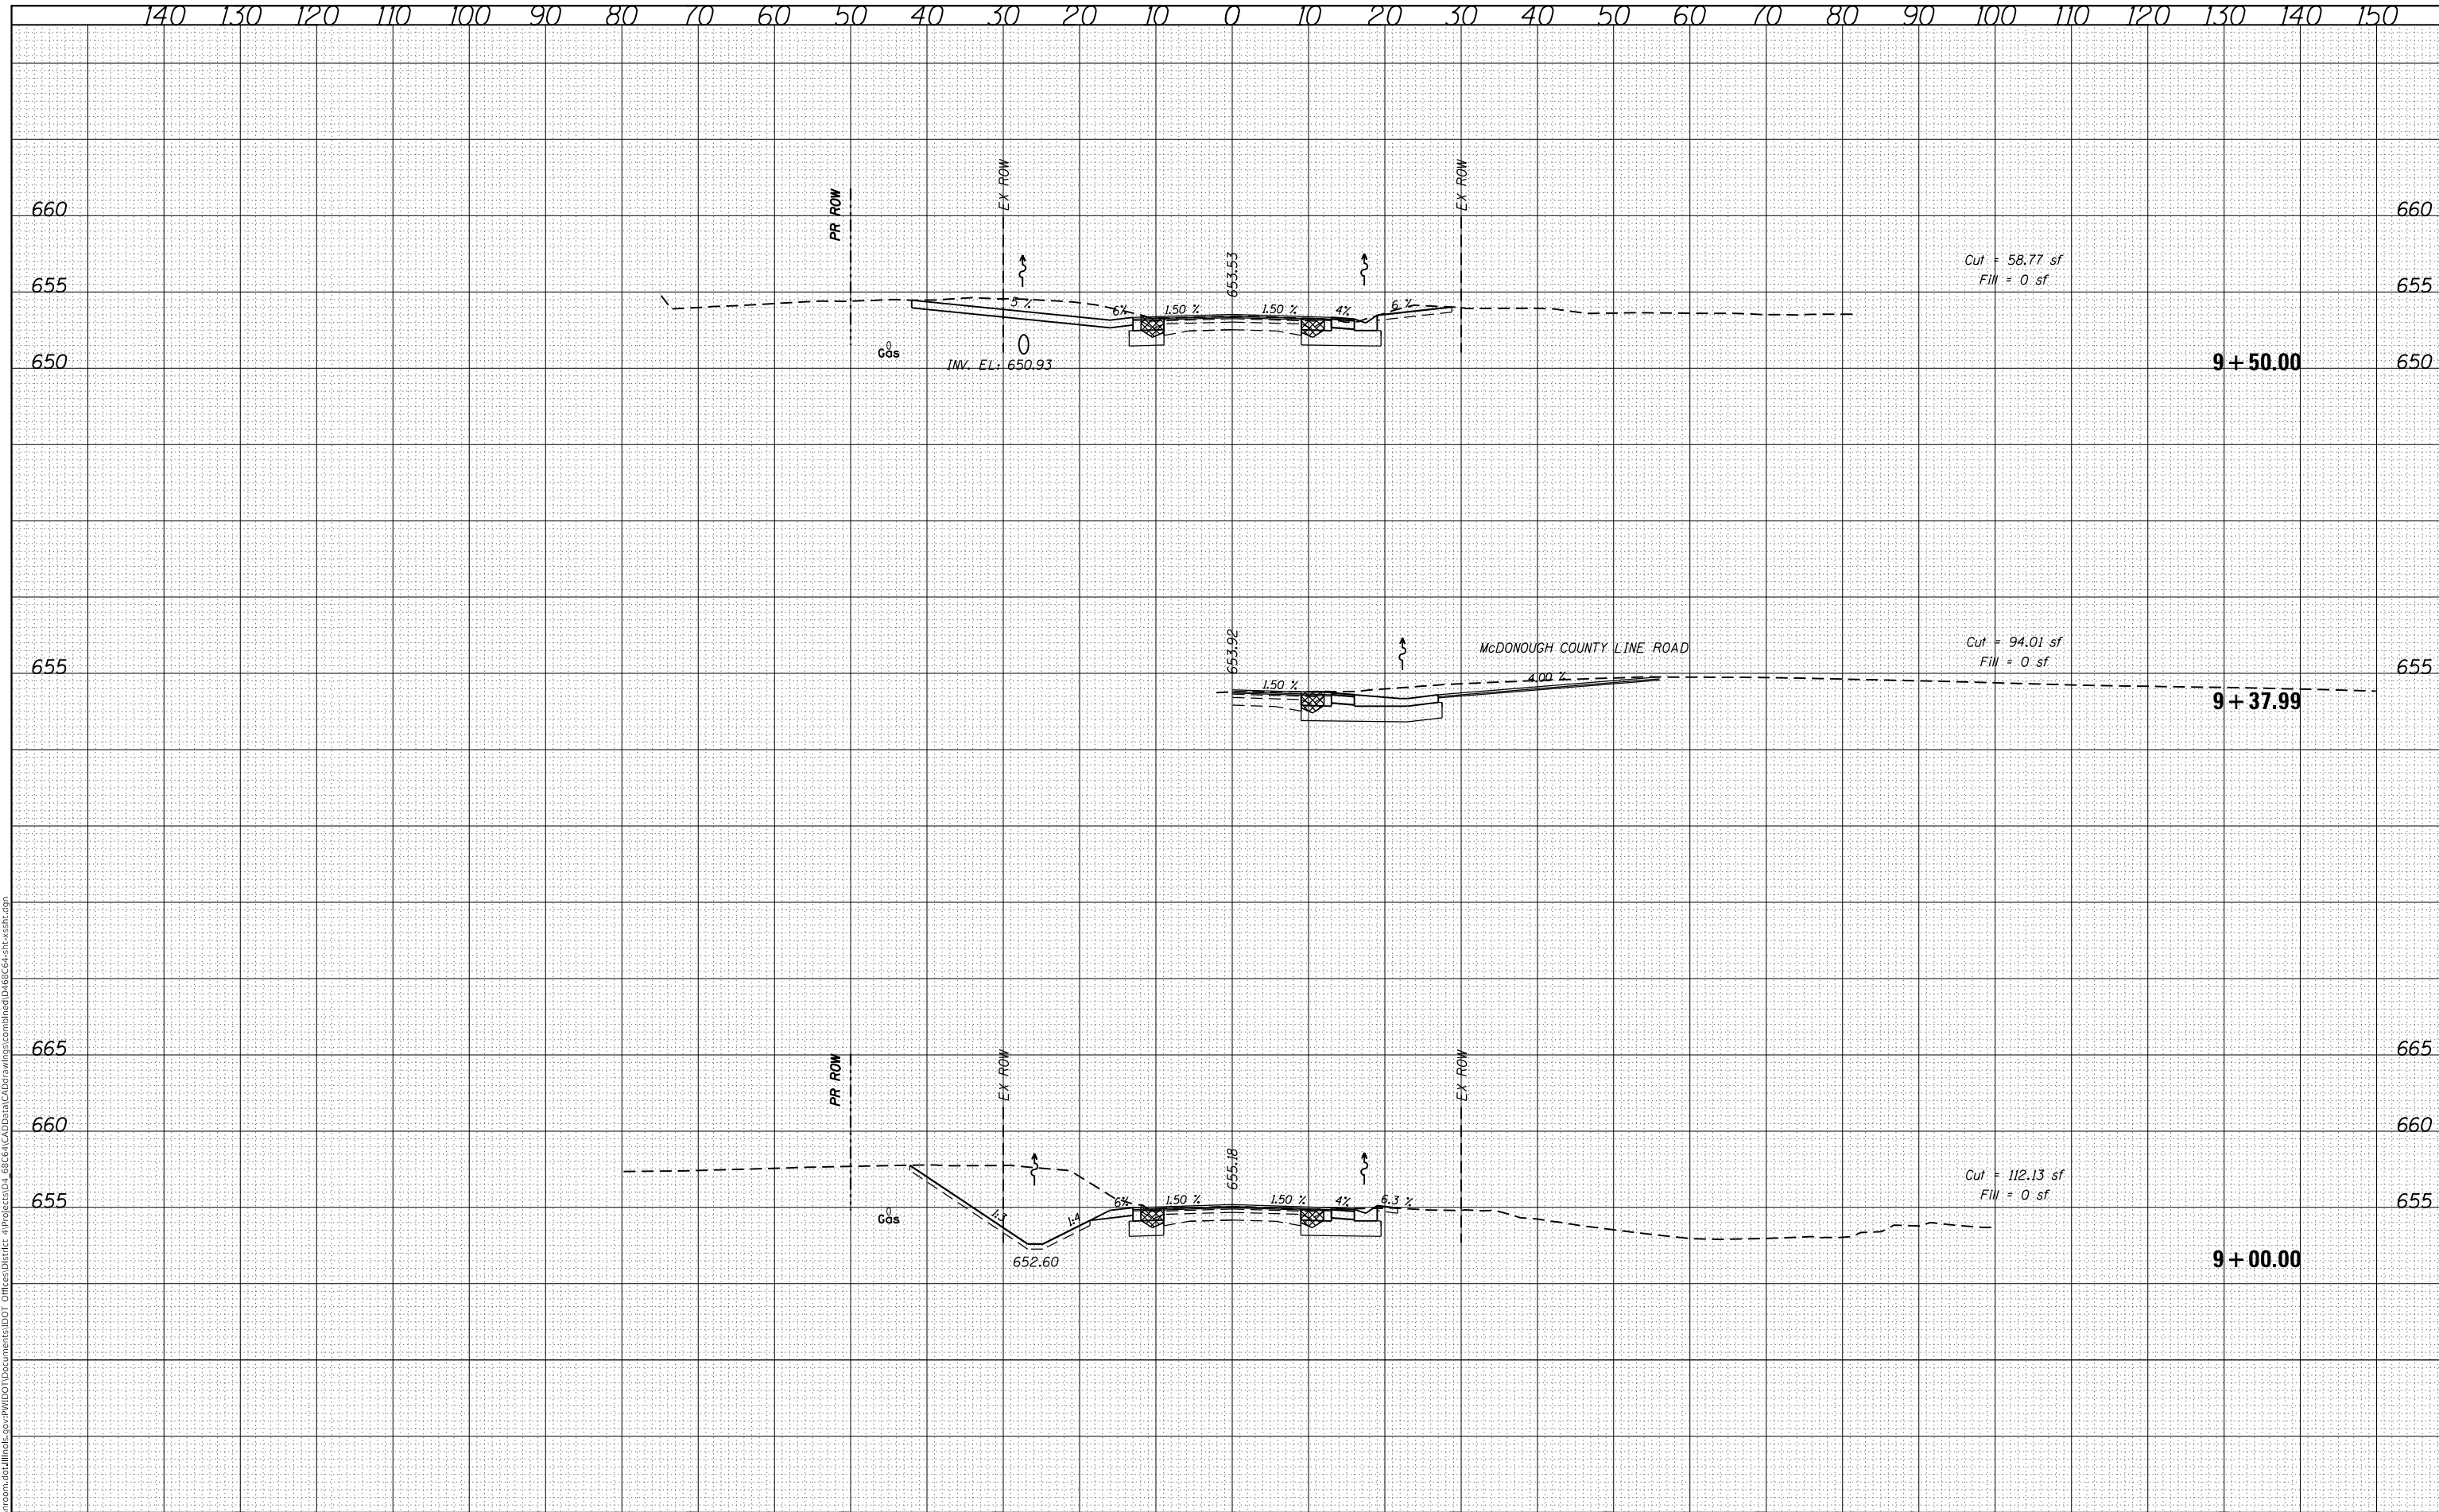
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ILLINOIS		FED. AID PROJECT		


* FULTON / McDONOUGH

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ORIGINAL SURVEY NO.	SURVEYED PLOTTED TEMPLATE AREAS CHECKED	BY	DATE

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FILE NAME: D:\vblam\msh.dwg Illinois:gov:PWIDOT\Documents\DOT_Offices\District_4\Projects\IDL_68C64\CAD\Drawn\CAD\Drawings\combined\IDL68C64-entxstb.dgn



USER NAME = eversct	DESIGNED -	REVISED -
PLOT SCALE = 20,0000' / in.	DRAWN -	REVISED -
PLOT DATE = 10/17/2019	CHECKED -	REVISED -
	DATE -	REVISED -

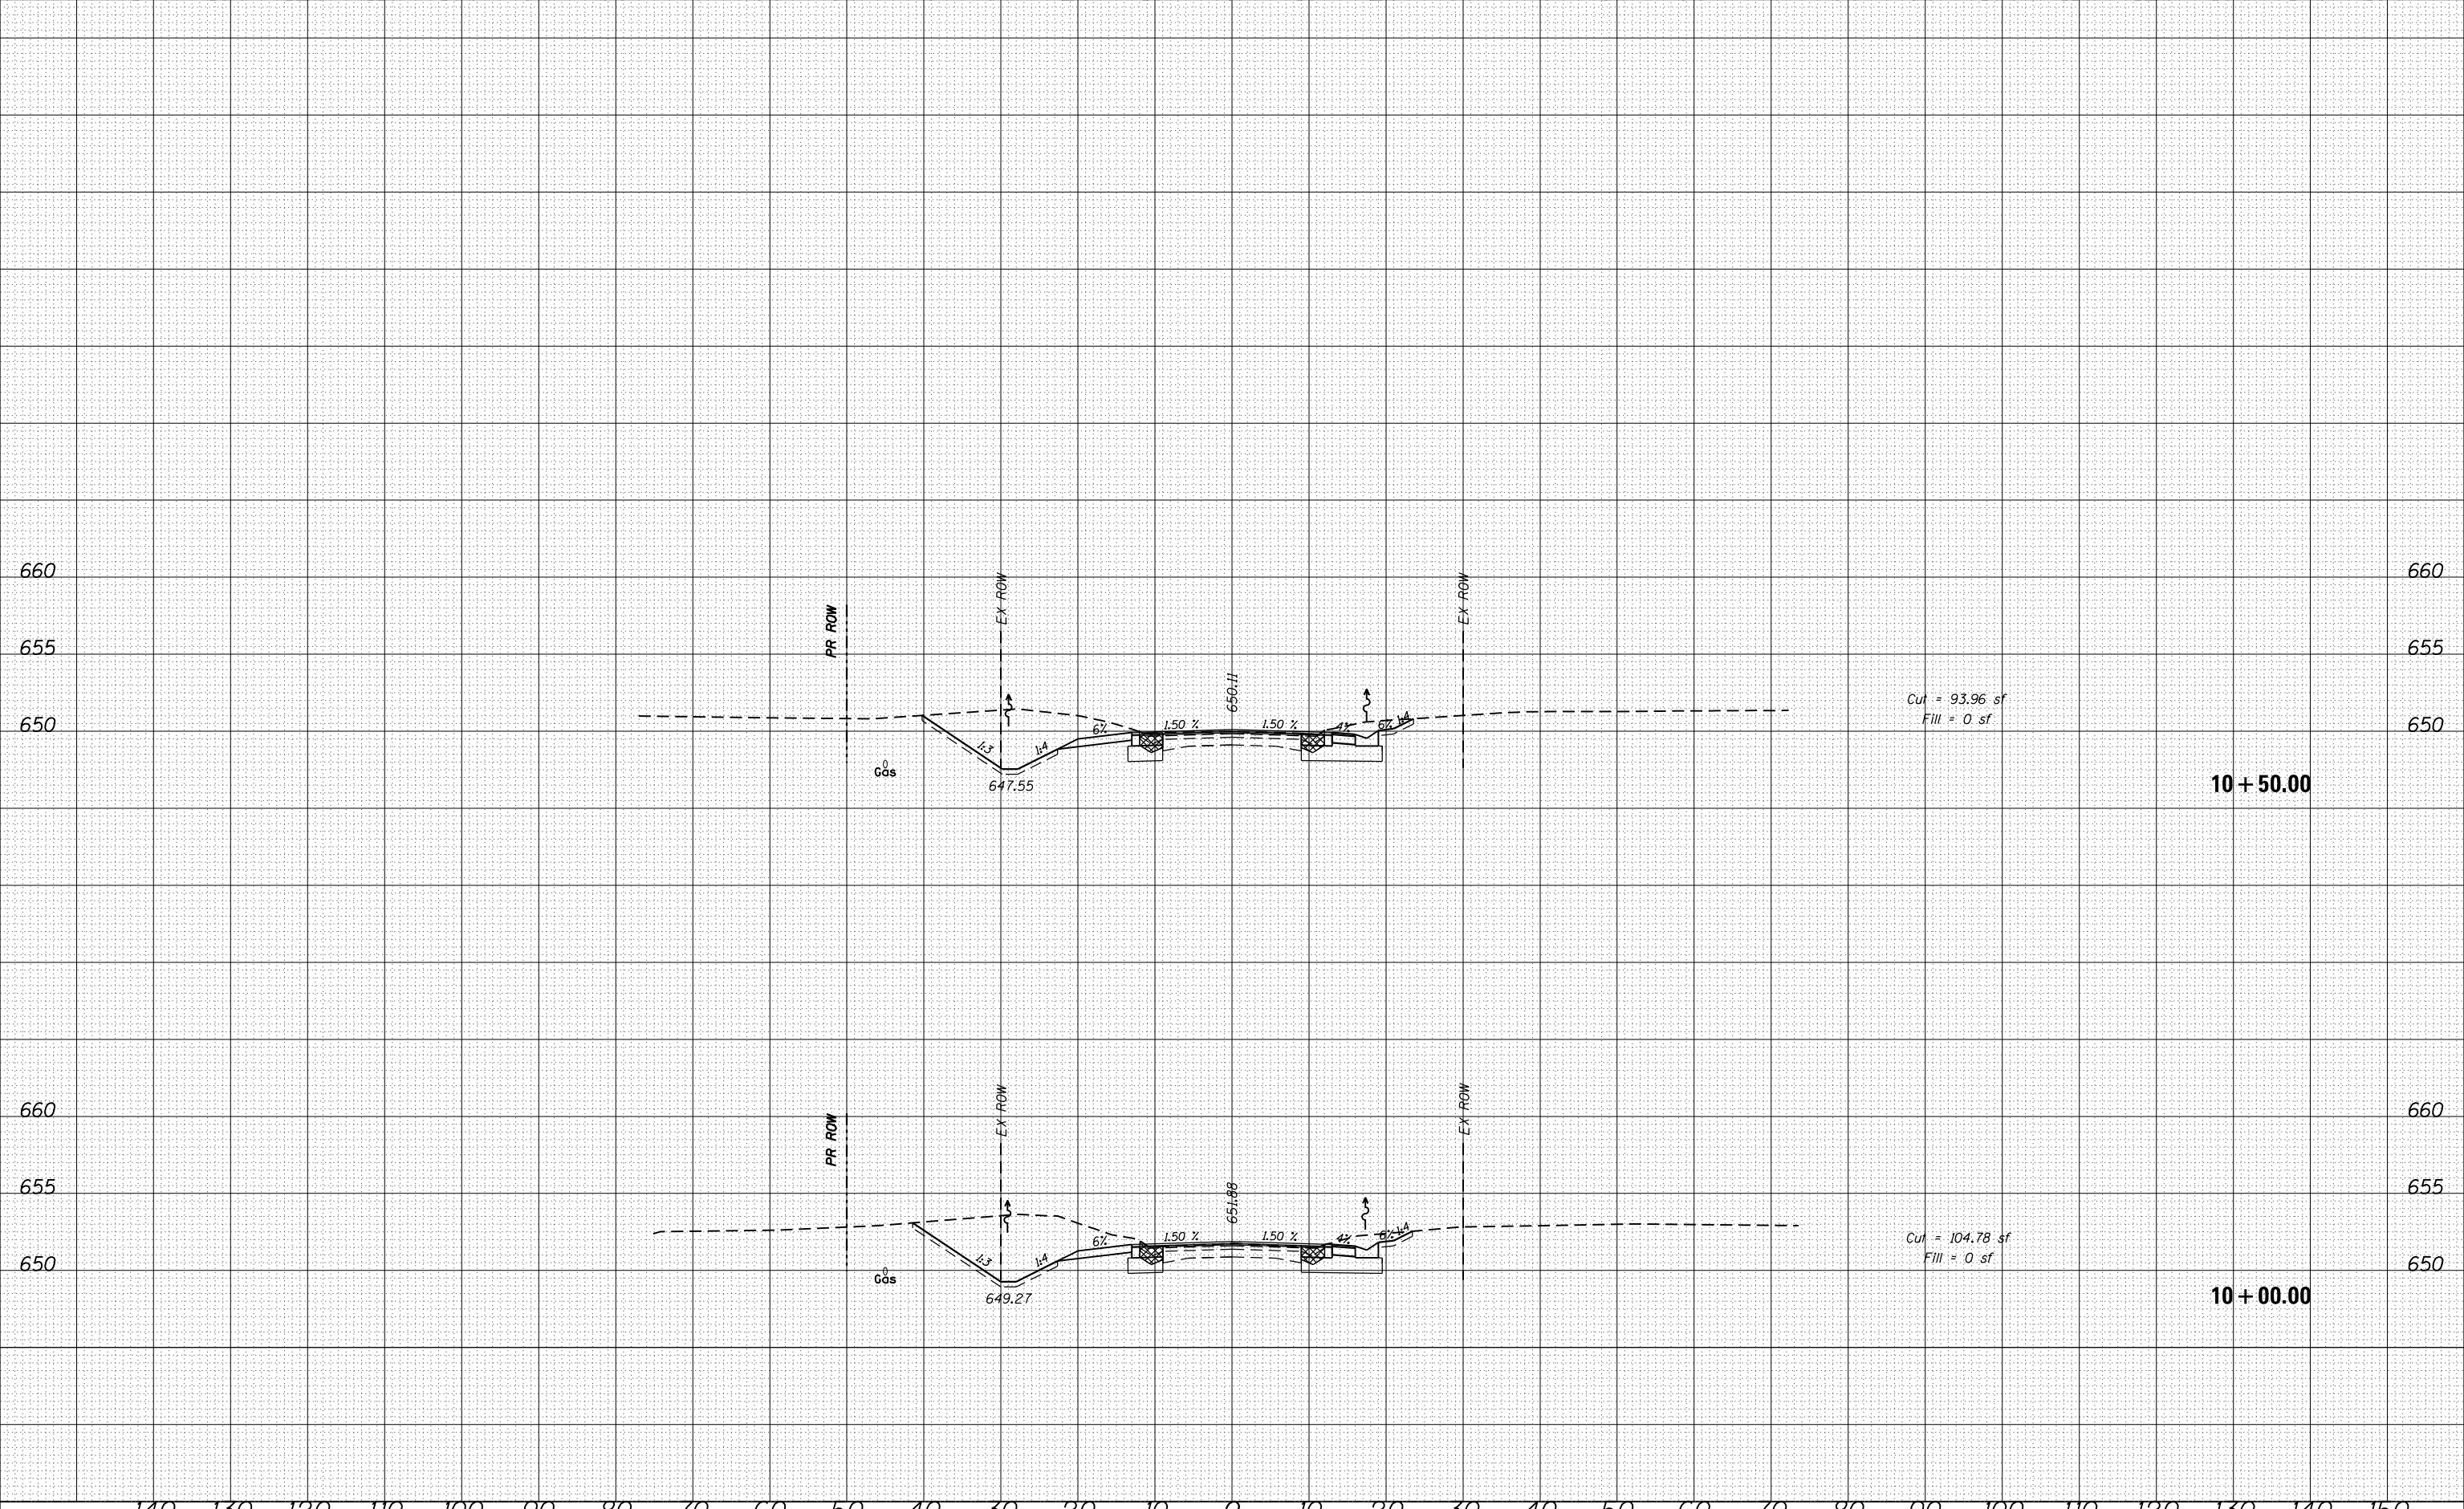**STATE OF ILLINOIS
DEPARTMENT OF TRANSPORTATION**


**IL 41
CROSS SECTIONS**
SCALE: SHEET OF SHEETS STA. 10+00.00 TO STA. 10+50.00

F.A.P. RTE. 574	SECTION (12)CR	COUNTY *	TOTAL SHEETS 202	SHEET NO. 99
				CONTRACT NO. 68C64
		ILLINOIS	FED. AID PROJECT	

DATE	
BY	
SURVEYED	
PLOTTED	
TEMPLATE	
AREAS CHECKED	
FINAL SURVEY NO.	
NOTE BOOK NO.	
AREAS CHECKED	

DATE	
BY	
SURVEYED	
PLOTTED	
TEMPLATE	
AREAS CHECKED	
ORIGINAL SURVEY NO.	
NOTE BOOK NO.	
AREAS CHECKED	

MODEL: Default
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USER NAME = eversct	DESIGNED -	REVISED -
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PLOT SCALE = 20.0000 ' / in.	CHECKED -	REVISED -
PLOT DATE = 10/17/2019	DATE -	REVISED -

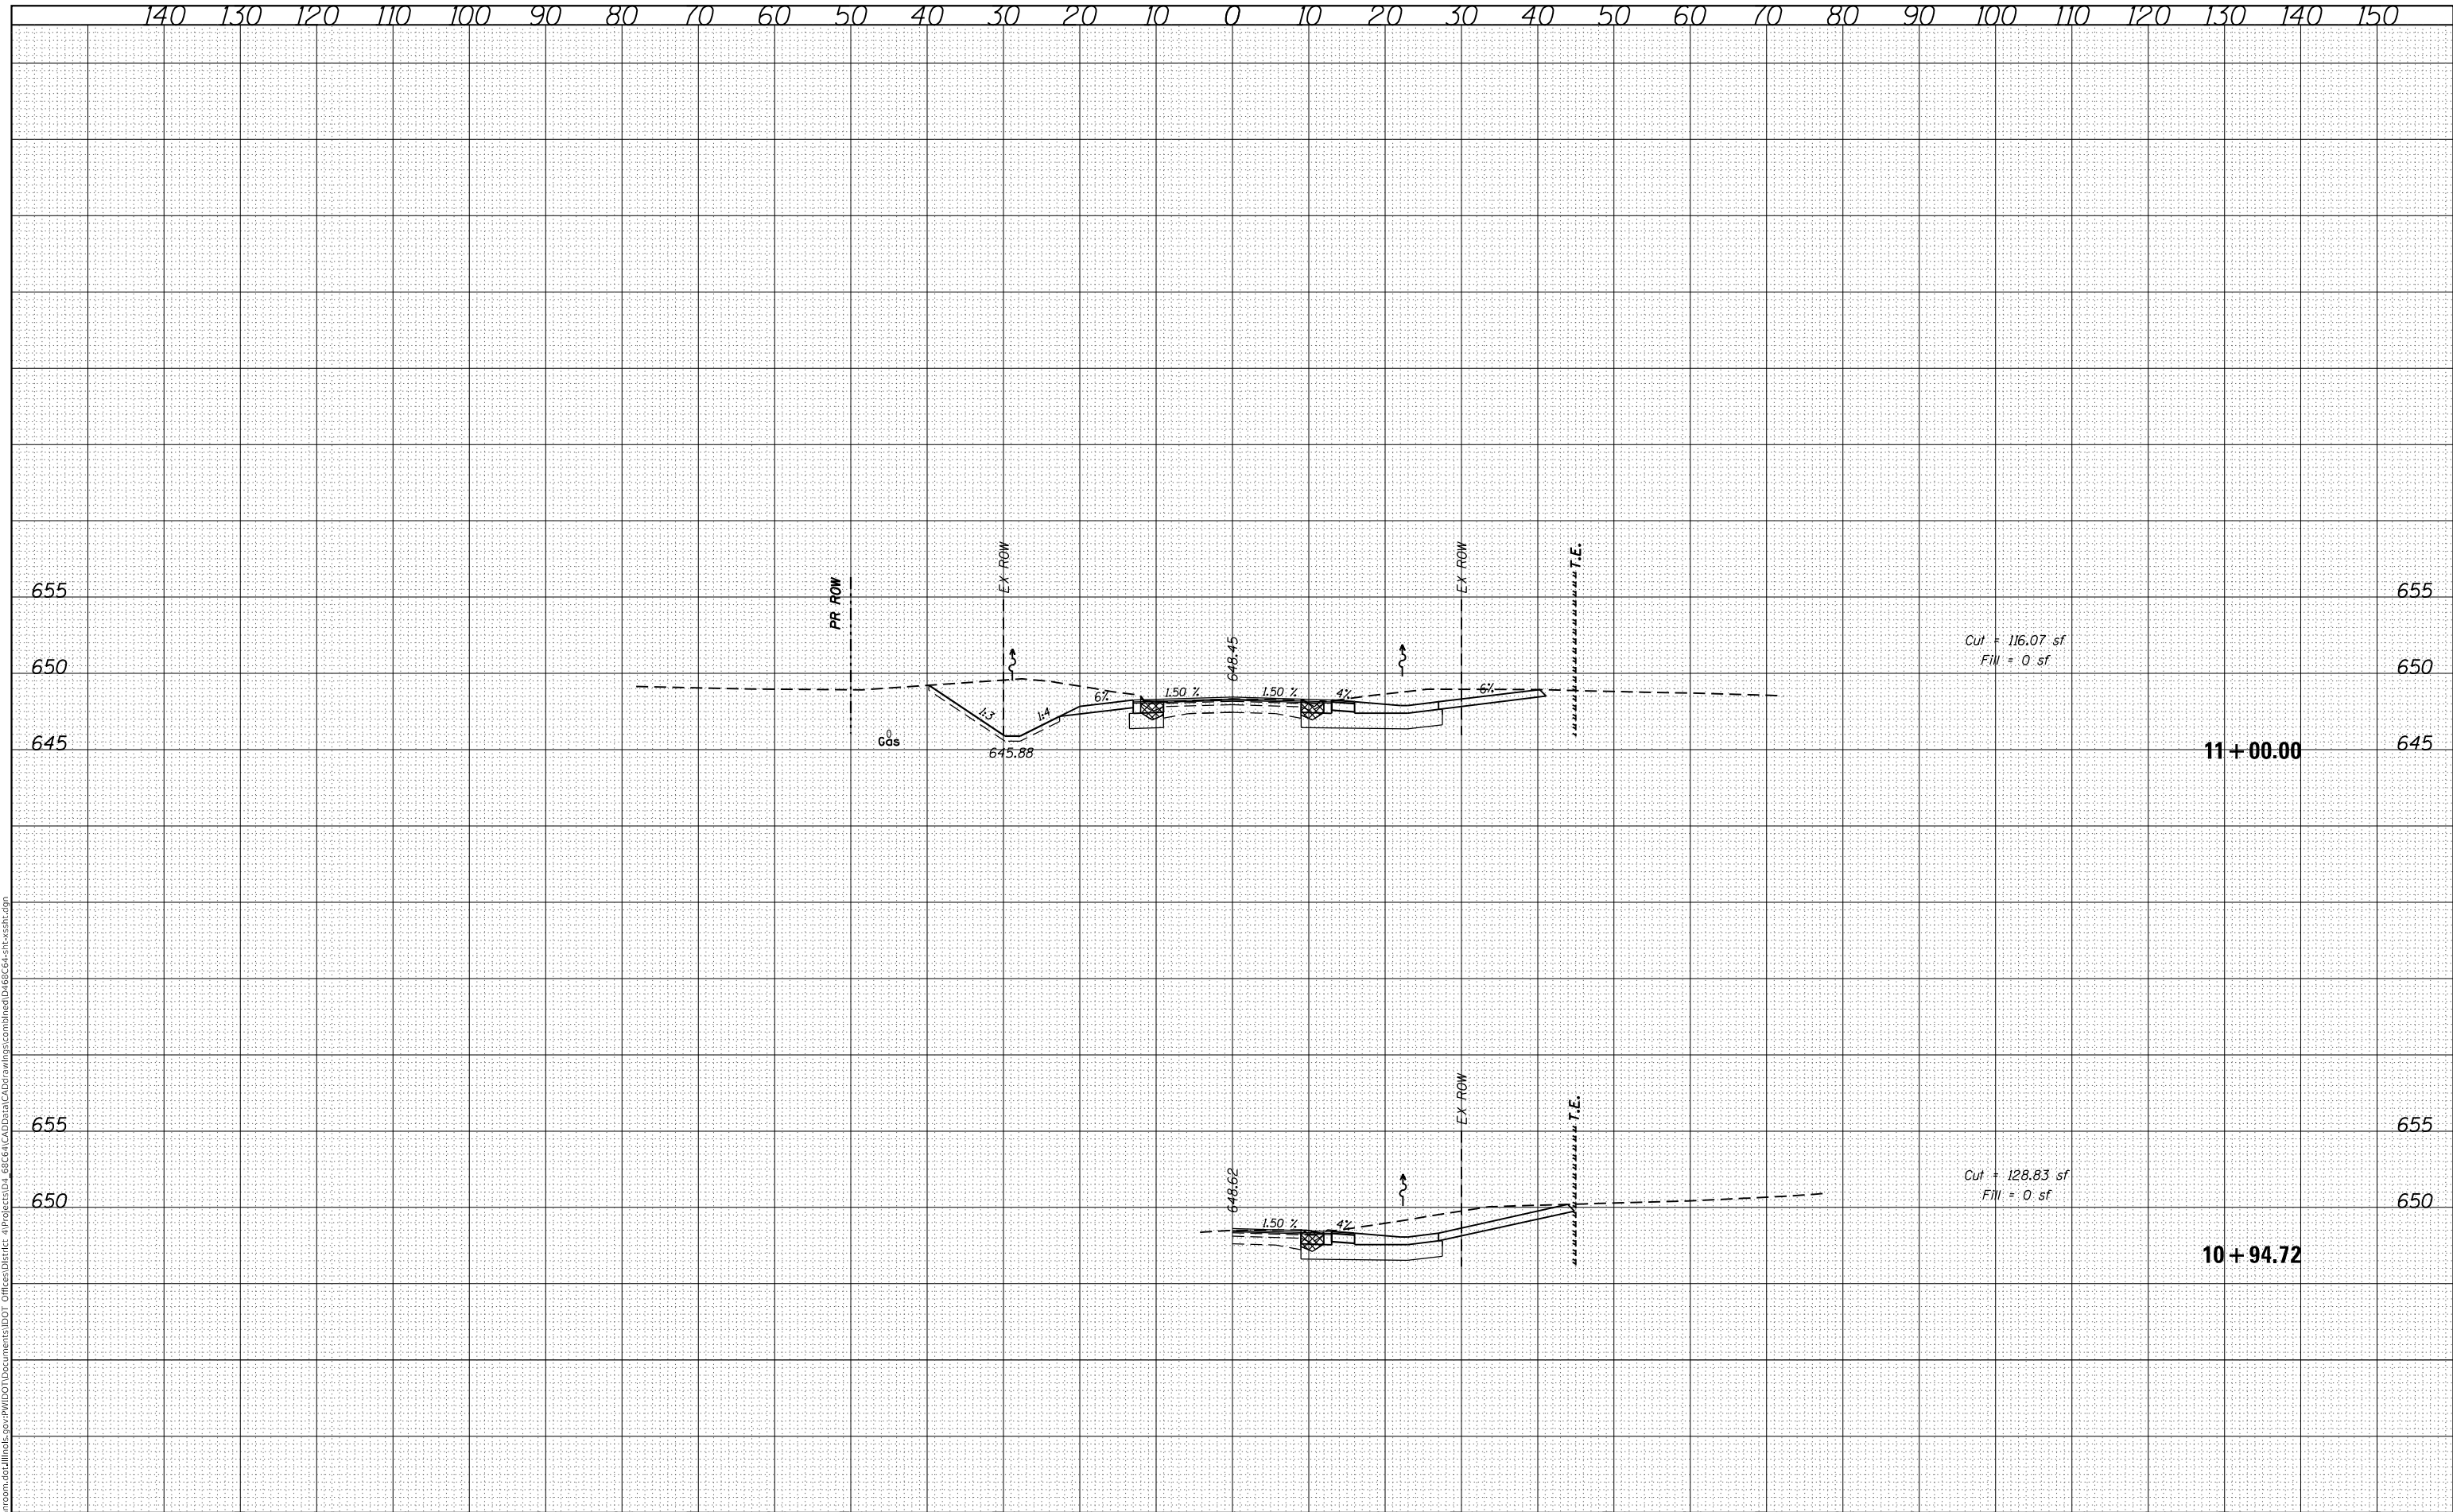**STATE OF ILLINOIS
DEPARTMENT OF TRANSPORTATION**

**IL 41
CROSS SECTIONS**

SCALE: SHEET OF SHEETS STA. 10+94.72 TO STA. 11+00.00

F.A.P. RTE. 574	SECTION (12)CR	COUNTY *	TOTAL SHEETS 202	SHEET NO. 100
CONTRACT NO. 68C64			ILLINOIS FED. AID PROJECT	