



F.A. RTE. NO.	SECTION	COUNTY	TOTAL SHEETS	SHEET NO.
308	*	ROCK ISLAND	210	207
STA.	TO STA.			
FED. ROAD DIST. NO.	ILLINOIS	FED. AID PROJECT		

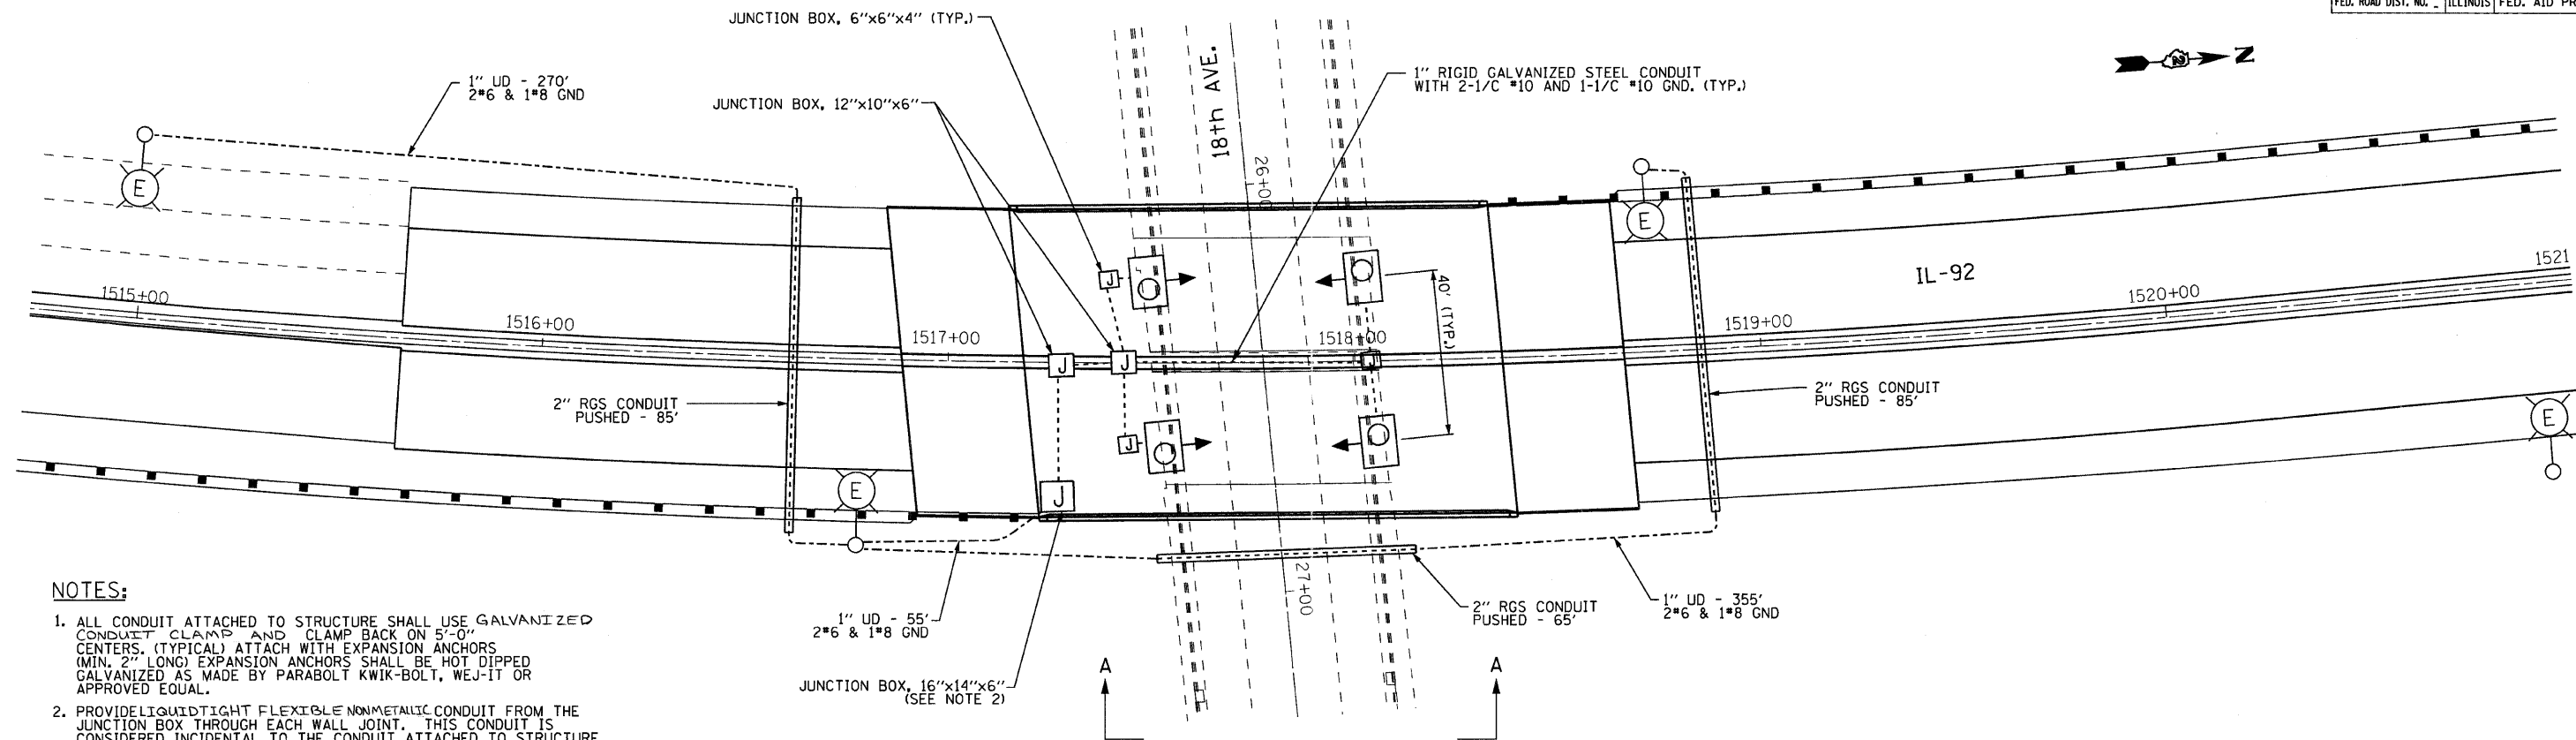


**NOTES:**

1. ALL CONDUIT ATTACHED TO STRUCTURE SHALL USE GALVANIZED CONDUIT CLAMP AND CLAMP BACK ON 5'-0" CENTERS. (TYPICAL) ATTACH WITH EXPANSION ANCHORS (MIN. 2" LONG) EXPANSION ANCHORS SHALL BE HOT DIPPED GALVANIZED AS MADE BY PARABOLT KWIK-BOLT, WEJ-IT OR APPROVED EQUAL.
2. PROVIDE LIQUID TIGHT FLEXIBLE NONMETALLIC CONDUIT FROM THE JUNCTION BOX THROUGH EACH WALL JOINT. THIS CONDUIT IS CONSIDERED INCIDENTAL TO THE CONDUIT ATTACHED TO STRUCTURE. NO ADDITIONAL COMPENSATION WILL BE ALLOWED.
3. LUMINAIRES SHALL BE SURFACE MOUNTED TO WALL WITH UNISTRUT P5500 STAINLESS STEEL CHANNELS (12 GAUGE) OR APPROVED EQUAL TO PROVIDE A MINIMUM CLEARANCE OF 2" BETWEEN THE BACK OF LUMINAIRE AND THE FACE OF THE WALL.
4. PROPOSED ELECTRICAL WORK TO BE DONE DURING STAGE 3.

PLAN  
1" = 20'

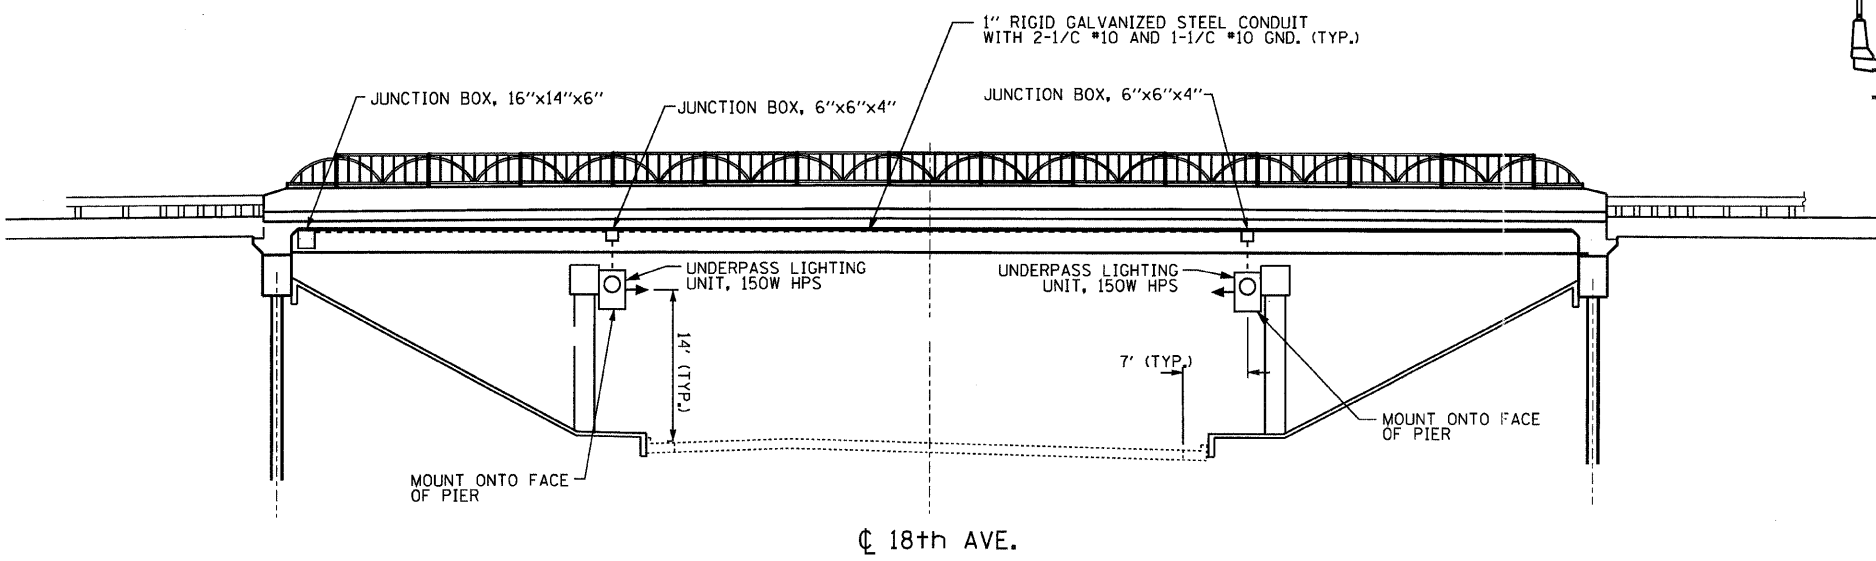

SECTION A-A  
LOOKING WEST  
NOT TO SCALE

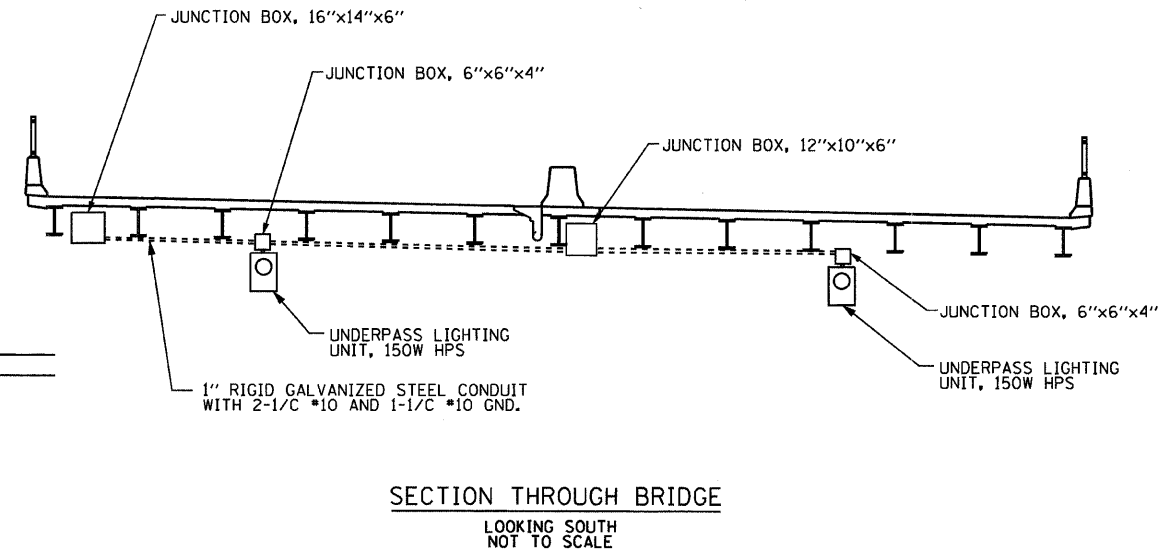

SECTION THROUGH BRIDGE  
LOOKING SOUTH  
NOT TO SCALE

**EJM** EJM ENGINEERING, INC.  
411 South Wells Street Suite 800  
Chicago, Illinois 60607

REVISIONS	
NAME	DATE

ILLINOIS DEPARTMENT OF TRANSPORTATION  
ILLINOIS ROUTE 92  
**PROPOSED ELECTRICAL PLAN  
18TH AVE.**  
SCALE: 1"=20'  
DATE: 11/26/07  
DRAWN BY: JDM  
CHECKED BY: JH

PLOT DATE \* DATE \*  
FILE NAME \* FILE \*  
USER NAME \* USER \*