
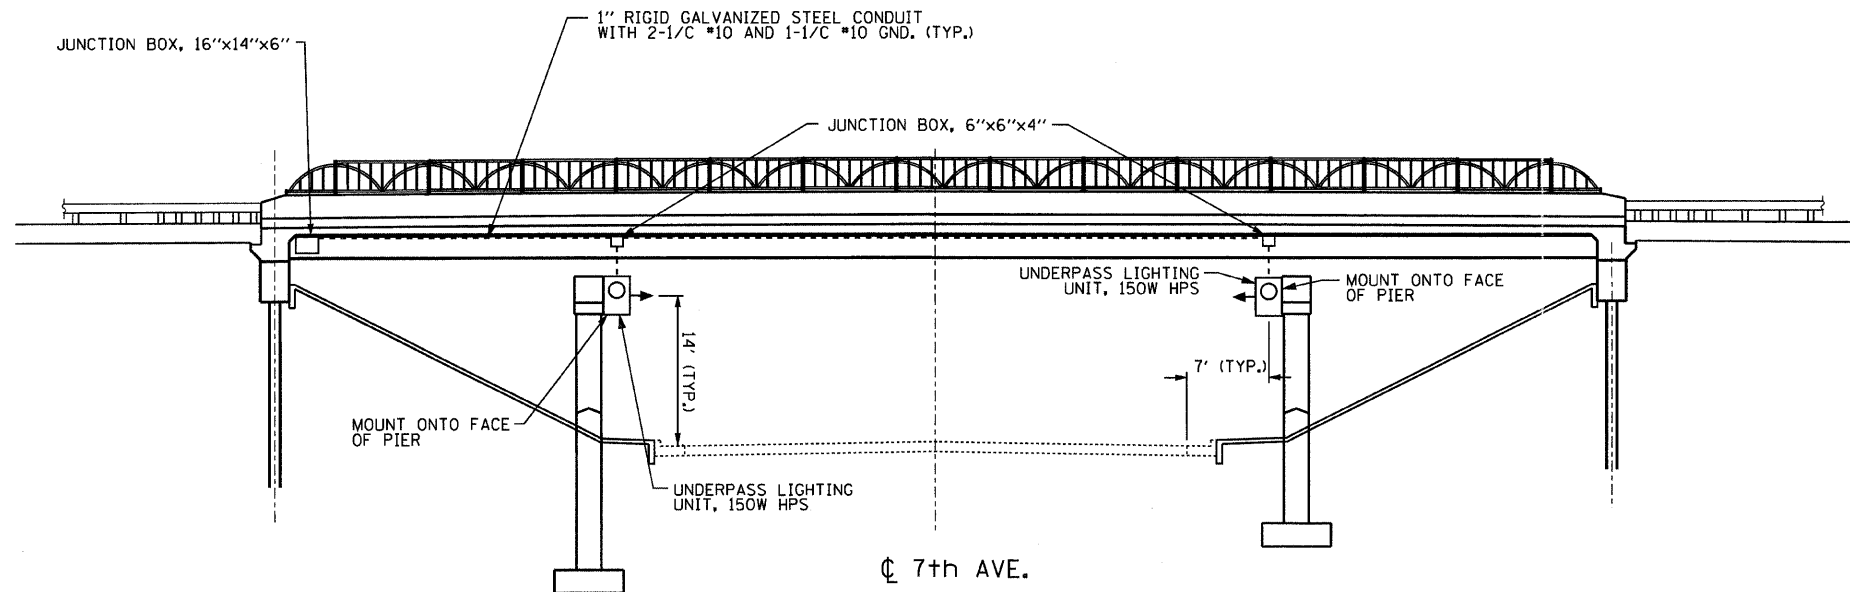



F.A. RTE.	SECTION	COUNTY	TOTAL SHEETS	SHEET NO.
308		ROCK ISLAND	210	209
STA.	TO STA.			
FED. ROAD DIST. NO.	ILLINOIS	FED. AID PROJECT		

NOTES:

1. ALL CONDUIT ATTACHED TO STRUCTURE SHALL USE GALVANIZED CONDUIT CLAMP AND CLAMP BACK ON 5'-0" CENTERS. (TYPICAL) ATTACH WITH EXPANSION ANCHORS (MIN. 2" LONG) EXPANSION ANCHORS SHALL BE HOT DIPPED GALVANIZED AS MADE BY PARABOLT KWIK-BOLT, WEJ-IT OR APPROVED EQUAL.
2. PROVIDE LIQUID TIGHT FLEXIBLE NONMETALLIC CONDUIT FROM THE JUNCTION BOX THROUGH EACH WALL JOINT. THIS CONDUIT IS CONSIDERED INCIDENTAL TO THE CONDUIT ATTACHED TO STRUCTURE. NO ADDITIONAL COMPENSATION WILL BE ALLOWED.
3. LUMINAIRES SHALL BE SURFACE MOUNTED TO WALL WITH UNISTRUT P5500 STAINLESS STEEL CHANNELS (12 GAUGE) OR APPROVED EQUAL TO PROVIDE A MINIMUM CLEARANCE OF 2" BETWEEN THE BACK OF LUMINAIRE AND THE FACE OF THE WALL.
4. PROPOSED ELECTRICAL WORK TO BE DONE DURING STAGE 3.

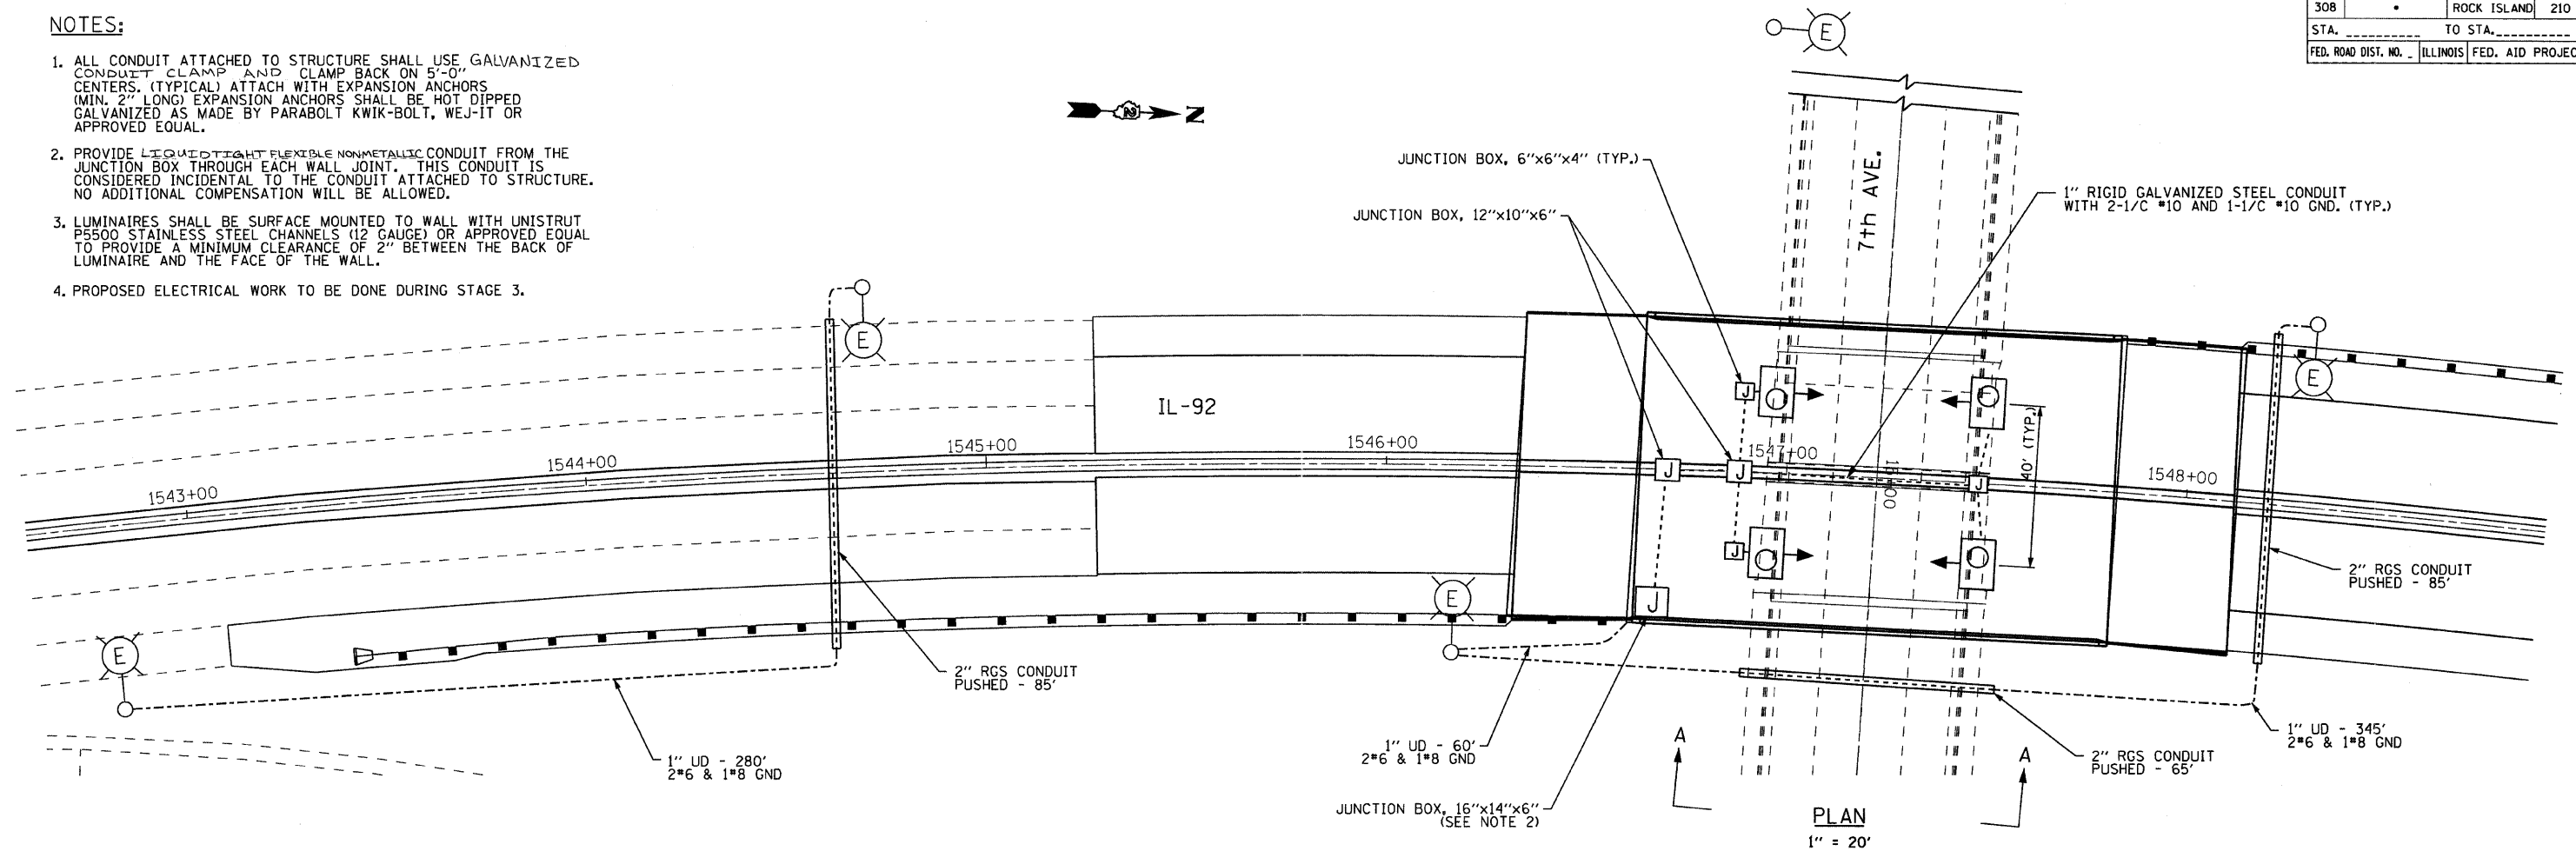

SECTION A-A
LOOKING WEST
NOT TO SCALE

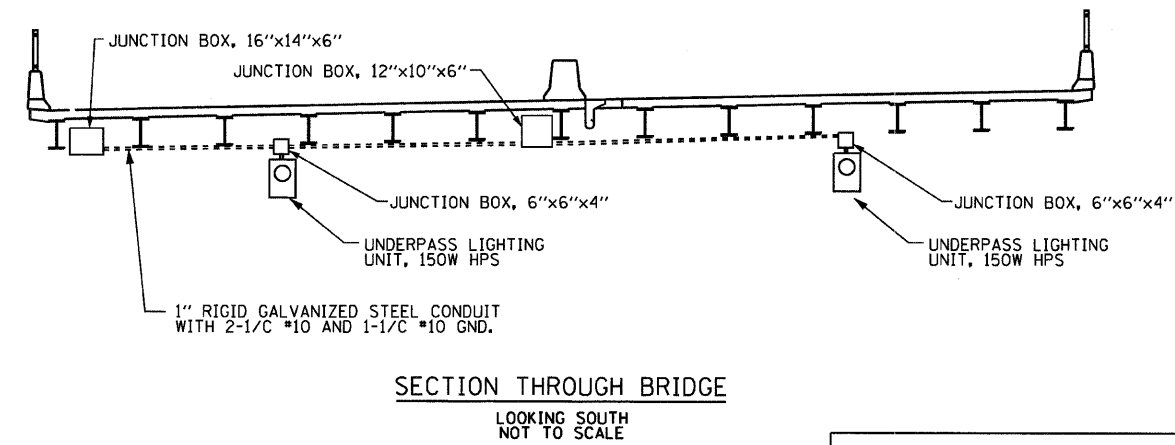

SECTION THROUGH BRIDGE
LOOKING SOUTH
NOT TO SCALE



ILLINOIS DEPARTMENT OF TRANSPORTATION
ILLINOIS ROUTE 92
PROPOSED ELECTRICAL PLAN
7TH AVE.

REVISIONS	
NAME	DATE

SCALE: 1"=20'
DATE: 11/26/07
DRAWN BY: JDM
CHECKED BY: JH

PLOT DATE: # DATES
FILE NAME: # FILES
PLOT SCALE: # SCALES
USER NAME: # USERS