
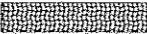

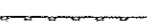

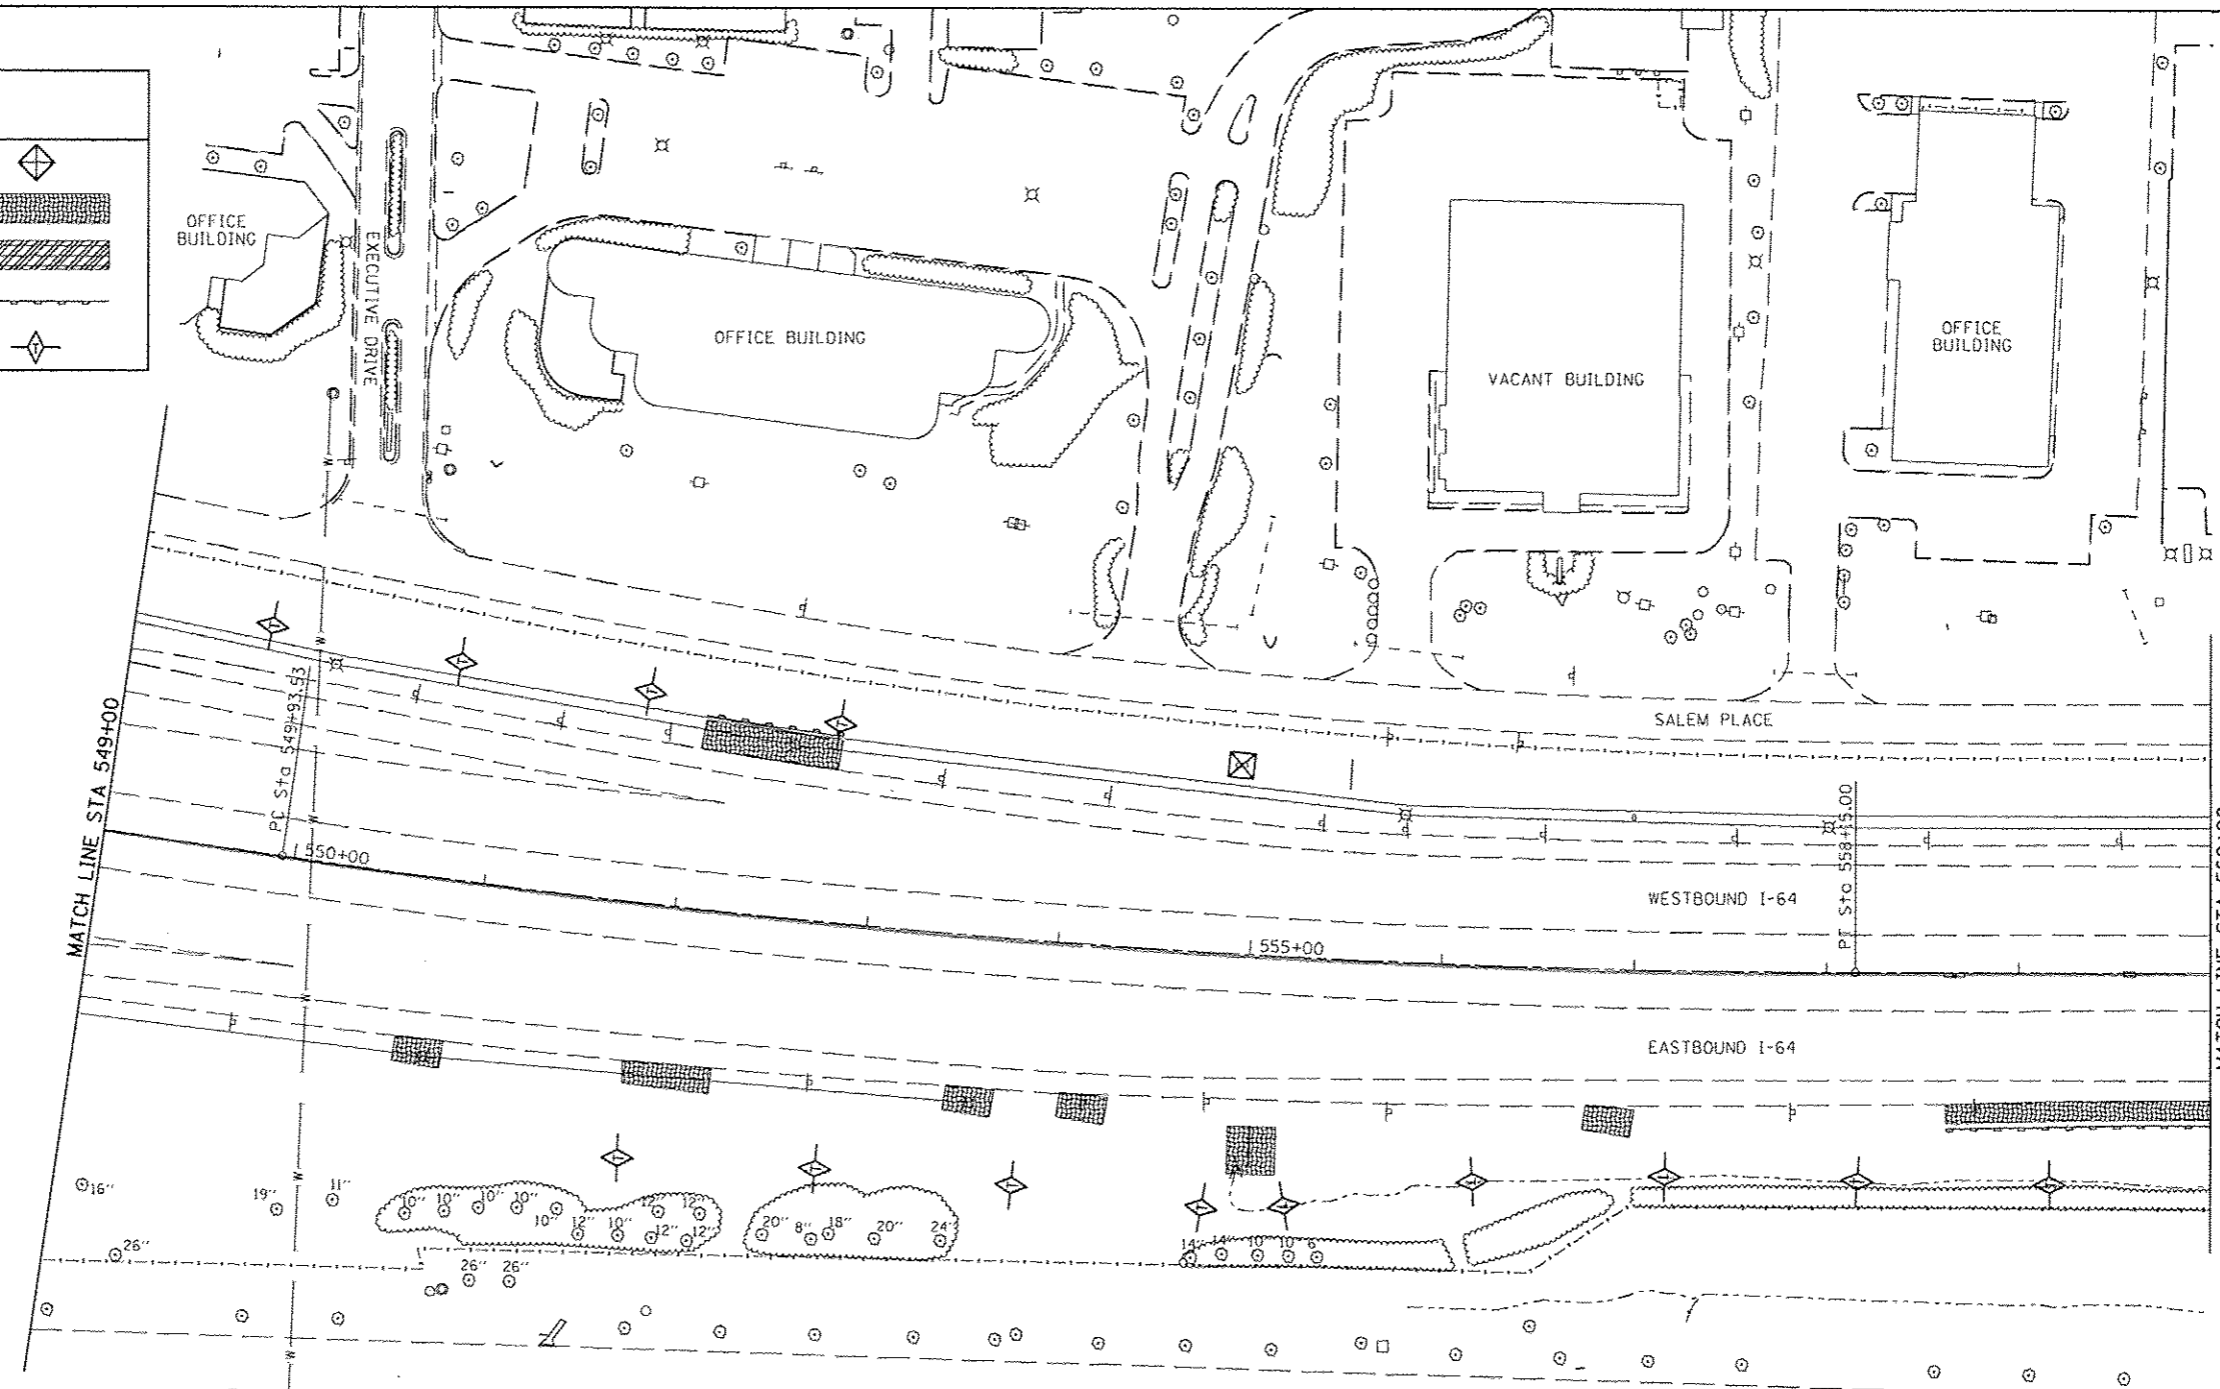




# LEGEND

- INLET & PIPE PROTECTION 
- EROSION CONTROL BLANKET 
- HEAVY DUTY EROSION CONTROL BLANKET 
- PERIMETER EROSION BARRIER 
- TEMPORARY DITCH CHECK 



EXIST. CURVE C1  
 PI STA. = 554+04.97  
 $\Delta = 8^{\circ} 12' 53''$  (L.T.)  
 $D = 1^{\circ} 00' 00''$   
 $R = 5,729.58'$   
 $T = 411.44'$   
 $L = 821.47'$   
 $E = 14.75'$   
 $e =$   
 $T.R. =$   
 $S.E. RUN =$   
 $P.C. STA. = 549+93.53$   
 $P.T. STA. = 558+15.00$

**NOTE:**  
 CADD DRAWINGS OF THE PROJECT WILL BE MADE AVAILABLE TO THE CONTRACTOR AT NO CHARGE FOR HIS/HER USE IN OBTAINING COORDINATES FOR LAYOUT OF THE PROPOSED IMPROVEMENTS

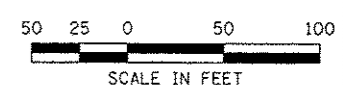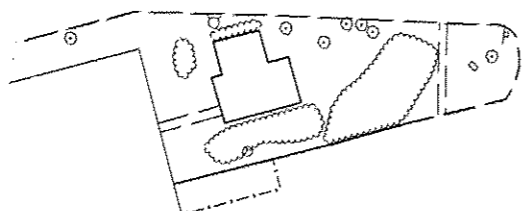

LAST SAVED = 7/6/2012  
 PEN TABLE = V8-Half.tbl  
 PLOT DRIVER = TR-V8pl-Block-Hal.tbl

FILE NAME =	USER NAME = jpeattibone	DESIGNED -	REVISED -
Plan_07.dgn		DRAWN -	REVISED -
PLOT SCALE = 100.0000' / IN.		CHECKED -	REVISED -
PLOT DATE = 7/6/2012 3:54:37 PM		DATE -	REVISED -

**HORNER & SHIFRIN, INC.**  
 ENGINEERS  
 www.HornerShifrin.com

**FAIRVIEW HEIGHTS**

**EROSION CONTROL PLAN**  
 INTERSTATE 64  
 STA 549+00 TO 560+00  
 SCALE: 1"=50' SHEET NO. 7 OF 10 SHEETS STA. TO STA.

I-64 / IL 159 INTERCHANGE ENHANCEMENT		TOTAL SHEETS	SHEET NO.
CONTRACT NO. 97455		60	57
SECTION 08-00037-00-LS			