03-08-2024 LETTING ITEM 134

FOR INDEX OF SHEETS, SEE SHEET NO. 2 FOR INDEX OF HIGHWAY STANDARDS SEE SHEET NO. 2

STATE OF ILLINOIS DEPARTMENT OF TRANSPORTATION

PLANS FOR PROPOSED FEDERAL AID HIGHWAY

FAU ROUTE 0163 FISH LAKE ROAD FROM IL 120 (BELVIDERE RD) TO NIPPERSINK ROAD RESURFACING/PATH IMPROVEMENTS SECTION: 15-08113-05-CH PROJECT: HVQH(429) VILLAGE OF VOLO LAKE COUNTY C-91-417-15

TRAFFIC DATA

ROAD NAME: FISH LAKE ROAD FUNCTIONAL CLASSIFICATION, MAJOR COLLECTOR POSTED SPEED LIMIT. 30 MPH DESIGN SPEED: 35 MPH ADT: 3,400 (2019)

> STA. 99+17.05 L ROUTE 12

> > GROSS LENGTH = 6,606.86 FEET = (1.251 MILES) NET LENGTH = 6,606.86 FEET = (1.251 MILES)

GRANT TOWNSHIP

END IMPROVEMENTS

FULL SIZE PLANS HAVE BEEN PREPARED USING STANDARD ENGINEERING SCALES. REDUCED SIZED PLANS WILL NOT CONFORM TO STANDARD SCALES. IN MAKING MEASUREMENTS ON REDUCED PLANS, THE ABOVE SCALES MAY BE USED.

J.U.L.I.E.

JOINT UTILITY LOCATION INFORMATION FOR EXCAVATION 1-800-892-0123 OR 811

BEGIN IMPROVEMENTS STA. 33+10.29

WAUCONDA TOWNSHII

(Not to Scale)

LOCATION MAP

DATE:

SIGNED:


FREEMONT TOWNSHIP

AVON TOWNSHIP

ILLINOIS LICENSE NO.: 062-067573 EXPIRATION DATE: NOVEMBER 30, 2025

625 Forest Edge Drive Vernon Hills, IL. 60061 TEL 847.478.9700 FAX 847.478.9701 GHA JOB #: 5867.200

SECTION 15-08113-05-CH LAKE II2 I CONTRACT #:

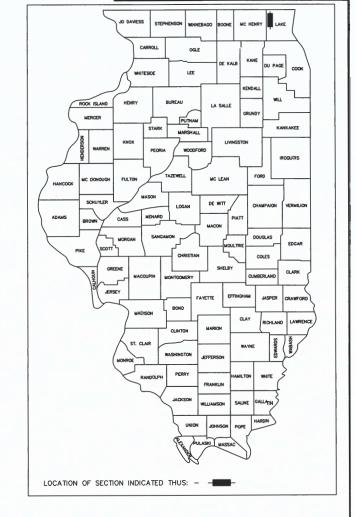

STATE OF ILLINOIS
DEPARTMENT OF TRANSPORTATION

Approved muhaul

Village of Volo, Village Administrator

Passed

Distric One Engineer of Local Roads & Streets

Releasing for Bid Based on Limited Review

3,2024 IR

PRINTED BY THE AUTHORITY OF THE STATE OF ILLINOIS

CONTRACT NO. 61K10

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SHEET INDEX

- 1 TITLE SHEET
- 2 INDEX OF SHEETS/GENERAL NOTES AND HIGHWAY STANDARDS
- 3 SOIL EROSION AND SEDIMENT CONTROL NOTES
- 4-12 SUMMARY OF QUANTITIES
- 13-16 TYPICAL SECTIONS
- 17 EARTHWORKS SCHEDULE
- 18 ALIGNMENT, TIES AND BENCHMARKS
- 19-24 EXISTING CONDITIONS / REMOVAL PLANS
- 25-36 PLAN AND PROFILES
- 37-39 DETOUR PLANS
- 40-45 SOIL EROSION AND SEDIMENT CONTROL PLANS
- 46-57 DRAINAGE AND UTILITY PLANS
- 58-60 ADA GRADING DETAILS
- 61-66 PAVEMENT MARKING PLANS
- 67-72 LANDSCAPE PLANS
- 73-74 RETAINING WALL DETAILS
- 75 LAKE COUNTY PUBLIC WORKS DETAILS
- 76-85 IDOT DISTRICT ONE DETAILS
- 86-112 CROSS SECTIONS

STATE STANDARDS

000001-08 STANDARD SYMBOLS, ABBREVIATIONS AND PATTERNS TEMPORARY EROSION CONTROL SYSTEMS
PERPENDICULAR CURB RAMPS FOR SIDEWALKS 280001-07 424001-11 DIAGONAL CURB RAMPS FOR SIDEWALKS
MID-BLOCK CURB RAMPS FOR SIDEWALKS 424006-05 424016-05 424026-03 ENTRANCE/ALLEY PEDESTRIAN CROSSINGS CLASS C AND D PATCHES
PRECAST REINFORCED CONCRETE FLARED END SECTION
PRECAST REINFORCED CONCRETE ELLIPTICAL FLARED END SECTION 442201-03 542306-03 CATCH BASIN TYPE A 602301-04 INLET - TYPE A INLET - TYPE B 602306-03 PRECAST MANHOLE TYPE A 4' (1.22 m) DIAMETER PRECAST MANHOLE TYPE A 5' (1.52 m) DIAMETER PRECAST REINFORCED CONCRETE FLAT SLAB TOP 602401-07 602402-03 602601-06 602701-02 MANHOLE STEPS 604001-05 FRAME AND LIDS TYPE 1 604036-03 GRATE TYPE 8 FRAME AND GRATE TYPE 11 604051-04 606001-08 CONCRETE CURB TYPE B AND COMBINATION CURB AND GUTTER CHAIN LINK FENCE 664001-02 701001-02 OFF-RD OPERATIONS, 2L, 2W, MORE THAN 15' AWAY OFF-RD OPERATIONS, 2L, 2W, 15' TO 24" FROM PAVEMENT EDGE OFF-RD, MOVING OPERATIONS, 2L, 2W, DAY ONLY 701006-05 LANE CLOSURE, 2L, 2W, SHORT TIME OPERATIONS
LANE CLOSURE, 2L, 2W, MOVING OPERATIONS—DAY ONLY 701301-04 701311-03 URBAN LANE CLOSURE, 2L, 2W, UNDIVIDED URBAN LANE CLOSURE, MULTILANE INTERSECTION 701501-06 701701-10

DISTRICT ONE DETAILS

701801-06

701901-09

720001-01

720006-04

780001-05

BD-03 OUTLET FOR CONCRETE CURB AND GUTTER
BD-07 STORM SEWER CONNECTION TO EXISTING SEWER
BD-08 DETAILS FOR FRAMES AND LIDS ADJUSTMENT WITH MILLING

(FOR SIGNS & MARKERS)

SIGN PANEL MOUNTING DETAILS SIGN PANEL ERECTION DETAILS

TYPICAL PAVEMENT MARKINGS

- BD-32 BUTT JOINT AND HMA TAPER DETAILS
- TC-10 TRAFFIC CONTROL AND PROTECTION FOR SIDE ROADS, INTERSECTIONS,

SIDEWALK, CORNER OR CROSSWALK CLOSURE TRAFFIC CONTROL DEVICES

APPLICATIONS OF TYPE A & B METAL POSTS

- AND DRIVEWAYS

 C-13 DISTRICT ONE TYPICAL PAVEMENT MARKINGS
- TC-16 SHORT TERM PAVEMENT MARKING LETTERS AND SYMBOLS TC-21 DETOUR SIGNING FOR CLOSING STATE HIGHWAYS
- TC-21 DETOUR SIGNING FOR CLOSING STATE HIGHWAYS
 TC-22 ARTERIAL ROAD INFORMATION SIGN
- TC-22 ARTERIAL ROAD INFORMATION SIG TC-26 DRIVEWAY ENTRANCE SIGNING

- **GENERAL NOTES**
 - 1. ALL CONSTRUCTION SHALL BE PERFORMED ACCORDING TO THE ILLINOIS DEPARTMENT OF TRANSPORTATION "STANDARD SPECIFICATIONS FOR ROAD AND BRIDGE CONSTRUCTION" ADOPTED JANUARY 1 2022, THE "SUPPLEMENTAL SPECIFICATIONS AND RECURRING SPECIAL PROVISIONS" ADOPTED JANUARY 1 2024, THE "STANDARD SPECIFICATIONS FOR WATER AND SEWER MAIN CONSTRUCTION IN ILLINOIS" LATEST EDITION, THE DETAILS IN THESE PLANS, THE CONTRACT DOCUMENTS, ALL APPLICABLE REQUIREMENTS OF THE ILLINOIS DEPARTMENT OF TRANSPORTATION, THE IEPA AND ORDINANCES OF AUTHORITIES HAVING JURISDICTION AND ALL ADDENDA THERETO.
 - 2. EASEMENTS FOR THE EXISTING UTILITIES, BOTH PUBLIC AND PRIVATE AND UTILITIES WITHIN PUBLIC RIGHTS-OF-WAY ARE SHOWN ON THE PLANS ACCORDING TO AVAILABLE RECORDS. THE CONTRACTOR SHALL BE RESPONSIBLE FOR DETERMINING THE EXACT LOCATION IN THE FIELD OF THESE UTILITY LINES AND THEIR PROTECTION FROM DAMAGE DUE TO CONSTRUCTION OPERATIONS. IF EXISTING UTILITY LINES OF ANY NATURE ARE ENCOUNTERED WHICH CONFLICT WITH NEW CONSTRUCTION, THE CONTRACTOR SHALL NOTIFY THE ENGINEER IMMEDIATELY SO THAT THE CONFLICT MAY BE RESOLVED.
 - 3. WHENEVER, DURING CONSTRUCTION OPERATIONS, ANY LOOSE MATERIAL IS DEPOSITED IN THE FLOW LINE OF GUTTERS, DRAINAGE STRUCTURES, DITCHES, ETC. SUCH THAT THE NATURAL FLOW LINE OF WATER IS OBSTRUCTED, THE LOOSE MATERIAL WILL BE REMOVED AT THE CLOSE OF EACH WORKING DAY. AT THE CONCLUSION OF CONSTRUCTION OPERATIONS, ALL DRAINAGE STRUCTURES AND FLOW LINES SHALL BE FREE FROM DIRT AND DEBRIS.
 - 4. THE CONTRACTOR SHALL VERIFY ALL DIMENSIONS AND EXISTING CONDITIONS AFFECTING THEIR WORK WITH THE ACTUAL CONDITIONS AT THE JOB SITE PRIOR TO ORDERING MATERIALS. IN ADDITION, THE CONTRACTOR MUST VERIFY THE LINE AND GRADES. IF THERE ARE ANY DISCREPANCIES FROM WHAT IS SHOWN ON THE CONSTRUCTION PLANS, STANDARD SPECIFICATIONS AND/OR SPECIAL DETAILS, THE CONTRACTOR SHALL SECURE WRITTEN INSTRUCTION FROM THE ENGINEER PRIOR TO PROCEEDING WITH ANY PART OF THE WORK AFFECTED BY OMISSION OR DISCREPANCIES. FAILING TO SECURE SUCH INSTRUCTION, THE CONTRACTOR WILL BE CONSIDERED TO HAVE PROCEEDED AT HIS/HER OWN RISK.
 - 5. ALL PAVEMENT DIMENSIONS ARE SHOWN TO EDGE OF PAVEMENT UNLESS OTHERWISE NOTED.
 - 6. WHERE SECTION OR SUBSECTION MONUMENTS ARE ENCOUNTERED, THE ENGINEER SHALL BE NOTIFIED BEFORE THE MONUMENTS ARE REMOVED. THE CONTRACTOR SHALL CAREFULLY PRESERVE ALL PROPERTY MARKS AND MONUMENTS UNTIL THE OWNER, AUTHORIZED SURVEYOR OR AGENT HAS WITNESSED OR OTHERWISE REFERENCED THEIR LOCATION.
 - 7. THE CONTRACTOR SHALL NOTIFY THE ENGINEER AT LEAST 72 HOURS PRIOR TO BEGINNING WORK.
 - 8. IF DURING CONSTRUCTION THE CONTRACTOR ENCOUNTERS OR OTHERWISE BECOMES AWARE OF ANY SEWERS OR UNDERDRAINS OTHER THAN THOSE SHOWN ON THE PLANS, HE/SHE SHALL INFORM THE ENGINEER, WHO SHALL DIRECT THE WORK NECESSARY TO MAINTAIN OR REPLACE THE FACILITIES IN SERVICE AND TO PROTECT THEM FROM DAMAGE DURING CONSTRUCTION IF MAINTAINED. EXISTING FACILITIES TO BE MAINTAINED THAT ARE DAMAGED BECAUSE OF NON-COMPLIANCE WITH THIS PROVISION SHALL BE REPLACED.
 - 9. THE CONTRACTOR SHALL PROVIDE TEMPORARY TOILET FACILITIES AND HAND SANITIZING STATIONS FOR THE USE OF ALL CONTRACTORS PERSONNEL EMPLOYED ON THE WORK SITE. THE FACILITIES SHALL BE MAINTAINED IN PROPER SANITARY CONDITION THROUGHOUT THE PROJECT. THE LOCATION OF THE TEMPORARY FACILITIES SHALL BE APPROVED BY THE ENGINEER.
 - 10. THE CONTRACTOR IS RESPONSIBLE FOR COMPLYING WITH THE NPDES PERMIT AND SWPPP MANUAL IF NO NPDES PERMIT OR SWPPP MANUAL IS NEEDED FOR THE PROJECT THE CONTRACTOR SHALL PERFORM SOIL EROSION SEDIMENT CONTROL BEST PRACTICES OR AS DIRECTED BY THE OWNER TO PREVENT ILLICIT DISCHARGES FROM THE SITE.
 - 11. ANY PROPOSED ACTIVITY IN THE VICINITY OF A HIGHWAY-RAIL GRADE CROSSING MUST ADHERE TO THE GUIDELINES SET FORTH IN THE MANUAL ON UNIFORM TRAFFIC CONTROL DEVICES (MUTCD) UNDER SECTION 6G.18: WORK IN THE VICINITY OF A GRADE CROSSING WHICH STATES: "WHEN GRADE CROSSINGS EXIST EITHER WITHIN OR IN THE VICINITY OF A TTC ZONE, LANE RESTRICTIONS, FLAGGING, OR OTHER OPERATIONS SHALL NOT CREATE CONDITIONS WHERE VEHICLES CAN BE QUEUED ACROSS THE TRACKS. IF THE QUEUING OF VEHICLES ACROSS THE TRACKS CANNOT BE AVOIDED, A UNIFORMED LAW ENFORCEMENT OFFICER OR FLAGGER SHALL BE PROVIDED AT THE CROSSING TO PREVENT VEHICLES FROM STOPPING ON THE TRACKS, EVEN IF AUTOMATIC WARNING DEVICES ARE IN PLACE.
 - 12. THE SUBGRADE STABILITY SHALL BE VERIFIED BY PROOF ROLLING WITH A FULLY LOADED TANDEM-AXLE TRUCK.
 - 13. GEOTECHNICAL FABRIC FOR GROUND STABILIZATION AND/OR AGGREGATE SUBGRADE IMPROVEMENT (CU YD) HAS BEEN PROVIDED FOR USE AT THE LOCATIONS INDICATED FOR SOILS THAT TEND TO BE UNSTABLE AND/OR UNSUITABLE. THE ACTUAL NEED FOR REMOVAL AND REPLACEMENT WITH ASI WILL BE DETERMINED IN THE FIELD AT THE TIME OF CONSTRUCTION BY THE GEOTECHNICAL ENGINEER. ALL POTENTIALLY UNSTABLE SOILS SHOULD BE TESTED WITH A STATIC OR DYNAMIC CONE PENETROMETER AND TREATED IN ACCORDANCE WITH ARTICLE 301.04 OF THE SSRBC AND IDOT SUBGRADE STABILITY MANUAL. IF UNSTABLE AND/OR UNSUITABLE SOILS ARE NOT ENCOUNTERED, THEN THE QUANTITY SHALL BE DEDUCTED AND NO ADDITIONAL COMPENSATION WILL BE DUE TO THE CONTRACTOR
 - 13. ANY AGGREGATE SUBGRADE IMPROVEMENT CONTAMINATED AND/OR DAMAGED BY THE CONTRACTOR'S VEHICLES AND/OR EQUIPMENTS IS TO BE REMOVED AND REPLACED AS DIRECTED BY THE ENGINEER AT THE CONTRACTOR'S EXPENSE.
 - 14. THE CONTRACTOR SHALL CONTACT THE DISTRICT ONE TRAFFIC CONTROL SUPERVISOR VIA EMAIL AT KALPANA.KANNAN-HOSADURGA@ILLINOIS.GOV A MINIMUM OF 72 HOURS IN ADVANCE OF BEGINNING WORK.
 - 15. TWO (2) WEEKS PRIOR TO THE PLACEMENT OF PERMANENT PAVEMENT MARKINGS, THE ENGINEER SHALL CONTACT THE AREA TRAFFIC FIELD ENGINEER, FADI SULTAN, VIA EMAIL AT FUDI.SULTAN@ILLINOIS.GOV
 - 16. THE AGGREGATE GRADATION FOR THE AGGREGATE SUBGRADE IMPROVEMENT 12" LOWER LIFT SHALL BE CS 1 OR RR 1.
 - 17. PER THE SPECIFICATIONS FOR SEGMENTAL CONCRETE BLOCK WALL, THE WALL SUPPLIER SHALL SUBMIT DESIGN COMPUTATIONS AND SHOP PLANS TO THE ENGINEER FOR REVIEW. NO WORK OR ORDERING OF MATERIALS FOR THE STRUCTURE SHALL BE DONE BY THE CONTRACTOR UNTIL THE SUBMITTAL HAS BEEN APPROVED IN WRITING BY THE ENGINEER.
 - 18. SEGMENTAL CONCRETE BLOCK WALL SUPPLIER SHALL PROVIDE DETAILS REQUIRED FOR CONSTRUCTION OF THE PROPOSED WALLS. ALL SEGMENTAL CONCRETE BLOCK WALL DETAILS SHOWN IN THESE PLANS ARE CONCEPTUAL AND ARE TO BE USED FOR ESTIMATING PURPOSES ONLY. ACTUAL DETAILS WILL DEPEND ON THE PROPOSED WALL SYSTEM SUBMITTED BY THE CONTRACTOR. DETAILS FOR WALL CURVES, PIPE PENETRATIONS, DRAINAGE STRUCTURES OR TREES BEHIND WALLS OR OTHER MISCELLANEOUS DETAILS SHALL BE PROVIDED BY THE WALL SUPPLIER.
 - 19. CONTRACTOR SHALL TAKE PRECAUTION BY PRESERVING EXISTING TREES WITHIN THE RIGHT-OF-WAY. IF ANY DAMAGE OCCURS, TREES SHALL BE REPLACED IN KIND PER ARTICLE 201.07, REPAIR OR REPLACEMENT OF EXISTING PLANT MATERIAL, REQUIREMENTS STATED HERRIN.
 - 20. EXISTING VEGETATED AREAS (TREES, SHRUBS, VEGETATIVE BUFFERS, TURF AREAS, ETC.) WHERE DISTURBANCE IS NOT OCCURRING (INCLUDING AREAS OUTSIDE THE PROJECT LIMITS) SHALL NOT BE DISTURBED TO ENSURE THAT EXISTING VEGETATION IS PRESERVED HEALTHY TO MINIMIZE SOIL EROSION AND TO ELIMINATE SOIL COMPACTION. NO MATERIALS ARE TO BE STORED OR VEHICLES DRIVEN OR PARKED WITHIN THESE UNDISTURBED AREAS AT ANY TIME.
 - 21. PHOSPHORUS FERTILIZER HAS BEEN INTENTIONALLY OMITTED. A PHOSPHORUS—FREE FERTILIZER IN THAT AREA SHALL BE USED (MIDDLE NUMBER SHOULD EQUAL 0).

- 23. TEMPORARY FENCE SHOULD BE ERECTED ALONG THE DRIPLINE OF THE TREES, SHRUBS, AND LANDSCAPED BEDS WITHIN THE LIMITS OF CONSTRUCTION DESIGNATED TO REMAIN TO ESTABLISH A "TREE PROTECTION ZONE" AND AROUND EXISTING WETLANDS TO ESTABLISH A "WETLAND PROTECTION ZONE" BEFORE ANY WORK BEGINS OR ANY MATERIAL IS DELIVERED TO THE JOBSITE. NO WORK IS TO BE PERFORMED (OTHER THAN ROOT PRUNING), MATERIALS STORED, OR VEHICLES DRIVEN OR PARKED WITHIN THE "TREE PROTECTION ZONE" AND "WETLAND PROTECTION ZONE". REMOVE PROTECTIVE TEMPORARY FENCE ONLY AFTER ALL CONSTRUCTION WORK HAS BEEN COMPLETED.
- 24. THE CONTRACTOR SHALL ATTACH AN ALUMINUM SIGN WITH THE FOLLOWING TEXT: PROTECTED WETLAND -NO INTRUSION. THE SIGN(S) SHALL BE ATTACHED TO THE STAKES BY A METHOD APPROVED BY THE ENGINEER. THE SIGN(S) WILL BE PROVIDED BY THE DEPARTMENT AND SHALL BE PICKED UP BY THE CONTRACTOR FROM THE DISTRICT ONE ROADSIDE DEVELOPMENT ARCHITECT IN SCHAUMBURG, ILLINOIS. SCHEDULING THE PICKUP OF THE SIGNS CAN BE ARRANGED BY CONTACTING THE DISTRICT ONE ROADSIDE DEVELOPMENT UNIT AT (847)705-4171. WHEN WORK HAS BEEN COMPLETED, THE SIGN SHALL BE RETURNED TO THE DISTRICT ONE ROADSIDE DEVELOPMENT UNIT. THE COST OF PICKING UP, ATTACHING THE SIGNS TO THE TEMPORARY FENCE STAKES, AND RETURNING THE SIGNS WILL NOT BE PAID FOR SEPARATELY, BUT SHALL BE INCLUDED IN THE CONTRACT UNIT PRICE FOR TEMPORARY FENCE.
- 25. CONTACT LAKE COUNTY PUBLIC WORKS (LCPW) AT 847-377-7500 A MINIMUM OF 48 HOURS PRIOR TO THE START OF CONSTRUCTION.
- 26. LAKE COUNTY PUBLIC WORKS SHALL BE GRANTED ACCESS TO ALL PARTS OF THE CONSTRUCTION SITE AND SHALL HAVE THE AUTHORITY TO INSPECT, APPROVE, AND/OR REJECT ALL SANITARY SEWER AND SANITARY SERVICE IMPROVEMENTS.
- 27. LAKE COUNTY PUBLIC WORKS SHALL BE INVITED TO THE PRE-CONSTRUCTION MEETING. PLEASE CONTACT TOM MILES, PRINCIPAL ENGINEER, 847-377-7150, TMILES@LAKECOUNTYIL.GOV

UTILITY NOTES

- MACHINE CORE ALL CONNECTIONS TO EXISTING STRUCTURES USING A CORE DRILL. HAMMERING OR SAWING OF STRUCTURES WILL NOT BE ALLOWED.
- 2. ALL CONNECTIONS TO EXISTING OR DISSIMILAR STORM/SANITARY LINES SHALL BE DONE WITH STAINLESS STEEL NON-SHEAR COUPLINGS.
- 3. STONE BEDDING AND BACKFILL SHALL BE OMITTED FOR A DISTANCE OF 15 FEET UP AND DOWNSTREAM OF SEWERS DRAINING TO OR FROM PONDS OR STREAMS. THE REPLACED BEDDING SHALL BE SILTY CLAY SOIL MECHANICALLY COMPACTED TO 90% MODIFIED PROCTOR DENSITY. THE USE OF PERMEABLE SOILS WILL NOT BE PERMITTED.

COMMITMENTS

COMMITMENTS ARE NOT TO BE ALTERED WITHOUT THE WRITTEN APPROVAL OF ALL PARTIES TO WHICH THE COMMITMENT WAS MADE.

IDNR COMMITMENTS

- I. GOOD HOUSEKEEPING PRACTICES SHOULD BE IMPLEMENTED AND MAINTAINED DURING AND AFTER CONSTRUCTION TO PREVENT TRASH AND OTHER DEBRIS FROM INADVERTENTLY BLOWING OR WASHING INTO NEARBY NATURAL AREAS.
- 2. SOIL EROSION AND SEDIMENT CONTROL BMPS SHOULD BE IMPLEMENTED AND PROPERLY MAINTAINED.
- 3. DISTURBED AREAS SHOULD BE RESEEDED WITH AN APPROPRIATE NATIVE SEED MIX THAT CONTAINS FORBS AS WELL AS GRASSES (SUCH AS IDOT CLASS 5, 5A, OR 5B SEED MIX), WHERE FEASIBLE.
- 4. IF EROSION CONTROL BLANKET IS TO BE USED, WILDLIFE—FRIENDLY PLASTIC—FREE BLANKET SHOULD BE USED AROUND WETLANDS AND ADJACENT TO NATURAL AREAS, IF NOT FEASIBLE TO IMPLEMENT PROJECT WIDE, TO PREVENT THE ENTANGLEMENT OF NATIVE WILDLIFE.
- 5. ANY REQUIRED NIGHT LIGHTING SHOULD FOLLOW INTERNATIONAL DARK—SKY ASSOCIATION (IDA) GUIDANCE TO MINIMIZE THE EFFECT OF LIGHT POLLUTION ON WILDLIFE. MEASURES SHOULD INCLUDE SHIELDING FIXTURES SO NO LIGHT TRAVELS UPWARD, USING "WARM—WHITE" OR FILTERED LEDS (CCT < 3,000K) TO MINIMIZE BLUE EMISSION, AND AVOIDING OVER—LIGHTING.</p>
- 5. TREES THREE (3) INCHES OR GREATER IN DIAMETER AT BREAST HEIGHT SHALL NOT BE CLEARED FROM APRIL 1ST THROUGH SEPTEMBER 30TH OF ANY GIVEN YEAR.
- 7. COMPENSATION FOR PERMANENT WETLAND LOSSES WILL BE PROVIDED AT A COMMERCIAL WETLAND BANK.

FILE NAME = 5867.200_Sht-DT.dwg	USER NAME = MARK COBB	DESIGNED - MGFC	REVISED	-	
		DRAWN - MGFC	REVISED	-	STATE OF ILLINOIS
	PLOT SCALE = 1" = .0833'	CHECKED - DPB	REVISED	-	DEPARTMENT OF TRANSPORTATION
	PLOT DATE = 1/30/2024 11:48 AM	DATE - 12/18/2023	REVISED	-	

INDEX OF SHE	EETS, GENERAL NOTE	S AND :	STATE STANDARDS	FAU. RTE	SECTION	COUNTY	TOTAL SHEETS	SHEET NO.
	FISH LAKE ROAD IM			0163	15-08113-05-CH	LAKE	112	2
	I IOII LAKE NOAD IMI			CONTRACT	# : 61	K10		
SCALE: N.A.	SHEET NO. 1 OF 1 SHEETS	STA.	TO STA.	ILLINOIS FED. AID PROJECT				



TYPICAL CONSTRUCTION SEQUENCING

- 1.) Installation of soil erosion and sediment control SE/SC measures
 - a.) Selective vegetation removal for silt fence installationb.) Silt fence installation
 - Construction fencing around areas not to be disturbed
 -) Stabilized construction entrance
- 2.) Tree removal where necessary (clear & grub)
- 3.) Construct sediment trapping devices (sediment traps, basins...)
- Construct detention facilities and outlet control structure with restrictor & temporary perforated riser
- 5.) Strip topsoil, stockpile topsoil and grade site
- 6.) Temporarily stabilize topsoil stockpiles (seed and silt fence around toe of slope)
- 7.) Install storm sewer, sanitary sewer, water and associated inlet & outlet protection
- 8.) Permanently stabilize detention basins with seed and erosion control blanket
- 9.) Temporarily stabilize all areas including lots that have reached temporary grade
- 10.) Install roadways
- 11.) Permanently stabilize all outlot areas
- 12.) Install structures and grade individual lots
- 13.) Permanently stabilize lots
- 14.) Remove all temporary SE/SC measures after the site is stabilized with vegetation
- * Soil erosion and sediment control maintenance must occur every two weeks and after every ½ or greater rainfall event

U:\Regulatory Program\SESC handouts\TYPICAL CONSTRUCTION SEQUENCING.doc

LAKE COUNTY STORMWATER MANAGEMENT COMMISSION SOIL EROSION AND SEDIMENT CONTROL CONSTRUCTION NOTES

- A.SEDIMENT CONTROL MEASURES SHALL BE INSTALLED PRIOR TO THE COMMENCEMENT OF HYDROLOGIC DISTURBANCE OF UPLAND AREAS.
- B.FOR THOSE DEVELOPMENTS THAT REQUIRE A DESIGNATED EROSION CONTROL INSPECTOR (DECI), INSPECTIONS AND DOCUMENTATION SHALL BE PERFORMED, AT A MINIMUM:
- UPON COMPLETION OF SEDIMENT AND RUNOFF CONTROL MEASURES (INCLUDING PERIMETER CONTROLS AND DIVERSIONS), PRIOR TO PROCEEDING WITH ANY OTHER EARTH DISTURBANCE OR GRADING.
- AFTER EVERY SEVEN (7) CALENDAR DAYS OR STORM EVENT WITH GREATER THAN 0.5 INCH
 OF RAINFALL OR LIQUID EQUIVALENT PRECIPITATION.
- C.SOIL DISTURBANCE SHALL BE CONDUCTED IN SUCH A MANNER AS TO MINIMIZE EROSION. IF STRIPPING, CLEARING, GRADING, OR LANDSCAPING ARE TO BE DONE IN PHASES, THE PERMITTEE SHALL PLAN FOR APPROPRIATE SOIL EROSION AND SEDIMENT CONTROL MEASURES.
- D. A STABILIZED MAT OF CRUSHED STONE MEETING IDOT GRADATION CA-1 UNDERLAIN WITH FILTER FABRIC AND IN ACCORDANCE WITH THE ILLINOIS URBAN MANUAL, OR OTHER APPROPRIATE MEASURE(S) AS APPROVED BY THE ENFORCEMENT OFFICER, SHALL BE INSTALLED AT ANY POINT WHERE TRAFFIC WILL BE ENTERING OR LEAVING A CONSTRUCTION SITE. SEDIMENT OR SOIL REACHING AN IMPROVED PUBLIC RIGHT-OF-WAY, STREET, ALLEY OR PARKING AREA SHALL BE REMOVED BY SCRAPING OR STREET CLEANING AS ACCUMULATIONS WARRANT AND TRANSPORTED TO A CONTROLLED SEDIMENT DISPOSAL AREA.
- E.TEMPORARY DIVERSIONS SHALL BE CONSTRUCTED AS NECESSARY TO DIRECT ALL RUNOFF FROM HYDROLOGICALLY DISTURBED AREAS TO AN APPROPRIATE SEDIMENT TRAP OR BASIN.
- F.DISTURBED AREAS SHALL BE STABILIZED WITH TEMPORARY OR PERMANENT MEASURES WITHIN SEVEN (7) CALENDAR DAYS FOLLOWING THE END OF ACTIVE HYDROLOGIC DISTURBANCE OR REDISTURBANCE.
- G.ALL STOCKPILES SHALL HAVE APPROPRIATE MEASURES TO PREVENT EROSION. STOCKPILES SHALL NOT BE PLACED IN FLOOD PRONE AREAS OR WETLANDS AND DESIGNATED BUFFERS.
- H.SLOPES STEEPER THAN 3H:1V SHALL BE STABILIZED WITH APPROPRIATE MEASURESAS APPROVED BY THE ENFORCEMENT OFFICER.
- I. APPROPRIATE EROSION CONTROL BLANKET SHALL BE INSTALLED ON ALL INTERIOR DETENTION BASIN SIDE SLOPES BETWEEN THE NORMAL WATER LEVEL AND HIGH WATER LEVEL.
- J.STORM SEWERS THAT ARE OR WILL BE FUNCTIONING DURING CONSTRUCTION SHALL BE PROTECTED BY AN APPROPRIATE SEDIMENT CONTROL MEASURE.
- K.IF DEWATERING SERVICES ARE USED, ADJOINING PROPERTIES AND DISCHARGE LOCATIONS SHALL BE PROTECTED FROM EROSION AND SEDIMENTATION. DISCHARGES SHALL BE ROUTED THROUGH AN APPROVED ANIONIC POLYMER DEWATERING SYSTEM OR A SIMILAR MEASURE AS APPROVED BY THE ENFORCEMENT OFFICER. DEWATERING SYSTEMS SHOULD BE INSPECTED DAILY DURING OPERATIONAL PERIODS. THE ENFORCEMENT OFFICER, OR APPROVED REPRESENTATIVE, MUST BE PRESENT AT THE COMMENCEMENT OF DEWATERING ACTIVITIES.
- L.IF INSTALLED SOIL EROSION AND SEDIMENT CONTROL MEASURES DO NOT MINIMIZE SEDIMENT LEAVING THE DEVELOPMENT SITE, ADDITIONAL MEASURES SUCH AS ANIONIC POLYMERS OR FILTRATION SYSTEMS MAY BE REQUIRED BY THE ENFORCEMENT OFFICER.
- M.ALL TEMPORARY AND PERMANENT EROSION CONTROL MEASURES MUST BE MAINTAINED AND REPAIRED AS NEEDED. THE PROPERTY OWNER SHALL BE ULTIMATELY RESPONSIBLE FOR MAINTENANCE AND REPAIR.
- N.ALL TEMPORARY SEDIMENT CONTROL MEASURES SHALL BE REMOVED WITHIN 30 DAYS AFTER FINAL SITE STABILIZATION IS ACHIEVED OR AFTER THE TEMPORARY MEASURES ARE NO LONGER NEEDED.
- O.THE EROSION CONTROL MEASURES INDICATED ON THE PLANS ARE THE MINIMUM REQUIREMENTS. ADDITIONAL MEASURES MAY BE REQUIRED, AS DIRECTED BY THE ENGINEER, ENFORCEMENT OFFICER, OR OTHER GOVERNING AGENCY.

FILE NAME = 5867.200_Sht-DT.dwg	USER NAME = DOMINIC OLESAK	DESIGNED - MGF	С	REVISED	-
		DRAWN - MGF	С	REVISED	-
	PLOT SCALE = 1" = .0833'	CHECKED - DPB		REVISED	-
	PLOT DATE = 12/15/2023 6:07 PM	DATE - 12/1	18/2023	REVISED	-

STATE OF ILLINOIS DEPARTMENT OF TRANSPORTATION

SOIL EROSION AND SEDIMENT CONTROL NOTES											
FISH LAKE ROAD IMPROVEMENTS											
SCALE: N.A.	SHEET NO. 1 OF	SHEETS S	STA. TO S	TA.							

FAU. RTE	SECT	ION	COUNTY	TOTAL SHEETS	SHEET NO.	
0163	15-08113	5-05-C	LAKE	112	3	
				CONTRACT :	#: 61	K10
		ILLINOIS	FED. AI	D PROJECT		

		SUMMARY OF QUANTITIES			80% FEDERAL / 20% LOCAL
# *	CODE NO.	ITEM	UNIT	TOTAL QUANTITY	0004
	20101000	TEMPORARY FENCE	FOOT	1,900	1,900
*	20101100	TREE TRUNK PROTECTION	EACH	158	158
	20101200	TREE ROOT PRUNING	EACH	158	158
	20200100	EARTH EXCAVATION	CU YD	3,347	3,347
	20201200	REMOVAL AND DISPOSAL OF UNSUITABLE MATERIAL	CU YD	335	335
	20800150	TRENCH BACKFILL	CU YD	1,038	1,038
	21001000	GEOTECHNICAL FABRIC FOR GROUND STABILIZATION	SQ YD	1,005	1,005
	21101615	TOPSOIL FURNISH AND PLACE, 4"	SQ YD	11,798	11,798
	21101625	TOPSOIL FURNISH AND PLACE, 6"	SQ YD	637	637
*	25000210	SEEDING, CLASS 2A	ACRE	2.50	2.50
*	25000400	NITROGEN FERTILIZER NUTRIENT	POUND	231	231
*	25000600	POTASSIUM FERTILIZER NUTRIENT	POUND	231	231
*	25200200	SUPPLEMENTAL WATERING	UNIT	29	29
	28000250	TEMPORARY EROSION CONTROL SEEDING	POUND	257	257
	28000400	PERIMETER EROSION BARRIER	FOOT	7,595	7,595
	28000500	INLET AND PIPE PROTECTION	EACH	4	4

FILE NAME = 5867.200_Sht-DT.dwg	USER NAME = DOMINIC OLESAK	DESIGNED - MGFC	REVISED -			SUMMARY OF QUA	ANTITIES	F.A.U. RTF	SECTION	COUNTY	TOTAL S	HEET NO.
		DRAWN - MGFC	REVISED -	STATE OF ILLINOIS		FISH LAKE ROAD IMP		0163	15-08113-05-CH	LAKE	112	4
	PLOT SCALE = 1" = .0833'	CHECKED - DPB	REVISED -	DEPARTMENT OF TRANSPORTATION		FISH LAKE ROAD IMP	MOVEMIEN 13			CONTRACT	#: 61K1	o
1	PLOT DATE = 12/15/2023 6:08 PM	DATE - 12/18/2023	REVISED -	I	SCALE: N.A.	SHEET NO. 1 OF 9 SHEETS	STA. TO STA.		ILLINOIS FED. A	AID PROJECT		

		SUMMARY OF QUANTITIES			80% FEDERAL / 20% LOCAL
*	CODE NO.	ITEM	UNIT	TOTAL QUANTITY	0004
	28000510	INLET FILTERS	EACH	70	70
	28001100	TEMPORARY EROSION CONTROL BLANKET	SQ YD	12,429	12,429
	30300001	AGGREGATE SUBGRADE IMPROVEMENT	CU YD	1,785	1,785
	30300112	AGGREGATE SUBGRADE IMPROVEMENT 12"	SQ YD	1,024	1,024
	35101600	AGGREGATE BASE COURSE, TYPE B 4"	SQ YD	669	669
	35101800	AGGREGATE BASE COURSE, TYPE B 6"	SQ YD	3,027	3,027
	35400100	PORTLAND CEMENT CONCRETE BASE COURSE WIDENING 6"	SQ YD	791	791
	40600275	BITUMINOUS MATERIALS (PRIME COAT)	POUND	37,841	37,841
	40600290	BITUMINOUS MATERIALS (TACK COAT)	POUND	7,844	7,844
	40600982	HOT-MIX ASPHALT SURFACE REMOVAL - BUTT JOINT	SQ YD	25	25
	40603080	HOT-MIX ASPHALT BINDER COURSE, IL-19.0, N50	TON	4,635	4,635
	40603200	POLYMERIZED HOT-MIX ASPHALT BINDER COURSE, IL-4.75, N50	TON	64	64
	40604060	HOT-MIX ASPHALT SURFACE COURSE, IL-9.5, MIX "D", N50	TON	2,199	2,199
	42400200	PORTLAND CEMENT CONCRETE SIDEWALK 5 INCH	SQFT	1,009	1,009
	42400800	DETECTABLE WARNINGS	SQFT	111	111
	44000100	PAVEMENT REMOVAL	SQ YD	933	933

FILE NAME = 5867.200_Sht-DT.dwg	USER NAME = DOMINIC OLESAK	DESIGNED - MGFC	REVISED -			SUMMARY OF QUANTITIES	S	FAU.	SECTION	COUNTY	TOTAL SHE SHEETS N	ĒΠ
		DRAWN - MGFC	REVISED -	STATE OF ILLINOIS			-	0163	15-08113-05-CH	LAKE	112 5	\exists
	PLOT SCALE = 1" = .0833'	CHECKED - DPB	REVISED -	DEPARTMENT OF TRANSPORTATION		FISH LAKE ROAD IMPROVEMI	ENIS			CONTRACT #		\neg
	PLOT DATE = 12/15/2023 6:08 PM	DATE - 12/18/2023	REVISED -		SCALE: N.A.	SHEET NO. 2 OF 9 SHEETS STA.	TO STA	1	ILLINOIS FED. AI'	PROJECT		\dashv

			SUMMARY OF QUANTITIES			80% FEDERAL / 20% LOCAL
#	*	CODE NO.	ITEM	UNIT	TOTAL QUANTITY	0004
		44000161	HOT-MIX ASPHALT SURFACE REMOVAL, 3"	SQ YD	1,264	1,264
		44000200	DRIVEWAY PAVEMENT REMOVAL	SQ YD	774	774
		44000500	COMBINATION CURB AND GUTTER REMOVAL	FOOT	301	301
		44000600	SIDEWALK REMOVAL	SQ FT	810	810
		44201717	CLASS D PATCHES, TYPE II, 6 INCH	SQ YD	24	24
		50105220	PIPE CULVERT REMOVAL	FOOT	312	312
		52200800	SEGMENTAL CONCRETE BLOCK WALL	SQ FT	755	755
		54213657	PRECAST REINFORCED CONCRETE FLARED END SECTIONS 12"	EACH	3	3
		54213660	PRECAST REINFORCED CONCRETE FLARED END SECTIONS 15"	EACH	4	4
		54213663	PRECAST REINFORCED CONCRETE FLARED END SECTIONS 18"	EACH	2	2
		54213669	PRECAST REINFORCED CONCRETE FLARED END SECTIONS 24"	EACH	2	2
		54214710	PRECAST REINFORCED CONCRETE FLARED END SECTIONS - ELLIPTICAL, EQUIVALENT ROUND-SIZE 15"	EACH	1	1
		550A0050	STORM SEWERS, CLASS A, TYPE 1 12"	FOOT	1,435	1,435
		550A0070	STORM SEWERS, CLASS A, TYPE 1 15"	FOOT	1,092	1,092
		550A0090	STORM SEWERS, CLASS A, TYPE 1 18"	FOOT	24	24
		550A0120	STORM SEWERS, CLASS A, TYPE 1 24"	FOOT	15	15
		*				

FILE NAME = 5867.200_Sht-DT.dwg	USER NAME = DOMINIC OLESAK	DESIGNED - MGFC	REVISED -			SUMMARY OF QUANTITIES	FAU.	SECTION	COUNTY	TOTAL S	TET I
		DRAWN - MGFC	REVISED -	STATE OF ILLINOIS			0163	15-08113-05-CH	LAKE	112	6
	PLOT SCALE = 1" = .0833'	CHECKED - DPB	REVISED -	DEPARTMENT OF TRANSPORTATION		FISH LAKE ROAD IMPROVEMENTS			CONTRACT #	# 61K	0
	PLOT DATE = 12/15/2023 6:08 PM	DATE - 12/18/2023	REVISED -		SCALE: N.A.	SHEET NO. 3 OF 9 SHEETS STA. TO STA.		ILLINOIS FED A	AID PROJECT		

CONSTRUCTION CODE **SUMMARY OF QUANTITIES** 80% FEDERAL / 20% LOCAL **TOTAL** CODE NO. UNIT ITEM 0004 QUANTITY 550A0340 STORM SEWERS, CLASS A, TYPE 2 12" FOOT 1,169 1,169 FOOT 239 550A0360 STORM SEWERS, CLASS A, TYPE 2 15" 239 550A0410 STORM SEWERS, CLASS A, TYPE 2 24" FOOT 22 22 550A4015 STORM SEWERS, CLASS A, TYPE 1 EQUIVALENT ROUND-SIZE 15" FOOT 275 275 FOOT 314 550A4000 STORM SEWERS, CLASS A, TYPE 1 EQUIVALENT ROUND-SIZE 18" 314 FOOT 433 433 55100500 STORM SEWER REMOVAL 12" 56400400 FIRE HYDRANTS TO BE RELOCATED EACH 3 3 60203805 CATCH BASINS, TYPE A, 5'-DIAMETER, TYPE 1 FRAME, OPEN LID EACH 1 60204805 CATCH BASINS, TYPE A, 5'-DIAMETER, TYPE 11 FRAME AND GRATE **EACH** 3 3 60219300 MANHOLES, TYPE A, 4'-DIAMETER, TYPE 11 FRAME AND GRATE **EACH** 30 30 60222000 MANHOLES, TYPE A, 5'-DIAMETER, TYPE 11 FRAME AND GRATE **EACH** 1 60236200 INLETS, TYPE A, TYPE 8 GRATE **EACH** 4 4 22 22 60236800 INLETS, TYPE A, TYPE 11 FRAME AND GRATE EACH **EACH** 5 60240310 INLETS, TYPE B, TYPE 11 FRAME AND GRATE 5 CU YD 60600095 CLASS SI CONCRETE (OUTLET) 4 4 60603800 COMBINATION CONCRETE CURB AND GUTTER, TYPE B-6.12 FOOT 12,877 12,877

FILE NAME = 5867.200_Sht-DT.dwg	USER NAME = DOMINIC OLESAK	DESIGNED - MGFC	REVISED -			SUMMARY OF QUANTITIES	FAU.	SECTION	COUNTY	TOTAL	SHEET
		DRAWN - MGFC	REVISED -	STATE OF ILLINOIS		FISH LAKE ROAD IMPROVEMENTS	0163	15-08113-05-CH	LAKE	112	7
	PLOT SCALE = 1" = .0833'	CHECKED - DPB	REVISED -	DEPARTMENT OF TRANSPORTATION		FISH LAKE RUAD IMPROVEMENTS			CONTRACT #	# 61K	0
	PLOT DATE = 12/15/2023 6:08 PM	DATE - 12/18/2023	REVISED -		SCALE: N.A.	SHEET NO. 4 OF 9 SHEETS STA. TO STA.		ILLINOIS FED. AI	D PROJECT		

						CONSTRUCTION CODE
			SUMMARY OF QUANTITIES			80% FEDERAL / 20% LOCAL
#	*	CODE NO.	ITEM	UNIT	TOTAL QUANTITY	0004
	*	66400305	CHAIN LINK FENCE, 6'	FOOT	374	374
	*	0000000	NON CRECIAL WASTE DISPOSAL	CLLVD	405	405
		66900200	NON-SPECIAL WASTE DISPOSAL	CU YD	135	135
	*	66900530	SOIL DISPOSAL ANALYSIS	EACH	4	4
	*	66901001	REGULATED SUBSTANCES PRE-CONSTRUCTION PLAN	LSUM	1	1
	*	66901003	REGULATED SUBSTANCES FINAL CONSTRUCTION REPORT	LSUM	1	1
	*	66901006	REGULATED SUBSTANCES MONITORING	CAL DA	4	4
		67000400		CALMO	0	0
		67000400	ENGINEER'S FIELD OFFICE, TYPE A	CAL MO	8	8
		67100100	MOBILIZATION	LSUM	1	1
		70300100	SHORT TERM PAVEMENT MARKING	FOOT	589	589
		70300150	SHORT TERM PAVEMENT MARKING REMOVAL	SQ FT	196	196
		70300211	TEMPORARY PAVEMENT MARKING LETTERS AND SYMBOLS - PAINT	SQFT	140	140
		70300221	TEMPORARY PAVEMENT MARKING - LINE 4"- PAINT	FOOT	11,782	11,782
	-	70300241	TEMPORARY PAVEMENT MARKING - LINE 6"- PAINT	FOOT	496	496
		70300261	TEMPORARY PAVEMENT MARKING - LINE 12"- PAINT	FOOT	518	518
		70300281	TEMPORARY PAVEMENT MARKING - LINE 24"- PAINT	FOOT	57	57
	-					
		78000100	THERMOPLASTIC PAVEMENT MARKING - LETTERS AND SYMBOLS	SQ FT	140	140
		* *			l	

FILE NAME = 5867.200_Sht-DT.dwg	USER NAME = DOMINIC OLESAK	DESIGNED - MGFC	REVISED -			SUMMARY OF QU	IANTITIES	F.A.U.	SECTION	COUNTY	TOTAL	SHEET
		DRAWN - MGFC	REVISED -	STATE OF ILLINOIS				0163	15-08113-05-CH	LAKE	112	8
	PLOT SCALE = 1" = .0833'	CHECKED - DPB	REVISED -	DEPARTMENT OF TRANSPORTATION		FISH LAKE ROAD IMP	PROVEMENTS	0.00		CONTRACT #	#: 61K	.10
	PLOT DATE = 12/15/2023 6:09 PM	DATE - 12/18/2023	REVISED -		SCALE: N.A.	SHEET NO. 5 OF 9 SHEETS	STA. TO STA.	\neg	ILLINOIS FED AL	ID PROJECT	<u> </u>	-

	* CODE NO SUMMARY OF QUANTITIES * CODE NO STEM											
# *	CODE NO.	ITEM	UNIT	TOTAL QUANTITY	0004							
*	78000200	THERMOPLASTIC PAVEMENT MARKING - LINE 4"	FOOT	11,782	11,782							
*	78000400	THERMOPLASTIC PAVEMENT MARKING - LINE 6"	FOOT	496	496							
*	78000600	THERMOPLASTIC PAVEMENT MARKING - LINE 12"	FOOT	518	518							
*	78000650	THERMOPLASTIC PAVEMENT MARKING - LINE 24"	FOOT	57	57							
*	78300202	PAVEMENT MARKING REMOVAL - WATER BLASTING	SQFT	211	211							
*	A2001020	TREE, ACER RUBRUM (RED MAPLE), 2-1/2" CALIPER, BALLED AND BURLAPPED	EACH	2	2							
*	A2001720	TREE, ACER SACCHARUM (SUGAR MAPLE), 2-1/2" CALIPER, BALLED AND BURLAPPED	EACH	1	1							
*	A2002280	TREE, ALNUS RUGOSA (SPECKLED ALDER), 5' HEIGHT, CLUMP FORM, BALLED AND BURLAPPED	EACH	12	12							
*	A2002366	TREE, BETULA NIGRA (RIVER BIRCH), 6' HEIGHT, CLUMP FORM, BALLED AND BURLAPPED	EACH	10	10							
*	A2002656	TREE, CARYA ILLINOENSIS (PECAN), 2" CALIPER, BALLED AND BURLAPPED	EACH	3	3							
*	A2002920	TREE, CELTIS OCCIDENTALIS (COMMON HACKBERRY), 2-1/2" CALIPER, BALLED AND BURLAPPED	EACH	8	8							
*	A2005020	TREE, GYMNOCLADUS DIOICUS (KENTUCKY COFFEETREE), 2-1/2" CALIPER, BALLED AND BURLAPPED	EACH	7	7							
*	A2005330	TREE, LIQUIDAMBAR STYRACIFLUA MORAINE (MORAINE SWEETGUM), 2-1/2" CALIPER, BALLED AND BURLAPPED	EACH	3	3							
*	A2006420	TREE, QUERCUS ALBA (WHITE OAK), 2-1/2" CALIPER, BALLED AND BURLAPPED	EACH	3	3							
*	A2006516	TREE, QUERCUS BICOLOR (SWAMP WHITE OAK), 2" CALIPER, BALLED AND BURLAPPED	EACH	11	11							
*	A2006720	TREE, QUERCUS MACROCARPA (BUR OAK), 2-1/2" CALIPER, BALLED AND BURLAPPED	EACH	5	5							

ILE NAME = 5867.200_Sht-DT.dwg	USER NAME = DOMINIC OLESAK	DESIGNED - MGFC	REVISED -			SUMMARY OF QU	IANTITIES	F.A.U. RTF	SECTION	COUNTY	TOTAL SHEET SHEETS NO.
		DRAWN - MGFC	REVISED -	STATE OF ILLINOIS				0163	15-08113-05-CH	LAKE	112 9
	PLOT SCALE = 1" = .0833'	CHECKED - DPB	REVISED -	DEPARTMENT OF TRANSPORTATION		FISH LAKE ROAD IM	PROVEMENTS			CONTRACT #	#: 61K10
	PLOT DATE = 12/15/2023 6:09 PM	DATE - 12/18/2023	REVISED -]	SCALE: N.A.	SHEET NO. 6 OF 9 SHEETS	STA. TO STA.		ILLINOIS FED A	ID PROJECT	

						CONSTRUCTION CODE
			SUMMARY OF QUANTITIES			80% FEDERAL / 20% LOCAL
#	*	CODE NO.	ITEM	UNIT	TOTAL QUANTITY	0004
	*	A2007120	TREE, QUERCUS RUBRA (RED OAK), 2-1/2" CALIPER, BALLED AND BURLAPPED	EACH	3	3
	*	A2007620	TREE, TAXODIUM DISTICHUM (COMMON BALD CYPRESS), 2-1/2" CALIPER, BALLED AND BURLAPPED	EACH	3	3
	*	A2007820	TREE, TILIA AMERICANA (AMERICAN LINDEN/ BASSWOOD), 2-1/2" CALIPER, BALLED AND BURLAPPED	EACH	4	4
	*	B2001566	TREE, CRATAEGUS CRUSGALLI (COCKSPUR HAWTHORN), 6' HEIGHT, SHRUB FORM, BALLED AND BURLAPPED	EACH	2	2
	*	C2003372	SHRUB, HAMAMELIS VIRGINIANA (COMMON WITCHHAZEL), 6' HEIGHT, BALLED AND BURLAPPED	EACH	6	6
	*	K1005421	SEEDING (SPECIAL)	ACRE	0.25	0.25
		LR400890	FULL-DEPTH RECLAMATION, 9.0"	SQ YD	10,892	10,892
		X5510011	PROPOSED STORM SEWER CONNECTION TO EXISTING MANHOLE	EACH	6	6
		X0327036	BIKE PATH REMOVAL	SQ YD	31	31
		X0327301	RELOCATE EXISTING MAILBOX	EACH	4	4
		X2010404	STUMP REMOVAL	EACH	84	84
		X2010510	CLEARING AND GRUBBING	LSUM	1	1
	*	X2500900	SEEDING, CLASS 1 (SPECIAL)	ACRE	0.25	0.25
	*	X2510635	HEAVY DUTY EROSION CONTROL BLANKET (SPECIAL)	SQ YD	128	128
	*	X2511630	EROSION CONTROL BLANKET (SPECIAL)	SQ YD	12,301	12,301
		X2800400	PERIMETER EROSION BARRIER (SPECIAL)	FOOT	1,013	1,013
		*				

FILE NAME = 5867.200_Sht-DT.dwg	USER NAME = DOMINIC OLESAK	DESIGNED 147 MGFC	REVISED -	OTATE OF ILLINOIS		SUMMARY OF QU	JANTITIE	S I	RTE.	SECTION	COUNTY	SHEETS NO	5. I
		DRAWN - MGFC	REVISED -	STATE OF ILLINOIS		FISH LAKE ROAD IM			0163	15-08113-05-CH	LAKE	112 10)
	PLOT SCALE = 1" = .0833'	CHECKED PB	REVISED -	DEPARTMENT OF TRANSPORTATION		FISH LAKE RUAD IM	RUVEIN	ENIS			CONTRACT #	#: 61K10	
	PLOT DATE = 12/15/2023 6:09 PM	DATE - 12/18/2023	REVISED -		SCALE: N.A.	SHEET NO. 7 OF 9 SHEETS	STA.	TO STA.		ILLINOIS FED. AIE	PROJECT		

	* CODE NO LITEM TOTAL									
# *	CODE NO.	ITEM	UNIT TOTAL QUANTITY	, 0004						
	X4021000	TEMPORARY ACCESS (PRIVATE ENTRANCE)	EACH 6	6						
	X4022000	TEMPORARY ACCESS (COMMERCIAL ENTRANCE)	EACH 5	5						
	X4023000	TEMPORARY ACCESS (ROAD)	EACH 6	6						
	X4421825	CLASS D PATCHES, TYPE I, 9 INCH (SPECIAL)	SQ YD 8	8						
	X4421826	CLASS D PATCHES, TYPE II, 9 INCH (SPECIAL)	SQ YD 63	63						
	X7010216	TRAFFIC CONTROL AND PROTECTION, (SPECIAL)	LSUM 1	1						
	Z0004530	HOT-MIX ASPHALT DRIVEWAY PAVEMENT, 8"	SQ YD 255	255						
	Z0004538	HOT-MIX ASPHALT DRIVEWAY PAVEMENT, 10"	SQ YD 302	302						
	Z0013798	CONSTRUCTION LAYOUT	LSUM 1	1						
	Z0017400	DRAINAGE & UTILITY STRUCTURES TO BE ADJUSTED	EACH 15	15						
	Z0017700	DRAINAGE & UTILITY STRUCTURES TO BE RECONSTRUCTED	EACH 2	2						
	Z0018700	DRAINAGE STRUCTURE TO BE REMOVED	EACH 17	17						
	Z0022800	FENCE REMOVAL	FOOT 1,057	1,057						
	Z0030850	TEMPORARY INFORMATION SIGNING	SQ FT 205	205						
	Z0051500	REMOVING AND RESETTING STREET SIGNS	EACH 18	18						
	Z0056648	STORM SEWERS, TYPE 1, WATER MAIN QUALITY PIPE, 12"	FOOT 130	130						

FILE NAME = 5867.200_Sht-D1.dwg	USER NAME = MARK COBB	DESIGNED - MGFC	REVISED -	l		SUMMARY OF QU	IANTITI	FS	RTF.	SECTION	COUNTY	SHEETS N	10.
		DRAWN - MGFC	REVISED -	STATE OF ILLINOIS					0163	15-08113-05-CH	LAKE	112	Ť.
	PLOT SCALE = 1" = .0833'	CHECKED - DPB	REVISED -	DEPARTMENT OF TRANSPORTATION		FISH LAKE ROAD IM	PROVEN	MENIS	0100	10 00110 00 011	CONTRACT	#: 61K10	
	PLOT DATE = 1/16/2024 11:04 AM	DATE - 12/18/2023	REVISED -		SCALE: N.A.	SHEET NO. 8 OF 9 SHEETS	STA.	TO STA.		ILLINOIS FED. A	AID PROJECT		


						CONSTRUCTION CODE
			SUMMARY OF QUANTITIES			80% FEDERAL / 20% LOCAL
#	*	CODE NO.	ITEM	UNIT	TOTAL QUANTITY	0004
		Z0056652	STORM SEWERS, TYPE 1, WATER MAIN QUALITY PIPE, 18"	FOOT	65	65
		Z0056669	STORM SEWERS, TYPE 2, WATER MAIN QUALITY PIPE, 15"	FOOT	63	63
		Z0056670	STORM SEWERS, TYPE 2, WATER MAIN QUALITY PIPE, 18"	FOOT	9	9
		Z0056672	STORM SEWERS, TYPE 2, WATER MAIN QUALITY PIPE, 24"	FOOT	20	20
	*	Z0073510	TEMPORARY TRAFFIC SIGNAL TIMING	EACH	3	3
#		Z0076600	TRAINEES	HOUR	500	
#		Z0076604	TRAINEES TRAINING PROGRAM GRADUATE	HOUR	500	
	*	Z0077900	WOOD POST AND RAIL FENCE	FOOT	201	201

^{*} SPECIALTY ITEM # CONSTRUCTION CODE 0042

FILE NAME = 5867.200_Snt-D1.dwg	USER NAME = DUMINIC OLESAK	DESIGNED	-	MGFC	REVISED	-	
		DRAWN	-	MGFC	REVISED	•	
	PLOT SCALE = 1" = .0833'	CHECKED	-	DPB	REVISED	-	DEPART
	PLOT DATE = 12/15/2023 6:09 PM	DATE	-	12/18/2023	REVISED	-	


	S	UMN	IAR'	Y OF	QUAN	TITIES	
-	FISH	LAK	E R	OAD	IMPRO	VEMENTS	
	SHEET N	IO . 9	OF 9	SHEETS	STA	TO STA.	


SCALE: N.A.

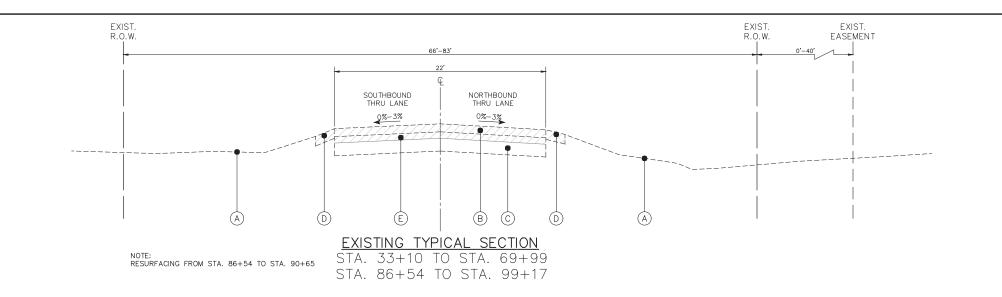

TYPICAL CROSS SECTION LEGEND

- NO. <u>DESCRIPTION</u>
- (A) EXISTING GROUND
- (B) EXISTING HMA PAVEMENT, (4.5"-5.0")
- © EXISTING AGGREGATE BASE, (10"-13.5")
- D AGGREGATE SHOULDER REMOVAL
- (E) FULL DEPTH RECLAMATION, 9"
- (F) PAVEMENT REMOVAL
- G EXISTING COMBINATION CONCRETE CURB AND GUTTER, TYPE B-6.12

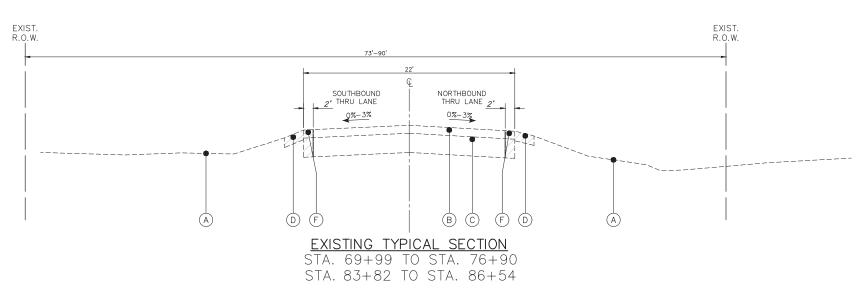

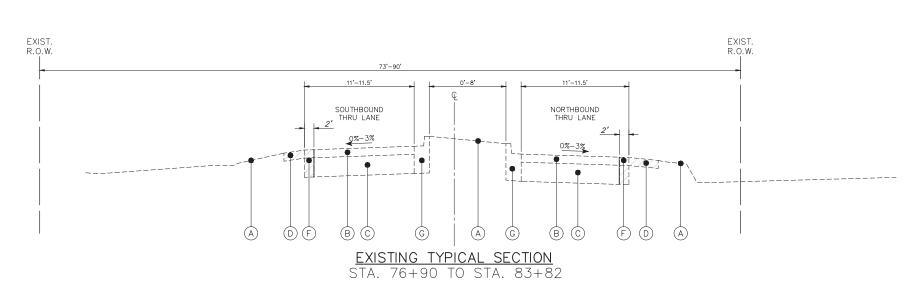



MIXTURE TYPE	AIR VOIDS	QMP
FULL DEPTH RECLAMATION & RECONSTRUCTION		
HOT-MIX ASPHALT SURFACE COURSE, MIX "D", IL-9.5, N50; 2"	4% @ 50 GYR	LR1030-2
HOT-MIX ASPHALT BINDER COURSE, IL-19.0, N50; 6"	4% @ 50 GYR	LR1030-2
PAVEMENT WIDENING	•	
HOT-MIX ASPHALT SURFACE COURSE, MIX "D", IL-9.5, N50; 2"	4% @ 50 GYR	LR1030-2
HOT-MIX ASPHALT BINDER COURSE, IL-19.0, N50; 6"	4% @ 50 GYR	LR1030-2
PAVEMENT RESURFACING	•	
HOT-MIX ASPHALT SURFACE COURSE, MIX "D", IL-9.5, N50; 2"	4% @ 50 GYR	LR1030-2
POLYMERIZED HOT-MIX ASPHALT BINDER COURSE, IL-4.75, N50; 1"	3.5% @ 50 GYR	LR1030-2
HOT-MIX ASPHALT DRIVEWAYS, 8" & 10"	-	
HOT-MIX ASPHALT SURFACE COURSE, MIX "D", IL-9.5, N50; 2"	4% @ 50 GYR	LR1030-2
HMA BASE COURSE (HMA BINDER IL-19 mm); PE-6", CE-8"	4% @ 50 GYR	LR1030-2
НМА РАТН		
HOT-MIX ASPHALT SURFACE COURSE, MIX "D", IL-9.5, N50; 3" (IN 2 LIFTS)	4% @ 50 GYR	LR1030-2
PATCHING		l
CLASS D PATCHES (HMA BINDER IL-19 mm)	4% @ 70 GYR	LR1030-2
CLASS D PATCHES (SPECIAL)		ı
HOT-MIX ASPHALT SURFACE COURSE, MIX "D", IL-9.5, N50; 2"	4% @ 50 GYR	LR1030-2
HOT-MIX ASPHALT BINDER COURSE, IL-19.0, N70; 7"	4% @ 70 GYR	LR1030-2
QMP DESIGNATIONS: QUALITY CONTROL/QUALITY ASSURANCE (QC/QA) F	PER LR1030-2	


THE UNIT WEIGHT USED TO CALCULATE ALL HMA SURFACE MIXTURE QUANTITIES IS 112 LBS/SQ.YD./IN.

THE "AC TYPE" FOR POLYMERIZED HMA MIXES SHALL BE "SBS/SBR PG 76-22" AND FOR NON-POLYMERIZED HMA THE AC TYPE SHALL BE "PG 64-22" UNLESS MODIFIED BY RECLAIMED MATERIALS SPECIFICATIONS.

FILE NAME = 5867.200_Sht-TYP.dwg	USER NAME = DOMINIC OLESAK	DESIGNED - MGFC	REVISED -		TYPICAL SECTIONS FISH LAKE ROAD IMPROVEMENTS			FAU.	SECTION	COUNTY	TOTAL SHEETS	AHEET NO.	
		DRAWN - MGFC	REVISED -	STATE OF ILLINOIS				0163	15-08113-05-CH	LAKE	112	13	
	PLOT SCALE = 1" = .0833'	CHECKED - DPB	REVISED -	DEPARTMENT OF TRANSPORTATION							CONTRACT	# 61K	10
	PLOT DATE = 12/15/2023 3:28 PM	DATE - 12/18/2023	REVISED -		SCALE: N/A	SHEET NO. 1 OF 4 SHEETS	STA.	TO STA.		ILLINOIS FED. A	ND PROJECT		

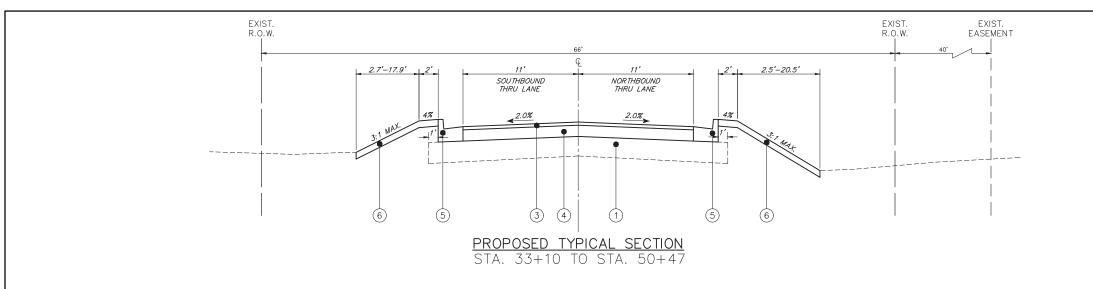

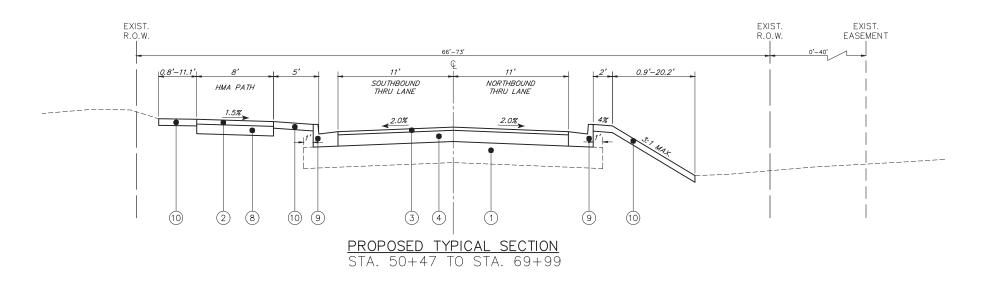

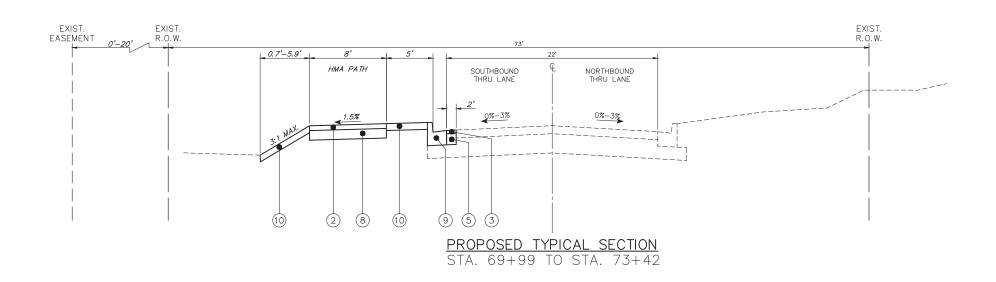

REVISED

REVISED

REVISED

REVISED

FILE NAME = 5867.200_Sht-TYP.dwg

JSER NAME = DOMINIC OLESAK

PLOT DATE = 12/15/2023 3:28 PM

DESIGNED - MGFC

DRAWN - MGFC

- 12/18/2023

CHECKED - DPB

DATE

STATE OF ILLINOIS DEPARTMENT OF TRANSPORTATION

SCALE: N/A

 TYPICAL SECTIONS
 FAU. RTE. O163
 SECTIONS

 FISH LAKE ROAD IMPROVEMENTS
 0163
 15-08113

 SHEET NO. 2 OF 4 SHEETS
 STA. TO STA.
 TO STA.

TYPICAL CROSS SECTION LEGEND

EXISTING HMA PAVEMENT, (4.5"-5.0")

EXISTING AGGREGATE BASE, (10"-13.5")

EXISTING COMBINATION CONCRETE CURB AND GUTTER, TYPE B-6.12

HOT-MIX ASPHALT SURFACE COURSE, MIX "D", IL-9.5, N50, (3") (PATH)

HOT-MIX ASPHALT SURFACE COURSE, MIX "D", IL-9.5, N50, (2") (ROAD)

SLOPES >3:1 USE HEAVY DUTY EROSION CONTROL BLANKET (SPECIAL)

HOT-MIX ASPHALT BINDER COURSE, IL-19.0, N50, (6")
PORTLAND CEMENT CONCRETE BASE COURSE WIDENING 6"

COMBINATION CONCRETE CURB AND GUTTER, TYPE B-6.12

AGGREGATE SUBGRADE IMPROVEMENT 12"

AGGREGATE BASE COURSE, TYPE B 4"

AGGREGATE BASE COURSE, TYPE B 6"

TOPSOIL FURNISH AND PLACE, 4" SEEDING, CLASS 2A

NITROGEN FERTILIZER NUTRIENT

POTASSIUM FERTILIZER NUTRIENT EROSION CONTROL BLANKET (SPECIAL)

AGGREGATE SHOULDER REMOVAL FULL DEPTH RECLAMATION, 9"

FULL DEPTH RECLAMATION, 9"

NO. <u>DESCRIPTION</u>

EXISTING GROUND

PAVEMENT REMOVAL

(A)

D

(F)


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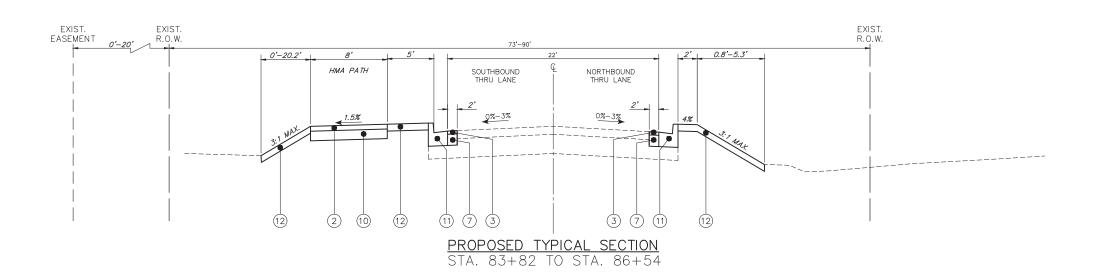
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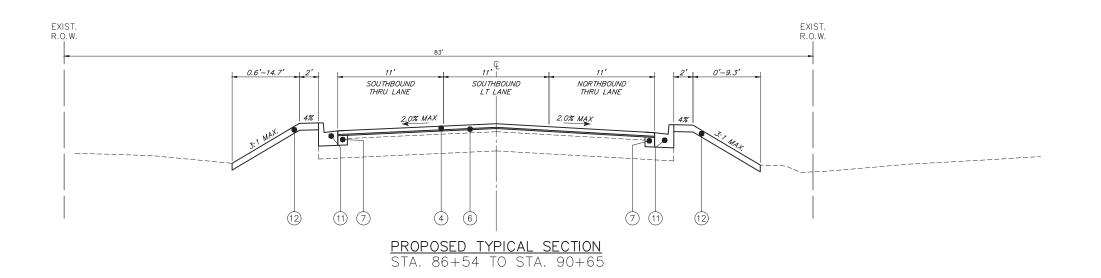
(6)

(7)

(9)





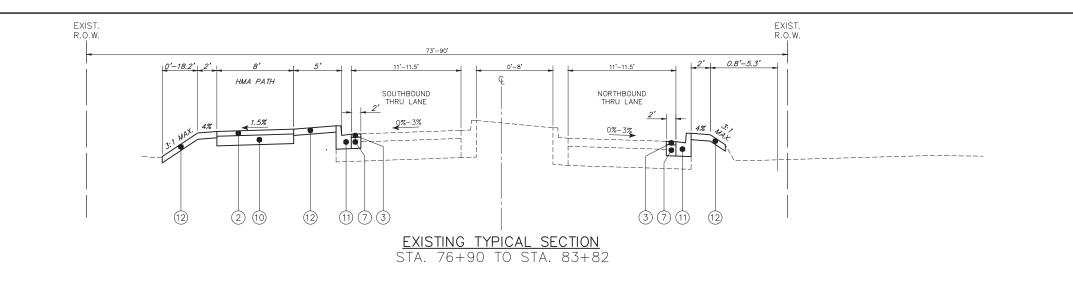

FILE NAME = 5867.200_Sht-TYP.dwg

JSER NAME = MARK COBB

PLOT DATE = 12/21/2023 1:00 PM

DESIGNED - MGFC

DRAWN - MGFC

DATE - 12/18/2023

CHECKED - DPB

REVISED

REVISED

REVISED

REVISED

STATE OF ILLINOIS DEPARTMENT OF TRANSPORTATION

SCALE: N/A

TYPICAL SECTIONS	FAU. RTE	SECTION	COUNTY	TOTAL SHEETS	SHEET NO.			
FISH LAKE ROAD IMPROVEMENTS	0163	15-08113-05-CH	LAKE	112	15			
- I IOI LAKE NOAD IMPROVEMENTO	_		CONTRACT	# 61	K10			
SHEET NO. 3 OF 4 SHEETS STA. TO STA.		ILLINOIS FED. AID PROJECT						

TYPICAL CROSS SECTION LEGEND

EXISTING HMA PAVEMENT, (4.5"-5.0")

EXISTING AGGREGATE BASE, (10"-13.5")

EXISTING COMBINATION CONCRETE CURB AND GUTTER, TYPE B-6.12

HOT-MIX ASPHALT SURFACE COURSE, MIX "D", IL-9.5, N50, (3") (PATH)

HOT-MIX ASPHALT SURFACE COURSE, MIX "D", IL-9.5, N50, (2") (ROAD) HOT-MIX ASPHALT SURFACE COURSE, MIX "D", IL-9.5, N50, (2")

POLYMERIZED HOT-MIX ASPHALT BINDER COURSE, IL-4.75, N50, (1")

SLOPES >3:1 USE HEAVY DUTY EROSION CONTROL BLANKET (SPECIAL)

HOT-MIX ASPHALT BINDER COURSE, IL-19.0, N50, (6")

PORTLAND CEMENT CONCRETE BASE COURSE WIDENING 6"

COMBINATION CONCRETE CURB AND GUTTER, TYPE $B\!-\!6.12$

AGGREGATE SUBGRADE IMPROVEMENT 12"

AGGREGATE BASE COURSE, TYPE B 4"

AGGREGATE BASE COURSE, TYPE B 6"

EROSION CONTROL BLANKET (SPECIAL)

TOPSOIL FURNISH AND PLACE, 4" SEEDING, CLASS 2A NITROGEN FERTILIZER NUTRIENT POTASSIUM FERTILIZER NUTRIENT

AGGREGATE SHOULDER REMOVAL

FULL DEPTH RECLAMATION, 9"

FULL DEPTH RECLAMATION, 9"

PAVEMENT REMOVAL

NO. <u>DESCRIPTION</u>

D

(F)

(G)


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(8)

(9)

(10)

(A) EXISTING GROUND

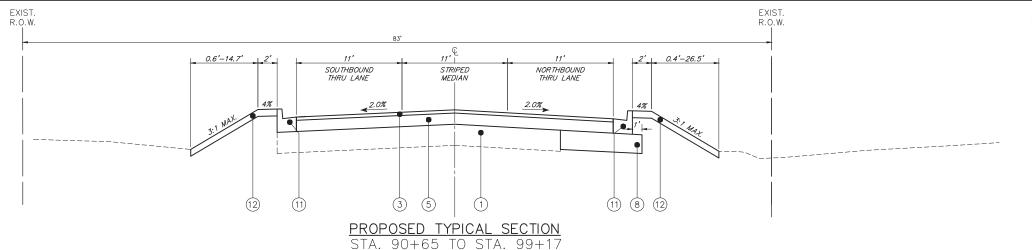


TYPICAL CROSS SECTION LEGEND


- NO. DESCRIPTION
- (A) EXISTING GROUND
- (B) EXISTING HMA PAVEMENT, (4.5"-5.0")
- © EXISTING AGGREGATE BASE, (10"-13.5")
- D AGGREGATE SHOULDER REMOVAL
- (E) FULL DEPTH RECLAMATION, 9"
- (F) PAVEMENT REMOVAL
- G EXISTING COMBINATION CONCRETE CURB AND GUTTER, TYPE B-6.12
- 1) FULL DEPTH RECLAMATION, 9"
- (2) HOT-MIX ASPHALT SURFACE COURSE, MIX "D", IL-9.5, N50, (3") (PATH)
- (3) HOT-MIX ASPHALT SURFACE COURSE, MIX "D", IL-9.5, N50, (2") (ROAD)
- HOT-MIX ASPHALT SURFACE COURSE, MIX "D", IL-9.5, N50, (2")
- 5 HOT-MIX ASPHALT BINDER COURSE, IL-19.0, N50, (6")
-) POLYMERIZED HOT-MIX ASPHALT BINDER COURSE, IL-4.75, N50, (1")
- 7) PORTLAND CEMENT CONCRETE BASE COURSE WIDENING 6"
- 8 AGGREGATE SUBGRADE IMPROVEMENT 12"
- 9) AGGREGATE BASE COURSE, TYPE B 4"
- O) AGGREGATE BASE COURSE, TYPE B 6"
- COMBINATION CONCRETE CURB AND GUTTER, TYPE B-6.12
- TOPSOIL FURNISH AND PLACE, 4"
 SEEDING, CLASS 2A
 NITROGEN FERTILIZER NUTRIENT
 POTASSIUM FERTILIZER NUTRIENT
 EROSION CONTROL BLANKET (SPECIAL)
 SLOPES >3:1 USE HEAVY DUTY EROSION CONTROL BLANKET (SPECIAL)


		3CHEDOLE C	OF EARTHWORK		I	I	
STATION	то	STATION	EARTH EXCAVATION (CU YD)	EARTH EXCAVATION ADJUSTED FOR 15% SHRINKAGE (CU YD)	FILL VOLUME (CU YD)	EARTHWOR BALANCE WASTE (+) C SHORTAGE ((CU YD)	
33+00.00	TO	33+50.00	0.00	0.00	0.00	0.00	
33+50.00	TO	34+00.00	18.63	15.84	3.41	12.43	
34+00.00	TO	34+50.00	32.79	27.87	8.45	19.42	
34+50.00	TO	35+00.00	34.06	28.95	17.04	11.91	
35+00.00	ТО	35+50.00	22.71	19.30	31.79	-12.49	
35+50.00	то	35+55.54	11.06	9.40	31.75	-22.35	
35+55.54	TO	36+00.00	2.18	1.85	2.15	-0.30	
36+00.00	TO	36+50.00	22.52	19.14	9.77	9.37	
36+50.00	TO	37+00.00	22.66	19.26	13.76	5.50	
37+00.00	TO	37+42.00	15.58	13.24	21.70	-8.46	
37+42.00	TO	37+50.00	28.50	24.23	47.97	-23.74	
37+50.00	TO	38+00.00	6.20	5.27	10.18	-4.91	
38+00.00	TO	38+50.00	16.63	14.14	36.58	-22.44	
38+50.00	TO	39+00.00	12.53	10.65	26.20	-15.55	
39+00.00	TO	39+50.00	20.38	17.32	14.07	3.25	
39+50.00	TO	39+62.00	18.94	16.10	18.71	-2.61	
39+62.00	TO	40+00.00	3.12	2.65	4.96	-2.31	
40+00.00	TO	40+50.00	12.74	10.83	9.45	1.38	
40+50.00	TO	41+00.00	22.99	19.54	6.93	12.61	
41+00.00	то	41+25.00	24.21	20.58	6.81	13.77	
41+25.00	то	41+50.00	11.45	9.73	5.62	4.11	
41+25.00	то	42+00.00	12.12	10.30	9.53	0.77	
42+00.00	TO TO	42+05.00	24.63	20.94	29.93	-8.99 1.70	
42+05.00	TO	42+50.00	2.88	2.45	4.15	-1.70	
42+50.00	TO	43+00.00	25.66	21.81	30.43	-8.62	
43+00.00	TO	43+50.00	20.92	17.78	21.58	-3.80	
43+50.00	TO	44+00.00	19.44	16.52	18.84	-2.32	
44+00.00	TO	44+50.00	25.32	21.52	13.15	8.37	
44+50.00	TO	45+00.00	20.93	17.79	16.94	0.85	
45+00.00	TO	45+50.00	10.62	9.03	27.16	-18.13	
45+50.00	TO	46+00.00	9.80	8.33	23.56	-15.23	
46+00.00	TO	46+37.00	10.03	8.53	22.06	-13.53	
46+37.00	TO	46+50.00	10.57	8.98	39.04	-30.06	
46+50.00	TO	47+00.00	3.62	3.08	15.25	-12.17	
47+00.00	то	47+50.00	7.75	6.59	32.68	-26.09	
47+50.00	то	48+00.00	9.95	8.46	19.27	-10.81	
48+00.00	TO	48+50.00	18.70	15.90	18.77	-2.87	
48+50.00	то	49+00.00	23.65	20.10	23.69	-3.59	
49+00.00	то	49+50.00	19.92	16.93	17.88	-0.95	
49+50.00	то		17.18	14.60	12.11		
		50+00.00				2.49	
50+00.00	TO	50+50.00	24.25	20.61	8.52	12.09	
50+50.00	TO	50+94.00	45.53	38.70	3.11	35.59	
50+94.00	TO	51+00.00	38.13	32.41	7.73	24.68	
51+00.00	TO	51+50.00	3.05	2.59	2.06	0.53	
51+50.00	TO	52+00.00	22.90	19.47	12.98	6.49	
52+00.00	TO	52+50.00	23.46	19.94	8.10	11.84	
52+50.00	TO	53+00.00	26.29	22.35	8.21	14.14	
53+00.00	TO	53+50.00	20.91	17.77	13.60	4.17	
53+50.00	TO	54+00.00	14.42	12.26	19.80	-7.54	
54+00.00	TO	54+50.00	19.00	16.15	14.18	1.97	
54+50.00	TO	55+00.00	23.41	19.90	11.98	7.92	
55+00.00	ТО	55+50.00	24.99	21.24	17.95	3.29	
55+50.00	ТО	56+00.00	26.53	22.55	16.79	5.76	
56+00.00	TO	56+08.00	21.81	18.54	23.27	-4.73	
56+08.00	TO	56+50.00	3.02	2.57	5.78	-3.21	
56+50.00	TO	57+00.00	15.89	13.51	25.42	-11.91	
57+00.00	TO	57+50.00	19.12	16.25	16.26	-0.01	
57+50.00	TO	58+00.00	17.00	14.45	15.84	-1.39	
58+00.00	TO	58+50.00	11.54	9.81	25.91	-16.10	
58+50.00	TO	58+67.40	12.10	10.29	26.24	-15.95	
58+67.40	TO	59+00.00	5.67	4.82	6.82	-2.00	
59+00.00	TO	59+50.00	12.26	10.42	15.49	-5.07	
59+50.00	TO	60+00.00	17.68	15.03	30.86	-15.83	
60+00.00	TO	60+50.00	17.21	14.63	29.37	-14.74	
60+50.00	то	61+00.00	19.19	16.31	22.29	-5.98	
61+00.00	то	61+50.00	17.74	15.08	20.41	-5.33	
61+50.00	то	61+55.00	20.42	17.36	22.89	-5.53	
	то				22.89		
61+55.00		61+70.00	2.13	1.81		-0.69	
61+70.00	TO	62+00.00	4.09	3.48	7.50	-4.02	
62+00.00	TO	62+50.00	4.76	4.05	21.86	-17.81	
62+50.00	TO	63+00.00	4.52	3.84	58.97	-55.13	
63+00.00	TO	63+43.58	2.67	2.27	74.64	-72.37	
63+43.58	TO	63+50.00	4.00	3.40	64.92	-61.52	
63+50.00	TO	64+00.00	0.80	0.68	8.84	-8.16	
64+00.00	ТО	64+50.00	5.19	4.41	59.17	-54.76	
64+50.00	TO	65+00.00	6.09	5.18	46.48	-41.30	
65+00.00	TO	65+50.00	13.35	11.35	28.17	-16.82	
65+50.00	TO	66+00.00	34.33	29.18	10.03	19.15	


STATION	то	STATION	EARTH EXCAVATION (CU YD)	EARTH EXCAVATION ADJUSTED FOR 15% SHRINKAGE (CU YD)	FILL VOLUME (CU YD)	EARTHWORK BALANCE WASTE (+) OI SHORTAGE (- (CU YD)	
66+30.00	TO	66+50.00	30.27	25.73	18.49	7.24	
66+50.00	TO	67+00.00	15.99	13.59	17.44	-3.85	
67+00.00	TO	67+50.00	26.57	22.58	43.04	-20.46	
67+50.00 68+00.00	TO TO	68+00.00 68+42.82	21.73	18.47 18.43	33.06 24.84	-14.59	
68+42.82	TO	68+50.00	21.68	17.82	14.73	-6.41 3.09	
68+50.00	то	69+00.00	4.14	3.52	1.52	2.00	
69+00.00	ТО	69+50.00	32.39	27.53	13.43	14.10	
69+50.00	TO	69+55.87	47.45	40.33	8.18	32.15	
69+55.87	TO	70+00.00	7.07	6.01	0.07	5.94	
70+00.00	TO	70+50.00	41.04	34.88	2.09	32.79	
70+50.00 71+00.00	TO TO	71+00.00 71+50.00	28.80 37.94	24.48 32.25	4.82 5.28	19.66 26.97	
71+50.00	TO	72+00.00	43.19	36.71	6.33	30.38	
72+00.00	то	72+50.00	39.34	33.44	7.69	25.75	
72+50.00	ТО	72+60.00	42.69	36.29	8.66	27.63	
72+60.00	TO	73+00.00	8.29	7.05	1.78	5.27	
73+00.00	TO	73+50.00	25.69	21.84	4.56	17.28	
73+50.00	TO	74+00.00	22.73	19.32	20.78	-1.46	
74+00.00	TO TO	74+18.00	21.65	18.40	74.64	-56.24	
74+18.00 74+50.00	TO TO	74+50.00 75+00.00	7.77 13.76	6.60 11.70	44.14 72.02	-37.54 -60.32	
75+00.00	TO	75+50.00	21.97	18.67	68.25	-49.58	
75+50.00	TO	76+00.00	21.94	18.65	56.49	-37.84	
76+00.00	TO	76+50.00	22.63	19.24	80.71	-61.47	
76+50.00	TO	76+66.07	33.05	28.09	48.04	-19.95	
76+66.07	TO	77+00.00	19.15 35.32	16.28	0.33	15.95	
77+00.00 77+50.00	TO TO	77+50.00 78+00.00	29.16	30.02 24.79	0.51 1.08	29.51 23.71	
78+00.00	то	78+50.00	26.80	22.78	5.95	16.83	
78+50.00	TO	78+96.00	22.53	19.15	15.41	3.74	
78+96.00	TO	79+00.00	19.94	16.95	16.62	0.33	
79+00.00	TO	79+50.00	1.71	1.45	1.24	0.21	
79+50.00	TO	80+00.00	23.22	19.74	8.33	11.41	
80+00.00 80+50.00	TO TO	80+50.00 81+00.00	32.43 34.84	27.57 29.61	2.02 3.74	25.55 25.87	
81+00.00	то	81+35.00	25.84	21.96	14.26	7.70	
81+35.00	ТО	81+50.00	15.70	13.35	21.27	-7.92	
81+50.00	TO	82+00.00	6.85	5.82	10.69	-4.87	
82+00.00	TO	82+50.00	22.41	19.05	37.21	-18.16	
82+50.00	TO	83+00.00	21.77	18.50	35.06	-16.56	
83+00.00 83+50.00	TO TO	83+50.00 84+00.00	21.54	18.31 18.88	18.66 6.94	-0.35 11.94	
84+00.00	TO	84+50.00	22.21	19.63	5.56	14.07	
84+50.00	то	85+00.00	23.06	19.60	5.40	14.20	
85+00.00	ТО	85+50.00	22.49	19.12	6.14	12.98	
85+50.00	TO	86+00.00	26.92	22.88	4.03	18.85	
86+00.00	TO	86+50.00	15.84	13.46	0.65	12.81	
86+50.00	TO	87+00.00	6.13	5.21	0.10	5.11	
87+00.00	TO TO	87+50.00 87+70.12	21.12	17.95	1.40	16.55 22.95	
87+50.00 87+79.12	TO	87+79.12 88+00.00	30.32 18.40	25.77 15.64	2.82 6.71	8.93	
88+00.00	TO	88+50.00	13.08	11.12	4.79	6.33	
88+50.00	TO	89+00.00	30.05	25.54	1.77	23.77	
89+00.00	TO	89+50.00	29.85	25.37	0.68	24.69	
89+50.00	TO	90+00.00	30.06	25.55	0.70	24.85	
90+00.00	TO TO	90+50.00	30.00	25.50	0.87	24.63	
90+50.00 91+00.00	TO TO	91+00.00 91+50.00	47.44 62.59	40.32 53.20	0.73 2.07	39.59 51.13	
91+50.00	TO	92+00.00	51.45	43.73	7.31	36.42	
92+00.00	TO	92+50.00	43.20	36.72	11.15	25.57	
92+50.00	TO	93+00.00	41.24	35.05	10.36	24.69	
93+00.00	TO	93+50.00	44.99	38.24	7.43	30.81	
93+50.00	TO	93+79.26	33.24	28.25	9.56	18.69	
93+79.26	TO	94+00.00	19.09	16.23	4.87	11.36	
94+00.00 94+50.00	TO TO	94+50.00 95+00.00	17.28 30.17	14.69 25.64	1.20 9.57	13.49 16.07	
95+00.00	TO	95+50.00	29.06	24.70	13.62	11.08	
95+50.00	TO	96+00.00	29.39	24.98	11.41	13.57	
96+00.00	TO	96+36.00	28.73	24.42	12.81	11.61	
96+36.00	TO	96+50.00	23.05	19.59	8.08	11.51	
96+50.00	TO TO	97+00.00	8.50	7.23	2.83	4.40	
97+00.00 97+50.00	TO TO	97+50.00 98+00.00	21.13 17.47	17.96 14.85	16.76 20.99	1.20 -6.14	
98+00.00	TO	98+50.00	28.76	24.45	17.67	6.78	
98+50.00	TO	99+00.00	33.13	28.16	12.65	15.51	
99+00.00	TO	99+31.10	63.84	54.26	6.65	47.61	
	TC	TAL VOLUMES (CU YD):	3347	2845	2661	183	


FILE NA	ME = 5867.200_Sht-DT.dwg	USER NAME = MARK COBB	DESIGNED - MGFC	REVISED -			EARTHWORK SCHEDULE		SECTION	COUNTY	TOTAL SHEET SHEETS NO.
			DRAWN - MGFC	REVISED -	STATE OF ILLINOIS			0163	15-08113-05-CH	LAKE	112 17
		PLOT SCALE = 1" = .0833'	CHECKED - DPB	REVISED -	DEPARTMENT OF TRANSPORTATION		FISH LAKE ROAD IMPROVEMENTS			CONTRACT #	# 61K10
- 1		PLOT DATE = 1/30/2024 12:24 PM	DATE - 12/18/2023	REVISED -		SCALE: N.A.	SHEET NO. 1 OF 1 SHEETS STA. TO STA.	1	ILLINOIS FED. A	D PROJECT	

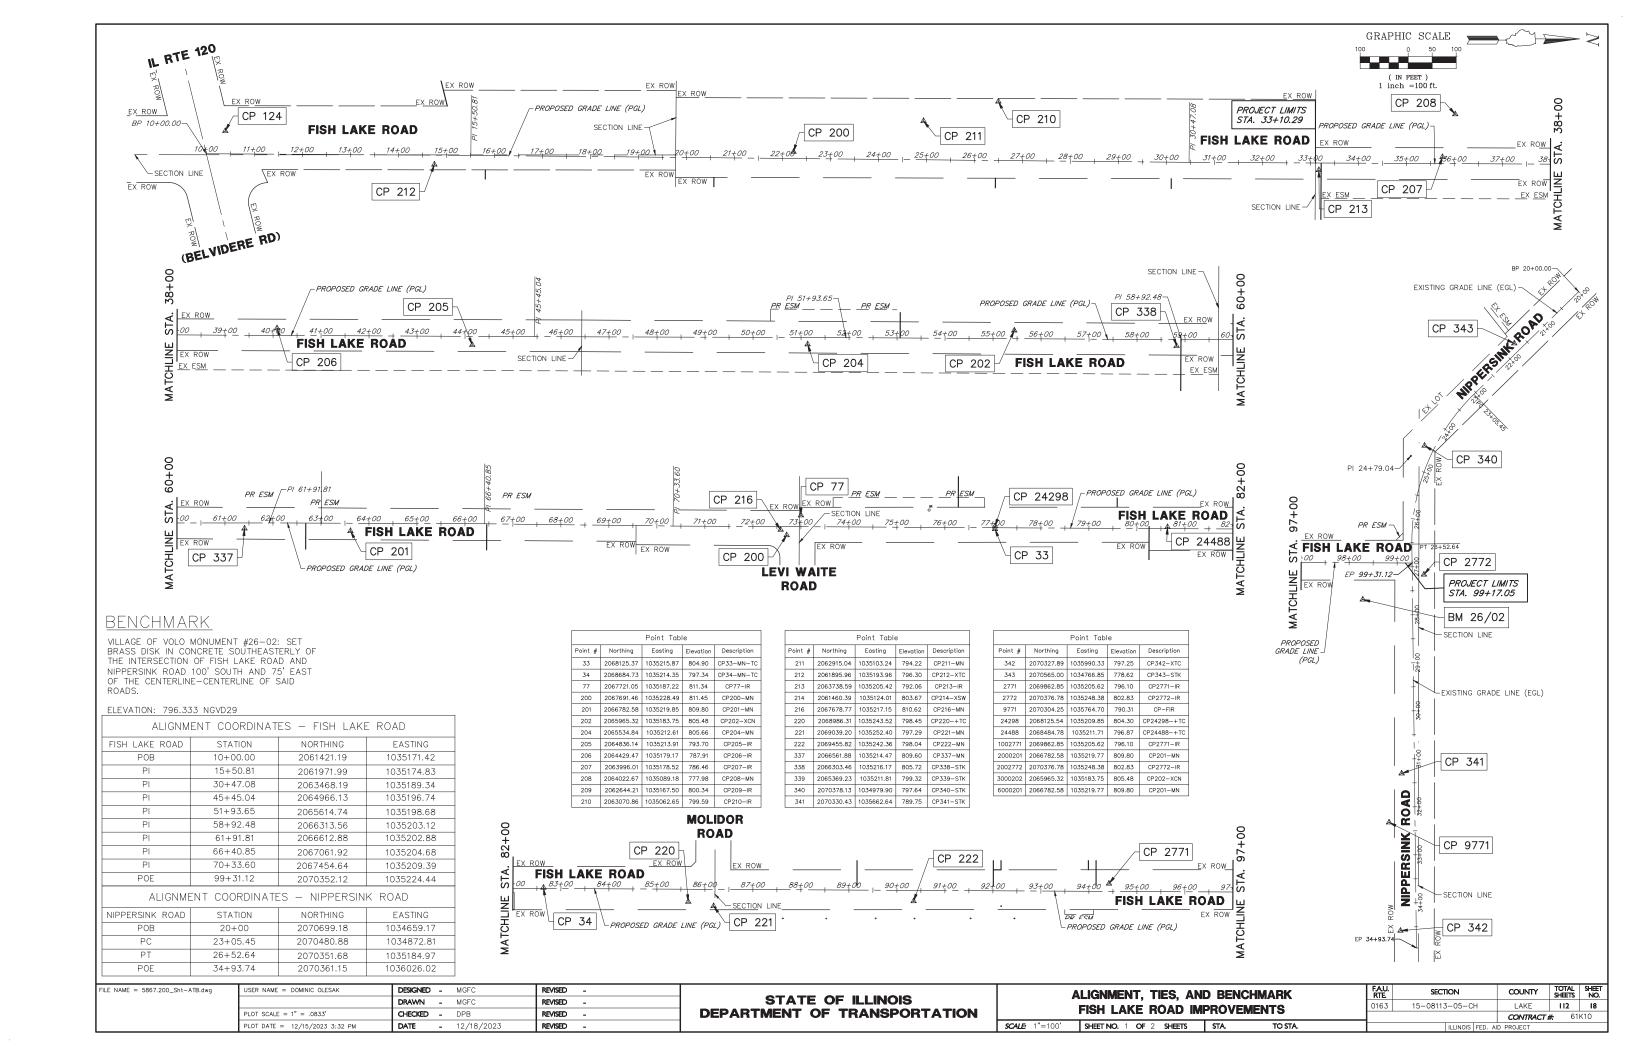


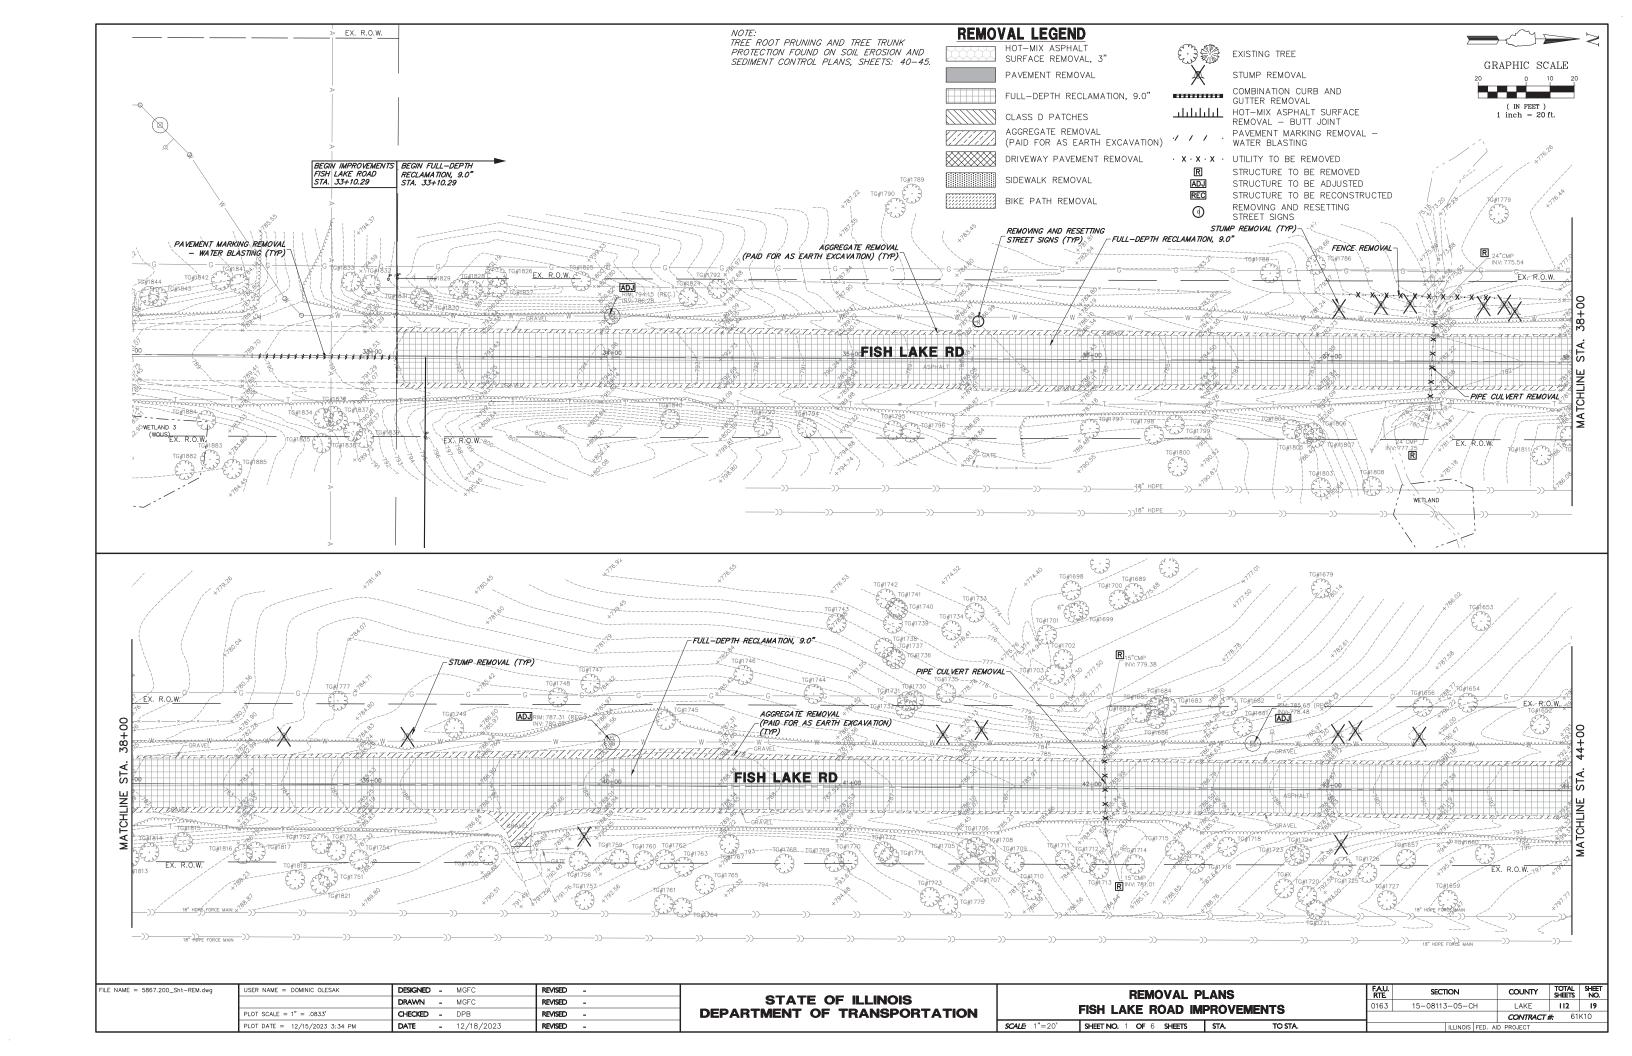


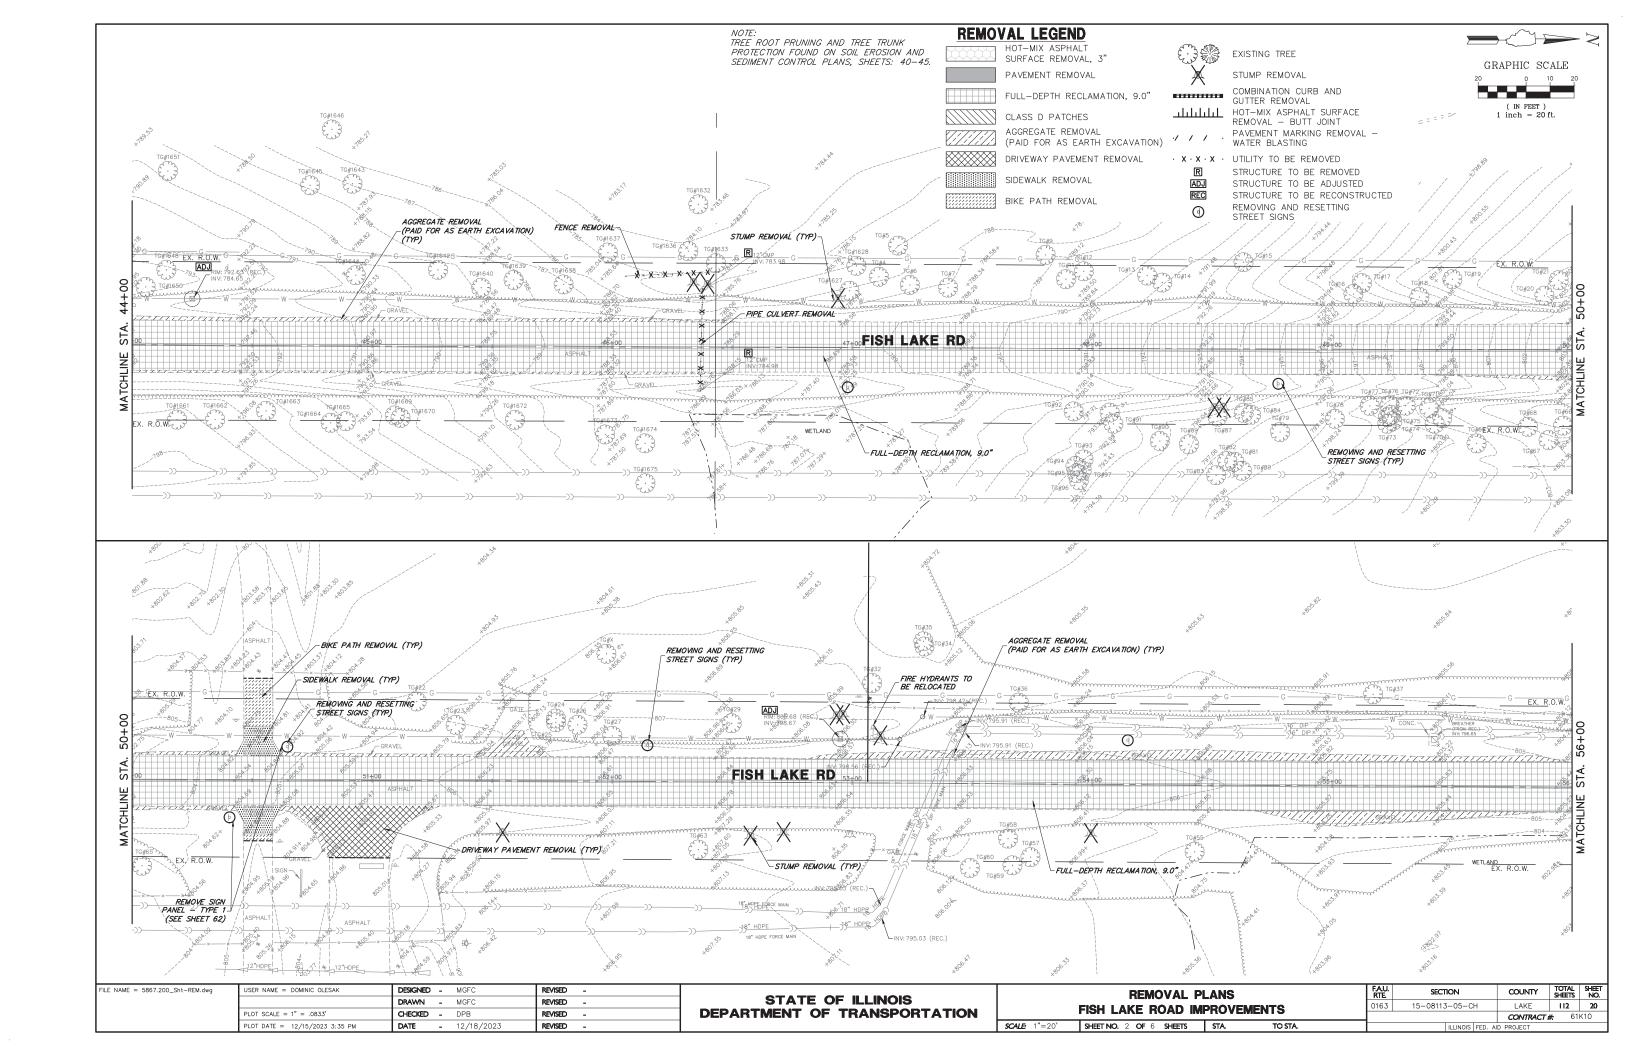


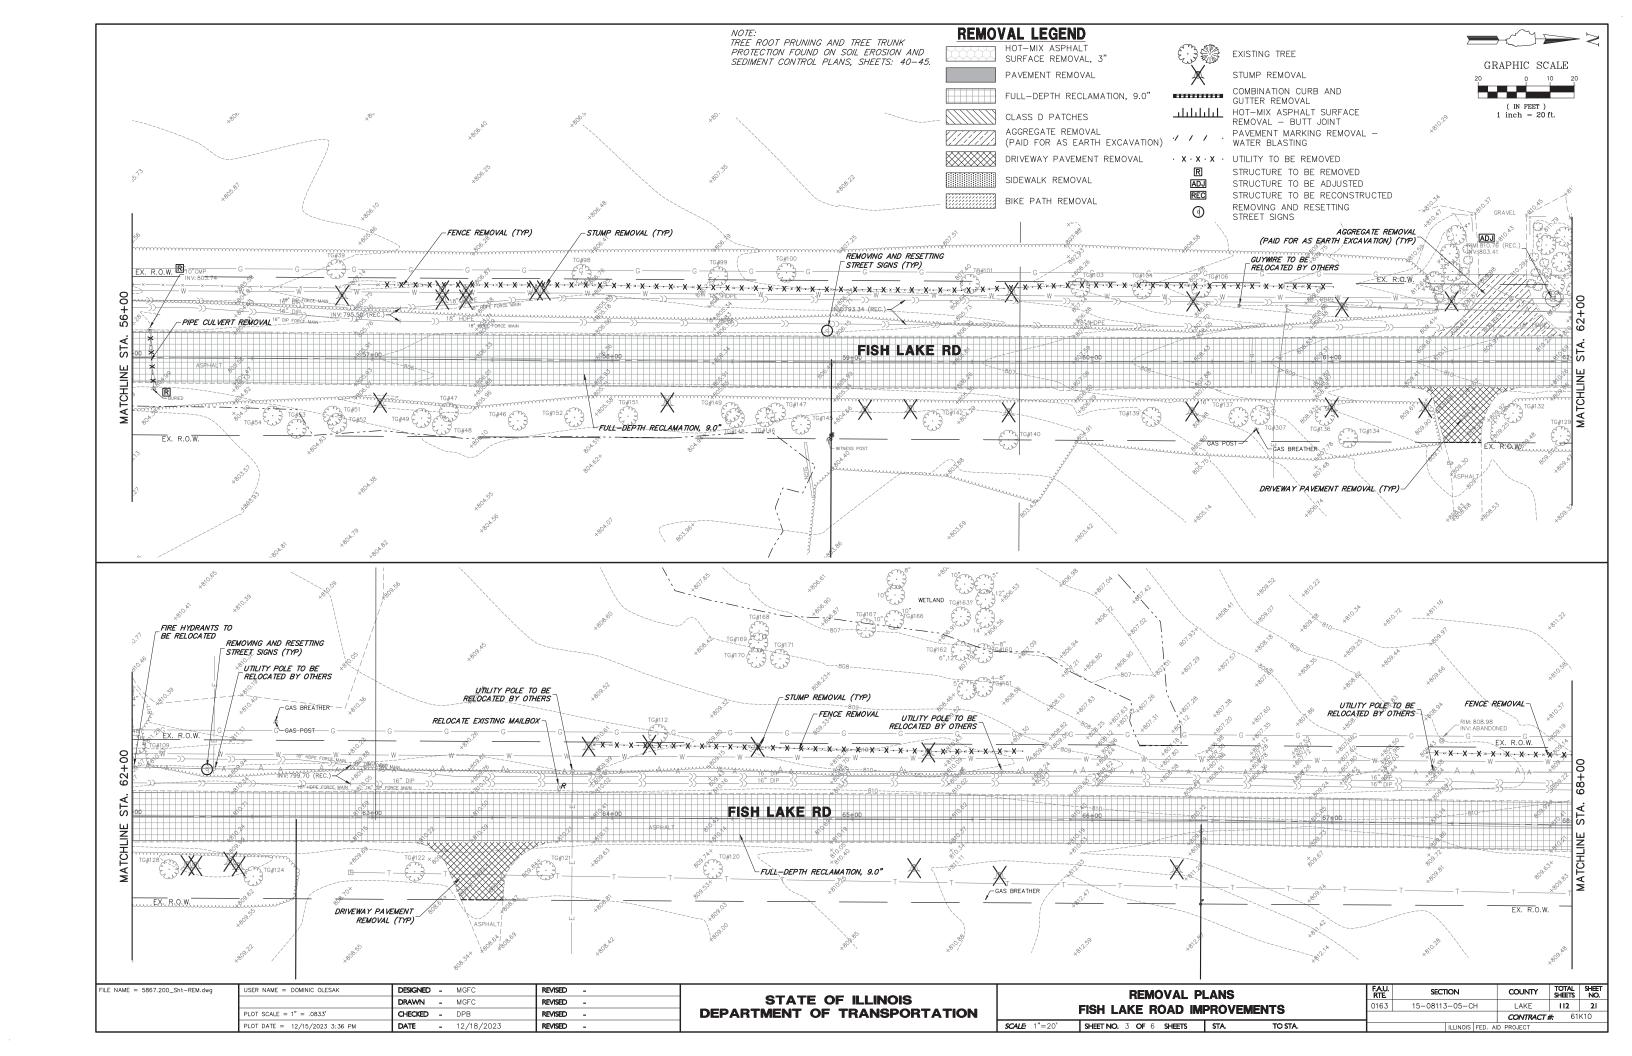


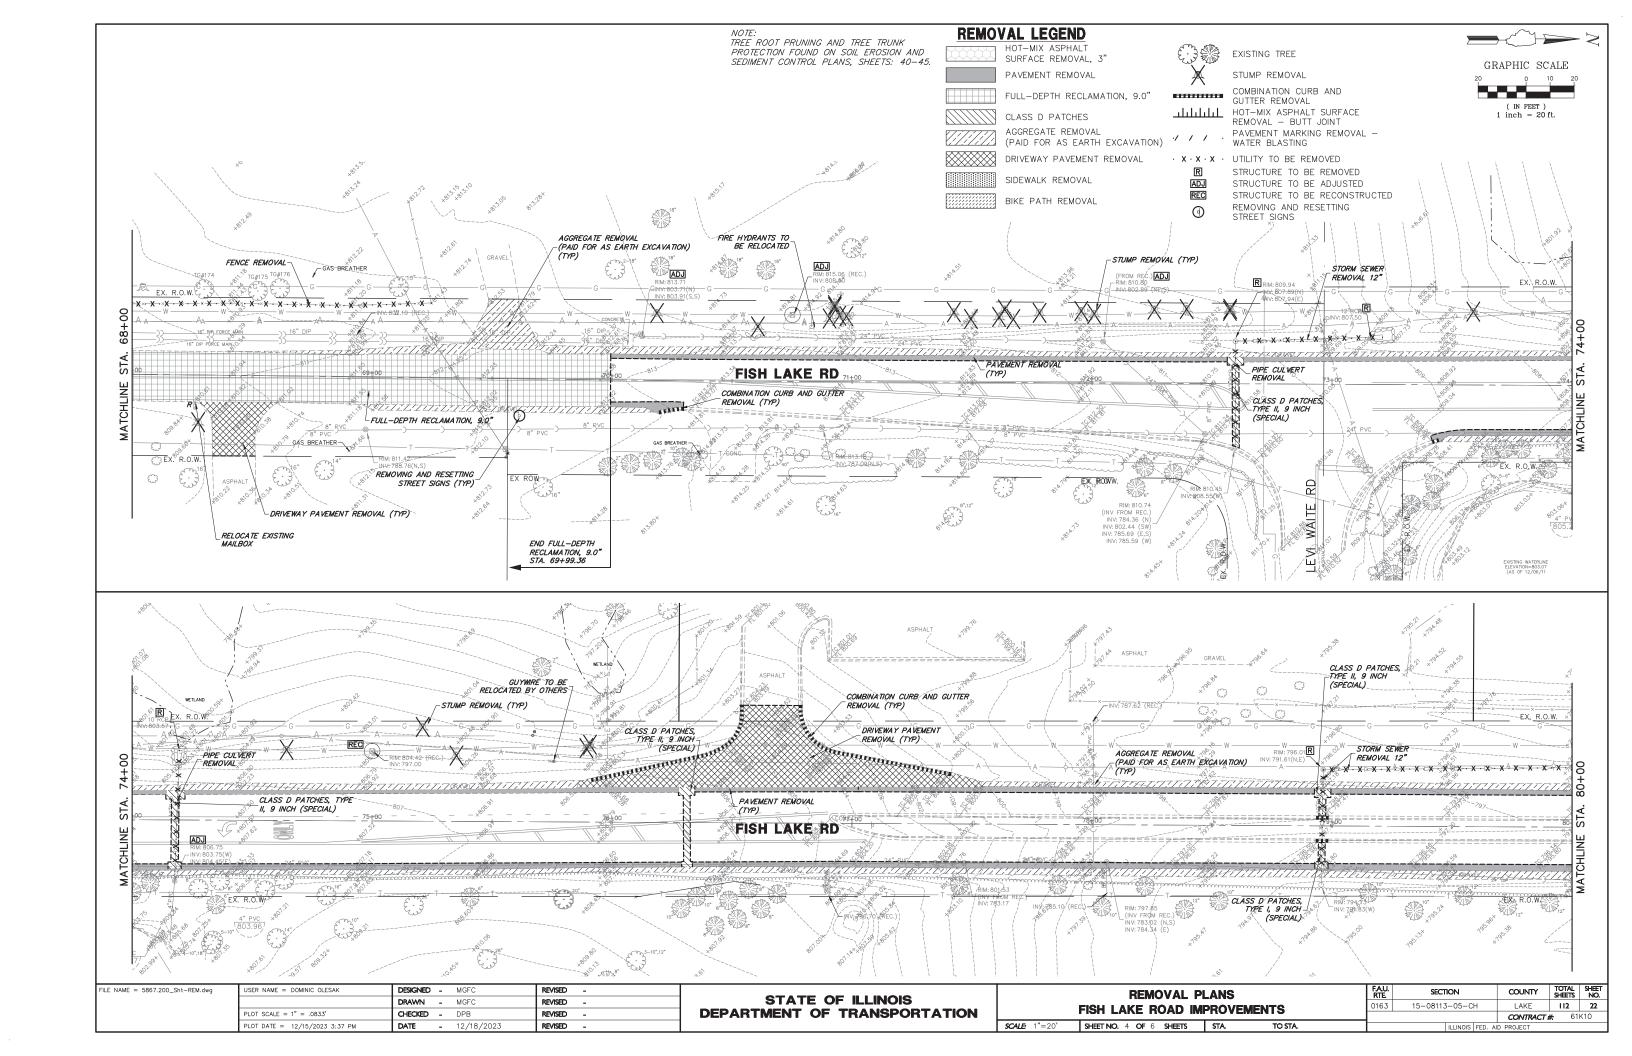


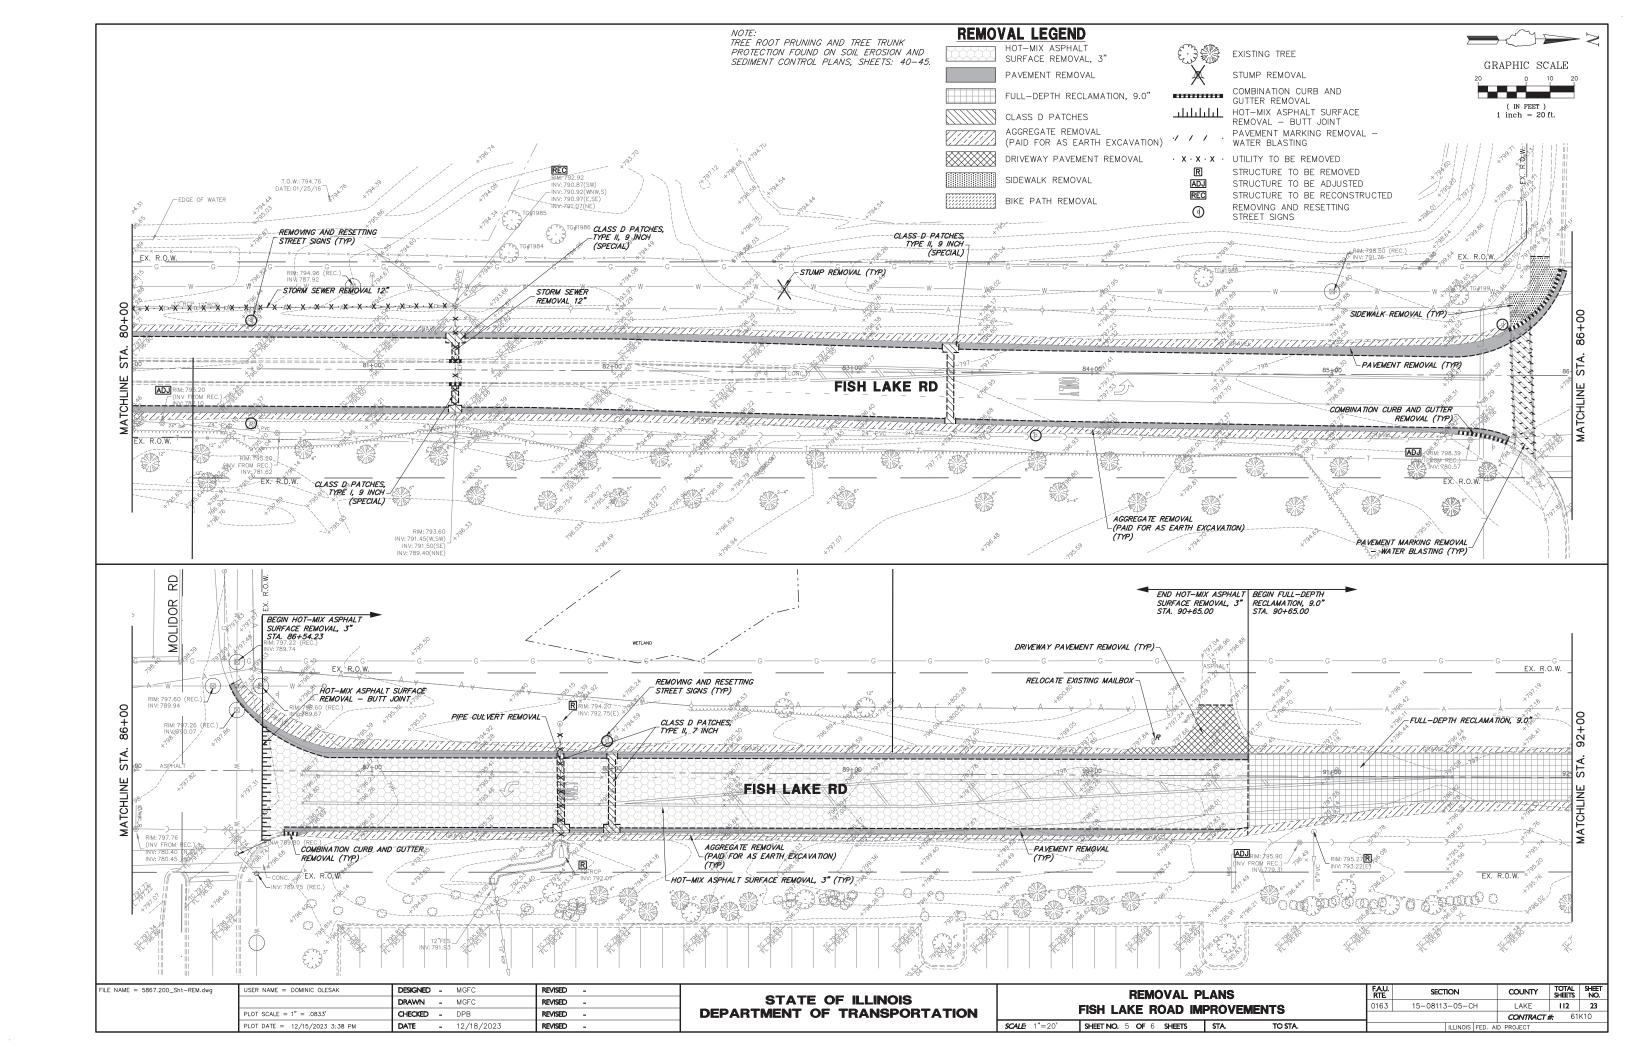


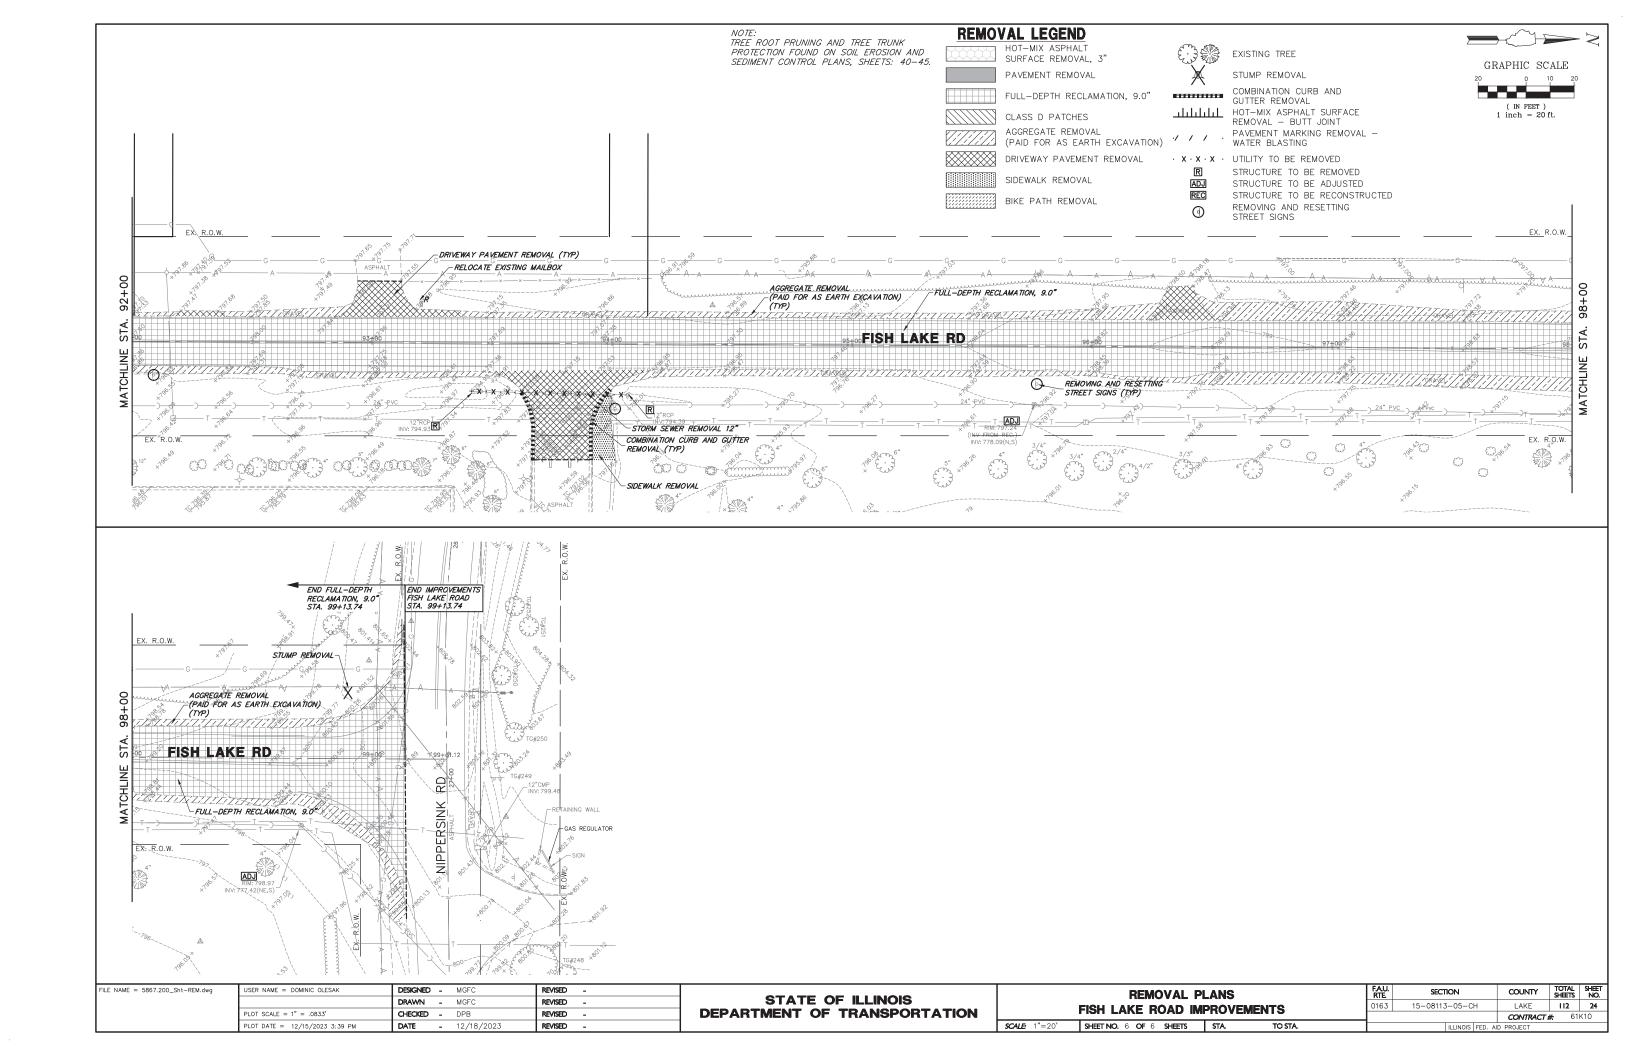


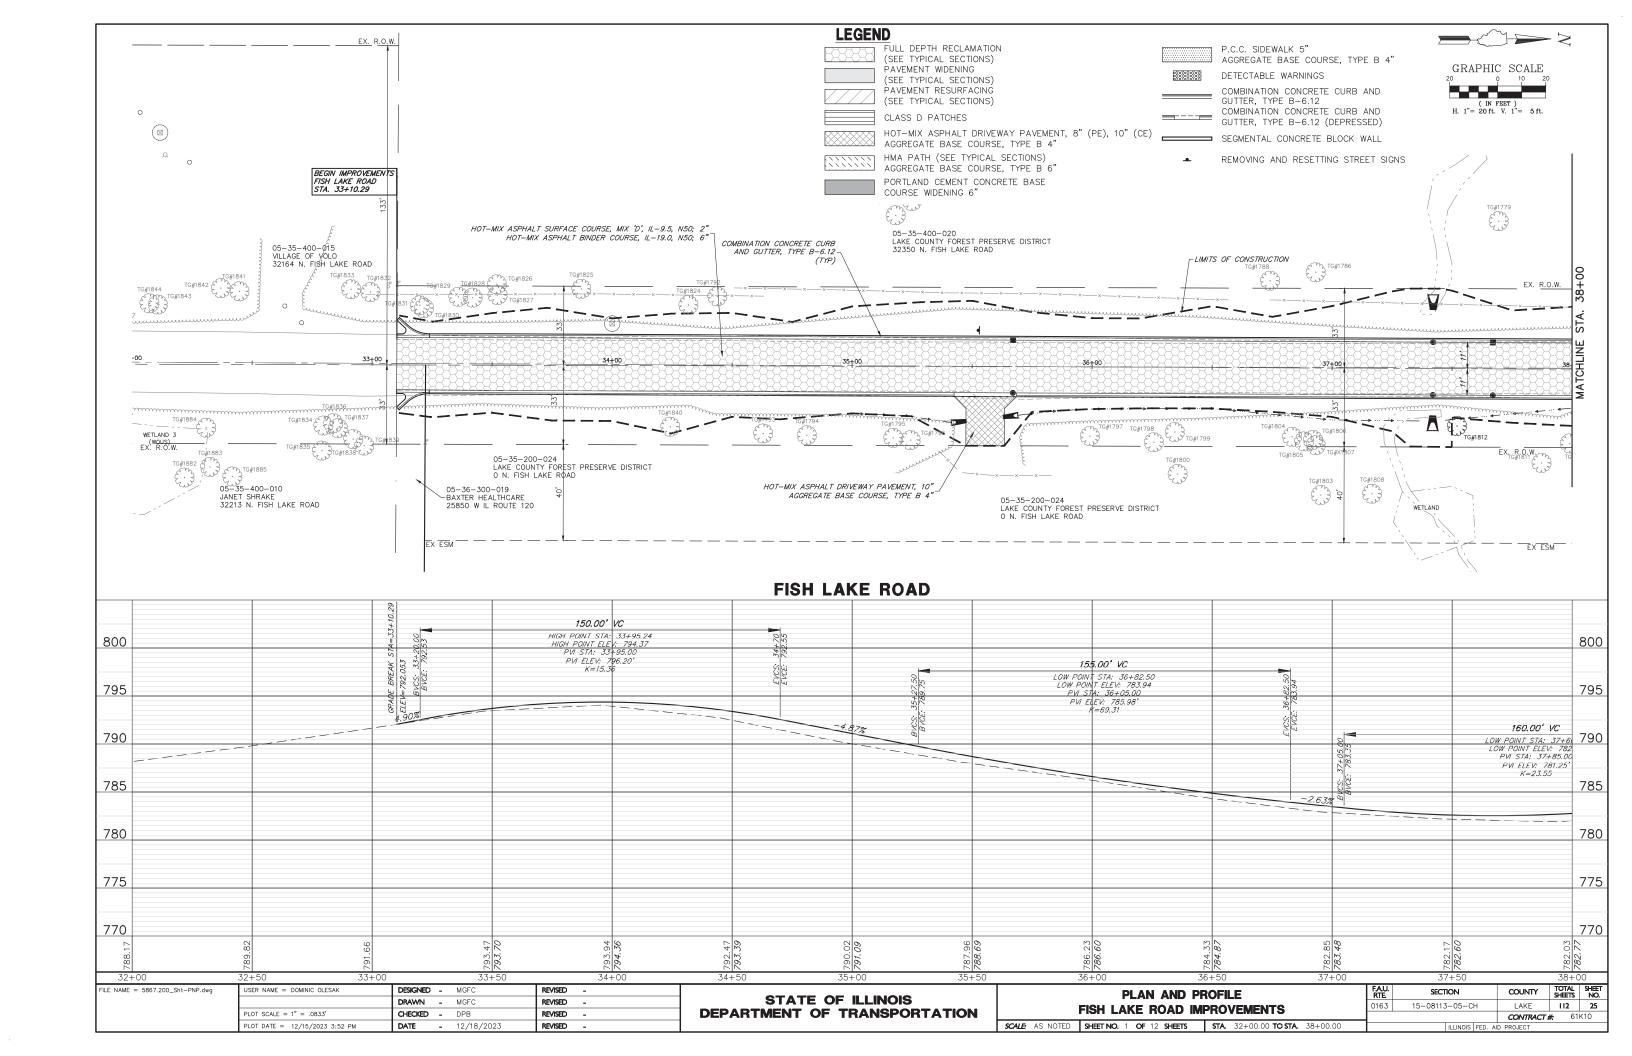


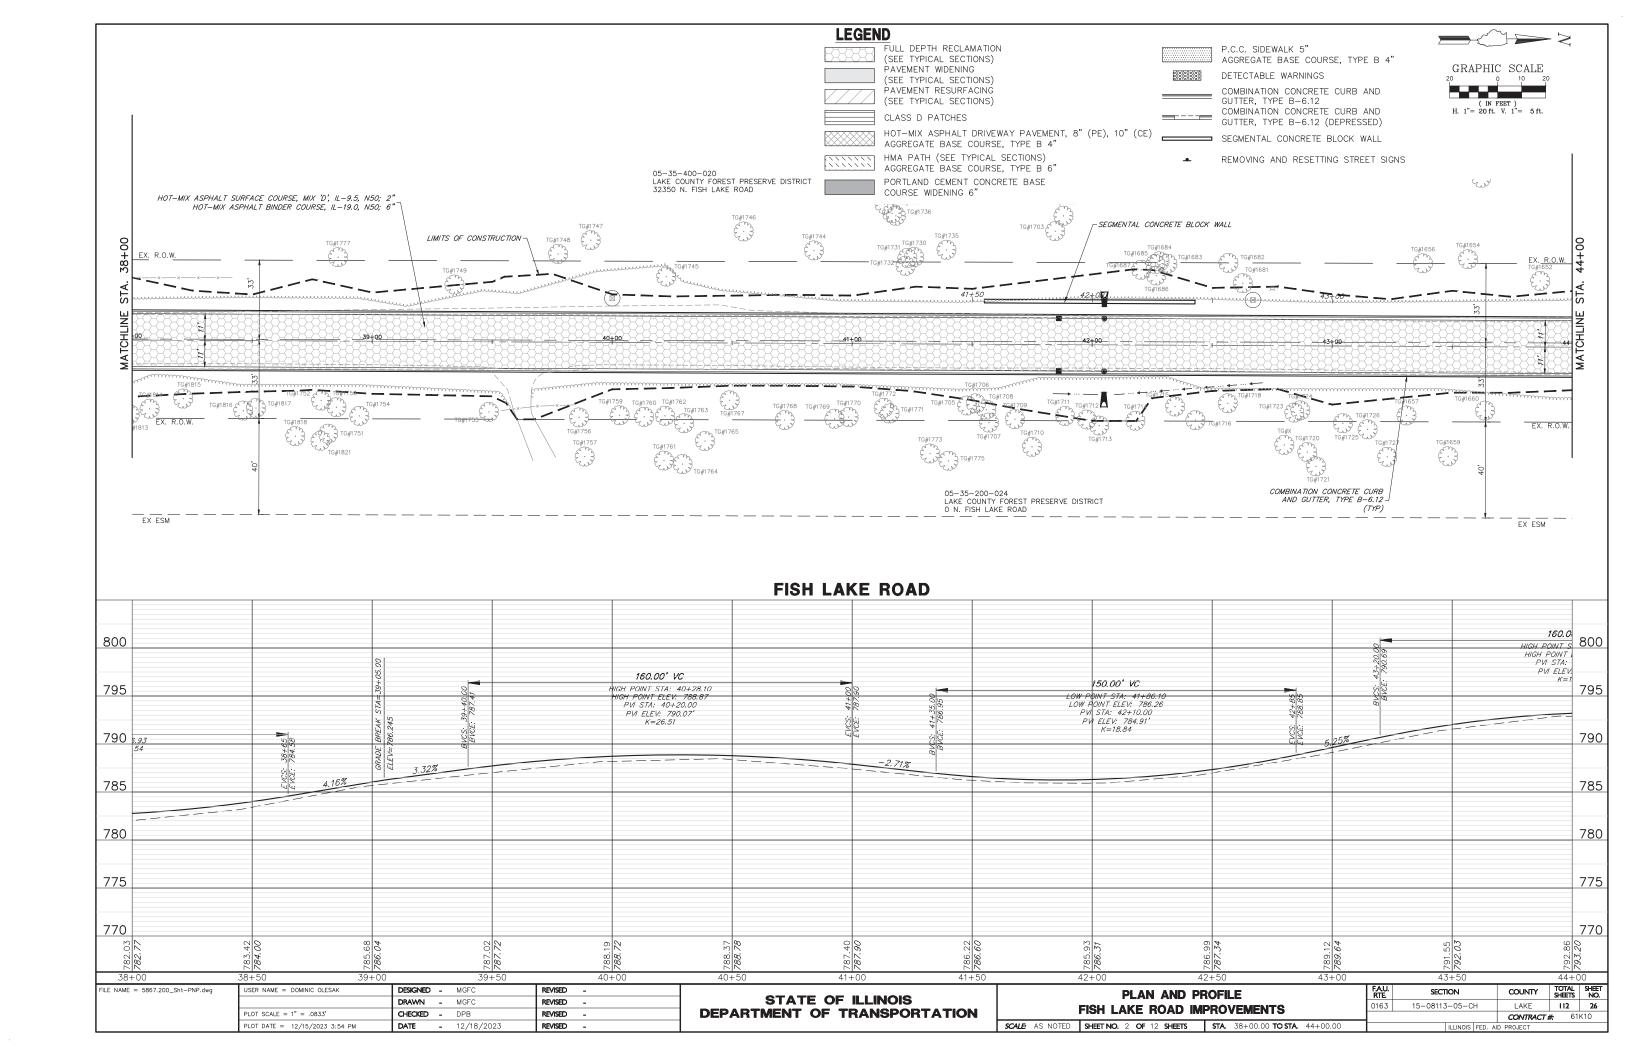


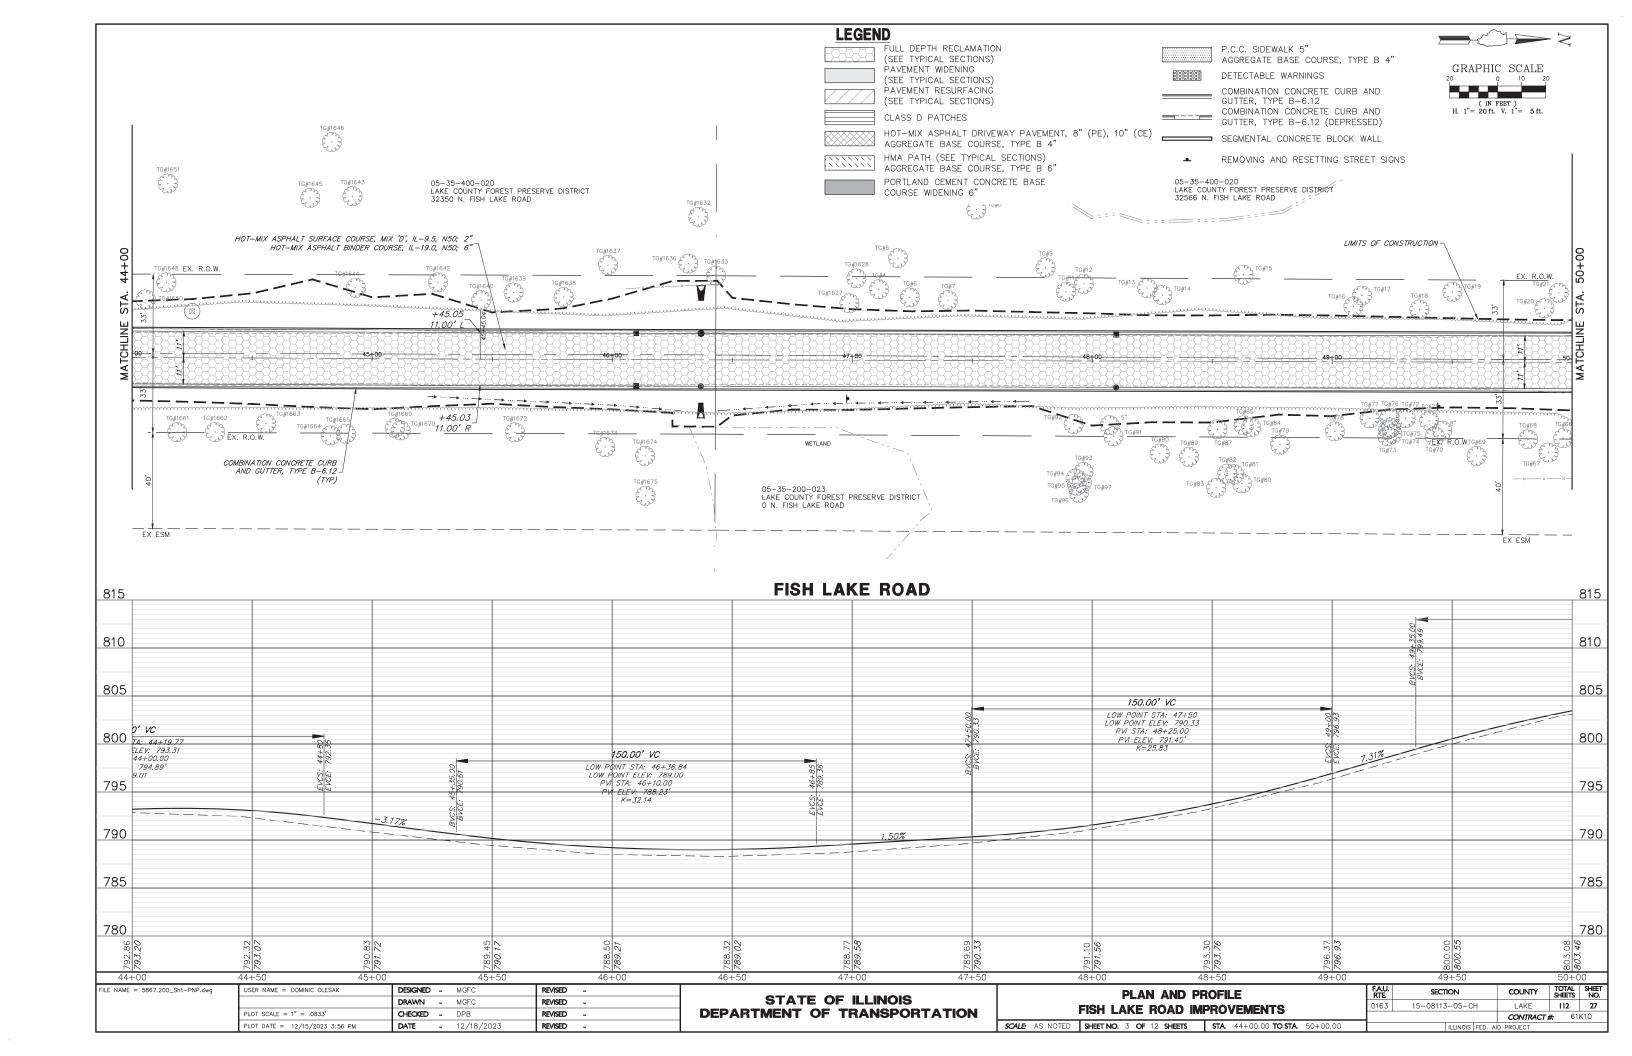


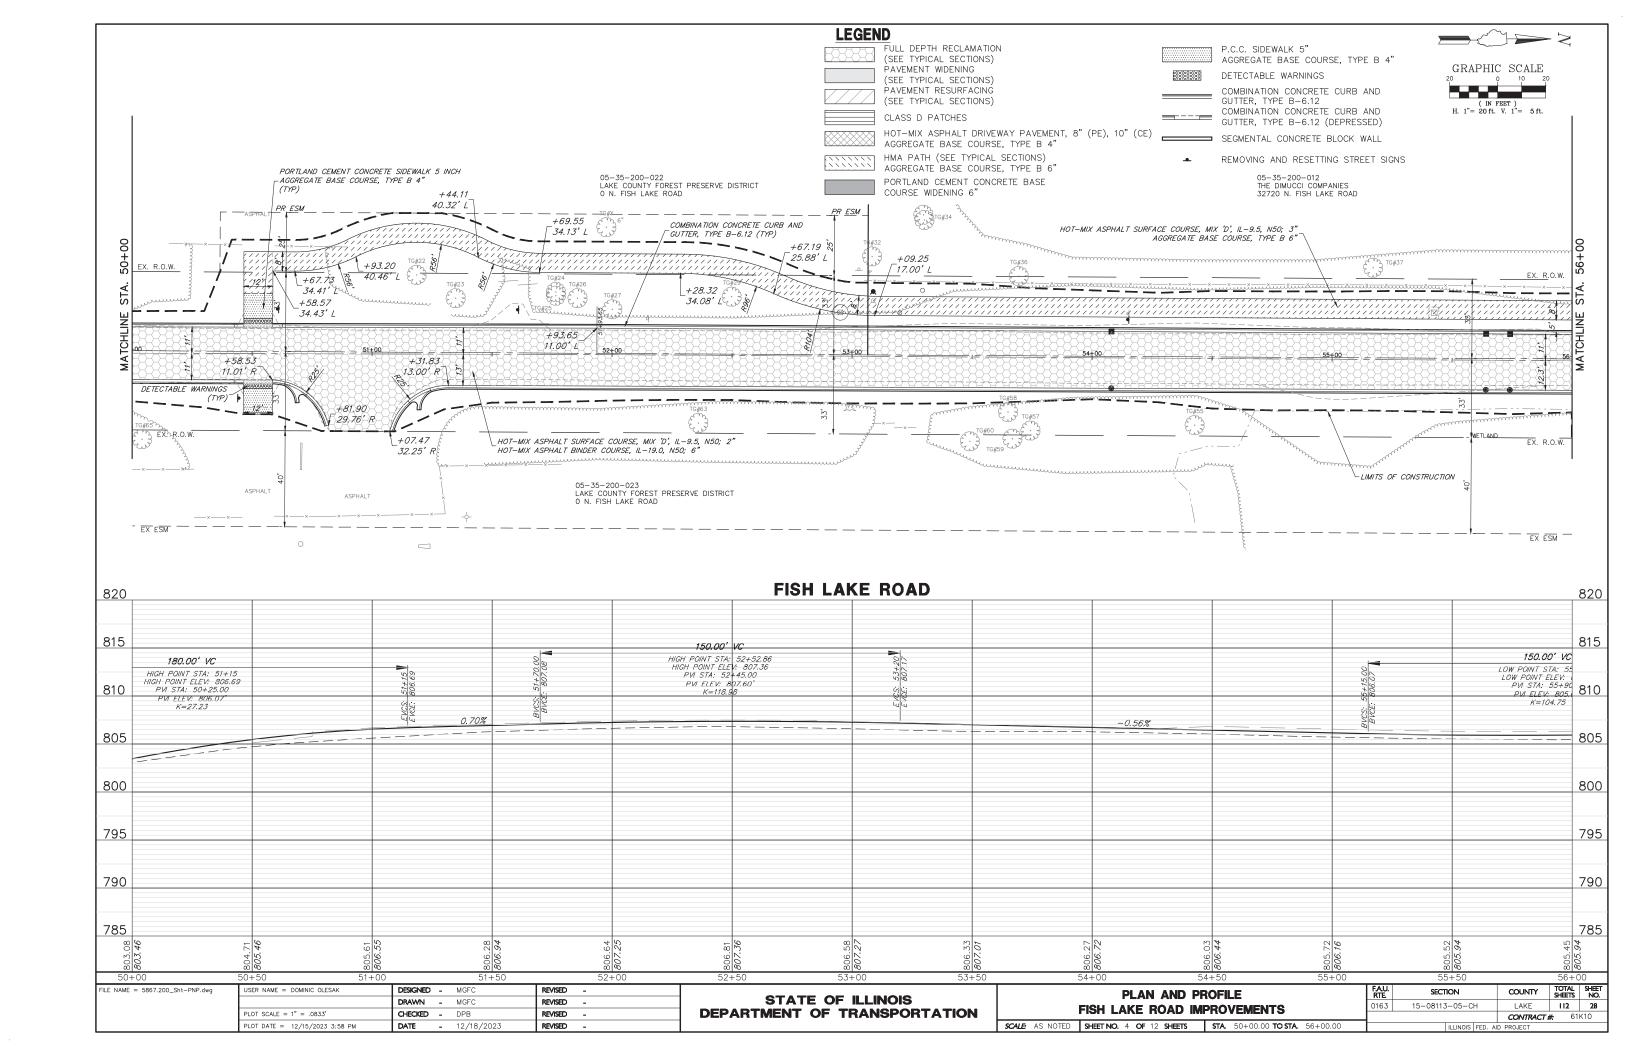


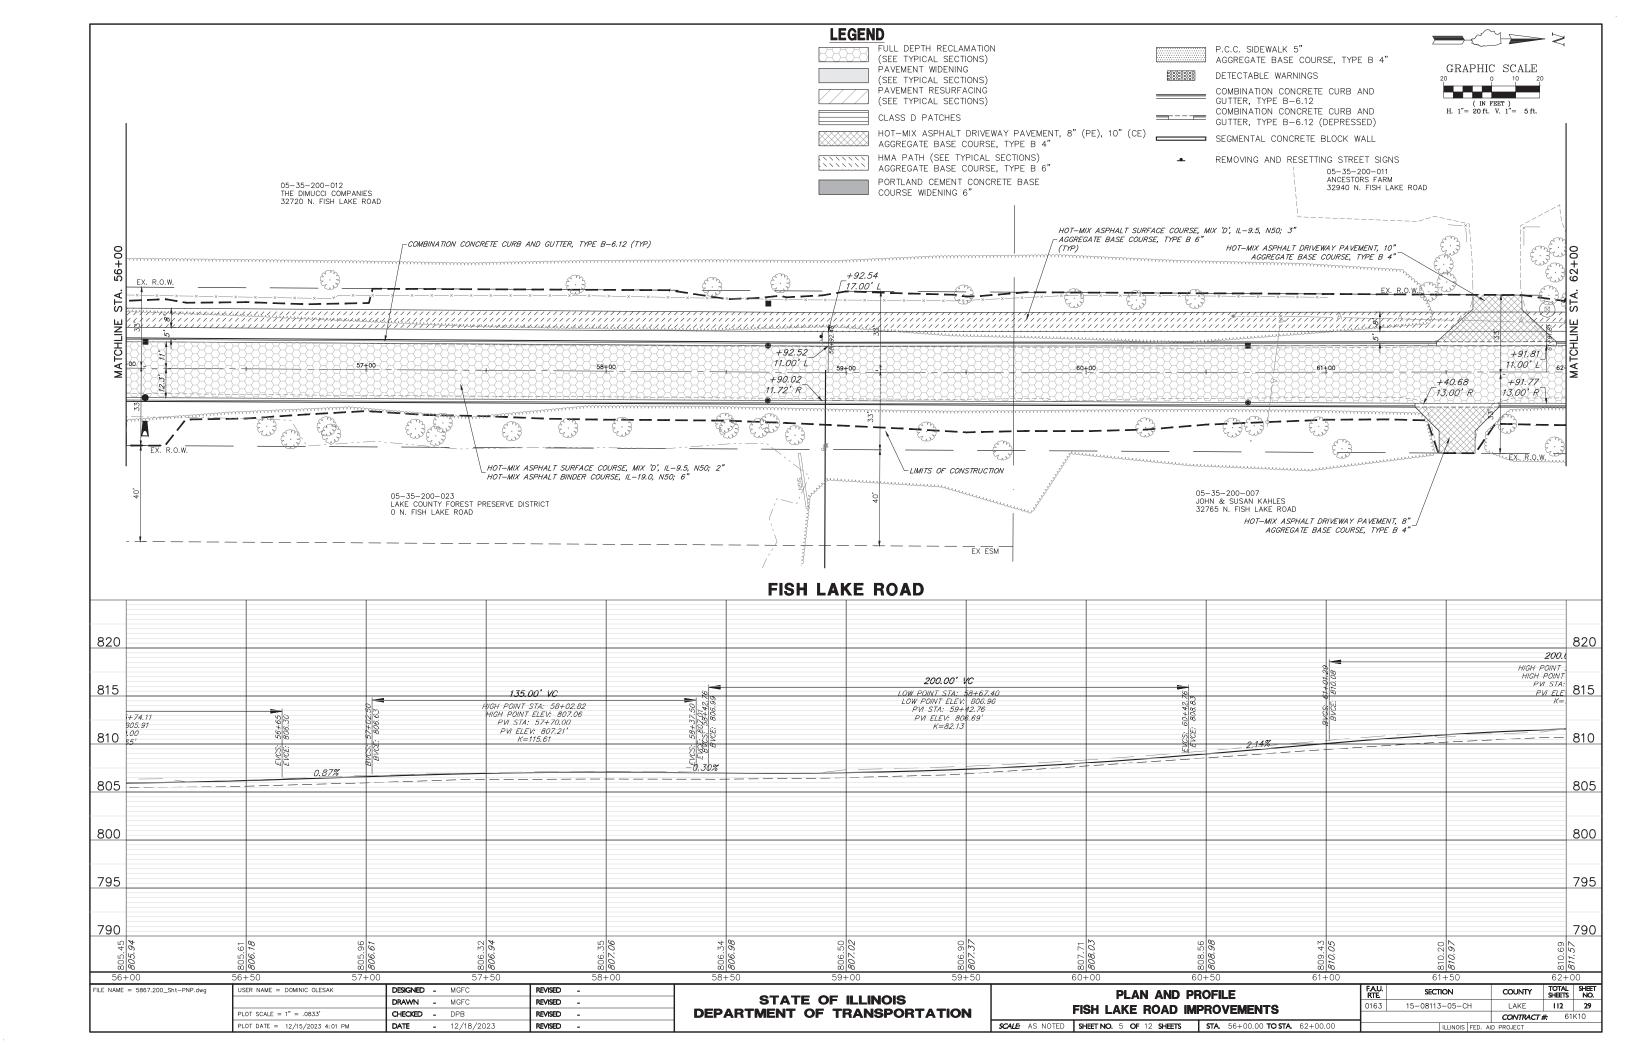


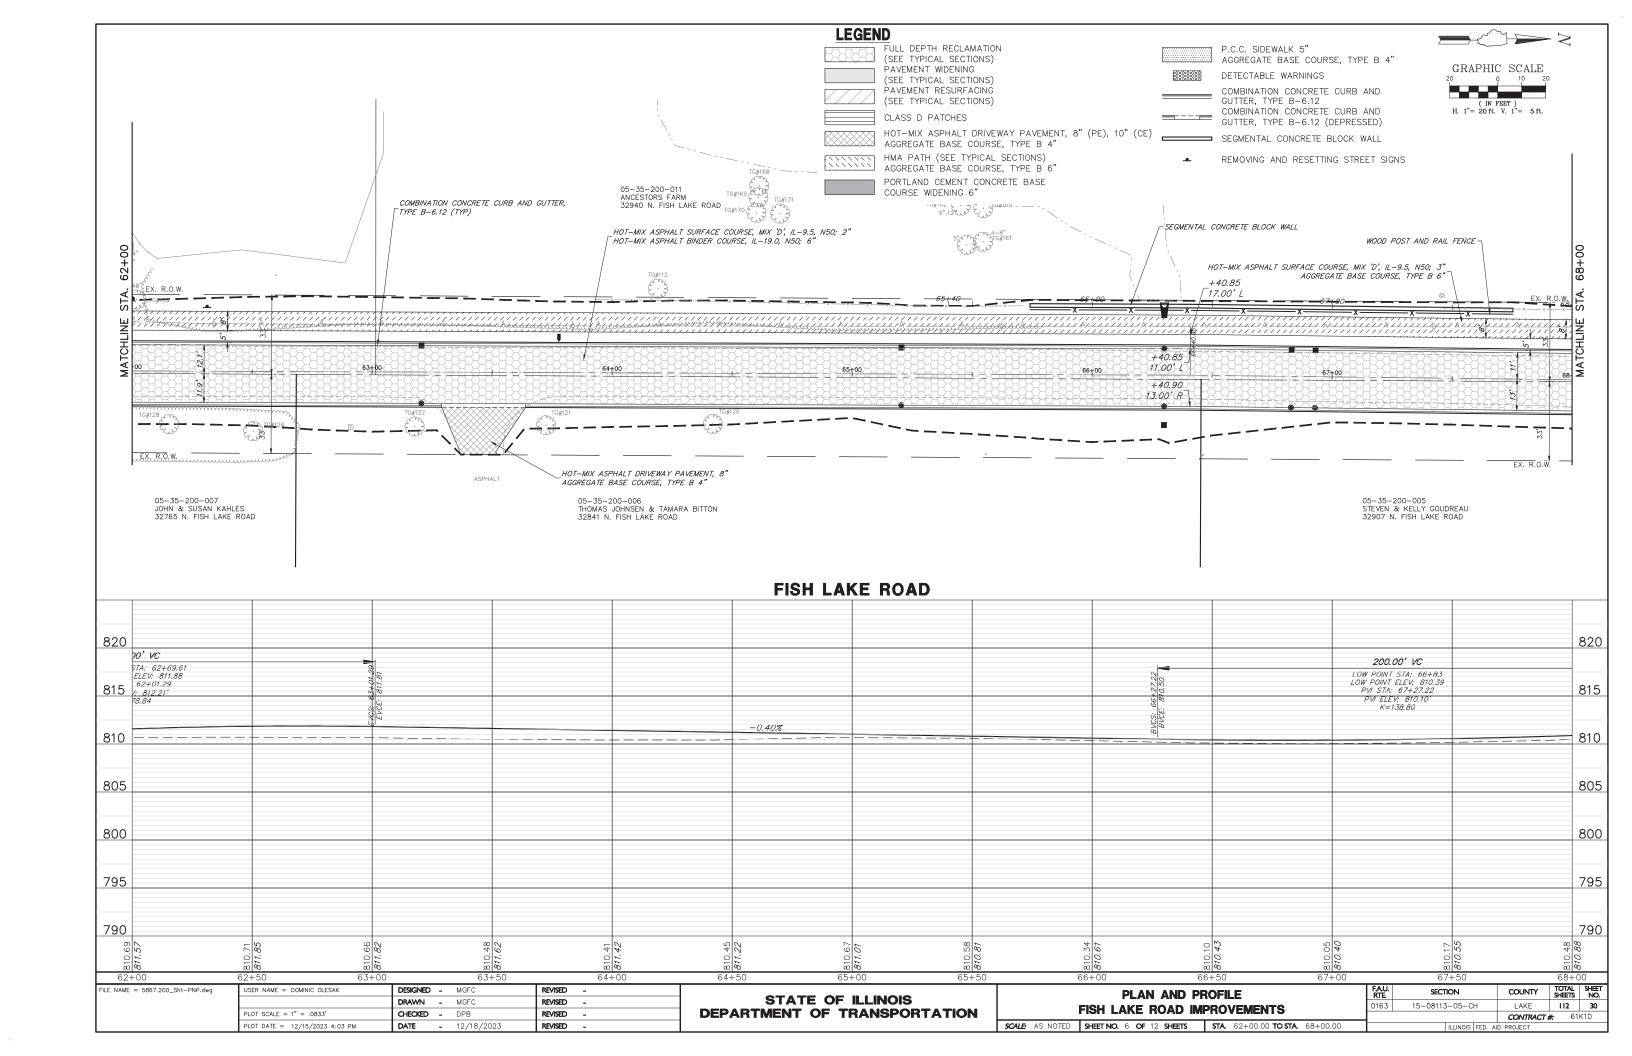


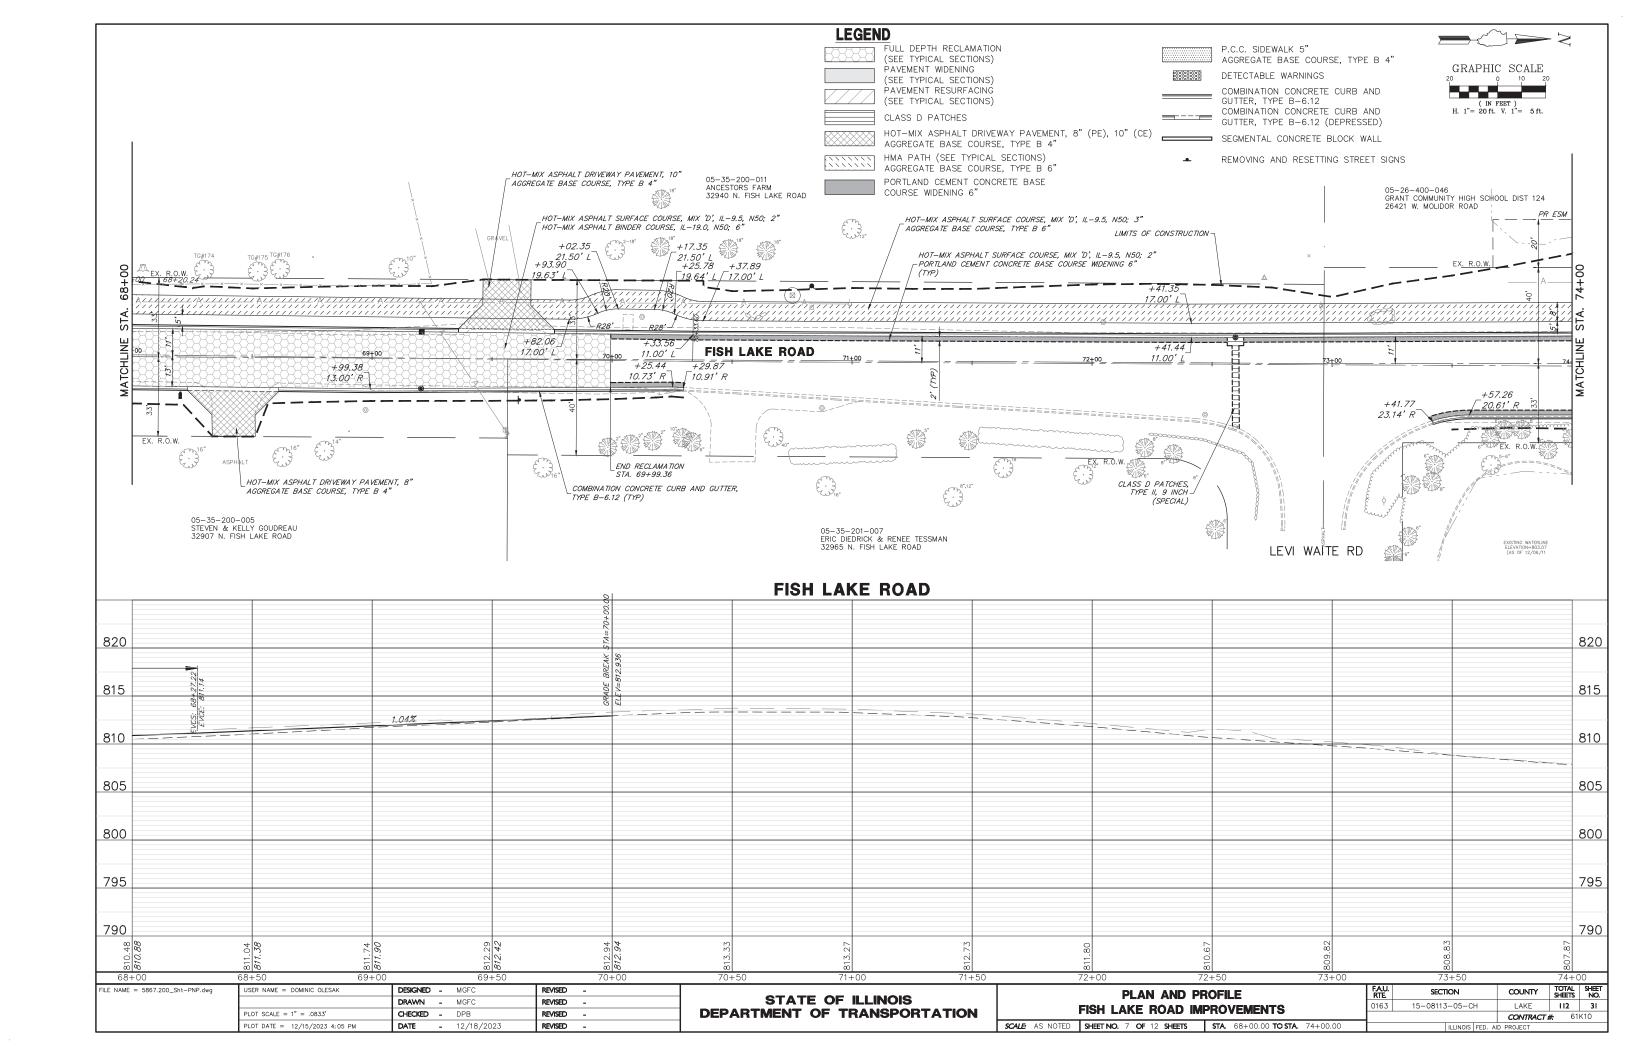


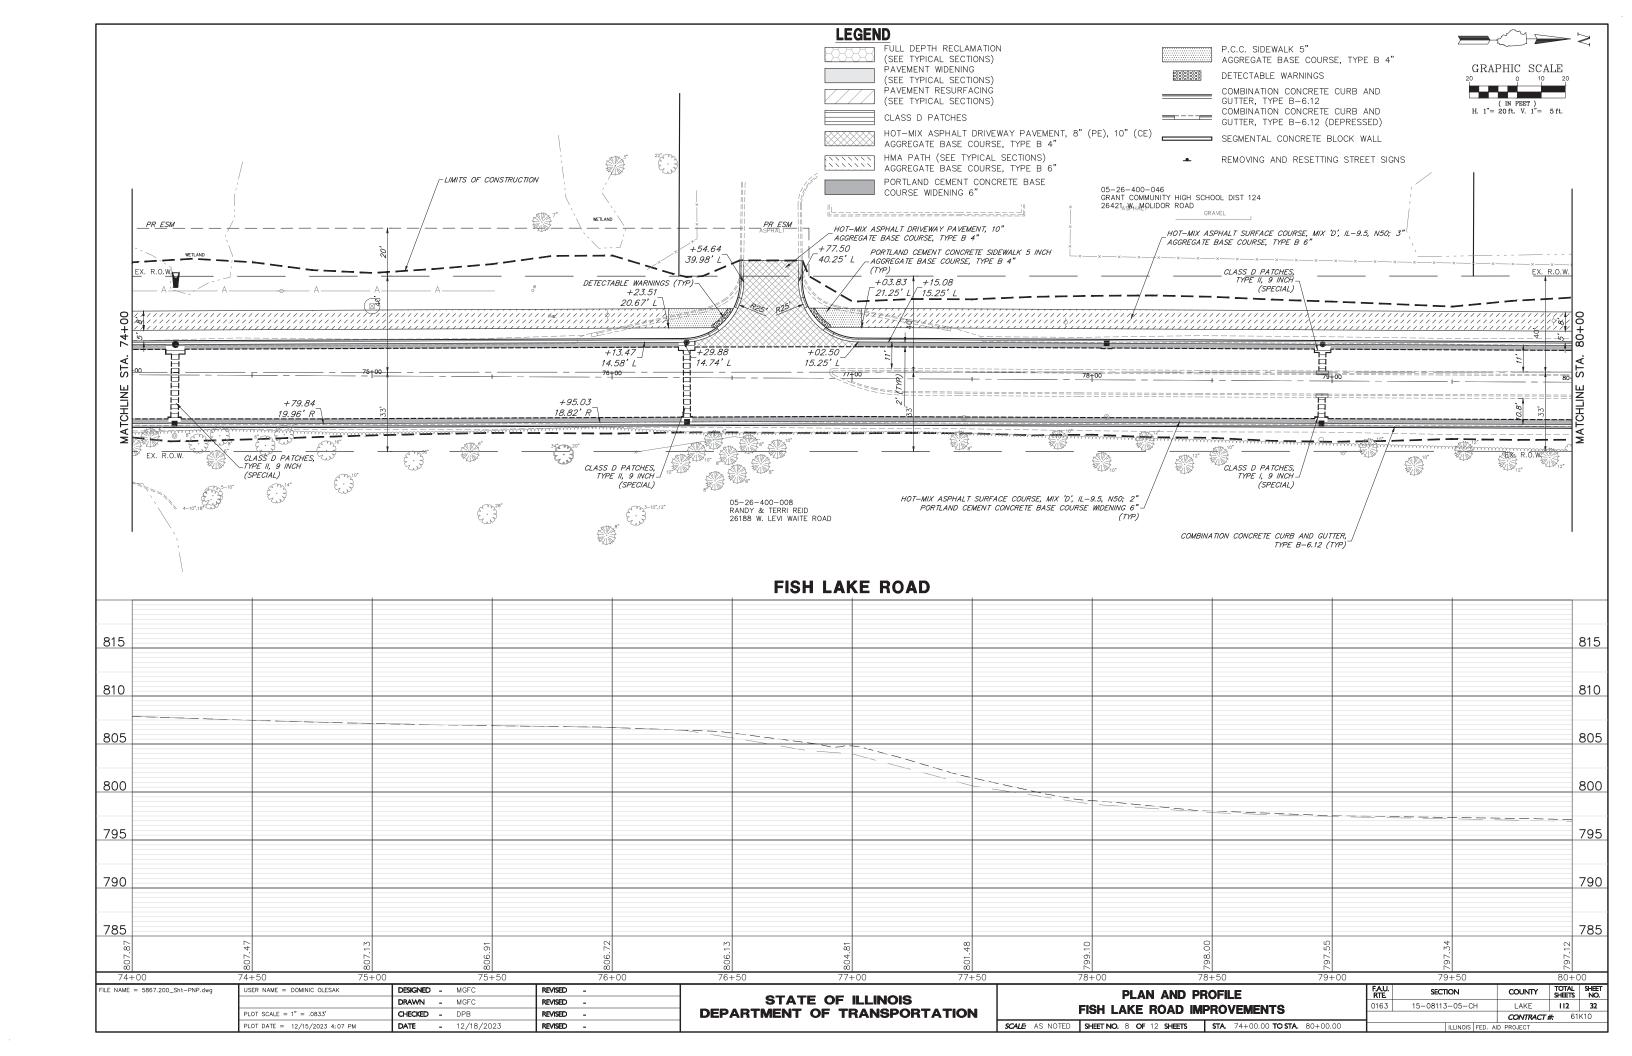

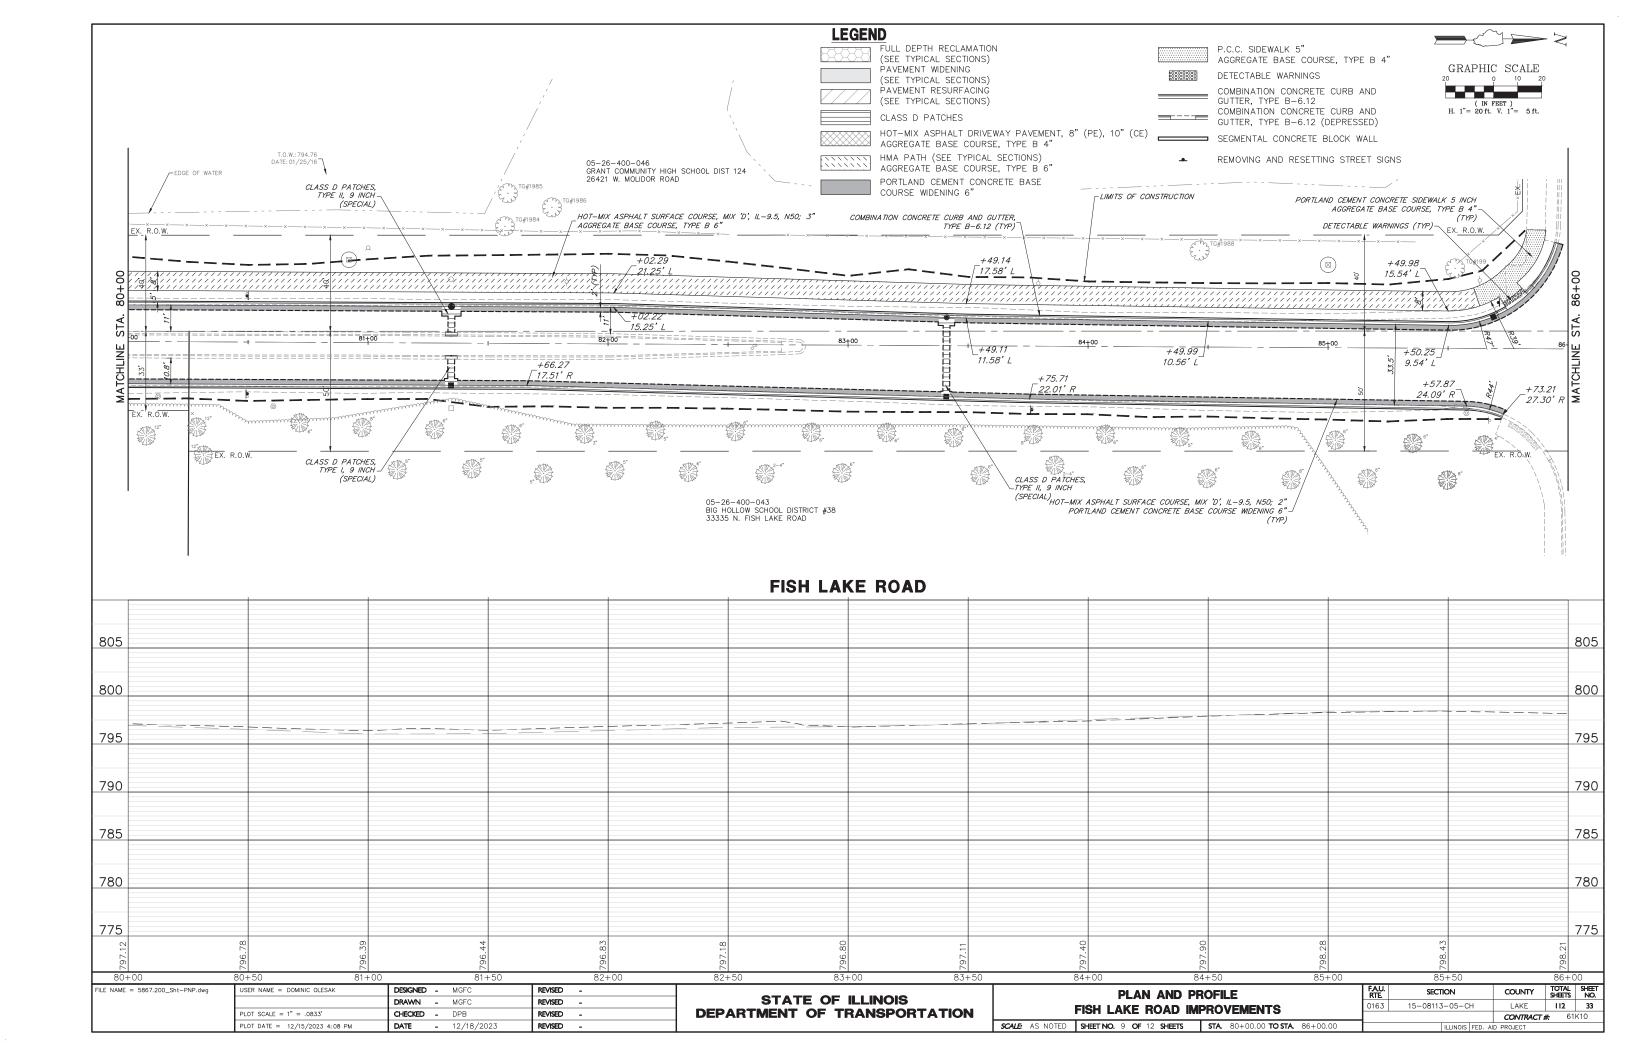

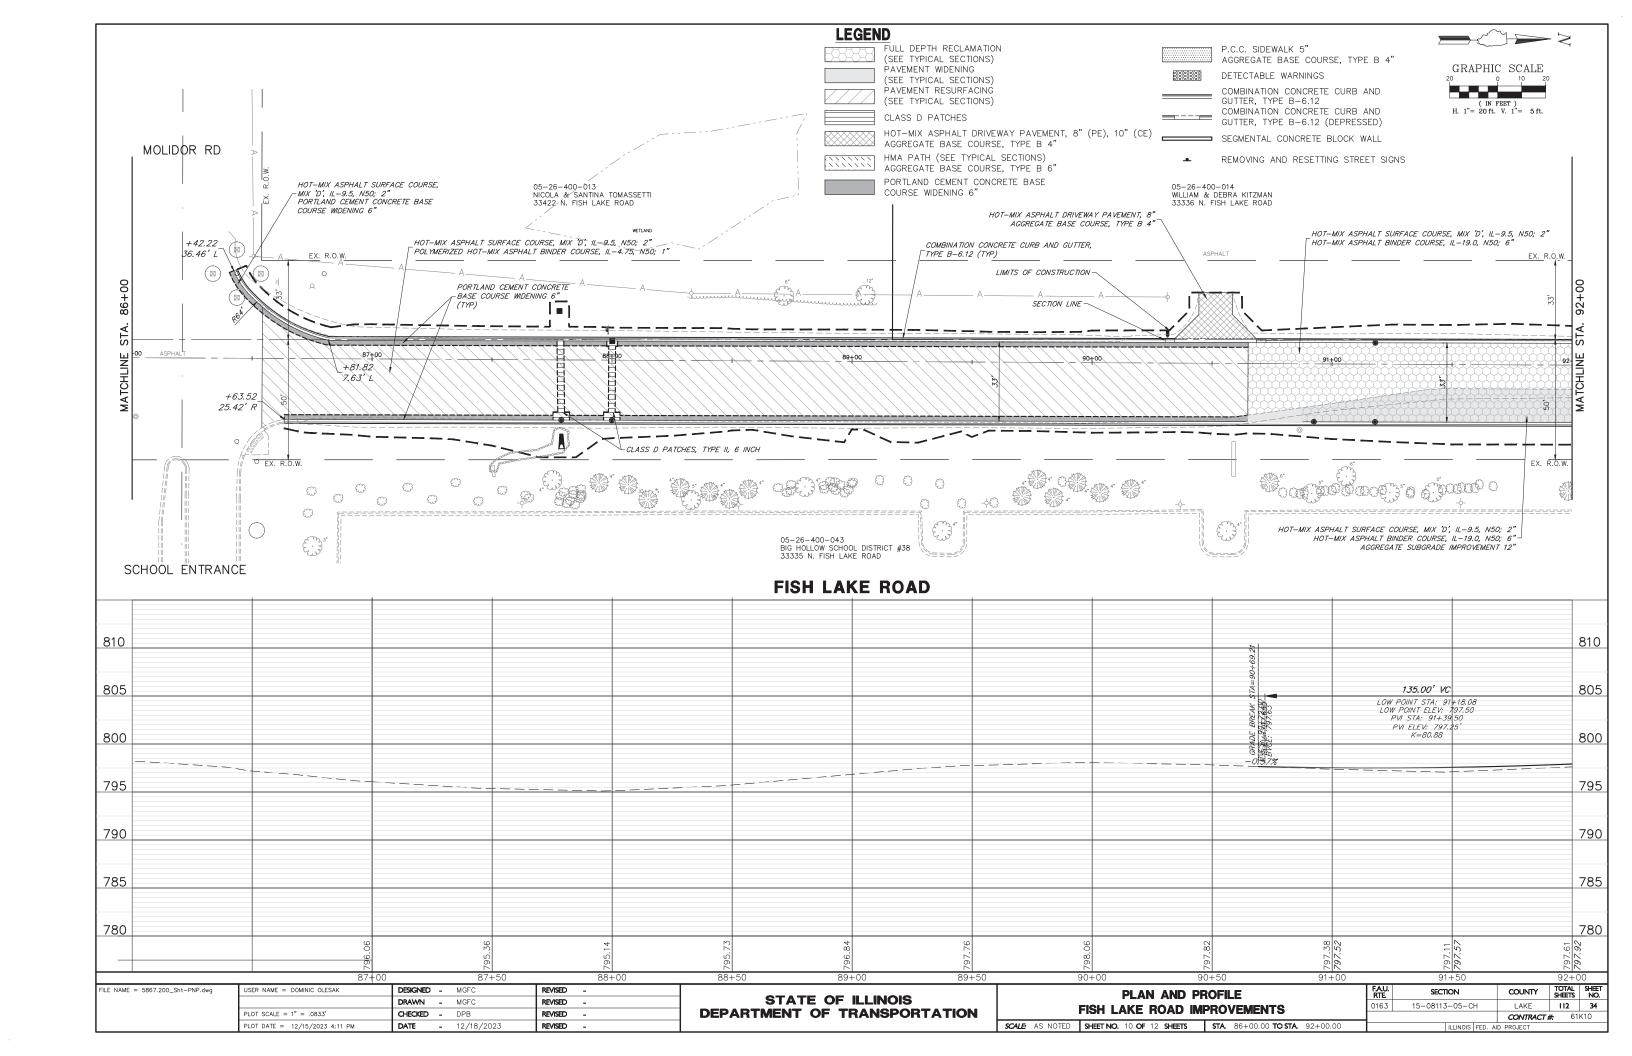


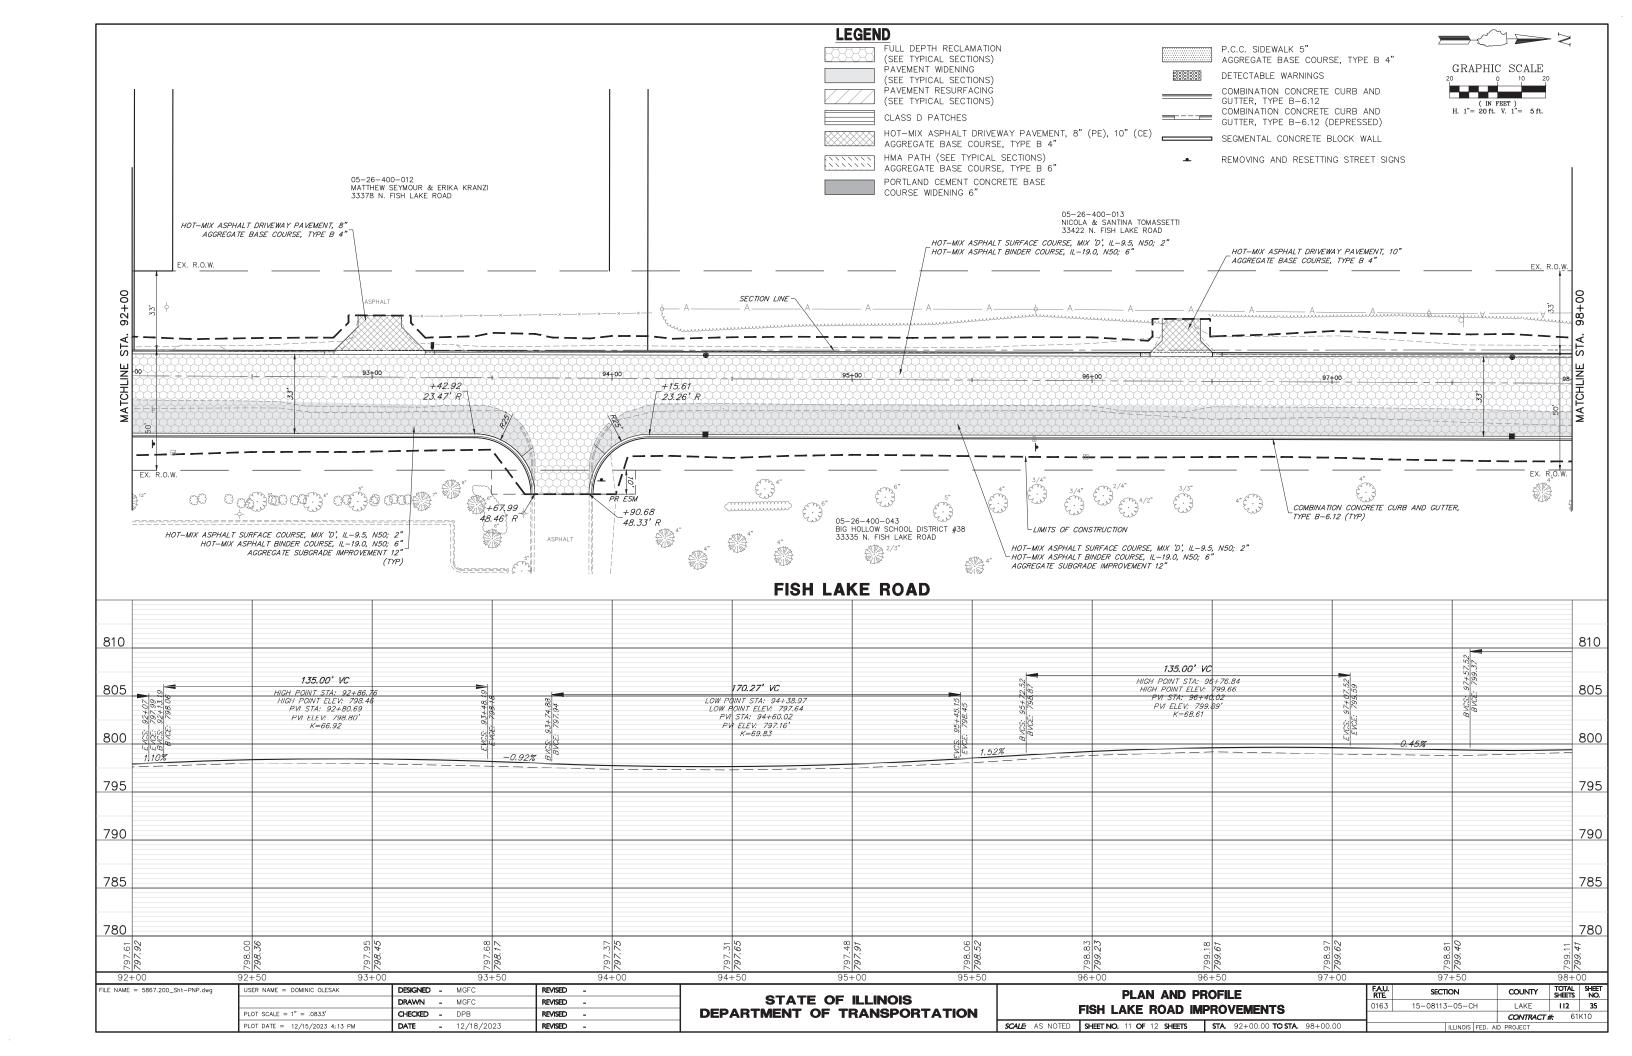

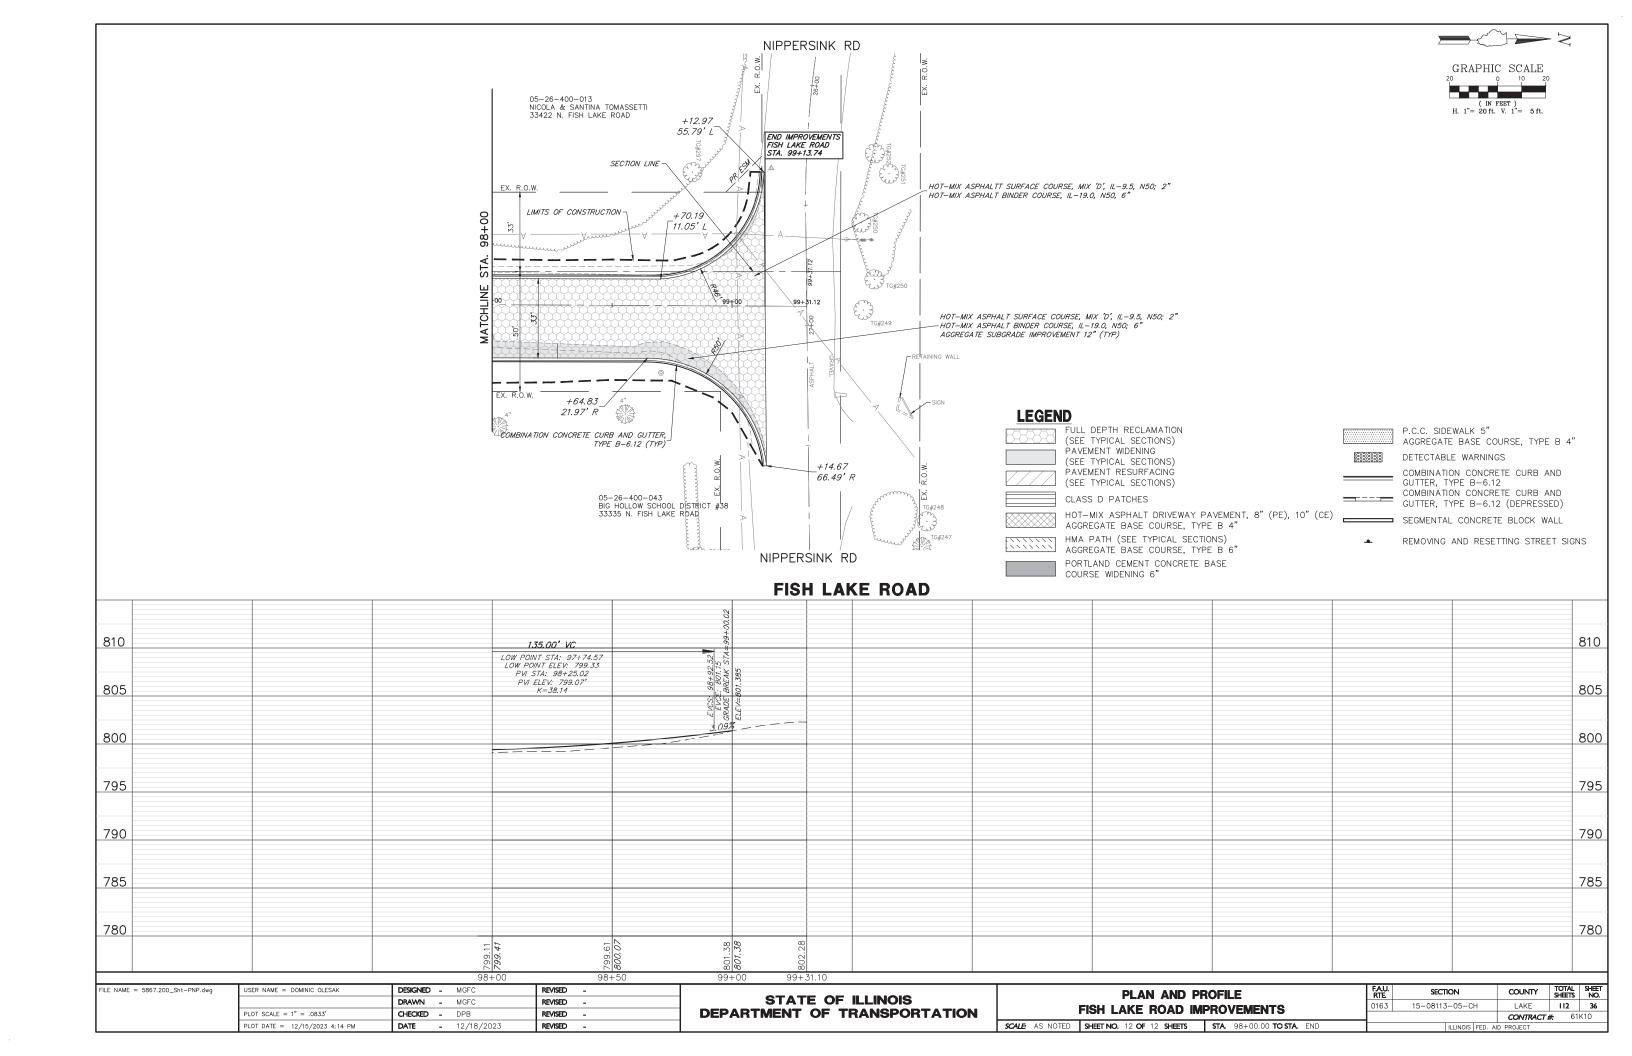

SCHEDULE OF QUANTITIES DETOUR GENERAL NOTES: SIGN TYPE QUANTITY SIGN NO. <u>SIGN</u> SIGN NO. <u>SIGN</u> SIGN TYPE **QUANTITY** 1. ALL SIGNING SHALL BE IN ACCORDANCE WITH THE APPLICABLE PROVISIONS OF THE CENTERLINE OF THE SUPPORTS STATE OF ILLINOIS "STANDARD SPECIFICATIONS FOR ROAD AND BRIDGE CONSTRUCTION ADOPTED JAN. 1, 2022", " THE QUALITY STANDARD FOR WORK ZONE END 16. THE ROAD NAME SIGN SHALL HAVE A BLACK LEGEND ON FLUORESCENT ORANGE (12) 2 TRAFFIC CONTROL DEVICES ADOPTED 2010", THE DETAILS IN THESE PLANS, THE M4-8a(0)-2418DETOUR REFLECTIVE SHEETING AND STANDARD BLACK BORDERS. THE SIGN BLANK SHALL BE A DETOUR (1) LATEST EDITION OF THE STATE OF ILLINOIS "MANUAL OF UNIFORM TRAFFIC CONTROL W20-2(0)-488 **AHEAD** 9" X VARIABLE OR A 12" X VARIABLE WITH DESIGN SERIES C LETTERS. THE CAPITAL LETTERS SHALL BE 6" WITH 4.5" LOWER CASE. 2. THE ENGINEER SHALL BE NOTIFIED IN WRITING AT LEAST THREE WEEKS PRIOR TO THE 17. CONSTRUCTION EQUIPMENT SHALL NOT BE PARKED IMMEDIATELY BEHIND THE TYPE Fish Lake Rd SPECIAL(O)-VARIABLE 41 DAY THE DETOUR IS TO BE IN EFFECT. THE ENGINEER SHALL DETERMINE THE HOUR OF III BARRICADES DURING NON-WORKING HOURS. IN ANY EVENT ARTICLE 701.04 OF CLOSURE. THE ENGINEER WILL CONTACT THE APPROPRIATE LOCAL AGENCIES AND THE "STANDARD SPECIFICATIONS" SHALL APPLY. (2) CLOSED W20-3(0)-482 Fish Lake Rd CLOSED SOUTH O 18. THE CONTRACTOR SHALL BE RESPONSIBLE FOR MAINTAINING THE VISIBILITY OF ALL IF DEEMED NECESSARY BY THE ENGINEER A PRE-CONSTRUCTION MEETING WITH THE (14) SPECIAL(0)-6030 9 Nippersink Rd USE Wilson Rd DETOUR AND CONSTRUCTION SIGNING, INCLUDING BRUSHING BACK VEGETATION IF CONTRACTOR SHALL BE HELD AT LEAST TWO WEEKS PRIOR TO THE DAY THE DETOUR DEEMED NECESSARY BY THE ENGINEER. IS TO BE IN EFFECT. 19. THE FOLLOWING ILLINOIS DEPARTMENT OF TRANSPORTATION STANDARD IS THE CONTRACTOR SHALL SUPPLY TO THE ENGINEER THE NAMES AND TELEPHONE ROAD NORTH M3-1(0)-2412 16 NUMBERS OF HIS REPRESENTATIVES ON THE CONSTRUCTION SITE AND HIS APPLICABLE FOR THIS WORK: 3 CLOSED W20-3(0)-48 REPRESENTATIVE RESPONSIBLE FOR THE DETOUR SIGNING PRIOR TO THE START OF STANDARD 701901 THE WORK. THE VILLAGE OF VOLO REPRESENTATIVE FOR THIS DETOUR IS: MICHAEL MAY (16) SOUTH M3-3(0)-241217 20. THE ENGINEER SHALL BE NOTIFIED AT LEAST TWO HOURS BEFORE THE ROAD IS TO BE VILLAGE OF VOLO OPENED TO TRAFFIC THE ENGINEER WILL CONTACT THE APPROPRIATE LOCAL VILLAGE ADMINISTRATOR ROAD CLOSED AGENCIES AND INTERESTED PARTIES. 500 S. FISH LAKE ROAD 4 R11-4-6030 12 TO VOLO. ILLINOIS 60073 THRU TRAFFIC 21. THE CONTRACTOR SHALL CONTACT KALPANA KANNAN-HOSADURGA, (847) 740-6982 THE DISTRICT ONE TRAFFIC CONTROL SUPERVISOR, AT KALPANA.KANNAN-HOSADURGA@ILLINOIS.GOV A MINIMUM OF 72 HOURS IN IF REQUESTED BY THE CONTRACTOR IN WRITING AT LEAST THREE WEEKS PRIOR TO ADVANCE OF BEGINNING WORK. THE DAY THE DETOUR IS TO BE IN EFFECT THE ENGINEER WILL FIELD LOCATE THE (5) DETOUR M4-10L(0)-4818 **2** POSITIONS OF ANY SIGNS. 22. THE DURATION OF THE DETOUR SHALL NOT EXCEED 80 WORKING DAYS. THE PENALTY FOR EXCEEDING THE DURATION SHALL BE \$2,000 PER WORKING DAY. 6. LONGITUDINAL DIMENSIONS SHOWN ON THESE PLANS MAY BE ADJUSTED TO FIT FIELD CONDITIONS, WITH THE APPROVAL OF THE ENGINEER. 23. THE DETOUR SHALL ONLY BE IN USE DURING THE FULL-DEPTH RECLAMATION AND **(6)** M4-10R(0)-4818 1 REGRADING OF THE STONE BASE PORTION OF THE PROJECT. URBAN LANE CLOSURE 7. THE ROAD SHALL NOT BE CLOSED UNTIL ALL SIGNING IS ERECTED IN ACCORDANCE (STANDARD 701501) SHALL BE USED WHEN THE DETOUR IS NOT IN PLACE. WITH THE DETOUR PLAN AND INSPECTED AND APPROVED BY THE ENGINEER. 24. TEMPORARY INFORMATION SIGNS ON TEMPORARY SUPPORTS SHALL BE PROVIDED 8. THE TRAFFIC CONTROL SHOWN ON THE DETOUR PLAN IS THE MINIMUM NECESSARY FOR ALL COMMERCIAL DRIVEWAYS THAT ARE LOCATED WITHIN A WORK AREA. THIS TO ENSURE THIS ROAD CLOSURE. THE CONTRACTOR SHALL MAKE ALL CHANGES IN WORK SHALL BE PAID FOR PER DISTRICT 1 DETAIL TC-26. THESE SIGNS SHALL BE 15 M4-9(0)-3021TRAFFIC CONTROL THAT IS DEEMED NECESSARY BY THE ENGINEER, ADDITIONS AND RELOCATED AS REQUIRED FOR EACH CONSTRUCTION STAGE AND SHALL BE PLACED AS DELETIONS OF TRAFFIC CONTROL FOR THIS DETOUR SHALL BE CONSIDERED INCLUDED DIRECTED BY THE ENGINEER. THIS SIGN RELOCATION WORK WILL NOT BE PAID FOR IN THE COST OF THE PAY ITEM "TRAFFIC CONTROL AND PROTECTION". SEPARATELY AND SHALL BE INCLUDED IN THE CONTRACT UNIT PRICE PER SQUARE FOOT FOR TEMPORARY INFORMATION SIGNING. **DETOUR** ALL EXISTING SIGNING THAT IS NOT APPLICABLE WHILE THE DETOUR IS IN EFFECT (8) M4-9R(0)-3021 6 SHALL BE COMPLETELY COVERED BY THE CONTRACTOR, IN A MANNER APPROVED BY THE ENGINEER. 10. ALL DETOUR SIGNING SHALL BE POST MOUNTED. **DETOUR** (9) M4-9R(0)-3021 6 11. ALL DETOUR SIGNING EXCEPT REGULATORY SIGNS SHALL HAVE BLACK LEGENDS ON FLUORESCENT ORANGE SHEETING AND STANDARD BLACK BORDERS. THE FLUORESCENT ORANGE REFLECTIVE SHEETING SHALL MEET THE REQUIREMENTS OF SECTION 1091 OF THE "STANDARD SPECIFICATIONS". ALL DETOUR SIGNING SHALL BE NEW OR LIKE NEW CONDITION. THE ENGINEER SHALL BE THE SOLE JUDGE OF THE **DETOUR** (10) M4-9L(0)-3021 3 CONDITION OF THE SIGNS. 12. THE SIZES OF ALL SIGNS NOT SPECIFIED IN THESE PLANS SHALL BE AS REQUIRED BY THE ILLINOIS MANUAL ON UNIFORM TRAFFIC CONTROL DEVICES. **DETOUR** (11)M4-9L(0)-3021 3 13. WHEN REQUIRED THE MINIMUM DIMENSIONS OF THE ORANGE WARNING FLAGS SHOWN IN THESE PLANS ARE 18" X 18". 14. ALL BARRICADES SHALL HAVE REFLECTORIZED STRIPING ON BOTH SIDES OF THE BARRICADES. THE TYPE III BARRICADES USED AT THE POINT OF CLOSURE TO THRU TRAFFIC SHALL NOT EXCEED 8 FEET IN WIDTH EACH, FOR A SINGLE APPROACH LANE. 15. THE "ROAD CLOSED" (R11-2), THE "ROAD CLOSED XX MILES AHEAD LOCAL TRAFFIC ONLY" (R11-3) AND THE "ROAD CLOSED TO THRU TRAFFIC" (R11-4) SIGNS SHALL BE MOUNTED ABOVE THE TOP OF THE BARRICADE. ALL TYPE III BARRICADES SHALL HAVE TWO (2) AMBER TYPE A-LOW INTENSITY FLASHING LIGHTS SPACED NEAR THE

	FILE NAME = 5867.200_Sht-DETOUR PLAN.dw	USER NAME = MARK COBB	DESIGNED -	MGFC	REVISED -			DETOUR PLAN GEN	FRAI N	OTES	RTE	SECTION	COUNTY	SHEETS	NO.
			DRAWN -	MGFC	REVISED -	STATE OF ILLINOIS					0163	15-08113-05-CH	LAKE	112	37
	PLOT SCALE = 1" = .0833'	CHECKED -	DPB	REVISED -	DEPARTMENT OF TRANSPORTATION	FISH LAKE ROAD IMPROVEMENTS				0.00	10 00110 00 011	CONTRACT	# 61	K10	
		PLOT DATE = 1/16/2024 10:14 AM	DATE -	12/18/2023	REVISED -		SCALE: N.T.S.	SHEET NO. 1 OF 3 SHEETS	STA.	TO STA.	1	ILLINOIS FED. AI	D PROJECT	***	

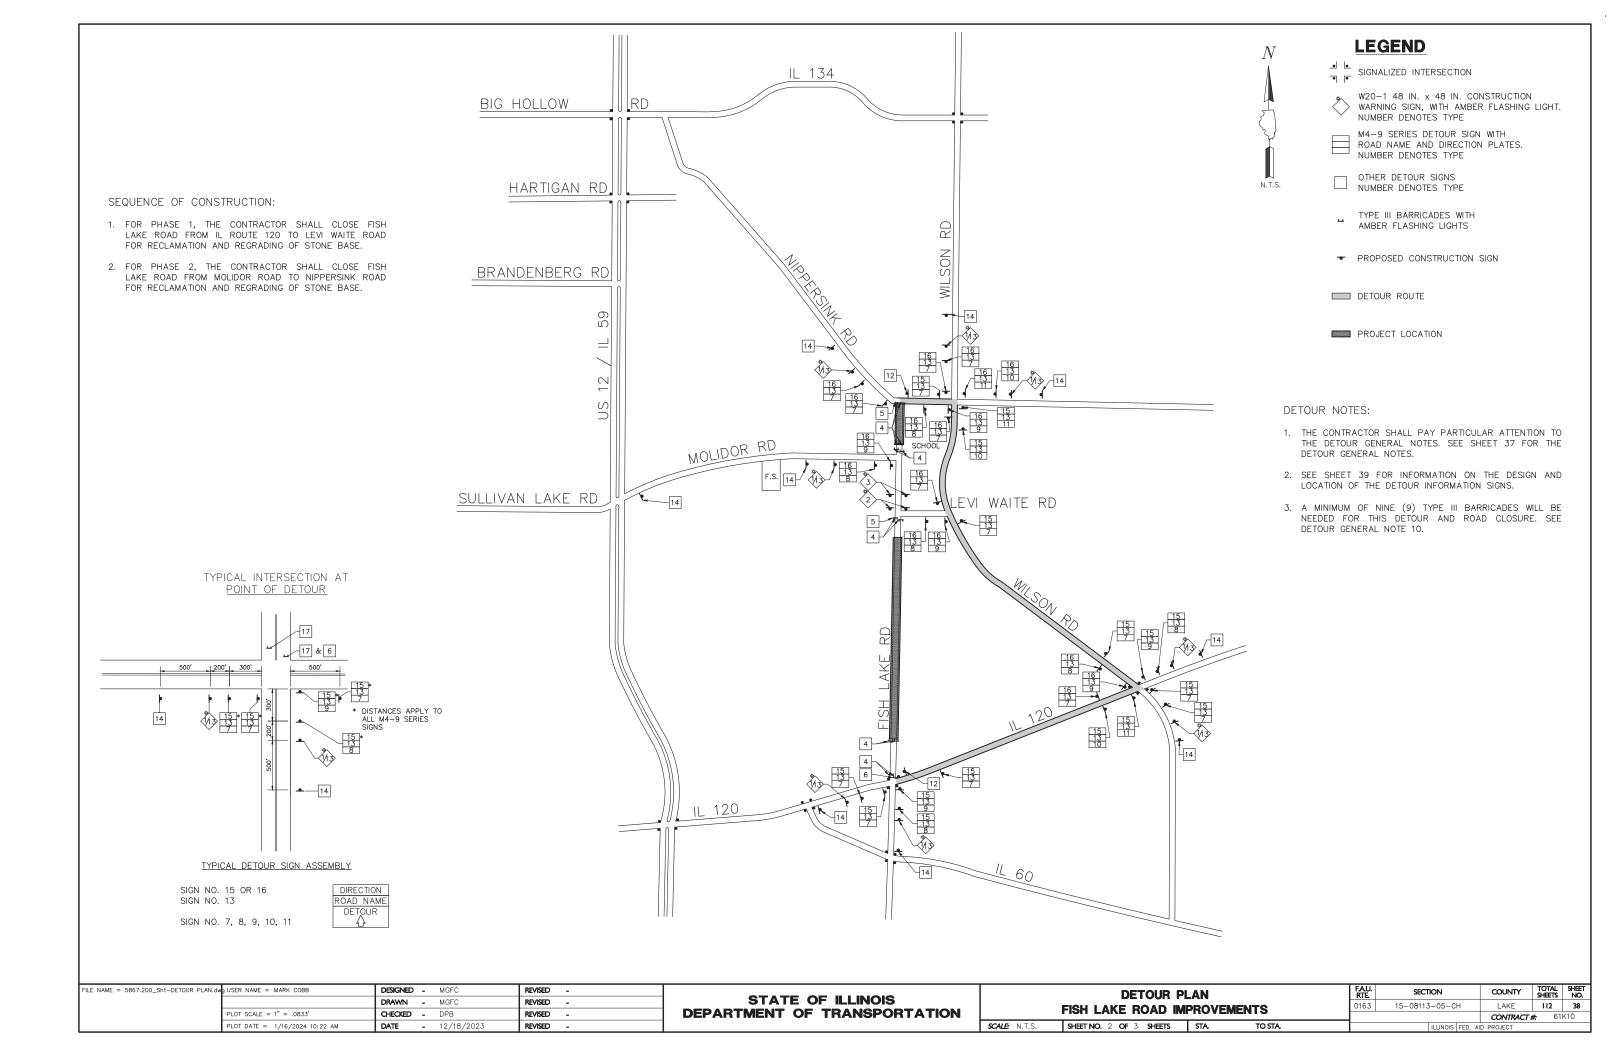

NUMBER OF SIGNS 8

Fish Lake Road
WILL BE CLOSED
FROM JUNE 1
TO OCT. 1

DATES SHOWN ARE FOR EXAMPLE ONLY

ROAD NAME BLANK: 6" BY 45" FLUORESCENT
ORANGE REFLECTIVE SHEETING WITH 5" BLACK
SERIES C UPPER CASE LETTERS

DATE BLANK: 6" BY 24"
FLUORESCENT ORANGE REFLECTIVE SHEETING
WITH 5" BLACK SERIES C UPPER CASE
LETTERS

DATE BLANK: 6" BY 24"
FLUORESCENT ORANGE REFLECTIVE SHEETING
WITH 5" BLACK SERIES C UPPER CASE
LETTERS

F
LETTERS

F
LETTERS

E

LETTERS

DIMENSIONS
(ENGLISH)

A 48"

B 36"

C 5/8"

D 7/8"

E 41/8"

F 5"

G 25/8"

H 93/4"

NOTE: SIGN SHEETING SHALL BE FLUORESCENT ORANGE WITH 5 INCH (125 mm) BLACK SERIES C LETTERS

LOCATIONS OF PRE-DETOUR INFORMATION SIGNS BY INTERSECTION

N.B. FISH LAKE ROAD APPROACHING NIPPERSINK ROAD

E.B. NIPPERSINK ROAD APPROACHING FISH LAKE ROAD

W.B. NIPPERSINK ROAD APPROACHING FISH LAKE ROAD

E.B. MOLIDOR ROAD APPROACHING FISH LAKE ROAD

N.B. FISH LAKE ROAD APPROACHING IL RTE. 120

E.B. IL RTE. 120 APPROACHING FISH LAKE ROAD


S.B. FISH LAKE ROAD APPROACHING IL RTE. 120

W.B. IL RTE. 120 APPROACHING FISH LAKE ROAD


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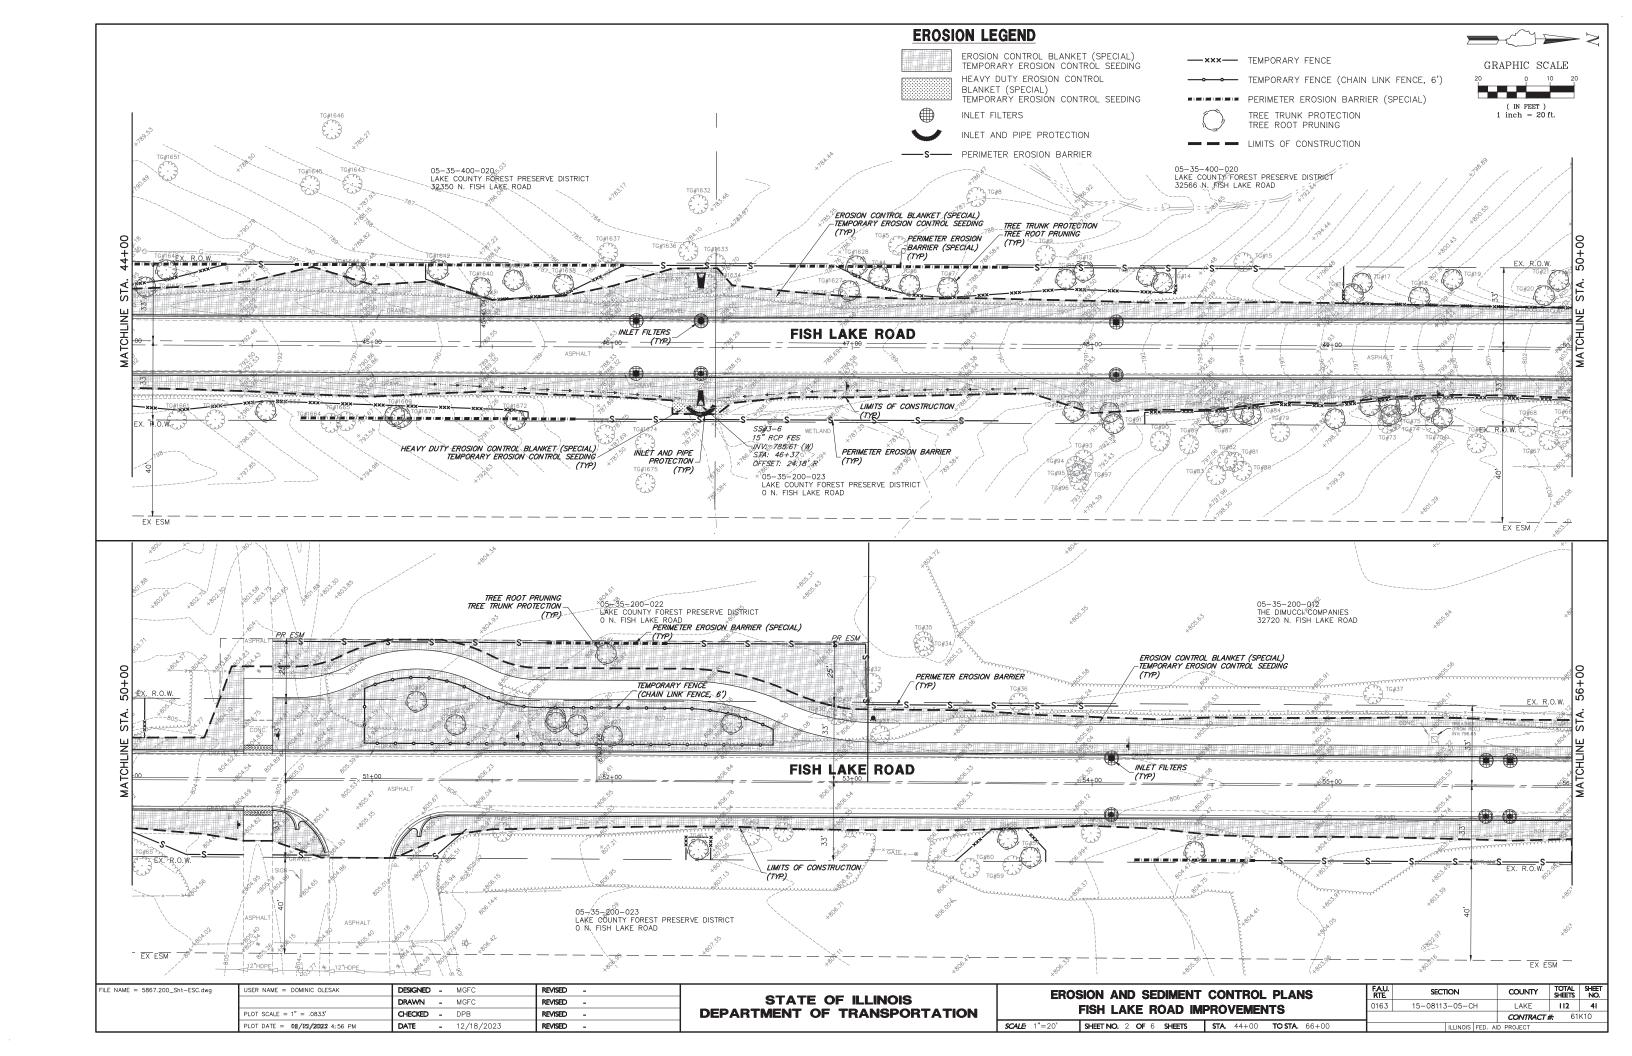
THESE SIGNS SHALL BE INSTALLED 14
CALENDAR DAYS PRIOR TO THE DETOUR
AND ROAD CLOSURE. THE SIGNS SHALL BE
REMOVED THE DAY THE DETOUR BEGINS.


SIGN LAYOUT FOR PRE—DETOUR
INFORMATION SIGNS AT THE
INTERSECTION OF IL RTE. 120 AND FISH
LAKE ROAD SHALL BE INSTALLED IN
SIMILAR FASHION. SIGNS AT THE
INTERSECTION OF MOLIDOR ROAD AND
FISH LAKE ROAD SHALL BE INSTALLED
IN SIMILAR FASHION.

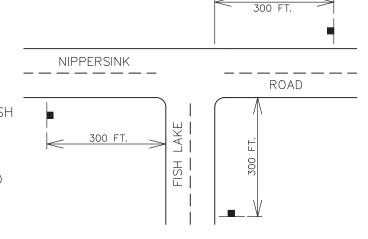



FILE NAME = 5867.200_Sht-DETOUR	PLAN.dwg USER NAME = DOMINIC OLESAK	DESIGNED - MGFC	REVISED -			DETOUR PLAN SI	GN SHFI	FT	FAU.	SECTION	COUNTY	TOTAL SHEET SHEETS NO.
		DRAWN - MGFC	REVISED -	STATE OF ILLINOIS					0163	15-08113-05-CH	LAKE	112 39
	PLOT SCALE = 1" = .0833'	CHECKED - DPB	REVISED -	DEPARTMENT OF TRANSPORTATION		FISH LAKE ROAD IMPROVEMENTS					CONTRACT	Γ# : 61K10
	PLOT DATE = 12/15/2023 4:15 PM	DATE - 12/18/2023	REVISED -		SCALE: N.T.S. SHEET NO. 3 OF 3 SHEETS STA. TO STA.					ILLINOIS FED.	AID PROJECT	




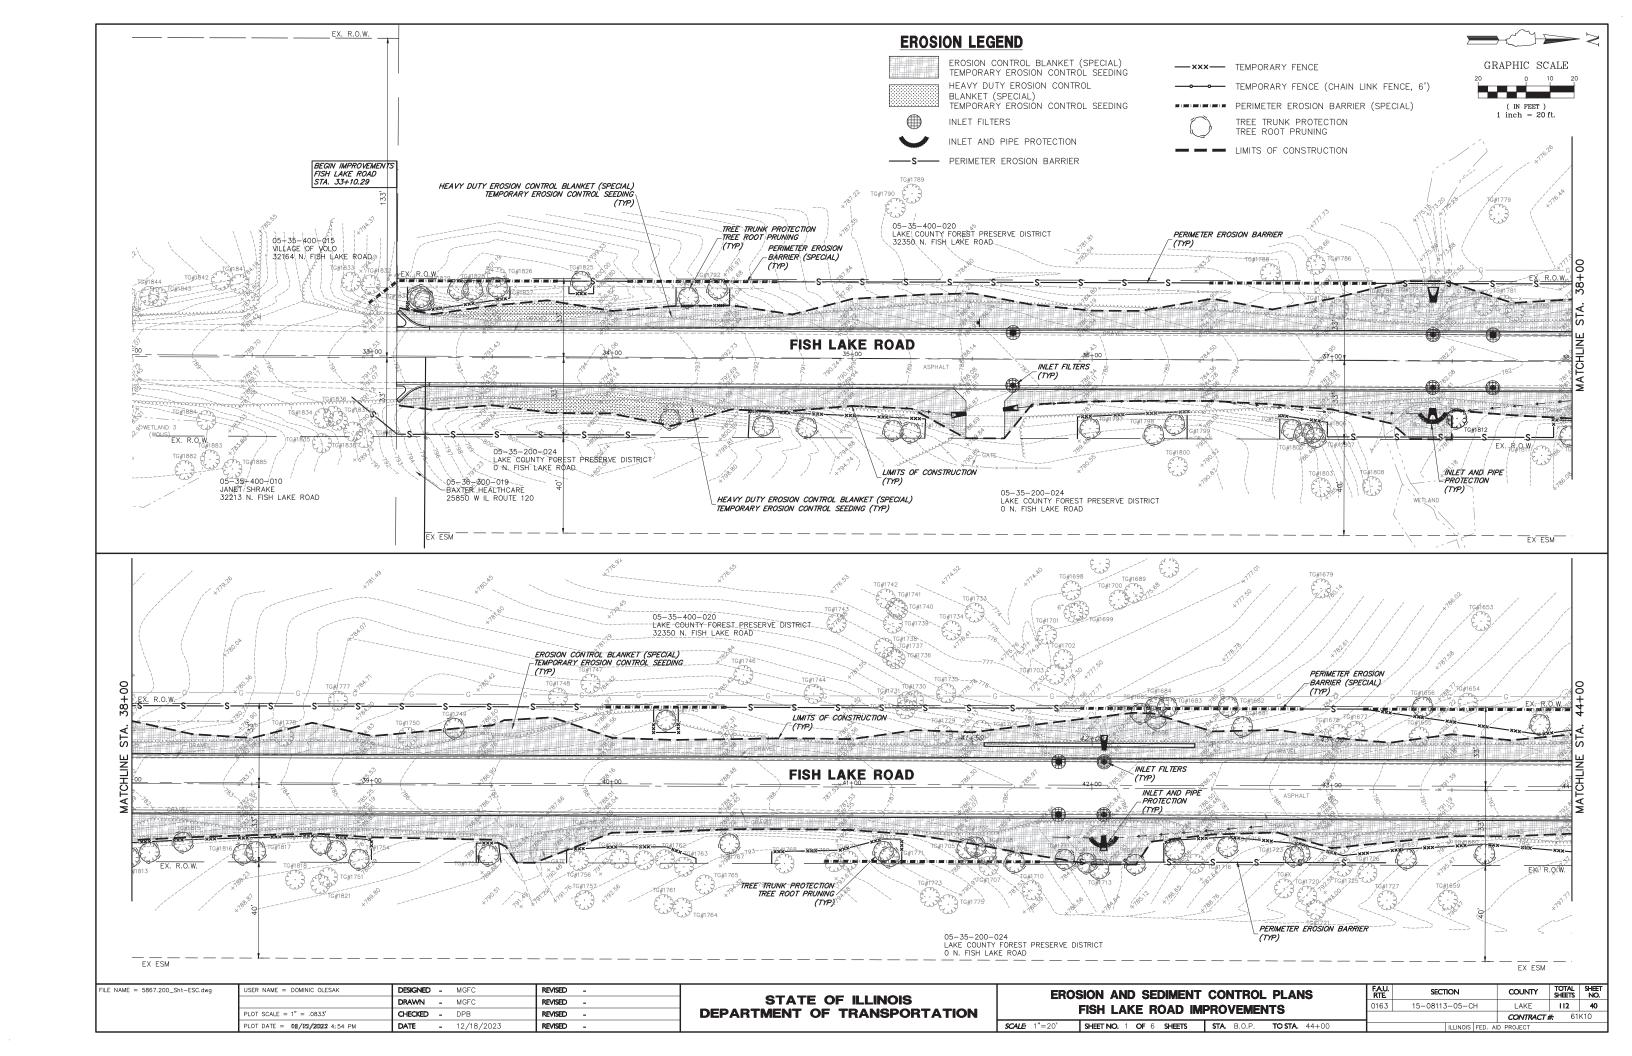


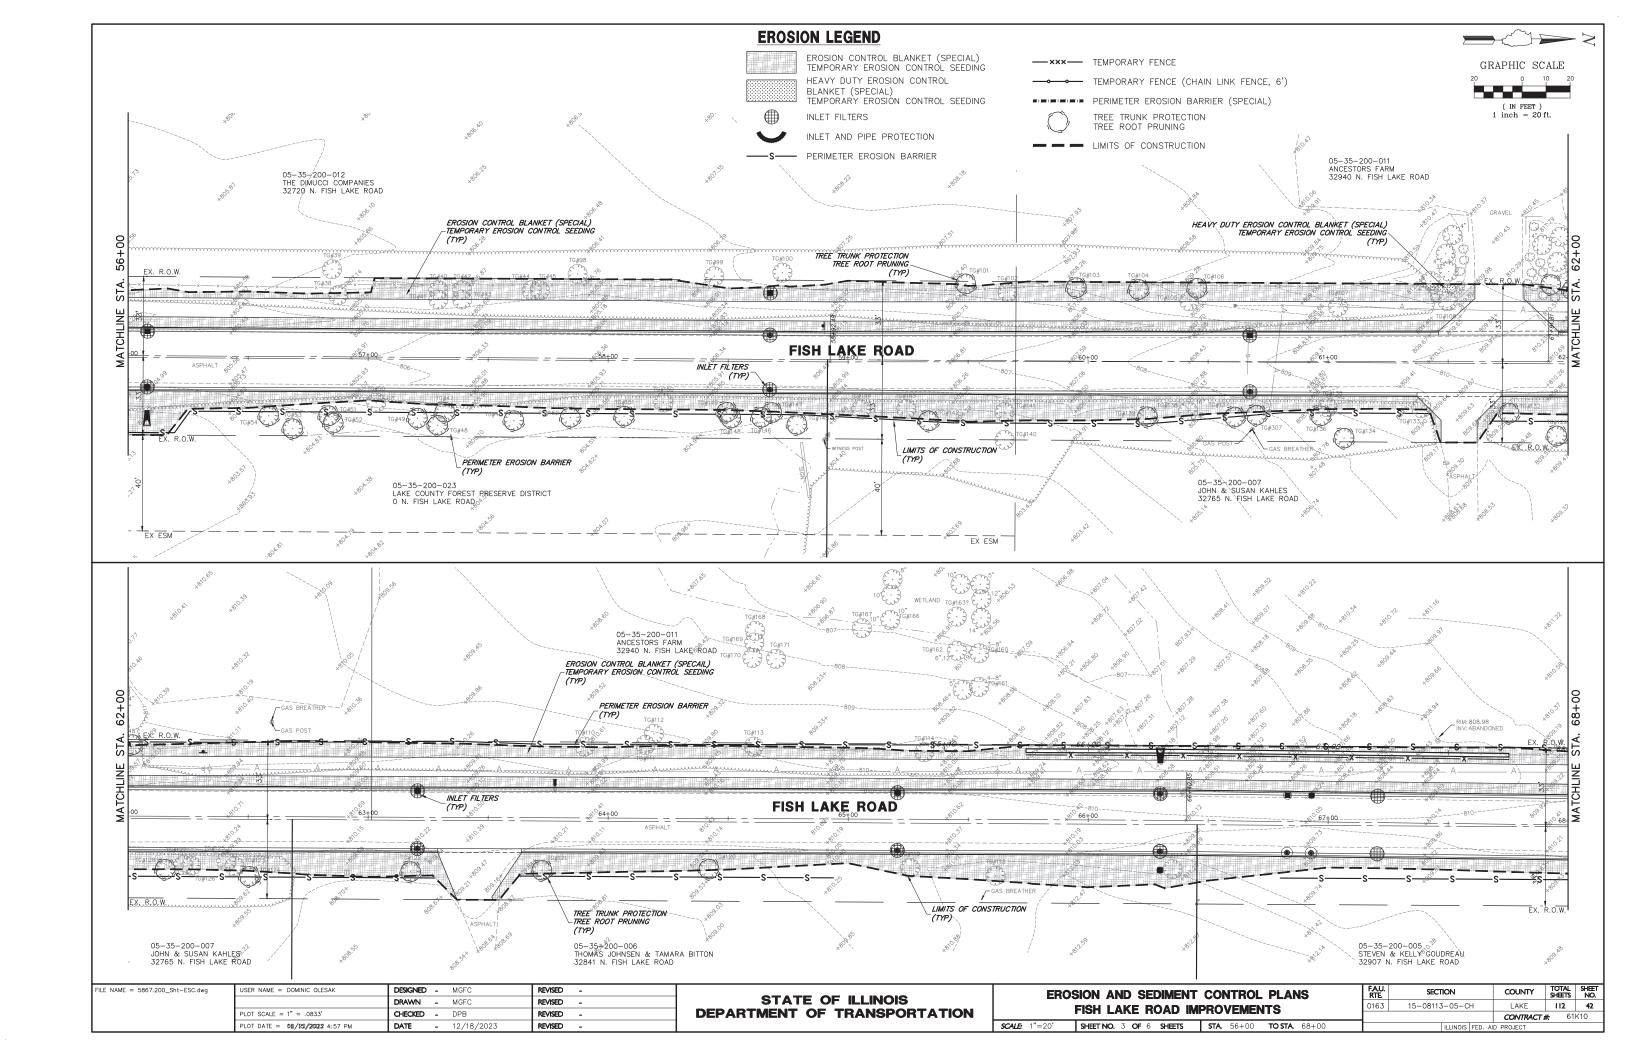


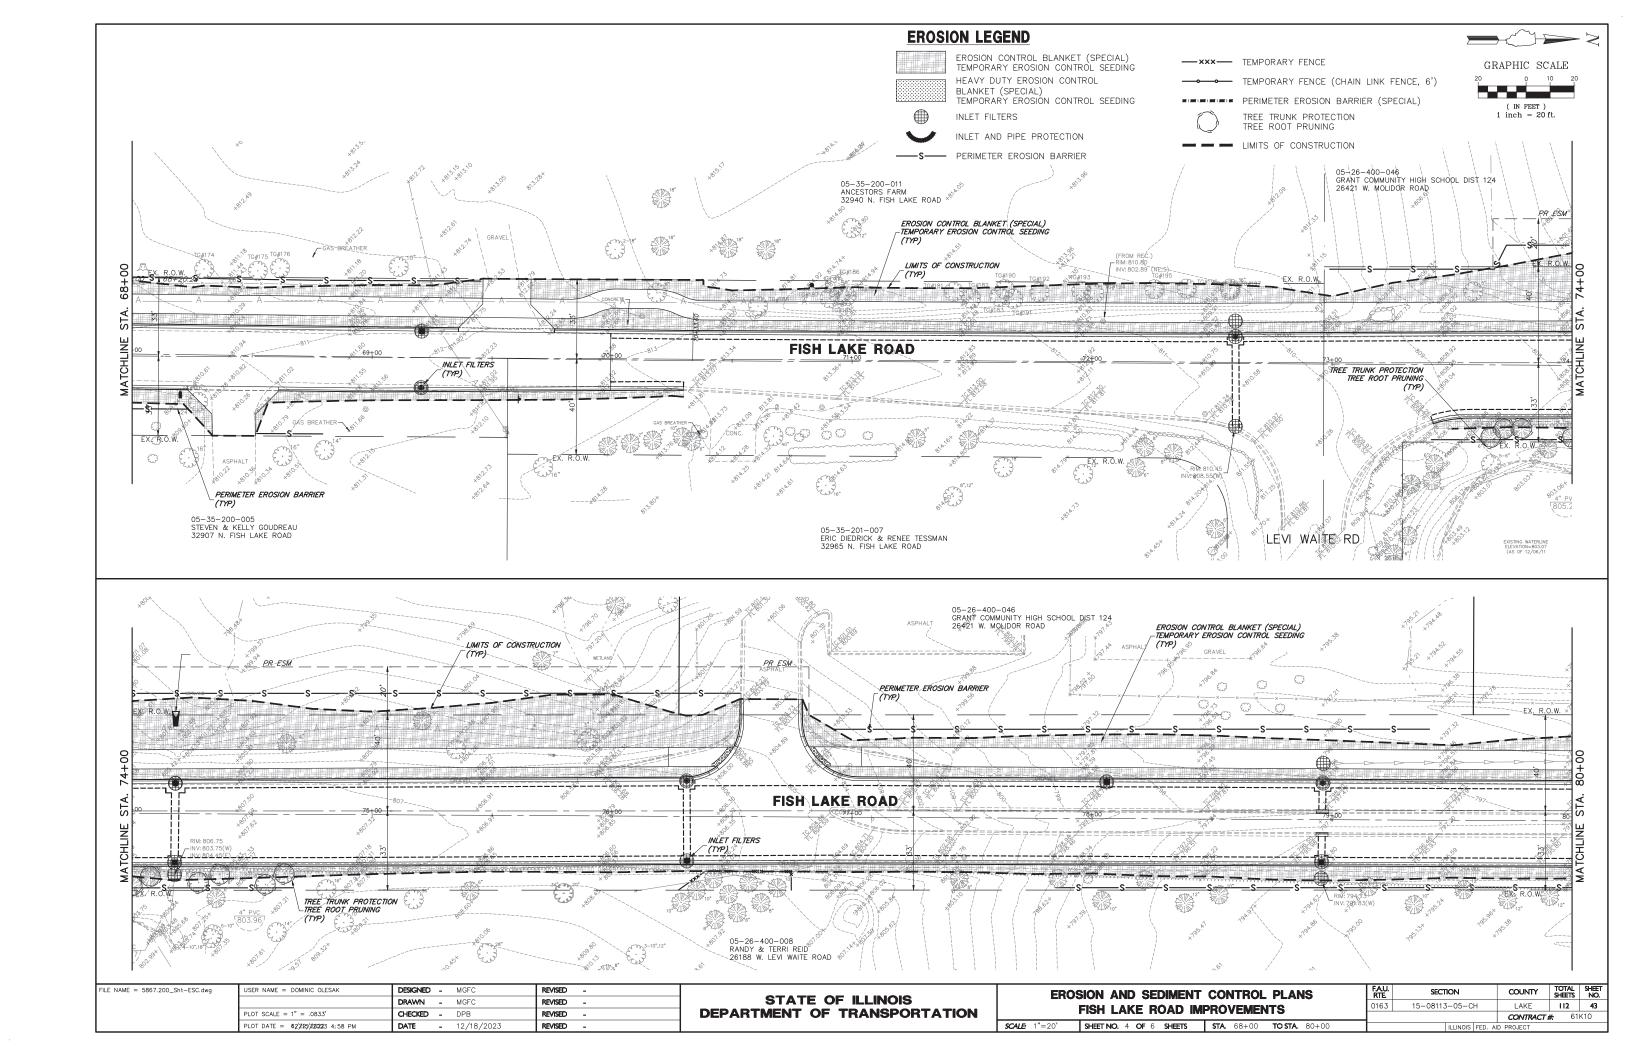


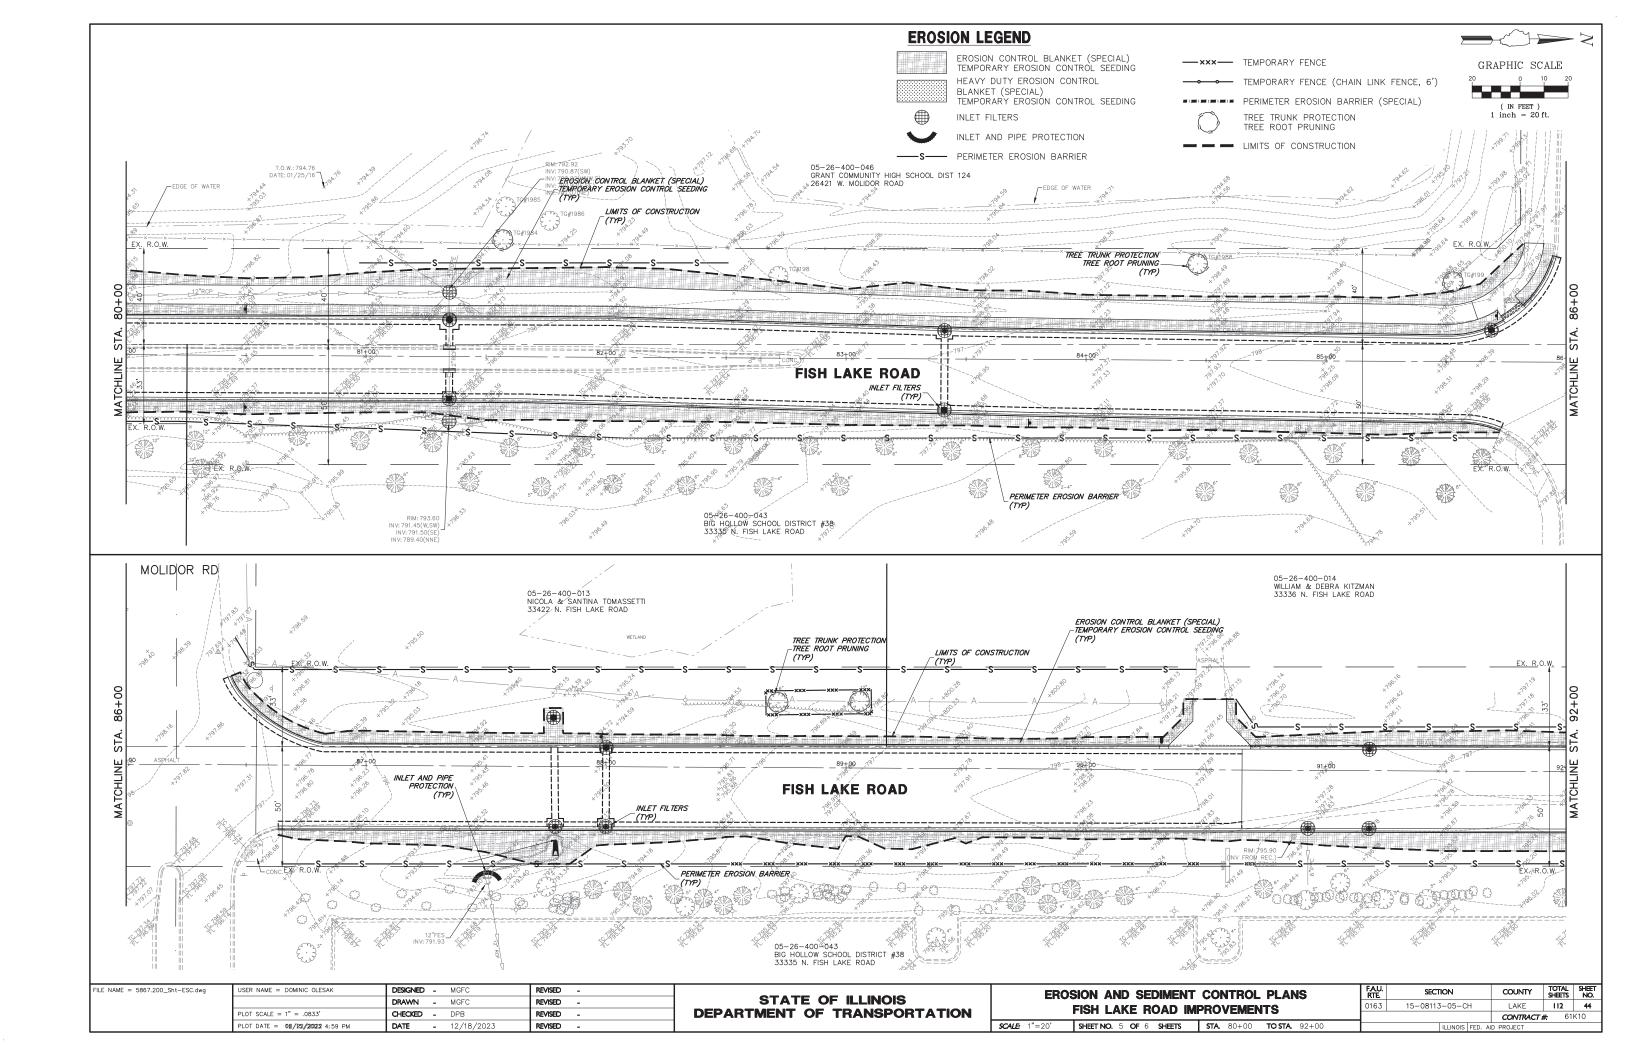


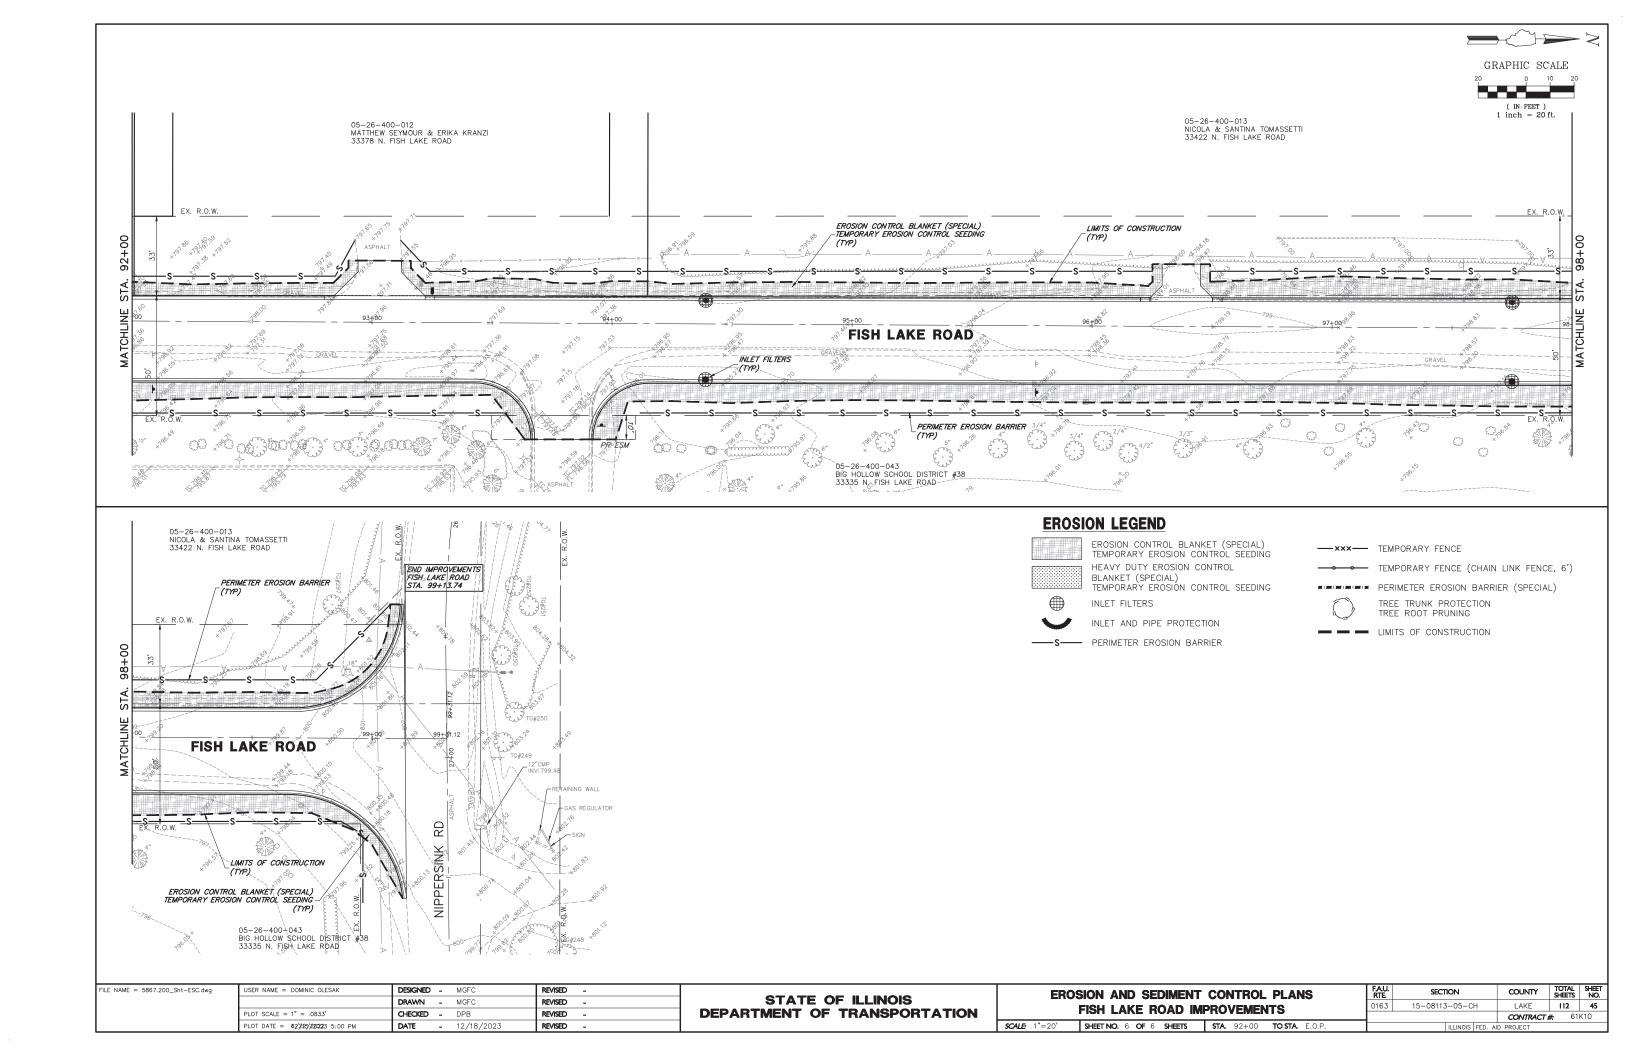


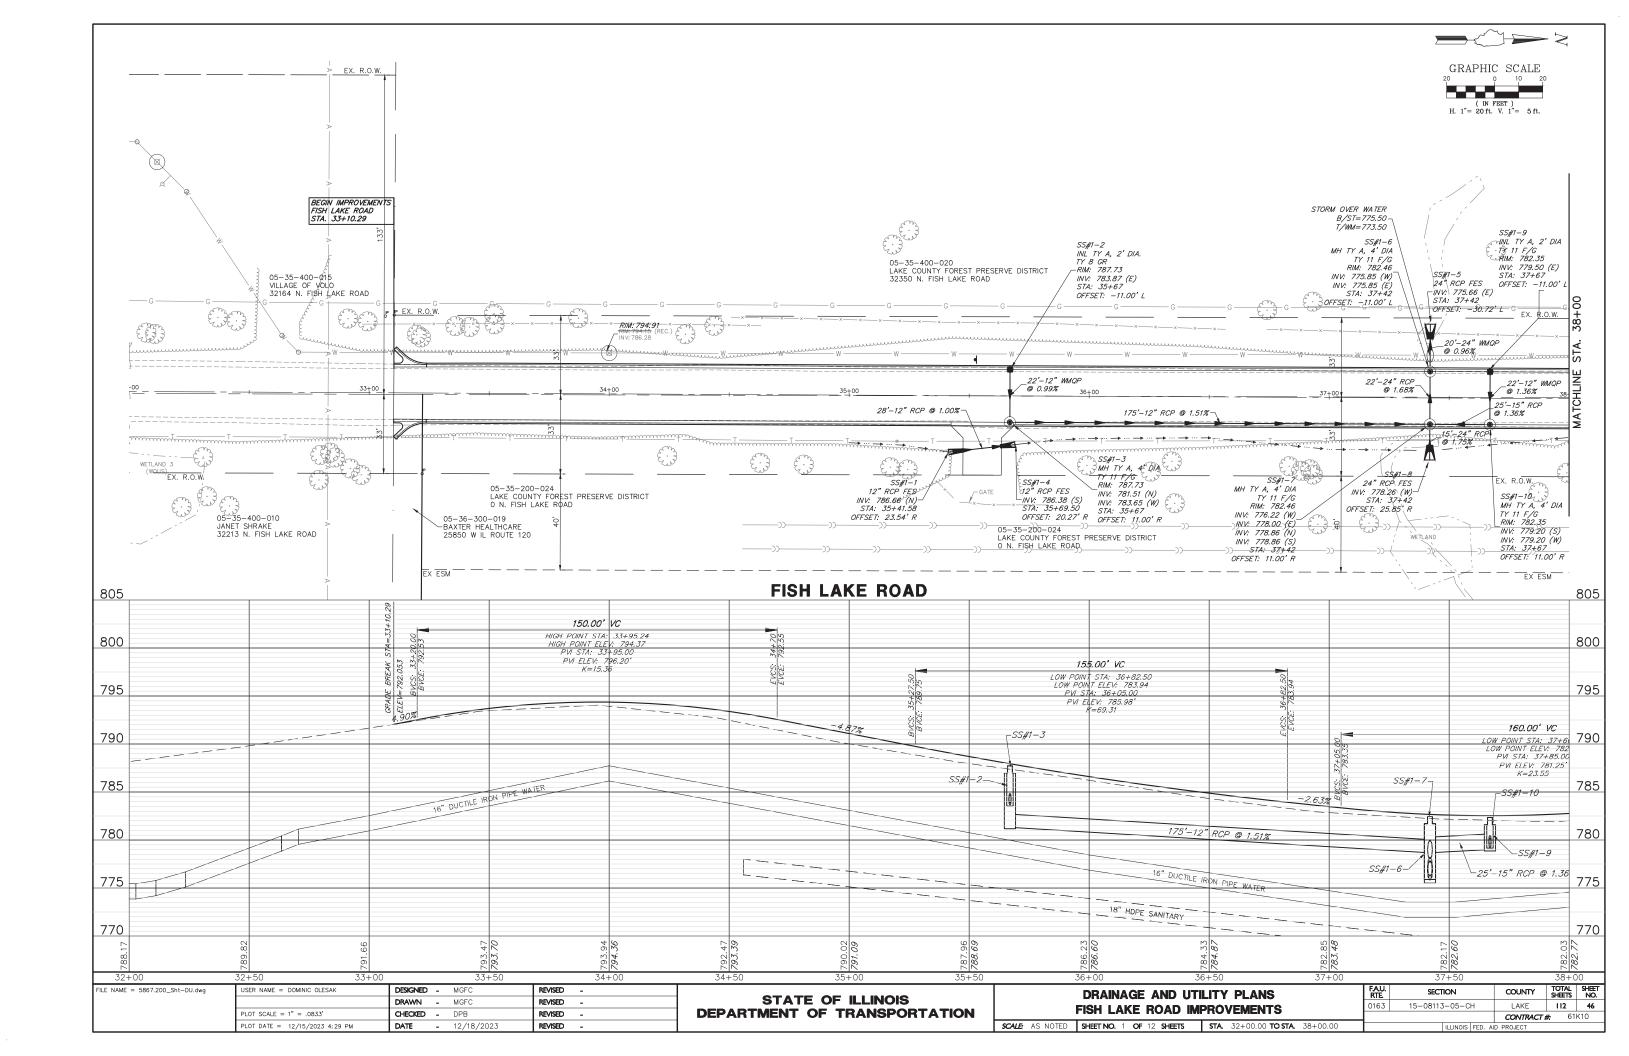


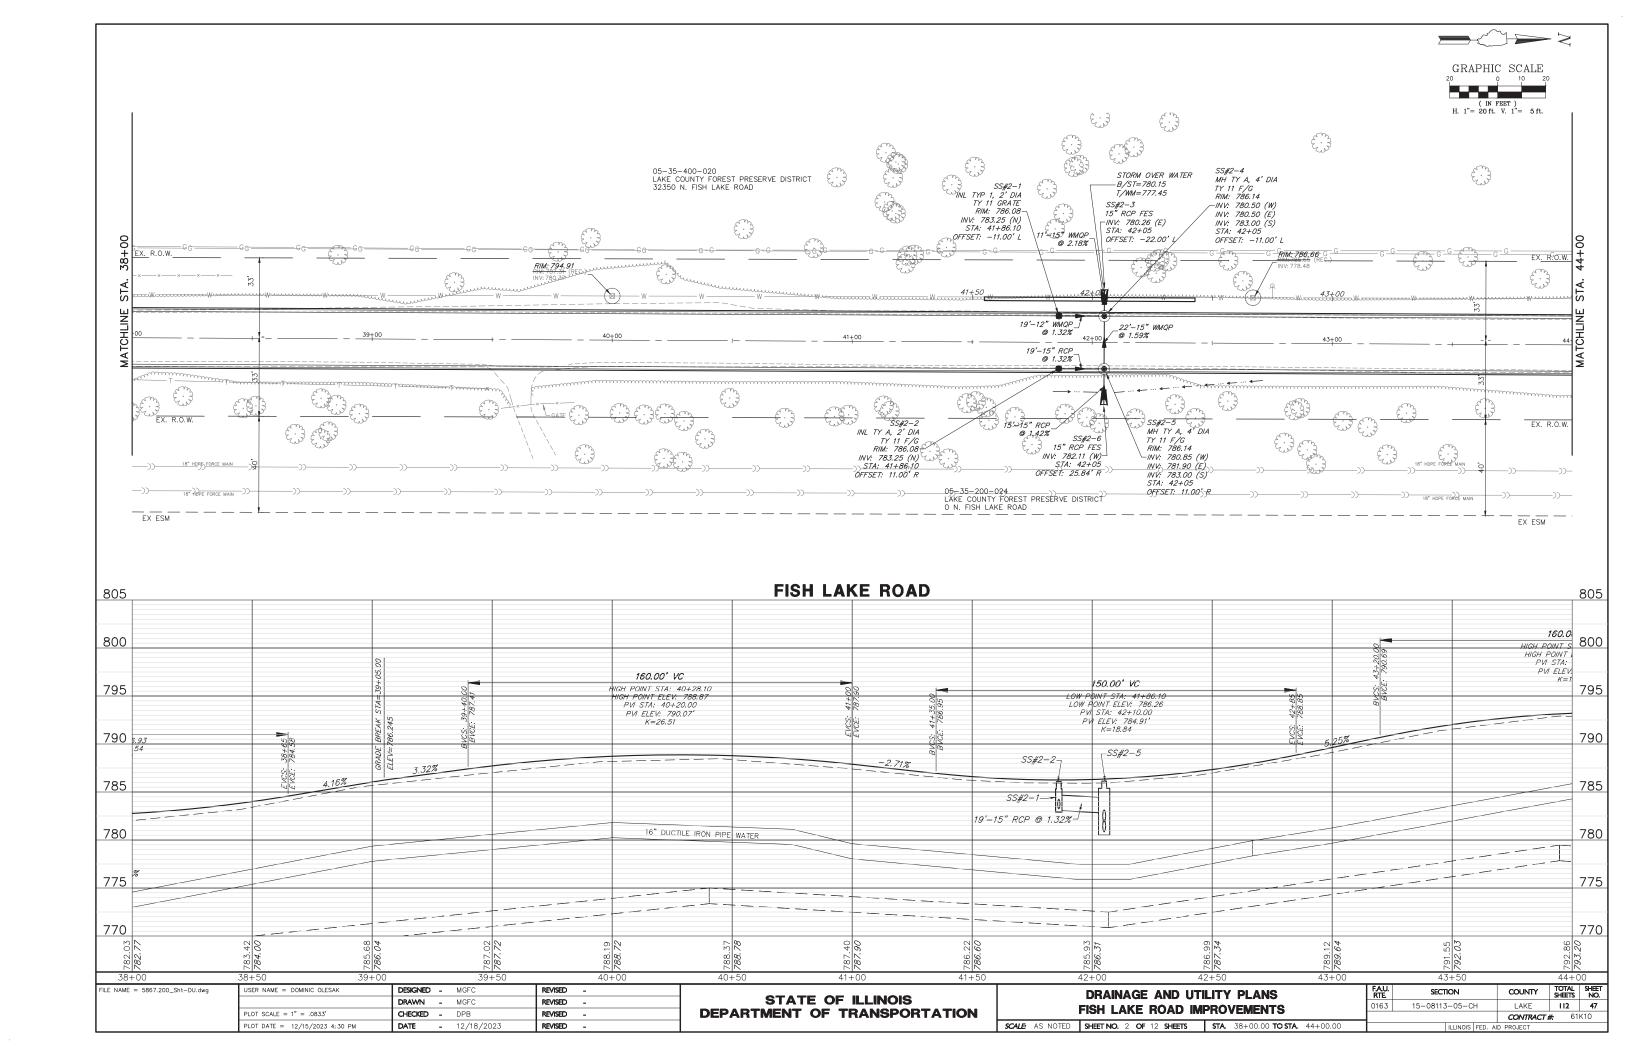


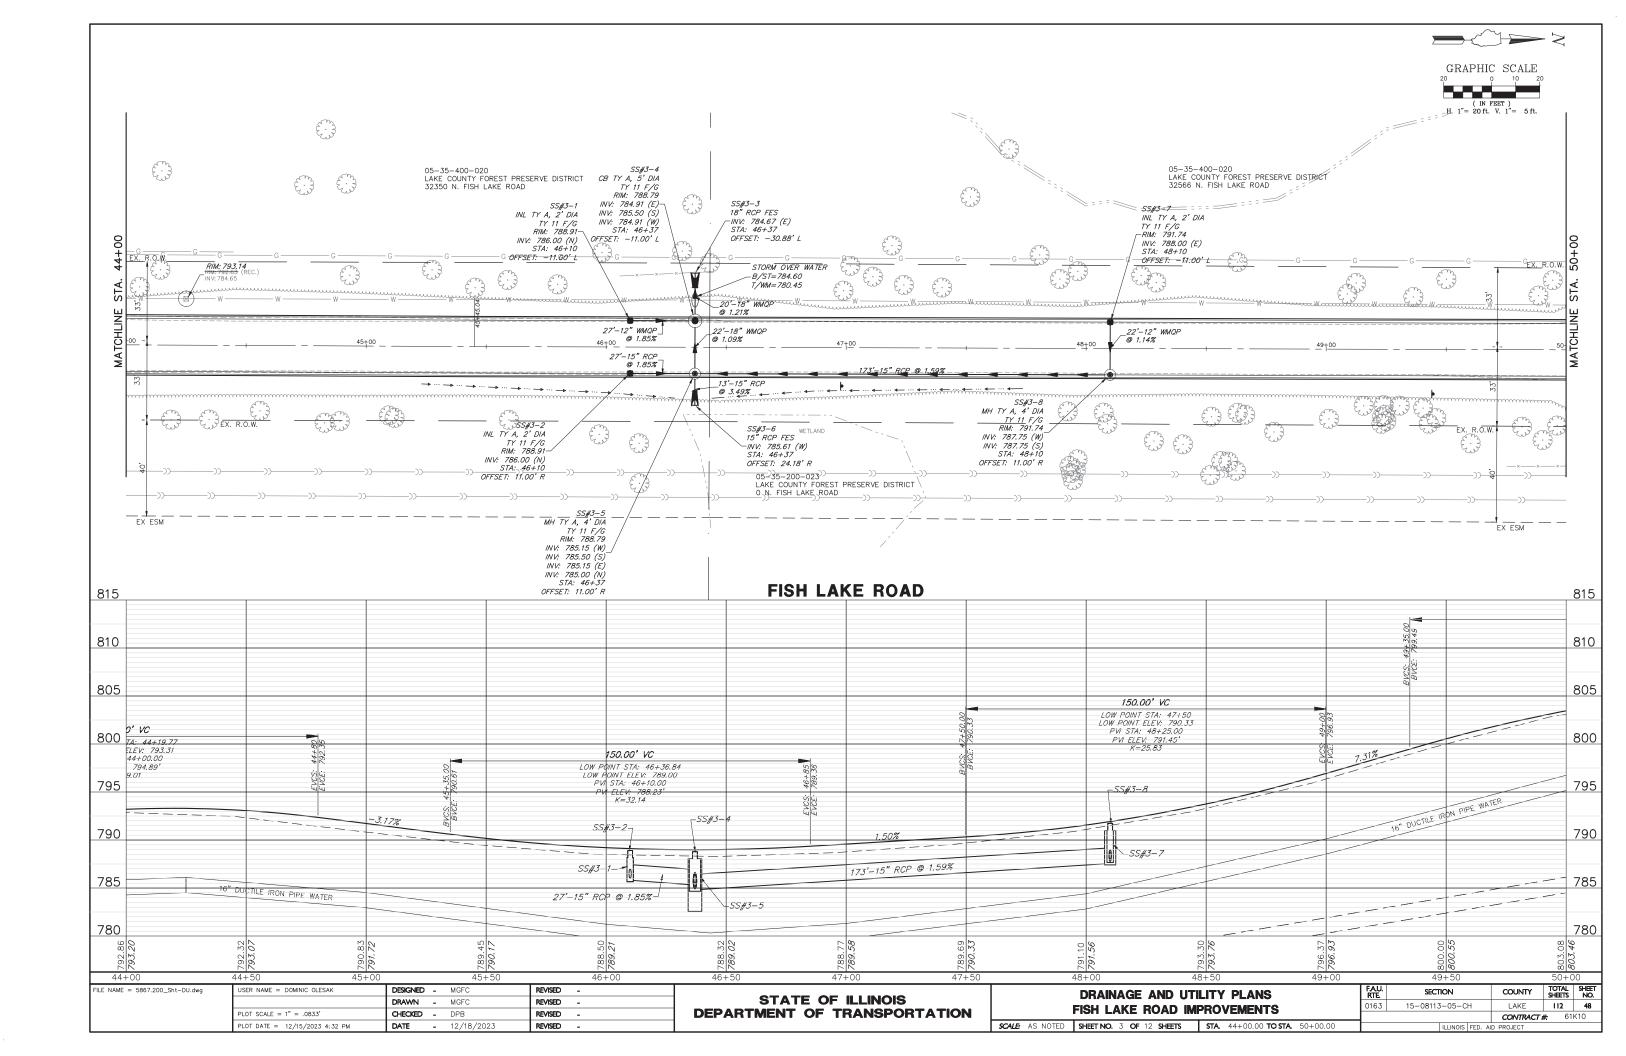


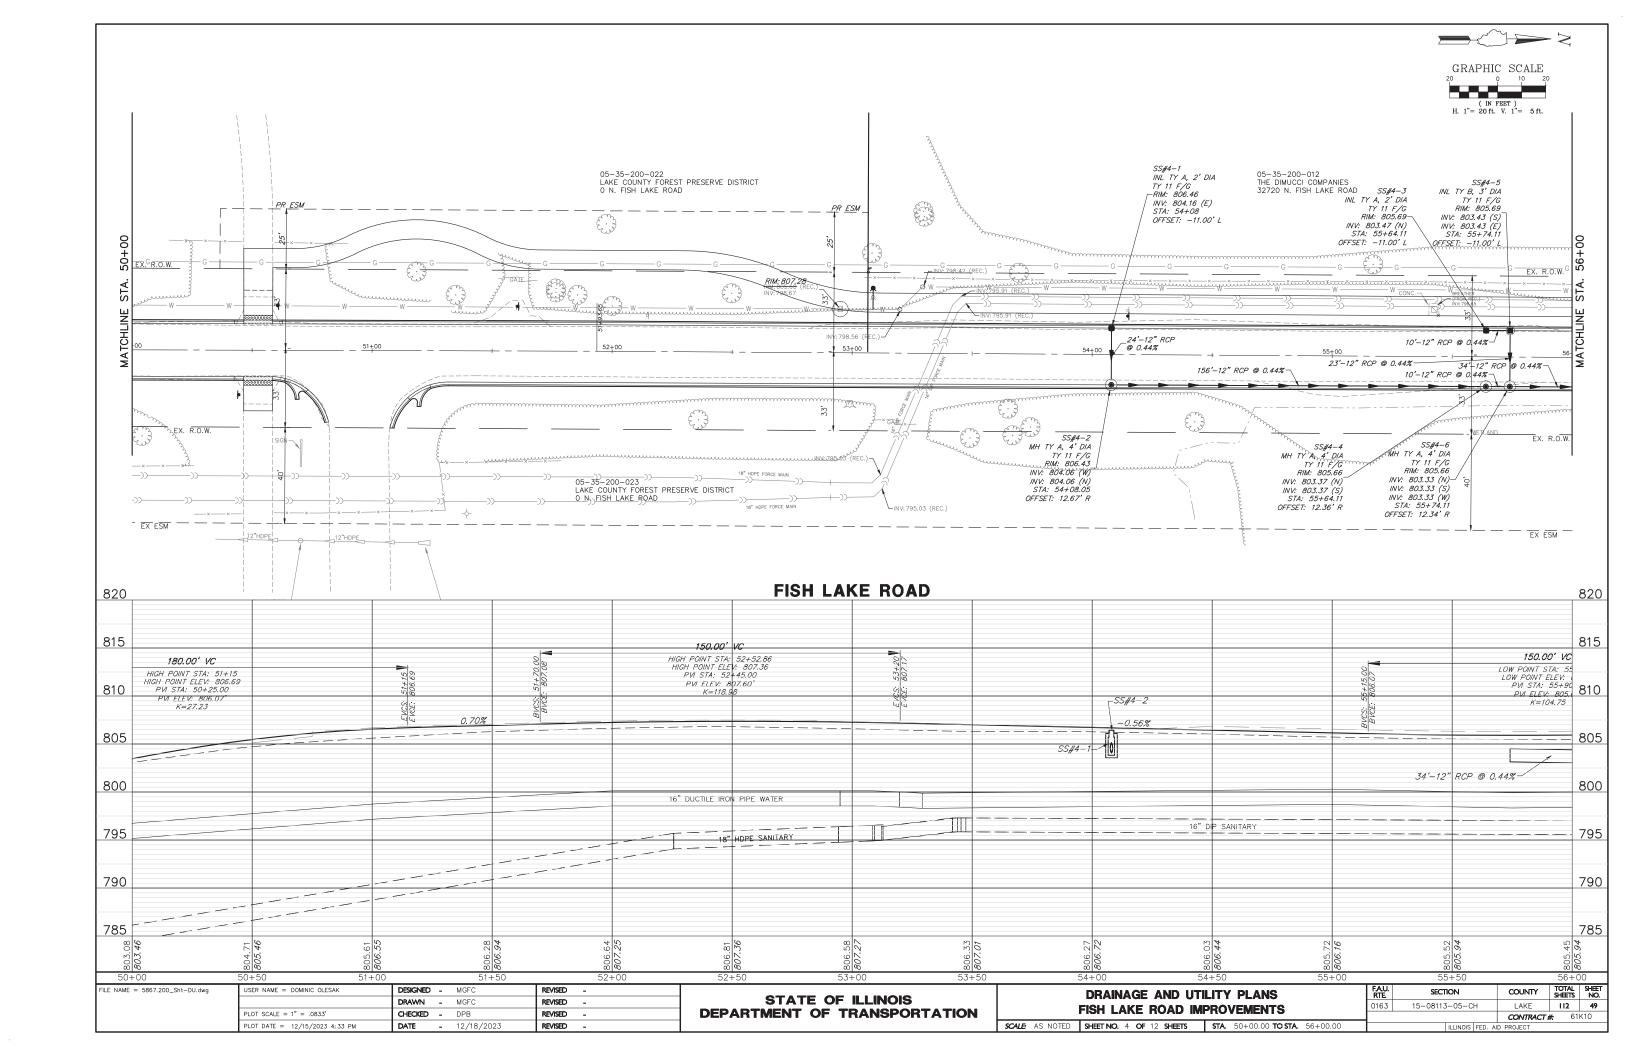


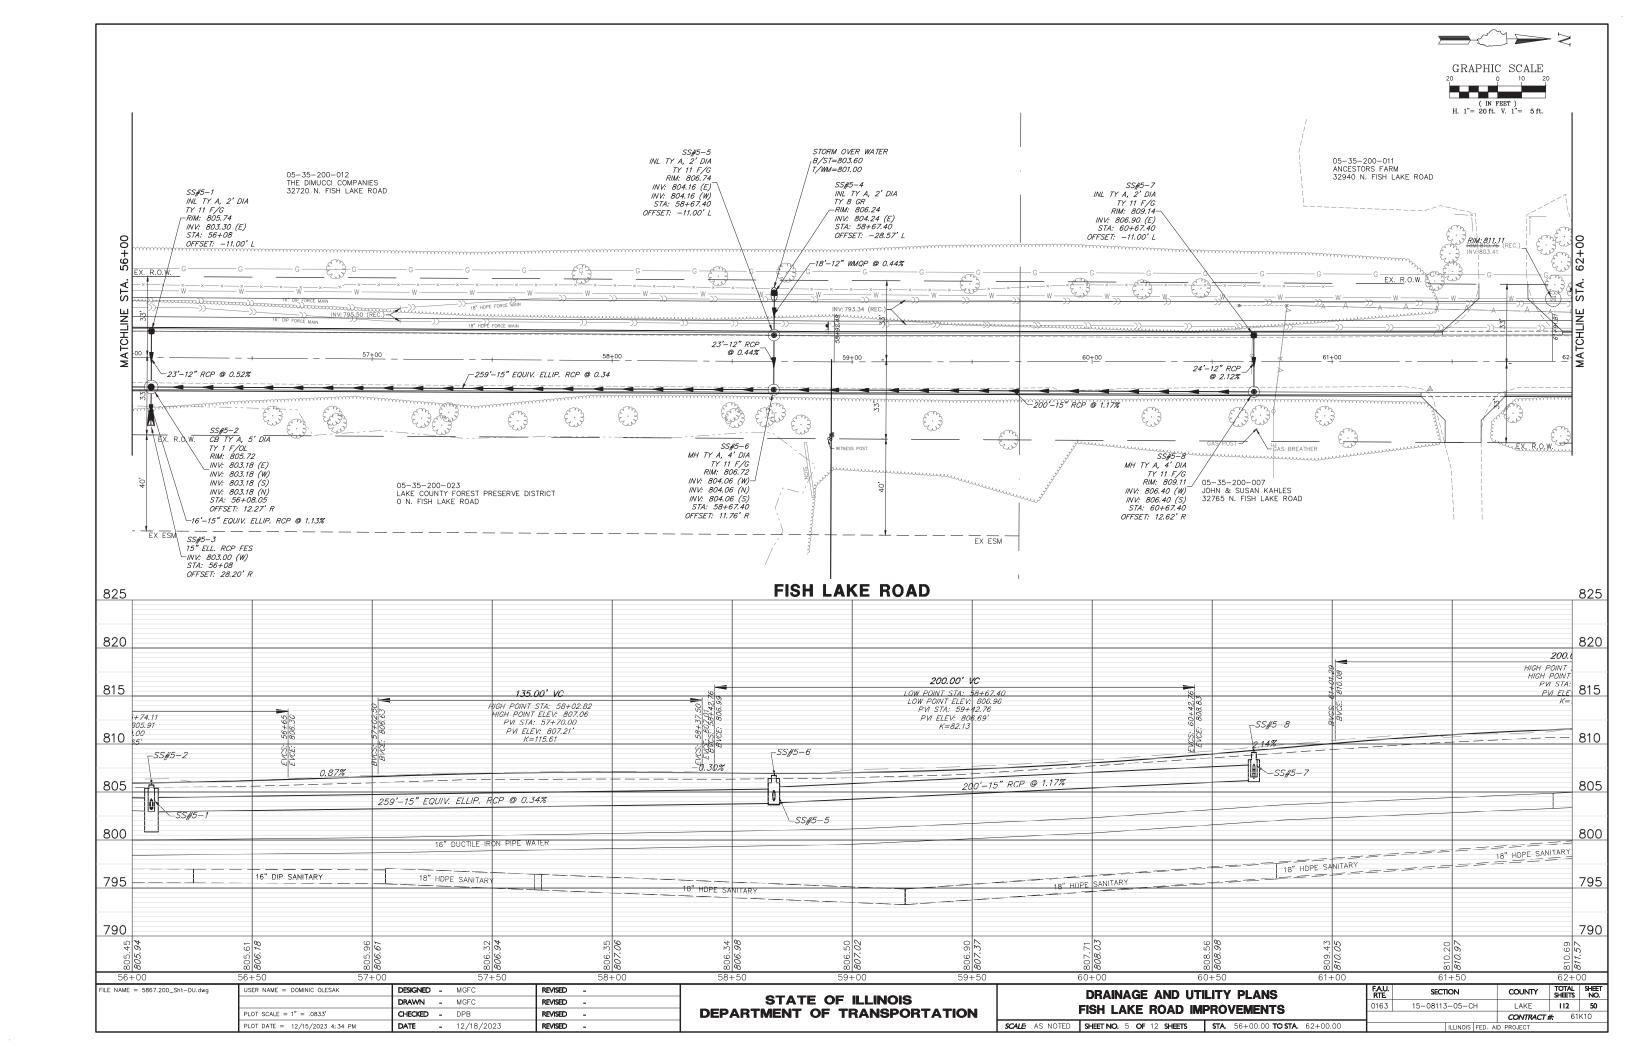


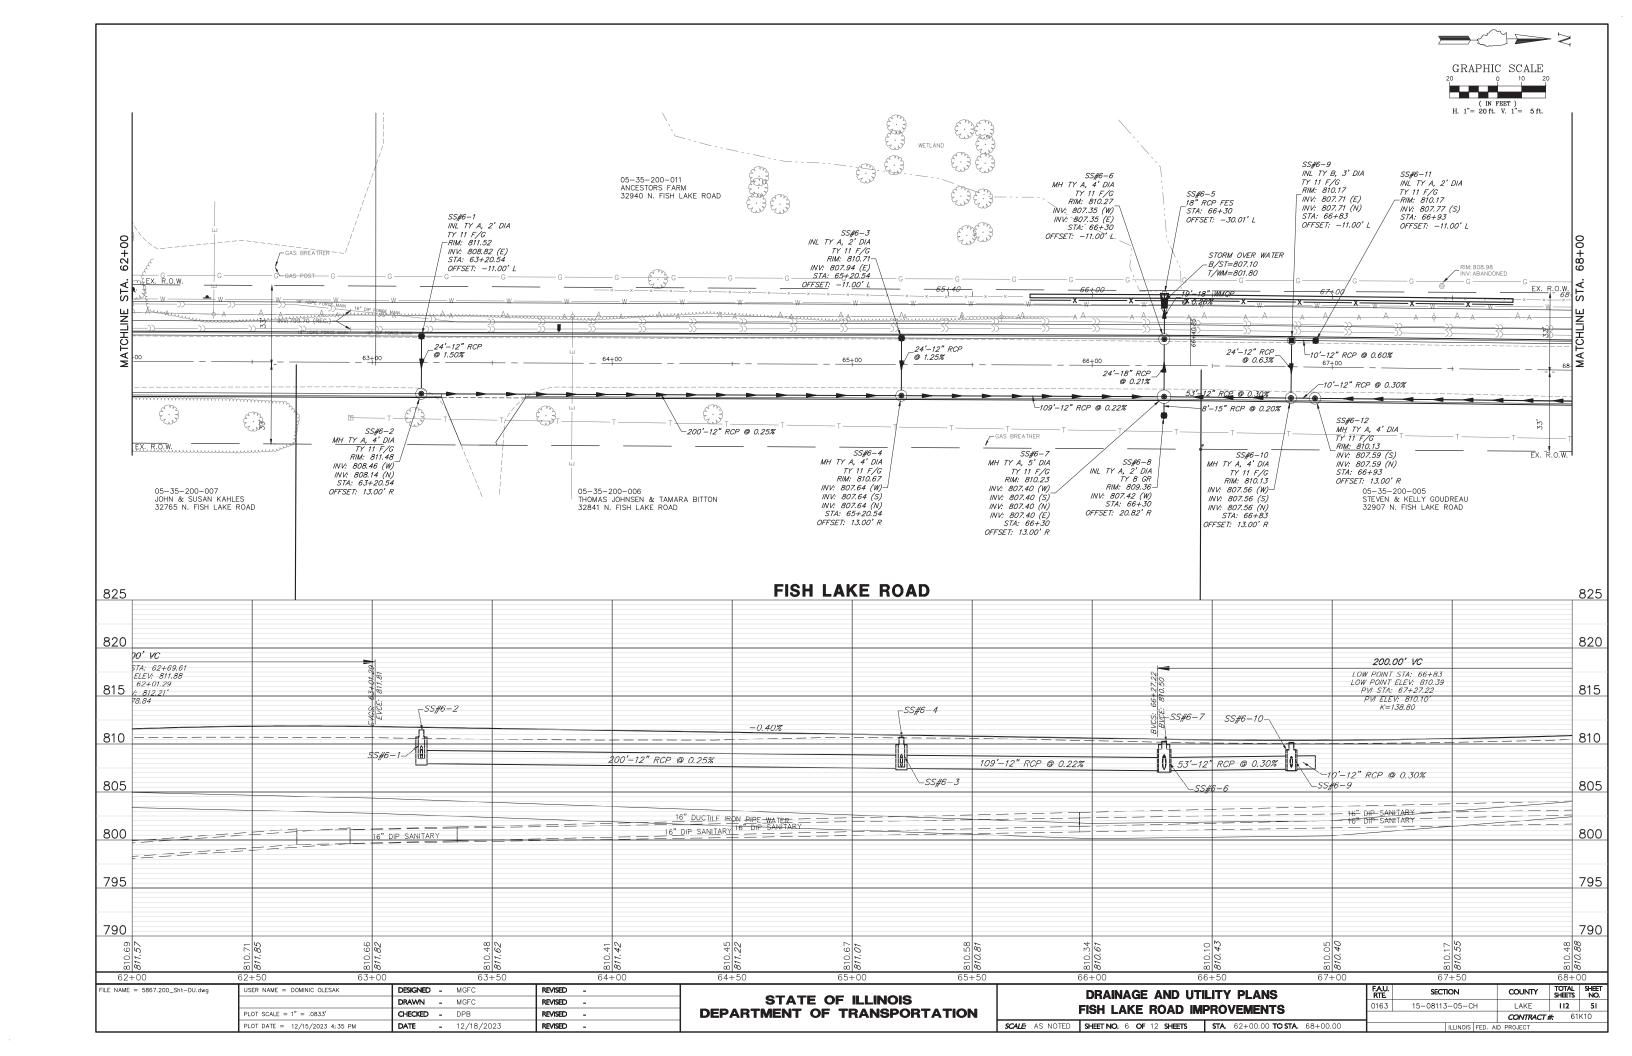


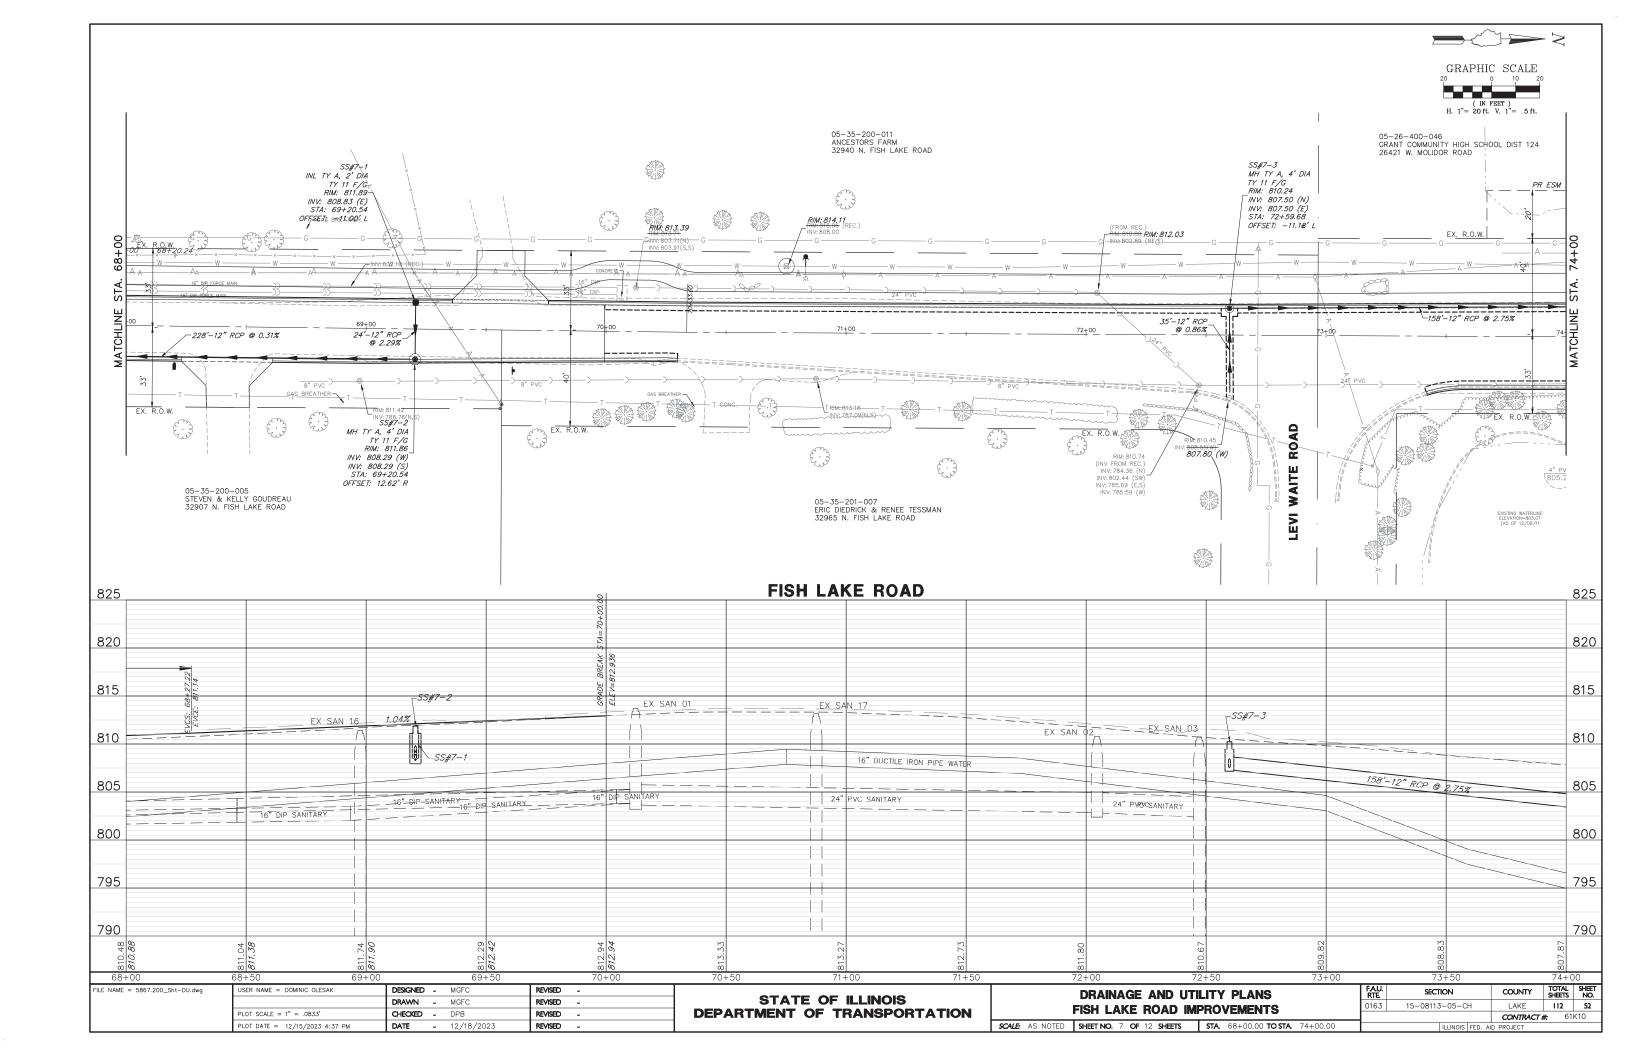


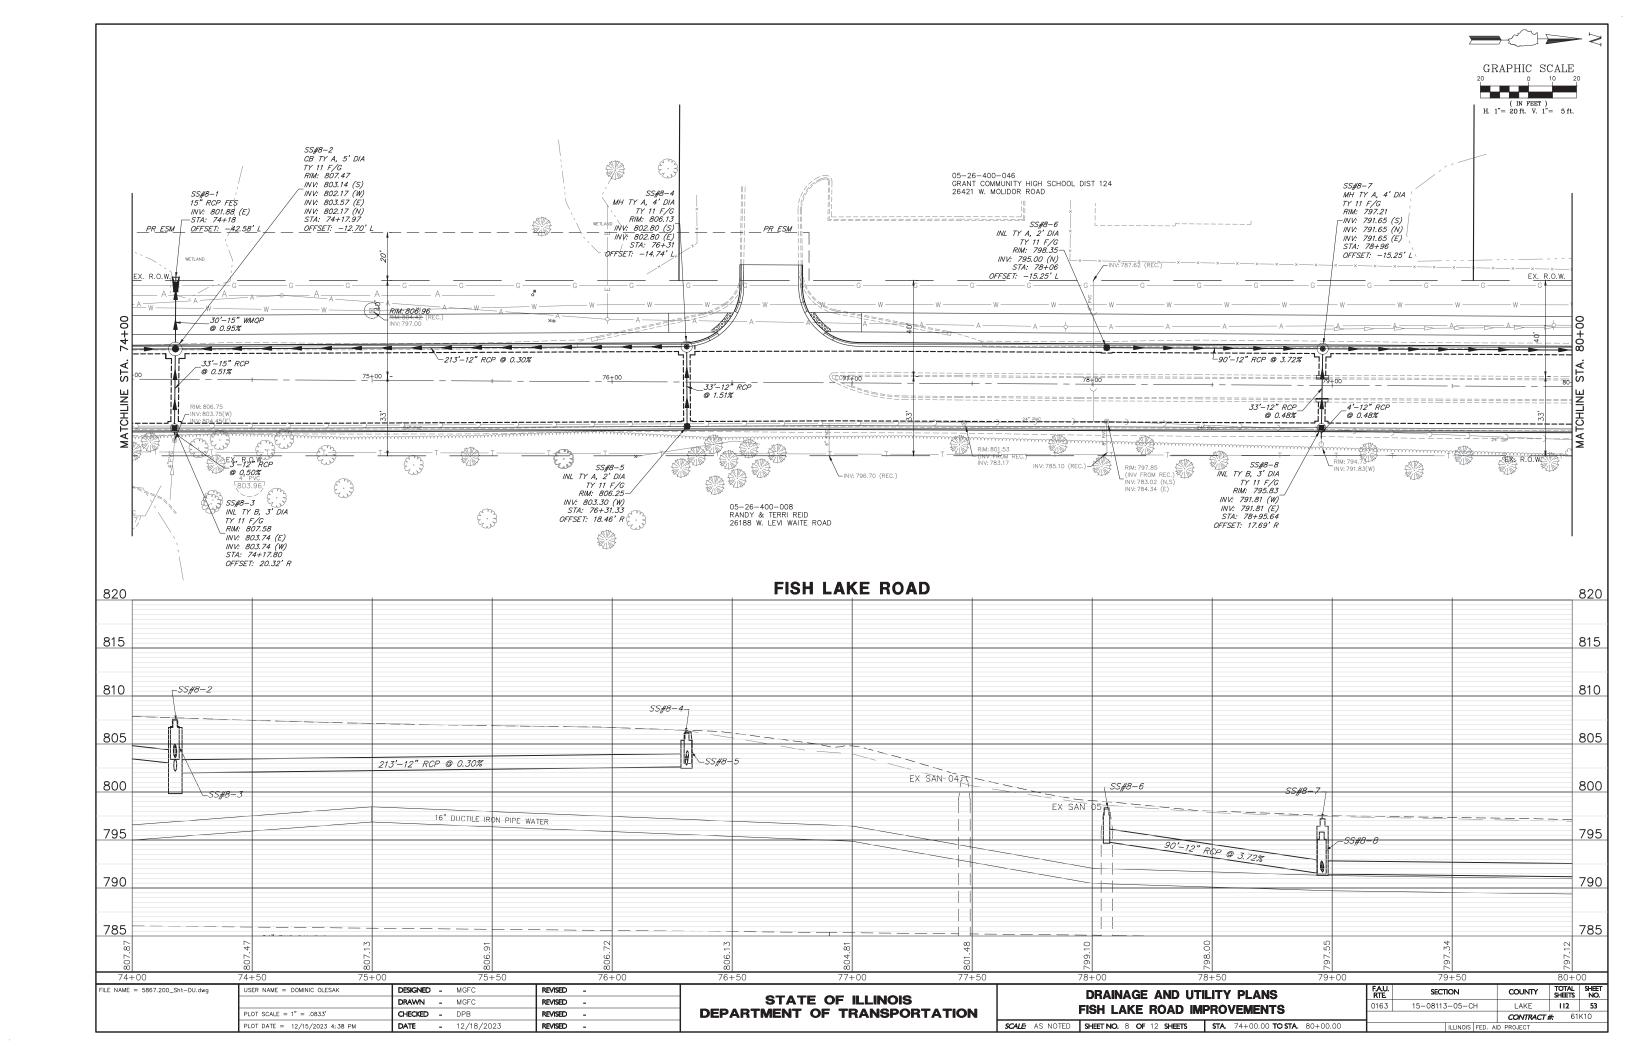


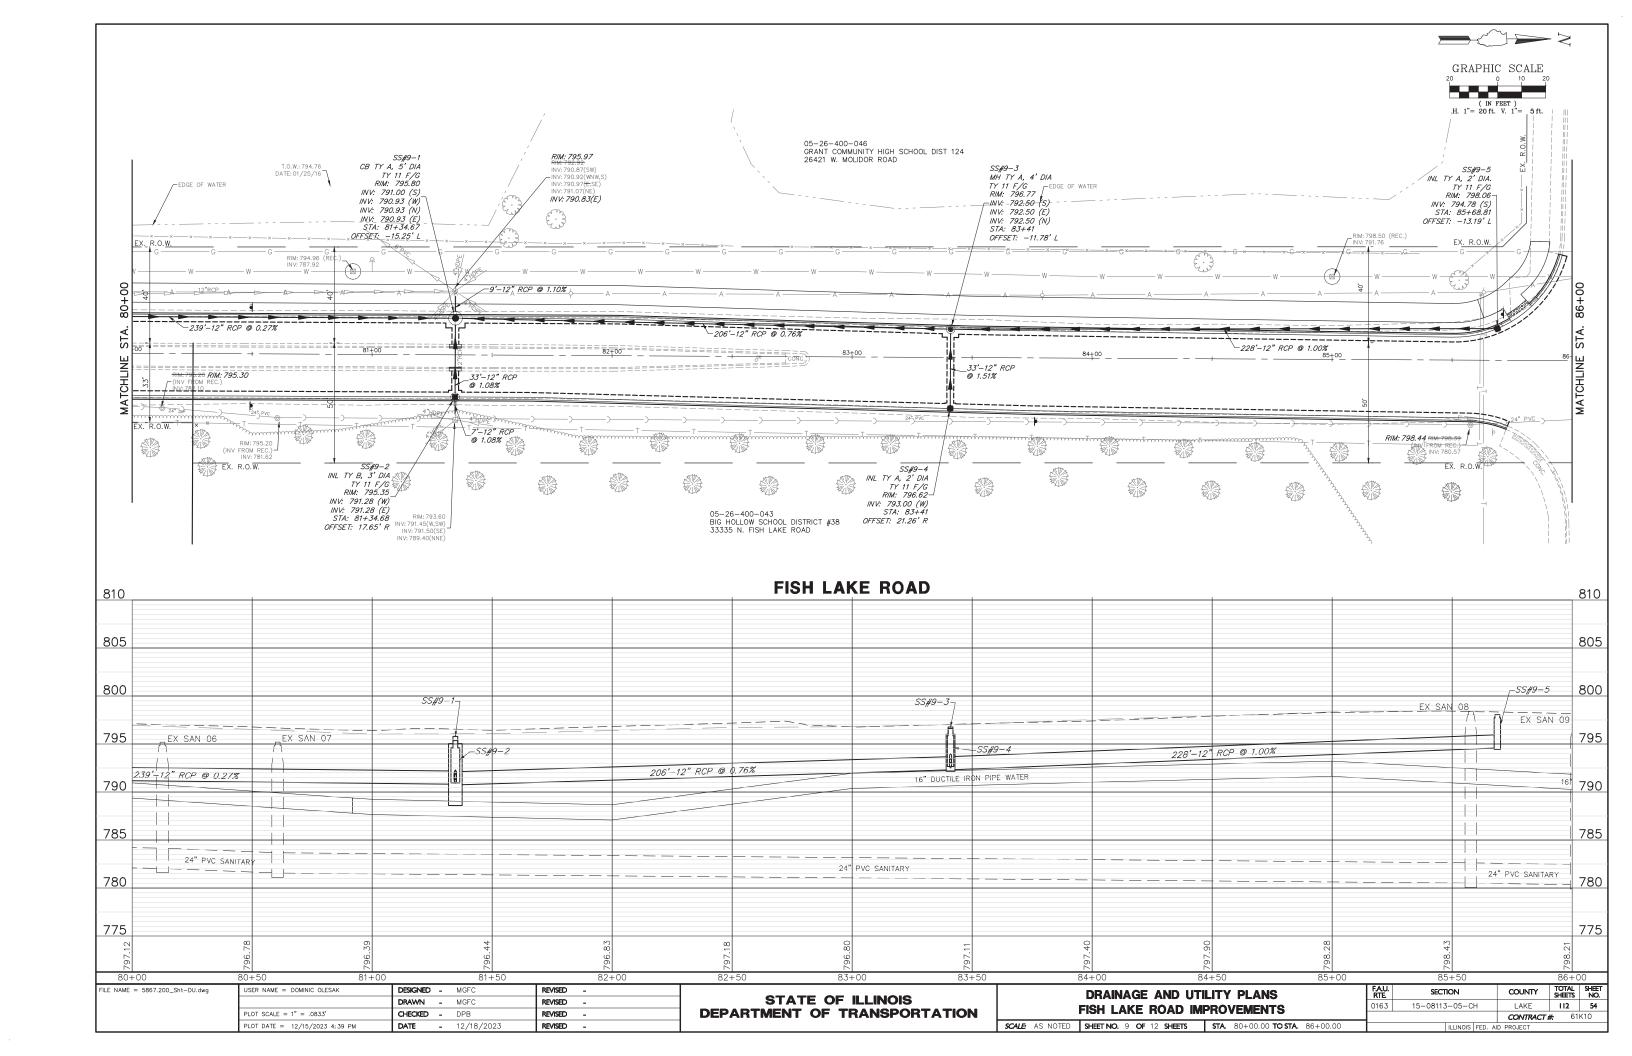

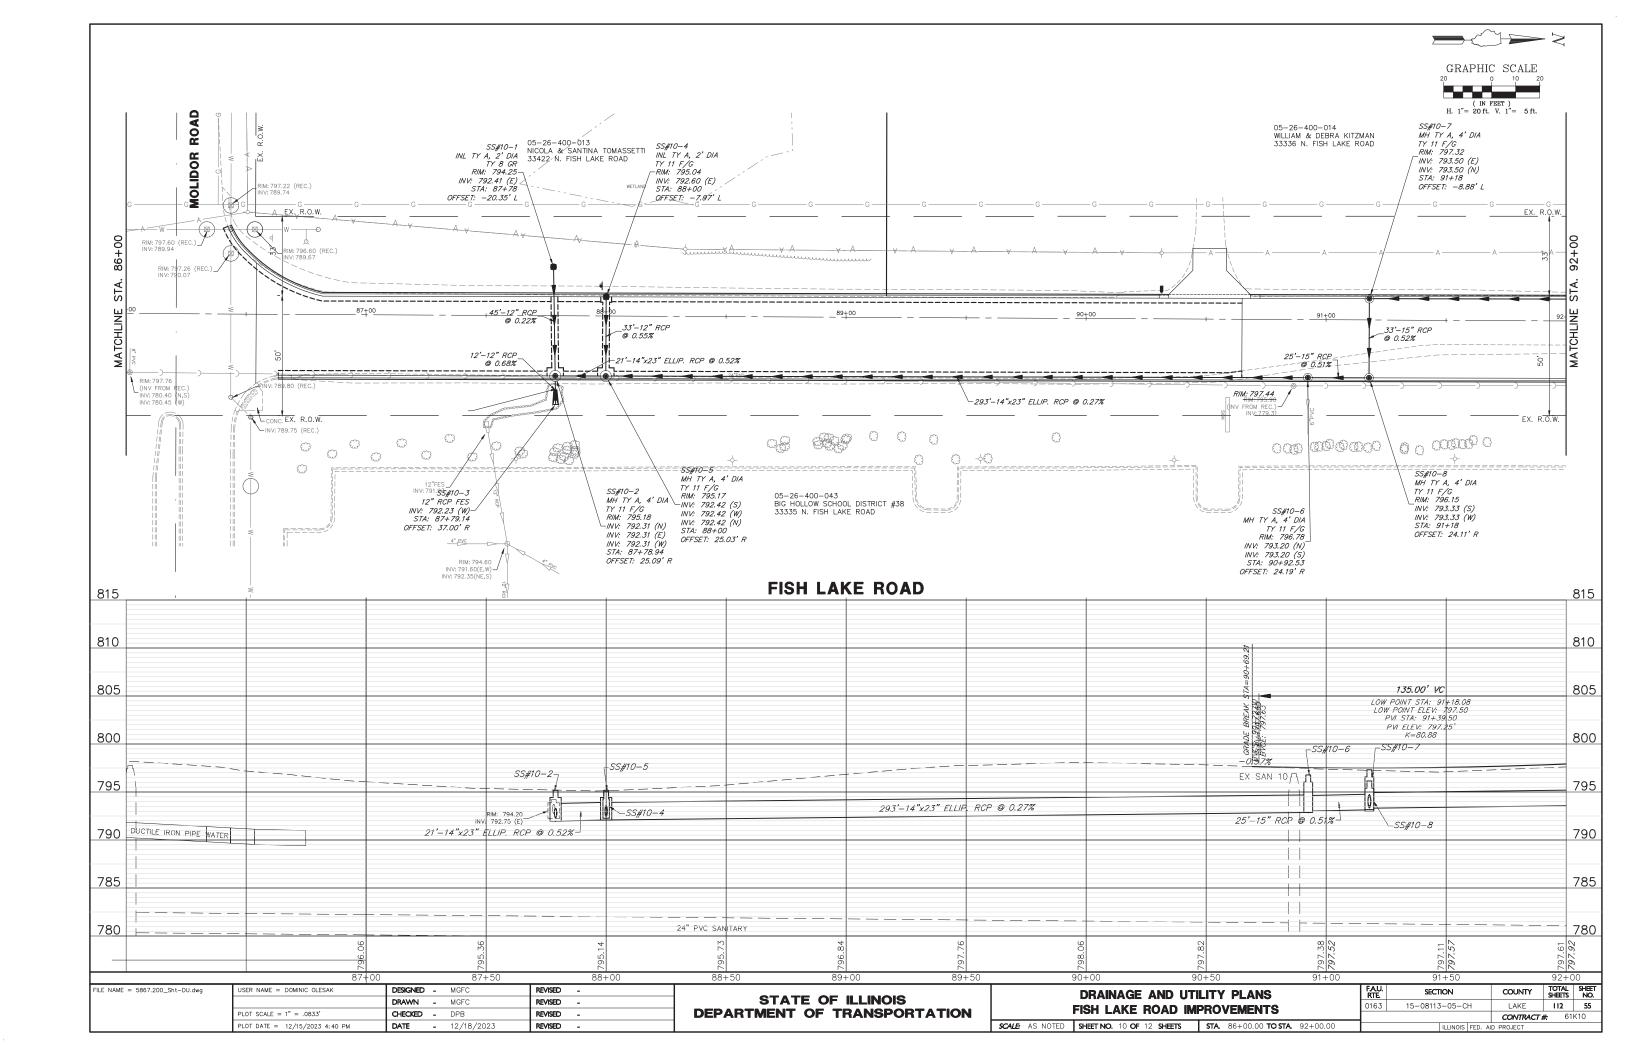

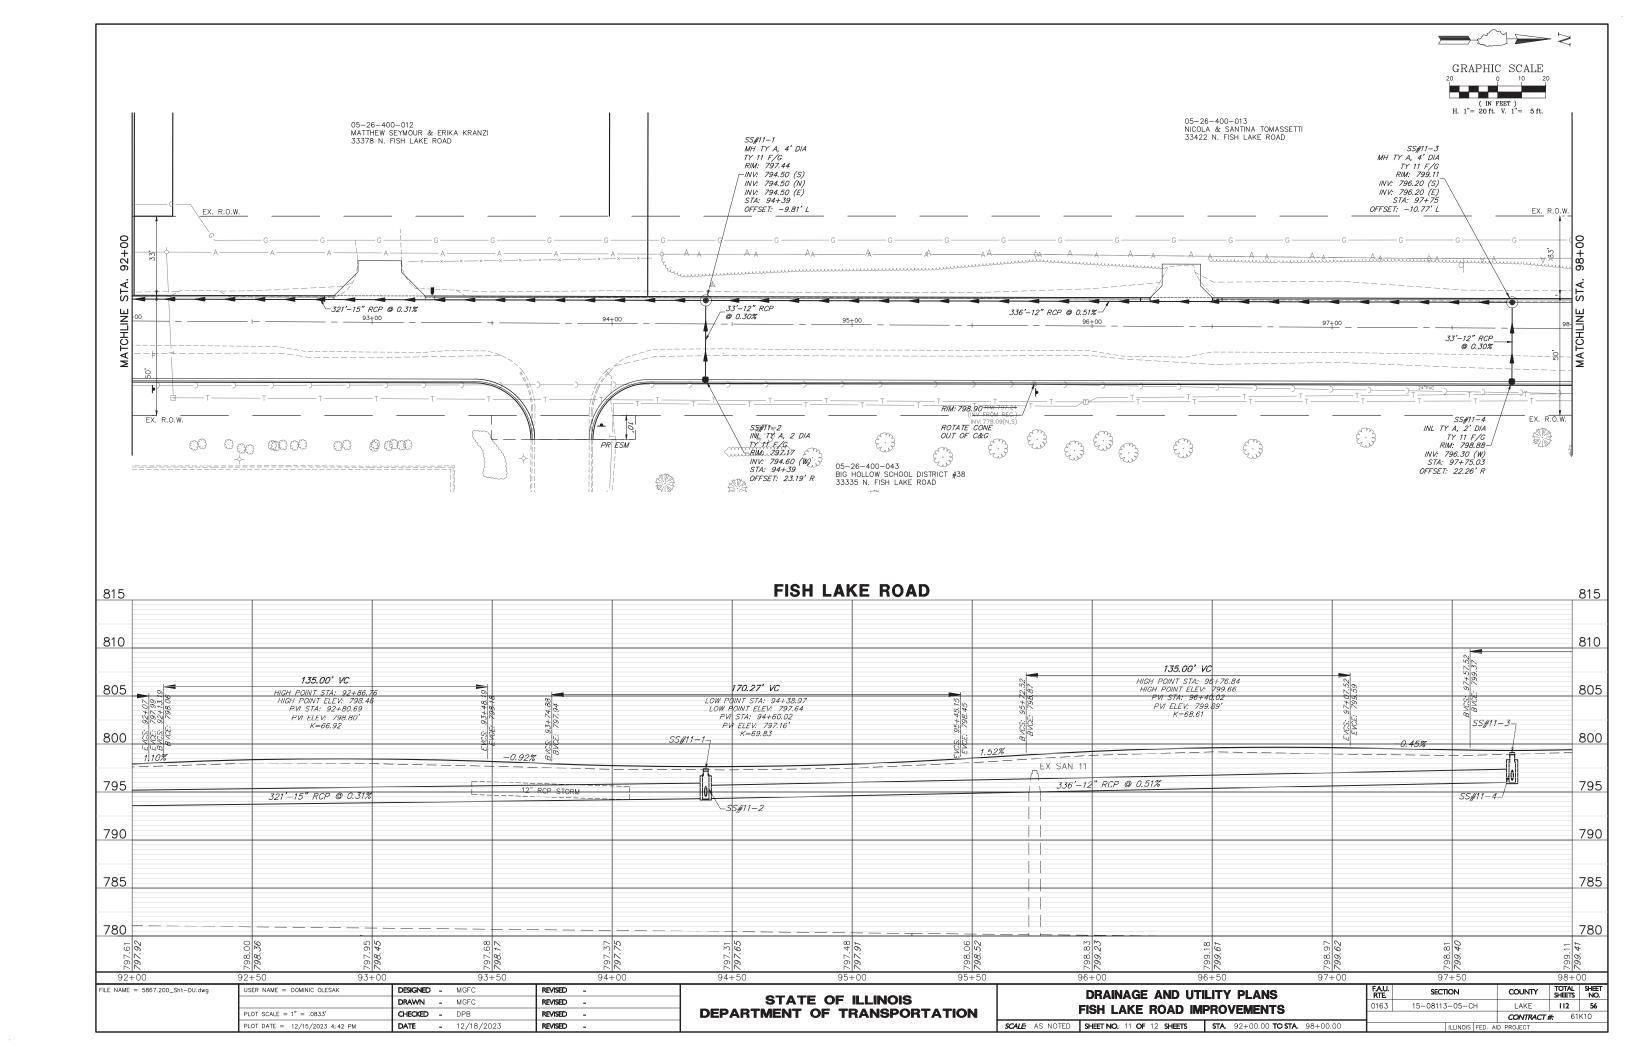

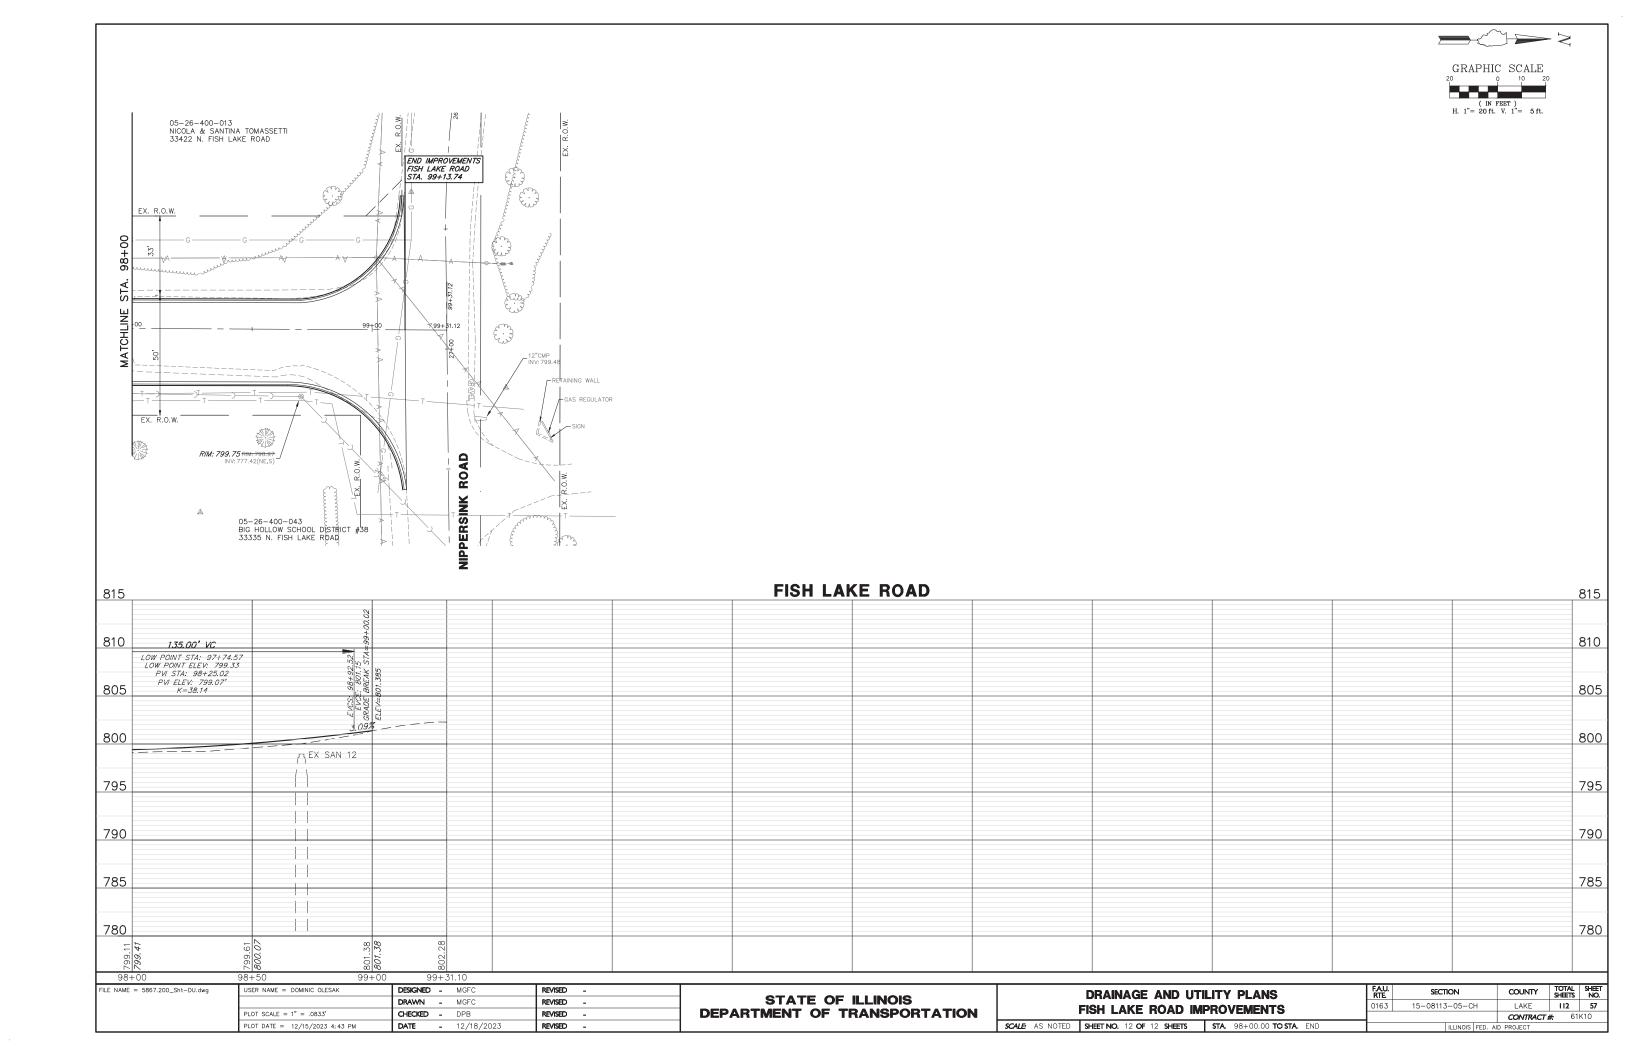

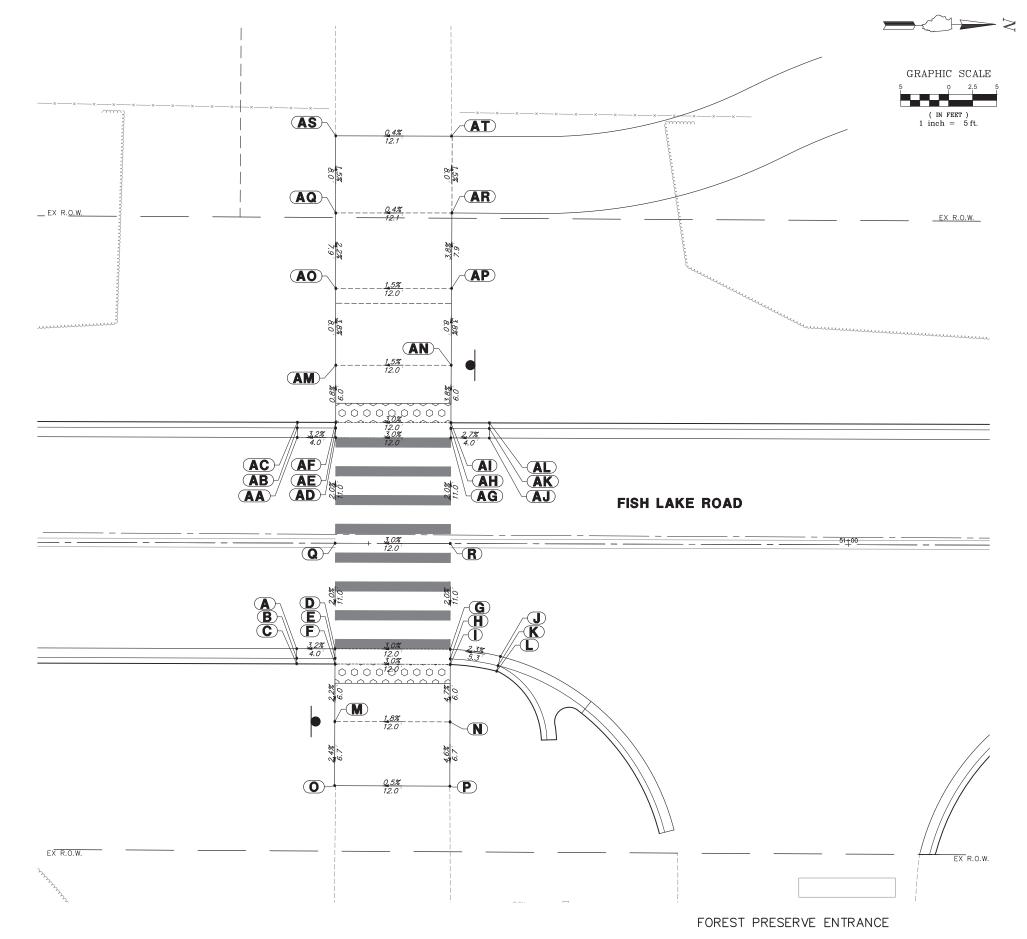

SCALE: 1"=5'

				_					
	ADA G	RADING T	ABLE			ADA GF	ABLE		
	STATION	OFFSET	ELEVATION			STATION	OFFSET	ELEVATION	
Α	50+42.5	11.0' R	805.00	A	4	50+42.5	11.0' L	805.00	
В	50+42.5	12.0' R	804.94	Αf	В	50+42.5	12.0' L	804.94	
С	50+42.5	12.6' R	805.44	A	0	50+42.5	12.6' L	805.44	
D	50+46.5	11.0' R	805.13	Α[)	50+46.5	11.0' L	805.13	
Ε	50+46.5	12.0' R	805.08	Αŧ	=	50+46.5	12.0' L	805.08	
F	50+46.5	12.6' R	805.12	Af	=	50+46.5	12.6' L	805.12	
G	50+58.5	11.0' R	805.49	A	3	50+58.5	11.0' L	805.49	
Н	50+58.5	12.0' R	805.44	Al	+	50+58.5	12.0' L	805.44	
I	50+58.5	12.6' R	805.48	А	I	50+58.5	12.6' L	805.48	
J	50+63.8	11.7' R	805.61	A	J	50+62.5	11.0' L	805.60	
K	50+63.5	12.7' R	805.55	Ał	<	50+62.5	12.0' L	805.54	
L	50+63.4	13.3' R	806.05	Al	-	50+62.5	12.6' L	806.04	
М	50+46.5	18.6' R	804.99	AM	N	50+46.5	18.5' L	805.07	
Ν	50+58.5	18.6' R	805.20	1A	٧	50+58.5	18.6' L	805.25	
0	50+46.5	25.3' R	(804.83)	A)	50+46.5	26.5' L	804.77	
Р	50+58.5	25.3' R	(804.89)	Af	0	50+58.6	26.6' L	804.95	
Q	50+46.5	0.0'	0.0' 805.35		Ç	50+46.5	34.4' L	804.60	
R	50+58.5	0.0'	805.71	Af	7	50+58.6	34.4' L	804.65	
				AS	5	50+46.4	42.4' L	(804.48)	
				A-	Т	50+58.5	42.4' L	(804.53)	

FILE NAME = 5867.200-ADA.dwg

USER NAME = DOMINIC OLESAK

DRAWN - MGFC

REVISED PLOT SCALE = 1" = .0833"

CHECKED - DPB

REVISED PLOT DATE = 12/15/2023 5:08 PM


DATE - 12/18/2023


REVISED -

STATE OF ILLINOIS
DEPARTMENT OF TRANSPORTATION

ADA GRADING DETAILS
FISH LAKE ROAD IMPROVEMENTS

SHEET NO. 1 OF 3 SHEETS STA TO STA

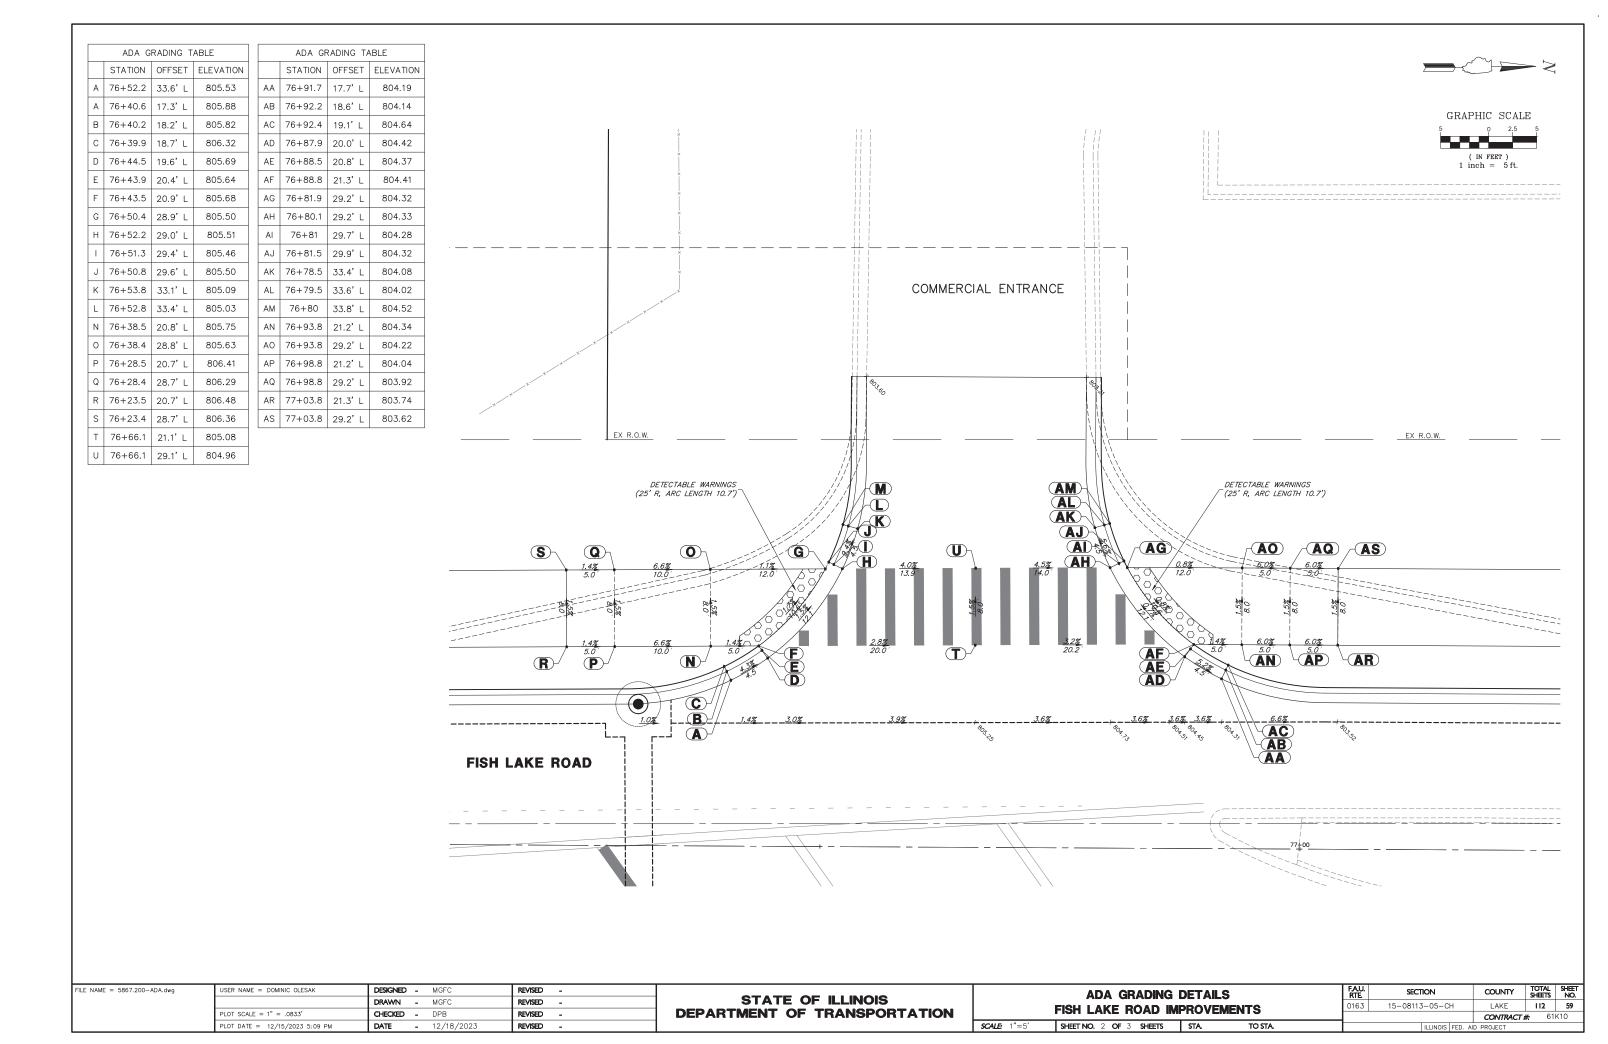


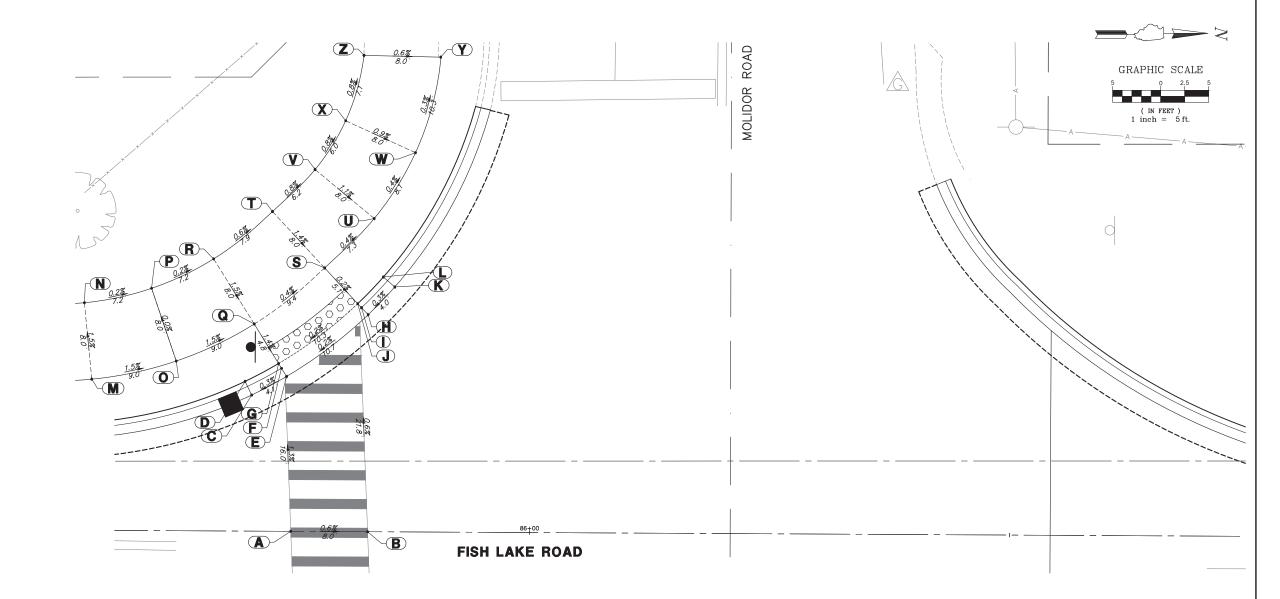



ADA GRADING TABLE											
	STATION	OFFSET	ELEVATION								
Α	85+75.1	0.0'	(798.31)								
В	85+83.1	0.0'	(798.26)								
С	85+71	14.2' L	798.09								
D	85+70.3	15.6' L	798.59								
Ε	85+74.6	16.1' L	798.11								
F	85+74.1	17.0' L	798.06								
G	85+73.8	17.5' L	798.10								
Н	85+83.1	22.6' L	798.13								
1	85+82.4	23.3' L	798.08								
J	85+82	23.7' L	798.12								
K	85+85.8	25.5' L	798.14								
L	85+84.6	26.5' L	798.58								
М	85+54.3	15.7' L	798.44								
Ν	85+53.5	23.7' L	798.32								
0	85+63.1	17.7' L	798.30								
Ρ	85+60.5	25.2' L	798.30								
Q	85+71.2	21.6' L	798.17								
R	85+66.9	28.3' L	798.29								
S	85+78.5	27.5' L	798.13								
Т	85+73.1	33.3' L	798.24								
U	85+83.7	32.6' L	798.10								
٧	85+77.5	37.7' L	798.19								
W	85+87.9	39.5' L	798.07								
X	85+80.6	42.8' L	798.14								
Υ	85+90.5	49.5' L	(798.04)								
Z	85+82.5	49.6' L	(798.09)								


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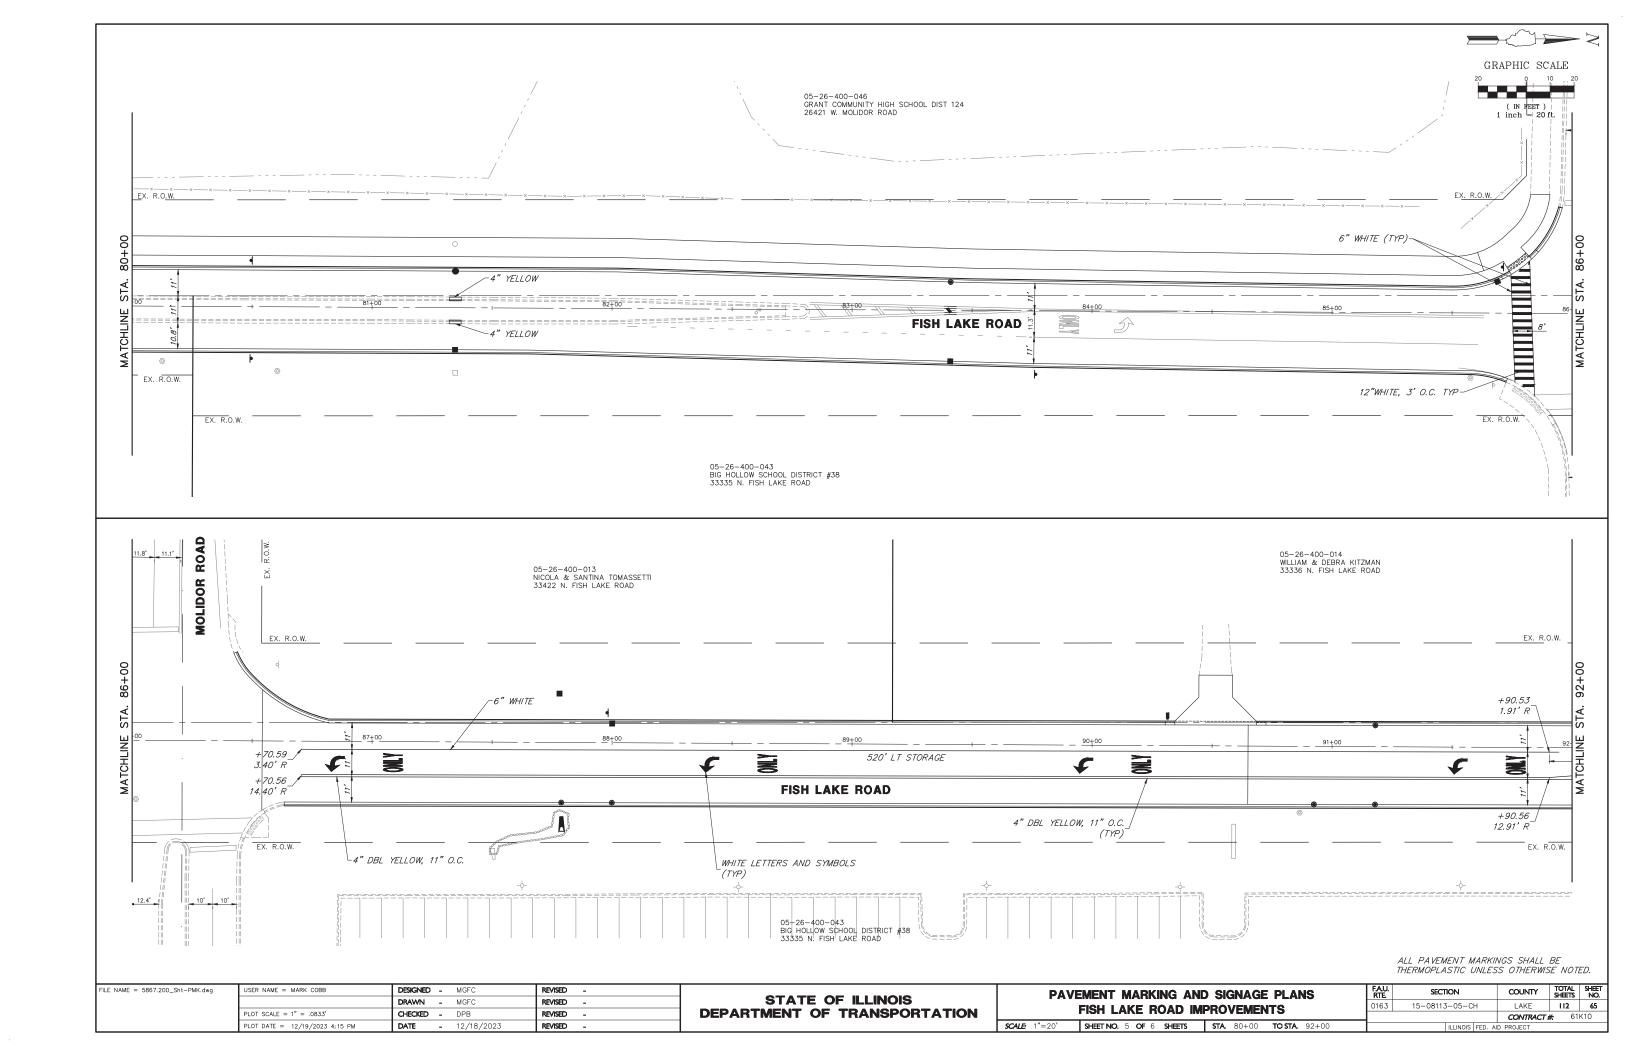
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		DRAWN -	MGFC	REVISED -	STATE OF ILLINOIS					0163	15-08113-05-CH	LAKE	112	60
	PLOT SCALE = 1" = .0833'	CHECKED -	DPB	REVISED -	DEPARTMENT OF TRANSPORTATION	ADA GRADING DETAILS FISH LAKE ROAD IMPROVEMENTS SCALE: 1"=5' SHEET NO. 3 OF 3 SHEETS STA. TO STA.			NEN I S			CONTRACT #	#: 61	K10
1	PLOT DATE = 12/15/2023 5:11 PM	DATE -	12/18/2023	REVISED -		SCALE: 1"=5'	SHEET NO. 3 OF 3 SHEETS	STA.	TO STA.		ILLINOIS FED. A	ID PROJECT		




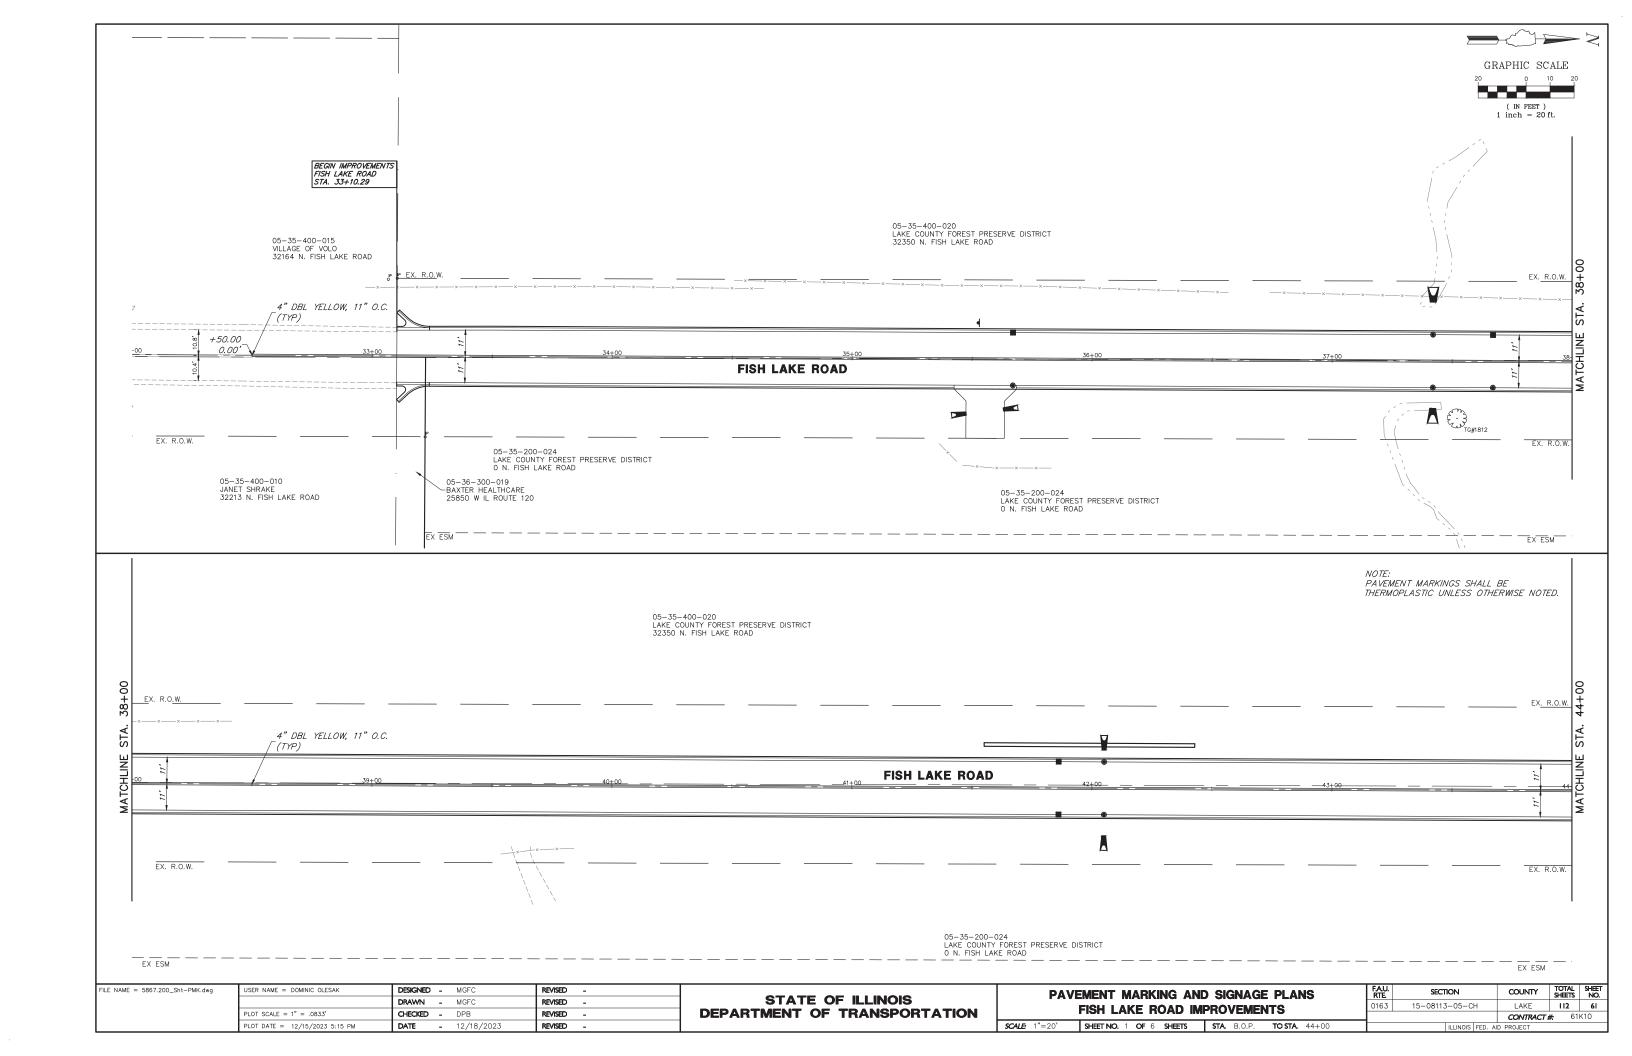


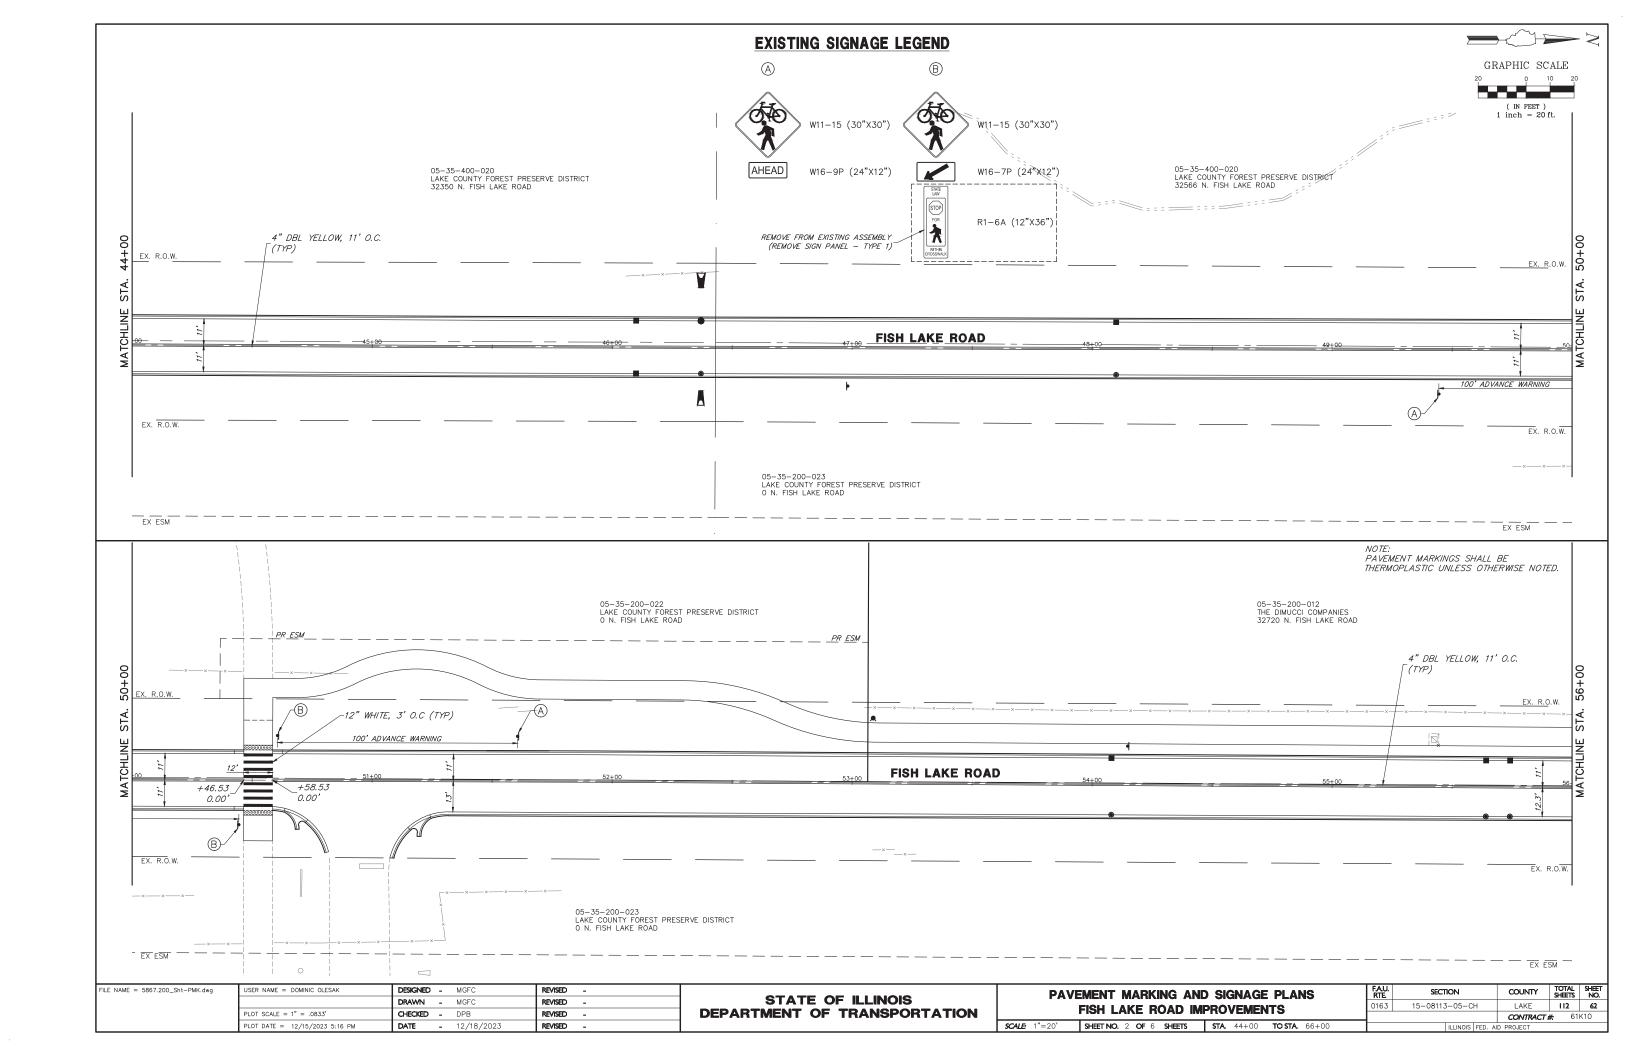


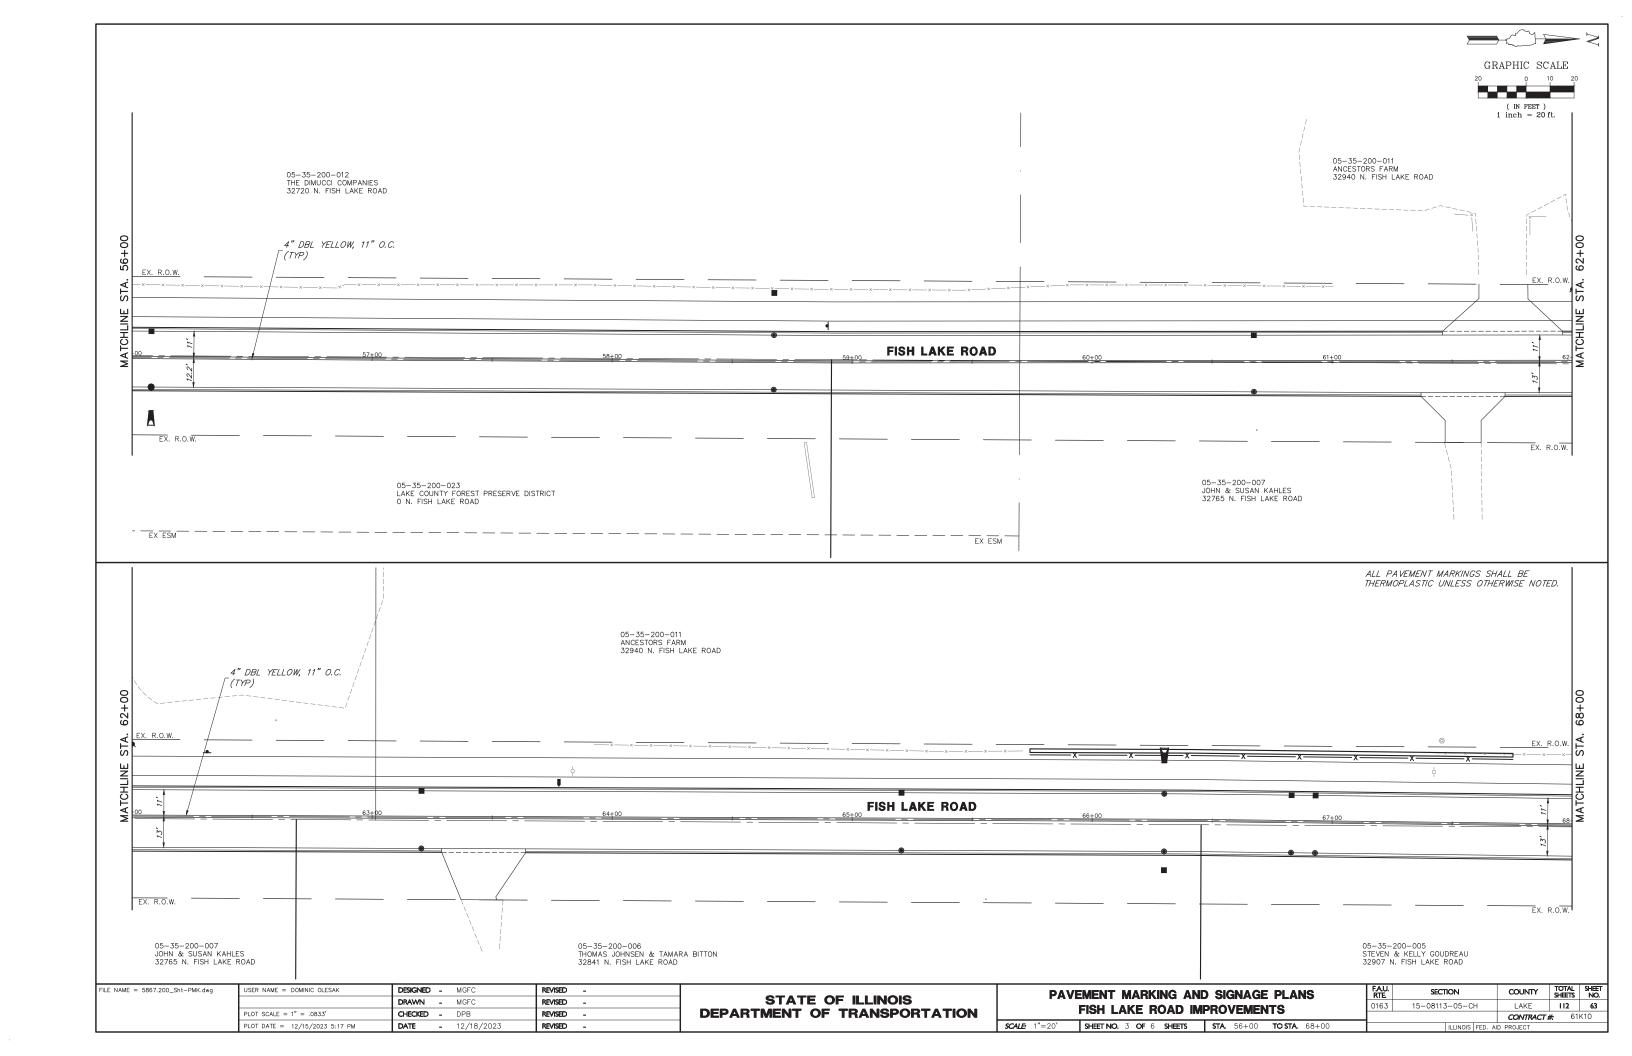


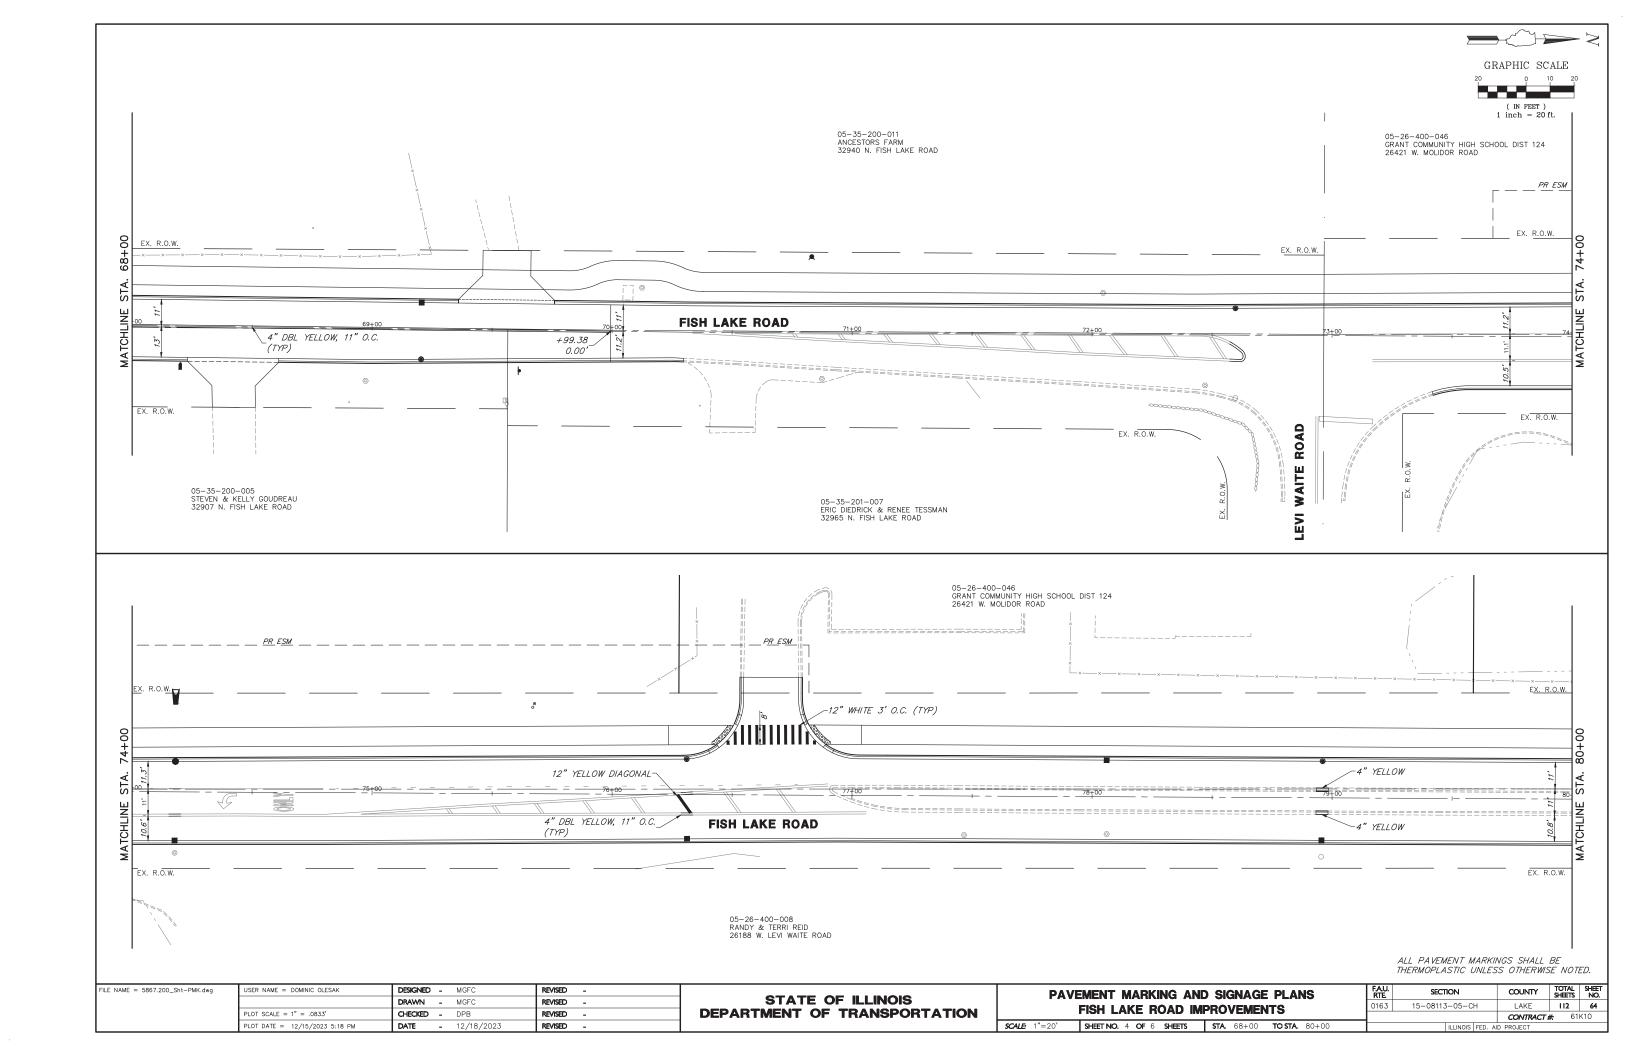


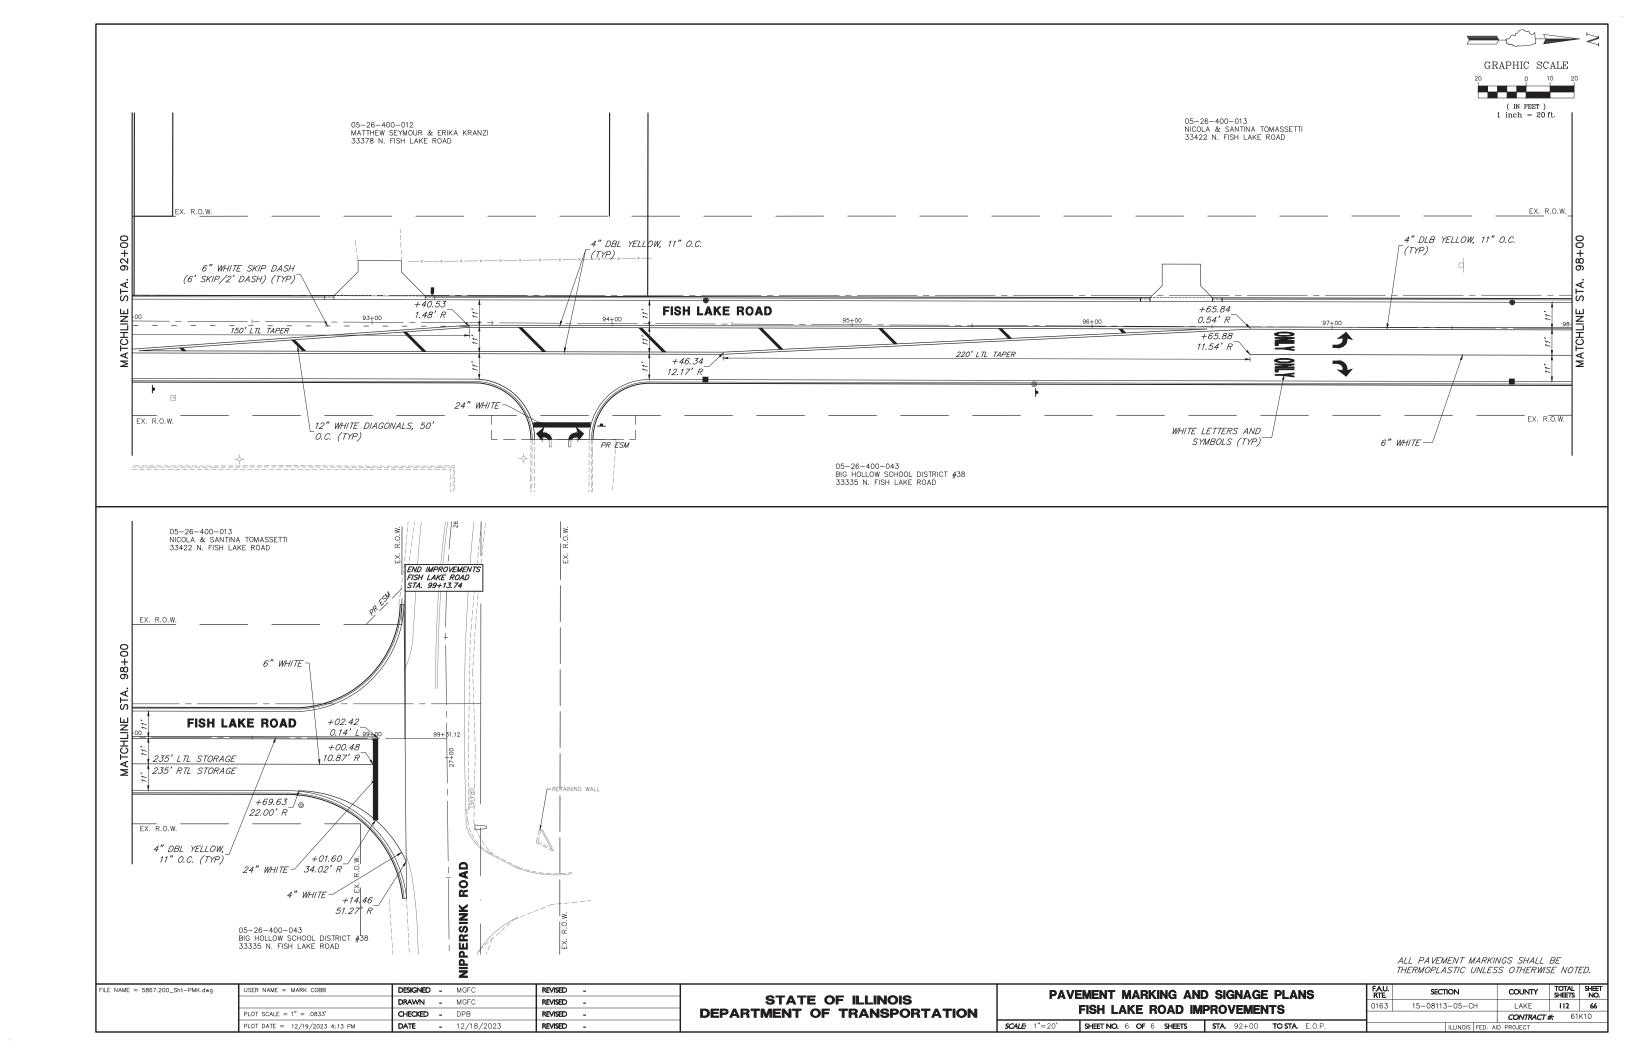


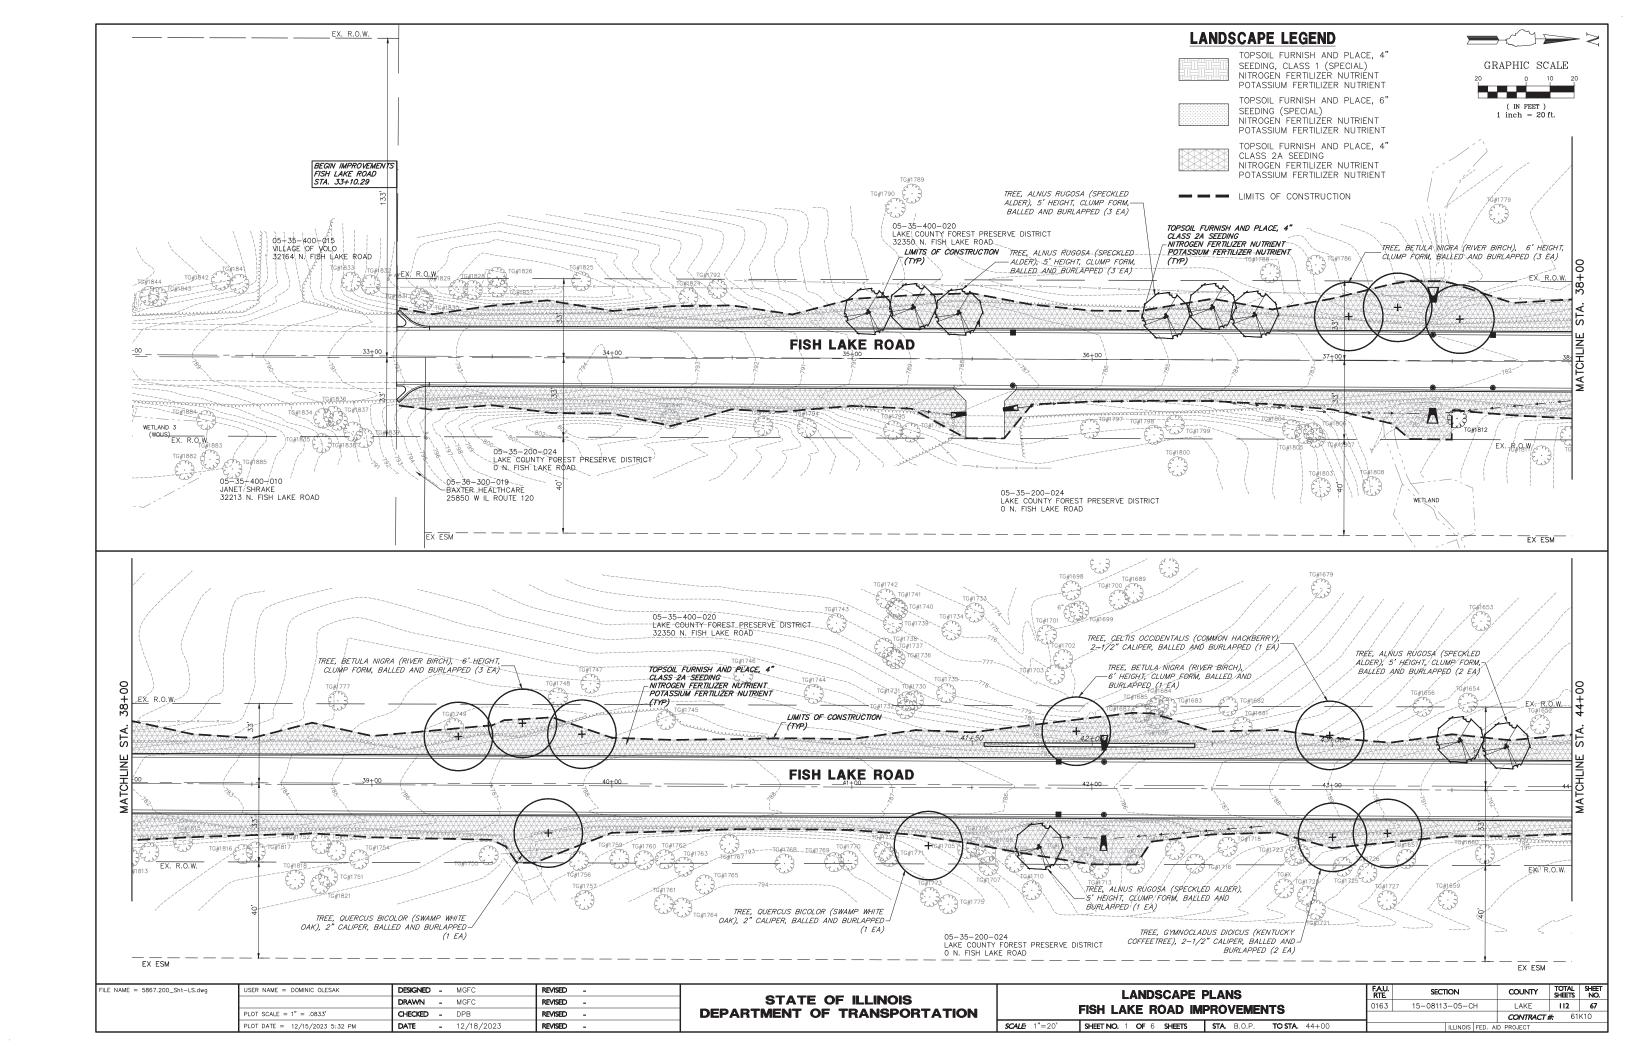


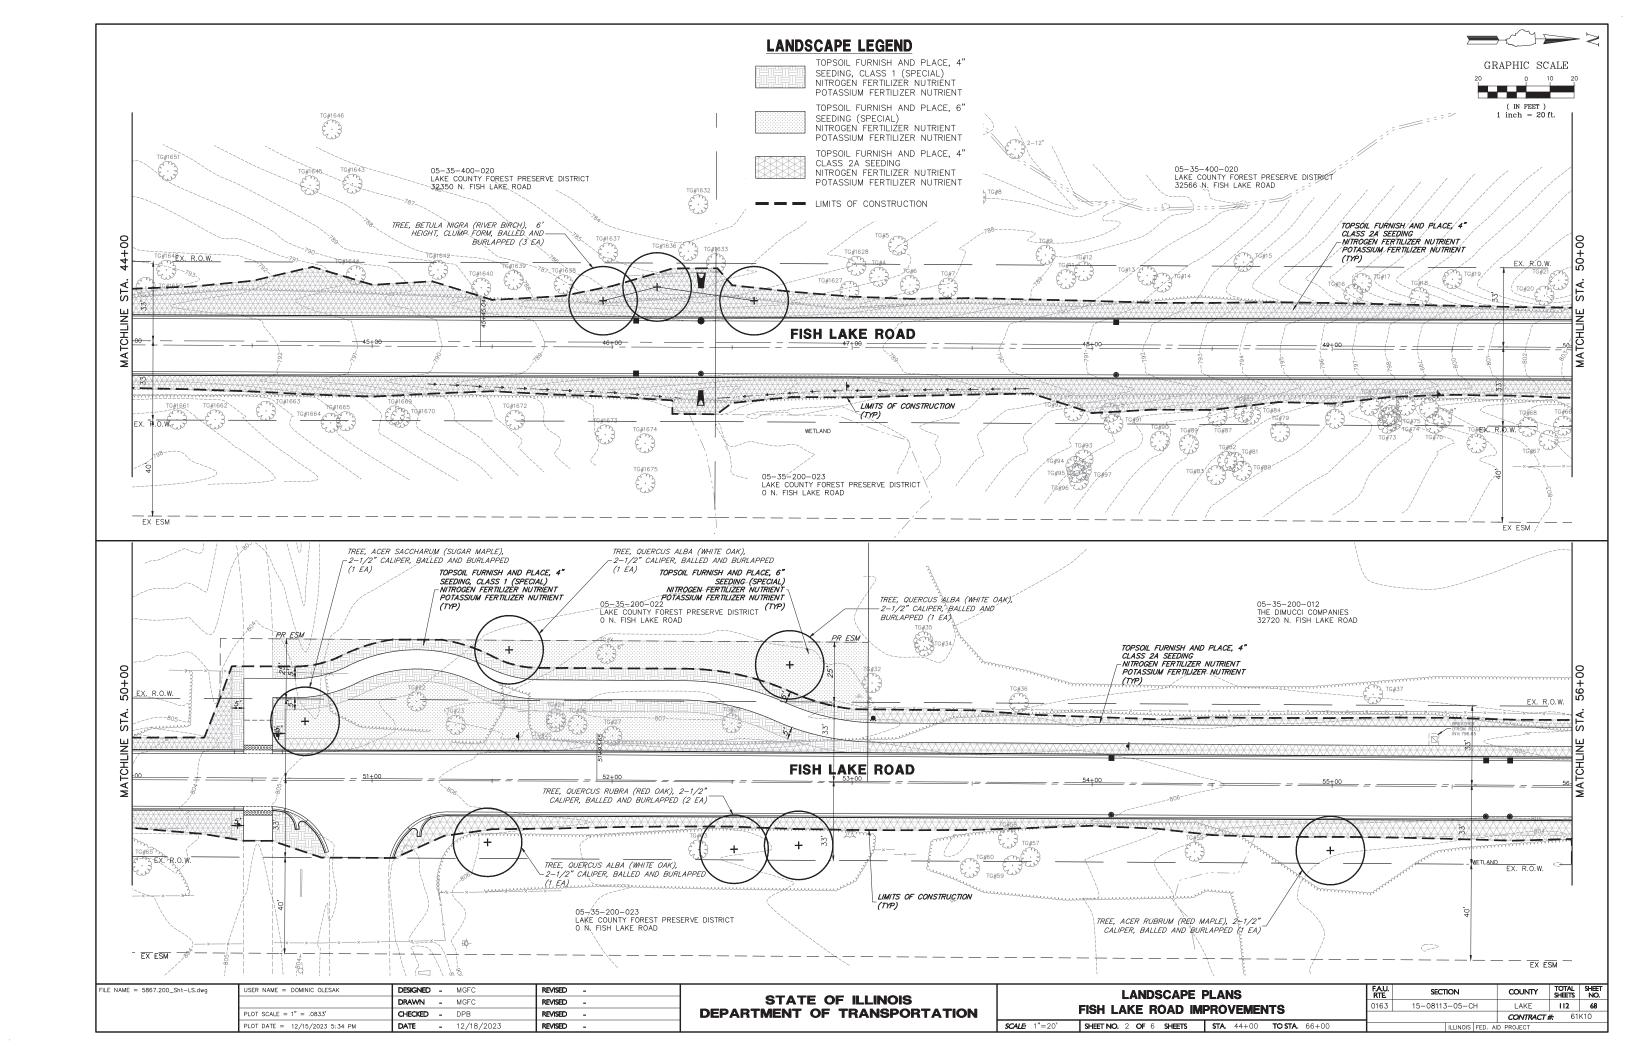


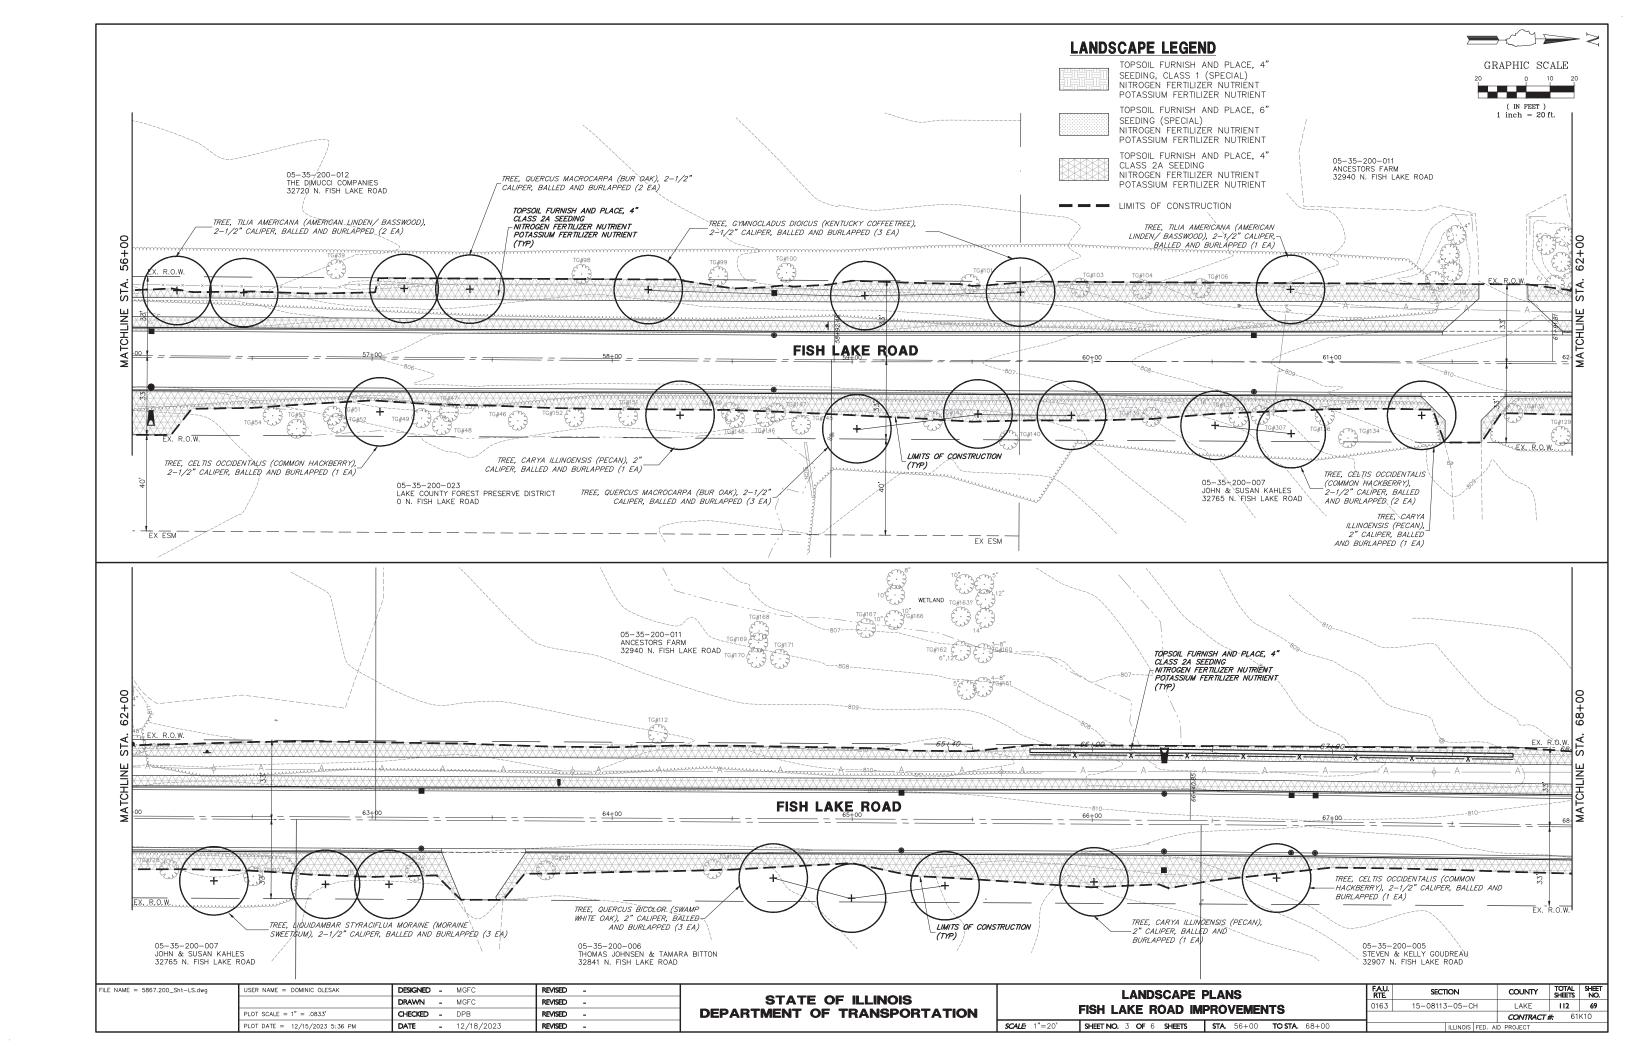


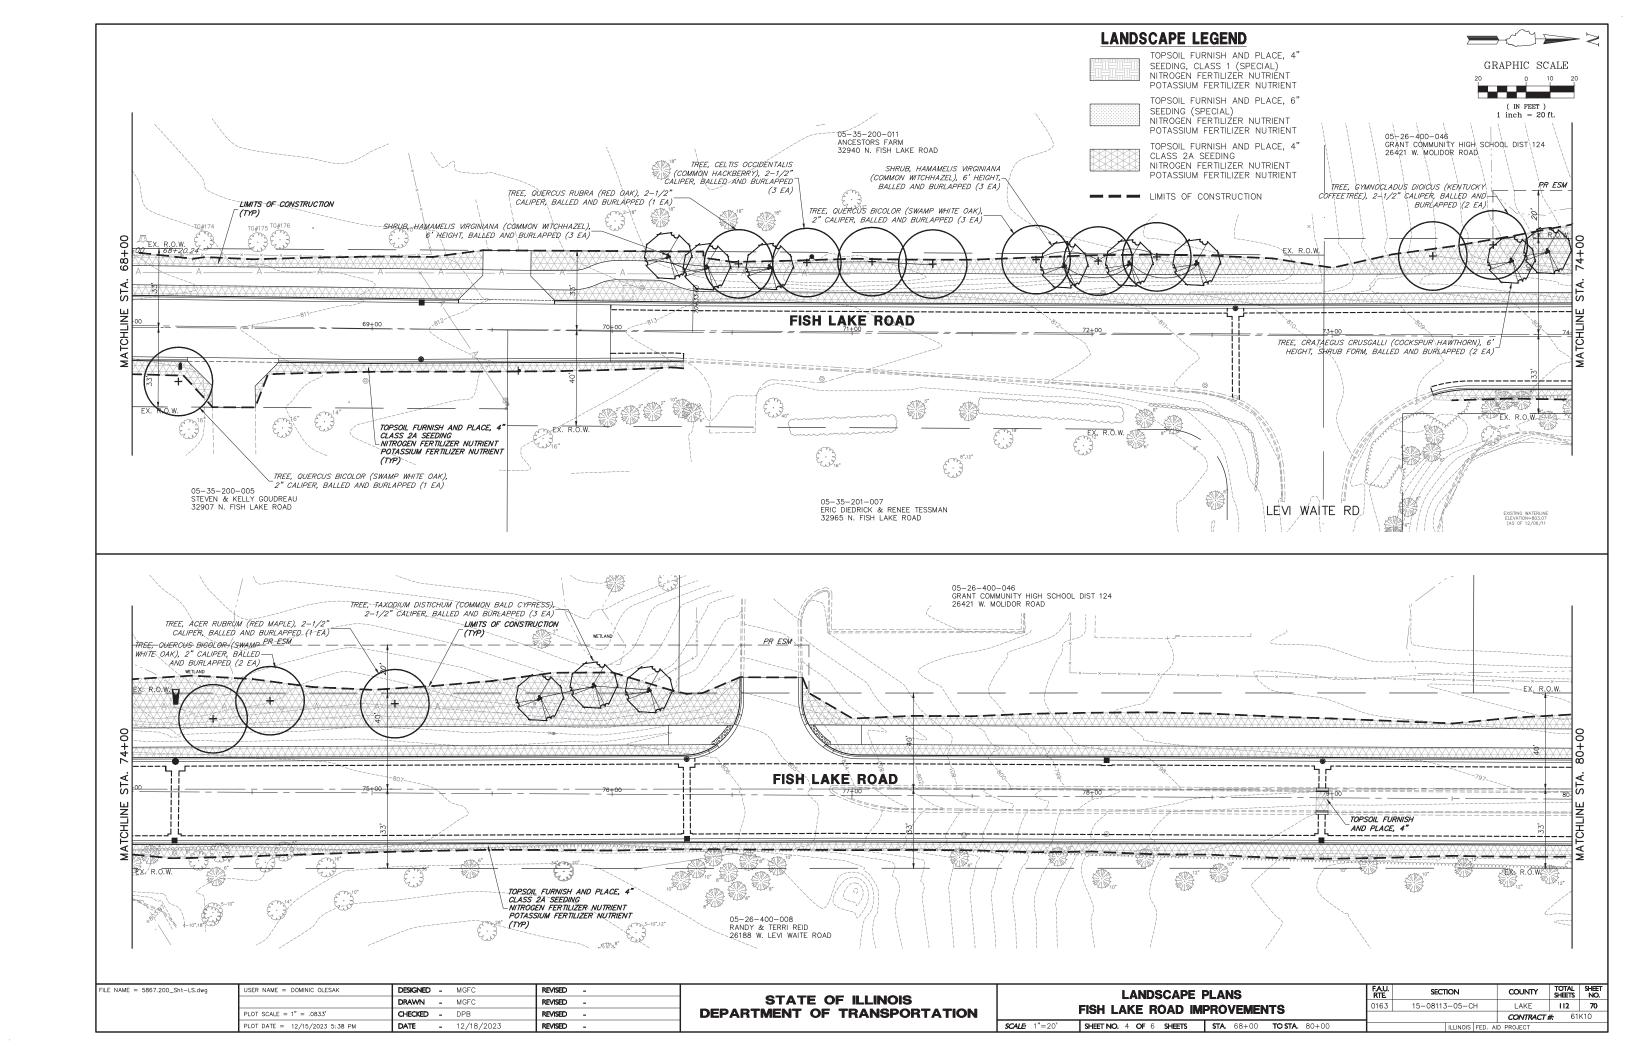


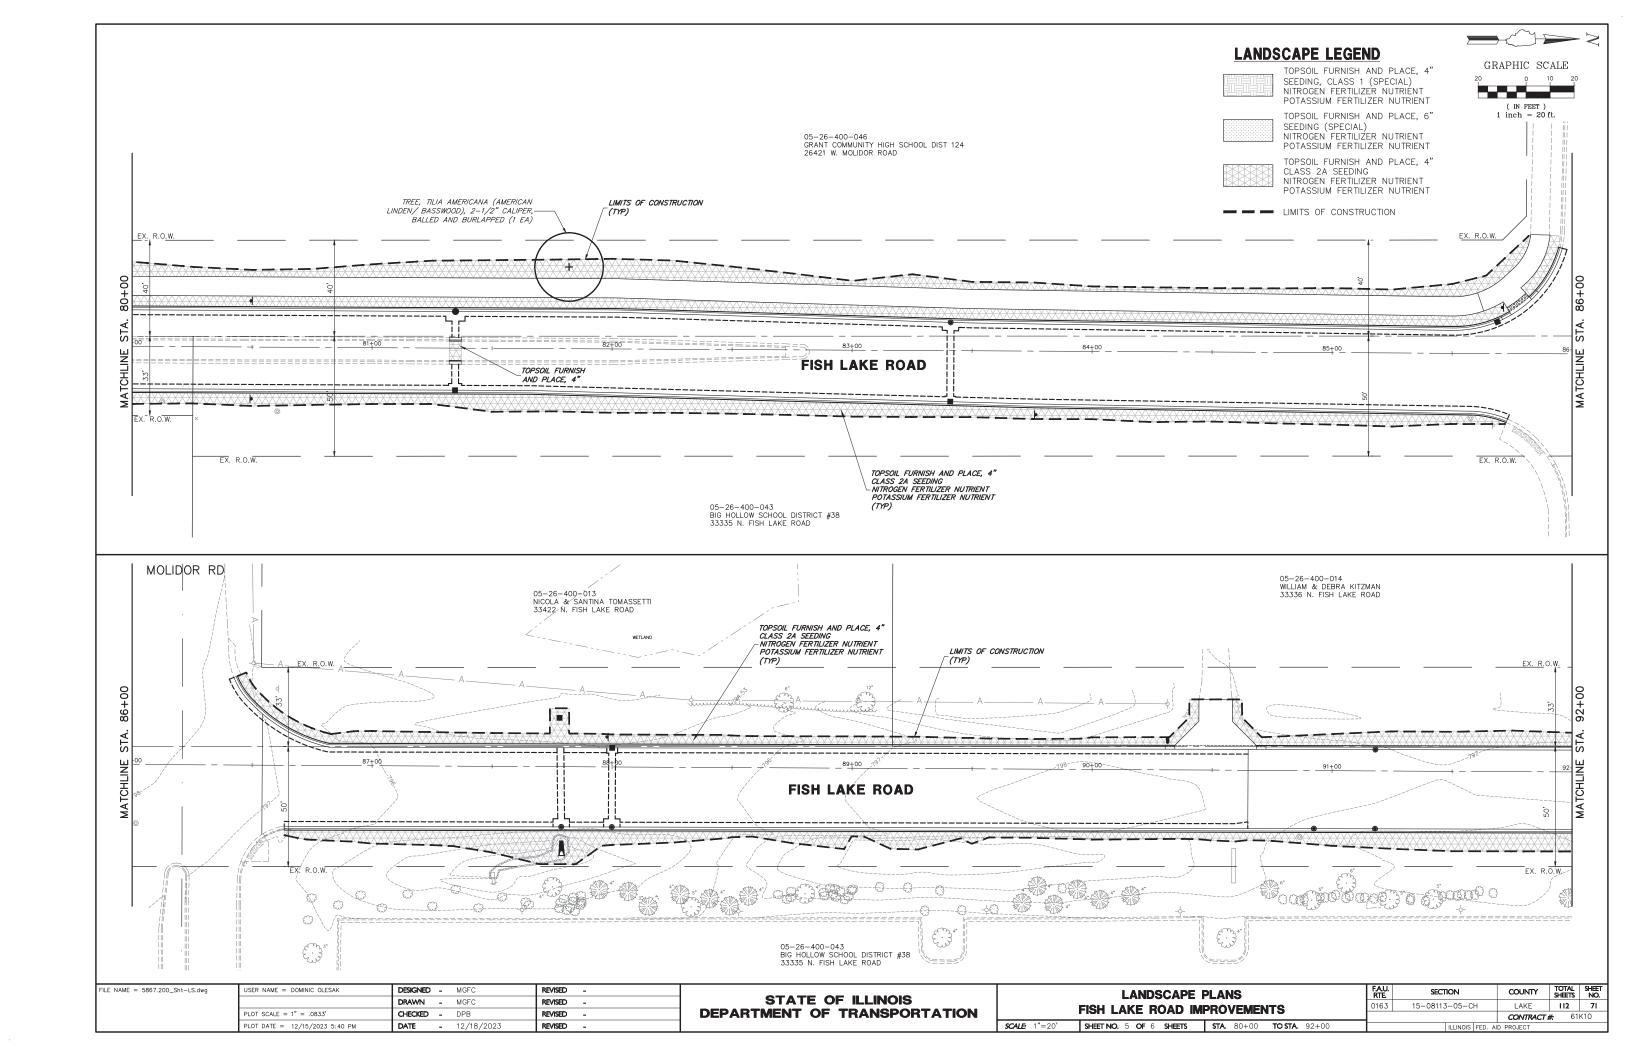


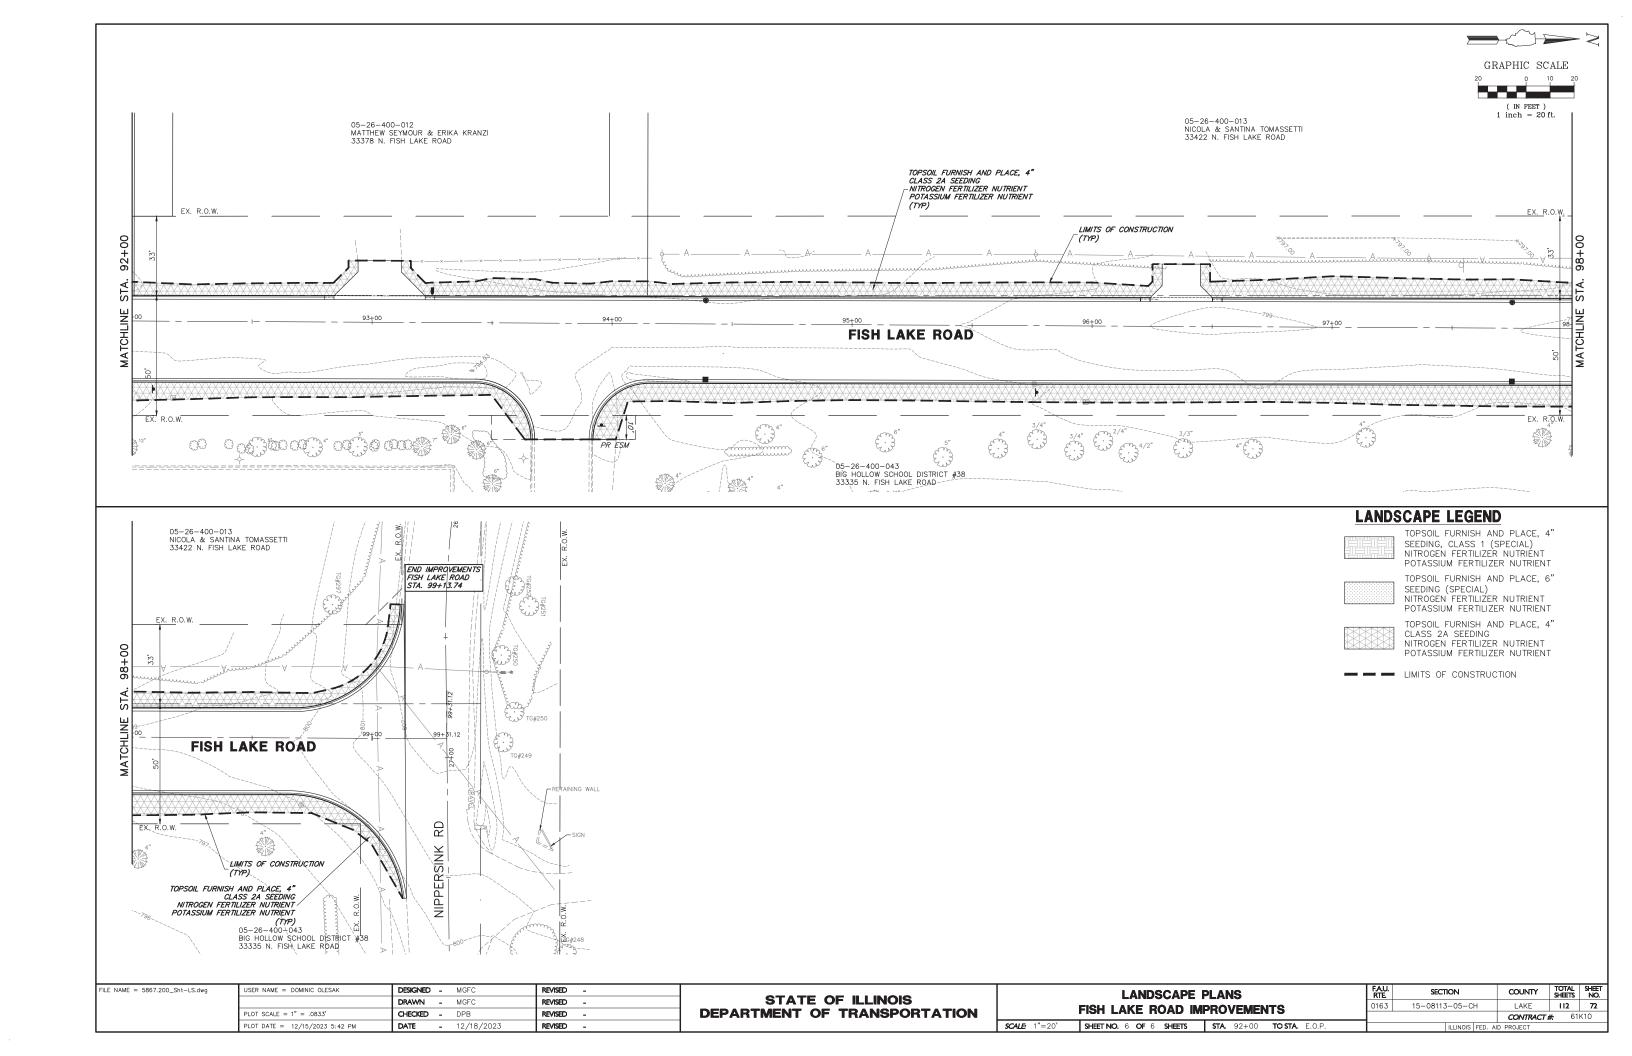

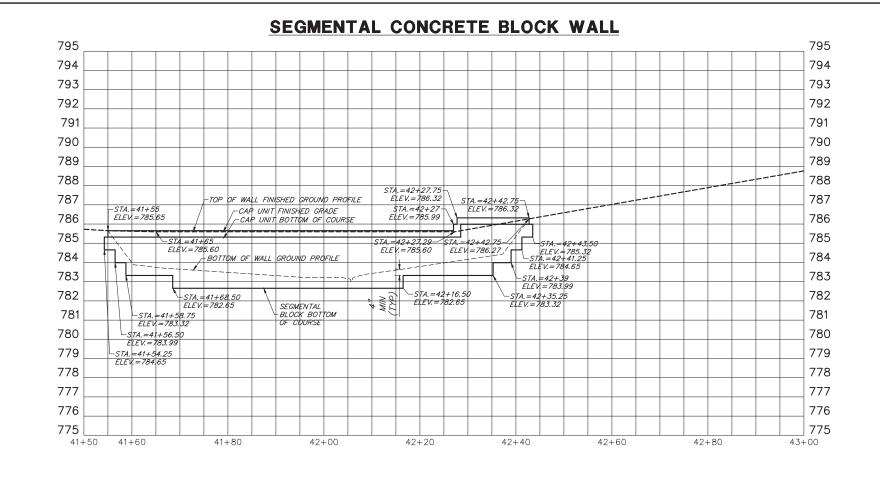

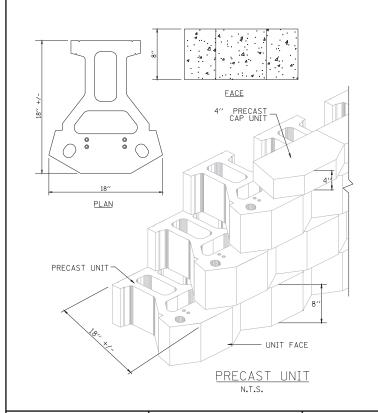


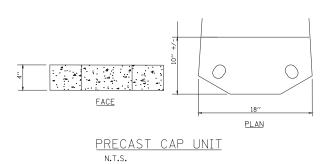

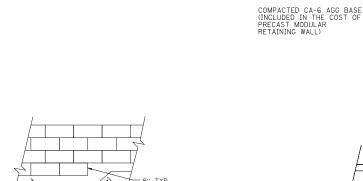

-6" COMPACTED AGGREGATE (CA-6) OR UNREINFORCED CONCRETE LEVELING PAD



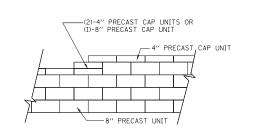

TOP OF WALL STEPS

RETAINING WALL

1.0% MIN


4" DIA. PIPE UNDERDRAIN -W/FABRIC WRAP (INCLUDED IN THE COST OF PRECAST MODULAR RETAINING WALL)


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		DRAWN - MGFC	REVISED -
	PLOT SCALE = 1" = .0833'	CHECKED - DPB	REVISED -
	PLOT DATE = 12/15/2023 6:21 PM	DATE - 12/18/2023	REVISED -

STATE OF ILLINOIS
DEPARTMENT OF TRANSPORTATION

RETAINING WALL DETAIL	FAU RTE
FISH LAKE ROAD IMPROVEMENTS	0163
SCALE: AS NOTED SHEET NO. 1 OF 2 SHEETS STA. 41+55.00 TO STA. 42+42	.75


FAU. RTE	SECTION	COUNTY	TOTAL SHEETS	SHEET NO.					
0163	15-08113-05-CH	LAKE	112	73					
CONTRACT #: 61K10									
ILLINOIS FED AID PROJECT									

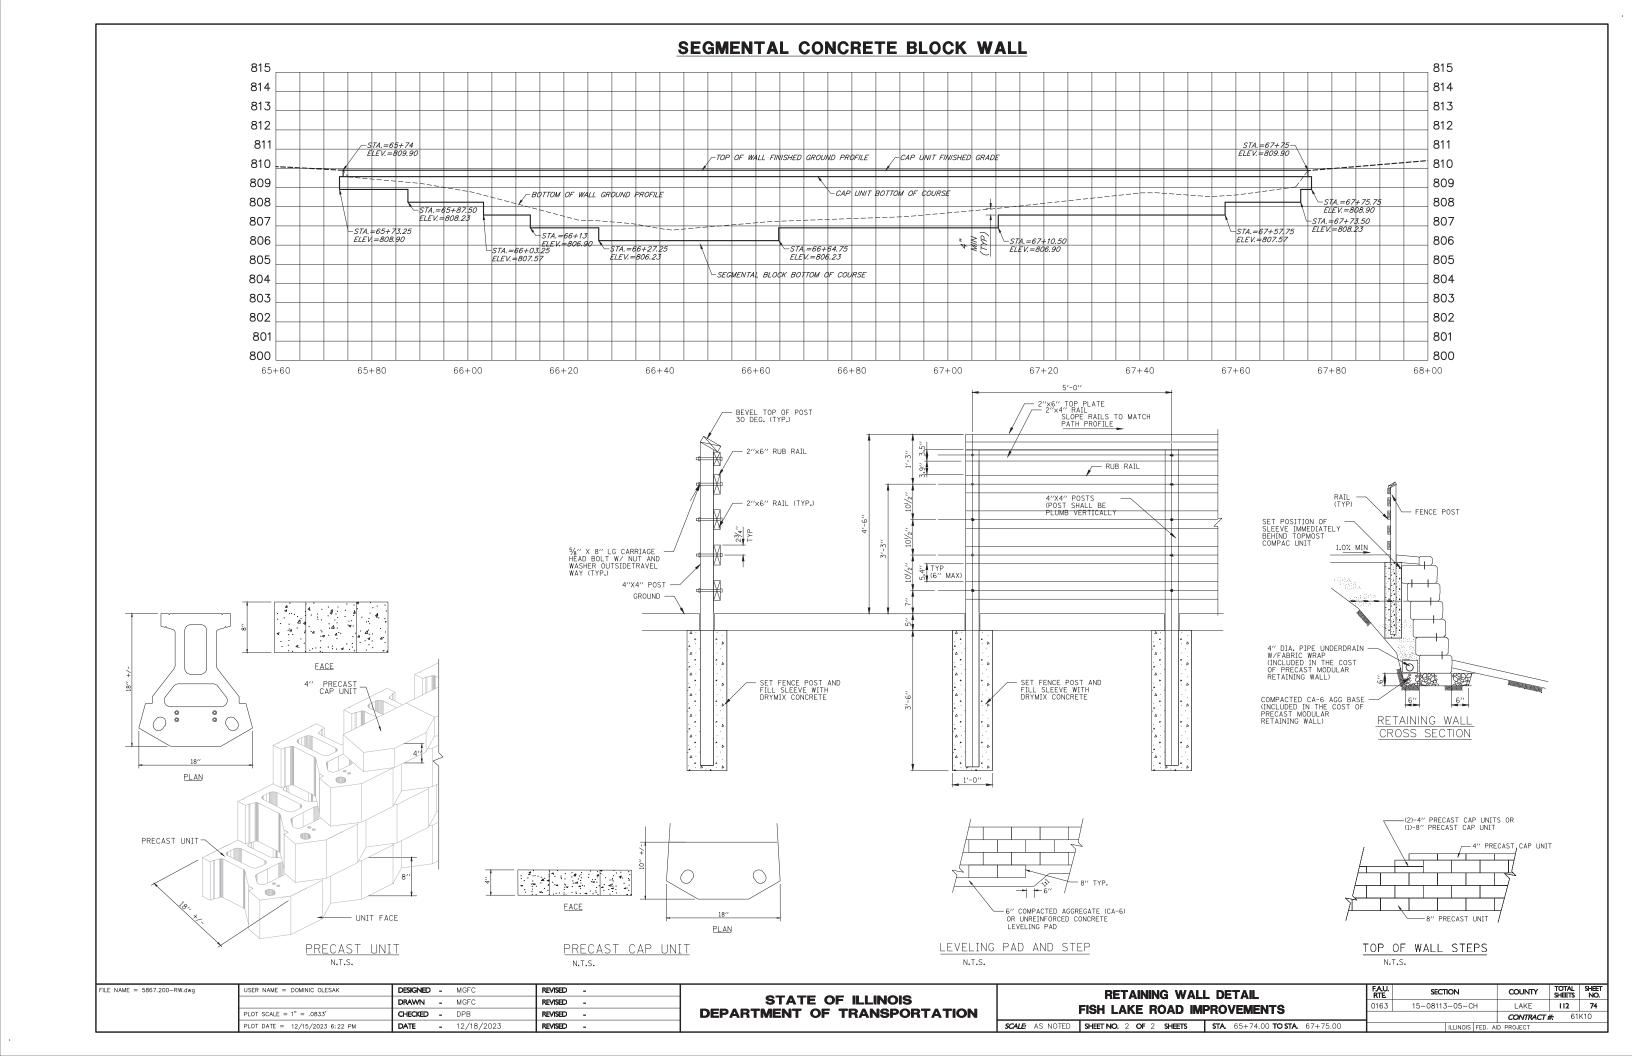

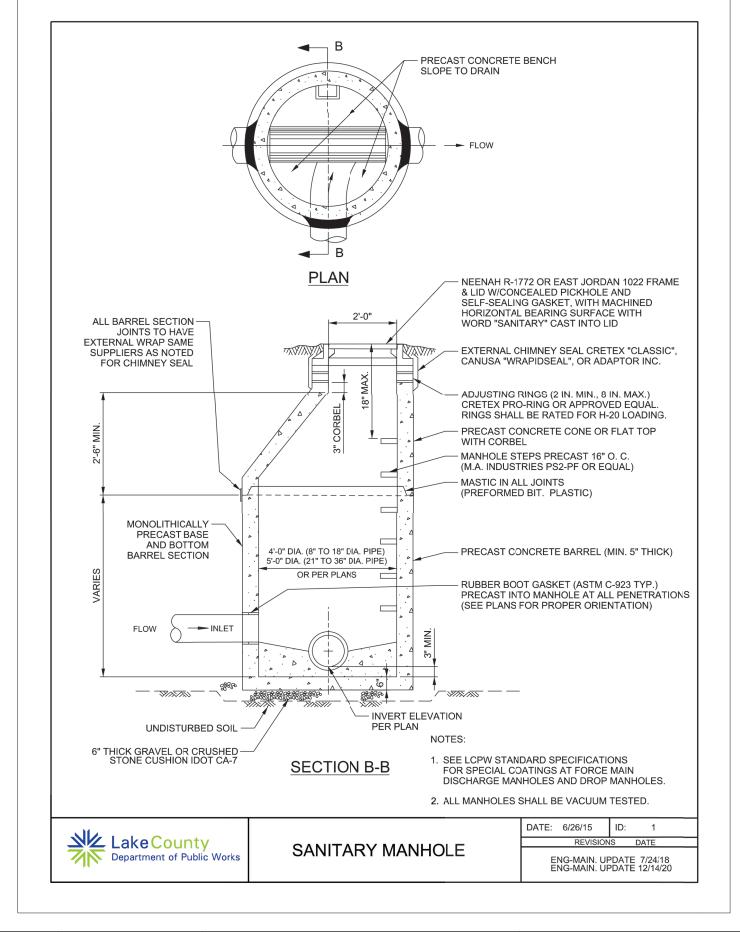

FILE NAME = 5867.200_Sht-DT.dwg	USER NAME = DOMINIC OLESAK	DRAWN -	MGFC MGFC	REVISED	-	STATE OF ILLINOIS	1	KE COUNTY PUBI
	PLOT SCALE = 1" = .0833'	CHECKED -	DPB	REVISED	-	DEPARTMENT OF TRANSPORTATION		FISH LAKE ROAD
	PLOT DATE = 12/15/2023 6:10 PM	DATE -	12/18/2023	REVISED	•		SCALE: N.A.	SHEET NO. 1 OF 1 SHEE


AKE COUNTY PUBLIC WORKS DETAILS	FAU. RTE	SECTION	COUNTY	TOTAL SHEETS	SHEET NO.
FISH LAKE ROAD IMPROVEMENTS	0163	15-08113-05-CH	LAKE	112	75
TIGHT LAKE NOAD IMPROVEMENTS	_		CONTRACT :	⊭ 61	K10
SHEET NO. 1 OF 1 SHEETS STA. TO STA.		ILLINOIS FE	ED. AID PROJECT		

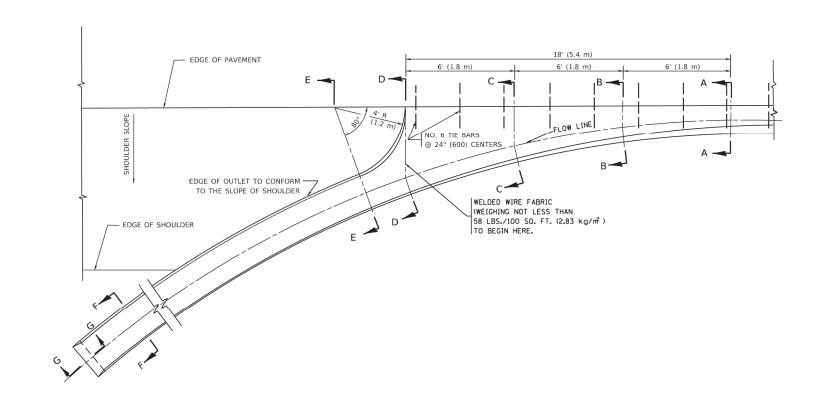




SECTION A-A *

st dimensions of the curb & gutter at section A-A ARE SHOWN ON STATE STANDARD 606001. FOR DETAILS OF OUTLET FOR CONCRETE CURB & GUTTER, TYPE B-6.24 (B-15.60) SEE STATE STANDARD 606006.

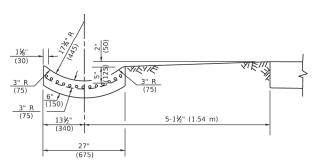




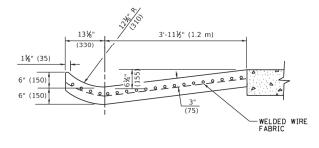


SECTION D-D

SECTION G-G

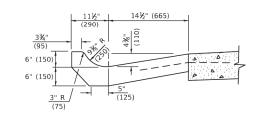

SECTION C-C

SCALE: NONE

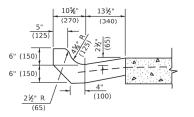

SECTION B-B

GENERAL NOTES

- 1. GUTTER OUTLET SHALL BE TIED TO THE PAVEMENT IN ACCORDANCE WITH DETAILS FOR LONGITUDINAL CONSTRUCTION JOINT SHOWN ON STANDARD 420001.
- 2. TIE BARS SHALL BE NO. 20 (NO.6) AT 24" (600) CENTERS UNLESS OTHERWISE SHOWN.
- 3. IF THE AVERAGE GRADE OF PAVEMENT FOR THE DISTANCE FROM SECTION A-A TO D-D EXCEEDS 2%, THIS DISTANCE SHALL BE INCREASED 6' (1.8 m) FOR EACH 1% INCREASE IN GRADE.

METHOD OF MEASUREMENT

FOR SECTION A-A TO E-E AND CURTAIN WALL=

1.25 CU. YDS. (0.96³m) CLASS SI CONCRETE (OUTLET) FOR 9" (225) PAV'T. $1.27\ \text{CU}.\ \text{YDS}.\ (0.96^3\text{m}\)\ \text{CLASS}\ \text{SI}\ \text{CONCRETE}\ (\text{OUTLET})\ \text{FOR}\ 10"\ (250)\ \text{PAV'T}.$ FOR SECTION F-F=

0.045 CU. YDS. (0.033m) CLASS SI CONCRETE PER ft. (m).

ALL DIMENSIONS ARE IN INCHES (MILLIMETERS) UNLESS OTHERWISE SHOWN.




STATE OF ILLINOIS **DEPARTMENT OF TRANSPORTATION**

								F.A. U. RTE. SECTION					
CURB AND GUTTER						0163	15-081	13-05-C	Н				
			001	10	AND GC	,,,,,,,,,,,,,,,,,,,,,,,,,,,,,,,,,,,,,,,		В	D600-01	(BD-03)	-	
	SHEET	1	OF	1	SHEETS	STA.	TO STA.			ILLINOIS	FED. AI	D F	


SECTION F-F


F.A. Ų. RTE.	SECTIO	N	COUNTY	TOTAL SHEETS	SHEE NO.
0163	15-08113-	05-CH	LAKE	112	76
В	D600-01 (B	D-03)	CONTRACT	NO. 61	K10
			ID DOOLEGE		

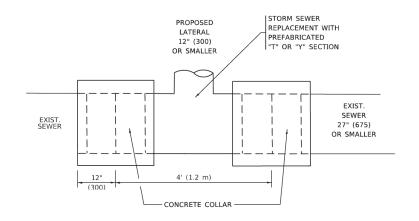


DETAIL "A"

LATERAL CONNECTION TO EXISTING SEWER OF 27" (675) OR SMALLER

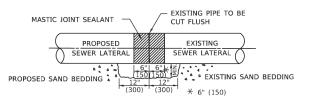

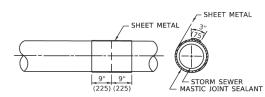

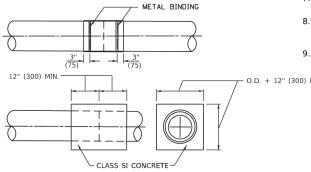

DETAIL "B"


CLASS SI CONCRETE COLLAR

CONSTRUCTION SEQUENCE

- CUT THE EXISTING END OF THE PIPE SO AS TO PRESENT A FLUSH BUTT JOINT. BRUSH AND CLEAN
 ALL PIPES
- APPLY THE MASTIC JOINT SEALANT TO THE FIRST 6" (150) OF EACH PIPE.
- BUTT THE PIPES TOGETHER LEAVING A MINIMUM OF 12' x 6' (300 x 150) DEEP EXCAVATION UNDER AND AROUND EACH PIPE END.
- CUT A PIECE OF SHEET METAL GAGE NO. 19 1.1 (0.0418) 18" (450) WIDE BY THE OUTSIDE CIRCUMFERANCE OF THE PIPE PLUS 3" (75) LONG.
- 5. WRAP THE SHEET METAL AROUND THE PIPES, 9" (225) ON EACH SIDE OF THE JOINT, STARTING AT THE TOP OF THE PIPE.
- 6. LAP THE SHEET METAL AT LEAST 3" (75)
 AT THE TOP OF THE PIPE AND PLACE THE
 MASTIC JOINT SEALANT BETWEEN THE LAP
- 7. PLACE TWO METAL BANDS AROUND THE SHEET METAL AND TIGHTEN.
- . WIPE OFF ANY EXCESS MASTIC JOINT SEALANT THAT OOZES OUT FROM BETWEEN THE SHEET METAL AND THE PIPES.

SCALE: NONE

PLACE CLASS SI CONCRETE AROUND THE JOINT.

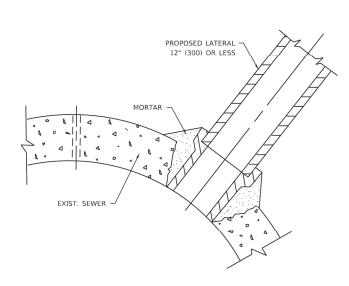

DETAIL "C"

PROPOSED LATERAL
CONNECTION TO EXISTING SEWER
OF 30" (750) OR LARGER

NOTES:

MATERIA

MATERIAL USED FOR THE TEE OR WYE SECTION SHALL BE COMPATIBLE WITH THE EXISTING STORM SEWER OR THE PROPOSED STORM SEWER.

CONSTRUCTION METHODS

- THIS WORK SHALL BE CONSTRUCTED IN CONFORMANCE WITH THE APPLICABLE PORTIONS
 OF SECTION 550 OF THE STANDARD SPECIFICATIONS.
- II. CONNECTION TO AN EXISTING STORM SEWER SHALL BE BY EITHER OF THE FOLLOWING METHODS:

 A) PROPOSED STORM SEWER CONNECTION TO EXISTING SEWER OF 27" (675) OR SMALLER SEE

 DETAIL "A" AND "B"
 - B) PROPOSED STORM SEWER CONNECTION TO EXISTING SEWER OF 30" (750) OR LARGER SEE DETAIL "C".

IF THE EXISTING SEWER PIPE IS CRACKED, BROKEN OR OTHERWISE DAMAGED BY THE CONTRACTOR IN MAKING THE CIRCULAR OPENING, THE CONTRACTOR SHALL REPLACE THAT SECTION OF PIPE WITH PIPE EQUAL AND SIMILAR IN ALL RESPECTS TO THE PIPE IN THE EXISTING SEWER, IN A CAREFUL WORKMANLIKE MANNER, WITHOUT EXTRA COMPENSATION.

FNFRAI

- CARE MUST BE TAKEN TO PREVENT DEBRIS FROM ENTERING THE SEWER. ALL DEBRIS WHICH ENTERS THE SEWER MUST BE REMOVED. THE SEWER MUST BE LEFT CLEAN AND UNOBSTRUCTED UPON COMPLETION OF THE CONTRACT.
- 2. CARE MUST BE TAKEN TO PREVENT ANY PART OF THE NEW PIPE CONNECTION FROM PROJECTING INTO THE EXISTING SEWER.

BASIS OF PAYMENT

- 1. TEE OR WYE CONNECTIONS SHALL BE PAID FOR AT THE CONTRACT UNIT PRICE EACH FOR STORM SEWER TEE OR WYE OF THE TYPE AND SIZE SPECIFIED IN THE PLANS, THIS PRICE SHALL INCLUDE ALL EXCAVATION OF THE TRENCH, REMOVAL OF THE EXISTING STORM SEWER, FURNISHING AND INSTALLING THE SPECIFIED TEE OR WYE SECTION, FURNISHING AND INSTALLING THE REQUIRED CONCRETE COLLAR, AND ALL OTHER MATERIAL NECESSARY TO COMPLETE THIS WORK AS SHOWN AND SPECIFIED.
- 2. REMOVAL AND REINSTALLATION OF EXISTING STORM SEWER ADJACENT TO THE PROPOSED TEE OR WYE SECTION, FOR THE PURPOSE OF FACILITATING THE INSTALLATION OF THE TEE OR WYE SECTION, WILL NOT BE PAID FOR SEPARATELY BUT SHALL BE INCLUDED IN THE UNIT PRICE BID FOR THE WORK.
- 3. TRENCH BACKFILL, EXCAVATION IN ROCK AND REMOVAL AND REPLACEMENT OF UNSUITABLE MATERIAL BELOW PLAN BEDDING GRADE WILL BE PAID FOR SEPARATELY.
- 4. CONCRETE COLLAR FOR CONNECTING A PROPOSED STORM SEWER TO AN EXISTING STORM SEWER WILL NOT BE PAID PAID FOR SEPARATELY BUT SHALL BE INCLUDED IN THE COST OF THE PROPOSED STORM SEWER.

* ALL DIMENSIONS ARE IN INCHES (MILLIMETERS) UNLESS OTHERWISE SHOWN.

USER NAME = Lawrence.DeManche	DESIGNED - M. DE YONG	REVISED - R. SHAH 09-09-94
	DRAWN -	REVISED - R. SHAH 10-25-94
PLOT SCALE = 100.0000 ' / in.	CHECKED -	REVISED - R. SHAH 06-12-96
PLOT DATE = 11/18/2022	DATE - 07-25-90	REVISED - K. SMITH 11-18-22

STATE OF ILLINOIS
DEPARTMENT OF TRANSPORTATION


DETAIL OF STORM SEWER CONNECTION TO EXISTING SEWER								
	SHEET	1	OF	1	SHEETS	STA.		TO STA.

F.A.U. RTE. SECTION COUNTY TOTAL SHEETS NO.
0163 15-08113-05-CH LAKE II2 77

BD500-01 (BD-07) CONTRACT NO. 61K10

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MODEL: Default

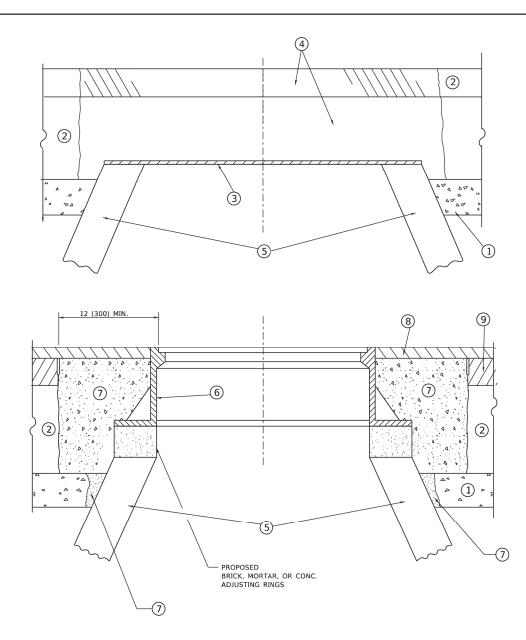

DETAILS FOR FRAMES AND LIDS ADJUSTMENT WITH MILLING

NOTES

- 1. EXISTING BROKEN FRAMES AND LIDS SHALL BE REMOVED AND DISPOSED OF BY THE CONTRACTOR AND SHALL BE REPLACED AS DIRECTED BY THE ENGINEER. REPLACEMENT FRAMES AND LIDS WILL BE PAID FOR IN ACCORDANCE WITH ARTICLE 109.04 OF THE STANDARD SPECIFICATIONS UNLESS A SEPARATE PAY ITEM HAS BEEN PROVIDED.
- IF THE EXISTING LIDS ARE OPEN, THE FRAME WILL BE ADJUSTED TO THE ELEVATION OF THE MILLED PAVEMENT SURFACE PRIOR TO THE MILLING OPERATION. THE FRAME WILL NOT BE REMOVED AND COVERED BY THE METAL PLATE.
- 3. CITY OF CHICAGO CASTINGS ARE THE PROPERTY OF THE CITY AND THE CONTRACTOR SHALL NOTIFY THE CITY FOR REMOVAL AND DISPOSITION OF THE CASTINGS.
- 4. THE METAL PLATE USED TO COVER THE STRUCTURE SHALL REMAIN THE PROPERTY OF THE CONTRACTOR.
- THE CONTRACTOR SHALL REMOVE ALL TRAFFIC CONTROL DEVICES BY THE END OF EACH WORK SHIFT.

. ,_______

STAGE 1 (BEFORE PAVEMENT MILLING)

CONSTRUCTION PROCEDURES

- A) REMOVE A MINIMUM OF 12 (300) OF THE PAVEMENT FROM AROUND THE STRUCTURE.
- B) REMOVE THE EXISTING FRAME AND LID FROM THE STRUCTURE.
- C) COVER THE STRUCTURE OPENING WITH A 36 (900) DIAMETER METAL PLATE
- D) BACKFILL WITH CRUSHED STONE AND HMA SURFACE MIX APPROVED BY THE ENGINEER. (MIN. 3 (80) HMA TO REMAIN AFTER MILLING).

STAGE 2 (AFTER PAVEMENT MILLING)

- A) REMOVE THE HMA SURFACE MIX AND CRUSHED STONE.
- B) INSTALL THE FRAME AND LID; ADJUST THE FRAME TO ITS FINAL SURFACE ELEVATION.
- C) THE SURROUNDING SPACE SHALL BE FILLED WITH CLASS PP-2* CONCRETE TO THE ELEVATION OF THE SURFACE OF THE EXISTING BASE COURSE OR THE BINDER COURSE.
- *UNLESS OTHERWISE SPECIFIED IN THE PLANS.

THE PROCEDURE EXPLAINED ABOVE SHALL CONFORM TO THE APPLICABLE PORTIONS OF SECTIONS 353, 406, 602, AND 603 OF THE STANDARD SPECIFICATIONS EXCEPT THAT "THE CONTRACTOR SHALL ADJUST THE STRUCTURES TO THE FINISHED PAVEMENT ELEVATION NO MORE THAN 5 CALENDAR DAYS PRIOR TO PLACEMENT OF THE FINAL LIFT OF SURFACE UNLESS APPROVED BY THE ENGINEER."

LEGEND

- ① SUB-BASE GRANULAR MATERIAL
- (6) FRAME AND LID (SEE NOTES)
- (2) EXISTING PAVEMENT
- (7) CLASS PP-2* CONCRETE
- 3 36 (900) DIAMETER METAL PLATE
- 8 PROPOSED HMA SURFACE COURSE
- PROPOSED CRUSHED STONE AND HMA SURFACE MIX
 - (9) PROPOSED HMA BINDER COURSE
- (5) EXISTING STRUCTURE

LOCATION OF STRUCTURES

THE CONTRACTOR WILL BE REQUIRED TO KEEP A RECORD OF THE LOCATIONS OF THE BURIED STRUCTURES ACCORDING TO THE STATION AND DISTANCE LEFT OR RIGHT OF THE CENTERLINE OF PAVEMENT. UPON COMPLETION OF THE WORK, THE CONTRACTOR WILL DELIVER THE RECORD TO THE ENGINEER.

BASIS OF PAYMENT

- 1. REMOVING FRAMES AND LIDS ON DRAINAGE AND UTILITY STRUCTURES IN THE PAVEMENT PRIOR TO MILLING, AND ADJUSTING TO FINAL GRADE PRIOR TO PLACING THE SURFACE COURSE, WILL BE PAID FOR AT THE CONTRACT UNIT PRICE EACH FOR "FRAMES AND LIDS TO BE ADJUSTED (SPECIAL)."
- THIS WORK WILL NOT BE PAID FOR WHEN DRAINAGE AND UTILITY STRUCTURES ARE SPECIFIED FOR PAYMENT AS STRUCTURE RECONSTRUCTION.
- NEW FRAMES AND LIDS, WHEN SPECIFIED, WILL BE PAID FOR SEPARATELY.
- 4. WHEN STRUCTURES ARE TO BE ADJUSTED OR RECONSTRUCTED, THE LOWERING AND RAISING OF THE FRAMES AND LIDS WILL NOT BE PAID FOR SEPARATELY BUT WILL BE INCLUDED IN THE COST OF THE CORRESPONDING PAY ITEM.


ALL DIMENSIONS ARE IN INCHES (MILLIMETERS) UNLESS OTHERWISE SHOWN

LAKE

CONTRACT NO. 61K10


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STATE OF ILLINOIS
DEPARTMENT OF TRANSPORTATION

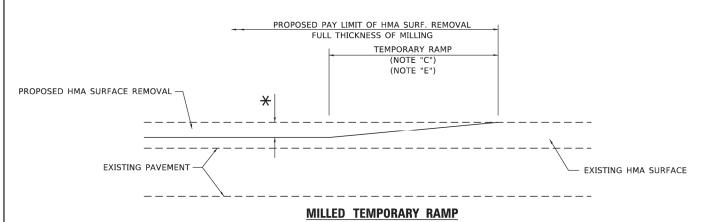

(FOR BUTT JOINT AND HMA TAPER SEE DETAIL BELOW)

OPTION 1

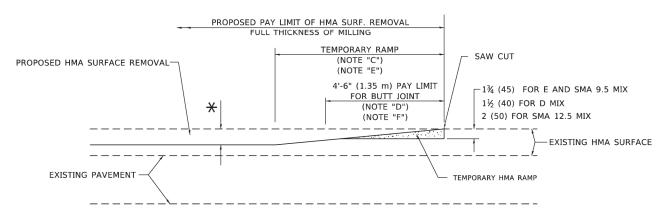


HMA CONSTRUCTED TEMPORARY RAMP

(FOR BUTT JOINT AND HMA TAPER SEE DETAIL BELOW)

OPTION 2

TYPICAL TEMPORARY RAMP

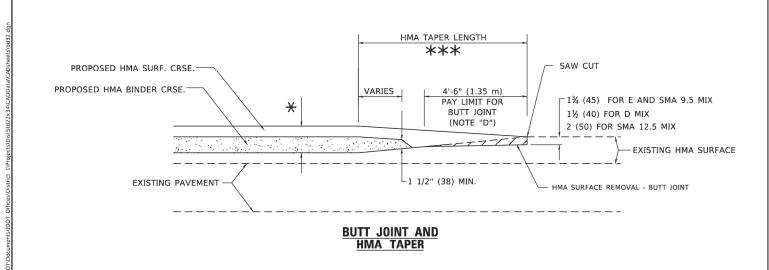

TYPICAL BUTT JOINT AND HMA TAPER FOR MILLING AND RESURFACING


 USER NAME
 = Lawrence.DeManche
 DESIGNED
 M. DE YONG
 REVISED
 A. ABBAS 03-21-97


 DRAWN
 REVISED
 M. GOMEZ 04-06-01

 PLOT SCALE
 = 100.0000 ' / in.
 CHECKED
 REVISED
 R. BORO 01-01-07

 PLOT DATE
 = 11/18/2022
 DATE
 06-13-90
 REVISED
 K. SMITH 11-18-22

STATE OF ILLINOIS DEPARTMENT OF TRANSPORTATION

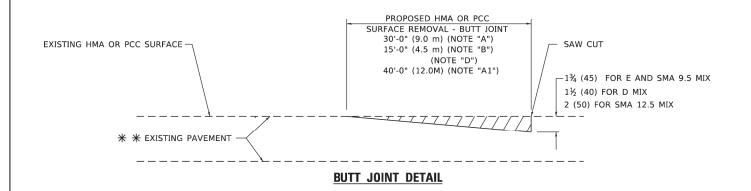

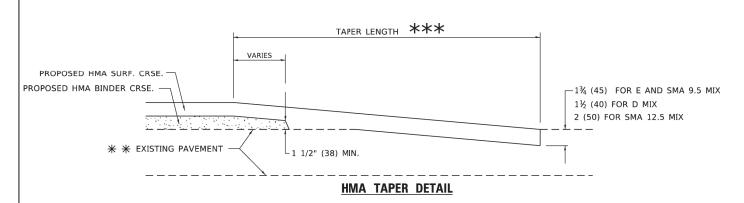

TYPICAL BUTT JOINT AND HMA TAPER FOR RESURFACING ONLY

** PC CONCRETE, HMA OR HMA RESURFACED PAVEMENT.

GENERAL NOTES


- A. MAINLINE ARTERIAL ROADWAYS AND MAJOR SIDE ROADS.
- A1. INTERSTATES
- B. MINOR SIDE ROADS.
- C. THE TEMP. RAMP SHALL BE CONSTRUCTED IMMEDIATELY UPON REMOVAL OF THE EXISTING HMA SURFACE.
- D. THE BUTT JOINT SHALL BE CONSTRUCTED IMMEDIATELY PRIOR TO PLACING THE PROPOSED HMA COURSES.
- E. TAPER THE TEMP. RAMP AT A RATE OF 3' 4" (1.02m) PER 1 INCH (25 mm) OF MILLING THICKNESS.
 - igstar SEE TYPICAL SECTIONS FOR MILLING THICKNESS.
- F. SEE ARTICLE 406.08 AND 406.14 OF THE STANDARD SPECIFICATIONS FOR "HMA AND/OR PCC SURFACE REMOVAL, BUTT JOINT".
- ***
 20'-0" (6.1 m) PER 1 (25) RESURFACING (NOTE "A")
 10'-0" (3.0 m) PER 1 (25) RESURFACING (NOTE "B")

BASIS OF PAYMENT

- THE BUTT JOINT WILL BE PAID FOR AT THE CONTRACT UNIT PRICE PER SQUARE YARD (SQUARE METER) FOR "HOT-MIX ASPHALT SURFACE REMOVAL - BUTT JOINT" OR FOR "PORTLAND CEMENT CONCRETE SURFACE REMOVAL- BUTT JOINT".
- THE TEMPORARY RAMP AND SAW CUT SHALL BE INCLUDED IN THE UNIT COST FOR HMA OR PCC SURFACE REMOVAL-BUTT JOINT.

SCALE: NONE

ALL DIMENSIONS ARE IN INCHES (MILLIMETERS) UNLESS OTHERWISE SHOWN.

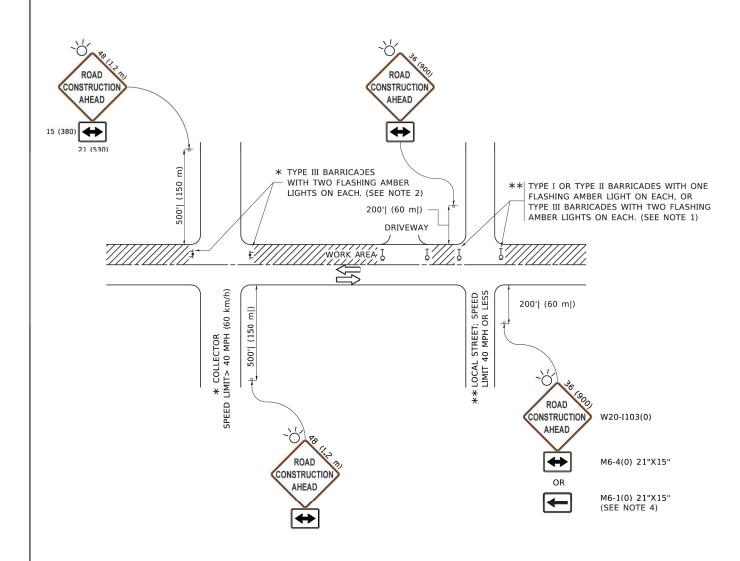

NOTES:

- 1. SIDE ROAD WITH A SPEED LIMIT OF 40 MPH (60 km/h) OR LESS AS SHOWN ON THE DRAWING AND AS DIRECTED BY THE ENGINEER:
- a) ONE "ROAD CONSTRUCTION AHEAD" SIGN 36 x 36 (900x900) WITH A FLASHER MOUNTED ON IT APPROXIMATELY 200' (60 m) IN ADVANCE OF THE MAIN ROUTE.
- b) THE CLOSED PORTION OF THE MAIN ROUTE SHALL BE PROTECTED BY BLOCKING WITH TYPE I, TYPE II OR TYPE III BARRICADES, 1/3 OF THE CROSS SECTION OF THE CLOSED PORTION.
- 2. SIDE ROAD WITH A SPEED LIMIT GREATER THAN 40 MPH (60 km/h) AS SHOWN ON THE DRAWING AND AS DIRECTED BY THE ENGINEER:
- a) ONE "ROAD CONSTRUCTION AHEAD" SIGN 48 x 48 (1.2 m x 1.2 m) WITH A FLASHER MOUNTED ON IT APPROXIMATELY 500' (150 m) IN ADVANCE OF THE MAIN ROUTE.
- THE CLOSED PORTION OF THE MAIN ROUTE SHALL BE PROTECTED BY
 b) BLOCKING WITH TYPE III BARRICADES, 1/2 OF THE CROSS SECTION
 OF THE CLOSED PORTION.
- CONES MAY BE SUBSTITUTED FOR BARRICADES OR DRUMS AT HALF THE SPACING DURING DAY OPERATIONS. CONES SHALL BE A MINIMUM OF 28 (710) IN HEIGHT.
- WHEN THE SIDE ROAD LIES BETWEEN THE BEGINNING OF THE MAINLINE
 4. SIGNING AND THE WORK ZONE, A SINGLE HEADED ARROW (M6-1) SHALL
 BE USED IN LIEU OF THE DOUBLE HEADED ARROW (M6-4).


- 5. WHEN WORK IS BEING PERFORMED ON A SIDE ROAD OR DRIVEWAY, FOLLOW THE APPLICABLE STANDARD(S). THE DIRECTIONAL ARROW (M6-1 OR M6-4) SHALL BE COVERED OR REMOVED WHEN NO LONGER CONSISTENT WITH THE TRAFFIC CONTROL SET-UP.
- 6. ADVANCE WARNING SIGNS ARE TO BE OMITTED ON DRIVEWAYS UNLESS OTHERWISE SPECIFIED IN THE PLANS OR BY THE ENGINEER
- THE TRAFFIC CONTROL AND PROTECTION FOR SIDE ROADS, INTERSECTIONS, AND DRIVEWAYS SHALL BE INCLUDED IN THE COST OF SPECIFIED TRAFFIC CONTROL STANDARDS OR ITEMS.


All dimensions are in inches (millimeters) unless otherwise shown.

STATE OF ILLINOIS
DEPARTMENT OF TRANSPORTATION

TRAFFIC CONTROL AND PROTECTION FOR SIDE ROADS, INTERSECTIONS, AND DRIVEWAYS

| SHEET 1 OF 1 SHEETS STA. TO STA

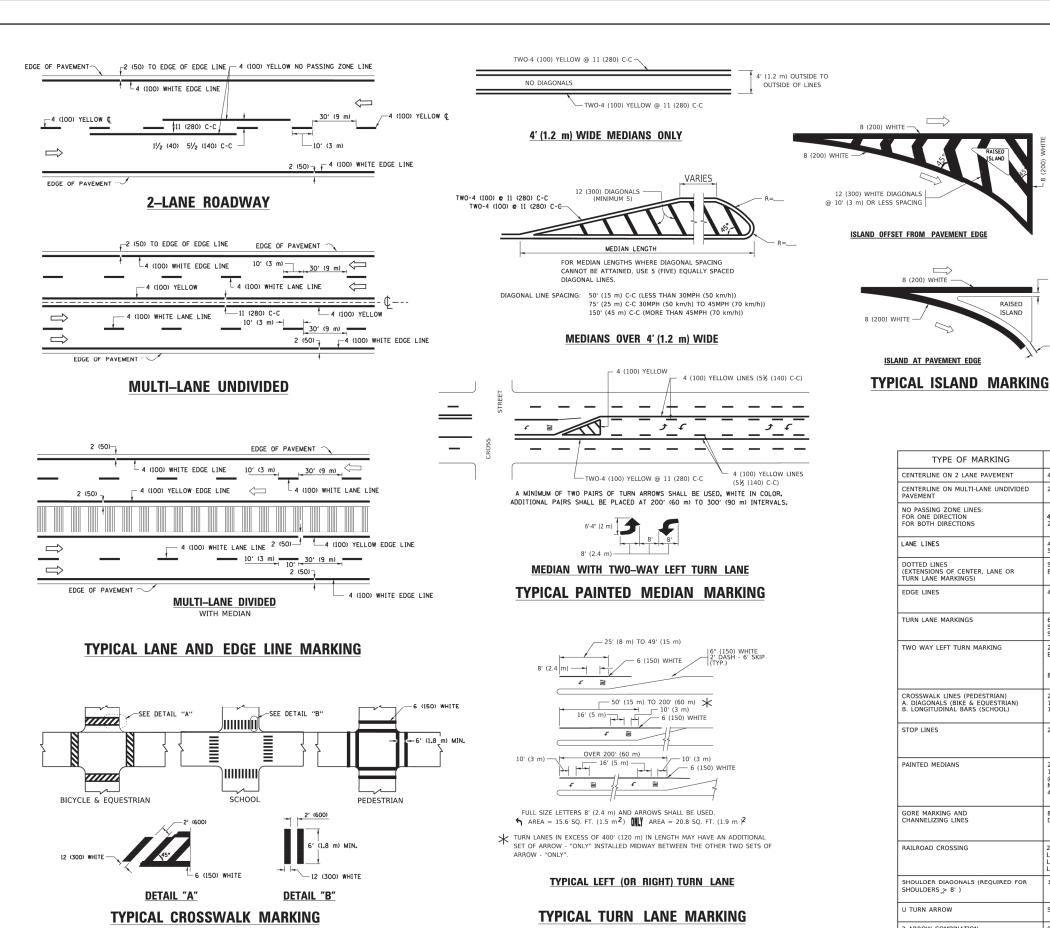

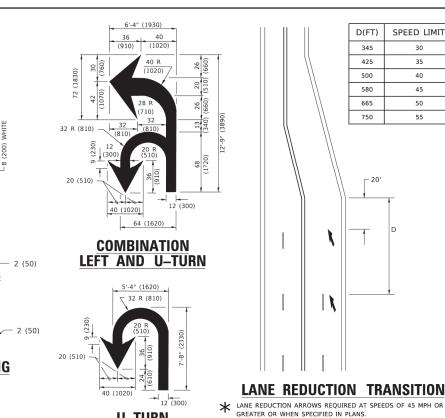

WIDTH OF LINE PATTERN TYPE OF MARKING COLOR SPACING / REMARKS SKIP-DASH CENTERLINE ON 2 LANE PAVEMENT SOLID NO PASSING ZONE LINES: FOR ONE DIRECTION FOR BOTH DIRECTIONS 5½ (140) C-C FROM SKIP-DASH CENTERLINE 11 (280) C-C OMIT SKIP-DASH CENTERLINE BETWEEN 4 (100) 2 @ 4 (100) LANE LINES SKIP-DASH SKIP-DASH 10' (3 m) LINE WITH 30' (9 m) SPACE 4 (100) 5 (125) ON FREEWAYS DOTTED LINES (EXTENSIONS OF CENTER, LANE OR TURN LANE MARKINGS) SAME AS LINE BEING EXTENDED SAME AS LINE BEING EXTENDED 2' (600) LINE WITH 6' (1.8 m) SPACE SKIP-DASH EDGE LINES 4 (100) SOLID YELLOW-LEFT WHITE-RIGHT OUTLINE MEDIANS IN YELLOW 6 (150) LINE; FULL SIZE LETTERS & SYMBOLS (8' (2.4m) TURN LANE MARKINGS SOLID SEE TYPICAL TURN LANE MARKING DETAIL SKIP-DASH AND SOLID IN PAIRS 10' (3 m) LINE WITH 30' (9 m) SPACE FOR SKIP-DASH; 5½ (140) C-C BETWEEN SOLID TWO WAY LEFT TURN MARKING 2 @ 4 (100) EACH DIRECTION LINE AND SKIP-DASH LINE SEE TYPICAL TWO-WAY LEFT TURN MARKING DETAIL 8' (2.4m) LEFT ARROW CROSSWALK LINES (PEDESTRIAN) A. DIAGONALS (BIKE & EQUESTRIAN) B. LONGITUDINAL BARS (SCHOOL) NOT LESS THAN 6' (1.8 m) APART 2' (600) APART 2' (600) APART SOLID SOLID SEE TYPICAL CROSSWALK MARKING DETAILS. PLACE 4' (1.2 m) IN ADVANCE OF AND
PARALLEL TO CROSSWALK, IF PRESENT.
OTHERWISE, PLACE AT DESIRED STOPPING
POINT. PARALLEL TO CROSSROAD CENTERLINE, WHERE
POSSIBLE STOP LINES 24 (600) SOLID WHITE 2 @ 4 (100) WITH 12 (300) DIAGONALS @ 45° NO DIAGONALS USED FOR 4' (1.2 m) WIDE MEDIANS 11 (280) C-C FOR THE DOUBLE LINE SEE TYPICAL PAINTED MEDIAN MARKING. PAINTED MEDIANS SOLID YELLOW: TWO WAY TRAFFIC WHITE: ONE WAY TRAFFIC DIAGONALS: 15' (4.5 m) C-C (LESS THAN 30MPH (50 km/h)) 20' (6 m) C-C 30MPH (50 km/h) TO 45MPH (70 km/h)) 30' (9 m) C-C (OVER 45MPH (70 km/h)) 24 (600) TRANSVERSE LINES; "RR" IS 6' (1.8 m) LETTERS; 16 (400) LINE FOR "X" RAILROAD CROSSING SOLID WHITE SEE STATE STANDARD 780001 AREA OF: "R"=3.6 SQ. FT. (0.33 m 2EACH "X"=54.0 SQ. FT. (5.0 m 2 50' (15 m) C-C (LESS THAN 30MPH (50 km/h)) 75' (25 m) C-C (30 MPH (50 km/h) TO 45MPH (70 km/h)) 150' (45 m) C-C (OVER 45MPH (70 km/h)) SHOULDER DIAGONALS (REQUIRED FOR 12 (300) @ 45 SOLID WHITE - RIGHT YELLOW - LEFT SHOULDERS > 8') U TURN ARROW SEE DETAIL SOLID WHITE 2 ARROW COMBINATION LEFT AND U TURN SEE DETAIL SOLID WHITE 30.4 SF

U-TURN

FOR FURTHER DETAILS ON PAVEMENT MARKING REFER TO STANDARD SPECIFICATIONS FOR ROAD AND BRIDGE CONSTRUCTION AND STATE STANDARD 780001.

SCALE: NONE

RAISED


ISLAND

USER NAME = footemj	DESIGNED	-	EVERS	REVISED	-	C. JUCIUS 09-09-09
	DRAWN	-		REVISED	-	C. JUCIUS 07-01-13
PLOT SCALE = 50.0000 ' / in.	CHECKED	-		REVISED	-	C. JUCIUS 12-21-15
PLOT DATE = 3/4/2019	DATE	-	03-19-90	REVISED	-	C. JUCIUS 04-12-16

* MARKINGS SHALL BE INSTALLED PARALLEL TO THE CENTERLINE OF


STATE OF ILLINOIS **DEPARTMENT OF TRANSPORTATION**

DISTRICT ONE						F.A. U. RTE. SECTION		COUNTY	TOTAL SHEETS	SHEET NO.
TYPICAL PAVEMENT MARKINGS				0163	15-08113-05-CH	LAKE	112	81		
TITICAL PAVEIMENT INIANKINGS					TC-13 CONTRACT NO. 6			NO. 61	K10	
	SHEET 1	OF 2	SHEETS	STA.	TO STA.		ILLINOIS FED. A	D PROJECT		

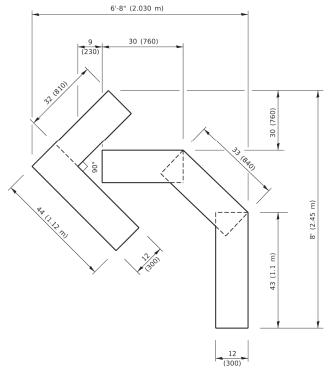


QUANTITY

4 (100) LINE = 45.5 ft. (13.9 m) 15.2 sq. ft. (1.41 sq. m)

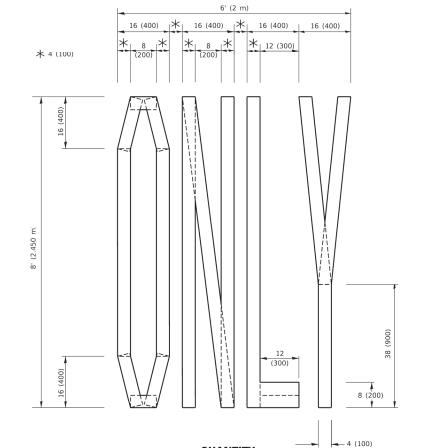

QUANTITY4 (100) LINE = 64.1 ft. (19.5 m)

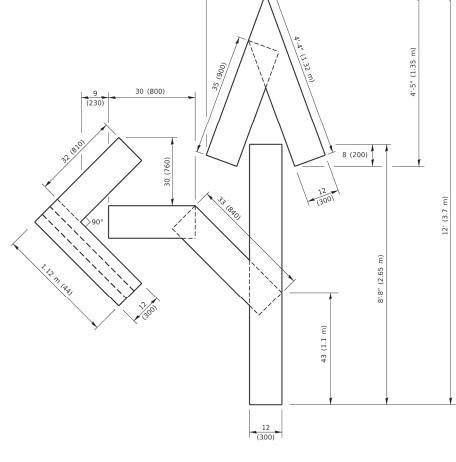


1'-8" (500)

QUANTITY

4 (100) LINE = 82.5 ft. (25.1 m) 27.5 sq. ft. (2.53 sq. m)

NOTE:

ALL QUANTITIES OF PLACEMENT ARE REPRESENTED IN LINEAR FEET OF 4" LINES TO MATCH THE 4" TEMPORARY TAPE PAY ITEM AND REPRESENTS THE TOTAL QUANTITY OF 4" TAPE REQUIRED.

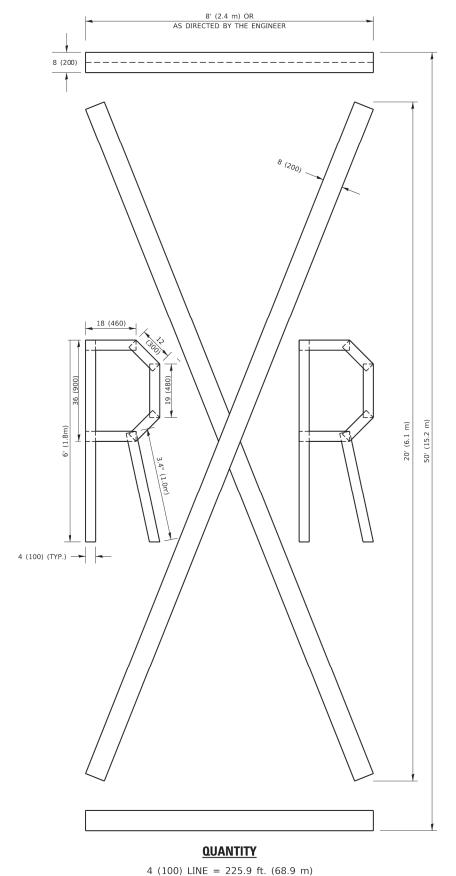

4 (100) LINE = 225.9 ft. (68.9 m)75.3 sq. ft. (6.99 sq. m)

All dimensions are in inches (millimeters) unless otherwise shown.


USER NAME = footemj	DESIGNED -	REVISED	- T. RAMMACHER 03-02-98
	DRAWN -	REVISED	- E. GOMEZ 08-28-00
PLOT SCALE = 50.0068 ' / in.	CHECKED -	REVISED	- E. GOMEZ 08-28-00
PLOT DATE = 3/4/2019	DATE - 09-18-94	REVISED	- A. SCHUETZE 09-15-16


21.4 sq. ft. (1.99 sq. m)

STATE OF ILLINOIS
DEPARTMENT OF TRANSPORTATION

SHORT TE	RM	PAV	EMENT	MARKING	G LETTERS	AND SYMBOLS	
SCALE: NONE	SHEET	Г 1	OF 1	SHEETS	STA.	TO STA.	_

F.A. Ų. RTE.	SEC	TION		COUNTY	TOTAL SHEETS	SHEE NO.
0163	15-08113	3-05-C	LAKE	112	82	
	TC-16		CONTRACT	NO. 61	K10	
		ILLINOIS	FED. A	ID PROJECT		

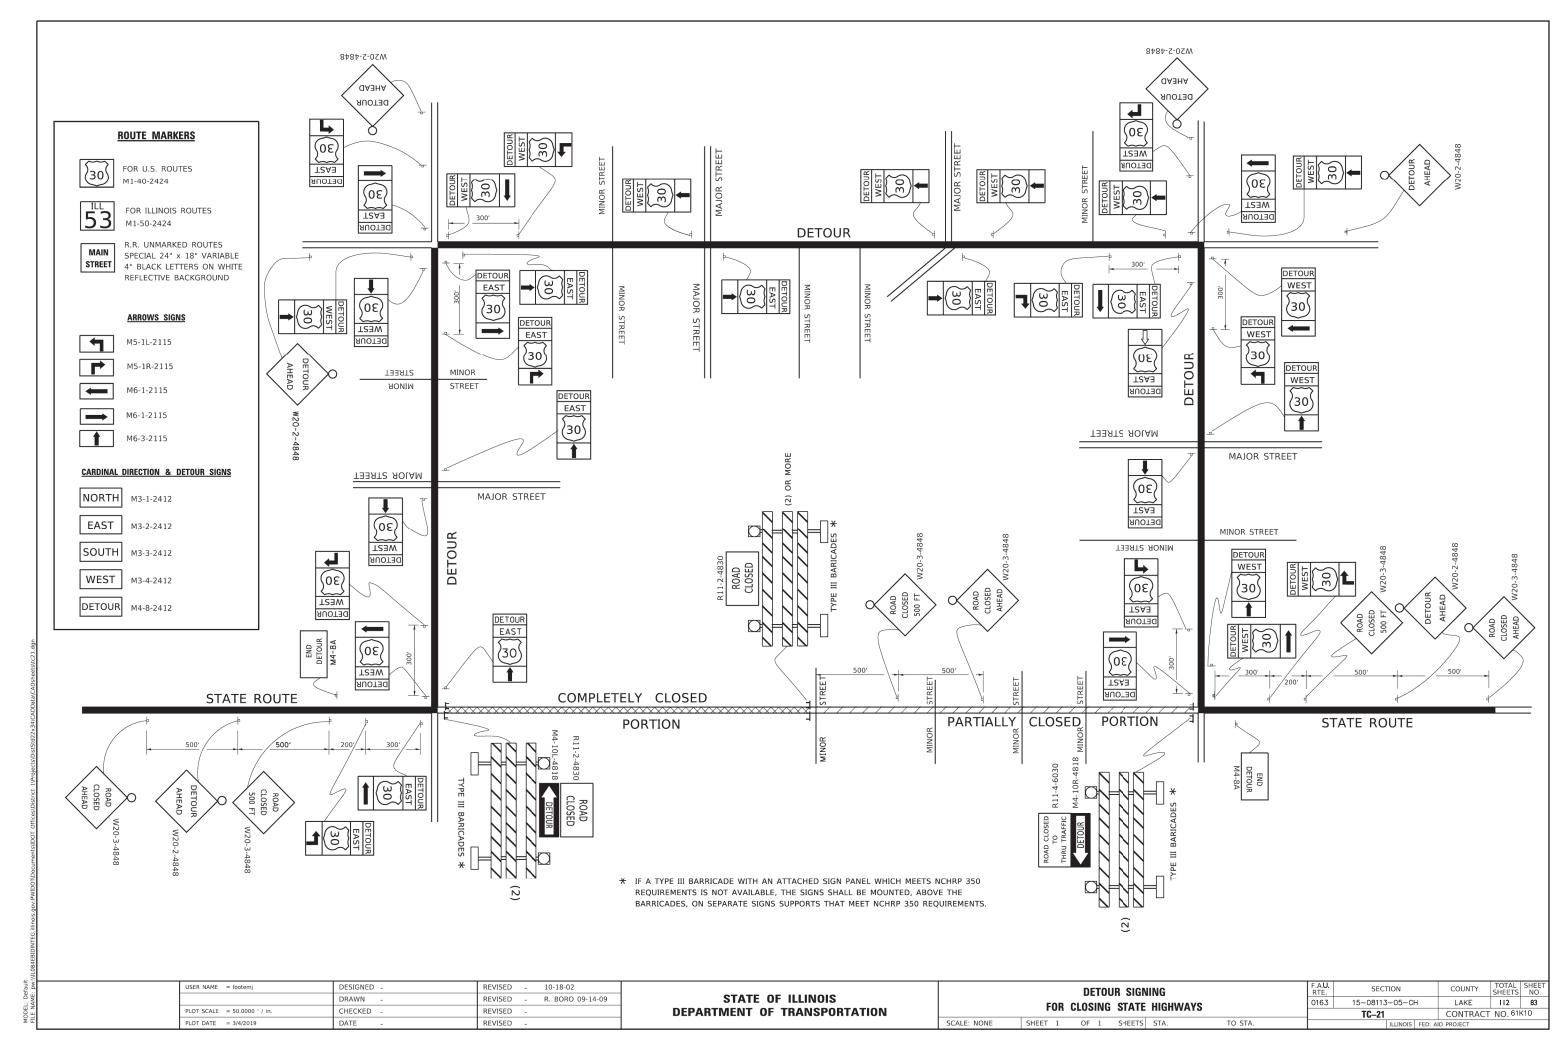

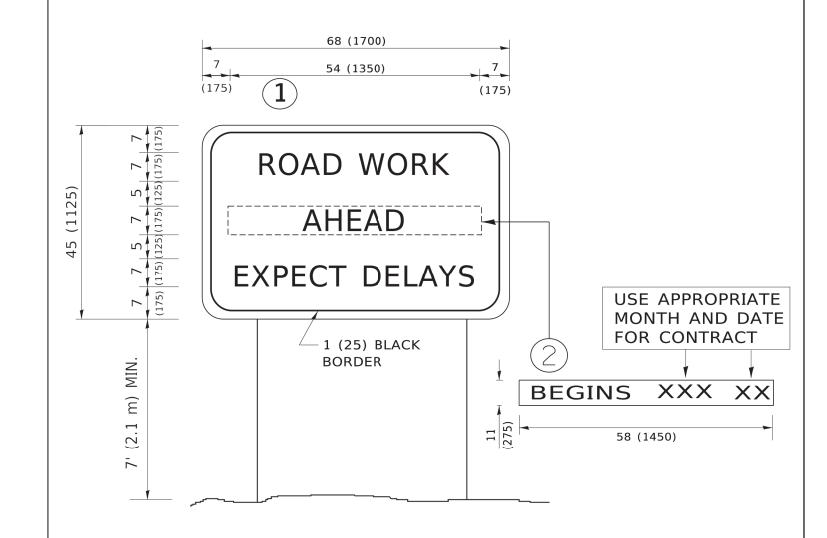

NOTES:

- 1. USE BLACK LETTERING ON ORANGE BACKGROUND.
- 2. ERECT SIGNS IN ADVANCE OF THE LOCATION FOR THE "ROAD CONSTRUCTION AHEAD" SIGN AT LOCATIONS AS DIRECTED BY THE ENGINEER.
- 3. ERECT SIGN(1)WITH INSTALLED PANEL(2)ONE WEEK PRIOR TO THE START OF CONSTRUCTION.
- 4. REMOVE PANEL(2)SOON AFTER THE START OF CONSTRUCTION.
- 5. SEE SPECIAL PROVISION FOR "TEMPORARY INFORMATION SIGNING" FOR ADDITIONAL INFORMATION.
- 6. ONE SIGN ASSEMBLY EQUALS 25.70 SQ. FT. (2.3 SQ. M.)
- 7. SHALL BE PAID FOR AS TEMPORARY INFORMATION SIGNING.

ALL DIMENSIONS ARE IN INCHES (MILLIMETERS) UNLESS OTHERWISE SHOWN.

USER NAME = footemj	DESIGNED -	REVISED - R. MIRS 09-15-97		ARTERIAL ROAD	F.A.L		COUNTY TOTAL SHEET NO.
	DRAWN -	REVISED - R. MIRS 12-11-97	STATE OF ILLINOIS		016	3 15-08113-05-CH	LAKE II2 84
PLOT SCALE = 50.0000 ' / in.	CHECKED -	REVISED -T. RAMMACHER 02-02-99	DEPARTMENT OF TRANSPORTATION	INFORMATION SIGN		TC-22	CONTRACT NO. 61K10
PLOT DATE = 3/4/2019	DATE -	REVISED - C. JUCIUS 01-31-07		SCALE: NONE SHEET 1 OF 1 SHEETS STA. TO STA.		ILLINOIS FED. A	ID PROJECT



3.0" RADIUS, 0.5" BORDER, WHITE ON GREEN; REFLECTORIZED "DRIVEWAY" D; "ENTRANCE" D; STANDARD ARROW CUSTOM 12.0" x 5.0"

NOTES:

- 1. HALF OF THE SIGNS WILL REQUIRE A LEFT HAND FACING ARROW.
- 2. TWO SIGNS SHALL BE USED AT EACH COMMERCIAL ENTRANCE PLACED BACK-TO-BACK: ONE WITH A RIGHT HAND ARROW (SHOWN) SHALL BE PLACED ON THE NEAR RIGHT SIDE THE DRIVEWAY AND ONE WITH A LEFT HAND ARROW SHALL BE PLACED ON THE FAR LEFT SIDE OF THE DRIVEWAY.
- 3. SIGNS TO BE PAID FOR AS ITEM "TEMPORARY INFORMATION SIGNING".

 USER NAME
 = leysa
 DESIGNED
 REVISED
 C. JUCIUS 02-15-07


 DRAWN
 REVISED

 PLOT SCALE
 = 50.0000 ' / in.
 CHECKED
 REVISED

 PLOT DATE
 = 8/6/2021
 DATE
 REVISED


STATE OF ILLINOIS
DEPARTMENT OF TRANSPORTATION



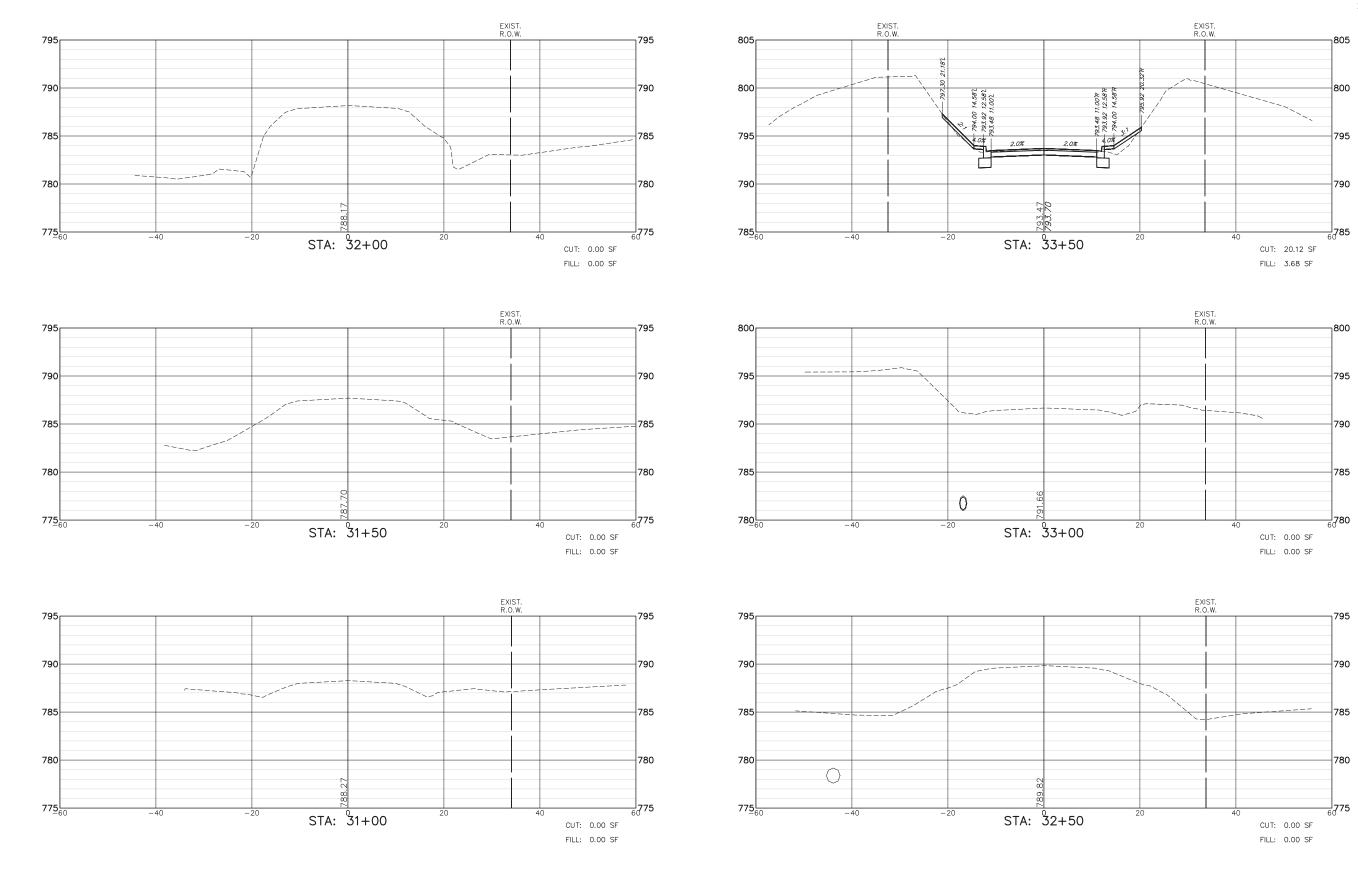

FILE NAME = 5867.200_Sht-XSEC.dwg	USER NAME = DOMINIC OLESAK	DESIGNED - MGFC	REVISED -			CROSS SECT	IONS	FAU.	SECTION	COUNTY	TOTAL	SHEET
		DRAWN - MGFC	REVISED -	STATE OF ILLINOIS	FISH LAKE ROAD IMPROVEMENTS				15-08113-05-CH	LAKE	112	86
	PLOT SCALE = 1" = .0833'	CHECKED - DPB	REVISED -	DEPARTMENT OF TRANSPORTATION						CONTRACT		K10
	PLOT DATE = 12/15/2023 5:51 PM	DATE - 12/18/2023	REVISED -		SCALE: AS NOTED SHEET NO. 1	1 OF 27 SHEETS	STA 31+00.00 TO STA 33+50.00		ILLINOIS FED. A	D PROJECT		
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FILE NAME = 5867.200_Sht-XSEC.dwg

USER NAME = DOMINIC OLESAK

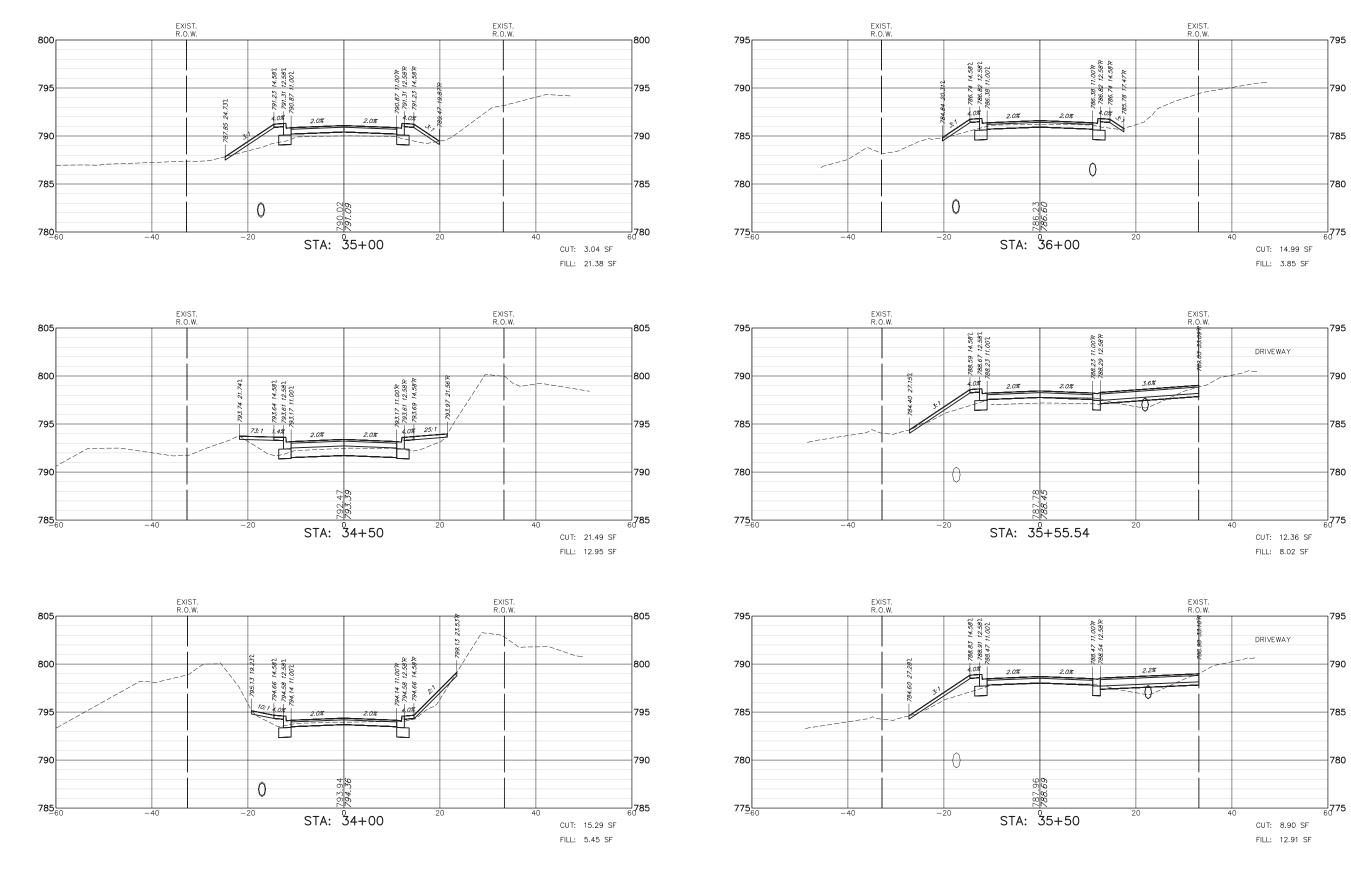PLOT DATE = 12/15/2023 5:51 PM

DESIGNED - MGFC

DRAWN - MGFC
CHECKED - DPB

DATE - 12/18/2023


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REVISED -

REVISED -

STATE OF ILLINOIS		CROSS SECT	FIONS	RTE	SECTION	COUNTY	SHEETS	NO.
		FISH LAKE ROAD IMI	PROVEMENTS	0163	15-08113-05-CH	LAKE	112	87
DEPARTMENT OF TRANSPORTATION		I ISH LAKE NOAD IIII	- NOVEMENTS			CONTRACT	# : 61l	(10
	SCALE: AS NOTED	SHEET NO. 2 OF 27 SHEETS	STA. 34+00.00 TO STA. 36+00.00		ILLINOIS FED. AI	D PROJECT		



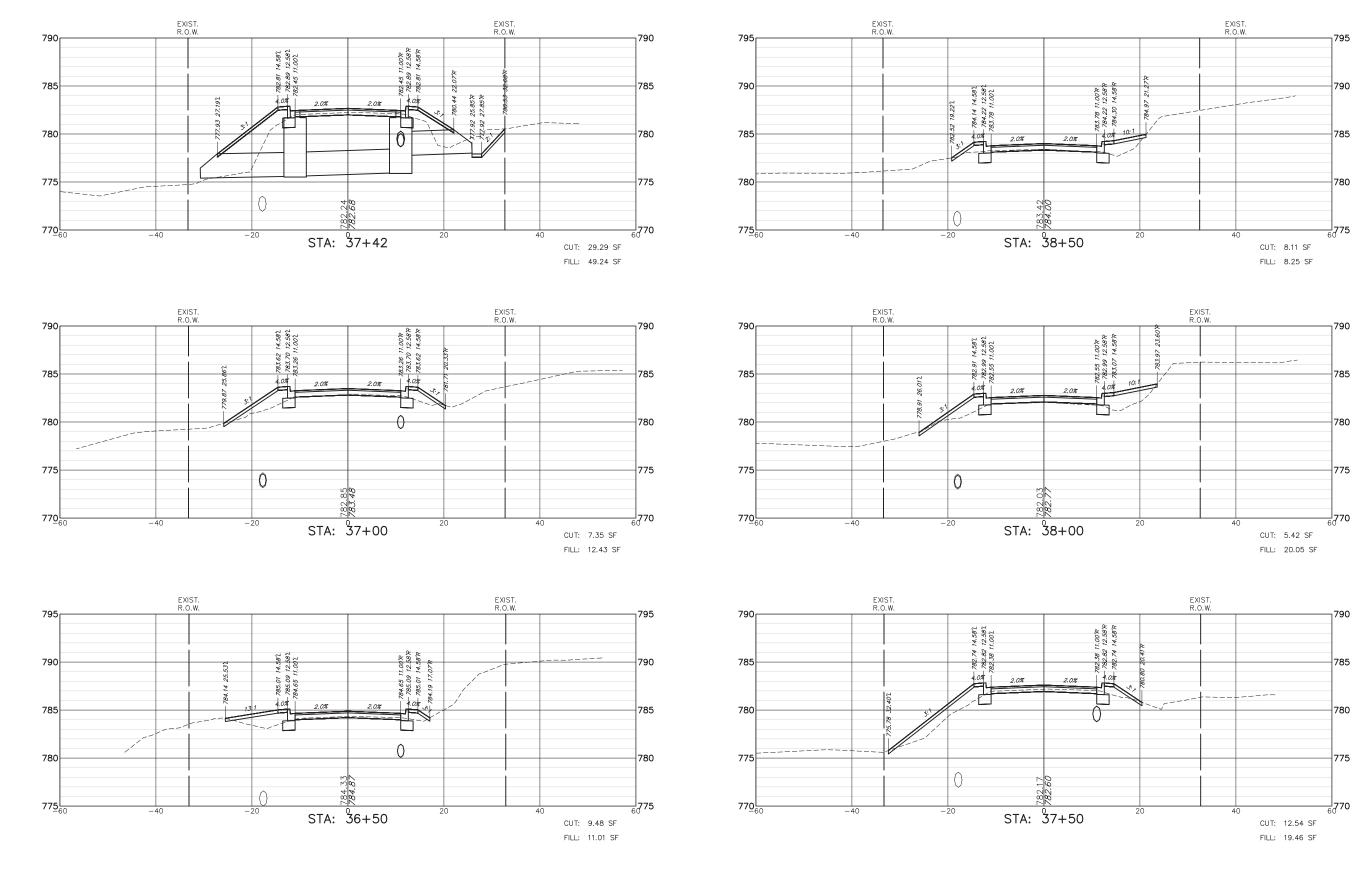

FILE NAME = 5867.200_Sht-XSEC.dwg

USER NAME = DOMINIC OLESAK

PLOT DATE = 12/15/2023 5:52 PM

DESIGNED - MGFC

DRAWN - MGFC

DATE - 12/18/2023

CHECKED - DPB

REVISED -REVISED -

REVISED -

REVISED -

STATE OF ILLINOIS DEPARTMENT OF TRANSPORTATION		CROSS SEC	FAU. RTE	SECTION	COUNTY	TOTAL SHEETS	SHEET NO.	
		FISH LAKE ROAD IM	PROVEMENTS	0163	15-08113-05-CH	LAKE	112	88
DEI ATTIMENT OF THANOI OTTATION	SCALE: AS NOTED	SHEET NO. 3 OF 27 SHEETS	STA 36+50.00 TO STA 38+50.00	┼──	ILLINOIS FED. AI	CONTRACT D PROJECT	# bii	<10



 COUNTY
 TOTAL SHEETS NO.

 LAKE
 112
 89

 CONTRACT #
 61K10

FAU. RTE.


CROSS SECTIONS

FISH LAKE ROAD IMPROVEMENTS

SCALE: AS NOTED SHEET NO. 4 OF 27 SHEETS STA. 39+00.00 TO STA. 41+00.00

SECTION

15-08113-05-CH

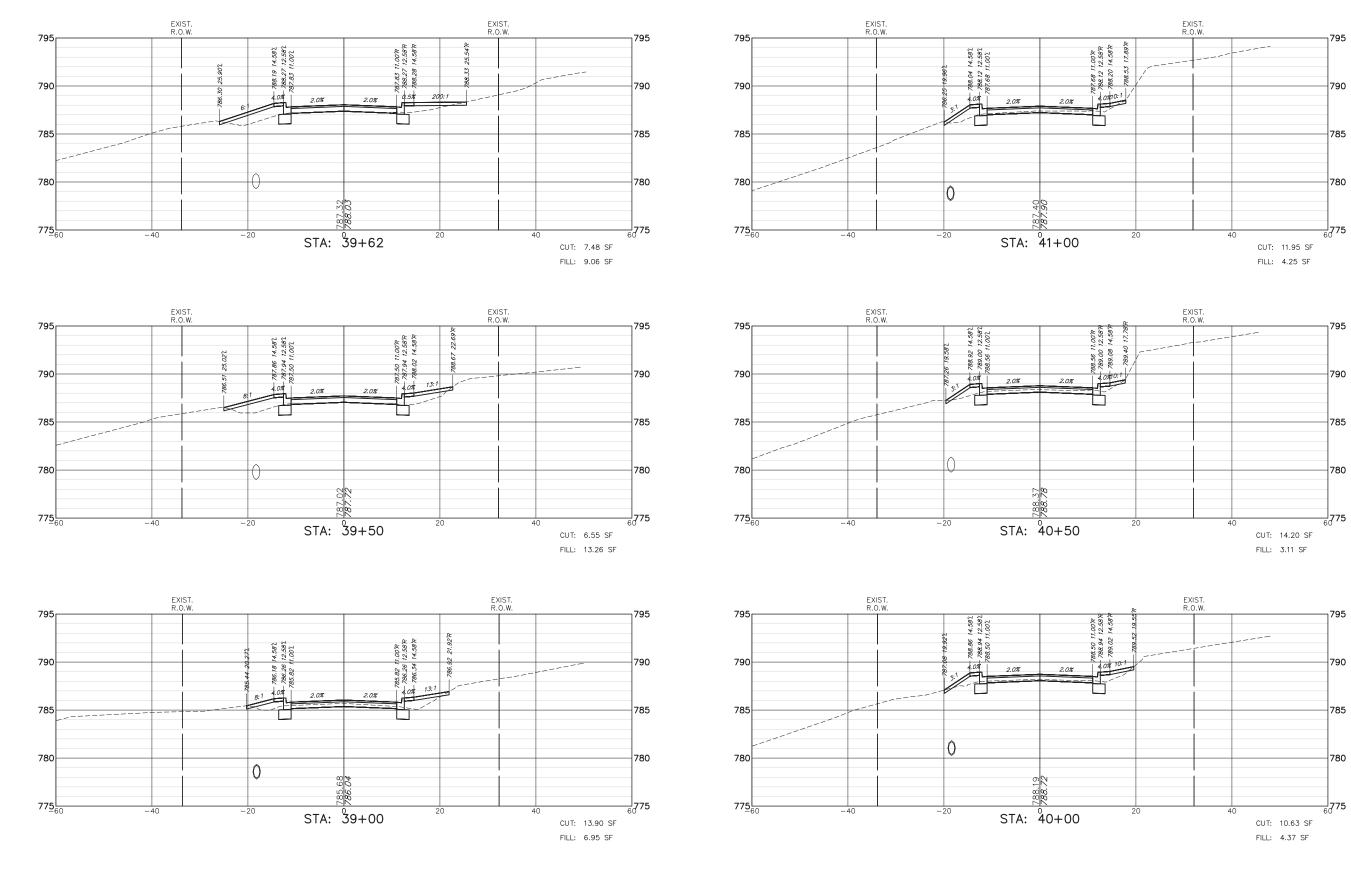

STATE OF ILLINOIS
DEPARTMENT OF TRANSPORTATION

FILE NAME = 5867.200_Sht-XSEC.dwg

USER NAME = DOMINIC OLESAK

PLOT DATE = 12/15/2023 5:52 PM

DESIGNED - MGFC

DRAWN - MGFC

DATE - 12/18/2023

CHECKED - DPB

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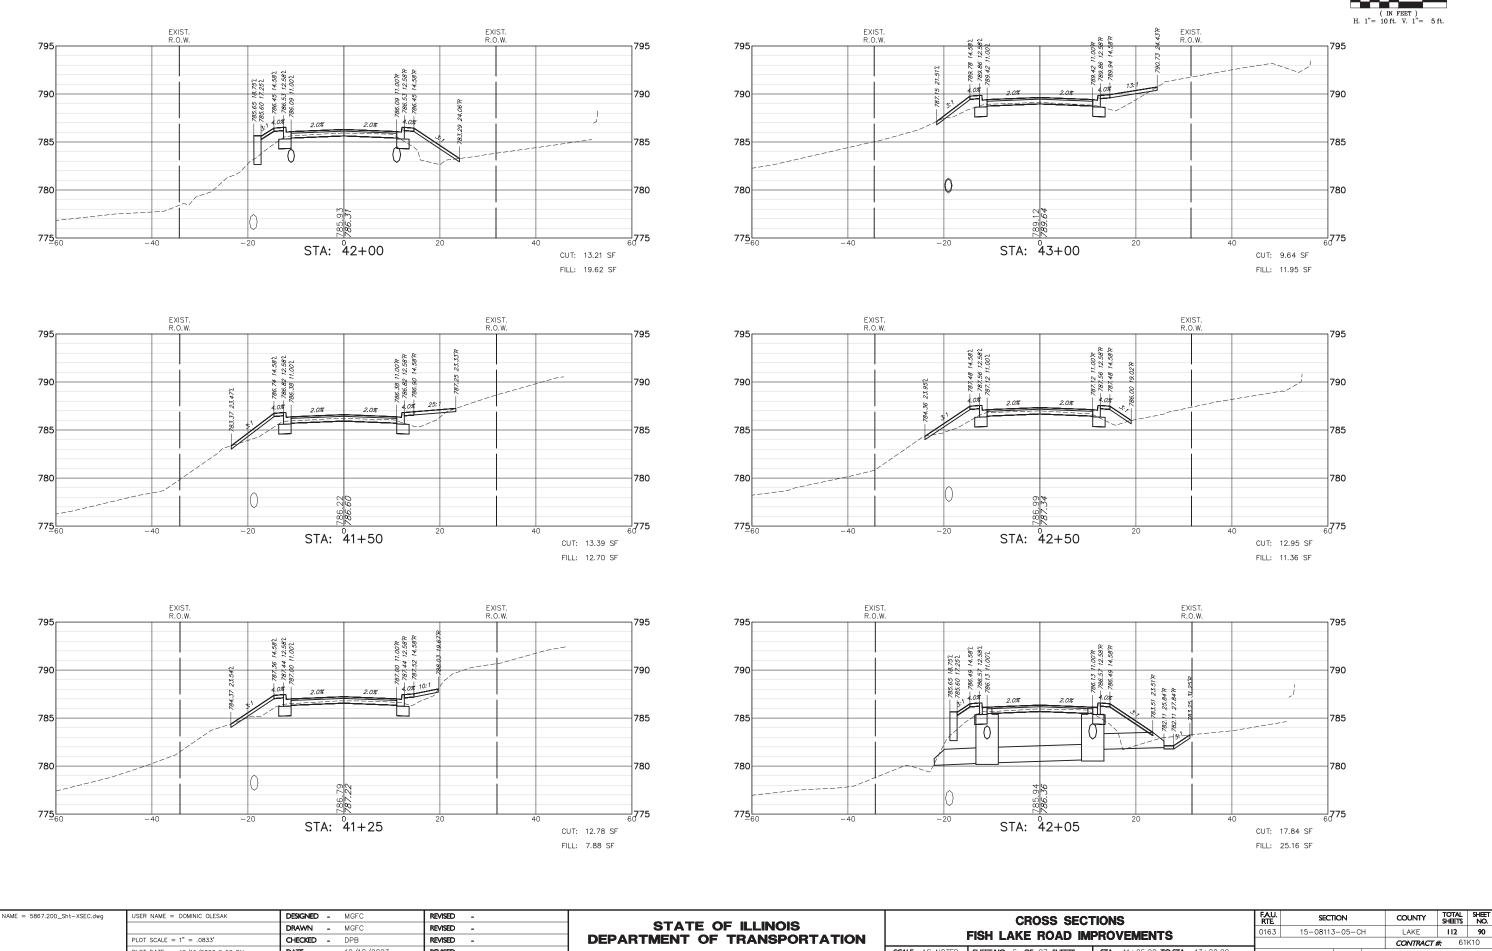
SECTION

15-08113-05-CH

CROSS SECTIONS

FISH LAKE ROAD IMPROVEMENTS

SCALE AS NOTED SHEET NO. 5 OF 27 SHEETS STA. 41+25.00 TO STA. 43+00.00



STATE OF ILLINOIS
DEPARTMENT OF TRANSPORTATION

FILE NAME = 5867.200_Sht-XSEC.dwg

USER NAME = DOMINIC OLESAK

DESIGNED - MGFC

DRAWN - MGFC

DATE - 12/18/2023


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FILE NAME = 5867.200_Sht-XSEC.dwg	USER NAME = DOMINIC OLESAK	DESIGNED -	MGFC	REVISED -		CROSS SECTIONS FISH LAKE ROAD IMPROVEMENTS			FAU.	SECTION	COUNTY	TOTAL SHEET SHEETS NO.
			MGFC	REVISED -	STATE OF ILLINOIS					15-08113-05-CH	LAKE	112 91
	PLOT SCALE = 1" = .0833'	CHECKED - I	DPB	REVISED -	DEPARTMENT OF TRANSPORTATION	FISH LAKE ROAD IMPROVEMENTS			_		CONTRACT	# 61K10
	PLOT DATE = 12/15/2023 5:53 PM	DATE -	12/18/2023	REVISED -		SCALE: AS NOTED SHEET NO. 6 OF 27 SHEETS STA. 43+50.00 TO STA. 46+00.00				ILLINOIS FED.	AID PROJECT	



 COUNTY
 TOTAL SHEETS NO.

 LAKE
 II2
 92

 CONTRACT #
 61K10

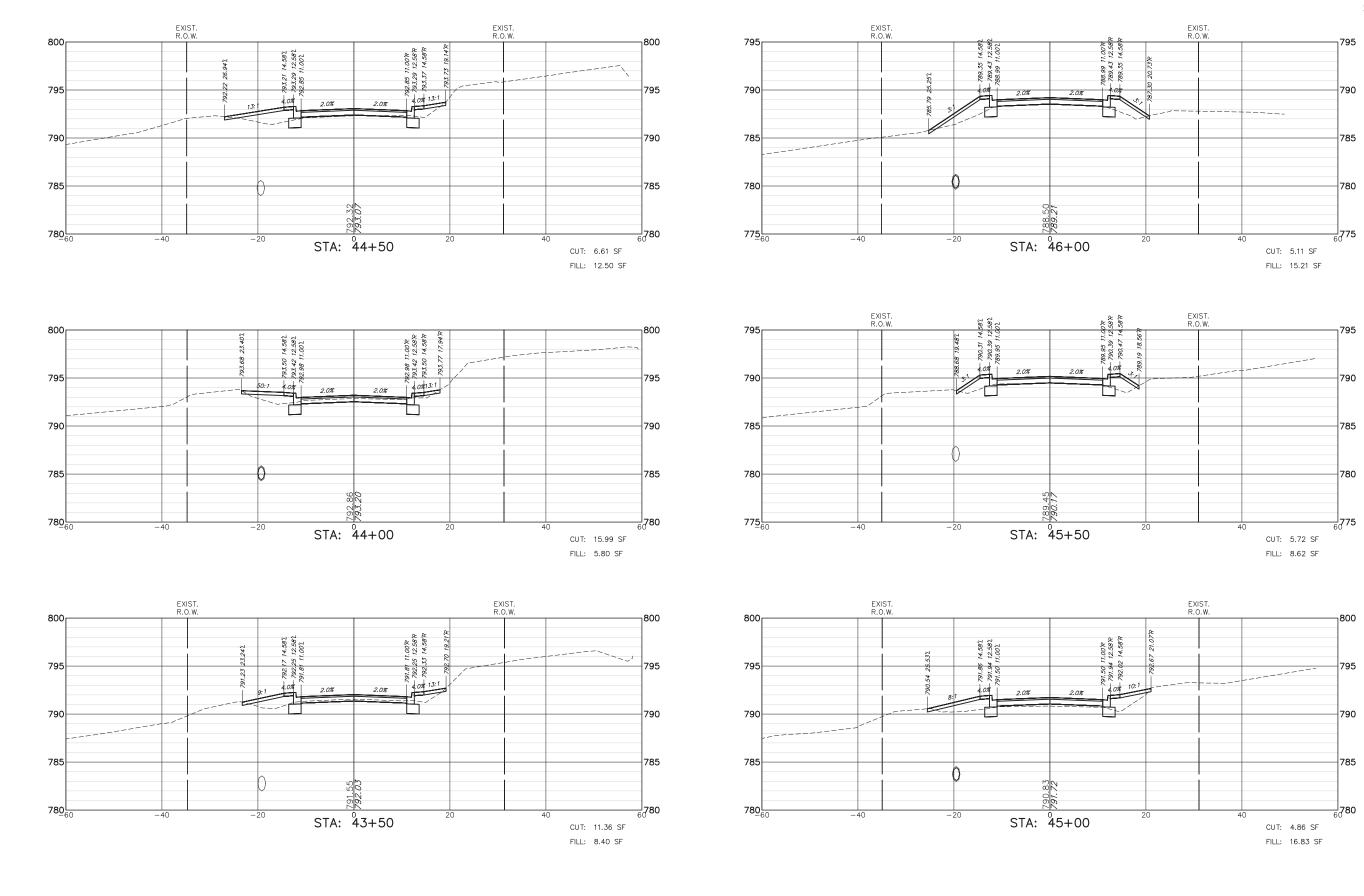FAU. RTE.


CROSS SECTIONS

FISH LAKE ROAD IMPROVEMENTS

 SCALE:
 AS NOTED
 SHEET NO.
 7
 OF 27
 SHEETS
 STA.
 46+37.00 TO STA.
 48+50.00

SECTION

15-08113-05-CH

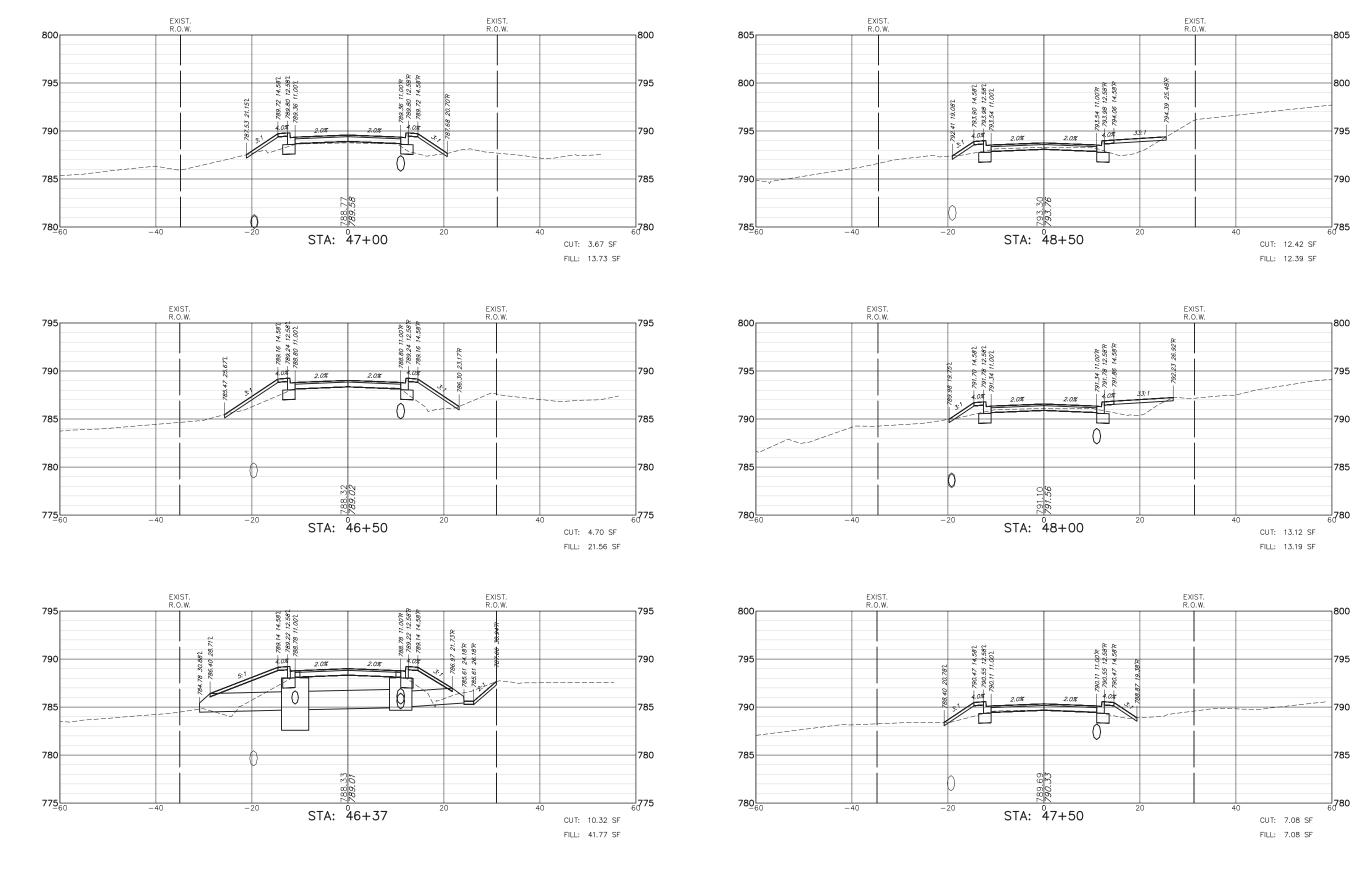

STATE OF ILLINOIS
DEPARTMENT OF TRANSPORTATION

FILE NAME = 5867.200_Sht-XSEC.dwg

USER NAME = DOMINIC OLESAK

DESIGNED - MGFC

DRAWN - MGFC


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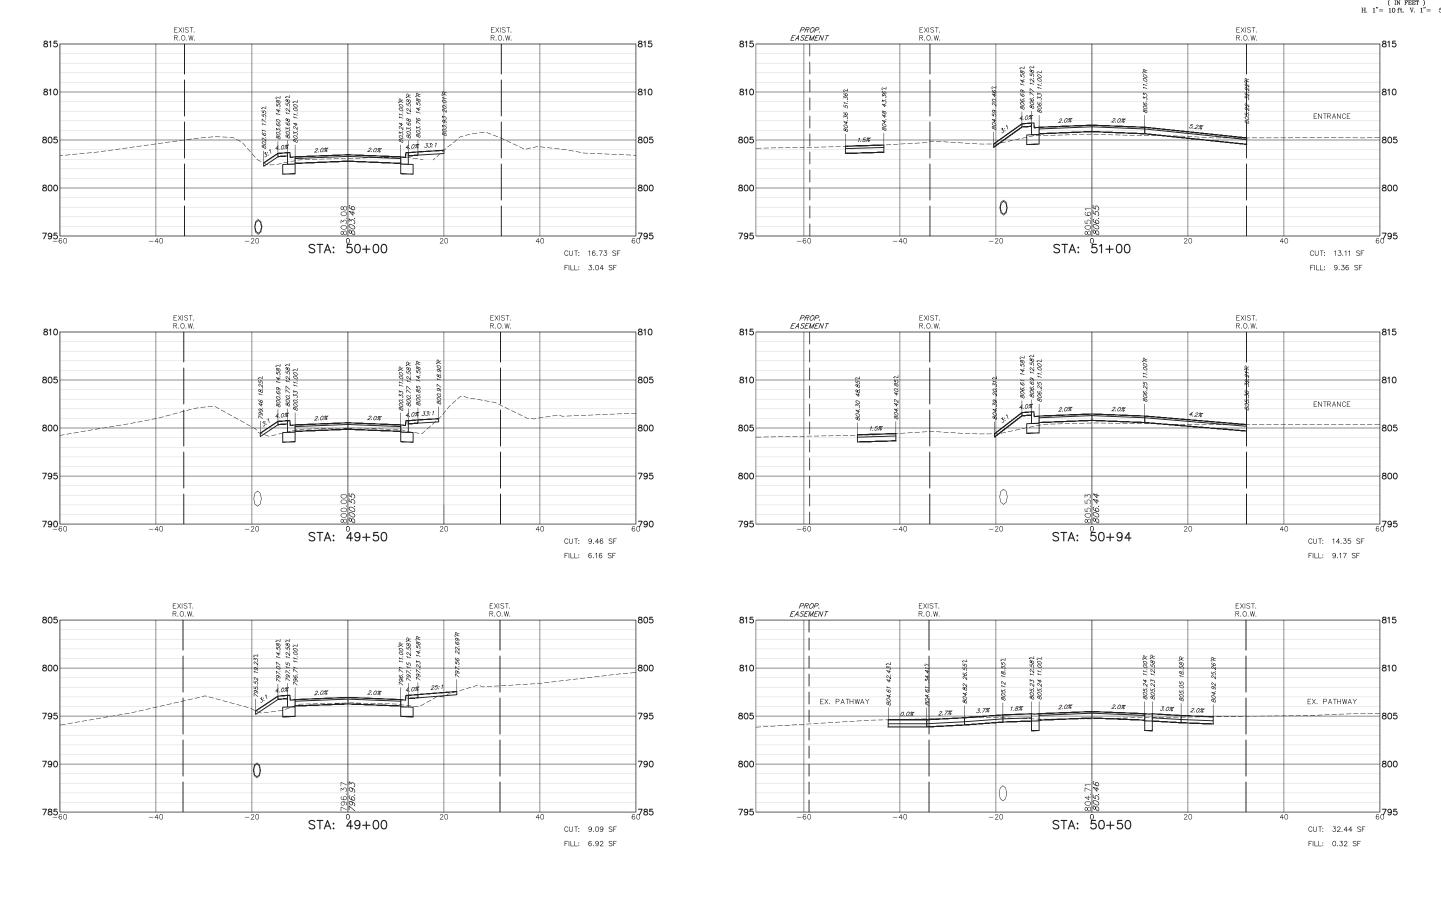
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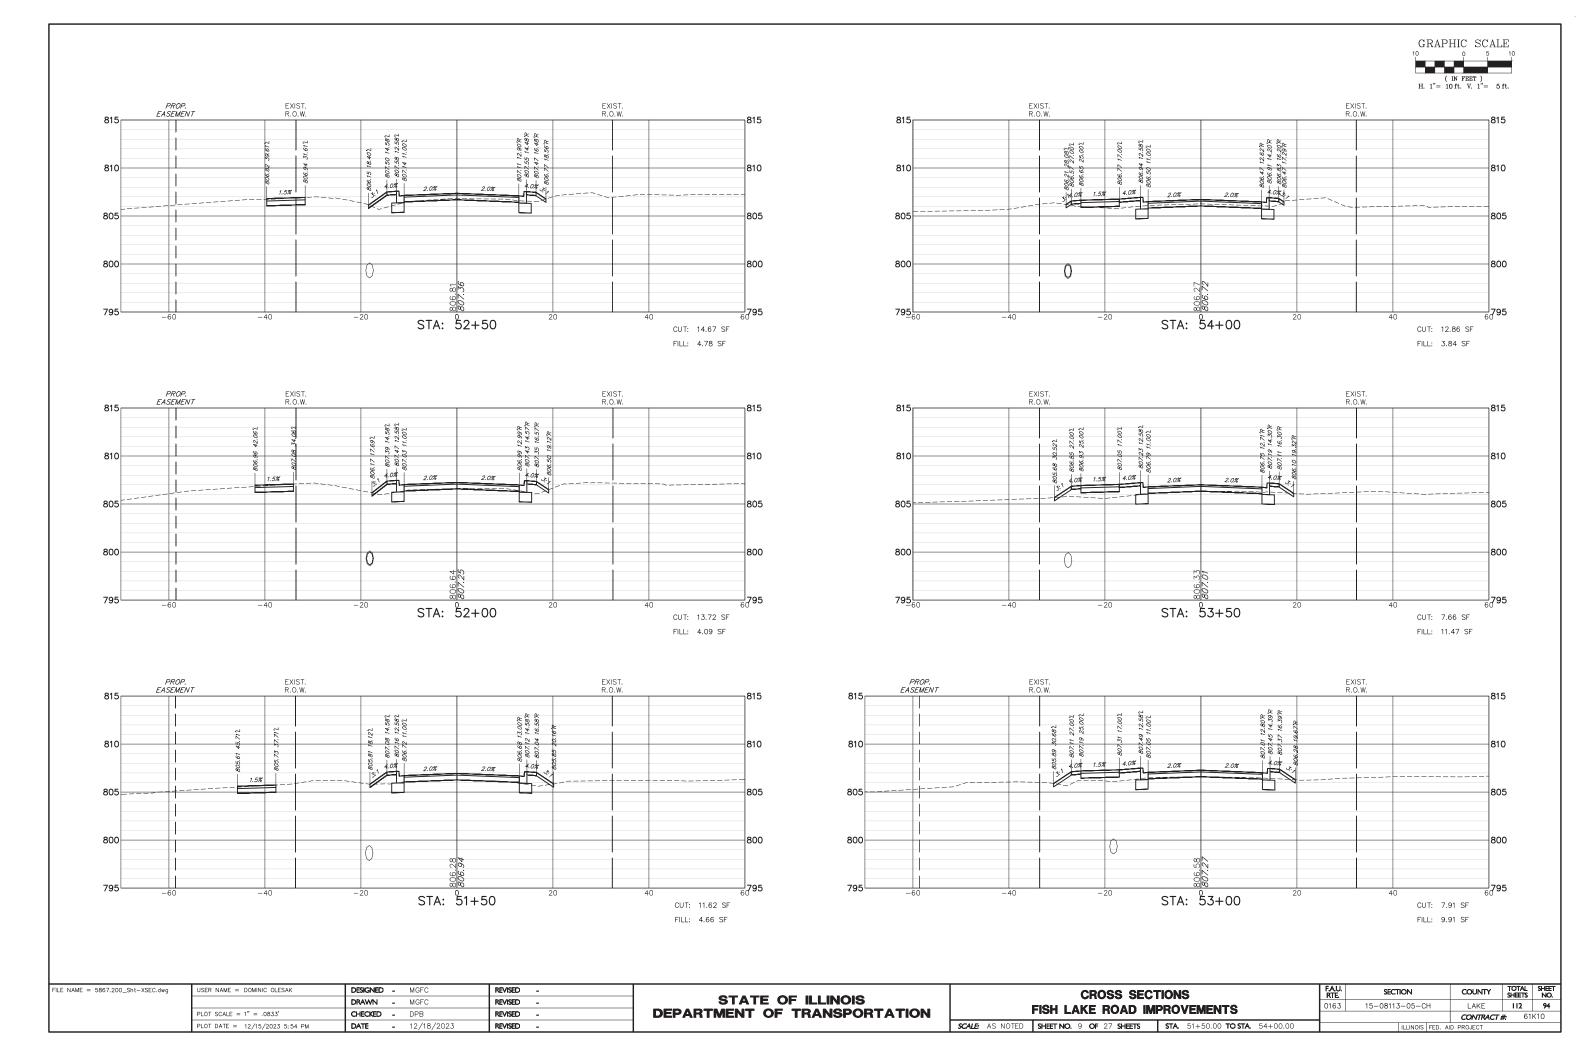
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FILE NAME = 5867.200_Sht-XSEC.dwg	USER NAME = DOMINIC OLESAK	DESIGNED -	MGFC	REVISED	-			CROSS SECT	TIONS	FAU.	SECTION	COUNTY	TOTAL SHEETS	SHEET		
		DRAWN -	MGFC	REVISED	-	STATE OF ILLINOIS	· ·		COLL LAKE DOAD IMPROVEMENTO				15-08113-05-CH	LAKE	112	93
	PLOT SCALE = 1" = .0833'	CHECKED -	DPB	REVISED	-	DEPARTMENT OF TRANSPORTATION	FISH LAKE ROAD IMPROVEMENTS					CONTRACT :	# 61k	(10		
	PLOT DATE = 12/15/2023 5:53 PM	DATE -	12/18/2023	REVISED	-		SCALE: AS NOTED	SHEET NO. 8 OF 27 SHEETS	STA 49+00.00 TO STA 51+00.00		ILLINOIS FED. AIE	PROJECT				





 COUNTY
 TOTAL SHEETS NO.

 LAKE
 112
 95

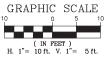 CONTRACT #
 61K10

FAU. RTE.


CROSS SECTIONS

FISH LAKE ROAD IMPROVEMENTS

 SCALE:
 AS NOTED
 SHEET NO.
 10 OF 27 SHEETS
 STA.
 54+50.00 TO STA.
 56+50.00

SECTION

15-08113-05-CH

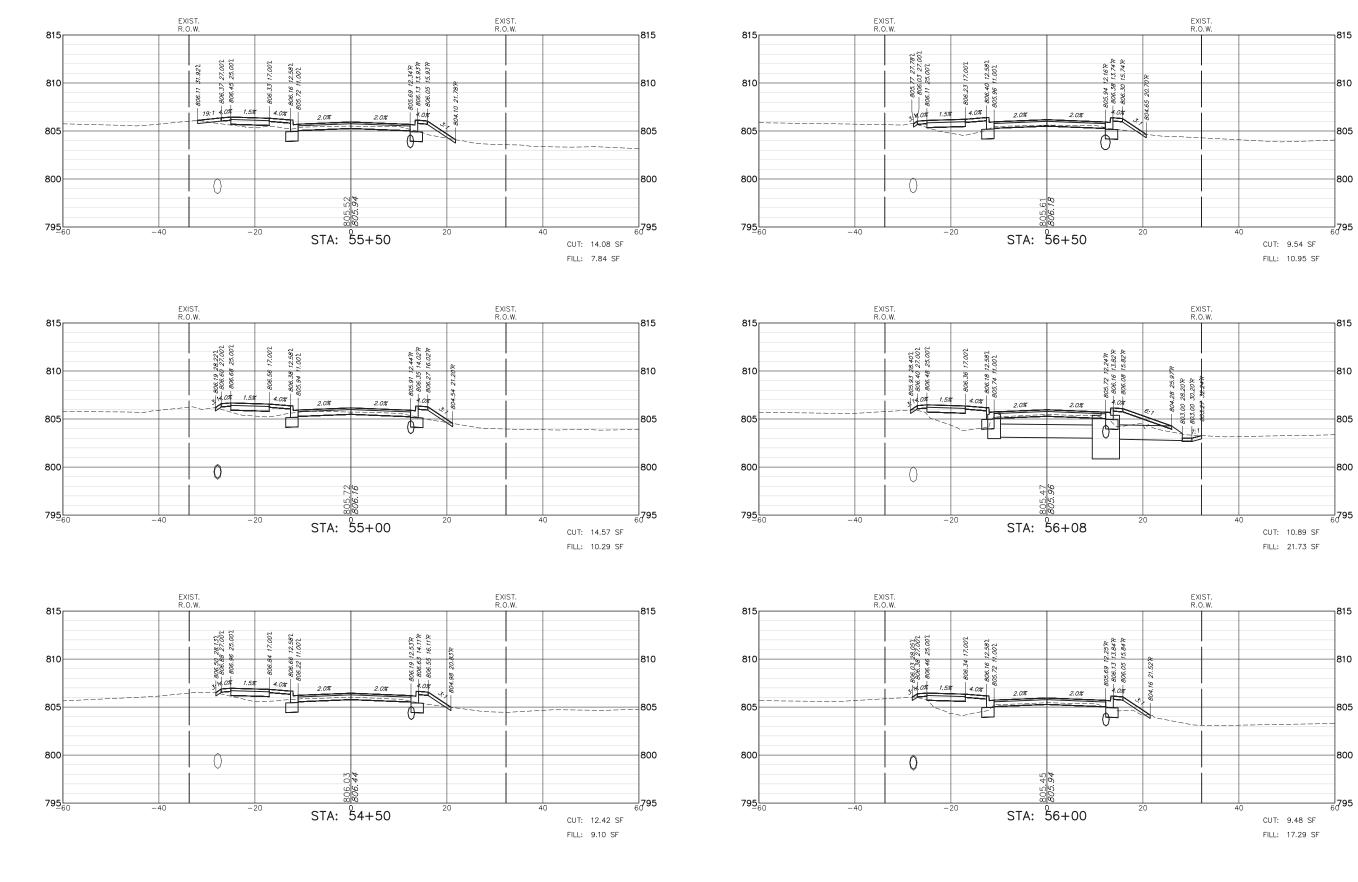

STATE OF ILLINOIS
DEPARTMENT OF TRANSPORTATION

FILE NAME = 5867.200_Sht-XSEC.dwg

JSER NAME = DOMINIC OLESAK

PLOT DATE = 12/15/2023 5:54 PM

DESIGNED - MGFC

DRAWN - MGFC

CHECKED - DPB


DATE - 12/18/2023

REVISED -

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REVISED



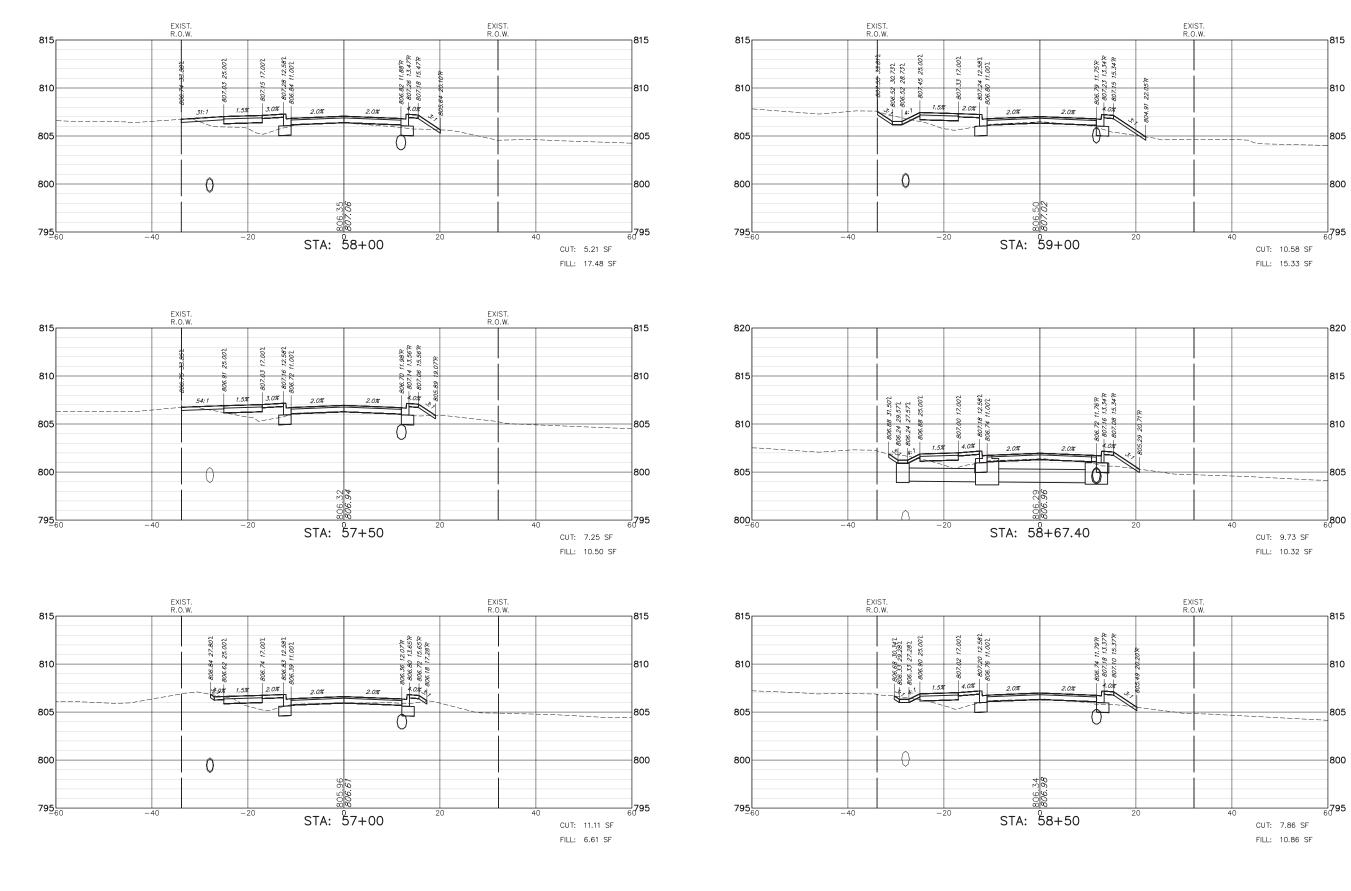

STATE OF ILLINOIS
DEPARTMENT OF TRANSPORTATION

FILE NAME = 5867.200_Sht-XSEC.dwg

USER NAME = DOMINIC OLESAK

PLOT DATE = 12/15/2023 5:55 PM

DESIGNED - MGFC

DRAWN - MGFC

DATE - 12/18/2023

CHECKED - DPB


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	CROSS SECT	RTE	SECTION	COUNTY	SHEETS	NO.	
	FISH LAKE ROAD IM	0163	15-08113-05-CH	LAKE	112	96	
	I IOII LAKE NOAD IIII	THOVEINENTS			CONTRACT :	# 611	(10
SCALE: AS NOTED	SHEET NO. 11 OF 27 SHEETS		ILLINOIS FED. AI	D PROJECT			





FILE NAME = 5867.200_Sht-XSEC.dwg	USER NAME = DOMINIC OLESAK	DESIGNED - MGFC	REVISED -	STATE OF ILLINOIS DEPARTMENT OF TRANSPORTATION		CROSS SEC	TIONS	FAU. RTE	SECTION	COUNTY	TOTAL SHEETS	SHEET NO.
		DRAWN - MGFC	REVISED -		FISH LAKE ROAD IMPROVEMENTS			0163	15-08113-05-CH	LAKE	112	97
	PLOT SCALE = 1" = .0833'	CHECKED - DPB	REVISED -	DEPARTMENT OF TRANSPORTATION		PROVEMEN I S			CONTRACT #	# 611	K10	
	PLOT DATE = 12/15/2023 5:55 PM	DATE - 12/18/2023	REVISED -		SCALE: AS NOTED	SHEET NO. 12 OF 27 SHEETS	STA 60+00.00 TO STA 61+70.00	ILLINOIS FED.		AID PROJECT		

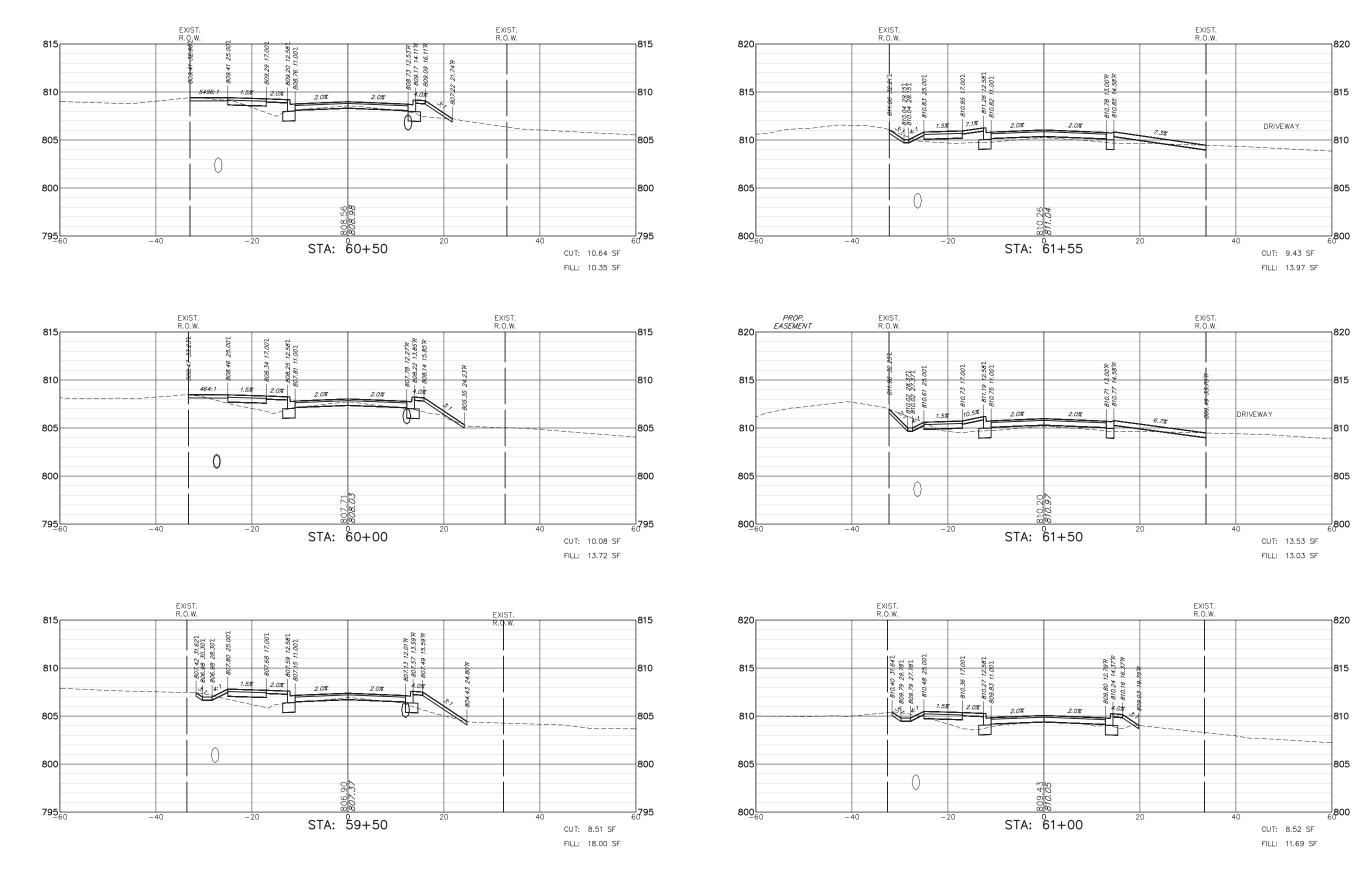

COUNTY TOTAL SHEET NO.

LAKE 112 98

CONTRACT #: 61K10

FAU. RTE.


CROSS SECTIONS

FISH LAKE ROAD IMPROVEMENTS

 SCALE:
 AS NOTED
 SHEET NO.
 13 OF 27 SHEETS
 STA.
 62+00.00 TO STA.
 64+00.00

SECTION

15-08113-05-CH

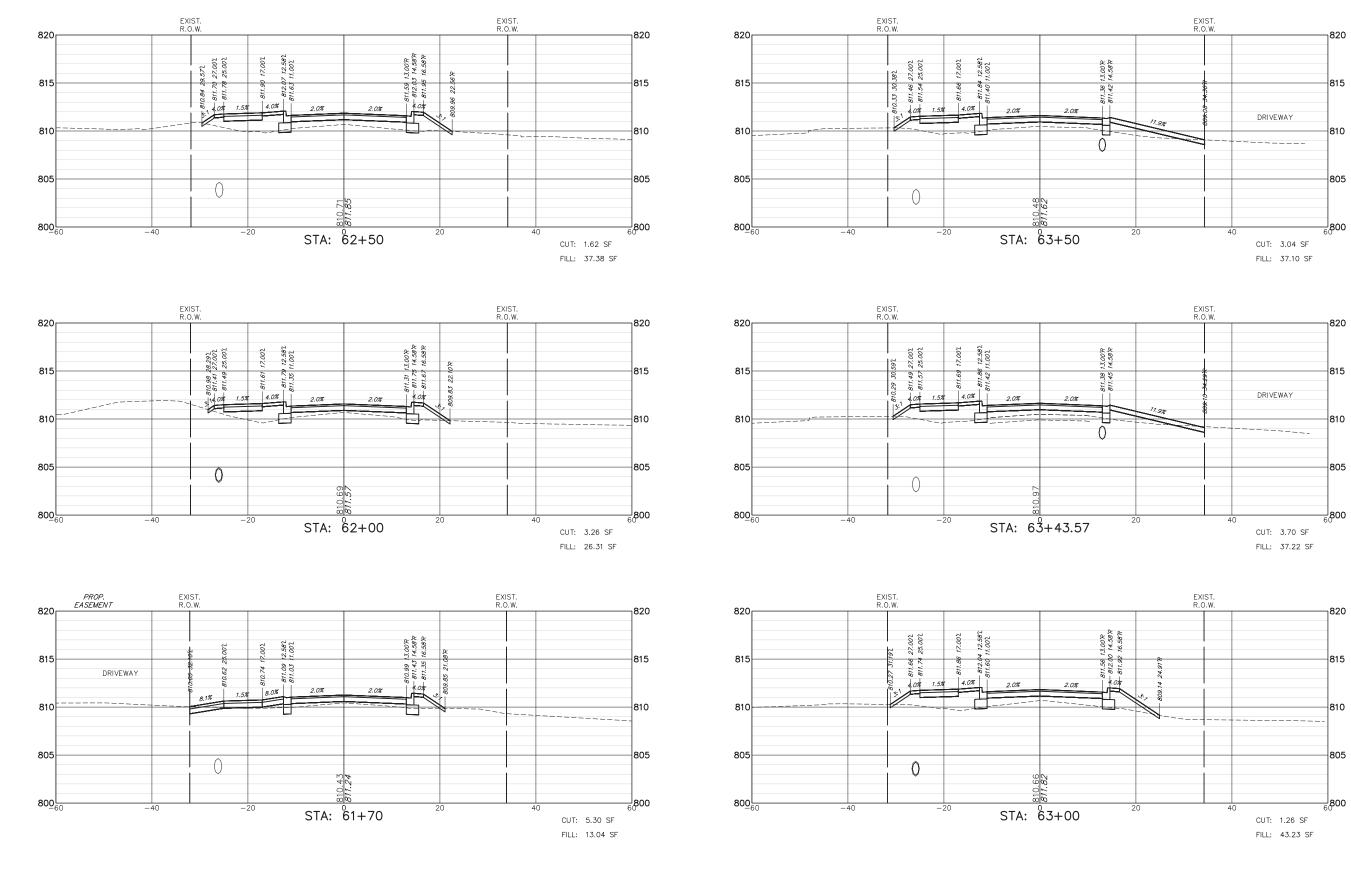

STATE OF ILLINOIS

DEPARTMENT OF TRANSPORTATION

FILE NAME = 5867.200_Sht-XSEC.dwg

USER NAME = DOMINIC OLESAK

DESIGNED - MGFC

DRAWN - MGFC

CHECKED - DPB

DATE - 12/18/2023

REVISED -

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 COUNTY
 TOTAL SHEETS NO.

 LAKE
 112
 99

 CONTRACT #
 61K10

FAU. RTE.


CROSS SECTIONS

FISH LAKE ROAD IMPROVEMENTS

SCALE: AS NOTED **SHEET NO.** 14 **OF** 27 **SHEETS STA.** 64+50.00 **TO STA.** 66+50.00

SECTION

15-08113-05-CH

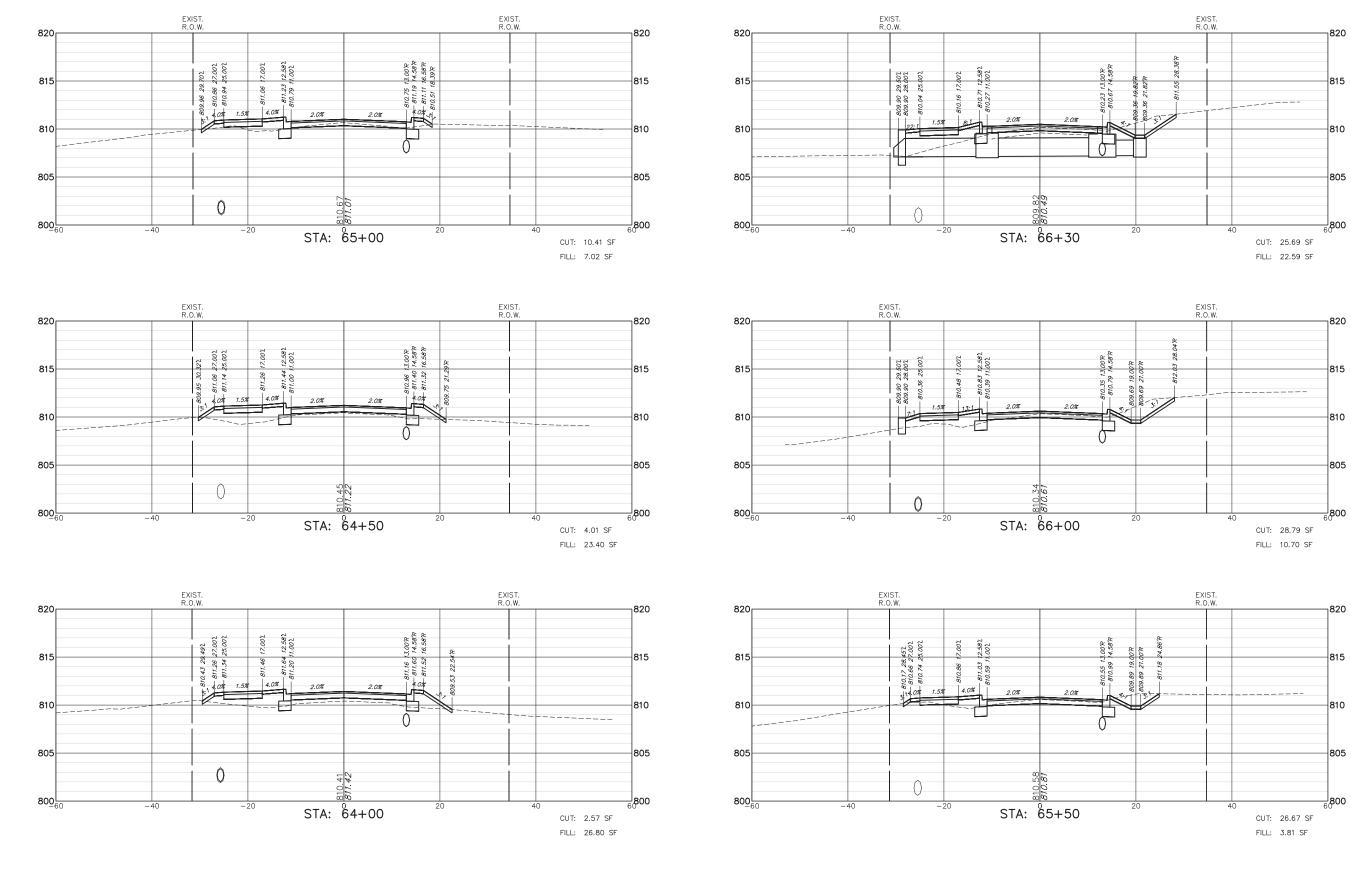

STATE OF ILLINOIS
DEPARTMENT OF TRANSPORTATION

FILE NAME = 5867.200_Sht-XSEC.dwg

JSER NAME = DOMINIC OLESAK

PLOT DATE = 12/15/2023 5:56 PM

DESIGNED - MGFC

DRAWN - MGFC

CHECKED - DPB

DATE - 12/18/2023

REVISED -

REVISED

REVISED



 COUNTY
 TOTAL SHEETS NO.

 LAKE
 112
 100

 CONTRACT #
 61K10

FAU. RTE.


CROSS SECTIONS

FISH LAKE ROAD IMPROVEMENTS

 SCALE:
 AS NOTED
 SHEET NO.
 15 OF 27 SHEETS
 STA.
 67+00.00 TO STA.
 69+00.00

SECTION

15-08113-05-CH

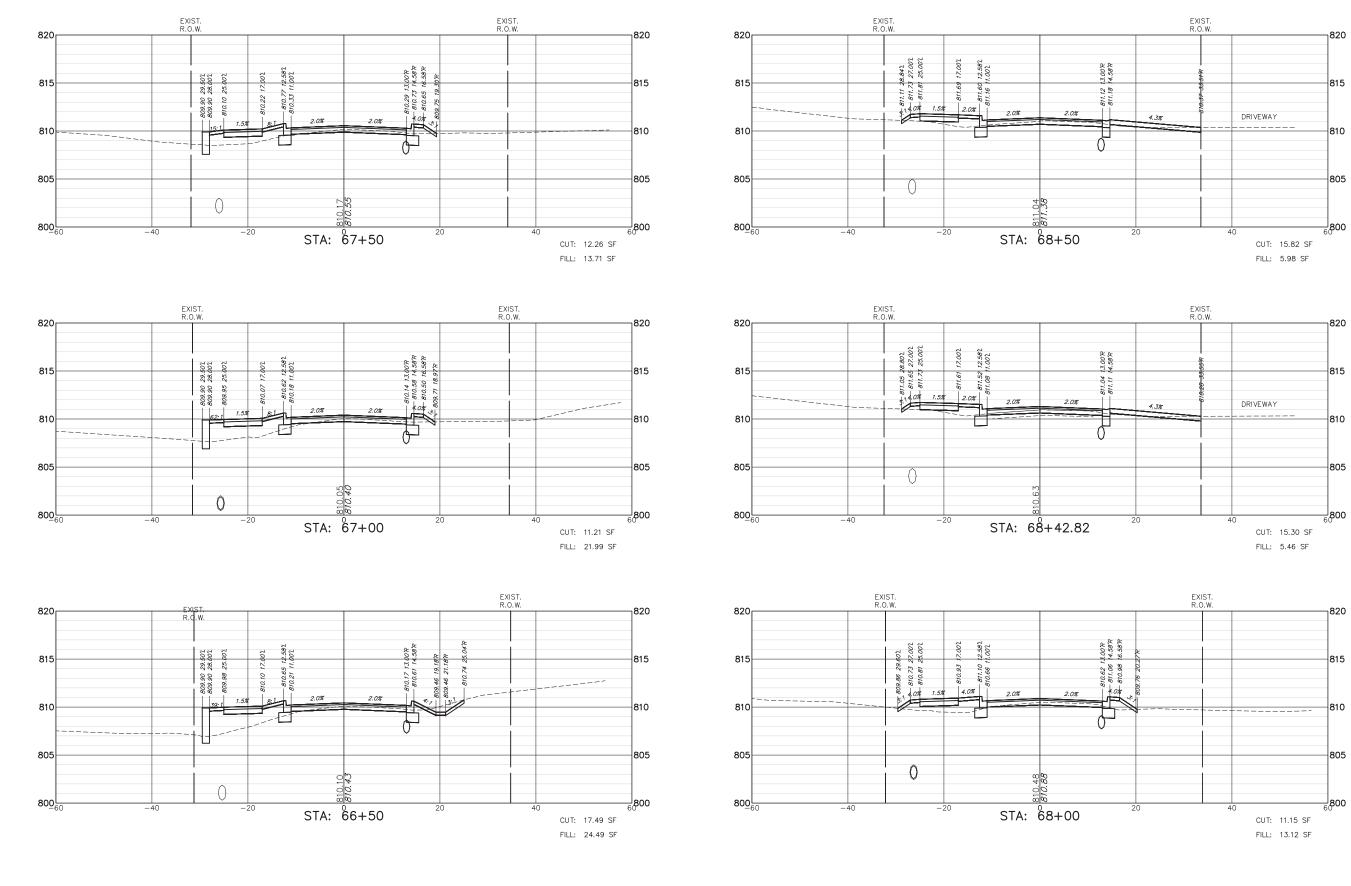

STATE OF ILLINOIS
DEPARTMENT OF TRANSPORTATION

FILE NAME = 5867.200_Sht-XSEC.dwg

JSER NAME = DOMINIC OLESAK

DESIGNED - MGFC

DRAWN - MGFC

CHECKED - DPB

DATE - 12/18/2023

REVISED -

REVISED

REVISED