

- 1 COVER SHEET
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- 5 SCHEDULES OF QUANTITIES
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- 17 SITE DETAILS
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HIGHWAY STANDARDS

- 000001-08 STANDARD SYMBOLS, ABBREVIATIONS AND PATTERNS
 280001-07 TEMPORARY EROSION CONTROL SYSTEMS
 424001-11 PERPENDICULAR CURB RAMPS FOR SIDEWALKS
 602301-04 INLET - TYPE A
 602306-03 INLET - TYPE B
 602401-07 PRECAST MANHOLE TYPE A, 4' DIAMETER
 602601-06 PRECAST REINFORCED CONCRETE FLAT SLAB TOP
 602701-02 MANHOLE STEPS
 604036-03 GRATE TYPE B
 604001-05 FRAME AND LIDS TYPE 1
 606001-08 CONCRETE CURB TYPE B AND COMBINATION CONCRETE CURB AND GUTTER
 701001-02 OFF-RD OPERATIONS, 2L, 2W, MORE THAN 15' AWAY
 701006-05 OFF-RD OPERATIONS, 2L, 2W, 15' TO 24" FROM PAVEMENT EDGE
 701301-04 LANE CLOSURE, 2L, 2W SHORT TIME OPERATIONS
 701801-06 SIDEWALK, CORNER OR CROSSWALK CLOSURE
 701901-08 TRAFFIC CONTROL DEVICES

0 50' 100'
 1' = 20'

FULL SIZE PLANS HAVE BEEN PREPARED USING STANDARD ENGINEERING SCALES. REDUCED SIZED PLANS WILL NOT CONFORM TO STANDARD SCALES. IN MAKING MEASUREMENTS ON REDUCED PLANS, THE ABOVE SCALES MAY BE USED.

J.U.L.I.E.
 JOINT UTILITY LOCATION INFORMATION FOR EXCAVATION
 1-800-892-0123
 OR 811

PROJECT ENGINEER: TIMOTHY J. LAROCQUE, P.E.
 PROJECT MANAGER: NEIL A. PIGGUSH, P.E.


PIGGUSH ENGINEERING
 586 William Latham Drive, Suite 8
 Bourbonnais, IL 60914
 O 815.614.3447
 F 815.614.3735 PiggushEng.com

CONTRACT NO. 87812

STATE OF ILLINOIS
DEPARTMENT OF TRANSPORTATION

**PLANS FOR PROPOSED
 MULTI-USE PATH**

**SAFE ROUTE TO SCHOOL FUNDS
 ESSON FARM ROAD
 SECTION 21-00018-00-BT
 MULTI-USE PATH
 VILLAGE OF GRANT PARK
 PROJECT KEOM(283)
 JOB NO. C-93-042-23**

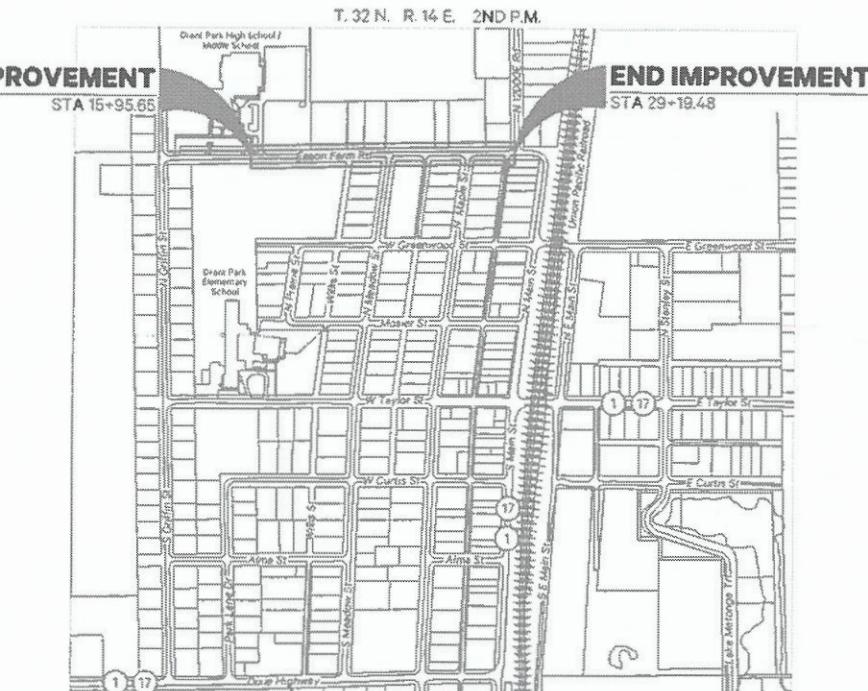

GROSS LENGTH = 1,321.51 FT. = 0.25 MILES
 NET LENGTH = 1,321.51 FT. = 0.25 MILES

ILLINOIS PROFESSIONAL ENGINEER #062067059

EXPIRATION DATE OF P.E. LICENSE: NOVEMBER 30, 2023

FA. RTE.	SECTION	COUNTY	TOTAL SHEETS	SHEET NO.
	21-00018-00-BT	KANKAKEE	22	3

ILLINOIS CONTRACT NO. 87812



**FUNCTIONAL CLASSIFICATION
 LOCAL
 2017 ADT = 1,100**

STATE OF ILLINOIS DEPARTMENT OF TRANSPORTATION	
APPROVED DECEMBER 17, 2022 	
PASSED JANUARY 5, 2023 	
RELEASING FOR BID BASED ON LIMITED REVIEW JANUARY 5, 2023 	



**PRINTED BY THE AUTHORITY
 OF THE STATE OF ILLINOIS**

BENCHMARK SUMMARY

Site Benchmarks:

BM #1
CUT "X" IN THE EAST CURB OF THE EXIT APRON OF GRANT PARK HIGH SCHOOL, APPROXIMATELY 34 FEET NORTH OF THE CENTERLINE OF ESSON FARM ROAD AND 26 FEET EAST-NORTHEAST OF THE "EXIT ONLY" SIGN.

BM #2
MAGNAIL IN ASPHALT APPROXIMATELY 10 FEET NORTH OF THE CENTERLINE OF ESSON FARM ROAD AND 37 FEET NORTHWEST OF A "STOP AHEAD" SIGN.

BM #3
CUT "X" IN CURB AT THE SOUTHEAST CORNER OF THE INTERSECTION OF ESSON FARM ROAD AND MEADOW STREET, APPROXIMATELY 23 FEET SOUTH OF THE CENTERLINE OF ESSON FARM ROAD AND 16 FEET NORTH-NORTHEAST OF A STOP SIGN.

BM #4
MAGNAIL IN ASPHALT APPROXIMATELY 10 FEET NORTH OF THE CENTERLINE OF ESSON FARM ROAD AND 140 FEET EAST OF A "STOP AHEAD" SIGN.

BM #5
MAGNAIL IN ASPHALT AT THE NORTHWEST CORNER OF THE INTERSECTION OF ESSON FARM ROAD AND 12000E ROAD, APPROXIMATELY 14 FEET NORTH OF THE CENTERLINE OF ESSON FARM ROAD AND 32 FEET EAST OF A "NO TRUCKS" SIGN.

COMMITMENTS

NO COMMITMENTS

GENERAL NOTES

- THE FOLLOWING UTILITIES LOCATED WITHIN THE LIMITS OF THIS IMPROVEMENT ARE MEMBERS OF JULIE. THE JULIE NUMBER IS 1-800-892-0123.

EMERGENCY SERVICES:

EMERGENCY NUMBER: 911
STATE POLICE: 815.698.2315
GRANT PARK POLICE (NON-EMERGENCY): 815.465.2151
FIRE DEPARTMENT (NON-EMERGENCY): 815.465.6123

WATER / SEWER / GARBAGE:

AQUA ILLINOIS, INC.
1000 S. SCHUYLER AVE
KANKAKEE, IL 60901
PHONE: 815.935.8800

NATURAL GAS:

NICOR GAS
1844 FERRY ROAD
NAPERVILLE, IL 60563
PHONE: 888.642.6748 OR 800.730.6114
EMAIL: BUILDER@NICOR.COM

ELECTRIC:

COM ED
2500 GOVERNORS HIGHWAY
UNIVERSITY PARK, IL 60466
PHONE: 800.334.7661

TELEPHONE:

AT&T
65 WEST WEBSTER - FLOOR 4E
JOLIET, IL 60431
PHONE: 815.727.8279

- ACCESS TO ENTRANCES SHALL BE MAINTAINED BY THE USE OF TEMPORARY AGGREGATE IN ACCORDANCE WITH ARTICLE 107.09 OF THE STANDARD SPECIFICATIONS EXCEPT THE COST OF FURNISHING, PLACING, AND REMOVING THE AGGREGATE WILL BE CONSIDERED INCIDENTAL TO THE CONTRACT AND NO OTHER COMPENSATION WILL BE ALLOWED.
- EXCEPTED AS NOTED IN THE PLANS, PAVEMENT GRADES SHOWN ARE TO THE TOP OF PAVEMENT SURFACES.
- THE ENGINEER SHALL BE THE SOLE JUDGE CONCERNING THE CURING TIME FOR THE VARIOUS HMA LIFTS.
- TEMPORARY MARKING TAPE SHALL BE USED FOR ALL TEMPORARY PAVEMENT MARKINGS ON THE FINAL SURFACE. THE TEMPORARY PAVEMENT MARKINGS WILL NOT BE PAID FOR SEPARATELY BUT SHALL BE INCLUDED IN THE LUMP SUM CONTRACT PRICE FOR TRAFFIC CONTROL AND PROTECTION, (SPECIAL).
- ALL SAWCUTTING OF EXISTING PAVEMENT SHALL BE CONSIDERED INCIDENTAL TO THE CONTRACT.
- WHERE SECTION OR SUBSECTION MONUMENTS ARE ENCOUNTERED, THE ENGINEER SHALL BE NOTIFIED BEFORE SUCH MONUMENTS ARE REMOVED. THE CONTRACTOR SHALL PROTECT AND CAREFULLY PRESERVE ALL PROPERTY MARKERS AND MONUMENTS UNTIL THE OWNER, AN AUTHORIZED SURVEYOR, OR AGENT HAS WITNESSED OR OTHERWISE REFERENCED THEIR LOCATION.
- THE WORK REQUIRED TO CONNECT ANY SEWER TO AN EXISTING DRAINAGE STRUCTURE OR PIPE WILL NOT BE PAID FOR SEPARATELY, BUT WILL BE CONSIDERED AS INCLUDED IN THE CONTRACT UNIT PRICE BID FOR THE SEWER ITEMS.
- THE CONTRACTOR IS RESPONSIBLE FOR MAINTAINING DRAINAGE THROUGHOUT THE CONSTRUCTION OF THIS PROJECT. THIS WORK WILL NOT BE PAID FOR SEPARATELY, BUT WILL BE CONSIDERED AS INCLUDED IN THE CONTRACT UNIT PRICE BID FOR THE SEWER ITEMS.
- EXISTING UTILITY INFORMATION SHOWN IN THE PLANS INCLUDING HORIZONTAL AND VERTICAL LOCATIONS WAS TAKEN FROM THE BEST AVAILABLE INFORMATION AND IS PROVIDED IN THE PLANS FOR INFORMATION ONLY. IN NO WAY DOES THIS INFORMATION RELEASE THE CONTRACTOR FROM THEIR DUE DILIGENCE TO FIELD VERIFY ALL EXISTING UTILITY LOCATIONS AND ELEVATIONS. ANY UNFORESEEN CONFLICTS WITH UTILITIES SHALL BE RECTIFIED IN ACCORDANCE WITH ARTICLE 107.40 OF THE STANDARD SPECIFICATIONS.
- FOR STABILIZATION, ALL TYPE III BARRICADES WILL REQUIRE A MINIMUM OF FOUR SAND BAGS PER BARRICADE.
- REMOVAL OF EXISTING AGGREGATE PAVEMENT WILL BE INCLUDED IN THE COST OF EARTH EXCAVATION.

INTERNET / CABLE TELEVISION:

COMCAST
1770 HOFFMAN WAY
SOUTH HOLLAND, IL 60473
PHONE: 708.444.8832

LOCAL MUNICIPALITY:

VILLAGE OF GRANT PARK
106 W. TAYLOR STREET
PO BOX 446
GRANT PARK, IL 60940
PHONE: 815.465.6531
EMAIL: VILLAGEOFGRANTPARK@ATT.NET

HIGHWAY DEPARTMENT:

KANKAKEE COUNTY
750 S. EAST AVE.
KANKAKEE, IL 60901
PHONE: 815.933.1731
FAX: 815.933.4499
HOURS: MON. - FRI. 6 A.M. TO 2:30 P.M.

- ALL DAMAGE TO DEPARTMENT OWNED UNDERGROUND FACILITIES, CAUSED BY THE CONTRACTOR SHALL BE REPAIRED TO THE SATISFACTION OF THE DEPARTMENT AT THE CONTRACTOR'S EXPENSE. THIS SHALL INCLUDE ALL TEMPORARY REPAIRS REQUIRED TO KEEP THE FACILITY OPERATIONAL WHILE MATERIAL IS BEING OBTAINED TO MAKE PERMANENT REPAIRS. SPLICING OF ELECTRIC CABLE WILL NOT BE ALLOWED. ELECTRIC CABLE SHALL BE REPLACED FROM POLE TO POLE OR CONTROLLER.


- MINOR RESIDENTIAL TILE / SUMP PUMP OUTLETS THAT CURRENTLY OUTLET INTO THE BACKSLOPES OF EXISTING DITCHES SHALL BE MARKED AS FOUND IN THE FIELD. THE CONTRACTOR SHALL MAINTAIN FLOW THROUGHOUT THE DURATION OF CONSTRUCTION. ALL TILES OUTLETING TO AN OPEN DITCH SHALL HAVE A CLASS SI CONCRETE HEADWALL IN ACCORDANCE TO THE PIPE DRAINS AND CONCRETE HEADWALLS HIGHWAY STANDARDS.

- ALL ELEVATIONS REFERRING TO NAVD 88 DATUM.

CODE NO.	ITEM	UNIT	TOTAL QUANTITY
20100210	TREE REMOVAL (OVER 15 UNITS DIAMETER)	UNIT	76
20200100	EARTH EXCAVATION	CU YD	96
20800150	TRENCH BACKFILL	CU YD	65
21001000	GEOTECHNICAL FABRIC FOR GROUND STABILIZATION	SQ YD	1,571
21101625	TOPSOIL FURNISH AND PLACE, 6"	SQ YD	1,370
25000100	SEEDING, CLASS 1	ACRE	0.28
25000400	NITROGEN FERTILIZER NUTRIENT	POUND	26
25000500	PHOSPHORUS FERTILIZER NUTRIENT	POUND	26
25000600	POTASSIUM FERTILIZER NUTRIENT	POUND	26
25100630	EROSION CONTROL BLANKET	SQ YD	1,370
28000250	TEMPORARY EROSION CONTROL SEEDING	POUND	28
28000500	INLET AND PIPE PROTECTION	EACH	10
35101600	AGGREGATE BASE COURSE, TYPE B 4"	SQ YD	284
35101800	AGGREGATE BASE COURSE, TYPE B 6"	SQ YD	222
35102100	AGGREGATE BASE COURSE, TYPE B 9"	SQ YD	1,361
40604050	HOT-MIX ASPHALT SURFACE COURSE, IL-9.5, MIX "C", N50	TON	250
42300200	PORTLAND CEMENT CONCRETE DRIVEWAY PAVEMENT, 6 INCH	SQ YD	121
42300400	PORTLAND CEMENT CONCRETE DRIVEWAY PAVEMENT, 8 INCH	SQ YD	89
42400200	PORTLAND CEMENT CONCRETE SIDEWALK 5 INCH	SQ FT	1,683
42400800	DETECTABLE WARNINGS	SQ FT	150
44000100	PAVEMENT REMOVAL	SQ YD	212
44000500	COMBINATION CURB AND GUTTER REMOVAL	FOOT	178
44000600	SIDEWALK REMOVAL	SQ FT	3,250
550A0050	STORM SEWERS, CLASS A, TYPE 1 12"	FOOT	765
60235300	INLETS, TYPE A, TYPE 1 FRAME, CLOSED LID	EACH	1
60236200	INLETS, TYPE A, TYPE 8 GRATE	EACH	8
60240210	INLETS, TYPE B, TYPE 1 FRAME, OPEN LID	EACH	1
60500060	REMOVING INLETS	EACH	1
60603600	COMBINATION CONCRETE CURB AND GUTTER, TYPE B-6.12	FOOT	99
67100100	MOBILIZATION	L SUM	1
78000200	THERMOPLASTIC PAVEMENT MARKING - LINE 4"	FOOT	1,225
78000400	THERMOPLASTIC PAVEMENT MARKING - LINE 6"	FOOT	279
78000600	THERMOPLASTIC PAVEMENT MARKING - LINE 12"	FOOT	270
78000650	THERMOPLASTIC PAVEMENT MARKING - LINE 24"	FOOT	42
* Z0013798	CONSTRUCTION LAYOUT	L SUM	1
* X0322135	BOLLARDS, QUICK RELEASE	EACH	2
* X7010216	TRAFFIC CONTROL AND PROTECTION, (SPECIAL)	L SUM	1
* X7240500	RELOCATE EXISTING SIGNS	EACH	8
* XX008751	PORTLAND CEMENT CONCRETE BASE COURSE 5"	SQ YD	86

* SPECIAL PROVISIONS

A SPECIALTY ITEMS

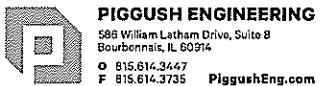

USER NAME: drafting2
588 William Latham Drive, Suite 8
Bourbonnais, IL 60514
o 815.614.3447
F 815.614.3735 PiggushEng.com PLOT DATE: 1/4/2023 10:03 PM

DESIGNED: TJL REVISED: per IDOT Review - 12/14/2022
FILE NAME: _201630301_Plan.dwg DRAWN: JW
PLOT SCALE: 0.38621 REVISED: _____
CHECKED: NAP REVISED: _____
DATE: 6/7/2022 REVISED: _____

VILLAGE OF GRANT PARK
MULTI-USE PATH

SUMMARY OF QUANTITIES

SCALE: N/A SHEET NO. 1 OF 1 SHEETS STA. _____ TO STA. _____

FA-RTE	SECTION	COUNTY	TOTAL SHEETS	HEET NO.
21-00018-00-BT	KANKAKEE	22	3	CONTRACT NO. 87812
ILLINOIS FED AID PROJECT				


SYMBOLS & LEGEND

Existing


○	Iron Pipe (Found)
□	Iron Rod (Found)
◎	Railroad Spike (Found)
■	Storm Inlet
■■	Curb Inlet
○	Storm / Sanitary Manhole
□	Gas Meter
□	Gas Valve
□	Septic Tank
□	Roadway Sign
□	Water Shut-Off
□	Hydrant
□	Well
□	Water Valve
□	Guy Wire
□	Light Post
□	Light Pole w/Mast Fixture
□	Flood Lamp
□	Cable Television Pedestal
□	Telephone Pedestal
□	Fiber Optic Pedestal
□	Power Pole w/Light
□	Power Pole
□	Power Meter
□	Utility Valve Vault
□	Pipeline Marker
□	Flagpole
□	Heavy Duty Hand Hole
— W —	Water Main, Size N/A
— 2W —	Water Main, 2"
— 6W —	Water Main, 6"
— 8W —	Water Main, 8"
— G —	Gas Main, Size N/A
— 1-1/2G —	Gas Main, 1-1/2"
— 2G —	Gas Main, 2"
— 4G —	Gas Main, 4"
— □ —	Storm Sewer Pipe
— □ —	Sanitary Sewer Pipe
— - - - -	Culvert
— OH —	Electric Line, Overhead
— ○ ○ ○ ○ —	Fence, Chain Link
— ○ ○ ○ ○ —	Fence, Wood
— = = = = = = —	Edge of Pavement / Sidewalk
— = = = = = = —	Curb and Gutter
— = = = = = = —	Edge of Gravel
— —	Ditch Flow Line

Proposed

■	New Roadway Sign
●	New Bollard
■■■■■	Accessible Ramp Detectable Warnings
□ □ □ □ □ □	New Concrete Sidewalk w/Control Joints
□	New Bituminous Pavement
+ + + + + + + +	New Concrete Pavement
— — — — — — — —	New Edge of Pavement / Sidewalk
— — — — — — — —	New Curb and Gutter
— ■ — ■ — ■ — ■ —	New 12" Steel Flared End Section
— - - - -	New Culvert
→ → → → →	New Storm Sewer Pipe

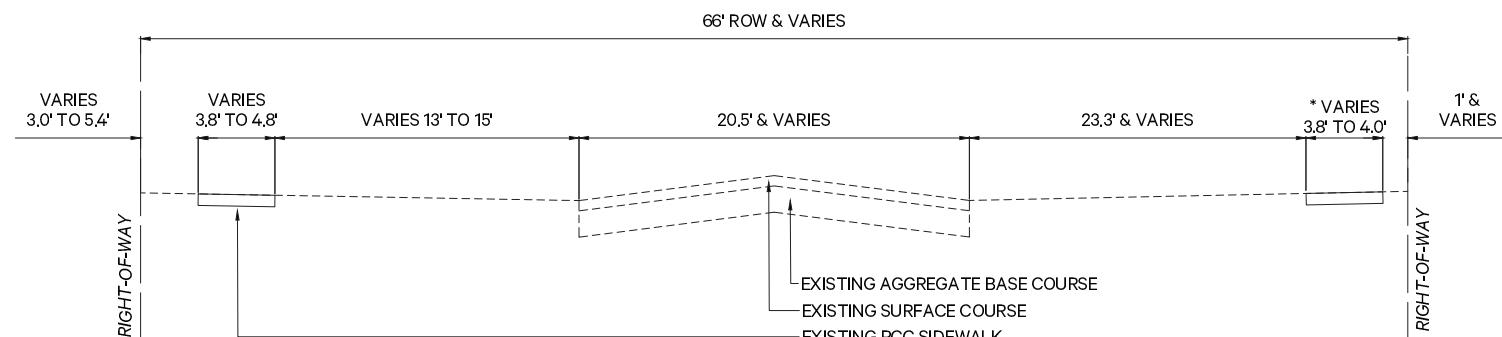

* EXISTING SIDEWALK
STA. 22+53.50 TO STA. 24+39.47
STA. 26+48.50 TO STA. 27+14.82

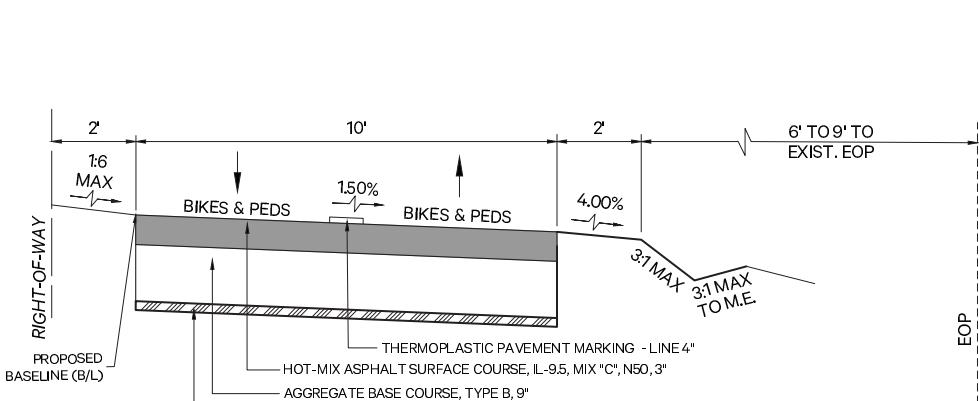

HMA MIXTURE REQUIREMENT TABLE

LOCATIONS:	ENTIRE PROJECT
MIXTURE USE(S):	HMA Surface
BUILDER GUIDE (PG):	PG 64-22
DESIGN AIR Voids:	4.0% @ N50
MIXTURE COMPOSITION (XTMURE GRADATION):	IL 9.5
FRiction AGGREGATE:	MIXTURE C
MIXTURE WEIGHT:	112.0 lb./Sq.Yd. / in.
QUALITY MANAGEMENT PROGRAM:	QC-QA
SUBLOT SIZE:	N/A
DENSITY TEST METHOD:	LR1030-2
MATERIAL TRANSFER DEVICE (REQUIRED):	NO

VILLAGE OF GRANT PARK MULTI-USE PATH

TYPICAL SECTIONS, SYMBOLS & LEGEND

SCALE: N/A SHEET NO. 1 OF 1 SHEETS STA. _____ TO STA. _____

FA RTE.	SECTION	COUNTY	TOTAL SHEETS	SHET NO.
—	21-00018-00-B-T	KANKAKEE	22	4
		CONTRACT NO. 87812		

BOLLARD ITEMS	
LOCATION	BOLLARDS, QUICK RELEASE

		X0322135
STATION	OFFSET	EACH
16+76.37	26' LT	1
28+99.06	26' LT	1
TOTAL		2

RELOCATION ITEMS		
LOCATION		RELOCATE EXISTING SIGNS
		X724.0500
STATION	OFFSET	EACH
16+03.00	24° LT	1
22+22.00	16.5' LT	1
23+32.00	18.5' LT	1
25+12.00	18.5' LT	1
26+54.00	25' RT	1
27+02.00	30' RT	1
28+69.00	18' LT	1
29+09.00	28.5' LT	1
TOTAL		8

PAVEMENT ITEMS																
LOCATION					GEOTECHNICAL FABRIC FOR GROUND STABILIZATION	AGGREGATE BASE COURSE, TYPE B 4"	AGGREGATE BASE COURSE, TYPE B 6"	AGGREGATE BASE COURSE, TYPE B 9"	HOT-MIX ASPHALT SURFACE COURSE, IL-9.5, MIX "C", N50	PCC DRIVEWAY PAVEMENT, 6 INCH	PCC DRIVEWAY PAVEMENT, 8 INCH	PORTLAND CEMENT CONCRETE SIDEWALK 5 INCH	DETECTABLE WARNINGS	COMBINATION CONCRETE CURB AND GUTTER, TYPE B-6.12	PORTLAND CEMENT CONCRETE BASE COURSE 5"	
					21001000	35101600	35101800	35102100	40604050	42300200	42300400	42400200	42400800	60603900	XX008751	
STATION	OFFSET	TO	STATION	OFFSET	SQ YD	SQ YD	SQ YD	SQ YD	TON	SQ YD	SQ YD	SQ FT	FOOT	SQ YD		
15+95.65	LT		22+90.00	LT	840	97	169	683	123	68	89	505	60	99	30	
22+52.77	RT		23+29.79	RT		58			3			376	30		16	
22+90.00	LT		26+88.77	LT	477	30	34	443	79	34		123	20		16	
26+46.00	RT		27+17.21	RT		65			2			489	40		11	
26+88.77	LT		29+19.48	LT	254	34	19	235	43	19		190			13	
TOTAL						1,571	284	222	1,361	250	121	89	1,683	150	99	86

STORM SEWER STRUCTURE ITEMS						
STR. #	LOCATION		INLET AND PIPE PROTECTION	INLETS, TYPE A, TYPE 1 FRAME, CLOSED LID	INLETS, TYPE A, TYPE 8 GRATE	INLETS, TYPE B, TYPE 1 FRAME, OPEN LID
			28000500	60235300	60236200	60240210
	STATION	OFFSET CEN STR	EACH	EACH	EACH	EACH
1	28+76.00	20.35' LT	1	1		
2	28+68.06	15.00' LT	1		1	
2A	27+25.34	14.86' LT	1		1	
3	28+81.60	14.48' LT	1		1	
4	25+27.03	14.67' LT	1			1
4A	23+80.38	15.00' LT	1		1	
4B	23+31.15	15.00' LT	1		1	
5	22+90.28	15.00' LT	1		1	
6	21+99.65	15.00' LT	1		1	
6A	21+14.37	15.00' LT	1		1	
	TOTAL		10	1	8	1

LOCATION					TRENCH BACKFILL	STORM SEWERS, CLASS A, TYPE 1 12"
STATION	OFFSET	TO	STATION	OFFSET	CU YD	FOOT
21+14.37	15.00' LT		21+99.65	15.00' LT	6	83
21+99.65	15.00' LT		22+90.28	15.00' LT	8	89
22+90.28	15.00' LT		23+31.15	15.00' LT	2	39
23+31.15	15.00' LT		23+80.38	15.00' LT	2	47
23+80.38	15.00' LT		25+27.03	14.67' LT	1	144
25+27.03	14.67' LT		25+27.36	33.00' LT	1	17
25+27.03	14.67' LT		26+81.60	14.62' LT	5	152
26+81.60	14.82' LT		27+25.34	14.86' LT	4	42
27+25.34	14.86' LT		28+68.06	15.00' LT	34	141
28+68.06	15.00' LT		28+76.00	20.35' LT	1	7
28+76.00	20.35' LT		28+79.88	24.24' LT	1	4
TOTAL					65	765

TREE REMOVAL ITEMS		
LOCATION	TREE REMOVAL (OVER 15 UNITS DIAMETER)	
	20100210	
STATION	OFFSET	UNIT
23+18.50	31.5' LT	28
27+20.00	26.5' RT	48

LANDSCAPING ITEMS											
LOCATION					TOPSOIL FURNISH AND PLACE, 6"	SEEDING, CLASS 1	NITROGEN FERTILIZER NUTRIENT	PHOSPHORUS FERTILIZER NUTRIENT	POTASSIUM FERTILIZER NUTRIENT	EROSION CONTROL BLANKET	TEMPORARY EROSION CONTROL SEEDING
					21101625	25000100	25000400	25000500	25000600	25100630	28000250
STATION	OFFSET	TO	STATION	OFFSET	SQ YD	ACRE	POUND	POUND	POUND	SQ YD	POUND
15+95.65	LT		22+90.00	LT	600	0.12	11	11	11	600	12
22+52.77	RT		23+29.79	RT	23	0.01	1	1	1	23	1
22+90.00	LT		26+88.77	LT	441	0.09	8	8	8	441	9
26+46.00	RT		27+17.21	RT	44	0.01	1	1	1	44	1
26+88.77	LT		29+19.48	LT	262	0.05	5	5	5	262	5
TOTAL					1370	0.28	26	26	26	1370	28



PIGGUSH ENGINEERING
586 William Latham Drive, Suite 8
Bourbonnais, IL 60914
O 815.614.3447
F 815.614.3725 PiggushEng.com

USER NAME : drafting2
FILE NAME : _20163.0301 Plan.dwg
PLOT SCALE : 0.3869:1
PLOT DATE : 11/03/2016 12:17PM

DESIGNED : TJL
DRAWN : JGW
CHECKED : NAP
DATE : 6/7/2002

REVISED : per IDOT Review - 12/

REVISED : _____

REVISED : _____



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**VILLAGE OF GRANT PARK
MULTI-USE PATH**

SCHEDULES OF QUANTITIES

SCHEDULES OF QUANTITIES

FA RTE.	SECTION	COUNTY	TOTAL SHEETS	SHEET NO.
—	21-00018-00-BT	KANKAKEE	22	5
CONTRACT NO. 87812				

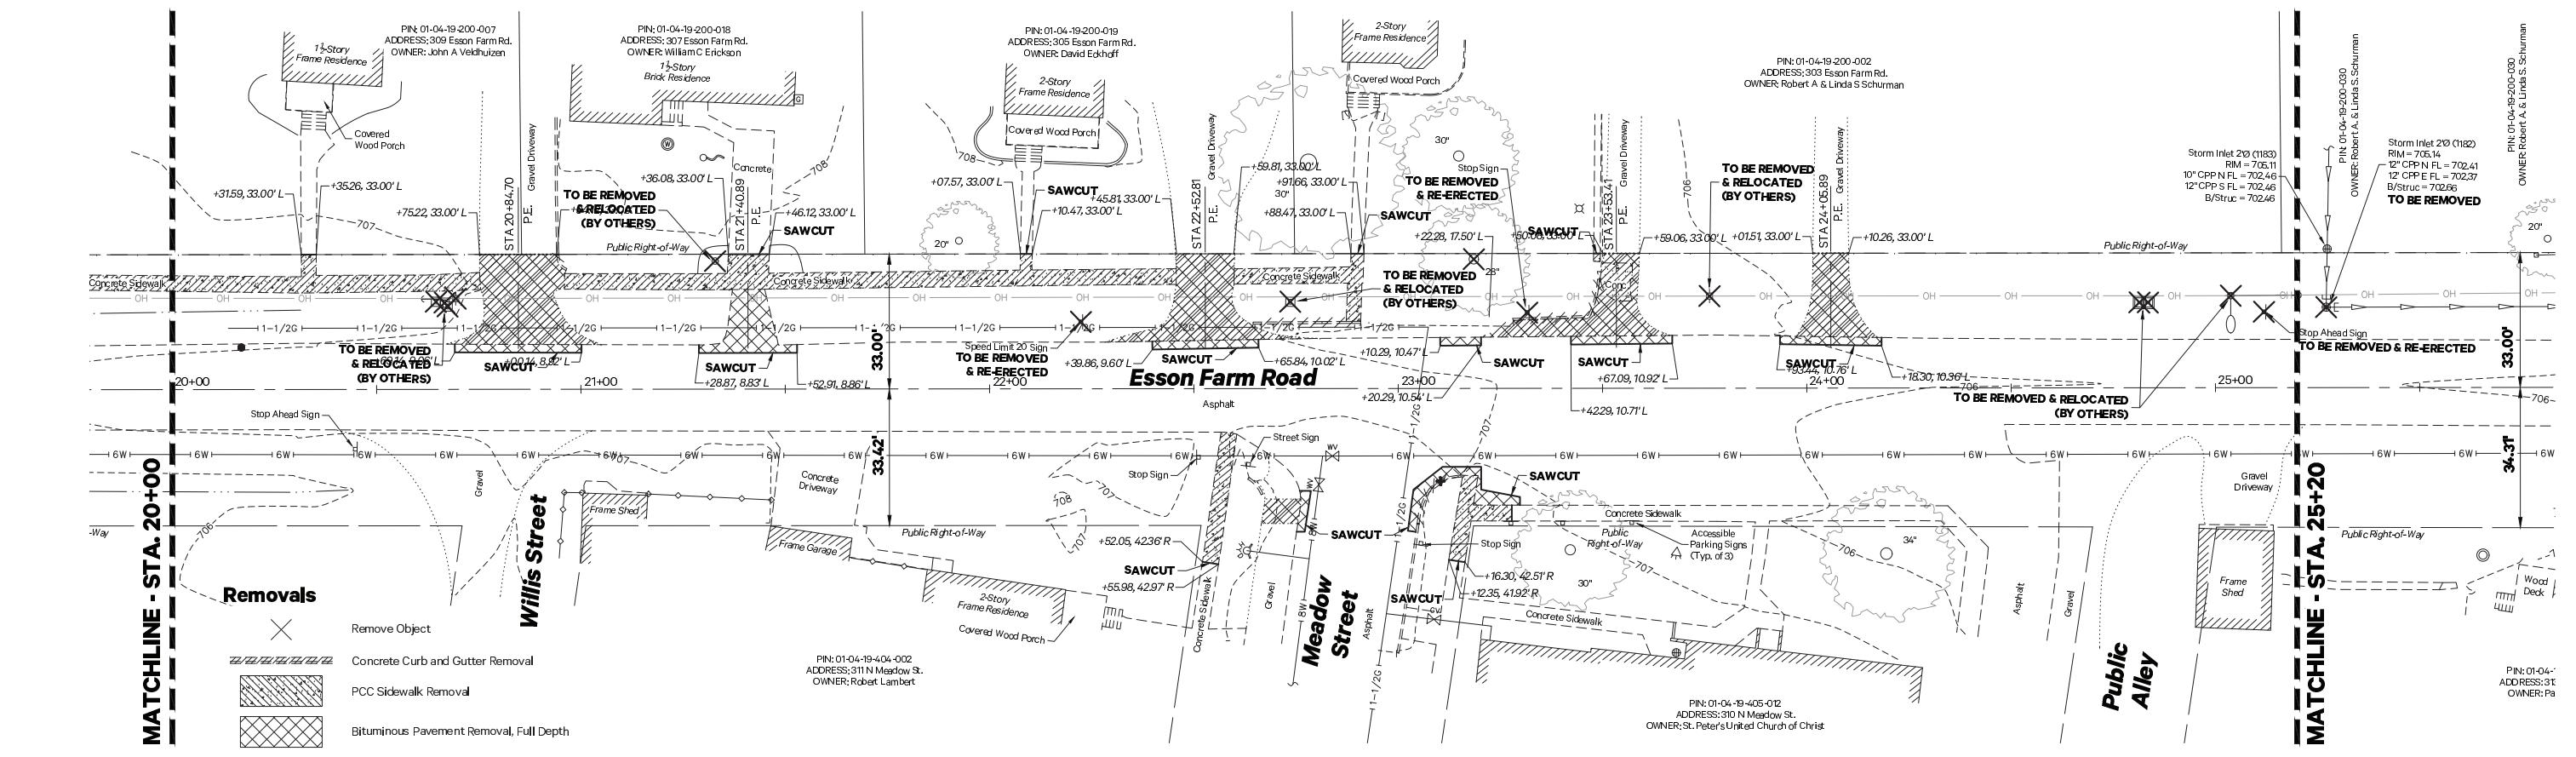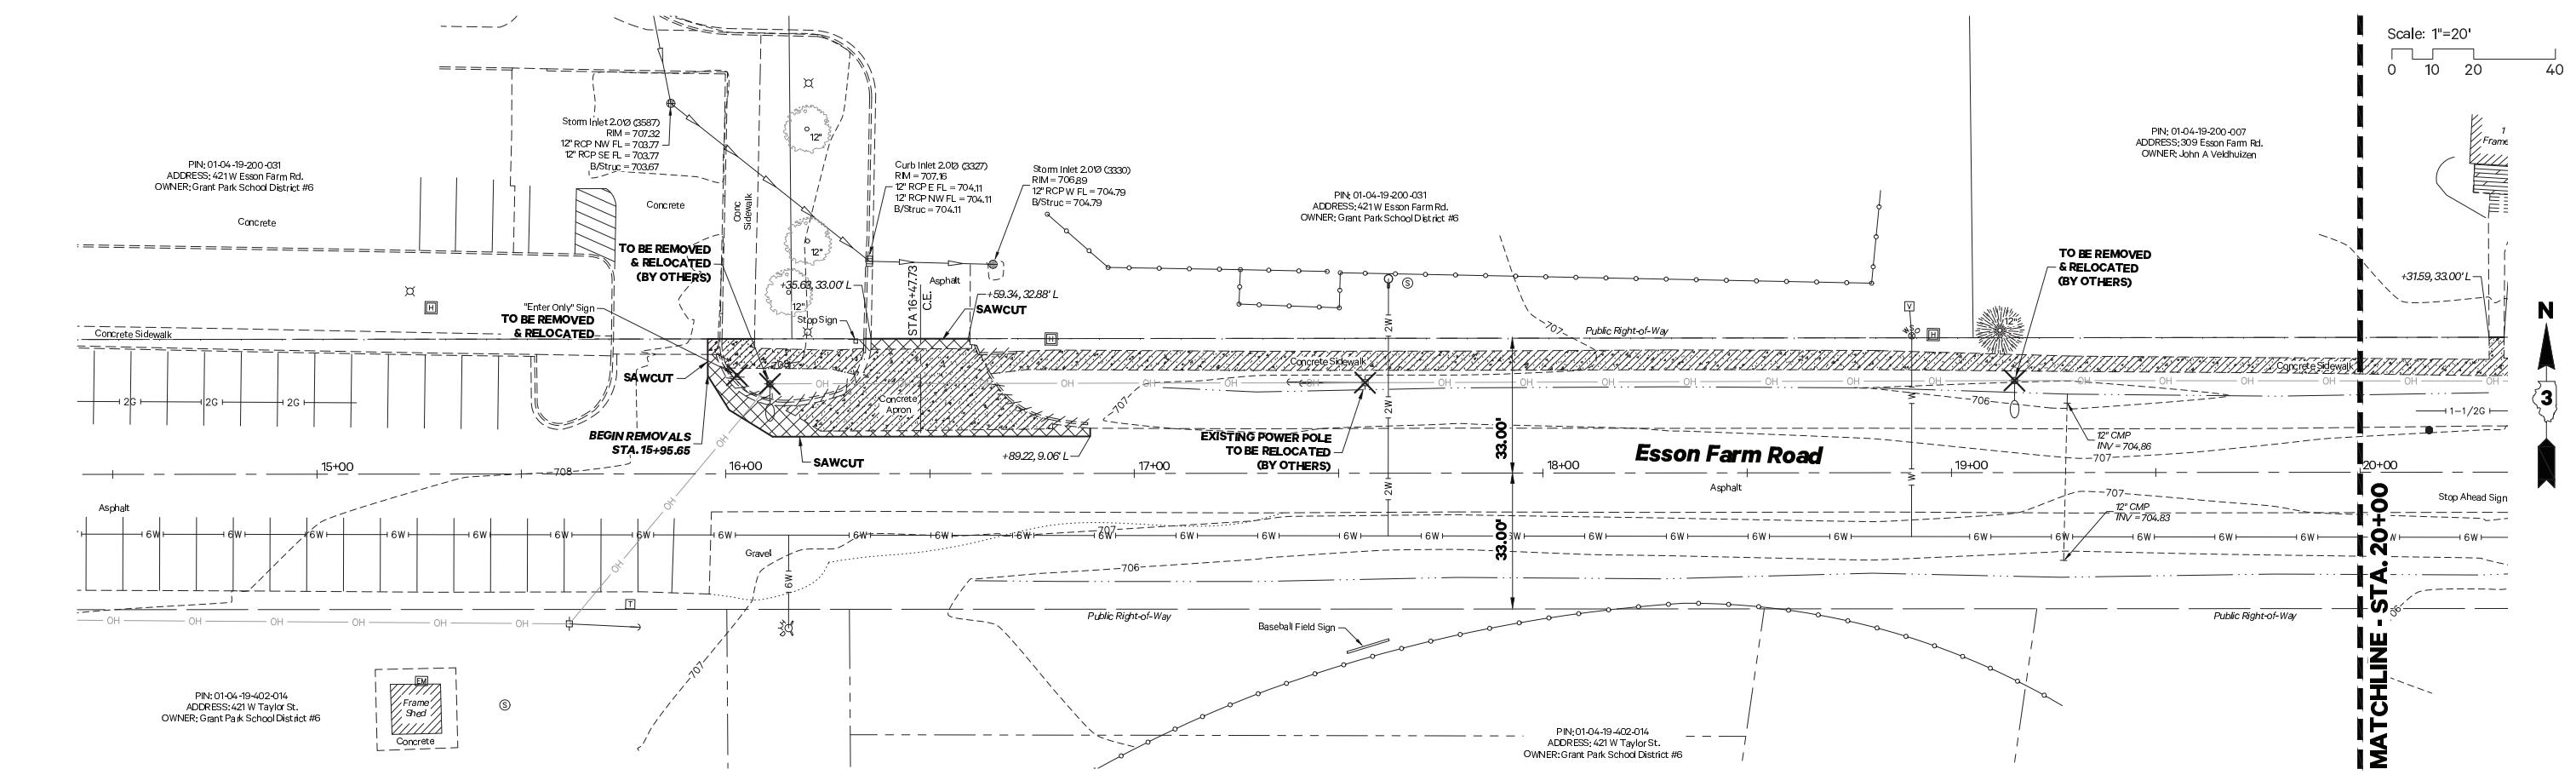


**VILLAGE OF GRANT PARK
MULTI-USE PATH**

EXISTING CONDITIONS & REMOVALS PLAN

SCALE: 1" = 20' SHEET NO. 1 OF 2 SHEETS STA. 15+95.70 TO STA. 25+20.00


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_____	21-00018-00-BT	KANKAKEE	22	6



CONTRACT NO. 87812


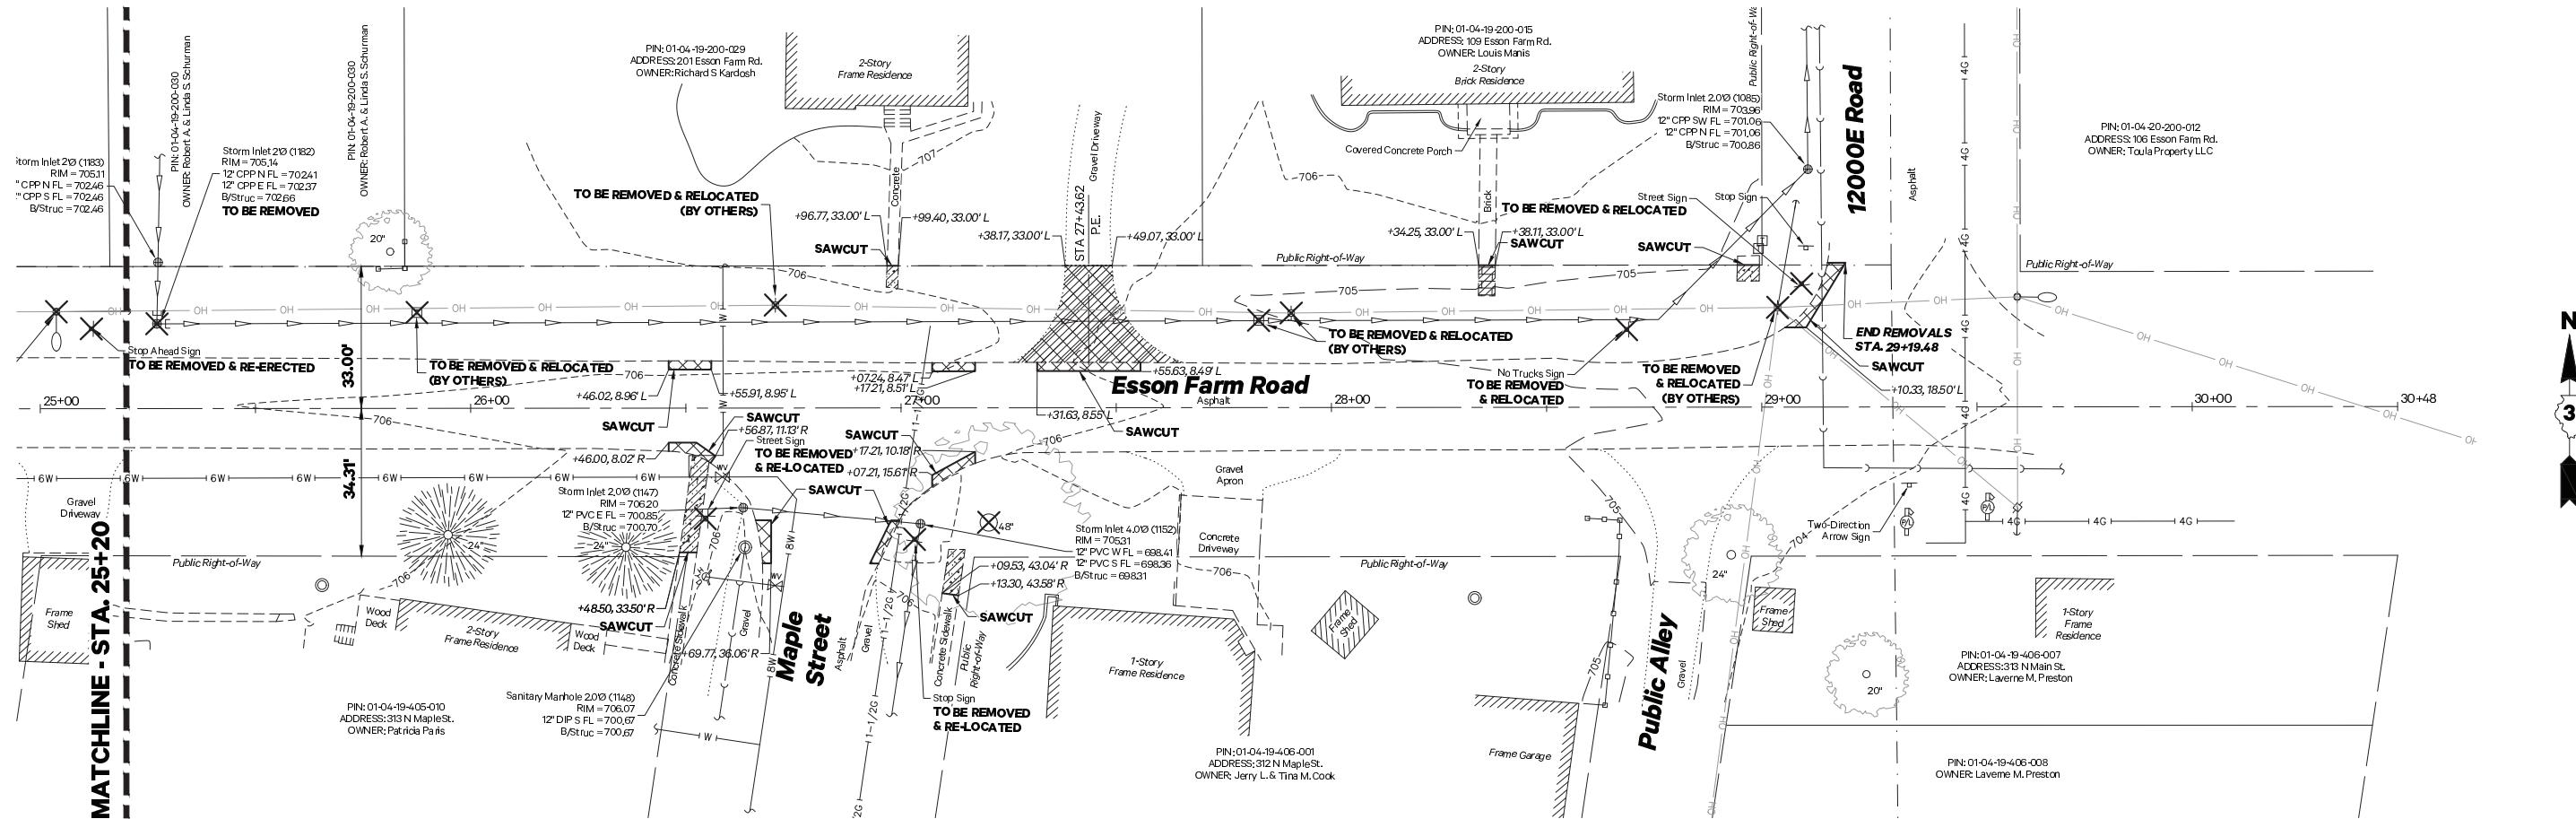


Removals

- Remove Object
- Concrete Curb and Gutter Removal
- PCC Sidewalk Removal
- Bituminous Pavement Removal, Full Depth
- Aggregate Pavement Removal, Full Depth

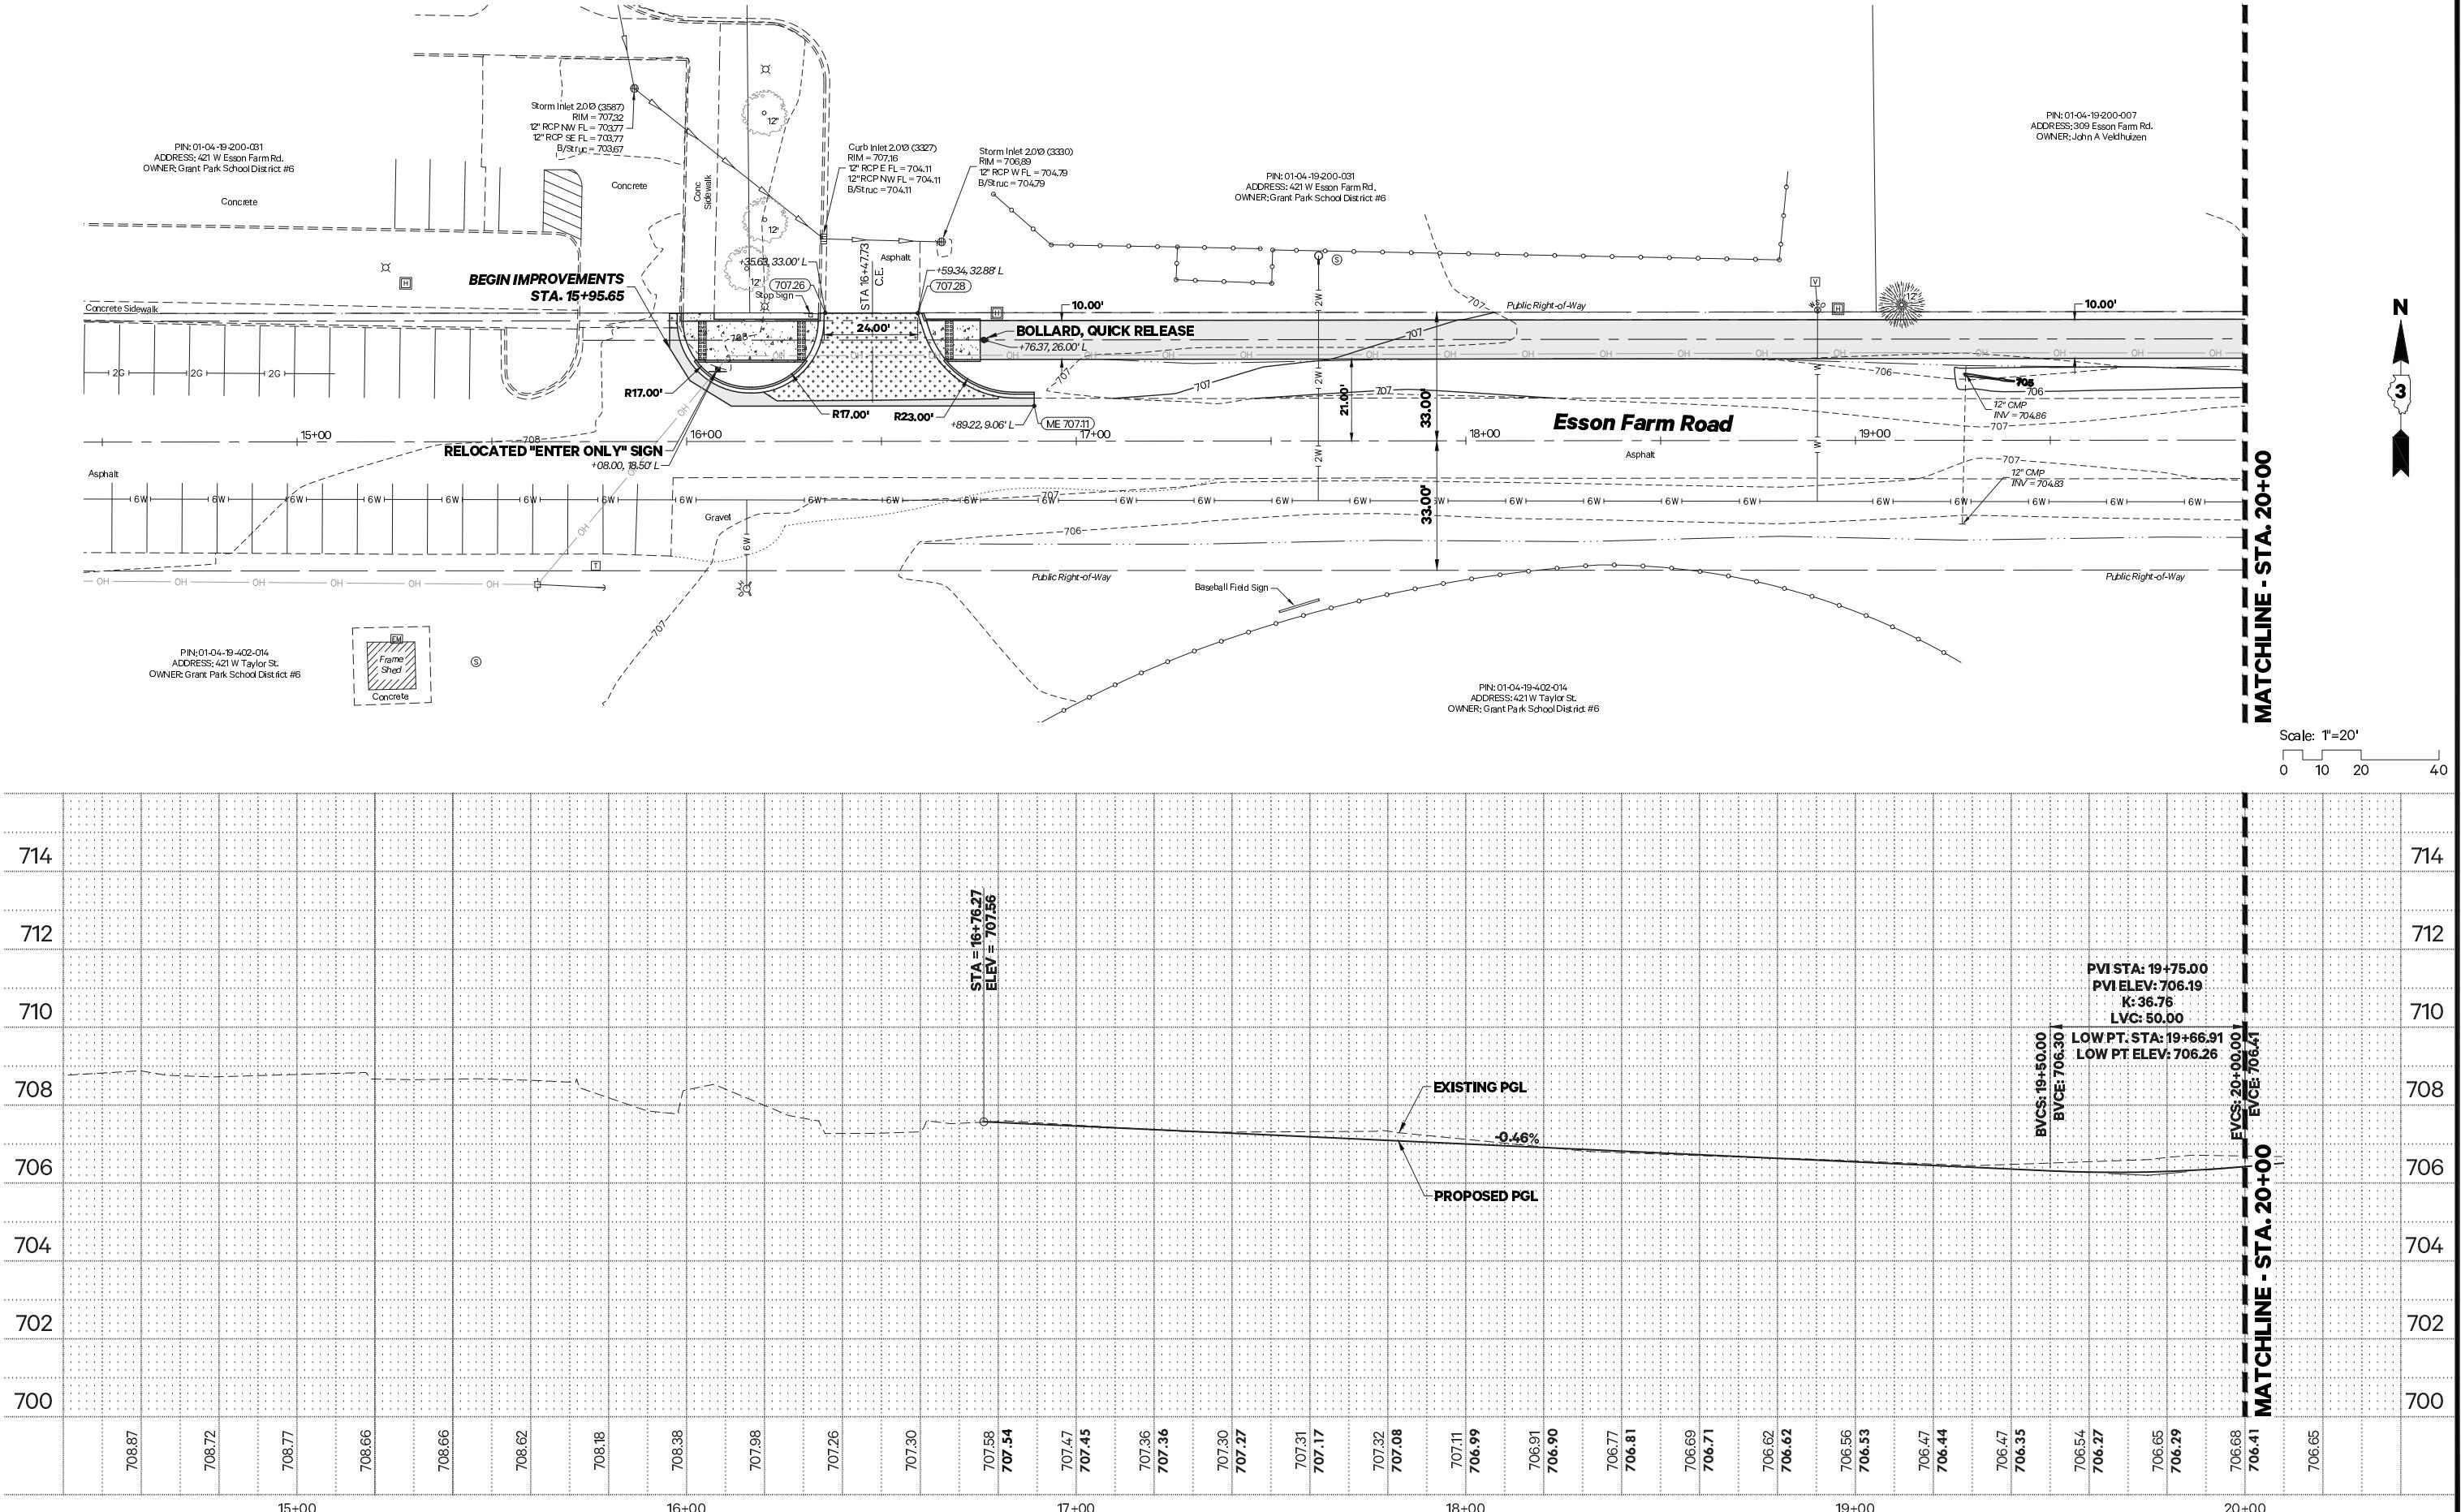

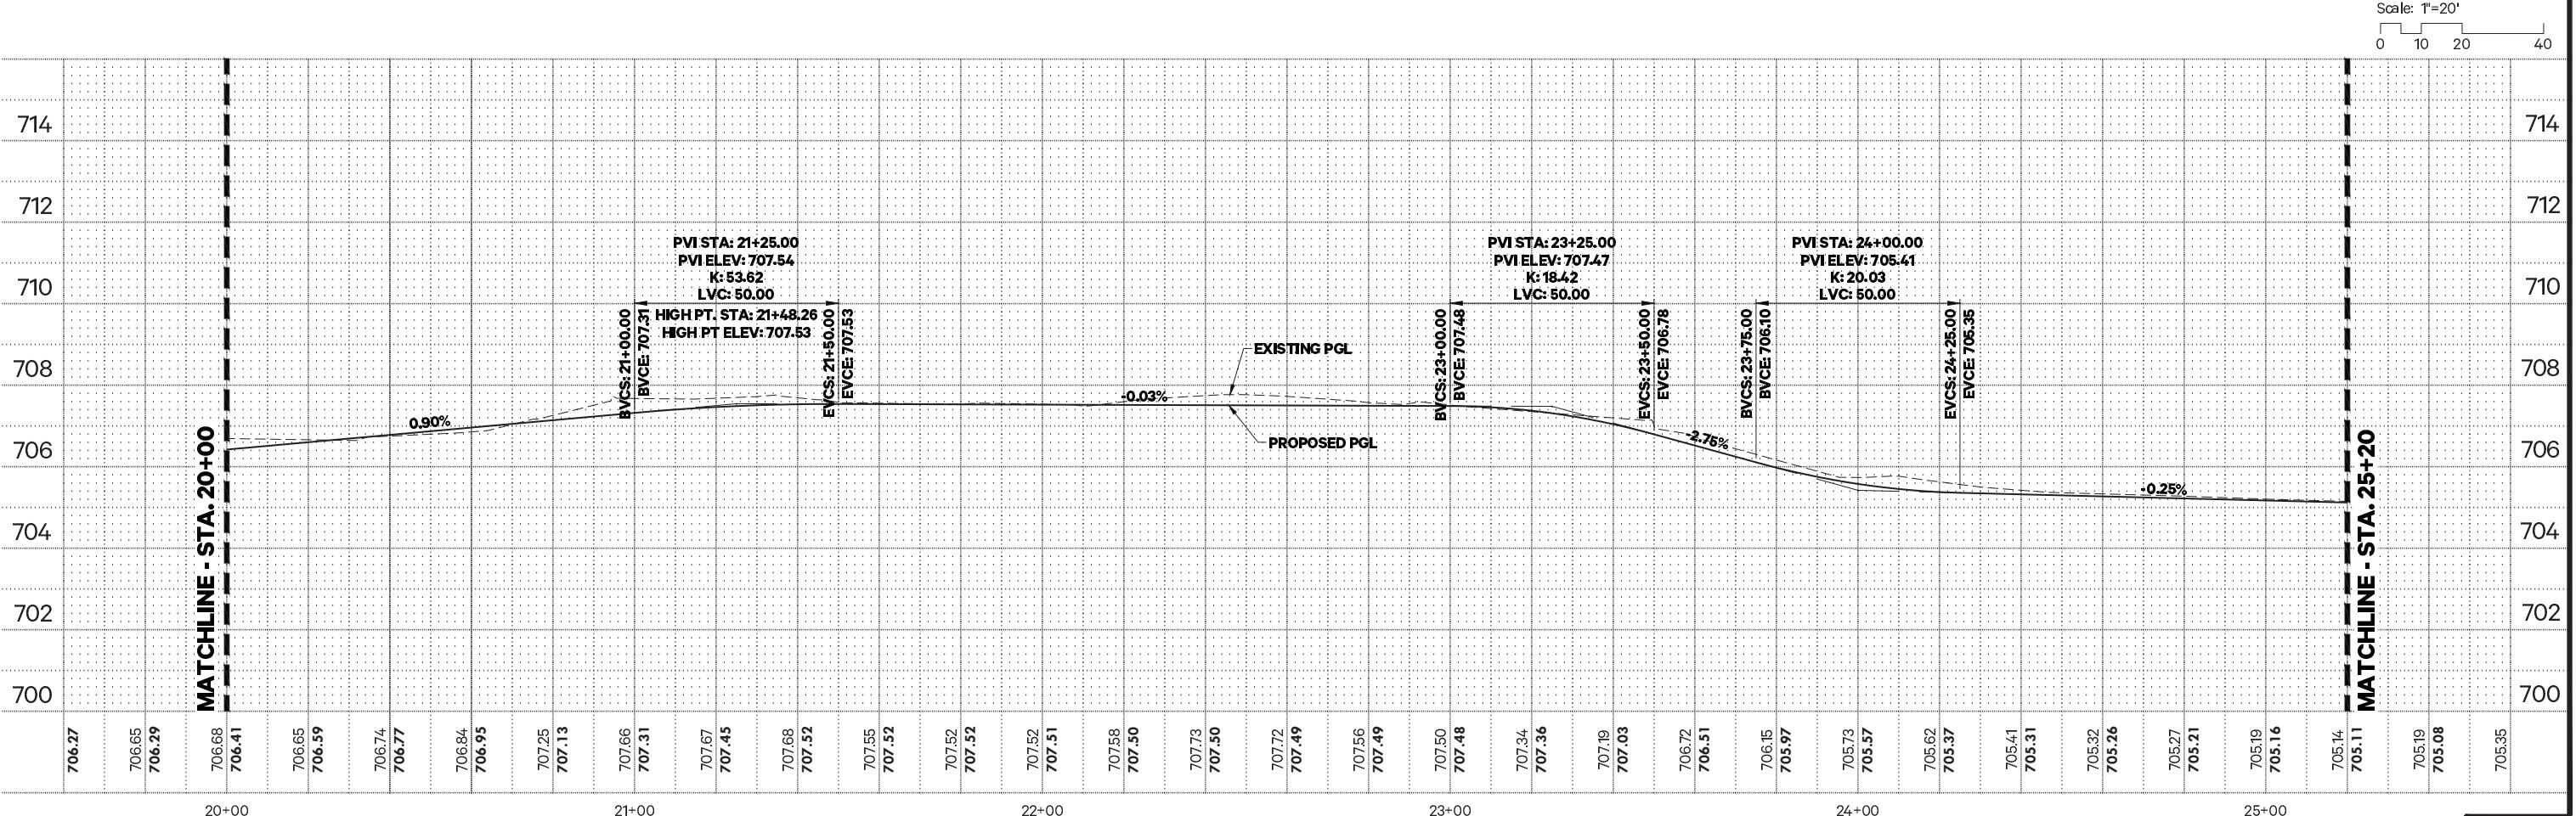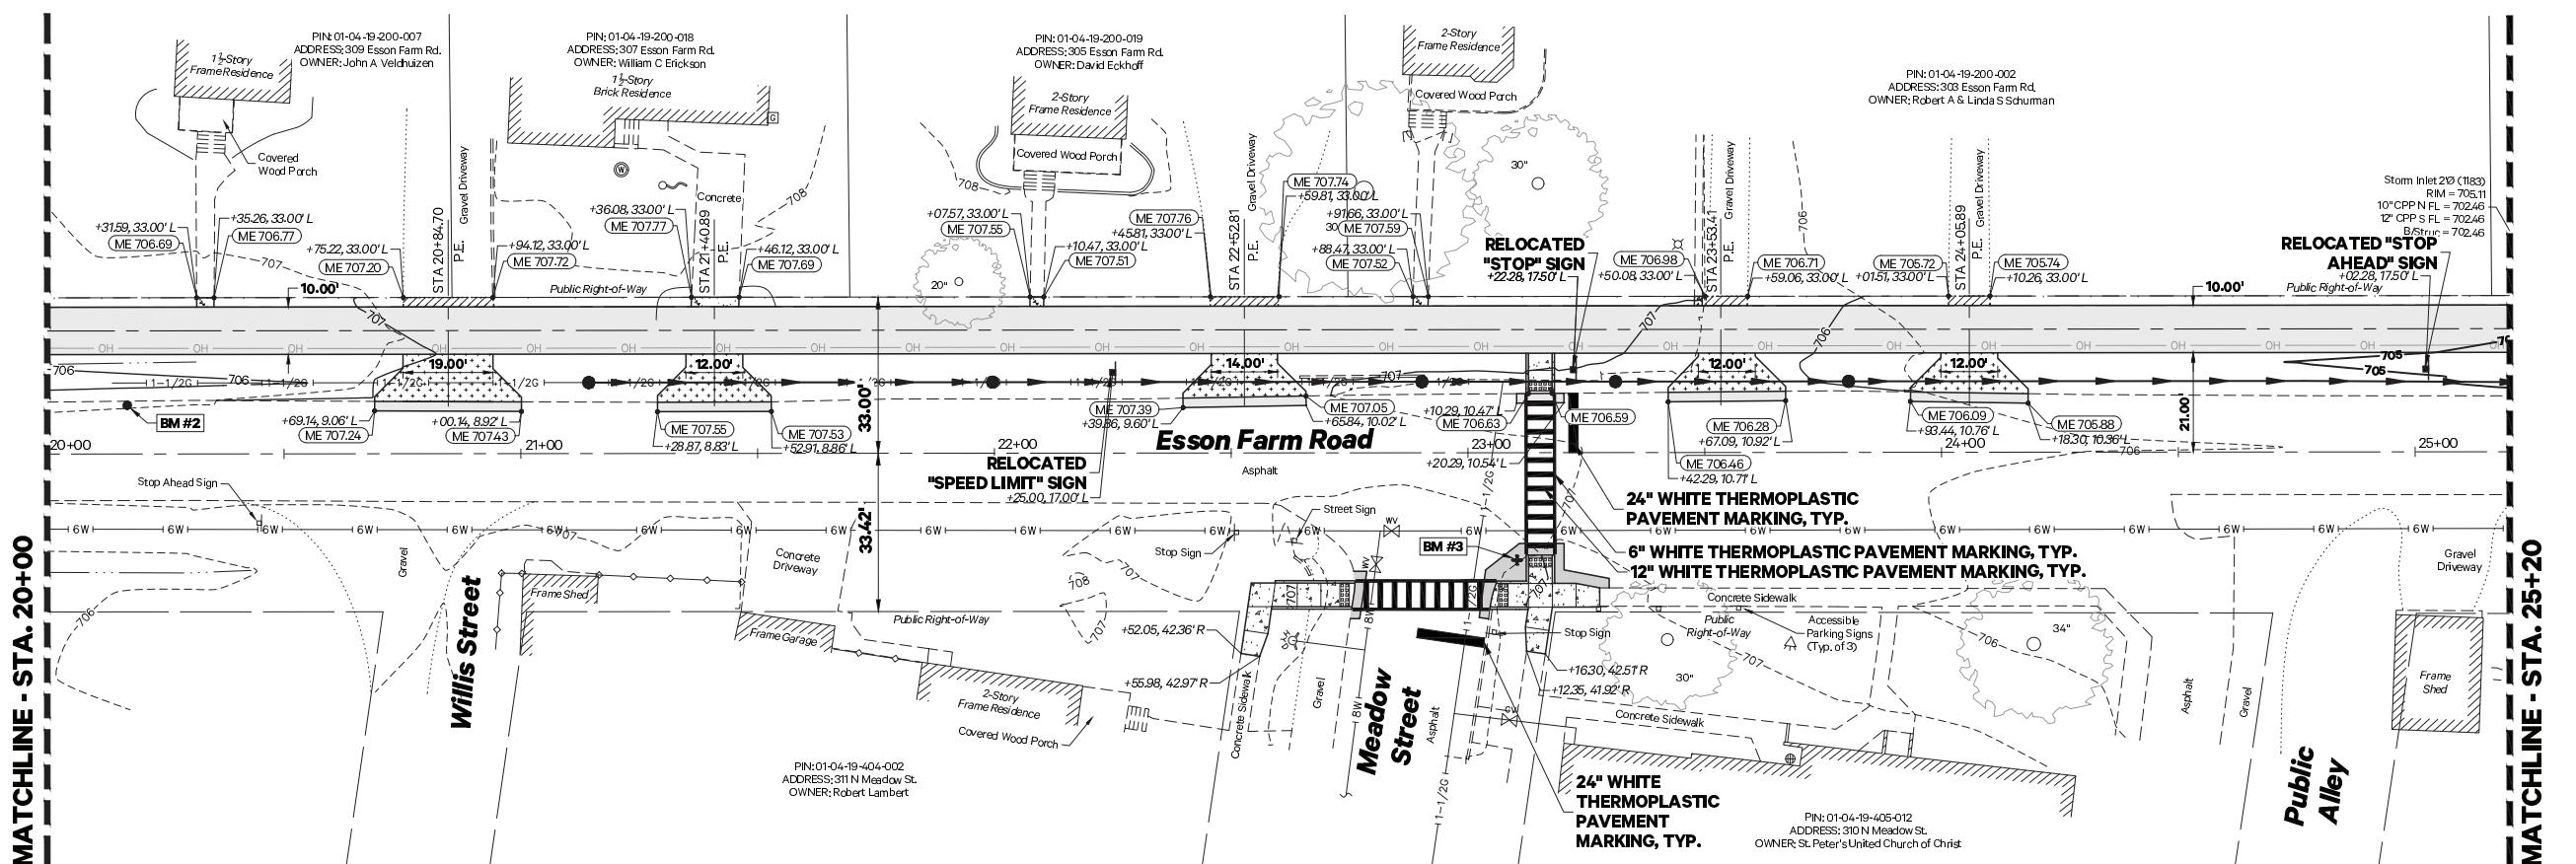

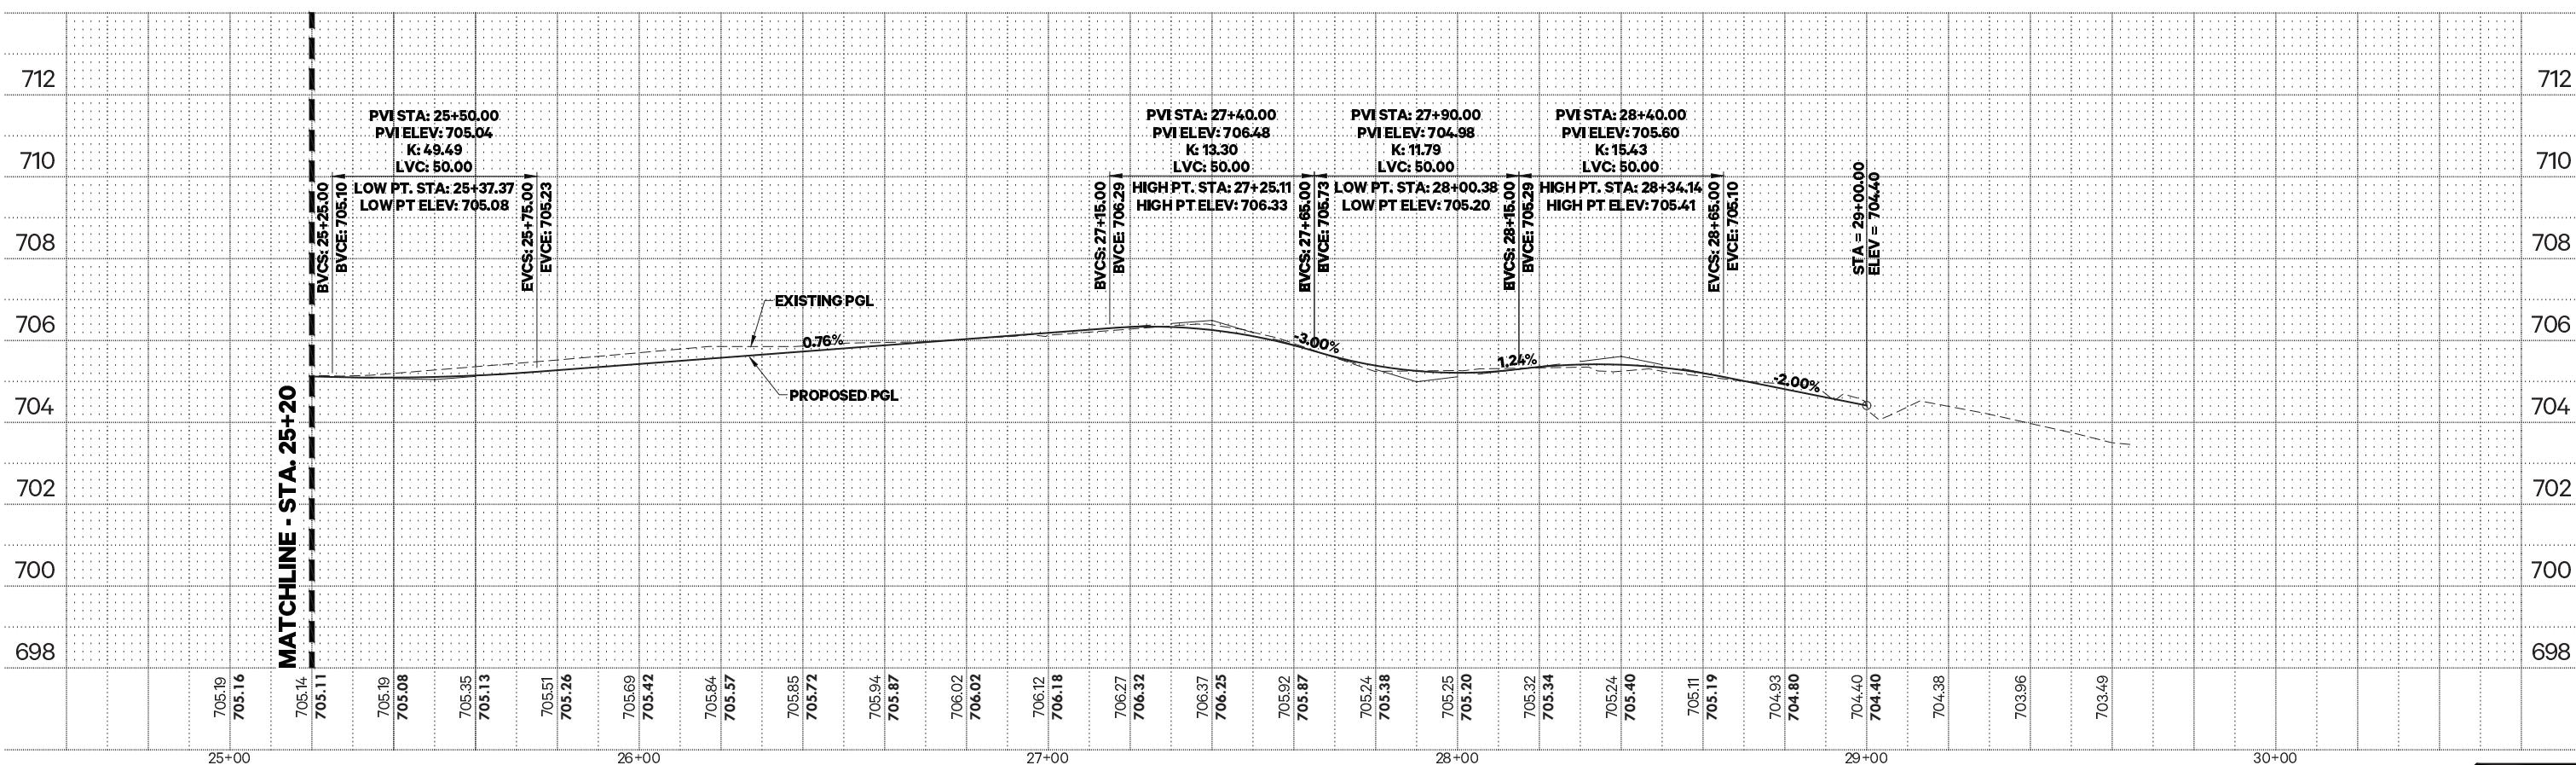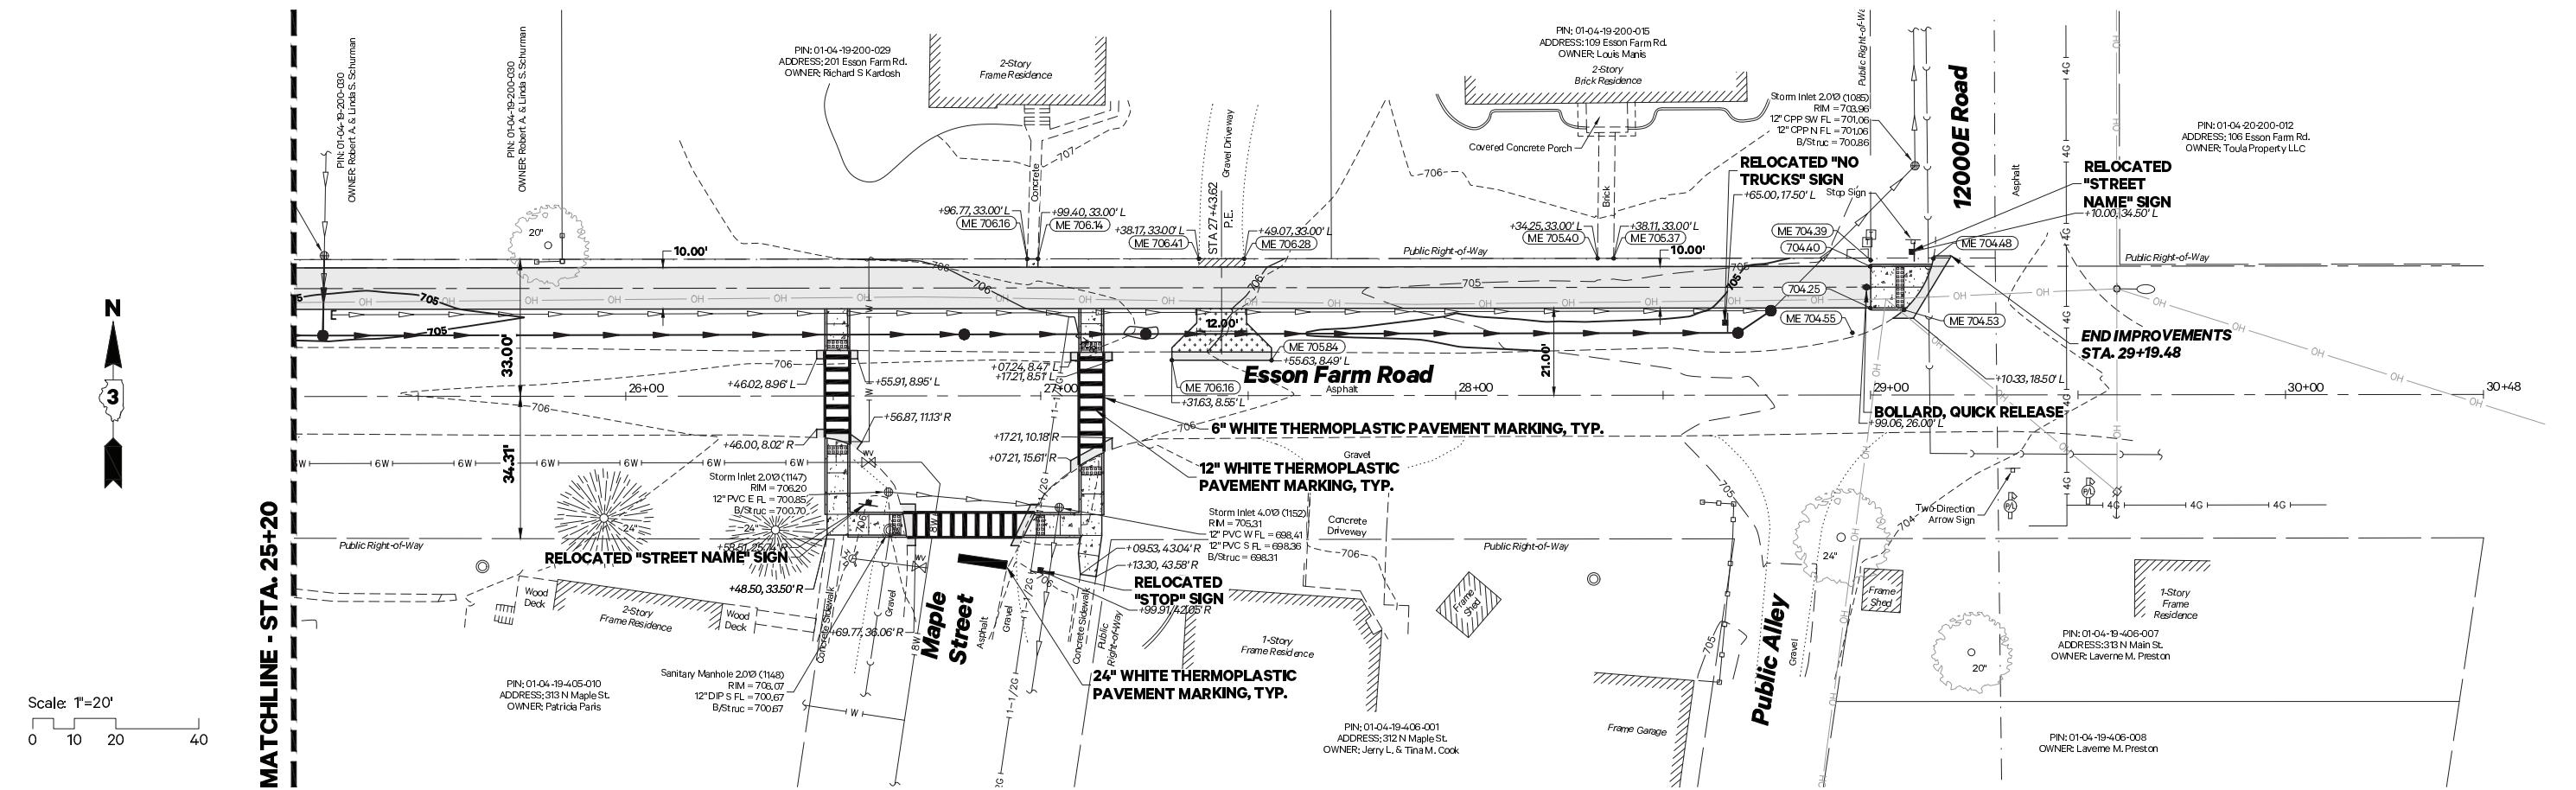

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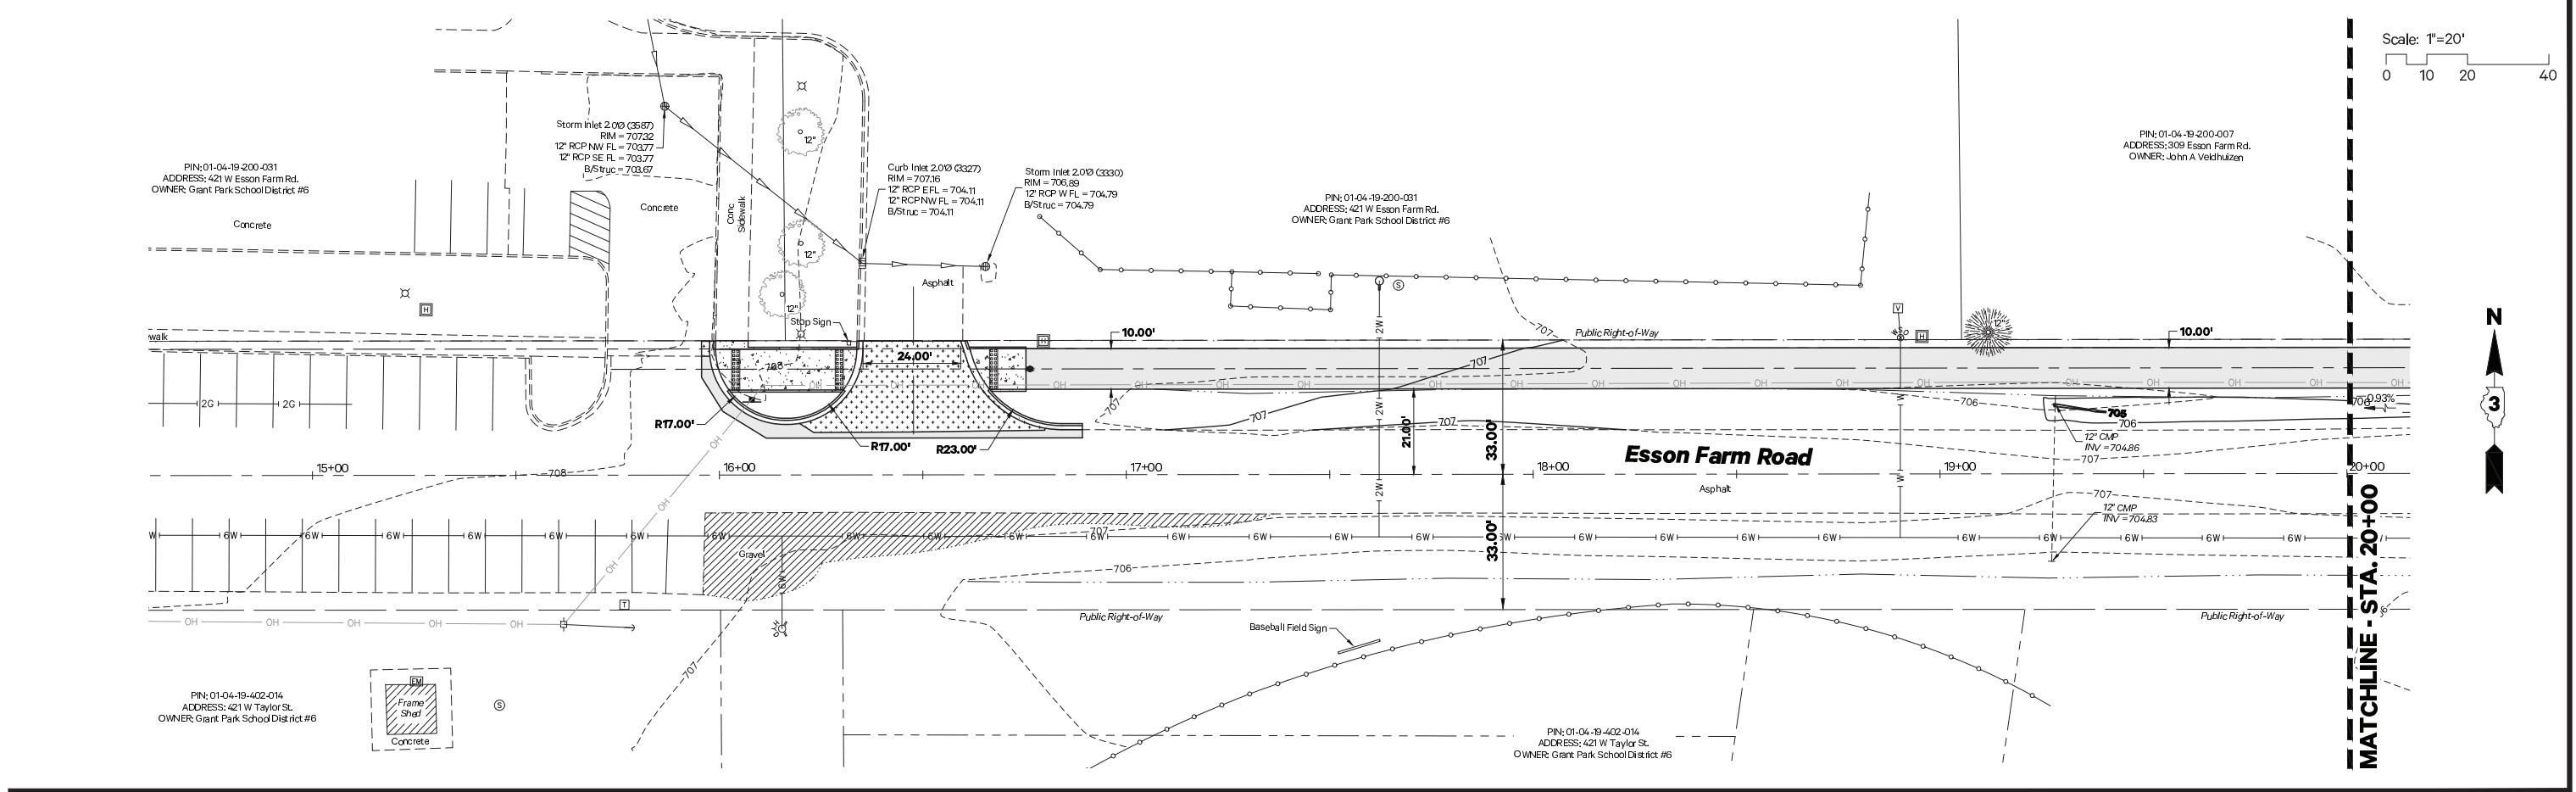
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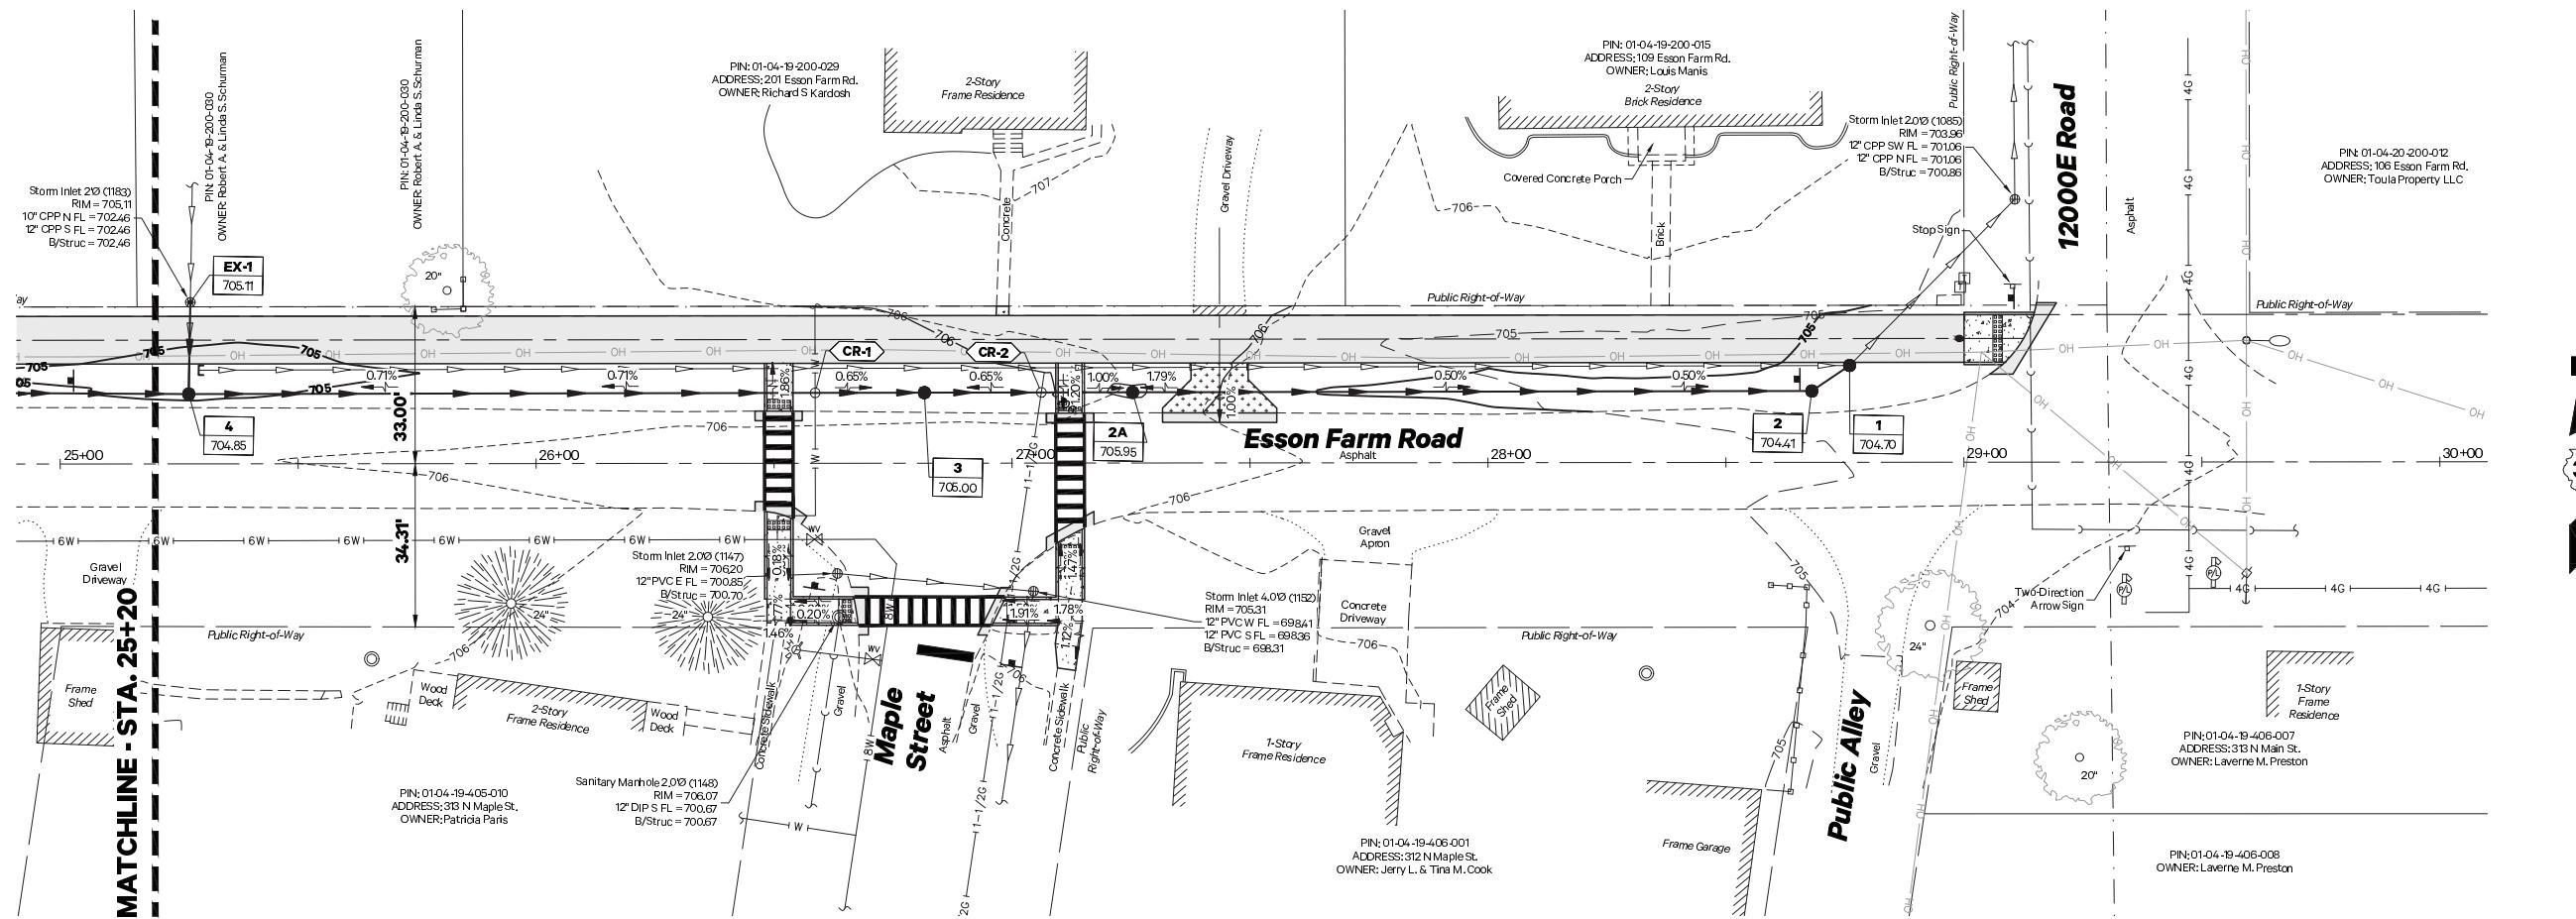
REVISED : per IDOT Review - 12/1
REVISED : _____
REVISED : _____
REVISED : _____

VILLAGE OF GRANT PARK MULTI-USE PATH

PLAN & PROFILES

SECTION	COUNTY	TOTAL SHEETS	HEET NO.
21-00018-00-BT	KANKAKEE	22	10
CONTRACT NO. 87812			





STORM SEWER STRUCTURE SCHEDULE

1. STA 28+76.00, 20.35' L
INLETS, TYPE A, TYPE 1 FRAME, CLOSED LID
RIM = 704.70
12" SW. FL IN INV = 70127
EXIST. 12" NE. FL OUT INV = 70122 (VERIFY IN FIELD)
1-2: 7 LF 12" RCP @ 0.55%
2. STA 28+68.06, 15.00' L
INLETS, TYPE A, TYPE 8 GRATE
RIM = 704.41
12" W. FL IN INV = 70131
12" E. FL OUT INV = 70131
2-2A: 14 LF 12" RCP @ 0.35%
- 2A. STA 27+25.24, 14.86' L
INLETS, TYPE A, TYPE 8 GRATE
RIM = 705.95
12" W. FL IN INV = 70181
12" E. FL OUT INV = 70181
2A-3: 42 LF 12" RCP @ 0.35%
3. STA 26+81.60, 14.82' L
INLETS, TYPE A, TYPE 8 GRATE
RIM = 705.00
12" W. FL IN INV = 70195
12" E. FL OUT INV = 70195
3-4: 152 LF 12" RCP @ 0.30%
4. STA 25+27.03, 14.67' L
INLETS, TYPE B, TYPE 1 FRAME, OPEN LID
RIM = 704.85
12" N. FL IN INV = 702.41
12" W. FL IN INV = 702.41
12" E. FL OUT INV = 702.41
4-EX-1: 17 LF 12" RCP @ 0.30%
4-4A: 144 LF 12" RCP @ 0.22%
- EX-1. STA 25+27.38, 33.93' LT
EXISTING INLET
EX. RIM = 705.11
EX 10" N. FL IN INV = 702.46 (VERIFY IN FIELD)
12" S. FL OUT INV = 702.46
- 4A. STA 23+80.38, 15.00' L
INLETS, TYPE A, TYPE 8 GRATE
RIM = 705.73
12" W. FL IN INV = 703.87
12" E. FL OUT INV = 702.73
4A-4B: 47 LF 12" RCP @ 0.22%
- 4B. STA 23+31.15, 15.00' L
INLETS, TYPE A, TYPE 8 GRATE
RIM = 706.35
12" W. FL IN INV = 703.97
12" E. FL OUT INV = 703.97
4B-5: 39 LF 12" RCP @ 0.22%
5. STA 22+90.28, 15.00' L
INLETS, TYPE A, TYPE 8 GRATE
RIM = 706.72
12" W. FL IN INV = 704.05
12" E. FL OUT INV = 704.05
5-6: 89 LF 12" RCP @ 0.22%
6. STA 21+99.65, 15.00' L
INLETS, TYPE A, TYPE 8 GRATE
RIM = 707.06
12" W. FL IN INV = 704.25
12" E. FL OUT INV = 704.25
6-6A: 83 LF 12" RCP @ 0.22%
- 6A. STA 21+14.37, 15.00' L
INLETS, TYPE A, TYPE 8 GRATE
RIM = 707.10
12" E. FL OUT INV = 704.43

UTILITY CROSSING SCHEDULE

- | | |
|---|----------------------------|
| CR-1. STA. 26+58.64, 14.75' LT
EXISTING FINISHED GRADE | = 705.65 |
| 12" STORM BOTTOM | = 70140 |
| EXIST. 1" WATER MAIN BOTTOM | = 701.15 (VERIFY IN FIELD) |
| CR-2. STA. 27+06.16, 14.79' LT
EXISTING FINISHED GRADE | = 705.79 |
| EXIST. 1 1/4" GAS MAIN BOTTOM | = 703.17 |
| 12" STORM TOP | = 703.05 |

Scale: 1" = 20'
0 10 20 40



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FILE NAME: 20163.0301 Plan.dwg
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PLOT DATE: 4/4/2023 1:09:45 PM

DESIGNED: TJL
DRAWN: JGW
CHECKED: NAP
DATE: 6/7/2022

REVISED: per IDOT Review -12/14/2022
REVISED: _____
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VILLAGE OF GRANT PARK MULTI-USE PATH



DRAINAGE & UTILITY PLANS

SCALE: 1" = 20' SHEET NO. 2 OF 2 SHEETS STA. 25+20.00 TO STA. 29+17.21

F.A. RTE.	SECTION	COUNTY	TOTAL SHEETS	SHEET NO.
_____	21-00018-00-BT	KANKAKEE	22	12

CONTRACT NO. 87812

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REVISED : per IDOT Review - 12/14/2022
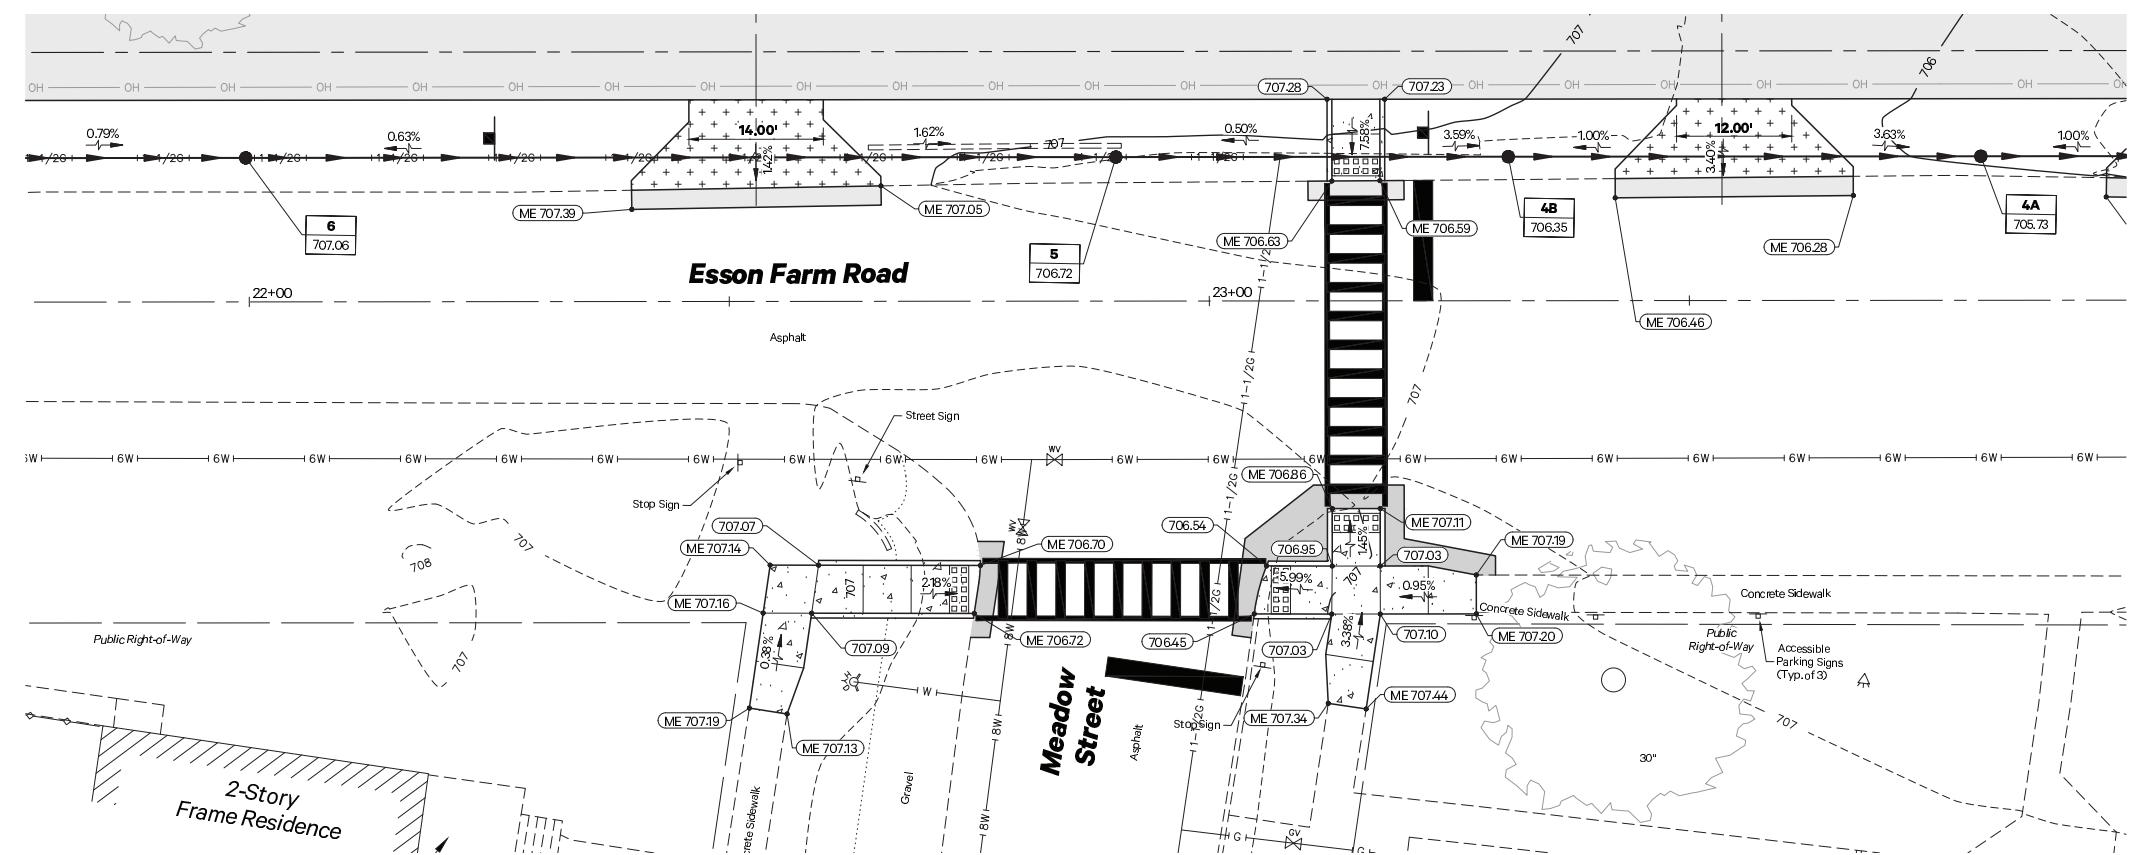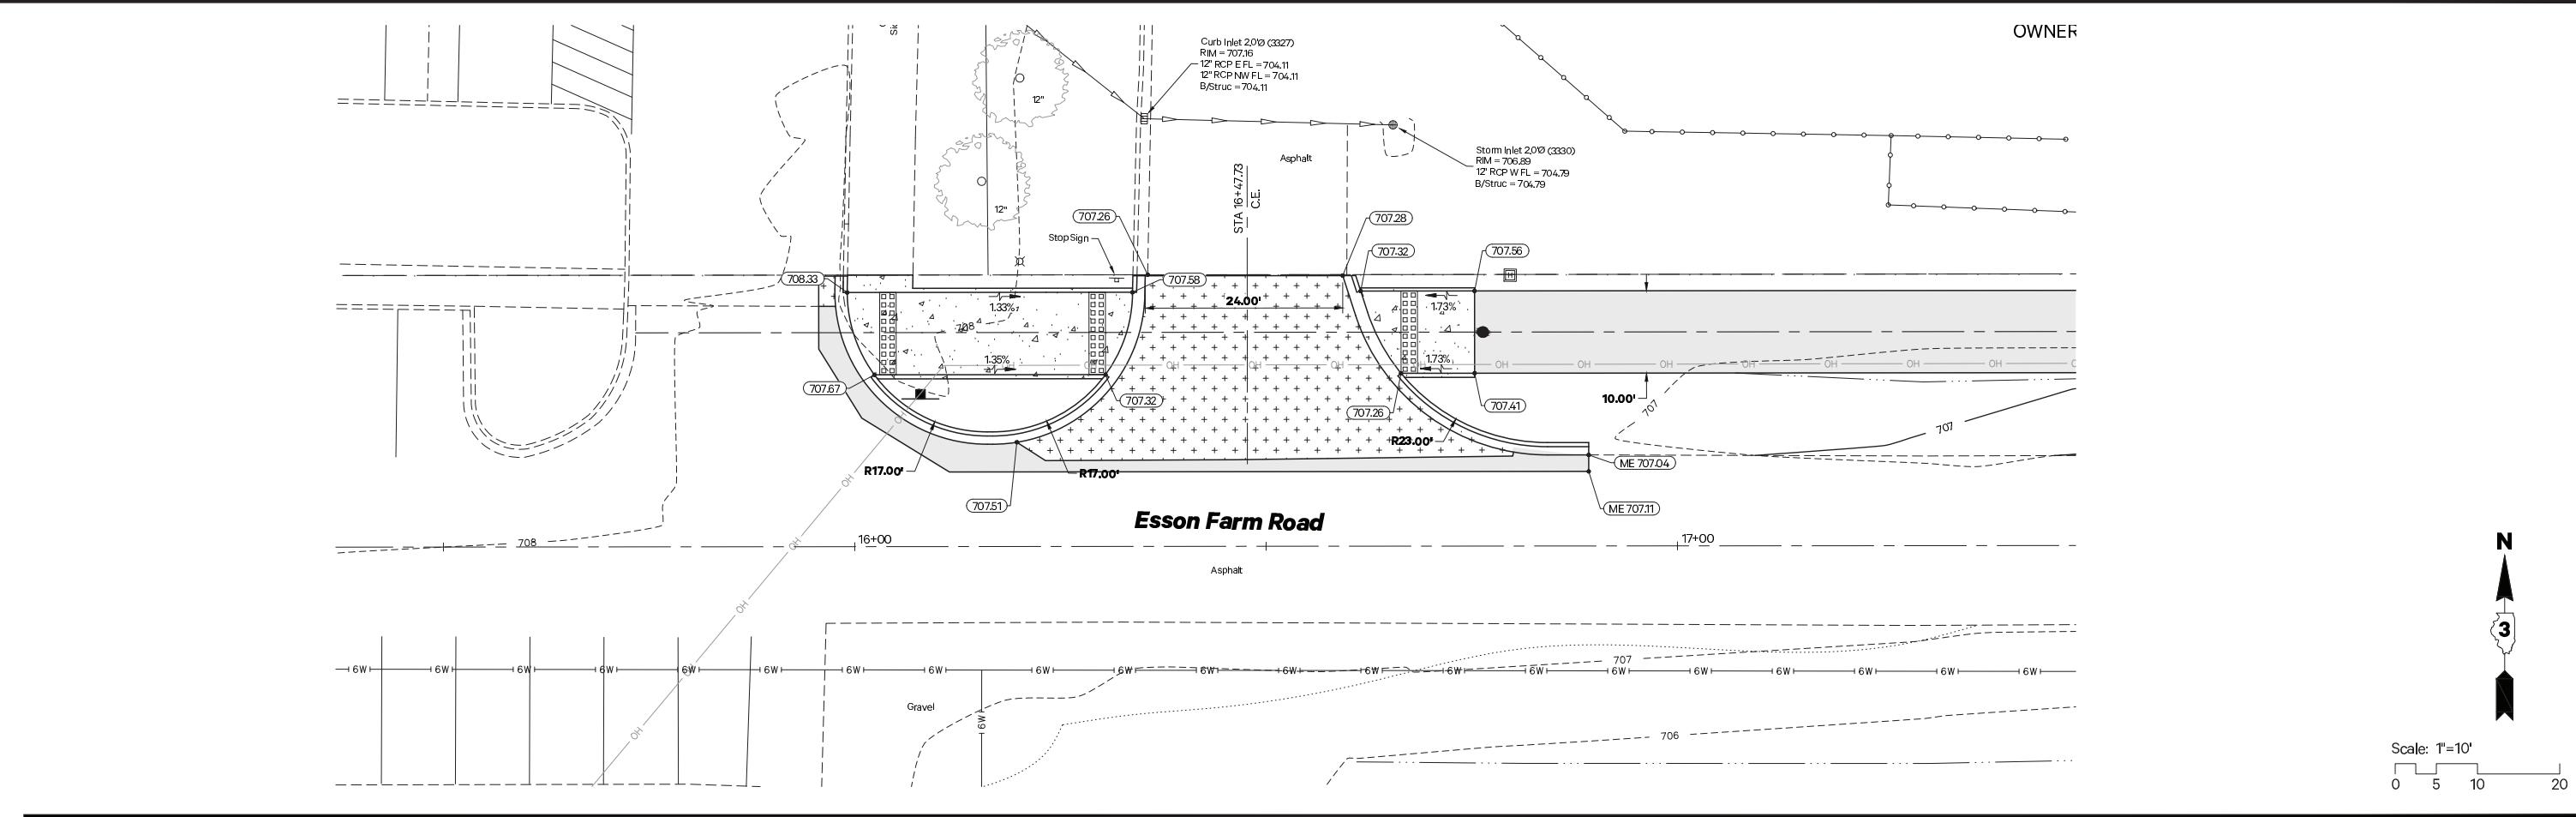
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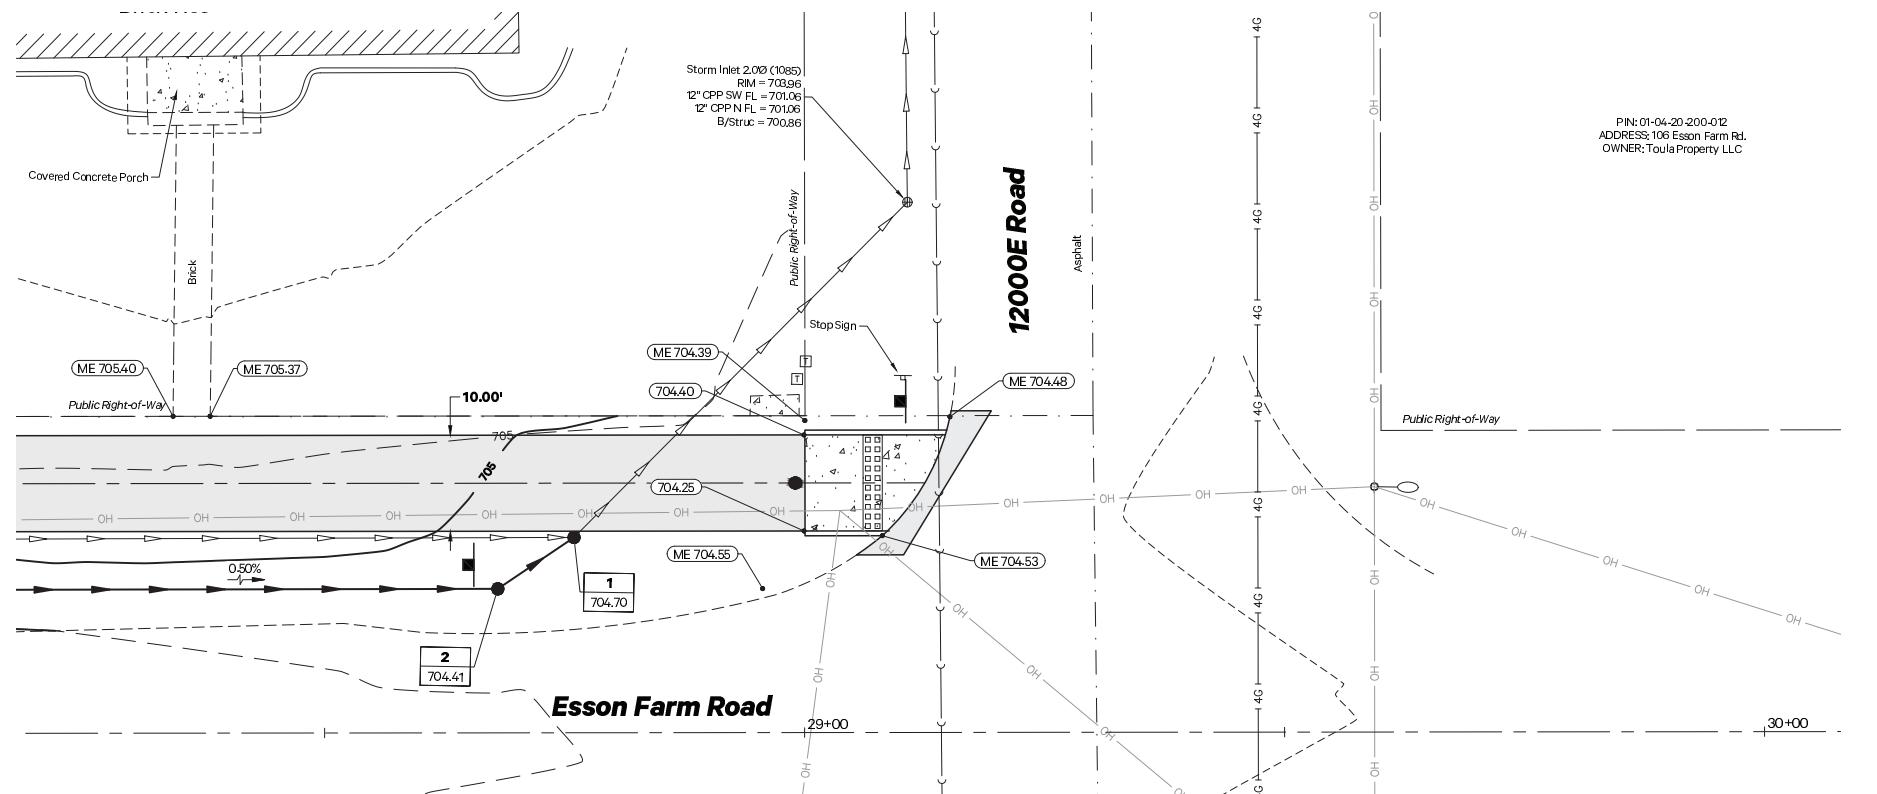
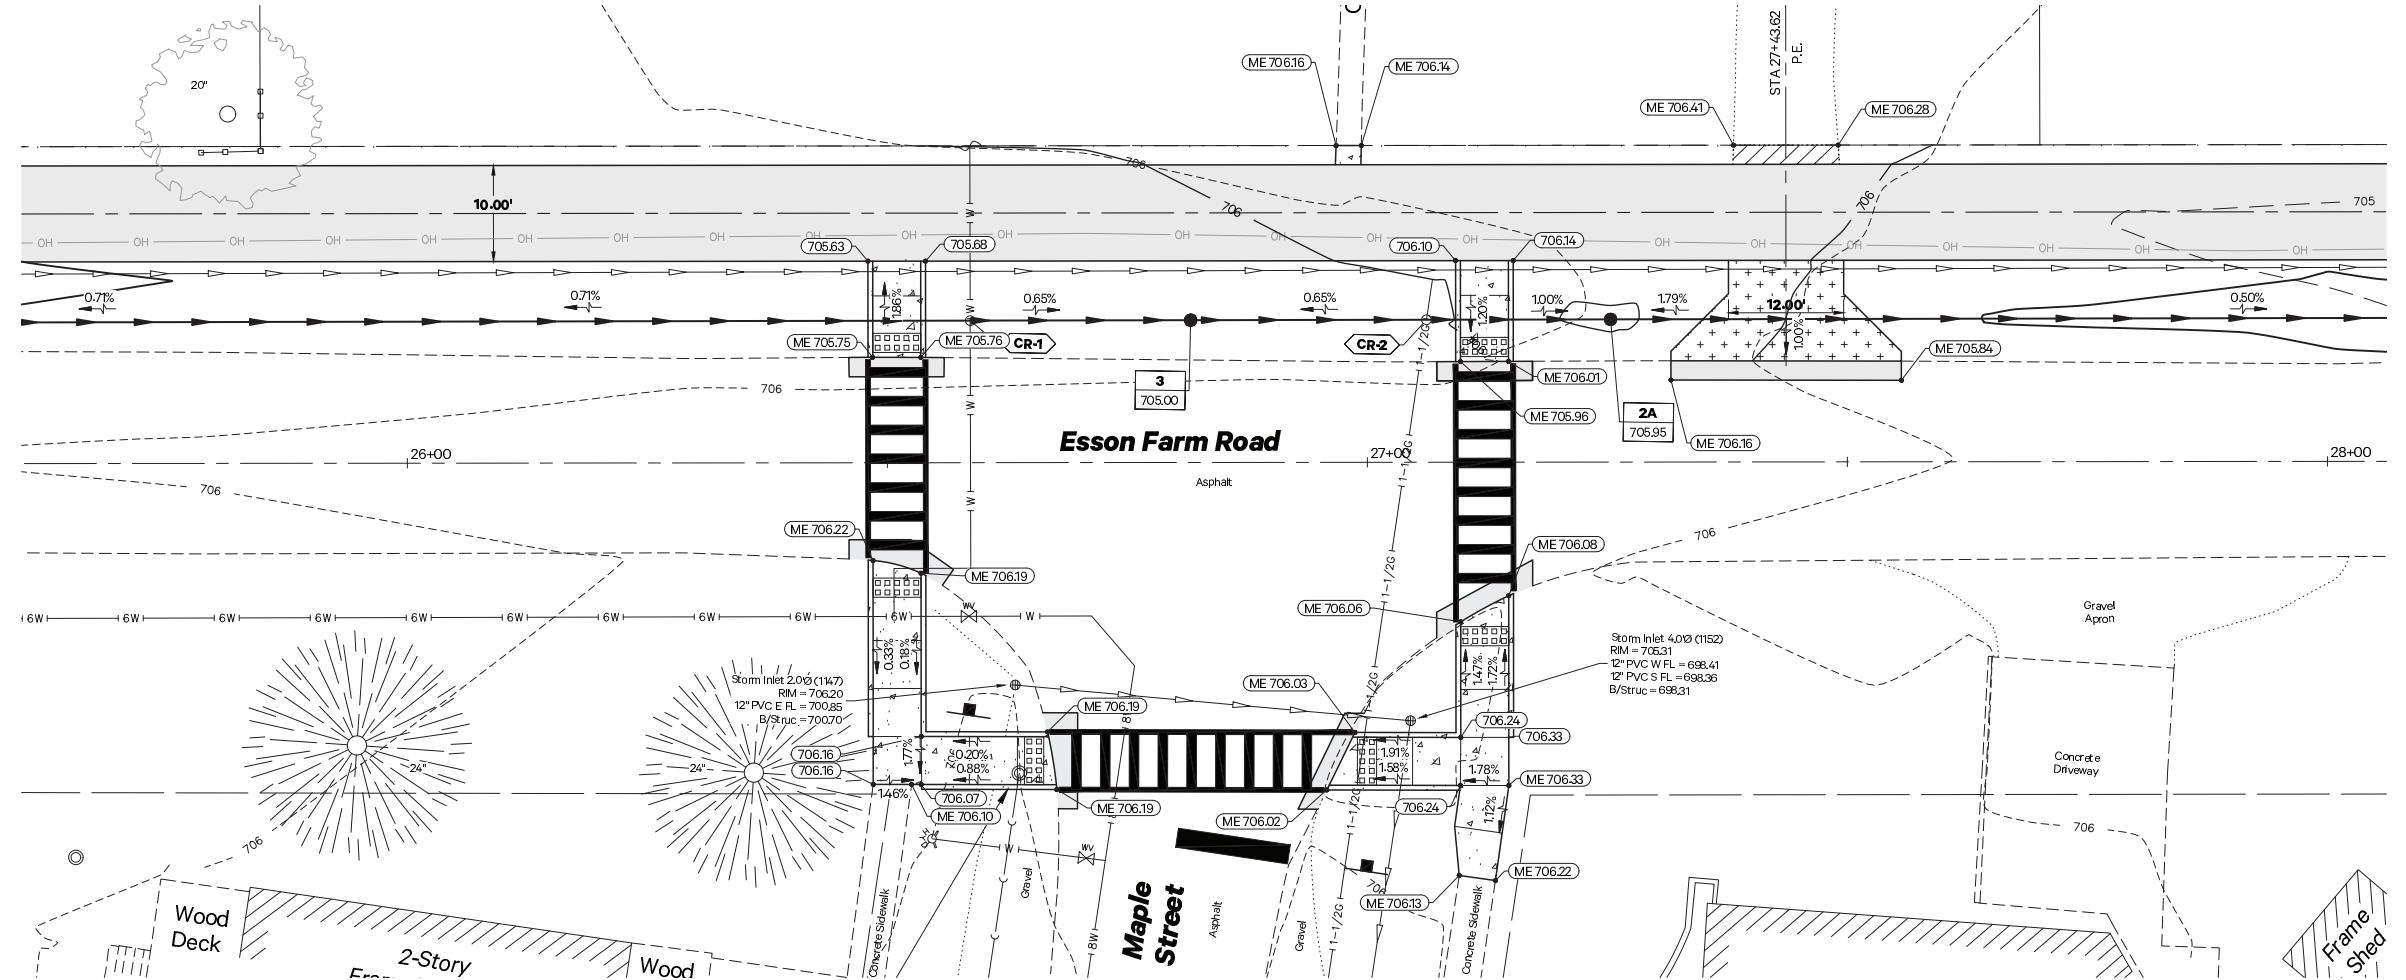
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REVISED : _____

VILLAGE OF GRANT PARK MULTI-USE PATH

MULTI-USE PATH
INTERSECTION GRADING DETAIL

E.	SECTION	COUNTY	TOTAL SHEETS	SHEET NO.
	21-00018-00-BT	KANKAKEE	22	13
			CONTRACT NO. 87812	
		ILLINOIS	FED. AID PROJECT	



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USER NAME : drafting2
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DESIGNED : TJL
DRAWN : JGW
CHECKED : NAP
DATE : 6/7/2022

REVISED : per IDOT Review - 12/14
REVISED : _____
REVISED : _____
REVISED : _____

VILLAGE OF GRANT PARK MULTI-USE PATH


MULTI-USE PATH INTERSECTION GRADING DETAIL

SCALE: 1" = 10' SHEET NO. 2 OF 2 SHEETS STA. N/A TO STA. N/A

SECTION	COUNTY	TOTAL SHEETS	HEET NO.
21-00018-00-BT	KANKAKEE	22	14
CONTRACT NO. 87812			
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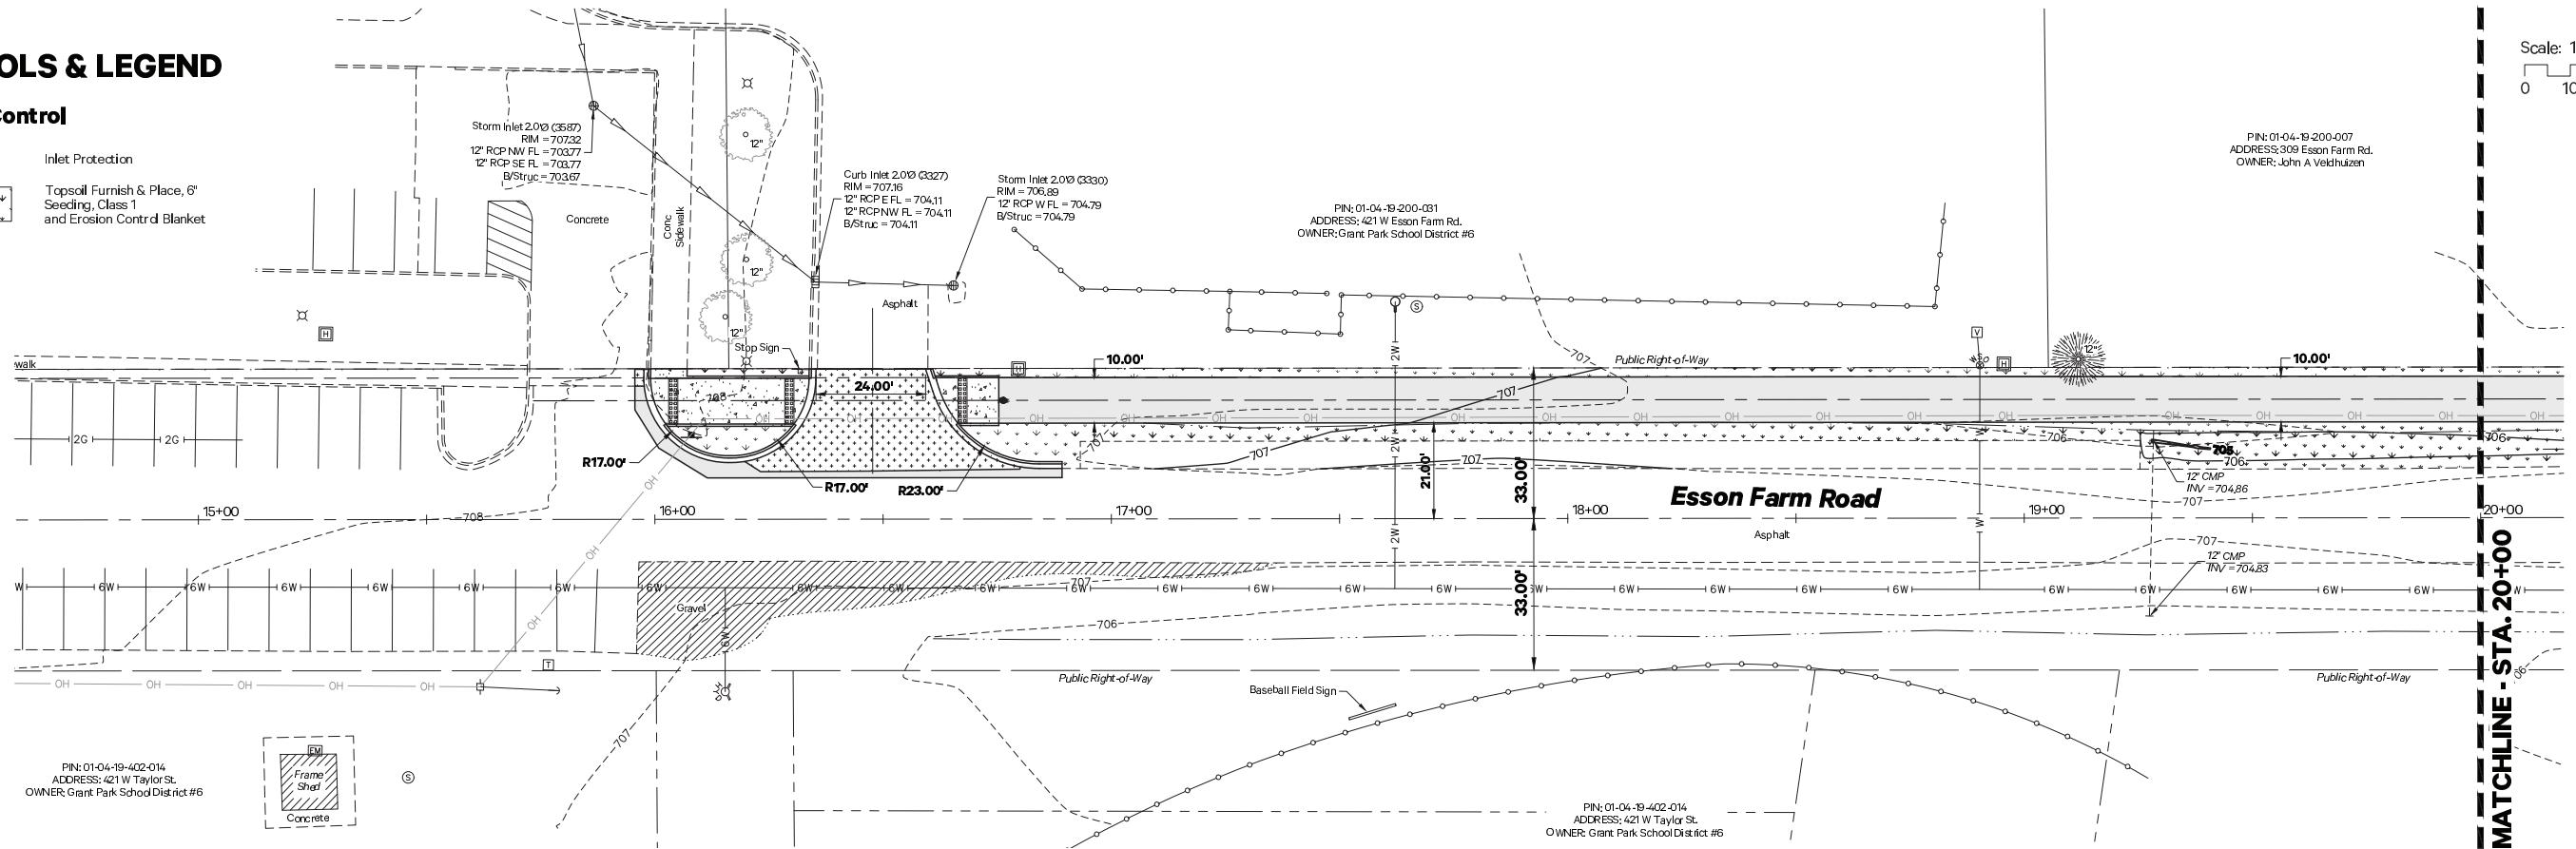
SYMBOLS & LEGEND

Erosion Control

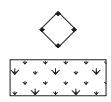

Inlet Protection


Topsoil Furnish & Place, 6"
Seeding, Class 1
and Erosion Contrd Blanket



Scale: 1"=20'

N
3

MATCHLINE - STA. 20+00

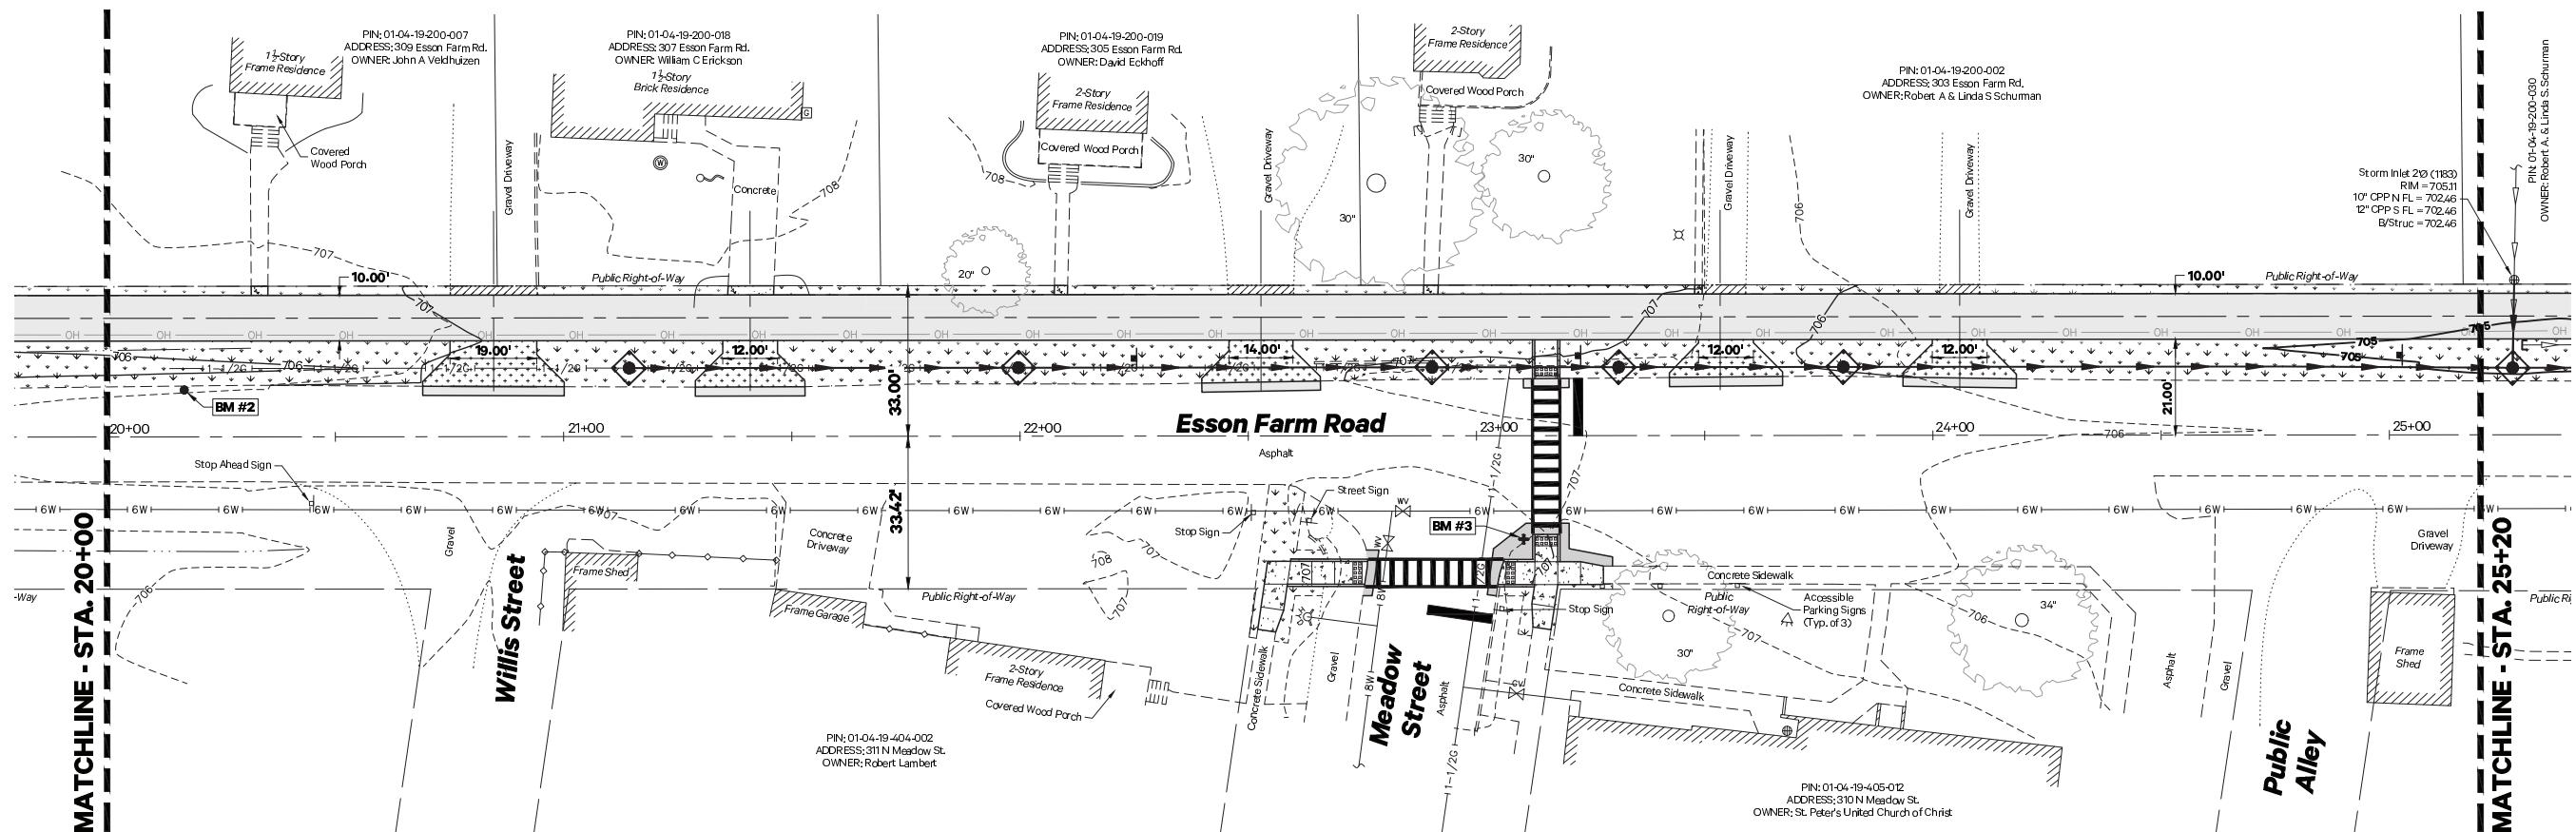

PIN: 01-04-19-200-030
OWNER: Robert A. & Linda S. Schurman

5

Public Ri

MATCHLINE - ST



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USER NAME : drafting2
FILE NAME : _20163,0301 Plan.dwg
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DESIGNED : TJL
DRAWN : JGW
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DATE : 6/7/2009

REVISED : per IDOT Review - 12/14/2022
REVISED : _____
REVISED : _____
REVISED : _____

VILLAGE OF GRANT PARK MULTI-USE PATH


EROSION CONTROL PLAN

SCALE: 1" = 20' SHEET NO. 1 OF 2 SHEETS STA. 15+95.70 TO STA. 25+20.00

FA RTE.	SECTION	COUNTY	TOTAL SHEETS	SHEET NO.
	21-00018-00-BT	KANKAKEE	22	15
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SYMBOLS & LEGEND

Erosion Control

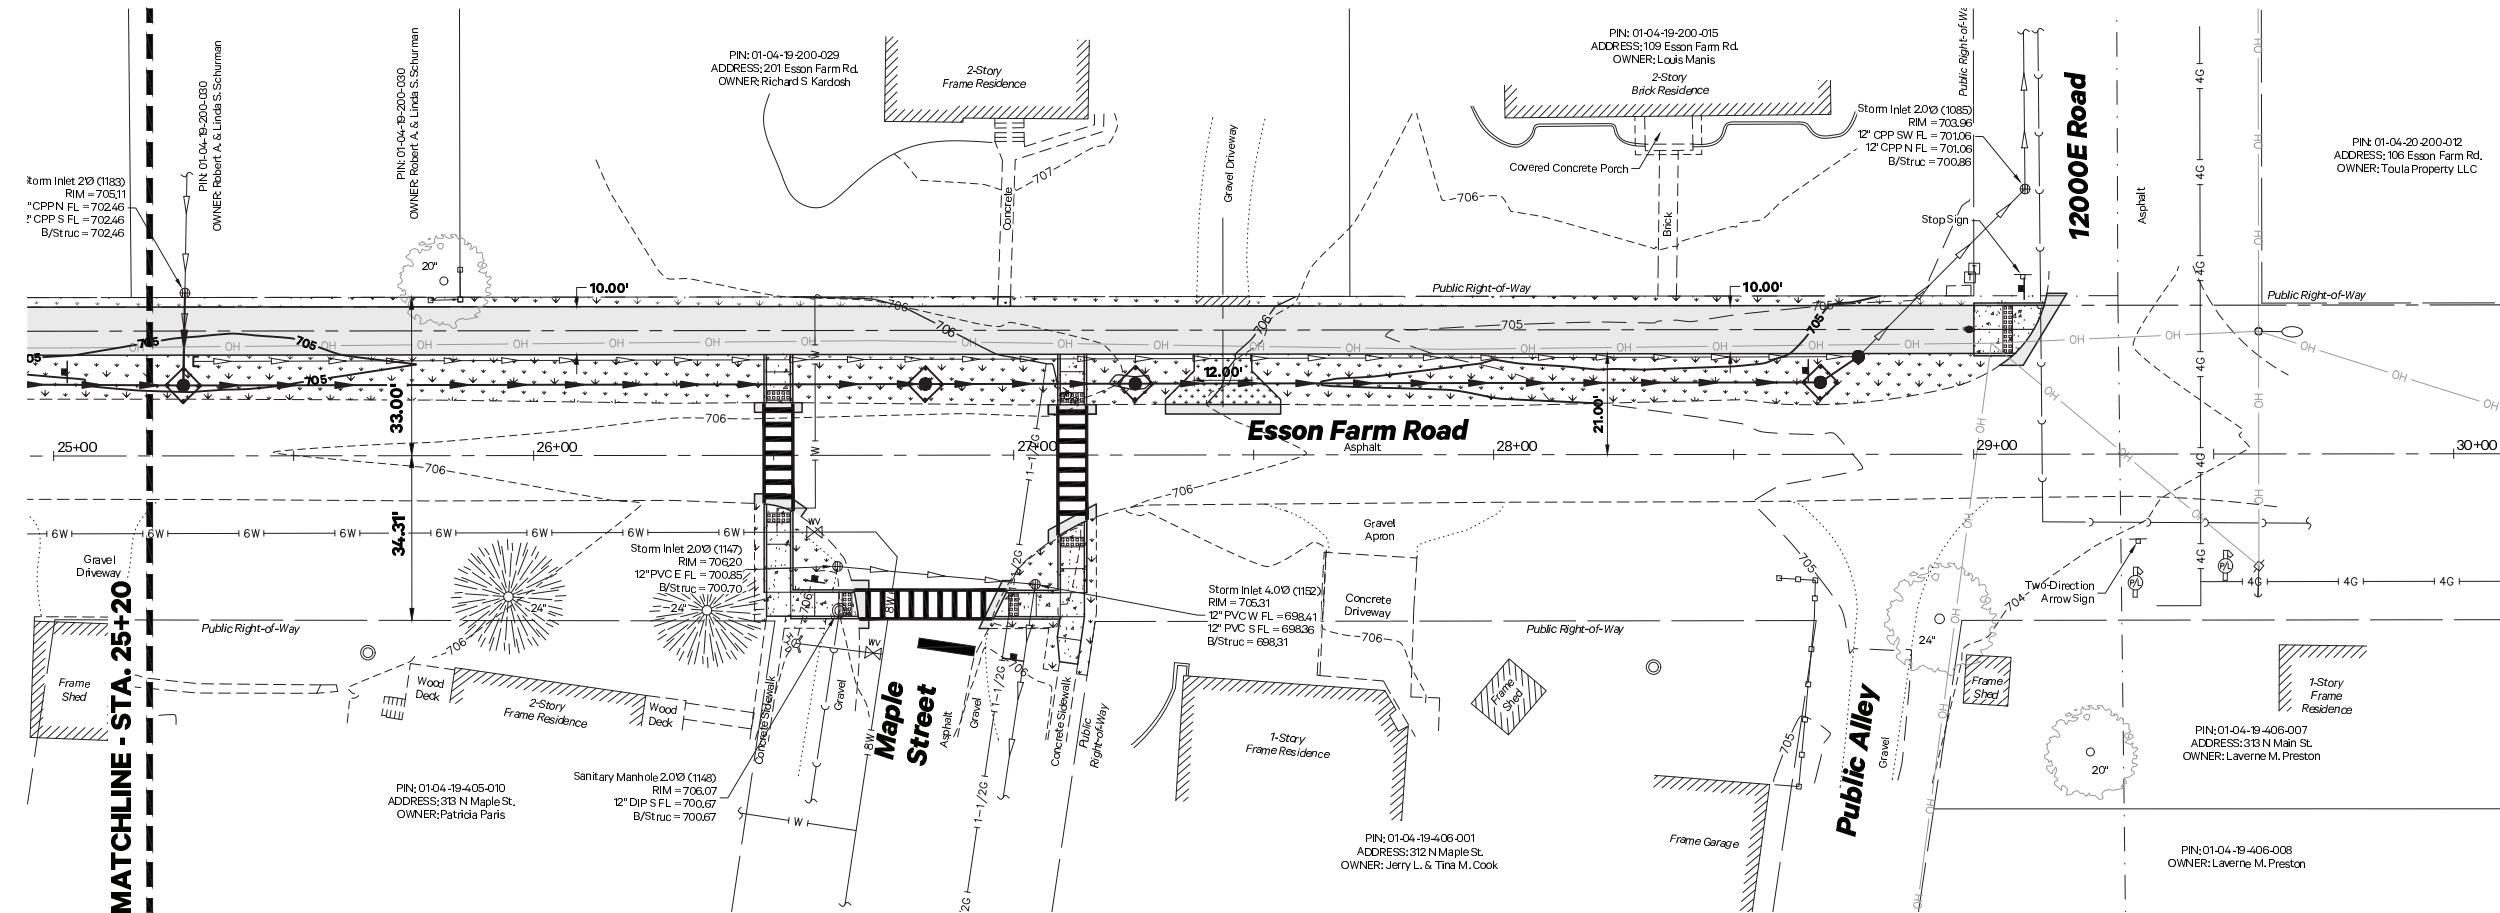

N
3

Scale: 1"=20'
0 10 20 40



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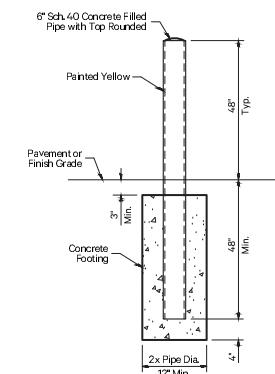
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CHECKED: NAP
PLOT DATE: 6/7/2022

REVISED: per IDOT Review -12/14/2022
REVISED: _____
REVISED: _____
REVISED: _____
REVISED: _____

VILLAGE OF GRANT PARK MULTI-USE PATH


PIPE BOLLARD, QUICK RELEASE

Not to Scale




COMMERCIAL ENTRANCE PAVEMENT DETAIL

Not to Scale

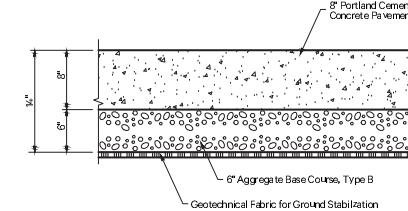


PRIVATE ENTRANCE PAVEMENT DETAIL

Not to Scale

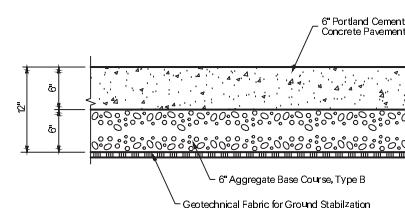

CROSSWALK AND STOP BAR

Not to Scale

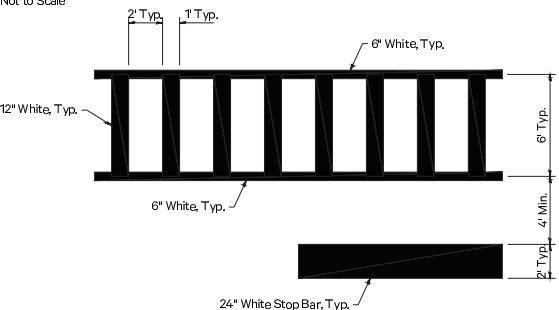


GENERAL NOTES

Spacing of Crosswalk Lines Selected to Avoid Wheel Path
DETL-SIGN_Crosswalk & Stop Bar

HMA PAVEMENT REPLACEMENT ADJACENT TO CURB & GUTTER DETAIL

Not to Scale

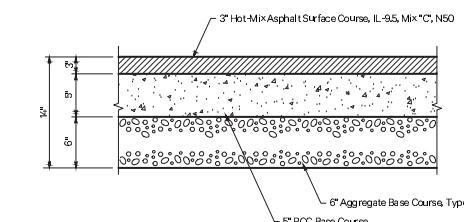


GENERAL NOTES

See Plan for % Slope of Pavement
DETL-PMT_Driveway Curb Section-Bituminous

HMA PAVEMENT REPLACEMENT DETAIL

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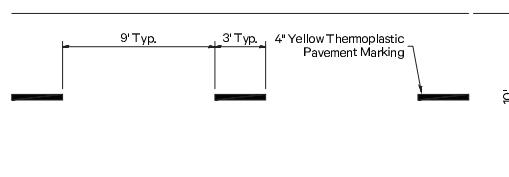


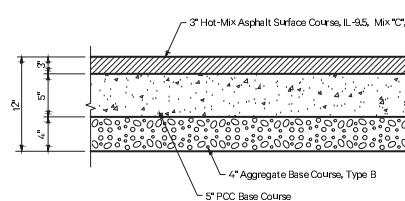GENERAL NOTES

See Plan for % Slope of Pavement
DETL-PMT_Driveway Curb Section-Bituminous

PATH STRIPING DETAIL

Not to Scale



DETL-SIGN_Path Striping


SITE DETAILS

SCALE: N/A SHEET NO. 1 OF 1 SHEETS STA. N/A TO STA. N/A

FA. RTE.	SECTION	COUNTY	TOTAL SHEETS	HEET NO.
_____	21-00018-00-BT	KANKAKEE	22	17

CONTRACT NO. 87812

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FILE NAME: _20163.0301 Plan.dwg
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PLOT DATE: 1/4/2023 1:10:15 PM

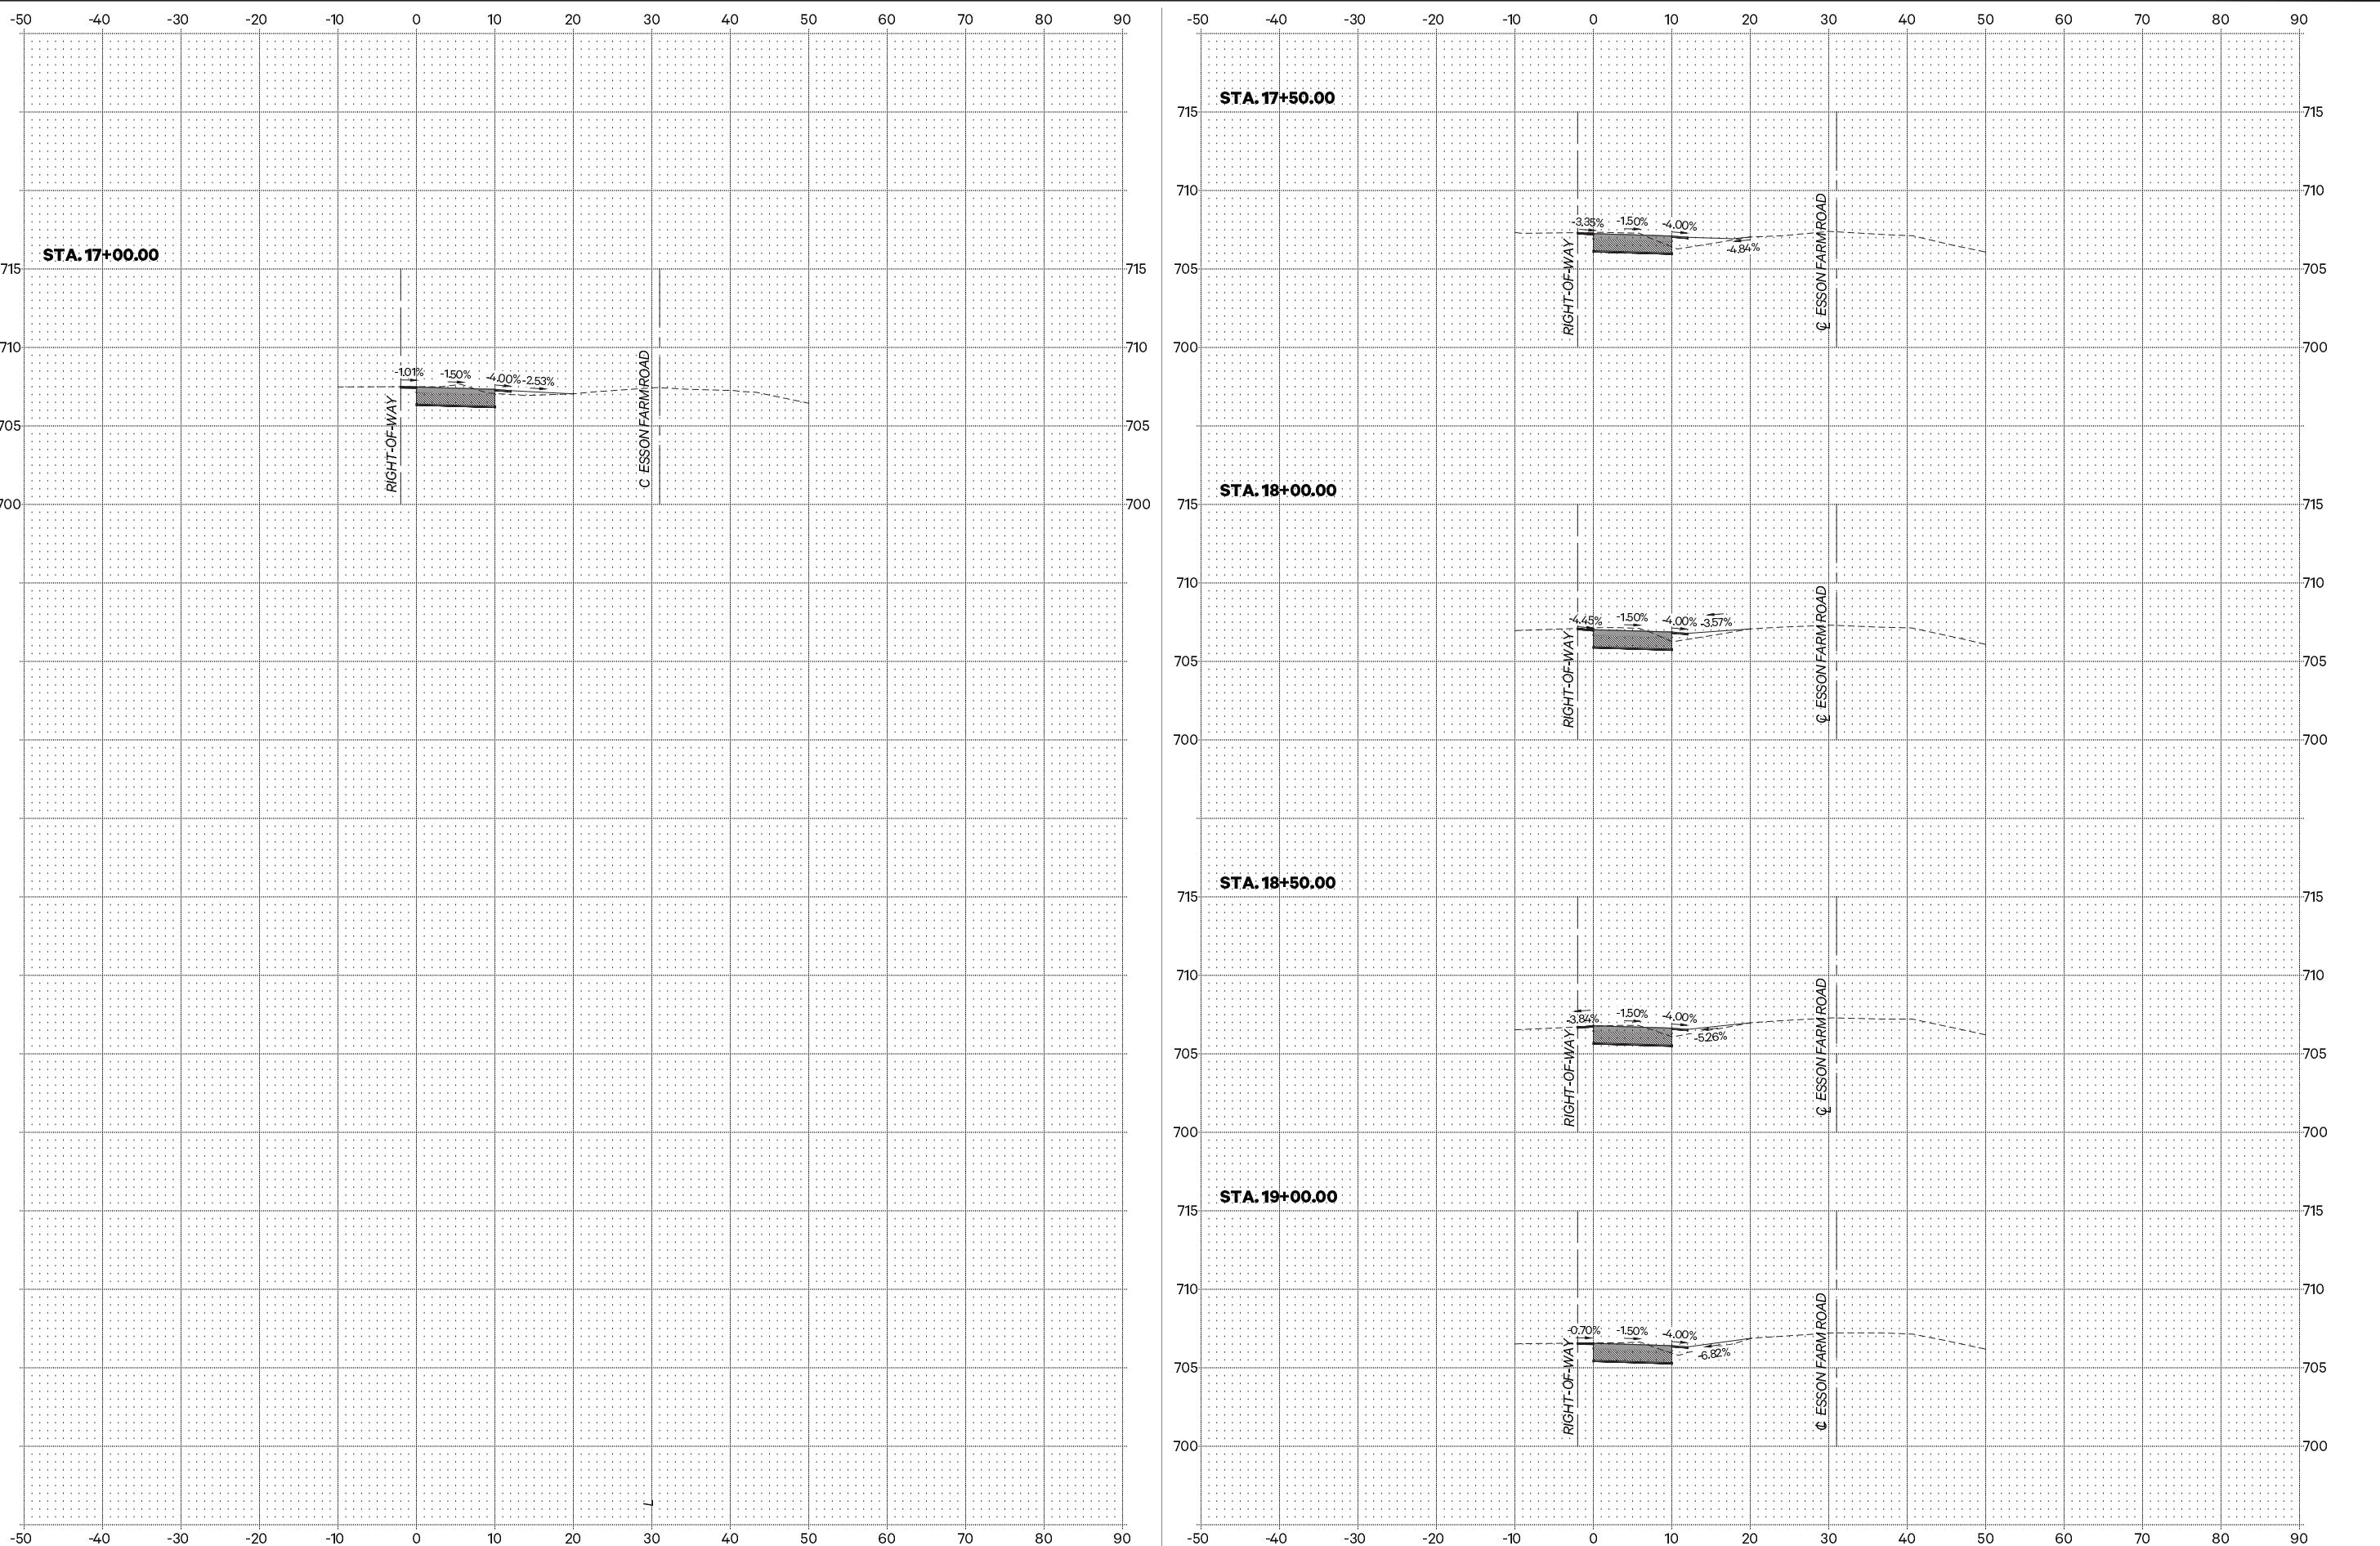DESIGNED: T.J.L.
DRAWN: J.G.W.
CHECKED: N.A.P.
DATE: 6/7/2022

REVISED: per IDOT Review - 12/14/2022
REVISED: _____
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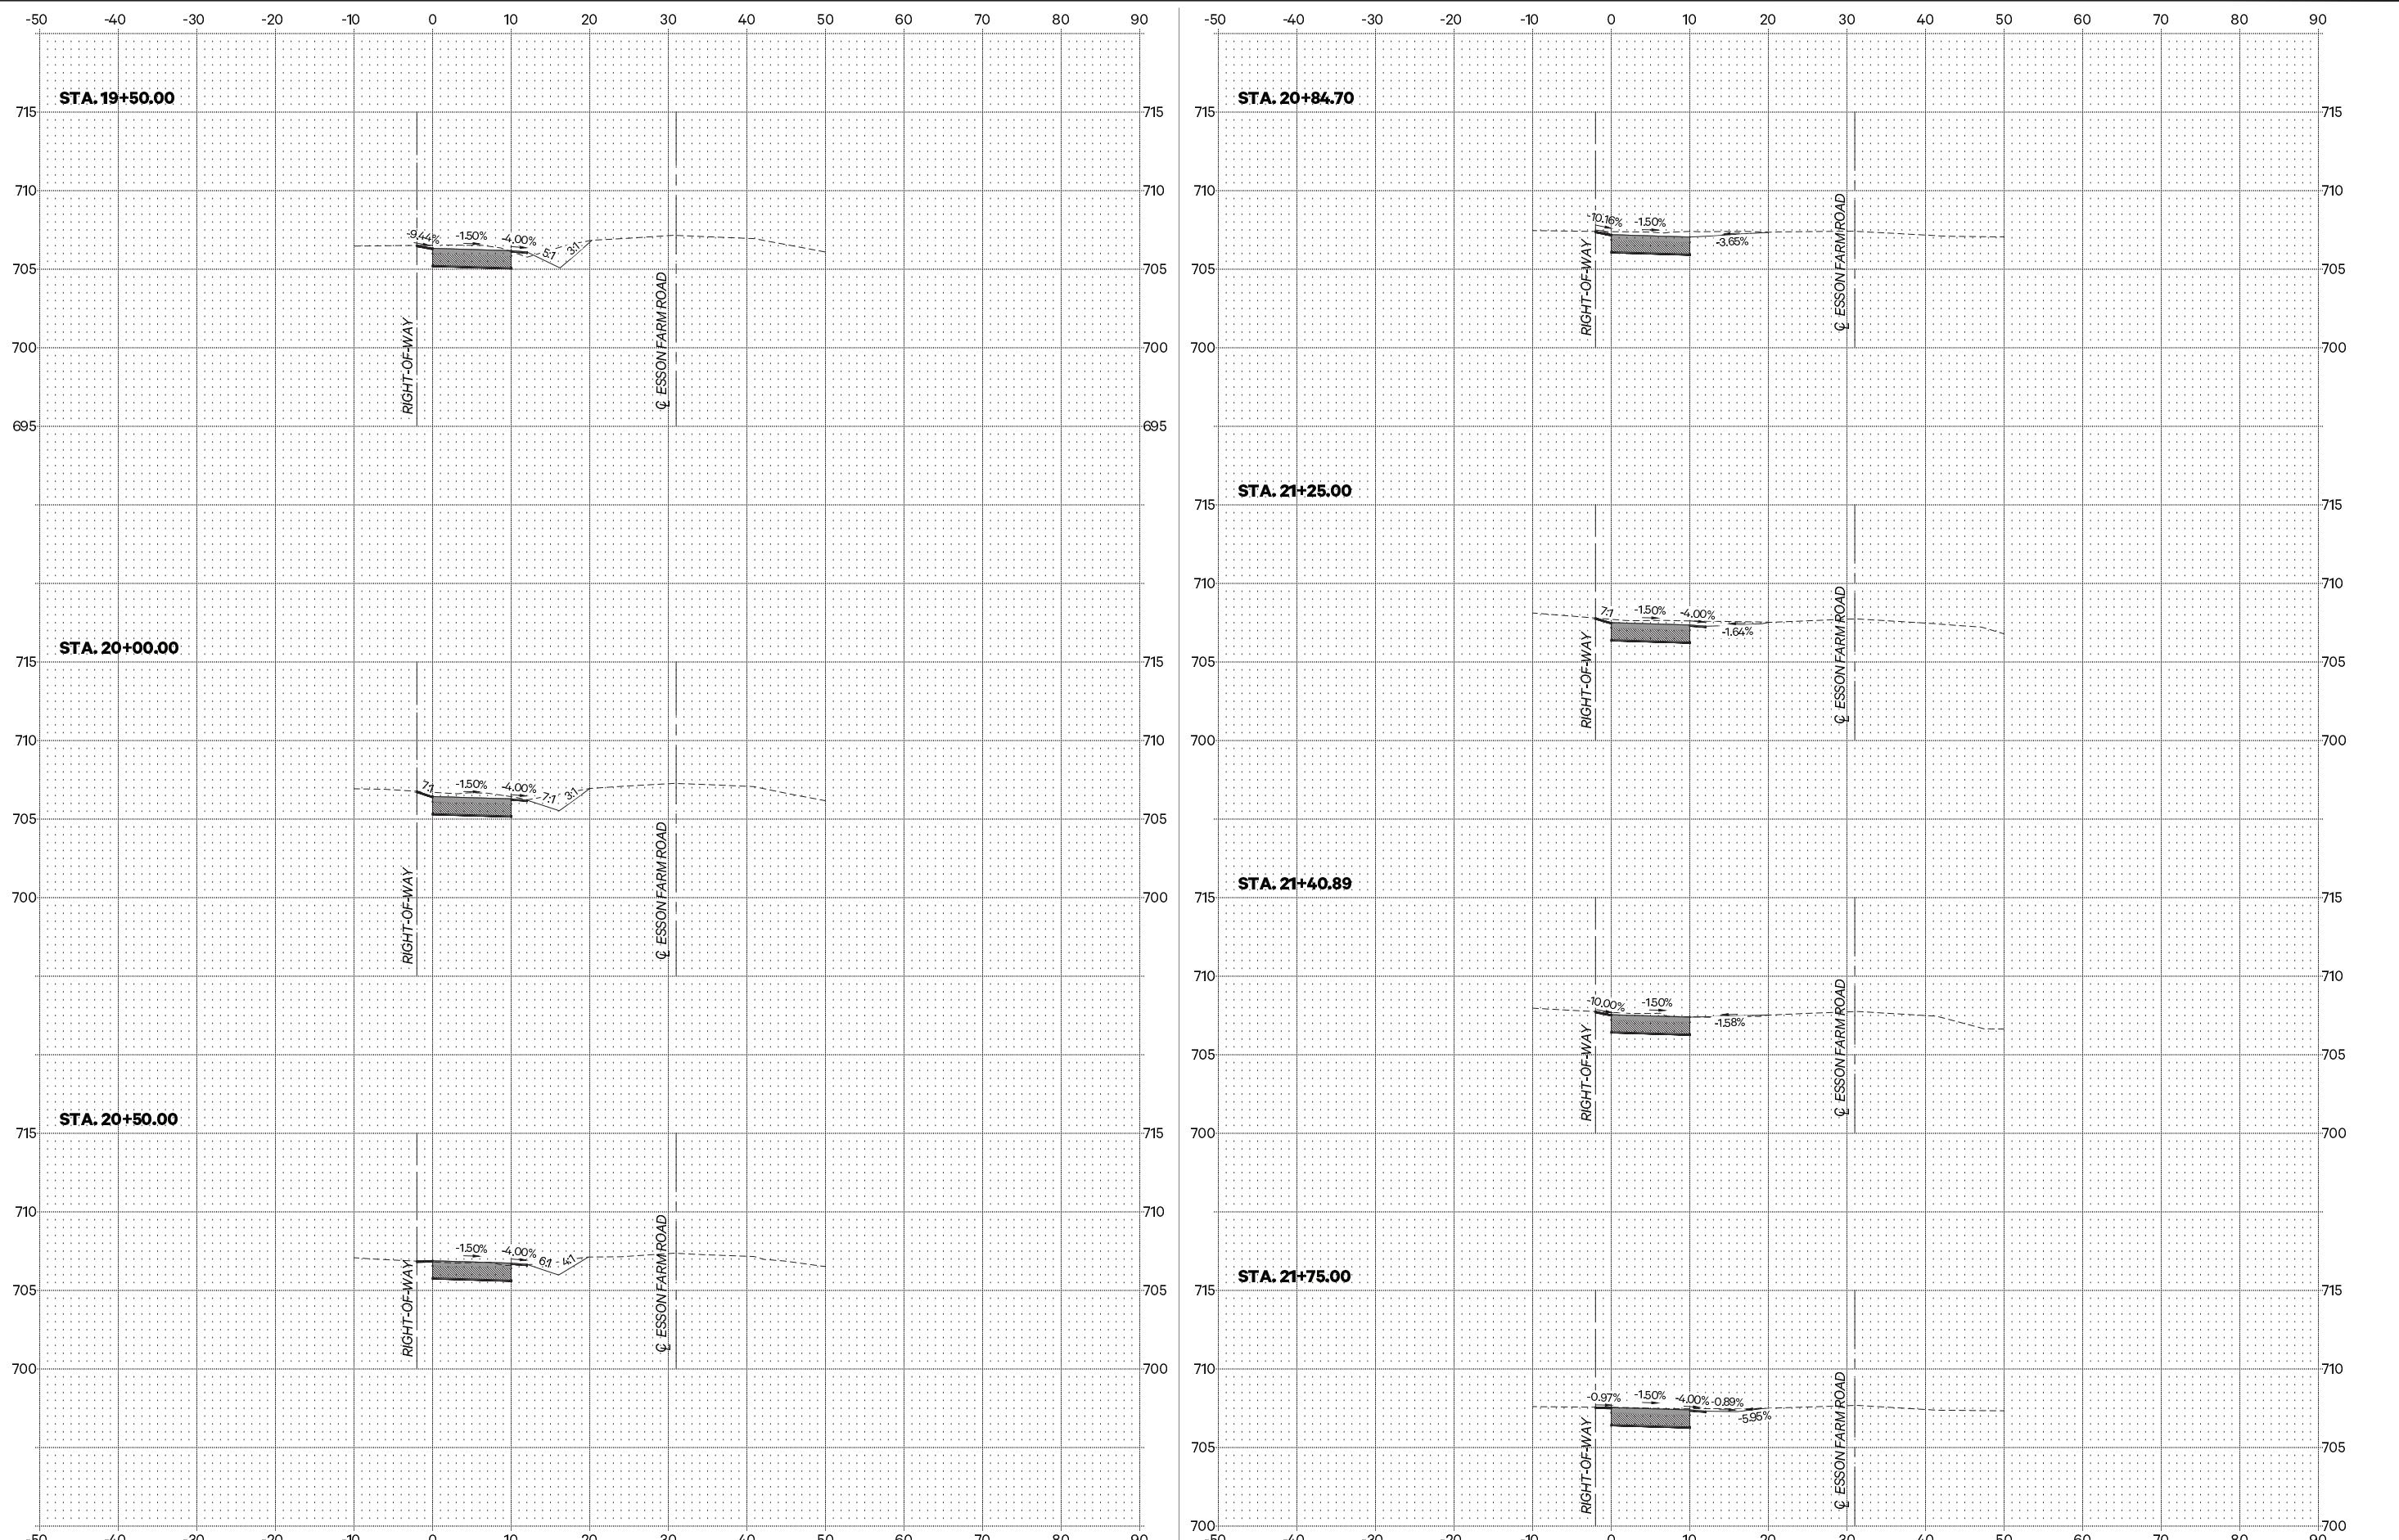
VILLAGE OF GRANT PARK MULTI-USE PATH

CROSS SECTIONS

SCALE: SHEET NO. 1 OF 5 SHEETS STA. 15+50.00 TO STA. 19+00.00

F.A. RTE.	SECTION	COUNTY	TOTAL SHEETS	SHEET NO.
_____	21-00018-00-BT	KANKAKEE	22	18
CONTRACT NO. 87812				

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**VILLAGE OF GRANT PARK
MULTI-USE PATH**


CROSS SECTIONS

SCALE: 1 OF 5 SHEETS STA. 19+50.00 TO STA. 21+75.00

F.A. RTE.	SECTION	COUNTY	TOTAL SHEETS	SHEET NO.
_____	21-00018-00-BT	KANKAKEE	22	19

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USER NAME: drafting2
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DRAWN: J.G.W.
CHECKED: N.A.P.
DATE: 6/7/2022

REVISED: per IDOT Review - 12/14/2022
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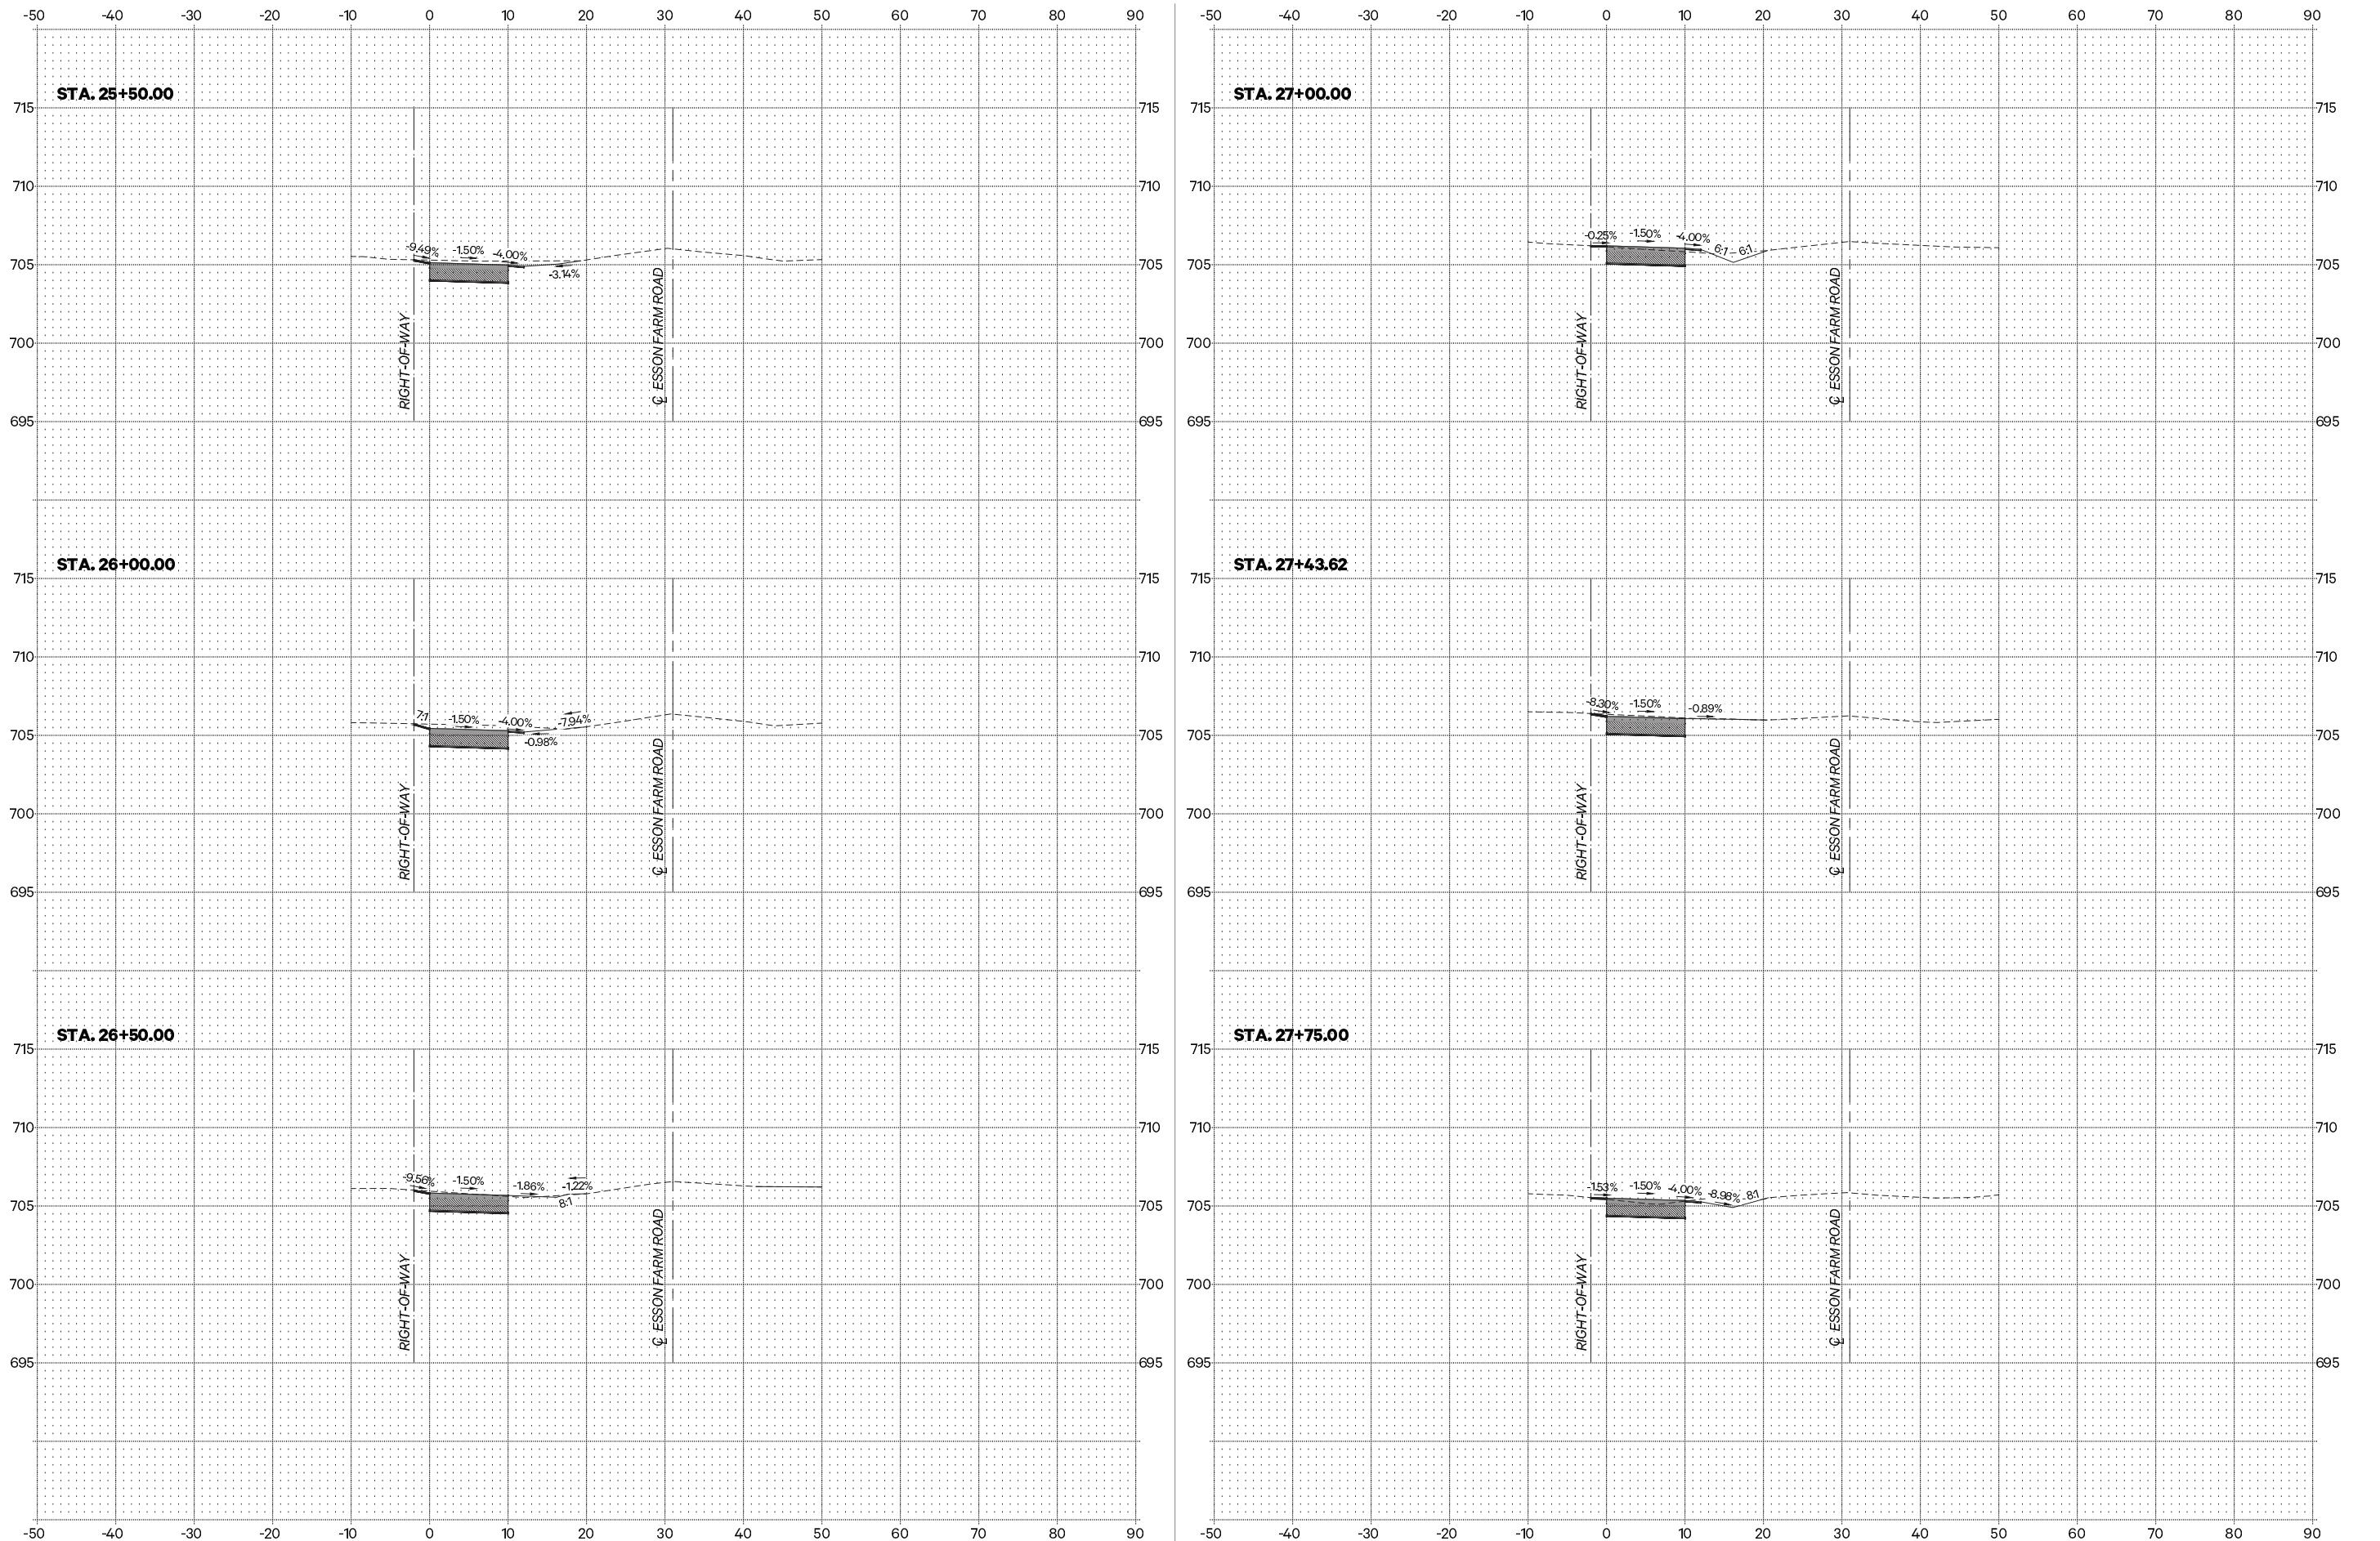
**VILLAGE OF GRANT PARK
MULTI-USE PATH**

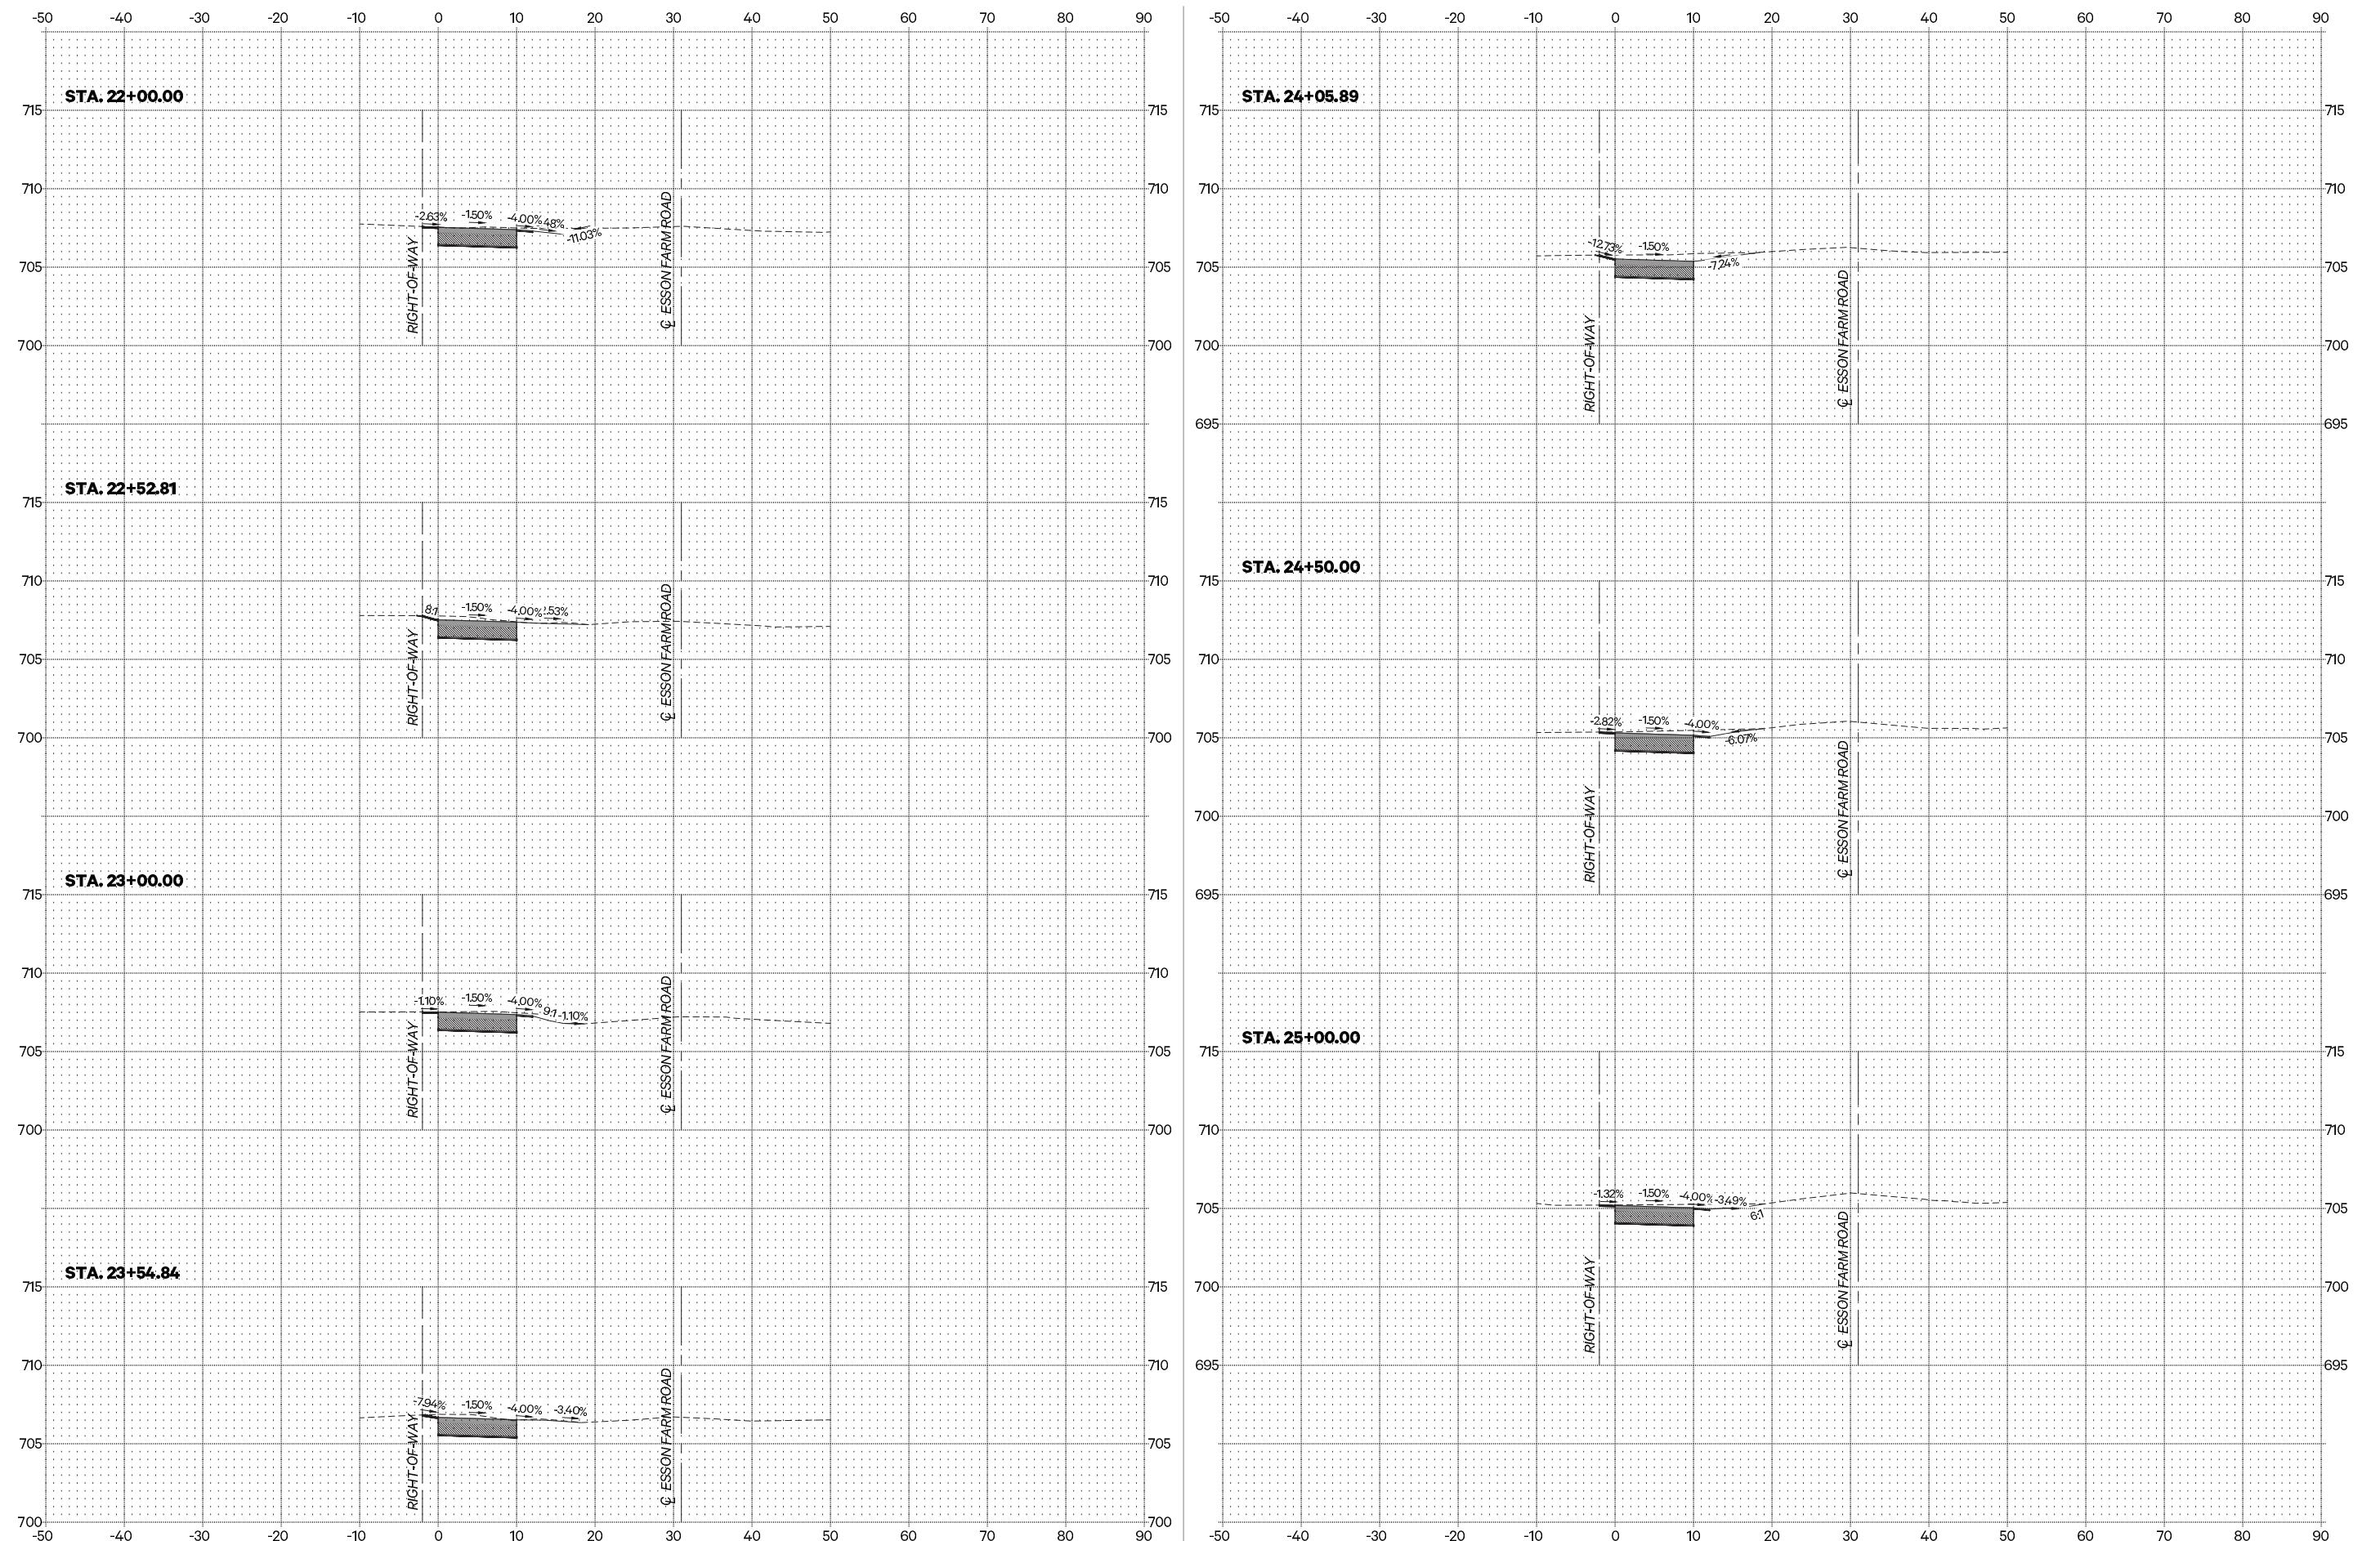CROSS SECTIONS

SCALE: 1"=10' SHEET NO. 3 OF 5 SHEETS STA. 22+00.00 TO STA. 25+00.00

F.A. RTE	SECTION	COUNTY	TOTAL SHEETS	SHEET NO.
_____	21-00018-00-BT	KANKAKEE	22	20
CONTRACT NO. 87812				

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USER NAME: drafting2
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CHECKED: N.A.P.
DATE: 6/7/2022

REVISED: per IDOT Review - 12/14/2022
REVISED: _____
REVISED: _____
REVISED: _____

VILLAGE OF GRANT PARK MULTI-USE PATH

CROSS SECTIONS

SCALE: 4 OF 5 SHEETS STA. 25+50.00 TO STA. 27+75.00

F.A. RTE.	SECTION	COUNTY	TOTAL SHEETS	SHEET NO.
_____	21-00018-00-BT	KANKAKEE	22	21
CONTRACT NO. 87812				

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