FOR INDEX OF SHEETS SEE SHEET NO. 2

STATE OF ILLINOIS **DEPARTMENT OF TRANSPORTATION DIVISION OF HIGHWAYS PLANS FOR PROPOSED FEDERAL AID HIGHWAY FAU 1376 GRAND AVENUE DES PLAINES RIVER TO DAVISSON STREET VILLAGE OF RIVER GROVE SECTION 10-00095-00-SW GRAND AVENUE STREETSCAPE PROJECT TE-00D1(823) COOK COUNTY** C-91-509-10

TRAFFIC DATA

2030 ADT = 27,500POSTED SPEED LIMIT: 30 MPH DESIGN SPEED LIMIT: 30 MPH MINOR ARTERIAL


PROJECT LOCATED IN THE VILLAGE OF RIVER GROVE

SCALE: 1" = 10'

FULL SIZE PLANS HAVE BEEN PREPARED USING STANDARD ENGINEERING SCALES. REDUCED SIZED PLANS WILL NOT CONFORM TO STANDARD SCALES. IN MAKING MEASUREMENTS ON REDUCED PLANS, THE ABOVE SCALES MAY BE USED.

> Call **Before** You Dig ONE-CALL SYSTEM

CONTRACT NO. 63511

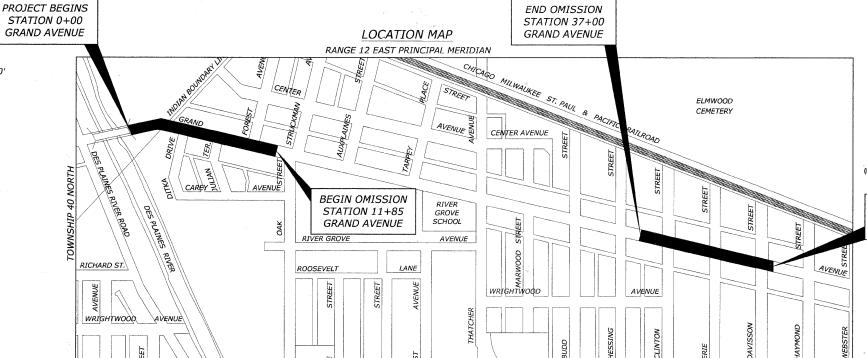

MAP SCALE: NONE **LEYDEN TOWNSHIP**

- AREA OF IMPROVEMENT GROSS LENGTH OF PROJECT = 4,725 FT. = 0.895 MI. NET LENGTH OF PROJECT = 2,210 FT. = 0.419 MI.

ILLINOIS PROJECT TE-00D1(823 SECTION LOCATION OF SECTION

соок

1376

STATE OF ILLINOIS ILLINOIS DEPARTMENT OF TRANSPORTATION **DIVISION OF HIGHWAYS**

INDICATED THUS:

PRINTED BY THE AUTHORITY OF THE STATE OF ILLINOIS

PROJECT ENDS STATION 47+25 GRAND AVENUE



EDWIN HANCOCK ENGINEERING COMPANY 9933 ROOSEVELT ROAD PHONE: (708)865-0300 WESTCHESTER, ILLINOIS 60154

E.H.E. NO. 760-10-00720

BENCHMARKS

GRAND A	AVENUE	
BM-1	BRASS PLATE ON NORTHWEST WINGWALL ON GOAND AVENUE BRIDGE AT DES PLAINES RIVER.	625.26
BM-21	WEST FLANGE BOLT ON FIRE HYDRANT AT NORTHEAST CORNER OF GRAND AVENUE AND INDIAN BOUNDARY ROAD.	626.92
BM-22	NORTHWEST FLANGE BOLT ON FIRE HYDRANT AT NORTHEAST CORNER OF GRAND AVENUE AND JULIAN TERRACE.	629.60
BM-23	NORTHEAST TOP FLANGE BOLT ON FIRE HYDRANT AT SOUTHEAST CORNER OF GRAND AVENUE AND OAK STREET.	631.29
BM-25	NORTH TOP FLANGE BOLT ON FIRE HYDRANT AT NORTHEAST CORNER OF GRAND AVENUE AND PARK AVENUE.	630.74
BM-37	SOUTHEAST TOP FLANGE BOLT ON FIRE HYDRANT AT SOUTHEAST CORNER OF GRAND AVENUE AND MARWOOD STREET.	630.97
BM-38	SOUTHEAST TOP FLANGE BOLT ON FIRE HYDRANT AT SOUTHEAST CORNER OF GRAND AVENUE AND BUDD STREET.	630.41
BM-40	SOUTHEAST TOP FLANGE BOLT ON FIRE HYDRANT AT SOUTHEAST CORNER OF GRAND AVENUE AND CLINTON STREET.	629.93
BM-41	SOUTHEAST TOP FLANGE BOLT ON FIRE HYDRANT AT SOUTHEAST CORNER OF GRAND AVENUE AND ERIE STREET.	630.30
BM-42	SOUTHEAST TOP FLANGE BOLT ON FIRE HYDRANT AT SOUTHEAST CORNER OF GRAND AVENUE AND DAVISSON STREET.	629.81
BM-43	SOUTHEAST TOP FLANGE BOLT ON FIRE HYDRANT AT SOUTHEAST CORNER	

LEGEND OF SYMBOLS

(TO BE USED IN CONJUNCTION WITH I.D.O.T. STANDARD 000001-05)

EXISTING	PROPOSED	DESCRIPTION
		COMBINATION SEWER
		COMBINED RELIEF SEWER
		STORM SEWER
——————————————————————————————————————		WATER MAIN
(()		MANHOLE, TYPE A, 4' DIAMETER
		INLET, TYPE A
Q		CATCH BASIN
Ω.		FIRE HYDRANT
Ω . ⊗ ⊗ ⊗		WATER MAIN VALVE BOX
<u></u>		WATER SERVICE BOX
⊠ RM		STRUCTURE TO BE REMOVED
	Α	EXISTING STRUCTURE TO BE ADJUSTED
	1 <u>C</u>	TYPE 1 FRAME & CLOSED LID
	1P	TYPE 1 FRAME & OPEN LID
	RC	RECONSTRUCT EXISTING STRUCTURE
*		CURB & GUTTER TO BE REMOVED & REPLACED
		PORTLAND CEMENT CONCRETE DRIVEWAY PAVEMENT, 8 INCH REMOVAL & REPLACEMENT
		CLASS C PATCHES, 8 INCH
		PAVING BRICK SIDEWALK
		PORTLAND CEMENT CONCRETE SIDEWALK FIVE INCH, REM & REPLACE
		INCIDENTAL HOT-MIX ASPHALT SURFACING REMOVAL & REPLACEMENT
		HOT-MIX ASPHALT SURFACE COURSE, MIX "D", N70
3"		TREE AND TREE PLANTER REMOVAL
3"		TREE REMOVAL BY OTHERS
	* * * * * *	TOPSOIL FURNISH AND PLACE, 4"
		TREE WITH BOX PLANTER

HIGHWAY STANDARD

SOUTHEAST TOP FLANGE BOLT ON FIRE HYDRANT AT SOUTHEAST CORNER OF GRAND AVENUE AND WEBSTER STREET.

OF GRAND AVENUE AND HAYMOND STREET.

BM-44

STANDARD NO.	TITLE OR DESCRIPTION
000001-06	STANDARD SYMBOLS, ABBREVIATIONS AND PATTERNS
280001-05	TEMPORARY EROSION CONTROL SYSTEMS
424001-05	CURB RAMPS FOR SIDEWALKS
604001-03	FRAMES AND LIDS - TYPE 1
701606-07	URBAN LANE CLOSURE, MULTILANE, 2W WITH MOUNTABLE MEDIAN
701801-04	LANE CLOSURE MULTILANE 1W OR 2W CROSSWALK OR SIDEWALK CLOSURE
701991-01	TRAFFIC CONTROL DEVICES

627.75 620.50	RIM ELEVATION (STORM) INVERT ELEVATION
	RIM ELEVATION (WATER MAIN) TOP OF WATER MAIN

PEDESTRIAN LIGHT

BITUMINOUS	CONCRETE	DRIVEWAY	

RIM ELEVATION (COMBINED SEWER) INVERT ELEVATION

CONCRETE	DRIVEWAY

ı	HANDH	OLE	

TOP OF CURB ELEVATION
EDGE OF PAVEMENT ELEVATION

→ \$- -	SUM

629.83 629.60

RDCB

INL

CATCH BASINS, TYPE A, 4'-DIAMETER, TYPE 1 FRAME, OPEN LID, SPECIAL
INLETS, TYPE A, TYPE 1 FRAME, OPEN

INL	ETS, TYPE A, T	YPE 1 FR	1
LID,	SPECIAL		
LID,	SPECIAL		

G	BREAK	IN	GRADE	
_				

т	POINT	OF	TANGEN

C	POINT	OF	CURVA	TURE

E/P	EDGE OF PAVEMENT

TIO	T05	
T/C	101	OF CUI

HANCOCK ENGINEERIN	G
♦ Civil Engineers	9933 Westchester, III
 Municipal Consultants 	Phot
♦ Established 1911	F.

9933 Rossevelt Road striuster, Effacia 60154-2780	PLOT SCALE -
Phone: 708/865-0306 Fax: 708/865-1212	PLOT DATE -

	USER NAME -	DESIGNED -	MK	REVISED -	1-5-11	IDOT FINAL
		DRAWN -	MK/LEV	REVISED -	6-28-10	DOT PRE-FINAL
1t Road 54-2780	PLOT SCALE -	CHECKED -	СВ	REVISED -	6-04-10	IDOT PSE
65-0300 65-1212	PLOT DATE -	DATE -	03-02-10			MWRDGC

629.15

629.65

	RTE. SECTION 1376 10-00095-00-SW				COUNTY	SHEETS	NO.
s					соок	29	2
	(FIELD BOOK NOS. 1441/1443/1516)			CONTRACT NO. 63511			
	FED. ROAD	DIST. NO. 1	ILLINOIS	FED.	AID PROJECT	TE-00D1	(823)
					E.H.E PROJEC	T NO. 760-	10-00720

MAINTENANCE OF SEWER FLOWS

THE CONTRACTOR SHALL CONDUCT HIS OPERATIONS TO MAINTAIN FLOWS AT ALL TIMES THROUGH EXISTING STORM AND SANITARY SEWER SYSTEMS. HE/ SHE SHALL PROVIDE AND MAINTAIN AN EFFICIENT PUMPING PLANT IF NECESSARY AND A TEMPORARY OUTLET TO DISCHARGE THE WATER COLLECTED IN A SAFE MANNER WITHOUT DAMAGE OF ANY KIND TO ADJACENT PROPERTIES. THE ENDS OF EXISTING DRAINAGE LINES WHICH ARE NOT TO BE INCORPORATED INTO THE PROJECT ARE TO BE SEALED AS SPECIFIED IN THE SPECIAL PROVISIONS. THE COST OF ALL THE PREVIOUSLY MENTIONED WORK SHALL BE INCLUDED IN THE ITEM FOR STORM SEWER CONNECTION, SPECIAL. ALL ACCUMULATION OF DEBRIS AND MATERIAL IN THE STRUCTURE FROM ANY SOURCE, SHALL BE REMOVED BY THE CONTRACTOR AT HIS EXPENSE.

PLUGGING EXISTING SEWERS

UNLESS OTHERWISE SPECIFIED, ABANDONED SEWERS AND DRAINS, AS DESIGNATED BY THE ENGINEER, SHALL BE PLUGGED AT BOTH ENDS WITH A MINIMUM OF TWO (2) FOOT LONG NON-SHRINK/MORTAR PLUG. THIS WORK SHALL NOT BE PAID FOR SEPERATELY, BUT SHALL BE INCLUDED IN THE PAY ITEMS FOR REMOVING AND/OR FILLING THE VARIOUS TYPES OF STRUCTURES.

TEMPORARY TRAFFIC CONTROL

THE RESIDENT ENGINEER SHALL CONTACT THE IDOT TRAFFIC CONTROL SUPERVISOR AT (847) 705-4470 A MINIMUM OF 72 HOURS PRIOR TO THE PLACEMENT OF TEMPORARY TRAFFIC CONTROL DEVICES.

COMMERCIAL PROPERTY ACCESS

THE CONTRACTOR SHALL MAINTAIN ACCESS TO COMMERCIAL PROPERTIES AT ALL TIMES AS DIRECTED BY THE ENGINEER. THIS CAN INVOLVE THE STAGING OF DRIVEWAY REMOVAL AND REPLACEMENT, CURI AND GUTTER REMOVAL AND REPLACEMENT, WITH DECORATIVE BRICK SIDEWALK AND THE USE OF TEMPORARY STONE FOR ACCESS. PAYMENT WILL NOT BE MADE SEPARATELY BUT WILL BE INCLUDED IN THE UNIT PRICE FOR THE RESPECTIVE PAY ITEMS IN THE CONTRACT.

EXISTING STRUCTURE MODIFICATIONS

ALL KNOWN EXISTING STRUCTURES IN THE PAVEMENT OR ADJACENT AREAS WHICH ARE INVOLVED IN THE CONSTRUCTION HAVE BEEN SHOWN ON THE PLANS AND NOTED AS TO BE REMOVED, FILLED, RECONSTRUCTED, OR ADJUSTED BY THE CONTRACTOR EXCEPT THOSE OF AMERITECH, COMED, AND THE NICOR GAS COMPANY, WHICH ARE TO BE ADJUSTED BY THE APPROPRIATE UTILITY OWNER WHERE EXISTING STRUCTURES ARE TO REMOVED OR FILLED, OR THE EXISTING CASTING REPLACED, THE CASTINGS REMOVED FROM THE STRUCTURE BECOME THE PROPERTY OF THE VILLAGE OF RIVER GROVE AND WILL BE PICKED UP BY THE PUBLIC WORKS DEPARTMENT.

SAW CUTTING

THE CONTRACTOR SHALL SAW CUT ASPHALT PAVEMENT AND DRIVEWAY PAVEMENT AS INDICATED ON THE PLANS OR AS DIRECTED BY THE ENGINEER, TO SEPARATE THE EXISTING PAVEMENT TO BE REMOVED BY MEANS OF AN APPROVED CONCRETE SAW TO A DEPTH AS DIRECTED BY THE ENGINEER. SUITABLE GUIDELINES OR DEVICES SHALL BE USED TO ASSURE CUTTING A NEAT, STRAIGHT LINE AS SHOWN ON THE PLANS. CARE SHALL BE TAKEN BY THE CONTRACTOR SO AS NOT TO DAMAGE THE REMAINING PAVEMENT DIRECTLY ADJACENT TO THE PAVEMENT TO BE REMOVED. ANY DAMAGE TO THE EXISTING PAVEMENT RESULTING FROM PAVEMENT REMOVAL OPERATIONS SHALL BE REPAIRED AT THE CONTRACTOR'S EXPENSE. THE PRICE OF SAW CUTTING, AS NOTED ABOVE, SHALL BE INCLUDED IN THE PARTICULAR PAY ITEMS.

CONNECTION OF DISSIMILIAR PIPE MATERIALS

FLEXIBLE CONNECTORS SHALL BE USED WHERE NEW SEWER PIPES ARE TO BE CONNECTED TO EXISTING SEWER PIPES. THE FLEXIBLE CONNECTORS SHALL CONSIST OF A SYNTHETIC RUBBER SLEEVE, WHICH WILL RESIST DETERIORATION CAUSED BY WASTES FOUND IN SEWERS AND TWO STAINLESS STEEL STRAPS. THE CONNECTORS SHALL BE "MISSION" COUPLINGS, "FERNCO" COUPLINGS, OR EQUAL. ALL LABOR AND MATERIAL REQUIRED TO CONNECT NEW SEWER PIPE TO EXISTING SEWER PIPE SHALL BE CONSIDERED INCLUDED IN THE RESPECTIVE SEWER PAY ITEMS.

FORMS FOR CONCRETE SIDEWALKS, DRIVEWAYS, PAVEMENT, AND GUTTER FLAGS

A 2" X 6" BOARD WILL BE USED AS A FORM FOR ALL SIDEWALKS TO BE INSTALLED FIVE INCHES (5") IN THICKNESS.
A 2" X 8" BOARD WILL BE USED AS A FORM FOR ALL DRIVEWAYS TO BE INSTALLED SEVEN INCHES (7") IN THICKNESS.
A 2" X 10" BOARD WILL BE USED AS THE FORM FOR ALL ALLEY RETURN PAVEMENTS TO BE INSTALLED EIGHT INCHES
(8") IN THICKNESS. A 2" X 12" BOARD WILL BE USED AS THE FORM FOR THE FACE OF THE GUTTER FLAGS TO BE
INSTALLED TEN INCHES (10") IN THICKNESS. ALL FORMS MUST BE OF A MINIMUM HEIGHT OF THE PROPOSED THICKNESS
OF THE REPSECTIVE CONCRETE ITEMS TO BE INSTALLED.

PAVEMENT MARKINGS

THE RESIDENT ENGINEER SHALL CALL THE IDOT AREA TRAFFIC FIELD ENGINEER, WALTER CZARNY, AT (773) 685-8386 AT LEAST 2 (TWO) WEEKS PRIOR TO PLACEMENT OF PERMANENT PAVEMENT MARKINGS.

NOTIFICATION OF RESIDENTS

THE CONTRACTOR WILL BE RESPONSIBLE FOR PROVIDING WRITTEN NOTICE TO ALL RESIDENCES AND/OR PLACES OF BUSINESS AT LEAST ONE (1) WORKING DAY PRIOR TO PERFORMING CONSTRUCTION ACTIVITY THAT WILL TEMPORARILY ELIMINATE ACCESS TO THEIR PROPERTY. THE WRITTEN NOTICE SHALL BE APPROVED BY THE ENGINEER PRIOR TO THE BEGINNING OF CONSTRUCTION.

NOTIFICATION OF CONSTRUCTION

THE CONTRACTOR SHALL NOTIFY THE ENGINEER, IN WRITING AT LEAST 48 HOURS PRIOR TO THE COMMENCEMENT OF CONSTRUCTION.

CONCRETE BREAKERS

WHEN REMOVING PAVEMENT, CURB AND GUTTER, SHOULDER, AND/OR ANY OTHER STRUCTURES, THE USE OF ANY TYPE OF CONCRETE BREAKERS SUCH AS DROP HAMMERS, WHICH MIGHT DAMAGE UNDERGROUND PUBLIC OR PRIVATE UTILITIES, WILL NOT BE PERMITTED. UNDER NO CIRCUMSTANCES WILL THE USE OF A FROST BALL BE PERMITTED.

OPEN EXCAVATIONS

LEAVING OPEN EXCAVATIONS NECESSARY FOR PAVEMENT PATCHES OR STRUCTURE ADJUSTMENTS OVERNIGHT WILL NOT BE ALLOWED ON THIS PROJECT. THE CONTRACTOR WILL BE RESPONSIBLE FOR COMPLETELY BACKFILLING OR PLATING OVER ALL EXCAVATIONS AT THE END OF EACH DAY. IF THE EXCAVATIONS ARE BACKFILLED THEY SHALL BE FILLED WITH AN AGGREGATE MEETING THE GRADATION OF CA-6. THE MATERIAL WILL BE COMPACTED SUFFICIENTLY TO PREVENT RUTTING OR SETTLEMENT OF MATERIAL UNDER TRAFFIC LOADS. IF PLATES ARE USED THEY SHALL BE OF SUFFICIENT THICKNESS TO SUPPORT VEHICULAR LOADS. THE PLATES SHALL EXTEND A MINIMUM OF NINE INCHES (9") BEYOND THE LIMITS OF THE EXCAVATION ON ALL SIDES. IF THE PLATES ARE TO BE LEFT OVER THE WEEKEND, THE EDGES OF THE PLATES SHALL BE CUSHIONED WITH A BITUMINOUS MIXTURE IN AREAS WHERE VEHICULAR TRAFFIC WILL CROSS THE PLATES.

PROJECT DATUM

PROJECT DATUM IS NAVD88

STREET SIGNS

IF ANY SIGNS ARE DAMAGED DURING CONSTRUCTION THEY SHALL BE REPLACED.

NON-SPECIAL WASTE

THE CONTRACTOR WILL BE RESPONSIBLE FOR HIRING AN ENVIRONMENTAL FIRM WITH AT LEAST FIVE (5) DOCUMENTED LUST CLEANUPS OR THAT IS PRE-QUALIFIED IN HAZARDOUS WASTE BY THE DEPARTMENT TO REMEDIATE THE SOIL CONTAMINATION AND MONITOR FOR WORKER PROTECTION IN AREAS NOTATED WITH SPECIAL DESIGNATION ON PLAN SHEFTS.

PROTECTION OF NEW CONCRETE

THE CONTRACTOR SHALL HAVE MEMBERS OF THEIR WORK-FORCE AT THE JOB SITE AFTER CONCRETE HAS BEEN POURED UNTIL THE CONCRETE HAS CURED SUFFICIENTLY SO THAT NO GRAFFITI CAN BE INSCRIBED IN THE NEWLY POURED CONCRETE SURFACES. THE EXPOSED FACES OF CONCRETE OF ANY ITEMS THAT ARE DEFACED SHALL BE REPLACED BY THE CONTRACTOR AT HIS OWN EXPENSE.

CONCRETE PROTECTION

AFTER THE CONCRETE HAS BEEN FINISHED AND THE WATER SHEEN HAS DISAPPEARED FROM THE SURFACE OF THE CONCRETE, THE SURFACE SHALL BE SEALED WITH MEMBRANE CURING COMPOUND OF A TYPE APPROVED BY THE ENGINEER. THE SEAL SHALL BE MAINTAINED FOR THE SPECIFIED CURING PERIOD. THE EDGES OF THE CONCRETE SHALL ALSO BE SEALED IMMEDIATELY AFTER THE FORMS ARE REMOVED. IN ADDITION, ALL CONCRETE PLACED AFTER OCTOBER 15TH, SHALL BE PROTECTED IN ACCORDANCE WITH ARTICLE 1020.13 OF THE STANDARD SPECIFICATIONS. THIS WORK SHALL BE CONSIDERED INCLUDED IN THE COST OF THE VARIOUS CONCRETE ITEMS IN THE CONTRACT. PROTECTIVE COAT CHALL BE PAID FOR ACCORDING TO SECTION 420

THE WORK SHALL BE UNDER THE CHARGE AND CARE OF THE CONTRACTOR UNTIL FINAL ACCEPTANCE BY THE ENGINEER. THE CONTRACTOR SHALL ASSUME ALL RESPONSIBILITY FOR ANY INJURY OR DAMAGE TO THE WORK FROM ANY CAUSE WHATSOEVER AND HE SHALL REBUILD. REPAIR OR RESTORE THE DAMAGED WORK AT HIS OWN EXPENSE.

BITUMINOUS EXPANSION JOINT

THREE-QUARTER INCH (3/4") BITUMINOUS PREMOLDED INORGANIC FIBER EXPANSION JOINTS SHALL BE INSTALLED WHERE NEW SIDEWALK OR CURB AND GUTTER OR DRIVEWAY PAVEMENT ABUTS AN EXISTING CONCRETE WALK, DRIVE, OR CURB WHICH IS TO REMAIN IN PLACE, AND AT NOT LESS THAN FIFTY FOOT (50") INTERVALS AT LOCATIONS WHERE SIDEWALK REPLACEMENT IS IN EXCESS OF FIFTY FEET (50"), AND AT LOCATIONS AS DIRECTED BY THE ENGINEER.

EXPANSION JOINTS WILL BE PLACED IN CURB AND GUTTER AT ALL RADIUS POINTS, ALL BEND POINTS, ON BOTH SIDES OF FRAMES AND GRATES THAT ARE IN THE CURB AND GUTTER, AND AT NOT LESS THAN NINETY FOOT (90°) INTERVALS AT LOCATIONS WHERE CURB REPLACEMENT IS IN EXCESS OF NINETY FEET (90°), AND AT LOCATIONS AS DIRECTED BY THE FINGINEER

ALL EXPANSION JOINTS LOCATED IN THE CURB AND GUTTER SHALL HAVE TWO (2) THREE QUARTER INCH (3/4")
DIAMETER, SMOOTH, ROUND, EPOXY COATED DOWEL BARS, EIGHTEEN INCHES (18") IN LENGTH, WITH PLASTIC END
CAPS INSERTED TO ALLOW THE CURB AND GUTTER TO EXPAND AND CONTRACT LATERALLY.

LANCOCK
ENGINEERING

Civil Engineers
**Workbert, Brade 488-279*

Municipal Consultants

**Established 1911*

**Put 94466-279*

**P

STATE OF ILLINOIS
DEPARTMENT OF TRANSPORTATION

GRAND AVENUE STREETSCAPE STAGE II
GENERAL NOTES

TO STA.

SHEET NO. 1 OF 1 SHEETS STA.

SCALE: NONE

SUMMARY OF QUANTITIES

	(CODE	PAY ITEM DESCRIPTION	UNIT	TOTAL QUANTITY	CONSTRUCTION CODE 0031 80% FEDERAL 20% LOCAL
~		xz08 0250	TRENCH BACKFILL, SPECIAL	CU YD	40	40
~	*	21101615	TOPSOIL FURNISH AND PLACE, 4"	SQ YD	1,775	1,775
	*	25000400	NITROGEN FERTILIZER NUTRIENT	POUND	35	35
	*	25000500	PHOSPHORUS FERTILIZER NUTRIENT	POUND	35	35
	*	25000600	POTASSIUM FERTILIZER NUTRIENT	POUND	35	35
	*	25200100	SODDING	SQ YD	1,775	1,775
	*	25200200	SUPPLEMENTAL WATERING	UNIT	20	20
~	*	28000510	INLET FILTERS	EACH	30	30
		35101600	AGGREGATE BASE COURSE, TYPE B 4*	SQ YD	1,335	1,335
~		35300100	PORTLAND CEMENT CONCRETE BASE COURSE 6"	SQ YD	475	475
~		35300300	PORTLAND CEMENT CONCRETE BASE COURSE 8"	SQ YD	325	325
		35501287	HOT-MIX ASPHALT BASE COURSE, 2 1/4"	SQ YD	555	555
		40300100	BITUMINOUS MATERIALS (PRIME COAT)	GALLON	200	200
		40603310	HOT-MIX ASPHALT SURFACE COURSE, MIX "C", N50	TON	67	67
		40603340	HOT-MIX ASPHALT SURFACE COURSE, MIX "D", N70	TON	125	125
~		42001300	PROTECTIVE COAT	SQ YD	4,200	4,200
		42300400	PORTLAND CEMENT CONCRETE DRIVEWAY PAVEMENT, 8 INCH	SQ YD	240	240
		42400200	PORTLAND CEMENT CONCRETE SIDEWALK 5 INCH	SQFT	27,750	27,750
~		42400800	DETECTABLE WARNINGS	SQ FT	296	296
		44000155	HOT-MIX ASPHALT SURFACE REMOVAL, 1 1/2"	SQ YD	1,300	1,300
~		44000200	DRIVEWAY PAVEMENT REMOVAL	SQ YD	795	795
~		44000500	COMBINATION CONCRETE CURB AND GUTTER REMOVAL	FOOT	3,900	3,900
		44201335	CLASS C PATCHES, TYPE IV, 8 INCH	SQ YD	100	100
~	*	56500600	DOMESTIC WATER SERVICE BOXES TO BE ADJUSTED	EACH	50	- 50
~	*	56500800	DOMESTIC WATER SERVICE BOXES	EACH	2	2
~		60265700	VALVE VAULTS TO BE ADJUSTED	EACH	1	1 .
		60266600	VALVE BOXES TO BE ADJUSTED	EACH	2	2
~		60406000	FRAMES AND LIDS, TYPE 1, OPEN LID	EACH	5	5
~		60406100	FRAMES AND LIDS, TYPE 1, CLOSED LID	EACH	- 5	5
~	П	60600605	CONCRETE CURB, TYPE B	FOOT	582	582
	*	66900200	NON-SPECIAL WASTE DISPOSAL	CU YD	121	121
	*	66900450	SPECIAL WASTE PLANS AND REPORTS	L SUM	1	1
	*	66900530	SOIL DISPOSAL ANALYSIS	EACH	1	1
	П	67100100	MOBILIZATION	L SUM	1	1

 DENOTES SPECIAL PROVISION HAS BEEN PRO 	VIDED
--	-------

^{*} DENOTES SPECIALTY ITEM

	CODE	PAY ITEM DESCRIPTION	UNIT	TOTAL QUANTITY	CONSTRUCTION CODE 903 80% FEDERA 20% LOCAL
~	70102625	TRAFFIC CONTROL AND PROTECTION, STANDARD 701606	L SUM	1	1
~	70102640	TRAFFIC CONTROL AND PROTECTION, STANDARD 701801		1	1
*	78000400	THERMOPLASTIC PAVEMENT MARKING - LINE 6"	FOOT	140	140
*	78000650	THERMOPLASTIC PAVEMENT MARKING - LINE 24"	FOOT	20	20
*	81018500	CONDUIT PUSHED, 2" DIA., GALVANIZED STEEL	FOOT	500	500
*	81603080	UNIT DUCT, 600V, 3-1C NO.2, 1/C NO.4 GROUND, (XLP-TYPE USE), 1 1/4" DIA. POLYETHYLENE	FOOT	4,800	4,800
*	81900200	TRENCH AND BACKFILL FOR ELECTRICAL WORK	FOOT	4,330	3,900
*	83600200	LIGHT POLE FOUNDATION, 24" DIAMETER	FOOT	222	222
~ *	550B0320	STORM SEWERS, CLASS B, TYPE 2. 8"	FOOT	30	30
-	550B0330	STORM SEWERS, CLASS B, TYPE 2 10"	FOOT	80	80
*	A2000616	TREE, ACER PLATANOIDES (NORWAY MAPLE), 2" CALIPER, BALLED AND BURLAPPED	EACH	1	1
*	B0237345	TREE, PYRUS CALLERYANA CLEVELAND (CLEVELAND SELECT CALLERY PEAR), 2" CALIPHER, TREE FORM, BALLED AND BURLAPPED	EACH	8	8
*	B2006316	TREE, SYRINGA RETICULATA IVORY SILK (IVORY SILK JAPANESE TREE LILAC), 2" CALIPER, TREE FORM, BALLED AND BURLAPPED	EACH	6	6
~	LR430040	PAVING BRICK SIDEWALK	SQ YD	2,135	2,135
~ *	X0323857	EXISTING LIGHT POLE FOUNDATION ADJUSTMENT	EACH	4	4
~	X0326210	GEOTECHNICAL FABRIC, SPECIAL	SQ YD	2,135	2.135
~ *	X0326441	STONE BEDDING MATERIAL	TON	500	500
*	X2111110	TOP SOIL Placement	CU YD	55	55
~	X4404700	SIDEWALK REMOVAL (SPECIAL)	SQ FT	46,965	46,965
~	X6022805	CATCH BASIN, TYPE A, 4' DIAMETER, TYPE 1 FRAME, OPEN LID, SPECIAL	EACH	4	4
-	X6022900	CATCH BASINS TO BE RECONSTRUCTED (SPECIAL)	EACH	1	1
-	- X6023204	INLETS, TYPE A, TYPE 1 FRAME, OPEN LID, SPECIAL	EACH	7	7
-	X6025300	CATCH BASINS TO BE ADJUSTED (SPECIAL)	EACH	15	15
-	X6025600	MANHOLES TO BE ADJUSTED (SPECIAL)	EACH	5	5
-	X6028000	MANHOLES TO BE RECONSTRUCTED (SPECIAL)	EACH	2	2
-	X6029600	CATCH BASINS, TYPE C, TYPE 1 FRAME, OPEN LID, SPECIAL	EACH	4	4
-	X6064200	COMBINATION CURB AND GUTTER, TYPE B-6.12 (SPECIAL)	FOOT	3,900	3,900
- *	X8140115	HANDHOLE TO BE ADJUSTED	EACH	3	3
-	Z0018700 *	DRAINAGE STRUCTURE TO BE REMOVED	EACH	12	12
*	Z0033028	MAINTENANCE OF LIGHTING SYSTEM	CAL MO	6	6
	Z0076600	TRAINEES (CONSTRUCTION CODE 0042)	HOUR	.5 00	
	XX000541	EXPLORATORY EXCAVATION	CU YD	25	25
-	XX000717	STORM SEWER CONNECTION, SPECIAL	EACH	. 2	2
*	XX006834	ELECTRICAL CONNECTION TO EXISTING LIGHTING SYSTEM	EACH	4	4
7	XX006993	10" X 4" CATCH BASIN TRAP AND RESTRICTOR	EACH	4	4
- *	: XX007151	PLANTER RAILING	FOOT	550	550
- *	XX007152	DECORATIVE LIGHT POLE, ALUMINUM, 12' MOUNTING HEIGHT	EACH	37	37
- *	XX007153	DECORATIVE ACORN STYLE LUMINIARE, SODIUMVAPOR, TENON MOUNT, 70 WATT	EACH	37	37

FIANCOCK

Civil Engiaces


Municipal Consultants

Emphisished III

STATE OF ILLINOIS
DEPARTMENT OF TRANSPORTATION


GRA	ND AVI	EN	IUE	: 6	TREE	ISCAPI	STAGE II	
SUMMARY OF QUANTITIES								
SCALE: NONE	SHEET NO.	1	OF	1	SHEETS	STA.	TO STA.	

F.A.U. SECTION				COUNTY	TOTAL SHEETS	SHEET NO.
1376	10-900	95-00-SW	соок	29	4	
 (FIELD	BOOK NOS. 14	41/1443/1516	CONTRACT NO. 63511			
 FED. ROA	AD DIST. NO. 1	ILLINOIS	FED.	AID PROJECT	TE-00D1	(823)

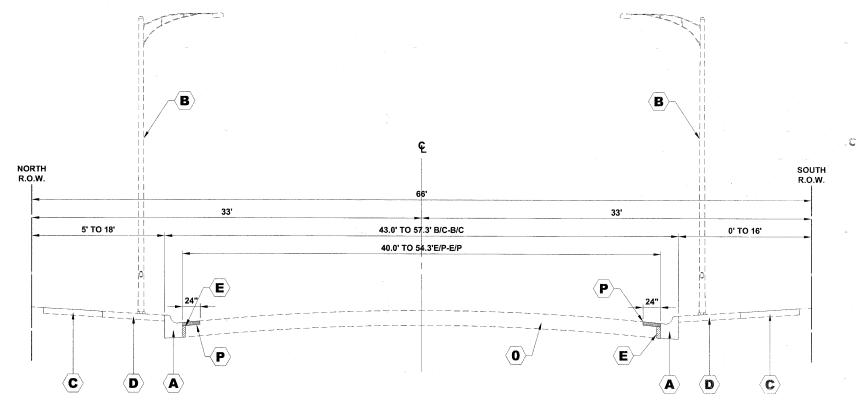

EXISTING TYPICAL CROSS SECTION

GRAND AVENUE
STATION 00+00 TO STATION 4+00

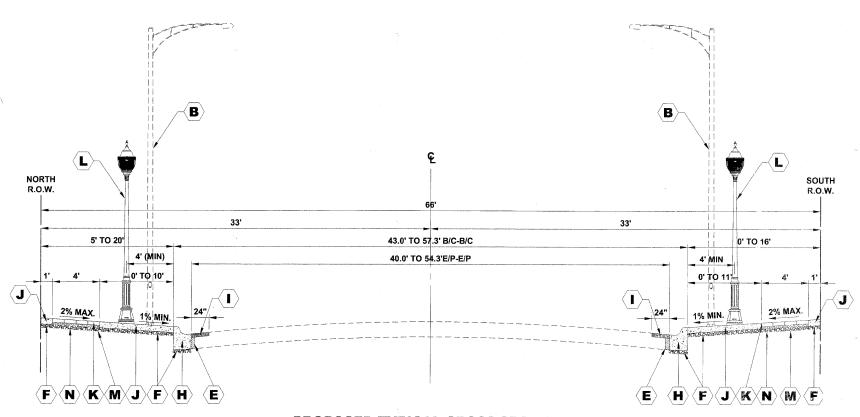

PROPOSED TYPICAL CROSS SECTION

GRAND AVENUE
STATION 00+00 TO STATION 4+00

maken, managaran a sa s							
ANCOCK		USER NAME -	DESIGNED -	MK	REVISED -	1-5-11	IDOT FINAL
ENGINEERING			DRAWN -	MK/LEV	REVISED -	6-28-10	IDOT PRE-FINAL
Ingineers ipal Consultants	9933 Rosservit Read intchester, filinois 60154-2790 Phone: 708/865/860	PLOT SCALE -	CHECKED -	СВ	REVISED -	6-04-10	IDOT PSE
ishad 1911		PLOT DATE .	DATE -	03-02-10	DEVISED	3 10 10	MWDDGC

STATE OF ILLINOIS
DEPARTMENT OF TRANSPORTATION

D / 1 ,	AT APPROXIMATELY 180' SPACING
C	EXISTING PORTLAND CEMENT CONCRETE SIDEWALK REMOVAL TO BE PAID FOR AS SIDEWALK REMOVAL (SPECIAL)
$\langle \mathbf{D} \rangle$	EXISTING SIDEWALK AREA - PORTLAND CEMENT CONCRETE, ASPHALT, OR AS NOTED ON PLANS REMOVAL TO BE PAID FOR AS SIDEWALK REMOVAL OR DRIVEWAY REMOVAL AS NOTED ON PLANS
E	6" CONCRETE WEDGE (INCLUDED IN COMBINATION CONCRETE CURB AND GUTTER, TYPE B-6.12 (SPECIAL))
$\langle \mathbf{F} \rangle$	STONE BEDDING MATERIAL (2")
(G)	AGGREGATE BASE COURSE, TYPE B, 4"
H	COMBINATION CONCRETE CURB AND GUTTER REMOVAL WITH COMBINATION CONCRETE CURB AND GUTTER, TYPE B-6.12 (SPECIAL)
	HOT-MIX ASPHALT SURFACE COURSE, MIX "D", N70, 1 ½"
$\langle \mathbf{J} \rangle$	PORTLAND CEMENT CONCRETE SIDEWALK, 5 INCH
K)	PAVING BRICK SIDEWALK
L	DECORATIVE LIGHT POLE, ALUMINUM, 12' MOUNTING HEIGHT WITH DECORATIVE ACORN STYLE LUMINAIRE, SODIUM VAPOR, TENON MOUNT, 70 WATT
M	GEOTECHNICAL FABRIC (SPECIAL)
(N)	PORTLAND CEMENT CONCRETE BASE COURSE 6"
	EXISTING PAVEMENT (HMA SURFACE COURSE OVER PCC BASE) THICKNESS OF PCC BASE ½/- 8"
$\langle \mathbf{P} \rangle$	HOT-MIX ASPHALT SURFACE REMOVAL, 1 ½"

DESCRIPTION

COMBINATION CONCRETE CURB AND GUTTER REMOVAL

EXISTING ROADWAY LIGHT POLE, 35' MOUNTING HEIGHT WITH 8' OR 12' MAST ARM

HOT-MIX ASPHALT (HMA) MIXTUR	RE REQUIREMENTS
MIXTURE TYPE	AIR VOIDS @ Ndes
PAVEMENT RESURFACING	G
HOT-MIX ASPHALT BASE COURSE, 2 1/4"	4% @ 50 GYR.
HOT-MIX ASPHALT SURFACE COURSE, MIX "D", N70	4% @ 70 GYR.
DRIVEWAYS	
HOT-MIX ASPHALT SURFACE COURSE, MIX "C", N50	4% @ 50 GYR.

THE UNIT WEIGHT USED TO CALCULATE ALL HMA SURFACE MIXTURE QUANTITIES IS 112 LBS/SQ YD/IN.

THE "AC TYPE" FOR POLYMERIZED HMA MIXES SHALL BE "SBS/SBR PG 70-22" AND FOR NON-POLYMERIZED HMA THE "AC TYPE" SHALL BE "PG 64-22" UNLESS MODIFIED BY DISTRICT ONE SPECIAL PROVISIONS. FOR "PERCENT OF RAP" SEE DISTRICT ONE SPECIAL PROVISIONS.


NOTE


SYMBOL

USE PORTLAND CEMENT CONCRETE BASE COURSE 6" UNDER PAVING BRICK SIDEWALK, WHERE BRICK SIDEWALK BUTTS AGAINST CURB AND FOR PORTIONS OF SIDEWALK WITH KEYSTONE AND CROSS-WALKS. EXACT LOCATIONS TO BE DETERMINED BY ENGINEER IN FIELD.

USE PORTLAND CEMENT CONCRETE BASE COURSE, 8" UNDER PAVING BRICK SIDEWALK, WHERE BRICK SIDEWALKS CROSS DRIVEWAY PAVEMENTS. EXACT LOCATIONS TO BE DETERMINED BY ENGINEER IN FIELD.

| Fa.U. | SECTION | COUNTY | TOTAL | SHEETS | RTE. | SHEETS | SHEE

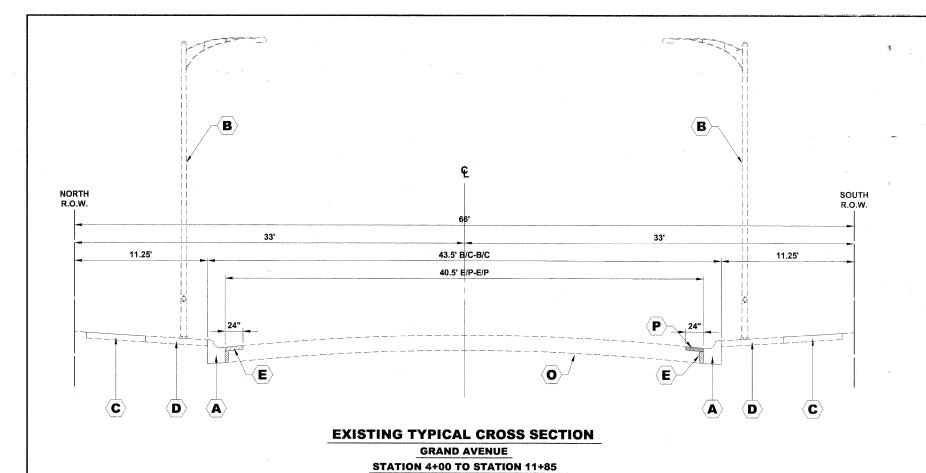

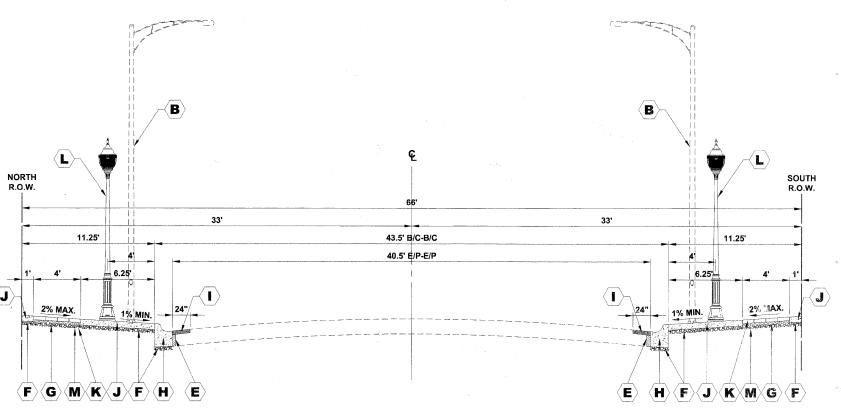

PROPOSED TYPICAL CROSS SECTION

GRAND AVENUE
STATION 4+00 TO STATION 11+85

TTANCOCK	~	USER NAME -	DESIGNED -	MK	REVISED -	1-5-11 IDOT FINAL
ENGINEERIN			DRAWN -	MK/LEV	REVISED -	6-28-10 IDOT PRE-FINAL
 ◆ Civil Engineers ◆ Municipal Consultants 	9933 Roosevelt Road Westchester, Ellmols 60154-2780	PLOT SCALE -	CHECKED -	СВ	REVISED -	6-04-10 IDOT PSE
◆ Established 1911		PLOT DATE -	DATE -	03-02-10	REVISED -	3-19-10 MWRDGC

STATE OF ILLINOIS DEPARTMENT OF TRANSPORTATION

$\langle \mathbf{c} \rangle$	EXISTING PORTLAND CEMENT CONCRETE SIDEWALK REMOVAL TO BE PAID FOR AS SIDEWALK REMOVAL (SPECIAL)
	EXISTING SIDEWALK AREA - PORTLAND CEMENT CONCRETE, ASPHALT, OR AS NOTED ON PLANS REMOVAL TO BE PAID FOR AS SIDEWALK REMOVAL OR DRIVEWAY REMOVAL AS NOTED ON PLANS
	6" CONCRETE WEDGE REMOVAL AND PLACEMENT (INCLUDED IN COMBINATION CONCRETE CURB AND GUTTER, TYPE B-6.12 (SPECIAL))
F	STONE BEDDING MATERIAL (2")
G	AGGREGATE BASE COURSE, TYPE B, 4"
$\langle \mathbf{H} \rangle$	COMBINATION CONCRETE CURB AND GUTTER REMOVAL WITH COMBINATION CONCRETE CURB AND GUTTER TYPE B-6.12 (SPECIAL)
	HOT-MIX ASPHALT SURFACE COURSE, MIX "D", N70
J	PORTLAND CEMENT CONCRETE SIDEWALK, 5 INCH
	PAVING BRICK SIDEWALK
L	DECORATIVE LIGHT POLE, ALUMINUM, 12' MOUNTING HEIGHT WITH DECORATIVE ACORN STYLE LUMINAIRE, SODIUM VAPOR, TENON MOUNT, 70 WATT
M	GEOTECHNICAL FABRIC (SPECIAL)
$\langle \mathbf{N} \rangle$	PORTLAND CEMENT CONCRETE BASE COURSE 6"
$\langle 0 \rangle$	EXISTING PAVEMENT (HMA SURFACE COURSE OVER PCC BASE) THICKNESS OF PCC BASE +/- 10"
$\langle \mathbf{P} \rangle$	HOT-MIX ASPHALT SURFACE REMOVAL, 1 $\frac{1}{2}$ "

EXISTING ROADWAY LIGHT POLE, 35' MOUNTING HEIGHT WITH 8' OR 12' MAST ARM

DESCRIPTION

(AS NOTED ON PLANS)

AT APPROXIMATELY 180' SPACING

COMBINATION CONCRETE CURB AND GUTTER REMOVAL

NOT

SYMBOL


 $\langle \mathbf{B} \rangle$


USE PORTLAND CEMENT CONCRETE BASE COURSE 6" UNDER PAVING BRICK SIDEWALK, WHERE BRICK SIDEWALK BUTTS AGAINST CURB AND FOR PORTIONS OF SIDEWALK WITH KEYSTONE AND CROSS-WALKS. EXACT LOCATIONS TO BE DETERMINED BY ENGINEER IN FIELD.

USE PORTLAND CEMENT CONCRETE BASE COURSE, 8" UNDER PAVING BRICK SIDEWALK, WHERE BRICK SIDEWALKS CROSS DRIVEWAY PAVEMENTS. EXACT LOCATIONS TO BE DETERMINED BY ENGINEER IN FIELD.

	ND AVENUE		
	TYPICAL C	ROSS SECTION	ONS
E	SHEET NO. 2 OF 3	SHEETS STA.	TO STA.

	F.A.U. RTE.	SE	CTION		COUNTY	TOTAL SHEETS	SHEET NO.	
	1376 10-00095-00-SW (FIELD BOOK NOS. 1441/1443/1516)				соок	29	6	
					CONTRACT NO. 63511			
	FED. ROAD	DIST. NO. 1	ILLINOIS	FED.	AID PROJECT	TE-00D1	(823)	

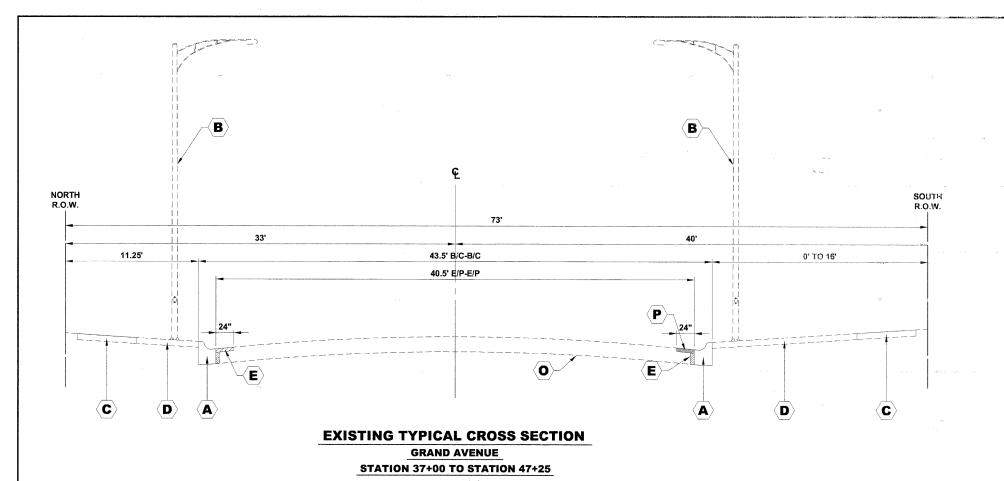

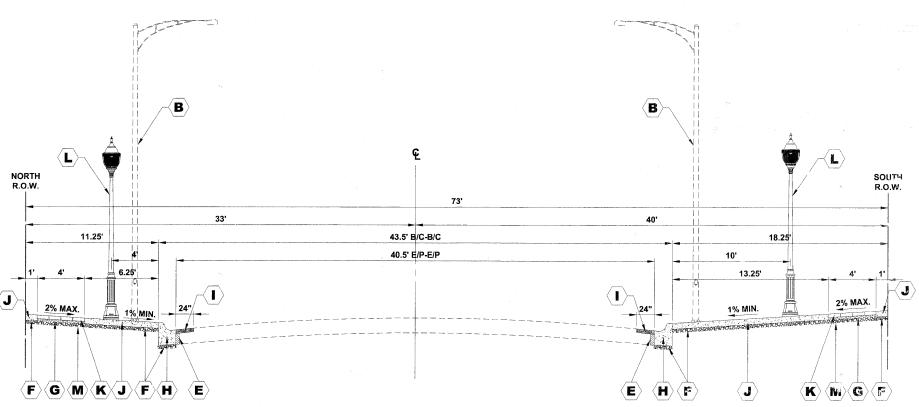

PROPOSED TYPICAL CROSS SECTION

GRAND AVENUE STATION 37+00 TO STATION 47+25

**TTANCOCK	USER NAME -	DESIGNED -	MK	REVISED -	1-5-11 IDOT FINAL
ENGINEERING		DRAWN -	MK/LEV	REVISED -	6-28-10 IDOT PRE-FINAL
♦ Civil Engineers Westbatter, Illand 6015187 Municipal Consultants	PLOT SCALE -	CHECKED -	СВ	REVISED -	6-04-10 IDOT PSE
◆ Established 1911 Page: 708/06/512		DATE -	03-02-10	REVISED -	3-19-10 MWRDGC

STATE OF ILLINOIS **DEPARTMENT OF TRANSPORTATION**

(C) ₂ 2	REMOVAL TO BE PAID FOR AS SIDEWALK REMOVAL (SPECIAL)
	EXISTING SIDEWALK AREA - PORTLAND CEMENT CONCRETE, ASPHALT, OR AS NOTED ON PLANS REMOVAL TO BE PAID FOR AS SIDEWALK REMOVAL OR DRIVEWAY REMOVAL AS NOTED ON PLANS
E	6" CONCRETE WEDGE REMOVAL AND PLACEMENT (INCLUDED IN COMBINATION CONCRETE CURB AND GUTTER, TYPE B-6.12 (SPECIAL))
F	STONE BEDDING MATERIAL (2")
	AGGREGATE BASE COURSE, TYPE B, 4"
H	COMBINATION CONCRETE CURB AND GUTTER REMOVAL WITH COMBINATION CONCRETE CURB AND GUTTER TYPE B-6.12 (SPECIAL)
	HOT-MIX ASPHALT SURFACE COURSE, MIX "D", N70
	PORTLAND CEMENT CONCRETE SIDEWALK, 5 INCH
K	PAVING BRICK SIDEWALK
	DECORATIVE LIGHT POLE, ALUMINUM, 12' MOUNTING HEIGHT WITH DECORATIVE ACORN STYLE LUMINAIRE, SODIUM VAPOR, TENON MOUNT, 70 WATT
	GEOTECHNICAL FABRIC (SPECIAL)
$\langle \mathbf{N} \rangle$	PORTLAND CEMENT CONCRETE BASE COURSE 6"
	EXISTING PAVEMENT (HMA SURFACE COURSE OVER PCC BASE) THICKNESS OF PCC BASE +/- 10"
$\langle \mathbf{P} \rangle$	HOT-MIX ASPHALT SURFACE REMOVAL, 1 ½"

EXISTING ROADWAY LIGHT POLE, 35' MOUNTING HEIGHT WITH 8' OR 12' MAST ARM AT APPROXIMATELY 180' SPACING

DESCRIPTION

(AS NOTED ON PLANS)

COMBINATION CONCRETE CURB AND GUTTER REMOVAL

EXISTING PORTLAND CEMENT CONCRETE SIDEWALK

SYMBOL

 $\langle {f A}
angle$


 $\langle \mathbf{B} \rangle$


USE PORTLAND CEMENT CONCRETE BASE COURSE 6" UNDER PAVING BRICK SIDEWALK, WHERE BRICK SIDEWALK BUTTS AGAINST CURB AND FOR PORTIONS OF SIDEWALK WITH KEYSTONE AND CROSS-WALKS. EXACT LOCATIONS TO BE DETERMINED BY ENGINEER IN FIELD.

USE PORTLAND CEMENT CONCRETE BASE COURSE, 8" UNDER PAVING BRICK SIDEWALK, WHERE BRICK SIDEWALKS CROSS DRIVEWAY PAVEMENTS. EXACT LOCATIONS TO BE DETERMINED BY ENGINEER IN FIELD.

GRAND AVENUE STREETSCAPE STAGE II TYPICAL CROSS SECTIONS 1376 SCALE: NONE SHEET NO. 3 OF 3 SHEETS STA.

SECTION 10-00095-00-SW соок (FIELD BOOK NOS. 1441/1443/1516) CONTRACT NO. 63511

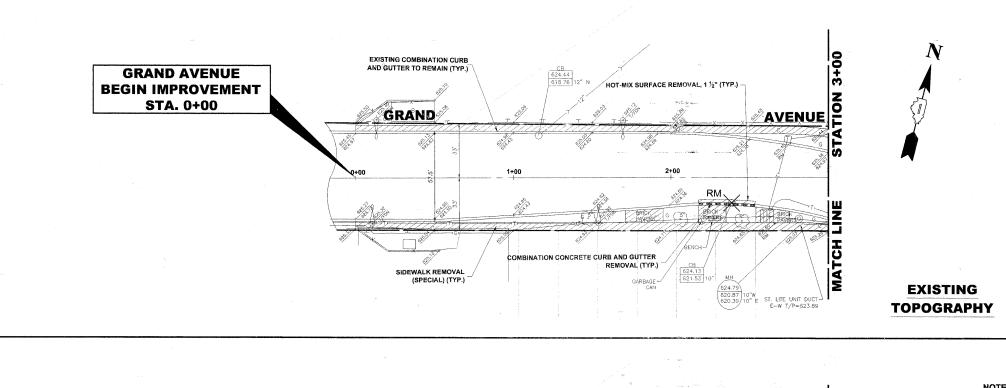

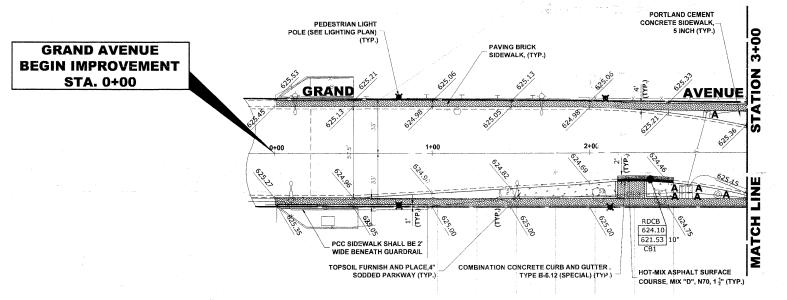

NOTE:

USE PORTLAND CEMENT CONCRETE BASE COURSE, 6" UNDER PAVING BRICK SIDEWALK, WHERE BRICK SIDEWALK BUTTS AGAINST CURB AND FOR PORTIONS OF SIDEWALK WITH KEYSTONE AND CROSS-WALKS. EXACT LOCATIONS TO BE DETERMINED BY ENGINEER IN FIELD.

USE PORTLAND CEMENT CONCRETE BASE COURSE, 8" UNDER PAVING BRICK SIDEWALK, WHERE BRICK SIDEWALKS CROSS DRIVEWAY PAVEMENTS. EXACT LOCATIONS TO BE **DETERMINED BY ENGINEER IN FIELD.**

ALL CONNECTIONS, INCLUDING CORE CONNECTIONS TO EXISTING STRUCTURES SHALL BE WATERTIGHT PER ASTM C-923.

SEE LEGEND ON SHEET 2 FOR SYMBOL DESCRIPTION.

1376

TO STA. 3900

(FIELD BOOK NOS. 1441/1443/1516)

соок

FED. ROAD DIST. NO. 1 | ILLINOIS | FED. AID PROJECT | TE-00D1(823)

E.H.E PROJECT NO. 760-10-00720

CONTRACT NO. 63511

THE WEST LIMITS MUST START ATLEAST TWO FEET (2') EAST FROM THE EXPANSION JOINT AT THE BRIDGE.

ALL PEDESTRIAN LIGHT POLES ARE TO BE LOCATED WITHIN PUBLIC ROW.

PROPOSED IMPROVEMENT

PLAN AND PROFILE

SCALE: 1"= 30' H./2"V. SHEET NO. 1 OF 6 SHEETS STA. 0+00

FNC	INEERING		DRAWN - MK/LEV	REVISED - 6-28-10 IDOT PRE-FINAL	STATE OF ILLINOIS		DI ANI AND		1376 10-00095-00-SW	COOK	20 0
LIAN	COCK	USER NAME -	DESIGNED - MK	REVISED - 1-5-11 IDOT FINAL		4	GRAND AVENUE STRE	FTSCAPE STAGE II	F.A.U. SECTION	COUNTY	TOTAL SHE
				0+00	1+00 +	2+00	+50 +12				
			The state of the s	1 (1) (1) (1) (1) (1) (1) (1) (1) (1) (1	Construction Control and Contr						
7.0			F 7 - 1997 19 - 1986 198 19 - 19 - 19 - 19 - 19 - 19 - 19 -	8 8	2 2 2 2 2 2 2 2 2 2 2 2 2 2 2 2 2 2 2 2	4 2 2 2 4					618
318				β F	89 49 89 80	2 23					640

						#10 1 - 1 - 1 - 1 - 1 - 1 - 1 - 1 - 1 - 1					
		1.16					···				ULU
620	l			A CONTRACTOR OF THE CONTRACTOR				The second secon			620
							10 to	***************************************			
				The same and the same as the same as the same and the sam							
522	NATIONAL CONTRACTOR OF THE SECOND CONTRACTOR O	The state of the s									622
ĺ							S. BACK OF WALK				
624								The second secon			624
204	l										
								W-A-W-W-A			
						1					
J <u>~</u> U					The back of W	161					626
626					N BACK OF W	A117 —					

DEPARTMENT OF TRANSPORTATION

PLOT SCALE -

Phone: 705/8654386

Bax: 708/8654212

PLOT DATE -


CHECKED -


DATE -


CB


REVISED - 6-04-10 IDOT PSE


REVISED - 3-19-10 MWRDGC

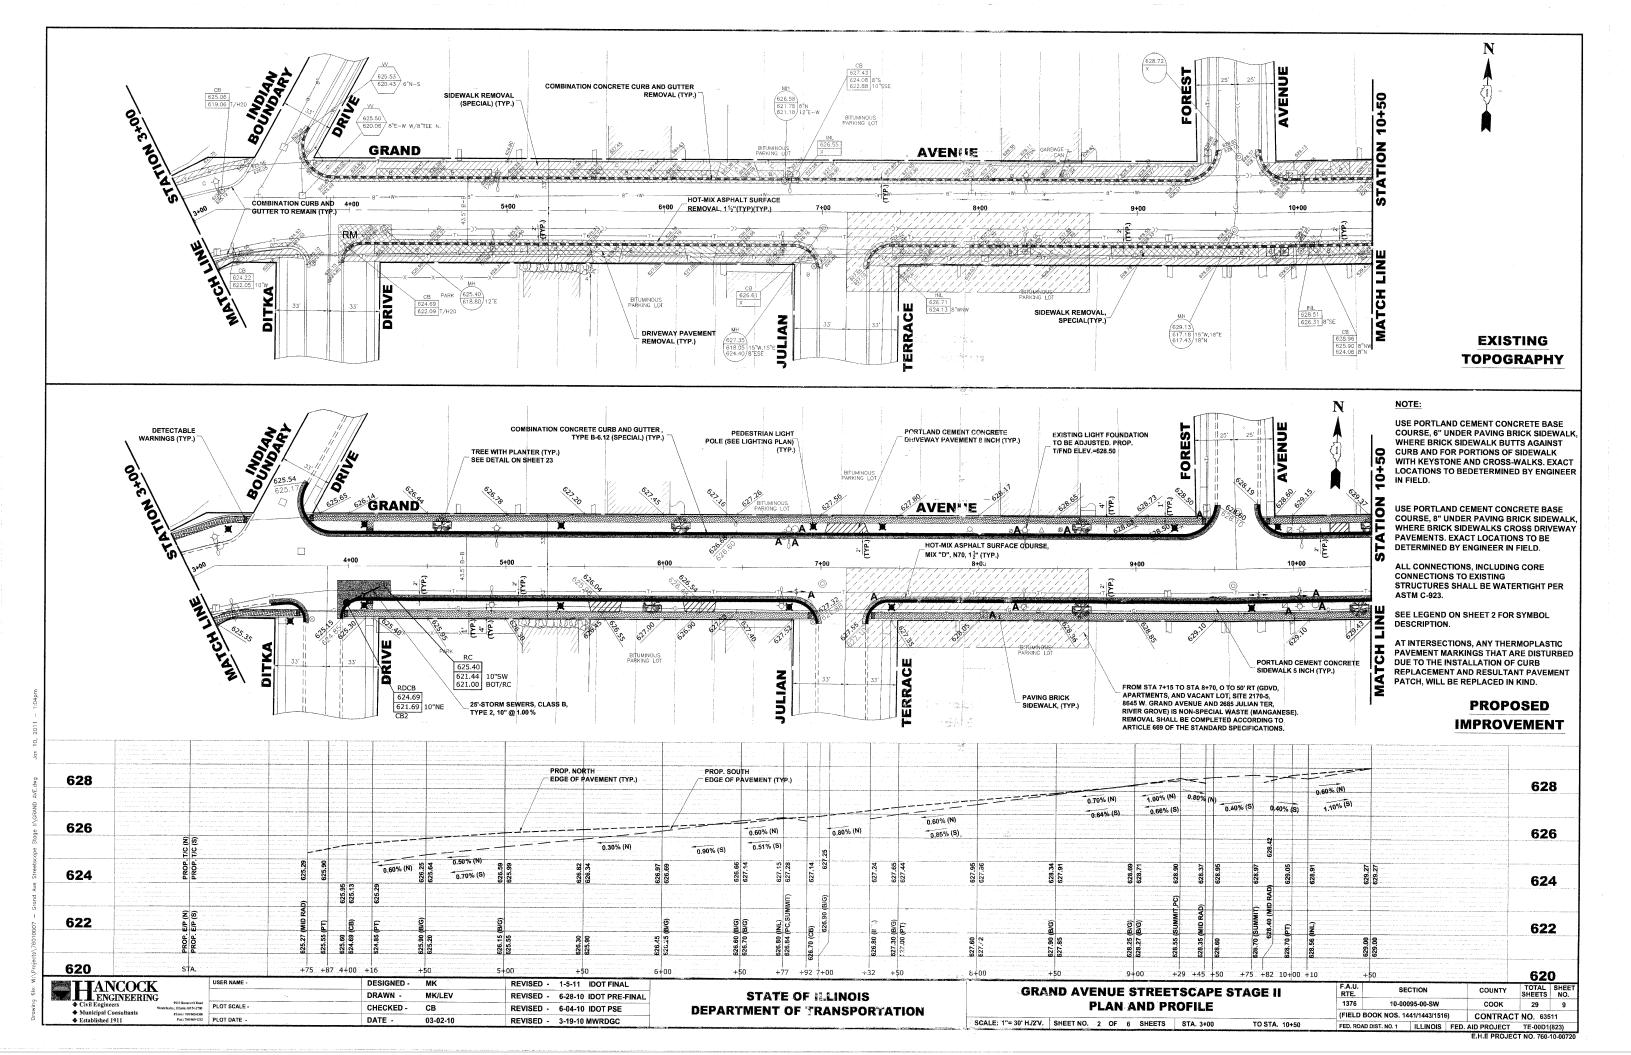


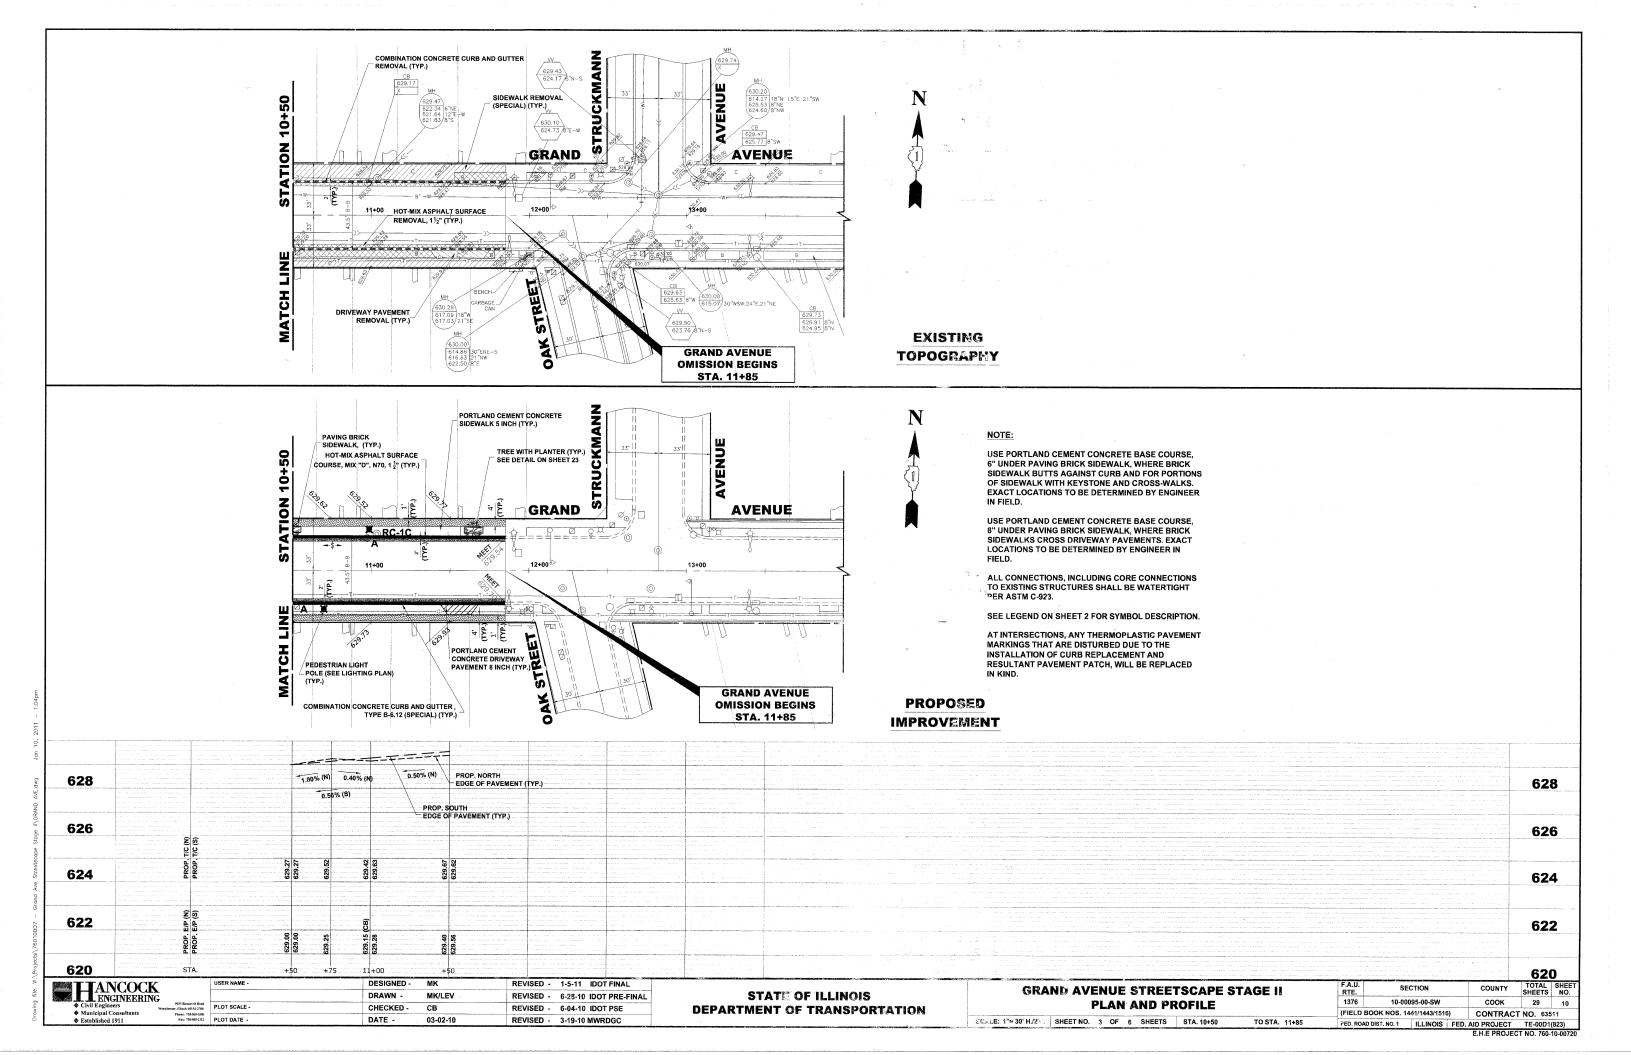

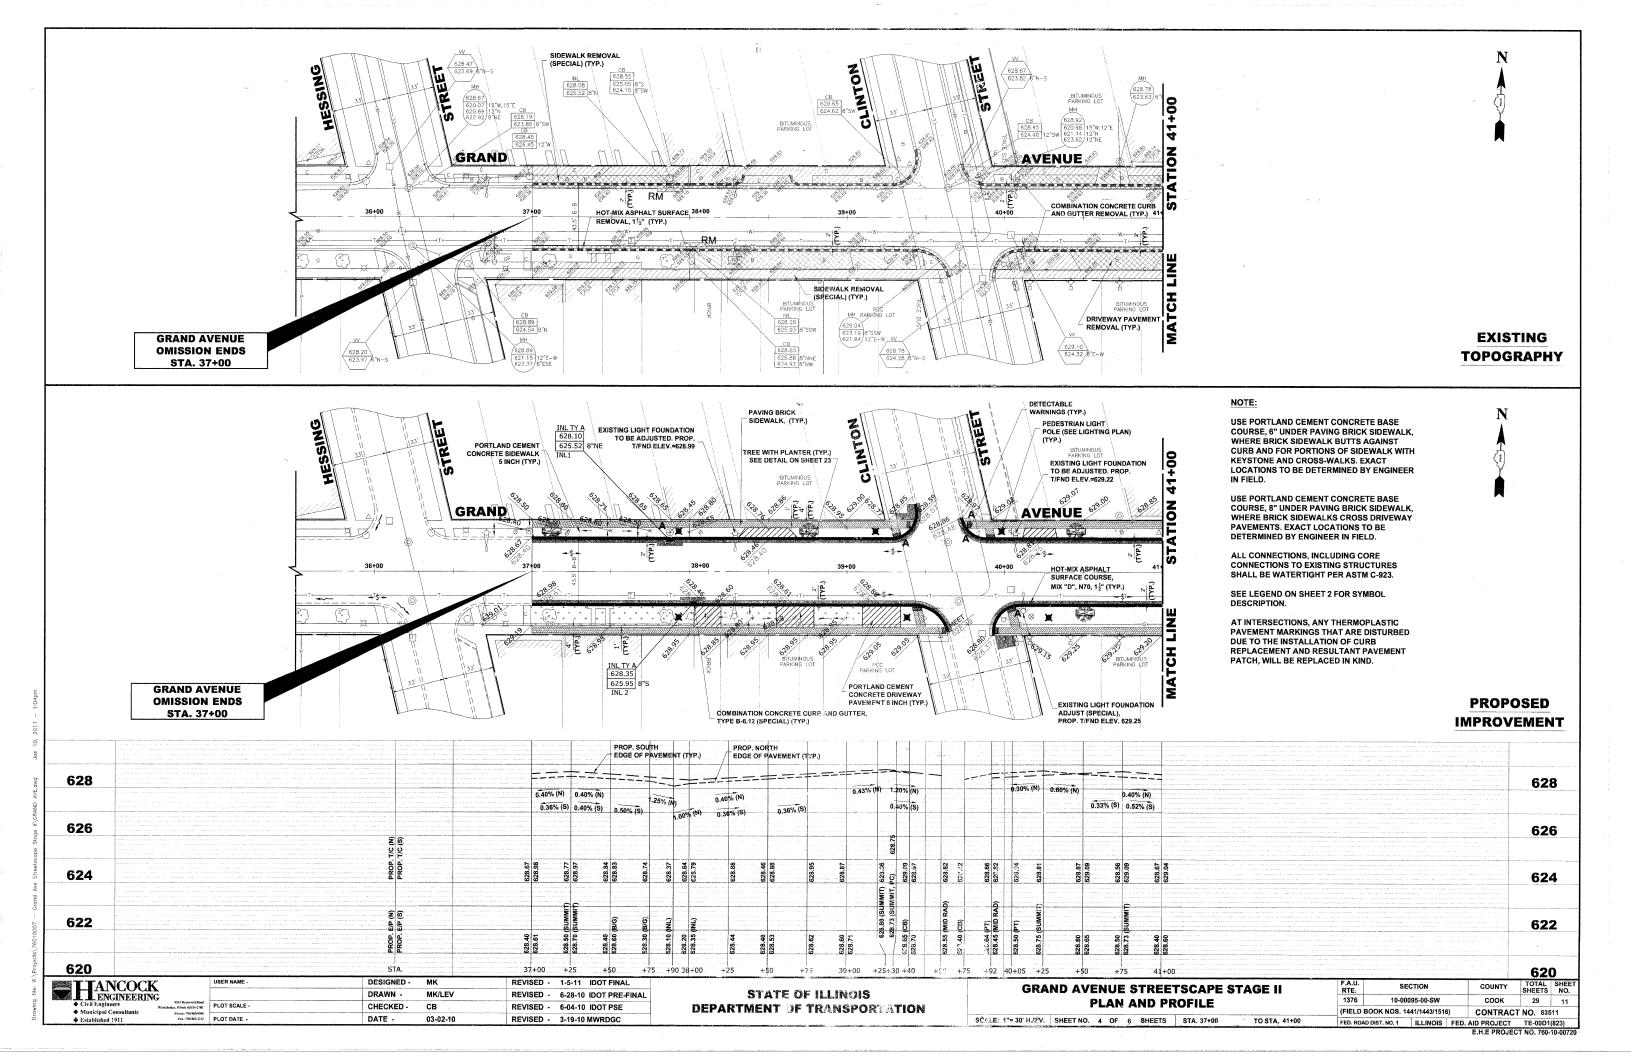

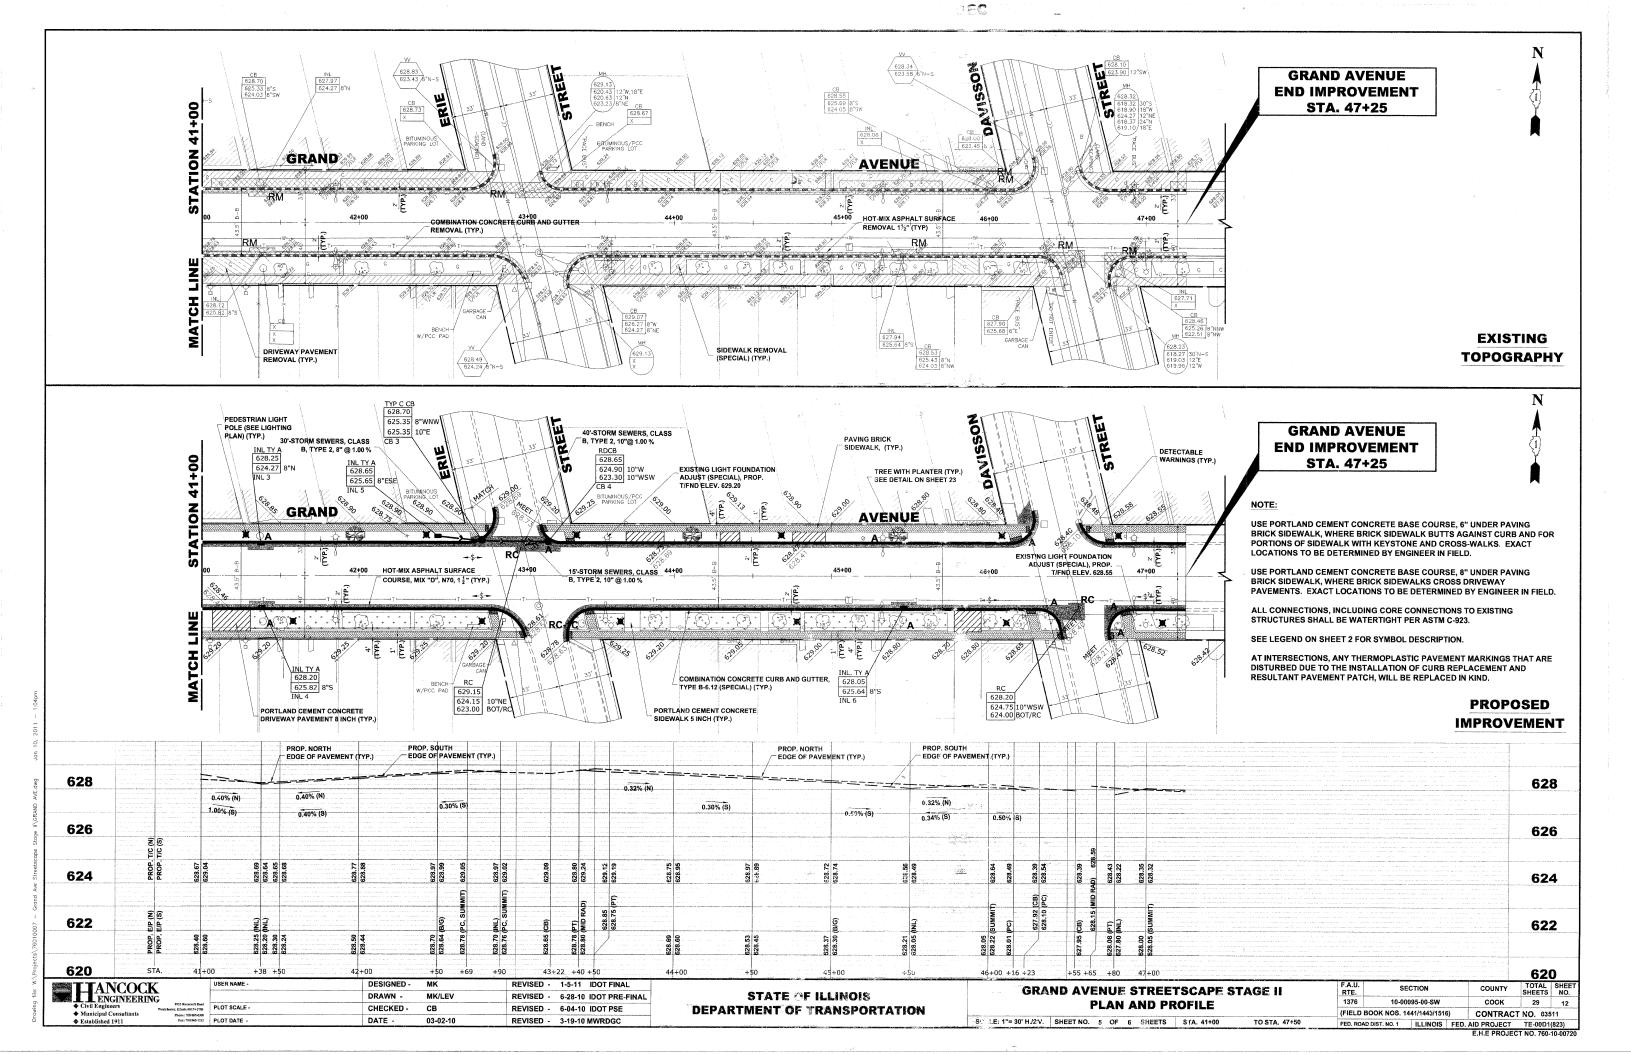

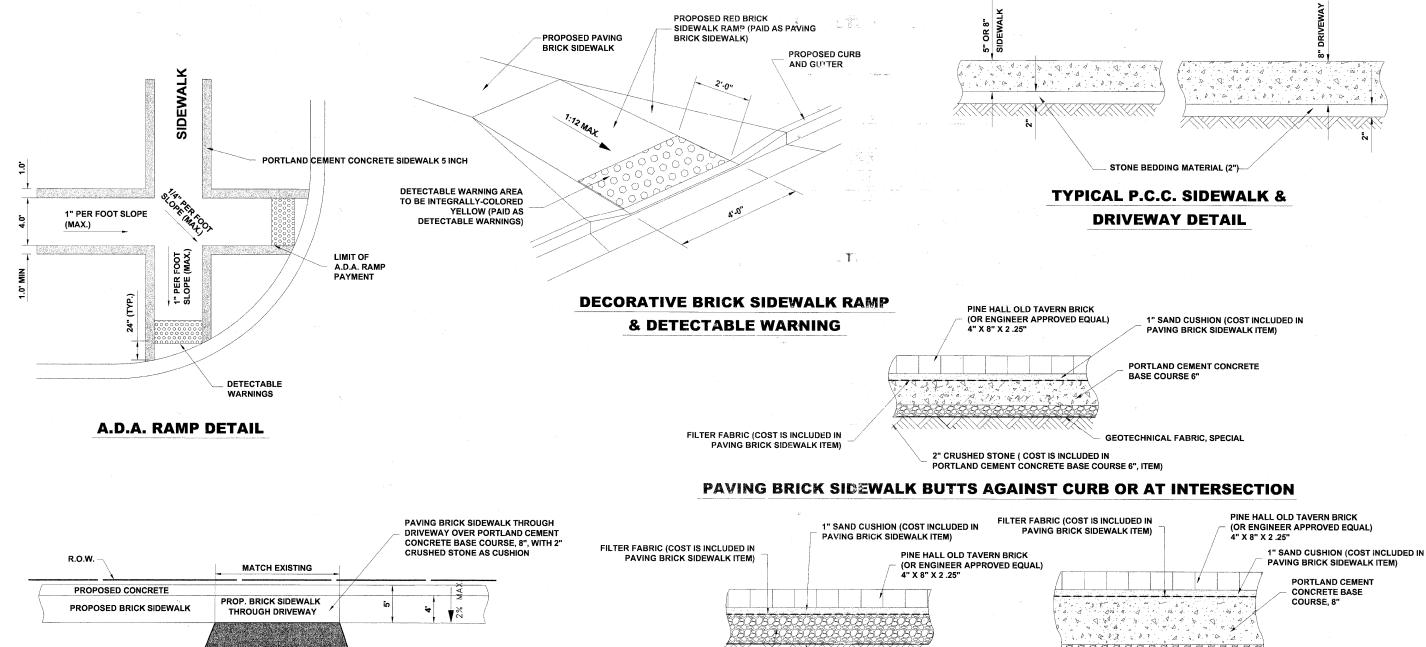

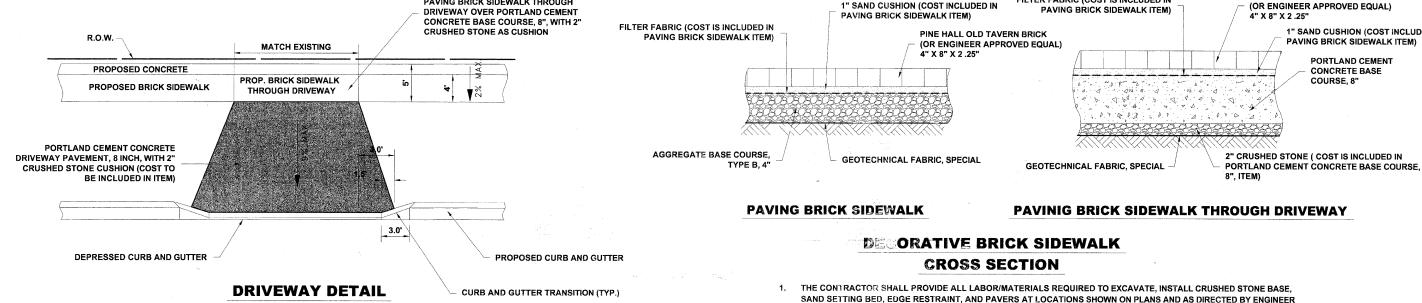

HANCOCK	<u> </u>
♦ Civil Engineers	9933 Westrhester, life
♦ Municipal Consultants	Phop
Established 1911	Fa


	USER NAME -	DESIGNED -	MK	REVISED -	1-5-11 IDOT FINAL
		DRAWN -	MK/LEV	REVISED -	6-28-10 IDOT PRE-FINAL
Read -2180 5-0300	PLOT SCALE -	CHECKED -	СВ	REVISED -	6-04-10 IDOT PSE
	PLOT DATE -	DATE -	03-02-10	REVISED -	3-19-10 MWRDGC

STATE OF ILLINOIS
DEPARTMENT (** TRANSPORTATION


2. PAVERS SHALL MEET THE REQUIREMENTS OF ASTM C-936.

SCALE: NONE

GRAND AVENUE STREETSCAPE STAGE II	F.A.U. SECTION		COUNTY		SHEET NO.
ROADWAY DETAILS	1376	10-00095-00-SW	соок	29	13
	(FIELD	BOOK NOS. 1441/1443/1516)	CONTRACT	NO. 635	11
NE SHEET NO. 1 OF 3 SHEETS STA. TO STA.	FED. ROA	AD DIST. NO. 1 ILLINOIS FED.	AID PROJECT	TE-00D1	(823)
			E.H.E PROJEC	T NO. 760-	10-00720

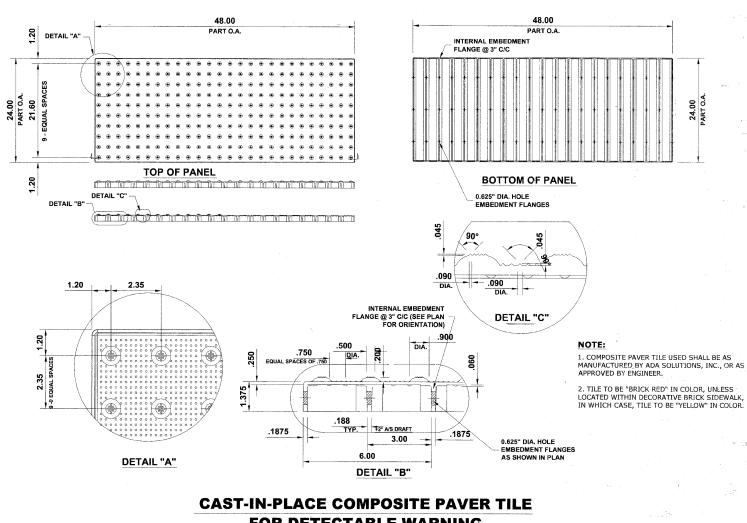

FOR DETECTABLE WARNING

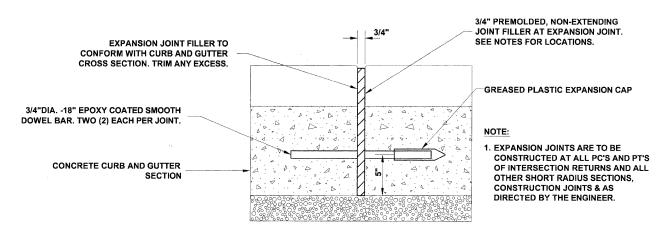

TYPICAL CURB AND GUTTER EXPANSION JOINT


HOT-MIX ASPHALT BASE COURSE, 21/4"

HOT-MIX ASPHALT SURFACE COURSE, 1½" DEPRESSED CURB 2' (TYP) MIX "D", N70, 11/2 " 12" AT DRIVEWAYS, 1" DOWEL BARS **DEPRESSED CURB AT** 3" PER FOOT SLOPE CA-7 BACKFILL 6" WIDE CONCRETE WEDGE (INCLUDED IN COST OF COMBINATION CONCRETE CURB AND GUTTER, TYPE B-6.12 (SPECIAL)) STONE BEDDING MATERIAL (2")

NOTES:

- PROVIDE 2 3/4" DIAMETER, 18" LONG EPOXY COATED SMOOTH DOWEL BARS WITH PLASTIC EXPANSION CAPS AT EACH EXPANSION JOINT.
- CONTRACTION JOINT 2" DEEP CONTRACTION JOINTS SHALL BE SAWED AT EQUAL SPACES (NOT EXCEEDING 15 FEET) BETWEEN NORMAL EXPANSION JOINTS, IN THE UPPER 1/3 OF CURB & GUTTERS WITHIN 24 HOURS OF PLACEMENT.
- A 6" CONCRETE WEDGE IS TO BE POURED IN THE SPACE BETWEEN THE NEW CURB & THE EXISTING PAVEMENT AFTER THE CURB HAS REACHED ITS INITIAL SET
- THE NEW CURB AND GUTTER SHALL BE BACKFILLED FOR THE FULL-DEPTH OF THE CURB WITH CA-7 OR OTHER STONE APPROVED BY ENGINEER.
- THE COST OF THE ABOVE SHALL BE INCLUDED IN THE COMBINATION CONCRETE CURB AND GUTTER, TYPE B-6.12 (SPECIAL).

COMBINATION CONCRETE CURB & GUTTER, TYPE B-6.12 (SPECIAL)

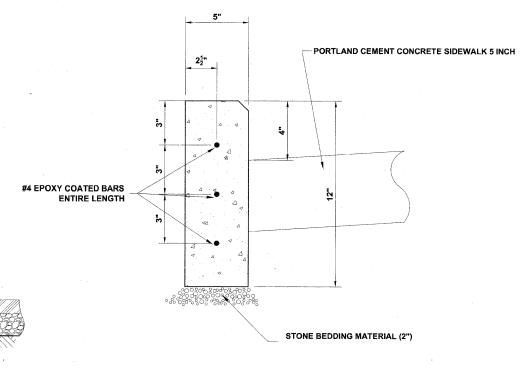

CONCRETE CURB, TYPE B

TYPICAL ASPHALTED PARKWAY

HOT-MIX ASPHALT SURFACE

COURSE, MIX "C", N50 (2")

ŧ	HANCOC	K NG
	♦ Civil Engineers	9933 Ross Westchester, lilinois 6
	♦ Municipal Consultants ♦ Established 1911	Place: 76 Fax: 76


		DESIGNED -	MK	REVISED -	1-5-11	IDOT FINAL
		DRAWN -	MK/LEV	REVISED -	6-28-10	IDOT PRE-FINAL
PL.C	OT SCALE -	CHECKED -	СВ	REVISED -	6-04-10	IDOT PSE
2 PLC	OT DATE -	DATE -	03-02-10	REVISED -	3-19-10	MWRDGC

STATE OF ILLINOIS DEPARTMENT OF TRANSPORTATION


GR	GRAND AVENUE STREETSCAPE STAGE II					STAGE II		
		₹0	AE	M	AY DE	TAILS		
E	SHEET NO.	2	OF	3	SHEETS	STA.	TO STA.	

F.A.U. RTE.	Si	CTION		COUNTY	TOTAL SHEETS	SHEET NO.
1376	10-00	095-00-SW		соок	29	14
(FIELD BC	OK NOS. 1	441/1443/151	5)	CONTRAC	FNO. 635	11
FED. ROAD I		ILLINOIS	FED.	AID PROJECT	TE-00D1	(823)

TYPICAL PVC SEWER TRENCH DETAIL

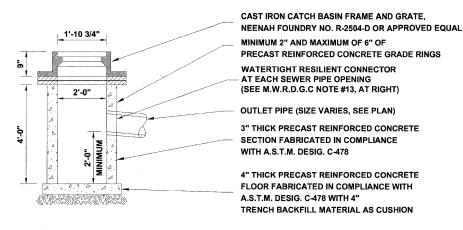

CATCH BASIN, TYPE C, SPECIAL

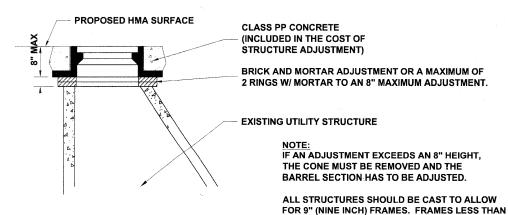

STRUCTURE ADJUSTMENT

M.W.R.D.G.C. GENERAL NOTES

- THE MWRD SEWER SYSTEMS SECTION FIELD OFFICE MUST BE NOTIFIED AT LEAST TWO (2) WORKING DAYS PRIOR TO THE COMMENCEMENT OF WORK AT (708) 588-4055
- **ELEVATION DATUM IS NAV 88**
- NO FLOOR DRAINS ON THIS PROJECT.
- NO DOWNSPOUTS AND FOOTING DRAINS ON THIS PROJECT.
- ALL PVC STORM SEWER PIPE JOINTS SHALL CONFORM TO ASTM D-3139. ALL PVC SEWER PIPE 12" IN DIAMETER OR LESS SHALL CONFORM TO ASTM D-2241 (WATER QUALITY PIPE). ALL PVC SEWER PIPE SHALL BE SDR 26.
- ALL D.LP. STORM COMBINED AND SANITARY SEWER PIPE JOINTS SHALL CONFORM TO ASTM A-21.11. ALL D.I.P. SEWER PIPE SHALL CONFORM TO ASTM A-21.51. ALL D.I.P. SEWER PIPE SHALL BE CLASS 52
- ALL SANITARY, COMBINED, AND STORM SEWER CONSTRUCTION IN COMBINED SEWER AREAS, REQUIRES STONE BEDDING 1/4" TO 1" IN SIZE, WITH A MINIMUM THICKNESS EQUAL TO 1/4 THE OUTSIDE DIAMETER OF THE SEWER PIPE, BUT NOT LESS THAN FOUR INCHES (4") NOR MORE THAN EIGHT INCHES (8"). MATERIAL SHALL BE CA-11 OR CA-13 AND SHALL BE EXTENDED AT LEAST 12" ABOVE THE TOP OF THE TIPE.
- "BAND SEAL" OR SIMILAR FLEXIBLE-TYPE COUPLINGS SHALL BE USED IN THE CONNECTION OF SEWER PIPE OF DISSIMILAR MATERIALS.
- WHEN CONNECTING TO AN EXISTING SEWER MAIN BY MEANS OTHER THAN AN EXISTING WYE, TEE, OR AN EXISTING MANHOLE, ONE OF THE FOLLOWING METHODS SHALL BE USED:
 - CIRCULAR SAW-CUT OF SEWER MAIN BY PROPER TOOLS ("SHEWER TAP" MACHINE, OR SIMILAR) AND PROPER INSTALLATION OF HUB-WYE SADDLE OR HUR-TEE SADDLE
 - REMOVE AN ENTIRE SECTION OF PIPE (BREAKING ONLY THE TOP OF ONE BELL) AND REPLACE WITH A WYE OR TEE BRANCH SECTION. AFTER THE WYE OR TEE BRANCH IS INSERTED, CONCRETE SHALL BE PLACED OVER THE BROKEN AREA TO A MINIMUM THICKNESS OF 4" AND TO A DIMENSION OF 8" IN
 - USING PIPE CUTTER, NEATLY AND ACCURATE YOUT DESIRED LENGTH OF PIPE FOR INSERTION OF PROPER FITTING. USE "BAND SEAL" OR SIMILAR COUPLINGS TO HOLD FIRMLY IN PLACE. FOLLOW MANUFACTURER'S... RECOMMENDATIONS FOR THE INSTALLATION.
- WHEREVER A SEWER CROSSES UNDER A WATER MAIN. THE MINIMUM VERTICAL DISTANCE FROM THE TOP OF THE SEWER TO THE BOTTOM OF THE WATER MAIN SHALL BE 18 INCHES. FURTHERMORE, A MINIMUM HORIZONTAL DISTANCE OF 10 FEET BETWEEN SANITARY/COMBINED SEWERS AND WATER MAINS SHALL 3E MAINTAINED UNLESS: THE SEWER IS LAID IN A SEPARATE TRENCH, KEEPING A MINIMUM 18" VERTICAL SEPARATION OR THE SEWER IS LAID IN THE SAME TRENCH WITH THE WATER MAIN LOCATED AT THE OPPOSITE SIDE ON A BENCH OF UNDISTURBED EARTH, KEEPING A MINIMUM 18" VERTICAL SEPARATION, IF EITHER THE VERTICAL OR HORIZONTAL DISTANCES DESCRIBED ABOVE CANNOT BE MAINTAINED, OR THE SEWER CROSSES ABOVE THE WATER MAIN, THE SEWER SHALL BE CONSTRUCTED TO WATER MAIN STANDARDS.
- ALL SANITARY MANHOLES, (AND STORM MANHOLES IN COMBINED SEWER AREAS), SHALL HAVE A MINIMUM INSIDE DIAMETER OF 48 INCHES, AND SHALL BE PRE-GAST REINFORCED
- ALL ABANDONED SEWERS SHALL BE PLUGGED AT BOTH ENDS WITH A MINIMUM OF TWO (2) FEET LONG, NON-SHRINK CONCRETE/MORTAR PLUG.
- ALL INLET AND OUTLET PIPES OF SANITARY SEWER MANHOLES AND OTHER UNDERGROUND STRUCTURES (AND IN COMBINED SEWER AREAS, ALSO ALL COMBINED/STORM SEWER MANHOLES, CATCH BASINS, INLETS, AND UNDERGROUND DETENTION STORAGE STRUCTURES) SHALL BE JOINED WITH WATERTIGHT FLEXIBLE RUBBER CONNECTORS CONFORMING TO A.S.T.M. C-443 & C-923 WITH STAINLESS STEEL BANDS
- THE MAXIMUM ALLOWABLE INFILTRATION OR EXFILTRATION IS 100 GAL/DAY/MILE/INCH DIA OF THE SEWER PIPE.

CAST IRON CATCH BASIN FRAME AND GRATE. NEENAH FOUNDRY NO. R-2504-D OR APPROVED EQUAL



4" THICK PRECAST REINFORCED CONCRETE FLOOR FABRICATED IN COMPLIANCE WITH A.S.T.M. DESIG. C-478, WITH 4" AND CUSH!

CALE: NONE

INLET, TYPE A, SPECIAL

DRAINAGE AND UTILITIES NOTES

THE LOCATIONS OF EXISTING DRAINAGE STRUCTURES, STORM SEWERS, COMBINED SEWERS TELEPHONE LINES, COMMUNICATION LINES, ELECTRIC LINES, GAS MAINS, AND WATER SERVICES ARE APPROXIMATE AND THEIR SPECIFIC LOCATIONS ARE TO BE DETERMINED IN THE FIELD AT NO COMPENSATION TO THE CONTRACTOR.

WHEN EXISTING DRAINAGE FACILITIES ARE DISTURBED, THE CONTRACTOR SHALL. PROVIDE AND MAINTAIN TEMPORARY OUTLETS AND CONNECTIONS FOR ALL PRIVATE OR PUBLIC DRAINAGE STRUCTURES OR SEWERS UNTIL PERMANENT CONNECTIONS TO SEWERS ARE BUILT AND IN SERVICE. THIS WORK SHALL NOT BE PAID FOR DIRECTLY, BUT SHALL BE CONSIDERED INCLUDED IN THE COST OF PROPOSED STORM SEWER PIPES.

WHEN, DURING CONSTRUCTION OPERATIONS, ANY LOOSE MATERIALS ARE DEPOSITED IN THE FLOW LINES. OF GUTTERS OR DRAINAGE STRUCTURES SO THAT THE NATURAL FLOW OF WATER IS OBSTRUCTED, THE OBSTRUCTING MATERIALS SHALL BE REMOVED AT THE CLOSE OF EACH WORK DAY. AT THE CONCLUSION OF THE CONSTRUCTION OPERATIONS, ALL DRAINAGE STRUCTURES ARE TO BE FREE OF ALL DIRT, DEBRIS, AND OBSTRUCTING MATERIALS. THE WORK SPECIFIED ABOVE WILL NOT BE PAID FOR SEPARATELY, BUT SHALL BE CONSIDERED AS INCLUDED IN THE COST OF PROPOSED STRUCTURES.

THE TYPE OF FRAMES AND GRATES REQUIRED FOR ALL CATCH BASINS AND MANHOLES LISTED IN THE SUMMARY OF QUANTITIES MAY BE FOUND ON THE PLANS AT THEIR RESPECTIVE LOCATIONS. WHERE LIDS ARE CALLED FOR ON THE PLANS, THEY SHALL BE IN ACCORDANCE WITH ARTICLE 604.01 OF THE STANDARD SPECIFICATIONS AND THE TERM LID IS USED IN LIEU OF GRATE.

ON ALL IMPROVEMENTS. THE FRAMES AND LIDS OF EXISTING CATCH BASINS, INLETS, MANHOLES, AND VALVE VAULTS WHICH ARE TO BE ABANDONED DUE TO CONSTRUCTION OF THIS IMPROVEMENT ARE TO REMAIN THE PROPERTY OF THE VILLAGE OF RIVER GROVE AND BE SALVAGED. THE VILLAGE OF RIVER GROVE PUBLIC WORKS YARD WILL PICK-UP STRUCTURES FROM JOB-SITE.

ANY COSTS FOR SHEETING OR SHORING REQUIRED FOR THE STORM SEWER INSTALLATION OR OTHER CONSTRUCTION ELEMENTS REQUIRING RELATIVELY DEEP EXCAVATIONS SHALL BE INCLUDED IN THE PARTICULAR PAYMENT ITEM AND NO ADDITIONAL COMPENSATION WILL BE ALLOWED FOR ANY SUPPLEMENTAL WORK ASSOCIATED WITH THE MAINTENANCE OF TRENCH SIDES OR OTHER EXCAVATED

SEWER PIPE INSTALLED ON THIS PROJECT SHALL CONFORM TO THE FOLLOWING STANDARD:


NO FIELD OR DRAINAGE TILES SHALL BE CONNECTED TO THE COMBINED SEWER SYSTEM. FIELD / DRAINAGE TILES ENCOUNTERED DURING CONSTRUCTION MUST BE REMOVED AND TAKEN OUT OF THE SITE AND SHALL NOT BE RECONNECTED TO THE COMBINED SEWER.

TYPE OF PIPE MATERIAL STANDARD JOINT STANDARD

POLYVINYLCHLORIDE PIPE, 8"-12"

ASTM D-2241

ASTM D-3139

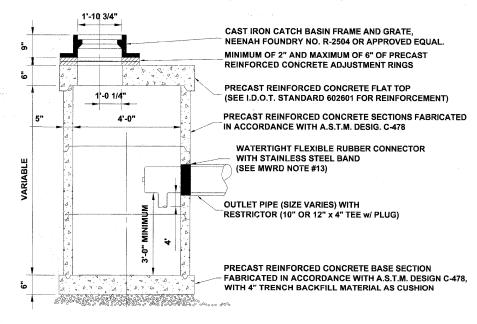

CATCH BASINS, TYPE A. SPECIAL

TO STA


USER NAME DESIGNED - MK REVISED - 1-5-11 IDOT FINAL DRAWN . MK/LEV REVISED - 6-28-10 IDOT PRE-FINAL CHECKED -СВ REVISED - 6-04-10 IDOT PSE PLOT DATE DATE -03-02-10 REVISED - 3-19-10 MWRDGC

9" WILL NOT BE ALLOWED.

STATE OF ILLINOIS DEPARTMENT OF TRANSPORTATION **GRAND AVENUE STREETSCAPE STAGE II ROADWAY DETAILS**

SHEET NO. 3 OF 3 SHEETS STA.

TOTAL SHEE SHEETS NO. SECTION COUNTY соок 1376 10-00095-00-SW 29 15 (FIELD BOOK NOS. 1441/1443/1516) CONTRACT NO. 63511 FED. ROAD DIST. NO. 1 ILLINOIS FED. AID PROJECT TE-00D1(823)

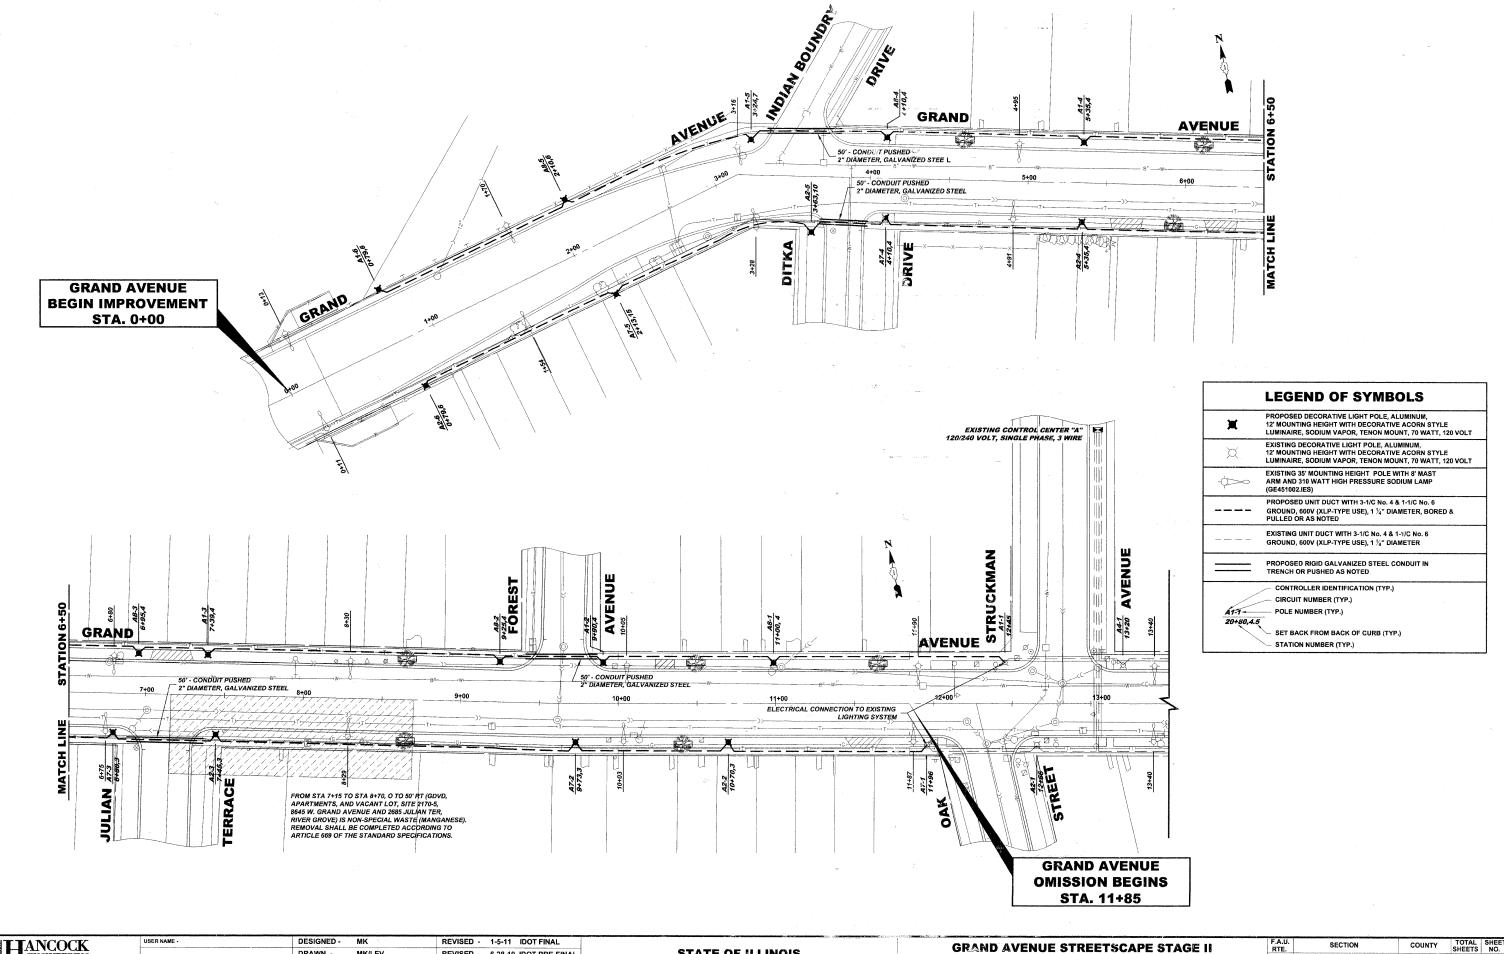

Drowing file: W:\ Projects\ 76010007 = Gran

ANCOCK

Civil Engineers


Musicipal Consultants


Established 1911


STATE OF ILLINOIS
DEPARTMENT OF TRANSPORTATIONS

GRAND AVENUE STREETSCAPE STAGE II
LIGHTING PLAN

SCALE: 1"= 30" SHEET NO. 1 OF 3 SHEETS STA.0+00 TO STA. 11+85

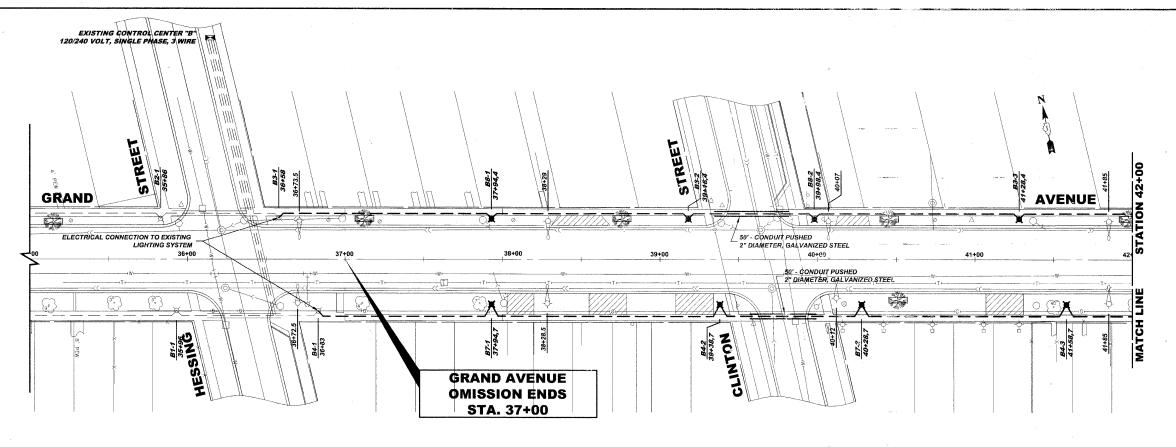

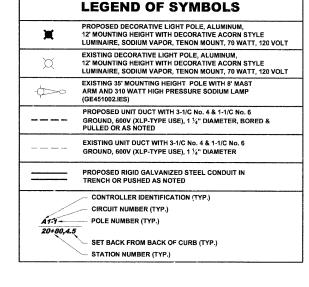

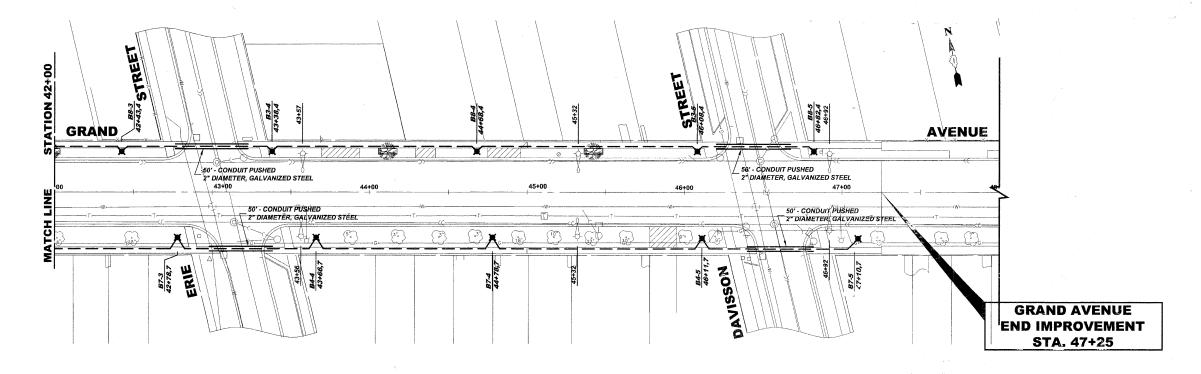


HANCOC	K
Civil Engineers Municipal Consultants Established 1911	Westchester, II Ph


USER NAME -DESIGNED -REVISED - 1-5-11 IDOT FINAL DRAWN -MK/LEV REVISED - 6-28-10 IDOT PRE-FINAL 103 Recent veil Read PLOT SCALE -CHECKED -СВ REVISED - 6-04-10 IDOT PSE PLOT DATE -DATE -03-02-10 REVISED - 3-19-10 MWRDGC

STATE OF ILLINOIS **DEPARTMENT OF TRANSPORTATION** **GRAND AVENUE STREETSCAPE STAGE II** LIGHTING PLAN SHEET NO. 2 OF 3 SHEETS STA. 37+00

TOTAL SHEET SHEETS NO. SECTION COUNTY COOK 29 17 1376 10-00095-00-SW (FIELD BOOK NOS. 1441/1443/1516) CONTRACT NO. 63511 FED. ROAD DIST. NO. 1 ILLINOIS FED. AID PROJECT TE-00D1(823)

€ :ALE: 1"= 30"

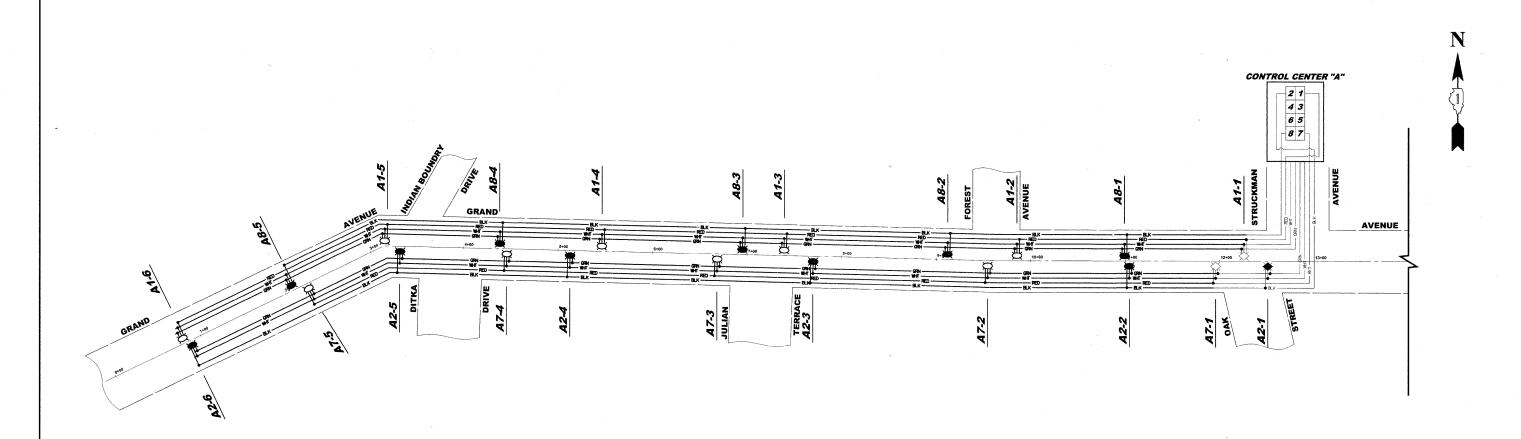

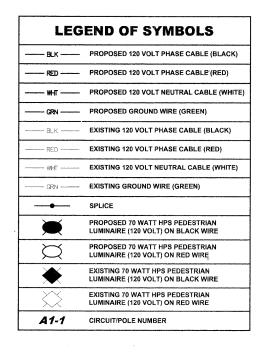

LIGHTING CONTROLLER "A" CIRCUIT LOADS							
CIRCUIT	PHASE	- RED	CIRCUIT	PHASE	BLACK		
CIRCUIT	AMPS	WATTS	CIRCUIT	AMPS	WATTS		
1	13.8	420	2	13.8	420		
3	13.8	420	4	18.4	560		
5	16.1	490	6	13.8	420		
7	13.8	420	8	11.5	350		
TOTAL	57.5	1,750	TOTAL	57.5	1,750		

PROPOSED LOAD FOR POLE = 70W LUMINAIRE + 120V FESTOON @ 180VA

TTANCOCK	USER NAME -	DESIGNED -	MK	REVISED -	1-5-11 IDOT FINAL
ENGINEERING		DRAWN -	MK/LEV	REVISED -	6-28-10 IDOT PRE-FINAL
◆ Civil Engineers Wenthester, Hands 60154-2780 Municipal Consultants	PLOT SCALE -	CHECKED -	СВ	REVISED -	6-04-10 IDOT PSE
♦ Established 1911 Far: 748-988-1212	PLOT DATE -	DATE -	03-02-10	REVISED -	3-19-10 MWRDGC

STATE OF ILLINOIS **DEPARTMENT OF TRANSPORTATION**


GRA	GRAND AVENUE STREETSCAPE STAGE II WIRING DIAGRAM CONTROL CENTER "A"				
WIR	NG DIA	\GRA	W CON.	TROL	CENTER "A"
ONE	SHEET NO.	1 OF	1 SHEETS	STA.	TO STA.

-	F.A.U. RTE.	SE	CTION		COUNTY	TOTAL SHEETS	SHEE NO.
	1376	10-00	095-00-SW		соок	29	18
	(FIELD	BOOK NOS. 1	441/1443/1510	5)	CONTRAC	TNO. 635	11
	FED. ROA	D DIST, NO. 1	ILLINOIS	FED.	AID PROJECT	TE-00D1	(823)

E.H.E PROJECT NO. 760-10-00720

SCALE: NONE

SHEET NO. 1 OF 1 SHEETS STA.

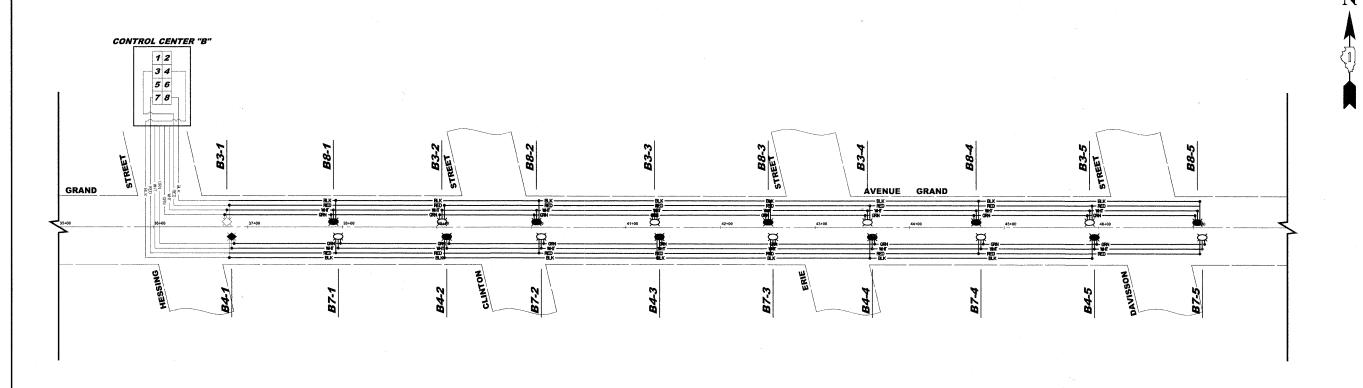

LEG	END OF SYMBOLS
ВLК	PROPOSED 120 VOLT PHASE CABLE (BLACK)
RED	PROPOSED 120 VOLT PHASE CABLE (RED)
w-п	PROPOSED 120 VOLT NEUTRAL CABLE (WHITE)
GRN	PROPOSED GROUND WIRE (GREEN)
BLK	EXISTING 120 VOLT PHASE CABLE (BLACK)
RED	EXISTING 120 VOLT PHASE CABLE (RED)
W-П	EXISTING 120 VOLT NEUTRAL CABLE (WHITE)
GRN	EXISTING GROUND WIRE (GREEN)
	SPLICE
	PROPOSED 70 WATT HPS PEDESTRIAN LUMINAIRE (120 VOLT) ON BLACK WIRE
X	PROPOSED 70 WATT HPS PEDESTRIAN LUMINAIRE (120 VOLT) ON RED WIRE
*	EXISTING 70 WATT HPS PEDESTRIAN LUMINAIRE (120 VOLT) ON BLACK WIRE
\Rightarrow	EXISTING 70 WATT HPS PEDESTRIAN LUMINAIRE (120 VOLT) ON RED WIRE
A1-1	CIRCUIT/POLE NUMBER

L	LIGHTING CONTROLLER "B" CIRCUIT LOADS											
PHASE - RED PHASE - BLACK												
CIRCUIT	AMPS	WATTS	CIRCUIT	AMPS	WATTS							
1	13.8	420	2	16.1	490							
3	11.5	350	4	11.5	350							
5	13.8	420	6	11.5	350							
7	11.5	350	8	11.5	350							
TOTAL	50.6	1,540	TOTAL	50.6	1,540							

NOTE:
PROPOSED LOAD FOR POLE = 70W LUMINAIRE + 120V FESTOON @ 180VA

	AND THE COURT OF T				
TIANCOCK	USER NAME -	DESIGNED -	MK	REVISED -	1-5-11 IDOT FINAL
ENGINEERING		DRAWN -	MK/LEV	REVISED -	6-28-10 IDOT PRE-FINAL
♦ Civil Engineers Westbaster, tilteds 40154-2280 Municipal Consultants Phone-2088455400	PLOT SCALE -	CHECKED -	СВ	REVISED -	6-04-10 IDOT PSE
♦ Established 1911 Fat: 7987865-1212	PLOT DATE -	DATE -	03-02-10	REVISED -	3-19-10 MWRDGC


STATE OF ILLINOIS **DEPARTMENT OF TRANSPORTATION**

GRAND AVENUE STREETSCAPE STAGE II WIRING DIAGRAM CONTROL CENTER "B" SCALE: NONE SHEET NO. 1 OF 1 SHEETS STA.


F.A.U. RTE. 1376 SECTION 10-00095-00-SW
 (FIELD BOOK NOS. 1441/1443/1516)
 CONTRACT NO. 63511

 FED. ROAD DIST. NO. 1
 ILLINOIS
 FED. AID PROJECT TE-0001(823)

 E.H.E PROJECT NO. 760-10-00720

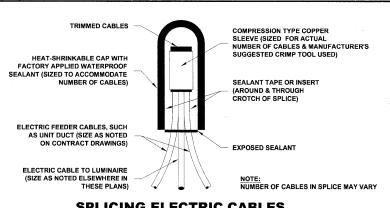

SPLICING ELECTRIC CABLES BASIC MATERIALS AND METHODS

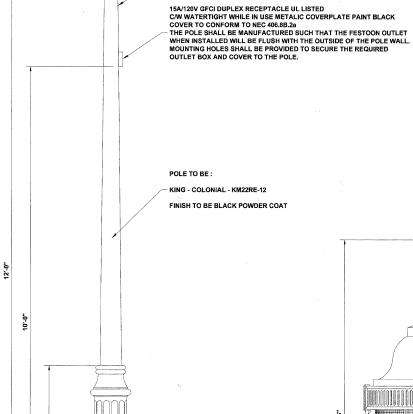

4" x 1½" LG C-CHANNEL x 3" LG GROUNDING


DECORATIVE LIGHT POLE, ALUMINUM,

12' MOUNTING HEIGHT


ACCESSIBLE THRU HAND HOLE)

POLE TO MEET

AND BE UL CLASSIFIED

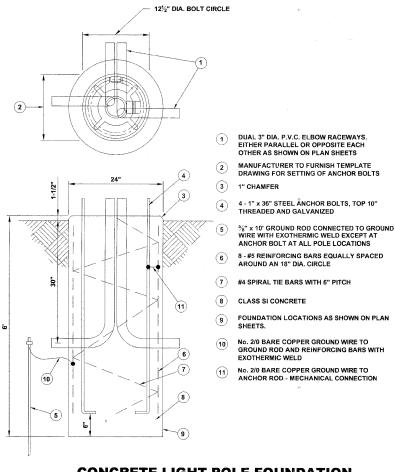

CONCRETE LIGHT POLE FOUNDATION

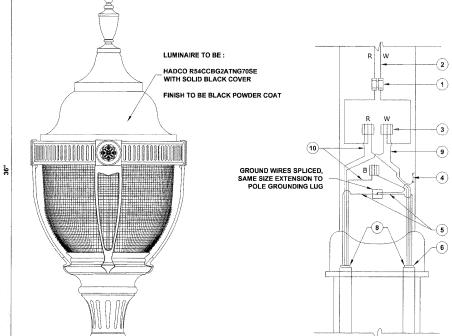

DECORATIVE ACORN STYLE LUMINAIRE,


SODIUM VAPOR, TENON MOUNT, 70 WATT

- STANDARD-TYPE SMALL DIMENSION DOUBLE POLE FUSEHOLDER WITH INSULATED BOOTS, **FUSING AND SOLID NEUTRAL SLUG (SEE SPECS)**
- 2 2-1/C #10 AWG, 600V TYPE RHW, SOLID COLOR CODED CABLES
- SPLICE AS SPECIFIED
- $\ensuremath{{\%}}\xspace^*$ 16 TAPPED HOLE BE PROVIDED FOR GROUND LUG
- INSULATED GROUND WIRE, 600V TYPE RHW, SOLID COLOR GREN, SIZE AS SPECIFIED
- 3" P.V.C. CONDUIT RACEWAYS
- ENDS OF THE UNIT DUCT SHALL BE SEALED AGAINST THE ENTRANCE OF WATER
- NEUTRAL CONDUCTOR, 600V TYPE RHW, SOLID COLOR WHITE, SIZE AS SPECIFIED
- PHASE CONDUCTORS, 600V TYPE RHW, SOLID COLOR, SIZE AS SPECIFIED

ALLOW 30" LOOP OF CABLES TO INSURE SUFFICIENT SLACK FOR WITHDRAWAL OF THE CONNECTORS OUTSIDE OF THE POLE HANDHOLE.

SCALE: NONE

POLE HANDHOLE WIRING DIAGRAM

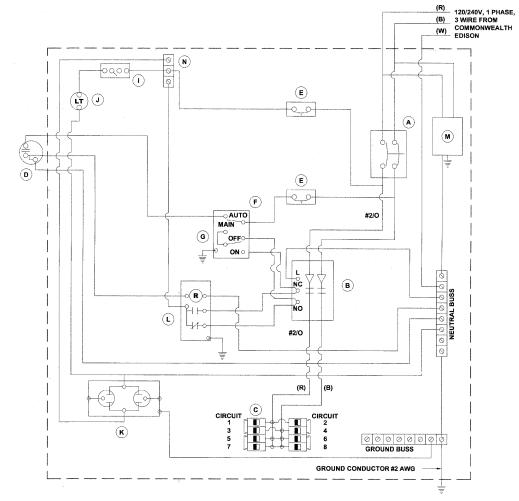

		DEVICE SCHEDULE
	QUANTITY	DESCRIPTION
A	1	100 AMP CIRCUIT BREAKER, MOLDED CASE, THERMAL MAGNETIC, 2-POLE, SINGLE THROW, 600V FRAME, NON-INTERCHANGABLE TRIP, BOLT ON TYPE.
В	1	100 AMP, ELECTRICALLY OPERATED AND MECHANICALLY HELD LIGHTING CONTRACTOR, 2-POLE, 600 VOLT WITH 120 V COIL
©	6	120/240 VOLT 1 PHASE PANEL BOARD WITH 100 AMP COPPER MAINS SINGLE POLE, 30 AMP, 120 VOLT BOLT ON BRANCH CIRCUIT BREAKERS
0	1	PHOTO-ELECTRIC CELL, 120 VOLT, MOUNT ON UNDERSIDE OF VENT ON CONTROLLER
E	2	THERMAL MAGNETIC, MOLDED CASE CIRCUIT BREAKER, 1 POLE, 15 AMP, 120 VOLT BOLT ON TYPE
F	1	CONTROL SWITCH, MOMENTARY CONTACT, SPDT, 15 AMP, 120 VOLT
G	1	CONTROL SWITCH, TOGGLE TYPE, SPDT, 20 AMP, 120 VOLT SPECIAL GRADE
①	1	MICRO SWITCH (MOUNTED WITH ACTUATOR TO SWITCH WHEN DOOR IS OPEN) 120 VOLT, 20 AMP
J	1	60 WATT LIGHT FIXTURE VAPOR TIGHT WITH GLOBE, GUARD, AND MOUNTING BOX
K	1	120 VOLT, 15 AMP RECEPTACLE, SPECIFICATION GRADE IN NEMA 5-15R WEATHER PROOF BOX WITH FLAP-TYPE COVER. OUTLET TO BE GFI-TYPE.
(L)	1	POWER RELAY WITH 25 AMP CONTACTS RATED FOR CONTRACTOR INRUSH CURRENT - 120 VOLT COIL
M	1	SURGE ARRESTOR, 5 WIRE EDCO "4803" OR EQUAL
(N)	1	TERMINAL BLOCK, 120 VOLT, 50 AMP MAXIMUM WITH NUMBER OF TERMINALS AS INDICATED


- ALL CIRCUIT BREAKERS SHALL HAVE AN INTERRUPT RATING OF 18,000 AMPS
- UL LISTED DEVICES/COMPONENTS SHALL BE USED
- NO SPLICES OF WIRES IN CABINET
- CONTROL WIRE TO BE #12 MTW
- POWER WIRE SHALL BE RATED RHH/RHW 600 VOLTS OF SIZE INDICATED
- LIGHTING CONTROLLER SHALL BE SERVICE ENTRANCE RATED

EXISTING 120/240 VOLT CONTROLLER PANEL WIRING DIAGRAM

TJANCOCK	USER NAME -	DESIGNED -	MK	REVISED -	1-5-11 IDOT FINAL
LENGINEERING		DRAWN -	MK/LEV	REVISED -	6-28-10 IDOT PRE-FINAL
♦ Civil Engineers Westbaster, Black 60154-2780 Municipal Consultants Page 18 Page 1 Page	PLOT SCALE -	CHECKED -	СВ	REVISED -	6-04-10 IDOT PSE
♦ Established 1911 Fax: 708:365-1212	PLOT DATE -	DATE -	03-02-10	REVISED -	3-19-10 MWRDGC

STATE OF ILLINOIS **DEPARTMENT OF TRANSPORTATION**

GRAND AVENUE STREETSCAPE STAGE II						F.A.U. RTE. SECTION		COUNTY	TOTAL SHEETS	SHEET NO.				
LIGHTING DETAILS					1376	10-000	95-00-SW		соок	29	20			
								(FIELD	BOOK NOS. 14	41/1443/1516	6)	CONTRACT	NO. 635	11
NE	SHEET NO.	1	OF	1	SHEETS	STA.	TO STA.	FED. ROA	AD DIST. NO. 1	ILLINOIS	FED.	AID PROJECT	TE-00D1	(823)

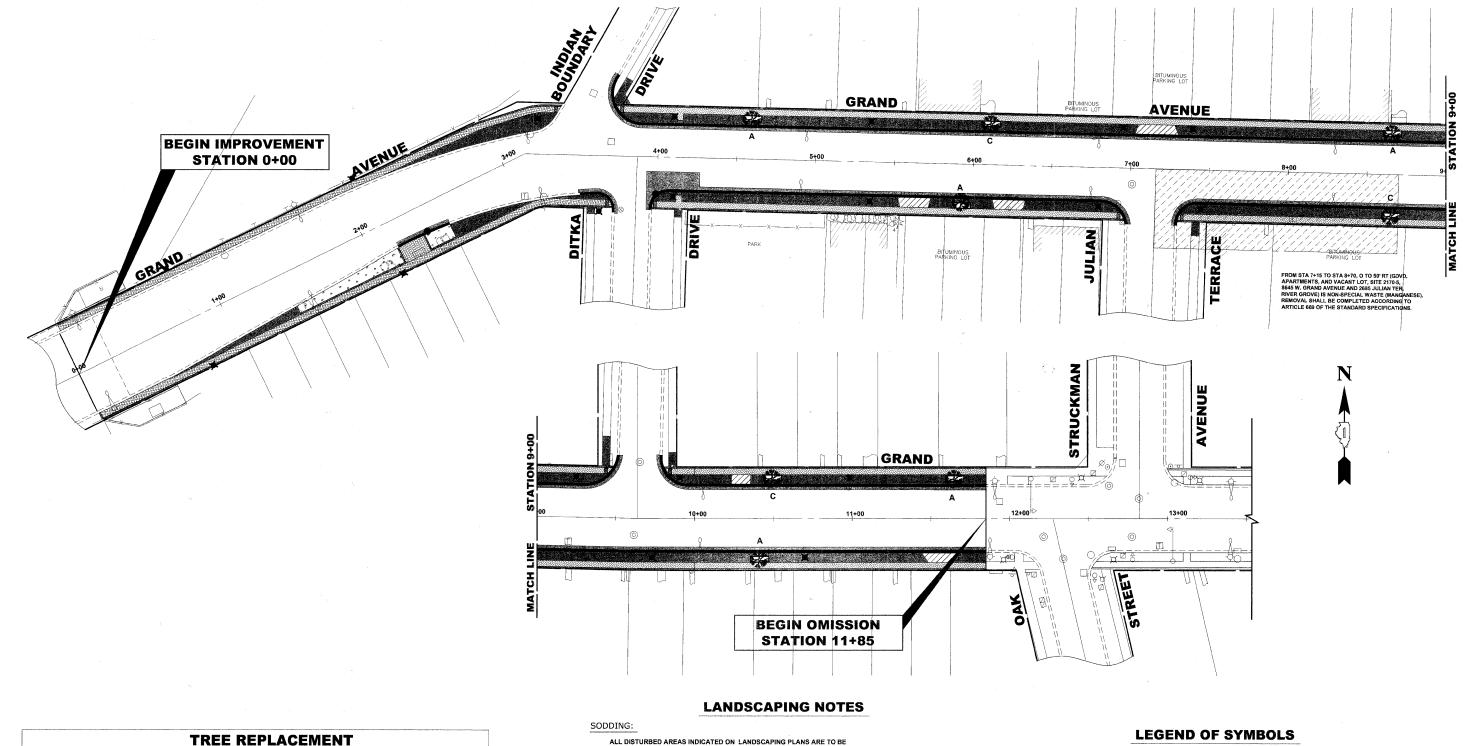

	TREE REPLACEMENT									
CODE	COMMON NAME	SCIENTIFIC NAME	SIZE	QUANTITY						
Α	CLEVELAND SELECT PEAR	PYRUS CALLERYANA	2" CALIPER	8						
В	NORWAY MAPLE	ACER PLANTANOIDES	2" CALIPER	1						
С	IVORY SILK	SYRINGA RETICULATA	2" CALIPER	6						

NOTE: ALL TREES BALLED AND BURLAPPED

ALL DISTURBED AREAS INDICATED ON LANDSCAPING PLANS ARE TO BE SODDED, INCLUDING FERTILIZER NUTRIENTS*, AND SUPPLEMENTAL WATERING WHICH IS TO BE USED AFTER THE INITIAL WATERING (AS SPECIFIED AND AS DIRECTED BY THE ENGINEER) AT THE RATE OF 10 GALLONS PER SQUARE YARD SODDING. SODDED SLOPES WHICH ARE 2:1 OR STEEPER SHALL BE STAKED. (PROVIDE A 3* STRIP AROUND CATCH BASINS IN SEEDED AREAS).

FERTILIZER NUTRIENTS* FOR SODDING:

USE A FERTILIZER WITH A 1:1:1 RATIO PER ACRE:

60 LBS. NITROGEN FERTILIZER NUTRIENT 60 LBS. PHOSPHORUS FERTILIZER NUTRIENT 60 LBS POTASSIUM FERTILIZER NUTRIENT

TOTAL: 180 LBS. PER ACRE

TREE REPLACEMENT:

TREE TYPE & LOCATION TO BE DETERMINED IN THE FIELD BY THE ENGINEER.

4" TOP SOIL LAYER:

SOIL SHALL BE SPREAD AS INDICATED ON THE TYPICAL CROSS SECTIONS.

SYMBOL

DESCRIPTION

PROPOSED PORTLAND CEMENT CONCRETE SIDEWALK 5 INCH

PROPOSED PAVING BRICK SIDEWALK AREA
PROPOSED PORTLAND CEMENT CONCRETE DRIVEWAY PAVEMENT, 8 INCH

PROPOSED INCIDENTAL HOT-MIX ASPHALT (SPECIAL)


PROPOSED SODDED PARKWAY
PROPOSED TREE WITH PLANTER

HANCOCK USER NAME -DESIGNED -MK REVISED - 1-5-11 IDOT FINAL DRAWN -MK/LEV REVISED - 6-28-10 IDOT PRE-FINAL PLOT SCALE CHECKED -СВ REVISED - 6-04-10 IDOT PSE Phone: 700/065-0300
Pxx: 700/065-0212 PLOT DATE -DATE -03-02-10 REVISED - 3-19-10 MWRDGC

STATE OF ILLINOIS
DEPARTMENT OF TRANSPORTATION

GRAND AVENUE STREETSCAPE STAGE II LANDSCAPING PLAN

SCALE: 1"=30' SHEET NO. 1 OF 2 SHEETS STA. TO STA.

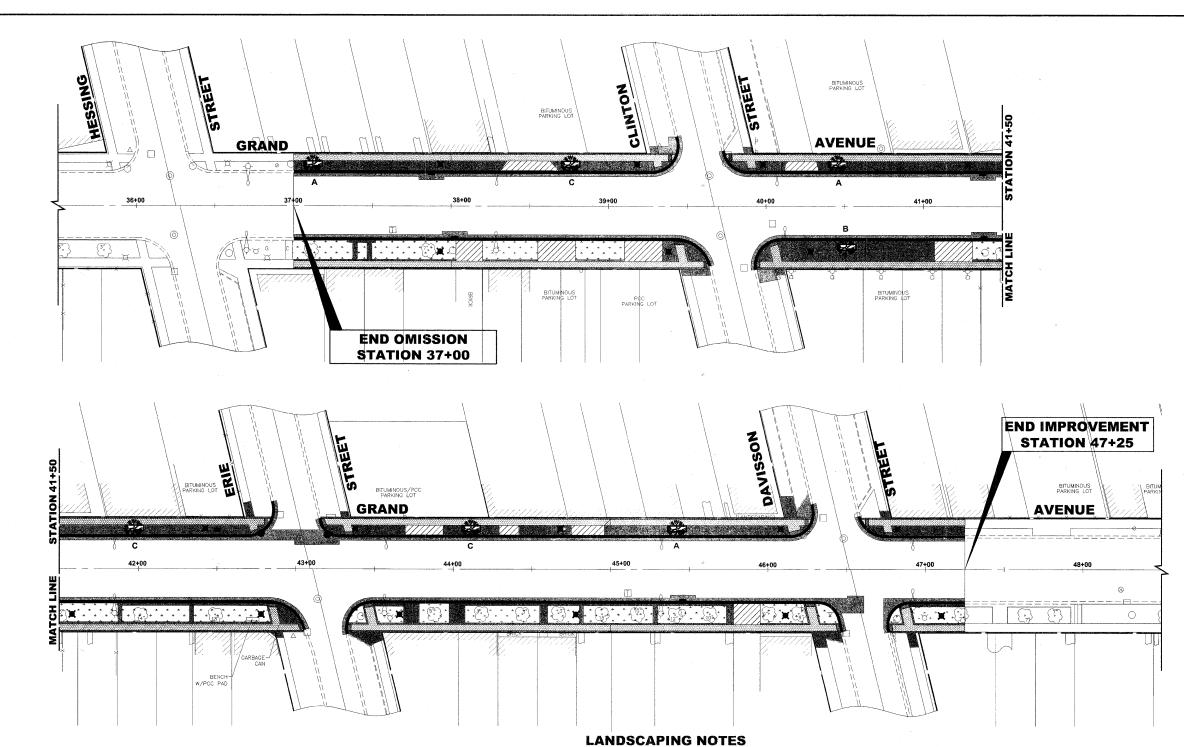

	TREE REPLACEMENT										
CODE	COMMON NAME	SCIENTIFIC NAME	SIZE	QUANTITY							
Α	CLEVELAND SELECT PEAR	PYRUS CALLERYANA	2" CALIPER	8							
В	NORWAY MAPLE	ACER PLANTANOIDES	2" CALIPER	1							
С	IVORY SILK	SYRINGA RETICULATA	2" CALIPER	6							

NOTE: ALL TREES BALLED AND BURLAPPED

SODDING:

ALL DISTURBED AREAS INDICATED ON LANDSCAPING PLANS ARE TO BE SODDED, INCLUDING FERTILIZER NUTRIENTS*, AND SUPPLEMENTAL WATERING WHICH IS TO BE USED AFTER THE INITIAL WATERING (AS SPECIFIED AND AS DIRECTED BY THE ENGINEER) AT THE RATE OF 10 GALLONS PER SOUARE YARD SODDING, SODDED SLOPES WHICH ARE 2:1 OR STEEPER SHALL BE STAKED. (PROVIDE A 3" STRIP AROUND CATCH BASINS IN SEEDED AREAS).

FERTILIZER NUTRIENTS* FOR SODDING:

USE A FERTILIZER WITH A 1:1:1 RATIO PER ACRE:

60 LBS. NITROGEN FERTILIZER NUTRIENT 60 LBS. PHOSPHORUS FERTILIZER NUTRIENT 60 LBS POTASSIUM FERTILIZER NUTRIENT

TOTAL: 180 LBS. PER ACRE

TREE REPLACEMENT:

TREE TYPE & LOCATION TO BE FINALIZED IN THE FIELD BY THE ENGINEER.

4" TOP SOIL LAYER:

SOIL SHALL BE SPREAD AS INDICATED ON THE TYPICAL CROSS SECTIONS.

LEGEND OF SYMBOLS

SYMBOL

PROPOSED PORTLAND CEMENT CONCRETE SIDEWALK 5 INCH

PROPOSED PAVING BRICK SIDEWALK AREA

PROPOSED PORTLAND CEMENT CONCRETE DRIVEWAY PAVEMENT, 8 INCH

PROPOSED INCIDENTAL HOT-MIX ASPHALT (SPECIAL)

PROPOSED SODDED PARKWAY

DESCRIPTION

PROPOSED TREE WITH PLANTER


HANCOC	NG
♦ Civil Engineers	9933 Waatchester, Hill
 Municipal Consultants 	Phor
♦ Established 1911	Fa


USER NAME DESIGNED -REVISED - 1-5-11 IDOT FINAL DRAWN -MK/LEV REVISED - 6-28-10 IDOT PRE-FINAL 33 Rosecseit Road IRIs. ./154-2780 one: 708-985-0300 Fax: 708-985-1212 PLOT DATE -PLOT SCALE -CHECKED -CB REVISED - 6-04-10 IDOT PSE DATE -03-02-10 REVISED - 3-19-10 MWRDGC

STATE OF ILLINOIS **DEPARTMENT OF TRANSPORTATION**

GRA			-			STAGE II
	L	AND	SC	APIN	G PLAN	
SCALE: 1"=30"	SHEET NO.	2 OF	2	SHEETS	STA.	TO STA.


F.A.U. RTE.	SE	CTION		COUNTY	TOTAL SHEETS	SHEE NO.
1376	10-000	95-00-SW		COOK	29	22
(FIELD	BOOK NOS. 14	41/1443/1516	5)	CONTRACT	NO. 635	11
FED. ROA	AD DIST. NO. 1	ILLINOIS	FED.	AID PROJECT	TE-00D1	(823)

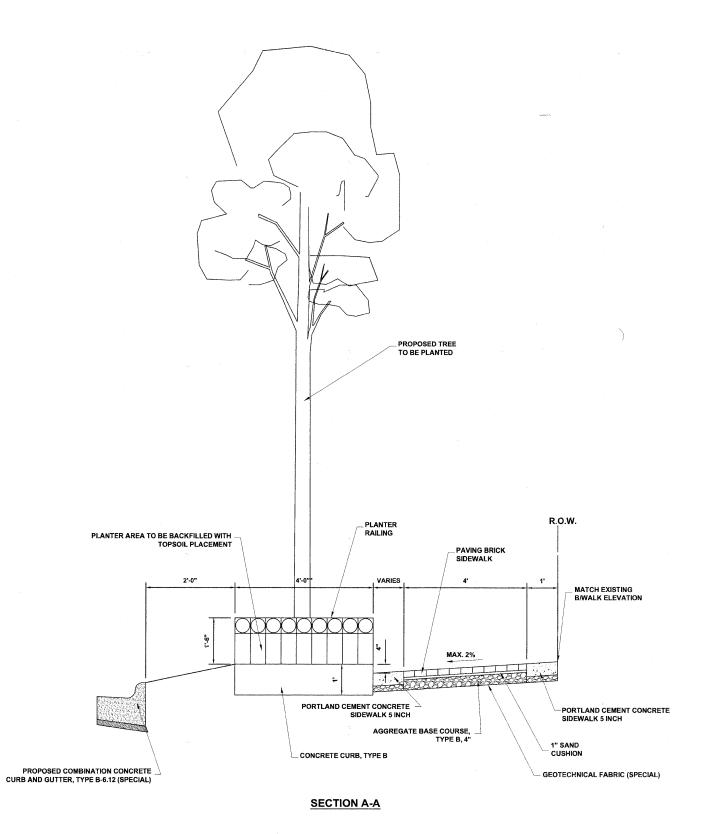

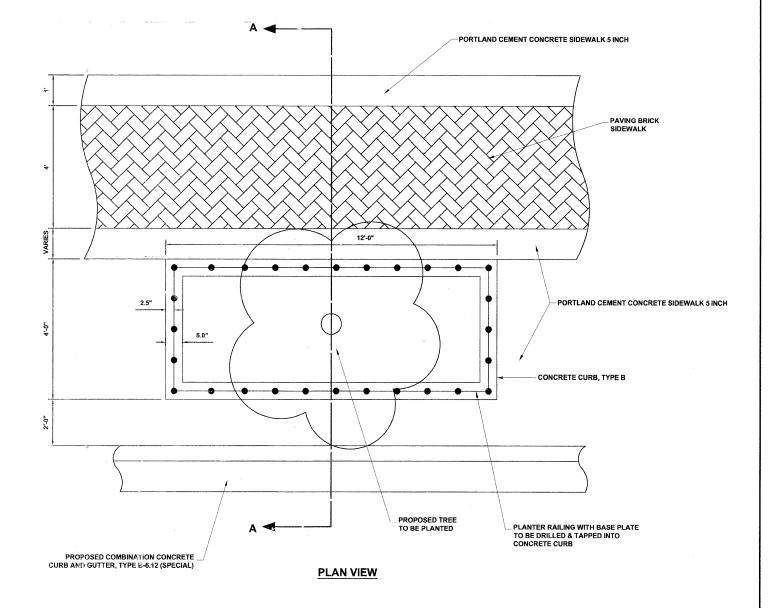

DETAIL FOR TREE WITH PLANTER

DESIGNED -REVISED - 1-5-11 IDOT FINAL SECTION **GRAND AVENUE STREETSCAPE STAGE II** STATE OF ILLINOIS DRAWN -MK/LEV REVISED - 6-28-10 IDOT PRE-FINAL LANDSCAPING DETAILS 29 23 PLOT SCALE -CHECKED -CB REVISED - 6-04-10 IDOT PSE **DEPARTMENT OF TRANSPORTATION** CONTRACT NO. 63511 (FIELD BOOK NOS. 1441/1443/1516) DATE -SCALE: NONE 03-02-10 REVISED - 3-19-10 MWRDGC SHEET NO. 1 OF 1 SHEETS STA. TO STA. FED. ROAD DIST. NO. 1 ILLINOIS FED. AID PROJECT TE-00D1(823)

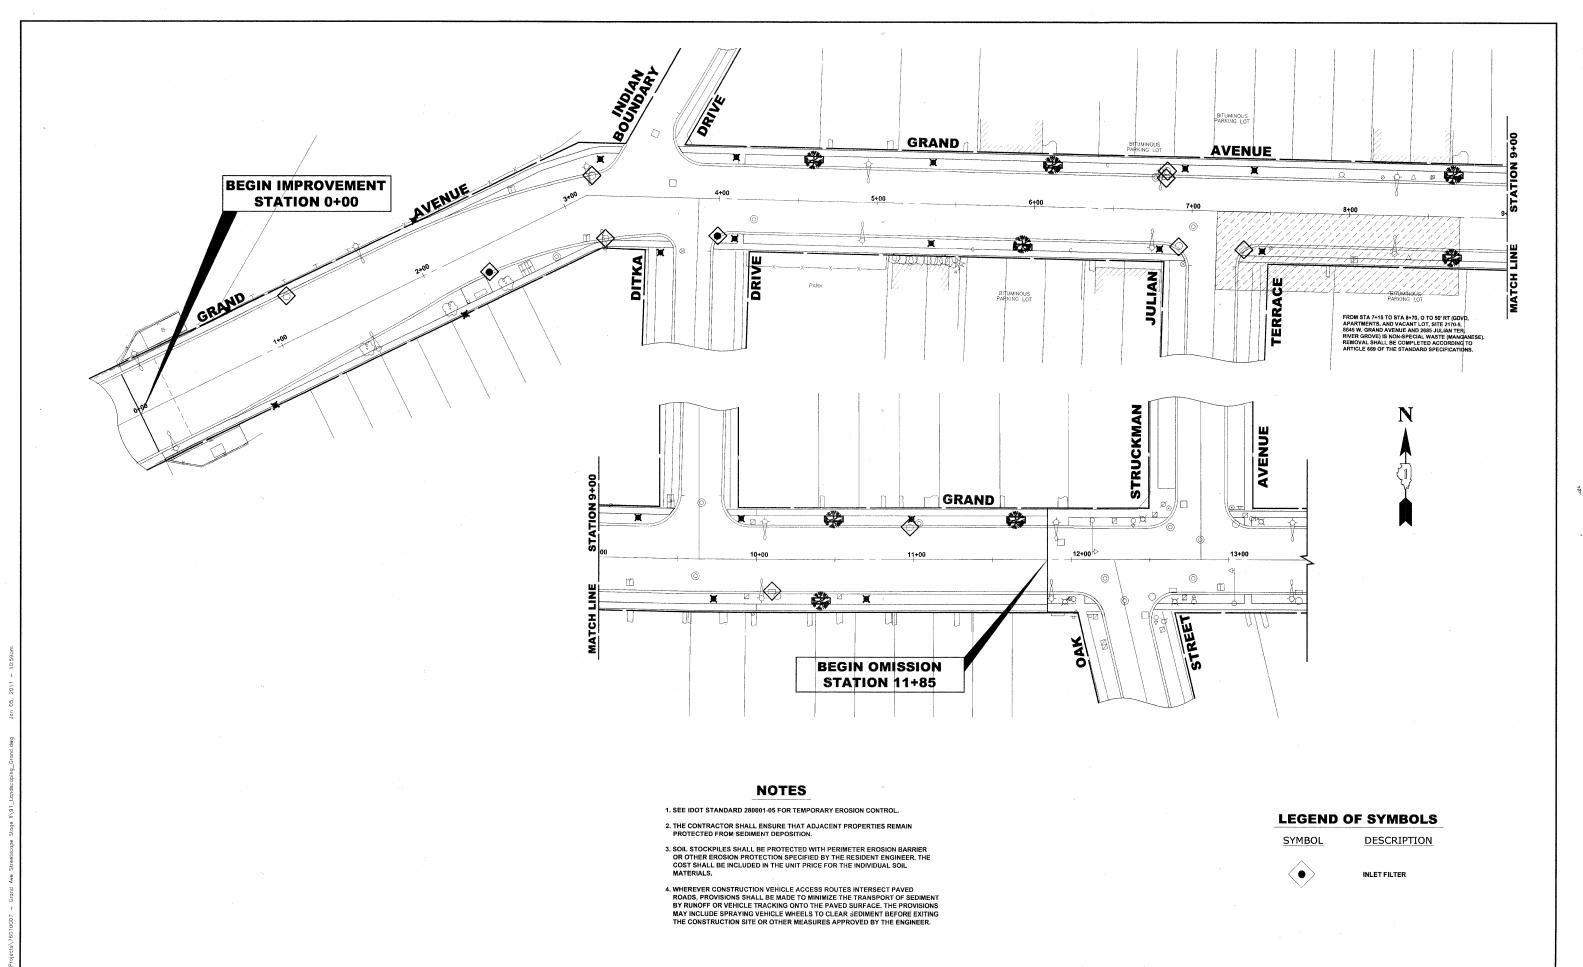

HANCOCK

DESIGNED - MK REVISED - 1-5-11 IDOT FINAL DRAWN -MK/LEV REVISED - 6-28-10 IDOT PRE-FINAL PLOT SCALE -CHECKED -CB REVISED - 6-04-10 IDOT PSE PLOT SCALE


Phone: 768:566-1212

PLOT DATE -DATE -03-02-10 REVISED - 3-19-10 MWRDGC

STATE OF ILLINOIS **DEPARTMENT OF TRANSPORTATION**

GRAND AVENUE STREETSCAPE STAGE II EROSION CONTROL PLAN SHEET NO. 1 OF 2 SHEETS STA. SCALE: 1"=30' TO STA.

SECTION TOTAL SHEET SHEETS NO. 29 24 CONTRACT NO. 63511 (FIELD BOOK NOS. 1441/1443/1516) FED. ROAD DIST. NO. 1 ILLINOIS FED. AID PROJECT TE-00D1(823)

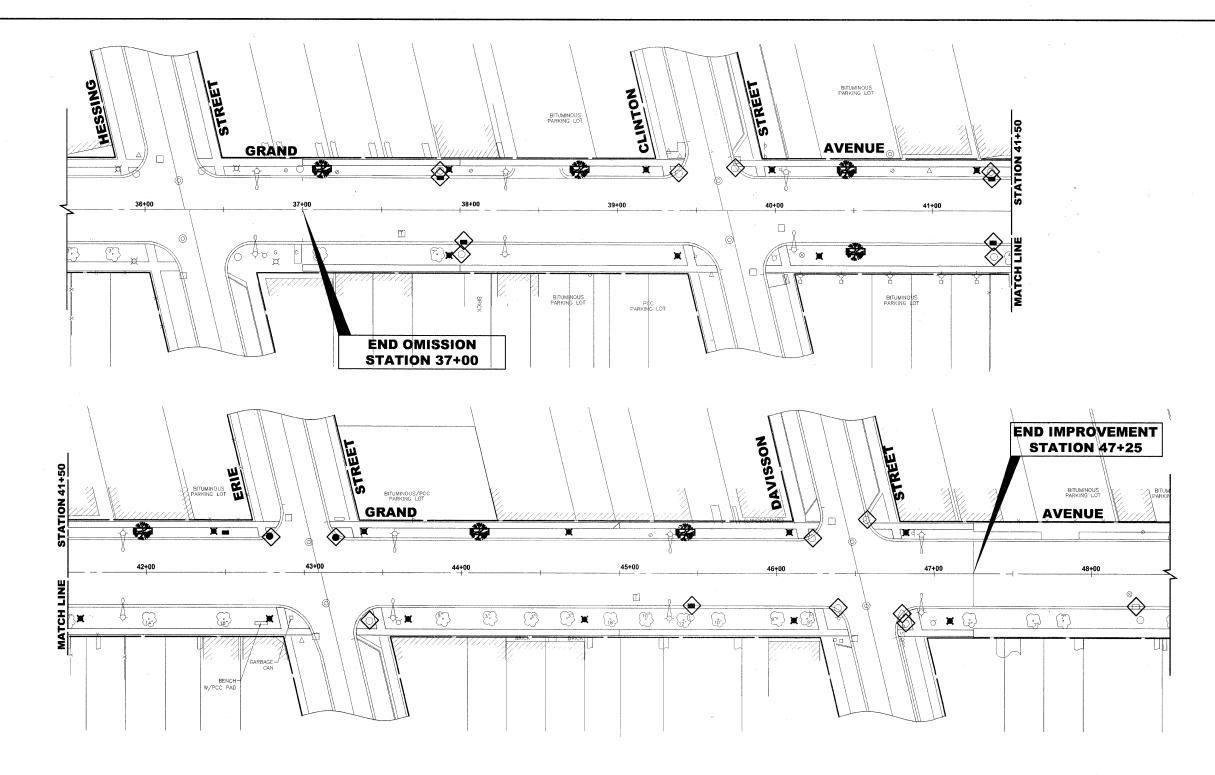

NOTES

- 1. SEE IDOT STANDARD 280001-05 FOR TEMPORARY EROSION CONTROL.
- 2. THE CONTRACTOR SHALL ENSURE THAT ADJACENT PROPERTIES REMAIN PROTECTED FROM SEDIMENT DEPOSITION.
- 3. SOIL STOCKPILES SHALL BE PROTECTED WITH PERIMETER EROSION BARRIER OR OTHER EROSION PROTECTION SPECIFIED BY THE RESIDENT ENGINEER. THE COST SHALL BE INCLUDED IN THE UNIT PRICE FOR THE INDIVIDUAL SOIL MATERIALS.
- 4. WHEREVER CONSTRUCTION VEHICLE ACCESS ROUTES INTERSECT PAVED ROADS, PROVISIONS SHALL BE MADE TO MINIMIZE THE TRANSPORT OF SEDIMENT BY RUNOFF OR VEHICLE TRACKING ONTO THE PAVED SURFACE. THE PROVISIONS MAY INCLUDE SPRAYING VEHICLE WHEELS TO CLEAR SEDIMENT BEFORE EXITING THE CONSTRUCTION SITE OR OTHER MEASURES APPROVED BY THE ENGINEER.

LEGEND OF SYMBOLS

SYMBOL

DESCRIPTION



INLET FILTER

HANCOCK ENGINEERING

PLOT SCALE -Phone: 708/065-0300 PLOT DATE -

DESIGNED - MK USER NAME -REVISED - 1-5-11 IDOT FINAL DRAWN -MK/LEV REVISED - 6-28-10 IDOT PRE-FINAL CHECKED -СВ REVISED - 6-04-10 IDOT PSE DATE -03-02-10 REVISED - 3-19-10 MWRDGC

STATE OF ILLINOIS **DEPARTMENT OF TRANSPORTATION**

GRAND AVENUE STREETSCAPE STAGE II EROSION CONTROL PLAN SCALE: 1"=30" SHEET NO. 2 OF 2 SHEETS STA. TO STA.

TOTAL SHEET NO. SECTION COUNTY соок 1376 10-00095-00-SW 29 25 (FIELD BOOK NOS. 1441/1443/1516) CONTRACT NO. 63511 FED. ROAD DIST. NO. 1 | ILLINOIS | FED. AID PROJECT | TE-90D1(823)

E.H.E PROJECT NO. 760-10-00720

* SEE TYPICAL SECTIONS FOR THICKNESS AND MATERIALS

NOTES:

- 1. THE WIDTH OF THE FULL DEPTH PATCH OVER A TRENCH SHALL BE 12 (300) WIDER ON EACH SIDE OF THE TRENCH.
- 2. FOR METHOD OF MEASUREMENT AND BASIS OF PAYMENT, SEE RECURRING SPECIAL PROVISION "PATCHING WITH HOT-MIX ASPHALT OVERLAY REMOVAL".

SEQUENCE OF CONSTRUCTION (PATCHING FIRST)

- 1. REMOVE THE EXISTING HMA MATERIAL OVER THE AREA TO BE PATCHED.
- 2. REMOVE AND REPLACE WITH CLASS C OR D PATCH.
- 3. REPLACE HMA MATERIAL OVER THE AREA TO BE PATCHED.

SEQUENCE OF CONSTRUCTION (MILLING FIRST)

- 1. MILL HMA FIRST IF THERE IS AT LEAST 41/2 INCHES OR MORE OF HMA MATERIAL ON TOP OF THE EXISTING PAVEMENT OR IF THE PAVEMENT IS FULL DEPTH HMA. A MINIMUM OF 2 INCHES OF HMA MATERIAL SHALL BE IN PLACE AFTER MILLING.
- 2. REMOVE AND REPLACE WITH FULL DEPTH CLASS D PATCHES TO TOP OF MILLED SURFACE.

ALL DIMENSIONS ARE IN INCHES (MILLIMETERS) UNLESS OTHERWISE SHOWN.

FILE NAME = USER NAME = beverel DESIGNED - R. SHAH REVISED - A. ABBAS 04-27-98 PAVEMENT PATCHING FOR DRAWN STATE OF ILLINOIS REVISED - R. BORD D1-01-07 1376 10-00095-00-SW HMA SURFACED PAVEMENT PLOT SCALE = 58.000 '/ IN. CHECKED REVISED - R. BORO 09-04-07 **DEPARTMENT OF TRANSPORTATION** BD400-04 (BD-22) CONTRACT NO. 63511 PLOT DATE = 18/27/2008 DATE - 10-25-94 REVISED - K. ENG 10-27-08 SCALE: NONE SHEET NO. 1 OF 1 SHEETS STA.

s\78010007 = Grand Ave Streetscope Stage I\93.IDOT_MARKINGS.dwg Aug 17. 2010 =

CONSTRUCTION AHEAD

NOTES:

- A. FOR NO LANE RESTRICTION ON THE SIDE ROAD OR DRIVEWAYS
- 1. SIDE ROAD WITH A SPEED LIMIT OF 40 MPH (50 km/h) OR LESS AS SHOWN ON THE DRAWING AND AS DIRECTED BY THE ENGINEER:
- Q) ONE NOAD CONSTRUCTION AMEAD SIGN 36 x 36 (900x900) WITH A FLASHER AND FLAG MOUNTED ON IT APPROXIMATELY 200' (60 m) IN ADVANCE OF THE MAIN ROUTE.
- b) THE CLOSED PORTION OF THE MAIN ROUTE SHALL BE PROTECTED BY BLOCKING WITH TYPE I, TYPE II OR TYPE III BARRICADES, 1/3 OF THE CROSS SECTION OF THE CLOSED PORTION.
- SIDE ROAD WITH A SPEED LIMIT GREATER THAN 40 MPH (60 km/h) AS SHOWN ON THE DRAWING AND AS DIRECTED BY THE ENGINEER:
- d) ONE ROAD CONSTRUCTION AHEAD SIGN 48×48 (1.2 m \times 1.2 m) WITH A FLASHER MOUNTED ON IT APPROXIMATELY 500' (150 m) IN ADVANCE OF THE MAIN ROUTE.
- b) THE CLOSED PORTION OF THE MAIN ROUTE SHALL BE PROTECTED BY BLOCKING WITH TYPE III BARRICADES, 1/2 OF THE CROSS SECTION OF THE CLOSED PORTION.
- 3. WHEN THE SIDE ROAD LIES BETWEEN THE BEGINNING OF THE MAINLINE SIGNING AND THE WORK ZONE, A SINGLE HEADED ARROW (MG-1) SHALL BE USED IN LIEU OF THE DOUBLE HEADED ARROW (MG-4).

- B. FOR A LANE CLOSURE ON A SIDE ROAD OR DRIVEWAY:
- USE APPLICABLE PORTIONS OF THE TYPICAL APPLICATION OF TRAFFIC CONTROL DEVICES (STD. 701501, STD. 701605 OR THE APPROPRIATE STANDARD). THE SPACING OF SIGNS AND BARRICADES SHALL BE ADJUSTED FOR FIELD CONDITIONS AS DIRECTED BY THE ENGINEER. THE DIRECTIONAL ARROW SHALL BE COVERED OR REMOVED WHEN NO LONGER CONSISTENT WITH THE SIDE ROAD LANE CLOSURE.
- C. ADVANCE WARNING SIGNS ARE TO BE OMITTED ON DRIVEWAY LINLESS OTHERWISE NOTED.
- D. THE TRAFFIC CONTROL AND PROTECTION FOR SIDE ROADS, INTERSECTIONS, AND DRIVEWAYS SHALL BE INCIDENTAL TO THE COST OF SPECIFIED TRAFFIC CONTROL STANDARDS OR ITEMS.


All dimensions are in millimaters (inches)

FILE NAME = USER NAME = geglianobit DESIGNED - LHA REVISED - J. OBERLE 10-18-95
Wildstatid/22k34\to18.dgn
DRAWN - REVISED - A. HOUSEH 03-06-96
PLOT SCALE = 68.000 '/ IN. CHECKED - REVISED - A. HOUSEH 10-15-96
PLOT DATE = 1/4/2008 DATE - 06-89 REVISED -T. RAMMACHER 01-06-00

STATE OF ILLINOIS
DEPARTMENT OF TRANSPORTATION

TRAFFIC CONTROL AND PROTECTION FOR
SIDE ROADS, INTERSECTIONS, AND DRIVEWAYS


SHEET NO. 1 OF 1 SHEETS STA. TO STA.

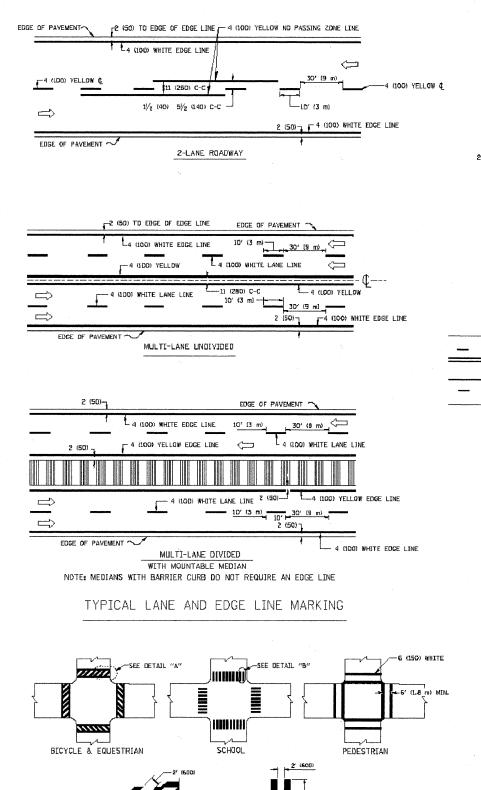


TYPICAL CROSSWALK MARKING

-6 (15D) WHITE


DETAIL "A"

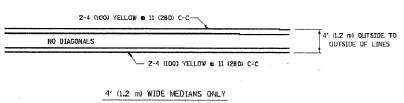

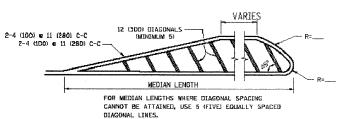


DIAGONAL LINE SPACING: 50' (15 m) C-C (LESS THAN 30MPH (50 km/h))
75' (25 m) C-C 30MPH (50 km/h) TO 45MPH (70 km/h))
150' (45 m) C-C (MORE THAN 45MPH (TD-km/h))

MEDIANS OVER 4' (1.2 m) WIDE

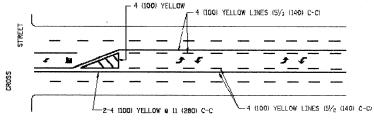


A MINIMUM OF TWO PAIRS OF TURN ARROWS SHALL BE USED, WHITE IN COLOR. ADDITIONAL PAIRS SHALL BE PLACED AT 200' (60 m) TO 300' (90 m) INTERVALS.

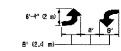

MEDIAN WITH TWO-WAY LEFT TURN LANE

TYPICAL PAINTED MEDIAN MARKING

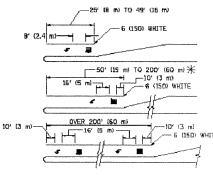



FULL SIZE LETTERS 8' (2.4 m) AND ARROWS SHALL BE USED. \P AREA = 16.6 SQ. FT. (1.5 m²)

** TURN LANES IN EXCESS OF 400' 0.20 m) IN LENGTH MAY HAVE AN ADDITIONAL SET OF ARROW - "ONLY" INSTALLED MIDWAY BETWEEN THE OTHER TWD SETS OF ARROW - "ONLY".

TYPICAL LEFT (OR RIGHT) TURN LANE

TYPICAL TURN LANE MARKING

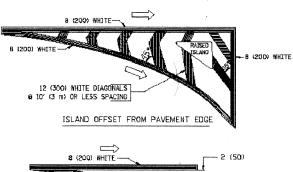

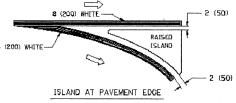

TYPICAL ISLAND MARKING

		*	_	
TYPE OF MARKING	WIDTH OF LINE	PATTERN	COLOR	SPACING / REMARKS
CENTERLINE ON 2 LANE PAVEMENT	4 (100)	SKIP-DASH	YELLOW	3D' (3 m) LINE WITH 30' (9 m) SPACE
CENTERLINE ON MULTI-LANE UNDIVIDED PAVEMENT	2 @ 4 (100)	SOLID	YELLOW	11 (280) C-C
NO PASSING ZONE LINES: FOR ONE DIRECTION FOR BOTH DIRECTIONS	4 (100) 2 @ 4 (100)	SOLID SOLID	YELLOW YELLOW	5½ (140) C-C FROM SKIP-DASH CENTERLINE 11 (280) C-C OMIT SKIP-DASH CENTERLINE BETWEEN
LANE LINES	4 (100) 5 (125) ON FREEWAYS	SKIP-DASH SKIP-DASH	WHITE WHITE	10' (3 m) LINE WITH 30' (9 m) SPACE
DOTTED LINES (EXTENSIONS OF CENTER, LANE OR TURN LANE MARKINGS)	SAME AS LINE BEING EXTENDED	SKIP-DASH	SAME AS LINE BEING EXTENDED	2' (600) LINE WITH 6' (L8 m) SPACE
EDGE LINES	4 (100)	SOLID	YELLOW-LEFT WHITE-RIGHT	OUTLINE MOUNTABLE MEDIANS IN YELLOW, EDGE LINES ARE NOT USED NEXT TO BARRIER CURB
TURN LANE MARKINGS	6 (150) LINE, FULL SIZE LETTERS & SYMBOLS (B' (2.4m))	SOLIO	WHITE	SEE TYPICAL TURN LAME MARKING DETAIL
TWO WAY LEFT TURN MARKING	2 oz 4 (100) EACH DIRECTION	SKIP-DASH AND SOLID	YELLOW	10' (3 m) LINE WITH 30' (9 m) SPACE FOR SKIP-DASH; 5½ (140) C-C BETWEEN SOLID LINE AND SKIP-DASH LINE
	8' (2.4m) LEFT ARROW	IN PAIRS	WHITE	SEE TYPICAL TWO-WAY LEFT TURN MARKING DETAIL
CROSSWALK LINES (PEDESTRIAN) A. DIAGONALS IBIKE & EQUESTRIAN) B. LONGITUDINAL BARS (SCHOOL)	2 a 5 (150) 12 (300) a 45° 12 (300) a 90°	SOLID SOLID SOLID	WHITE WHITE WHITE	NOT LESS THAN 6' (L8 m) APART 2' (500) APART 2' (500) APART SEE TYPICAL DROSSWALK MARKING DETAILS.
STOP LINES	24 (600)	SOLIO	WHITE	PLACE 4" IL2 ml IN ADVANCE OF AND PARALLEL TO ERDSSMALL, IF PRESENT OTHERWISE, PLACE AT DESIRED STOPPING POINT. PARALLEL TO CROSSROAD CENTERLINE, WHERE POSSIBLE
PAINTED MEDIANS	2 & 4 (100) WITH 12 (300) DIAGONALS	SOLID	YELLOW: TWO WAY TRAFFIC	11 (280) C-C FOR THE DOUBLE LINE
	ND DIAGONALS USED FOR 4' (1.2 m) WIDE MEDIANS		WHITE: DNE WAY TRAFFIC	SEE TYPICAL PAINTED MEDIAN MARKING.
CORE MARKING AND CHANNELIZING LINES	B (20D) WITH 12 (30D) DIAGONALS & 45°	SOLID	WHITE	DIACDNALS: 15' (4.5 m) C-C (LESS THAN 30MPH (50 km/h)) 20' (6 m) C-C 30MPH (50 km/h) TO 45MPH (70 km/h)) 30' (9 m) C-C (DVER 45MPH (70 km/h))
RAILFOAD CROSSING	24 (600) TRANSVERSE LINES, "RR" IS 5' (1.8 ml LETTERS; 16 (400) LINE FOR "X"	SOLID	WHITE	SEE STATE STANDARD 7BOUGL AREA OF- "R"=3.6 SQ. FT. (0.33 m²) EACH "X"=54.0 SQ. FT. (5.0 m²)
SHOULDER DIAGONALS	12 (300) e 45°	SOLID	WHITE - RIGHT YELLOW - LEFT	50' (15 m) C-C (LESS THAN 30MPH (50 km/h)) 75' (25 m) C-C (30 MPH (50 km/h) TO 45MPH (70 km/h)) 15D' (45 m) C-C (0VER 45MPH (70 km/h))

FOR FURTHER DETAILS ON PAVEMENT MARKING REFER TO STANDARD SPECIFICATIONS FOR ROAD AND BRIDGE CONSTRUCTION AND STATE STANDARD 780001.


All dimensions are in inches imilimeters) unless otherwise shown.

	*,						
FILE NAME =	USER NAME = drzyakoego	DESIGNED	-	EVERS	REVISED	-T. RAMMACHER	10-27-94
ai\pw_work\pwidat\drivakaagn\d@188315\ta	3.dgn	DRAWN	_		REVISED	-C. JUCIUS	09-09-09
	PLOT SCALE = 60.000 '/ IN.	CHECKED	-		REVISED	-	
	PLOT DATE = 9/9/2009	DATE		03-19-90	REVISED	-	

DETAIL "B"

STATE OF ILLINOIS
DEPARTMENT OF TRANSPORTATION

DISTRICT ONE					F.A.U. RTE.	SECTION	COUNTY	SHEE NO.		
TYPICAL PAVEMENT MARKINGS						1376	10-00095-00-SW	соок	29	28
							TC-13	CONTRACT	NO.	63511
SCALE: NONE	SHEET NO. 1	OF 1	SHEETS	STA.	TO STA.	FEO. RC	DAD DIST. NO. 1 ILLINOIS FED. A	ID PROJECT	TE-00D1((823)

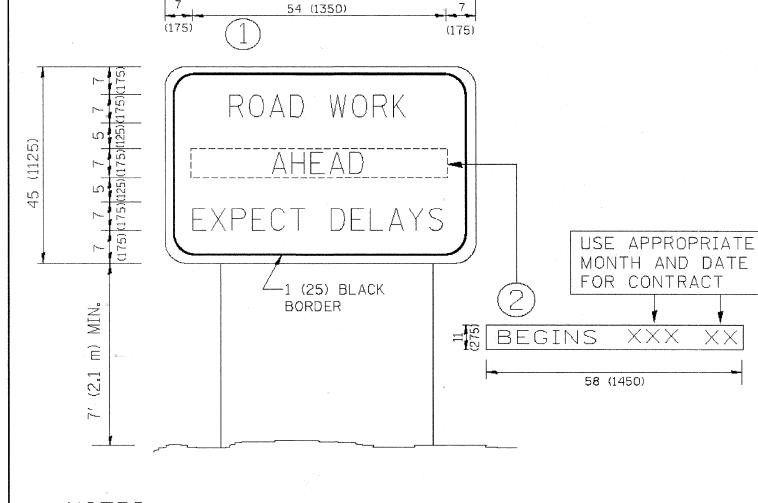

68 (1700)

<u>NOTES:</u>

- 1. USE BLACK LETTERING ON ORANGE BACKGROUND.
- 2. ERECT SIGNS IN ADVANCE OF THE LOCATION FOR THE "ROAD CONSTRUCTION AHEAD" SIGN AT LOCATIONS AS DIRECTED BY THE ENGINEER.
- 3. ERECT SIGN (1) WITH INSTALLED PANEL (2) ONE WEEK PRIOR TO THE START OF CONSTRUCTION.
- 4. REMOVE PANEL 2 SOON AFTER THE START OF CONSTRUCTION.
- 5. SEE SPECIAL PROVISION FOR "TEMPORARY INFORMATION SIGNING" FOR ADDITIONAL INFORMATION.
- 6. ONE SIGN ASSEMBLY EQUALS 25.70 SQ. FT. (2.3 SQ. M.)
- 7. SHALL BE PAID FOR AS TEMPORARY INFORMATION SIGNING.

ALL DIMENSIONS ARE IN INCHES (MILLIMETERS) UNLESS OTHERWISE SHOWN.

}	FILE NAME =	USER NAME = geglienobt	DESIGNED -	REVISED -	R. MIRS 09-15-97					F.A.	SECTION	COUNTY	TOTAL SI	EET		
igi E	Wi\daetatd\22x34\ta22.dgn		DRAWN -	REVISED -	R. MIRS 12-11-97	STATE OF ILLINOIS	ARTERIAL ROAD			1376	10-00095-00-SW	соок	SHEETS NO.	29		
Sime		PLOT SCALE = 50.000 '/ IN.	CHECKED -	REVISED -	T. RAMMACHER 02-02-99	DEPARTMENT OF TRANSPORTATION	REFORMATION SIGN				TG-22	CONTRACT	T NO. 635	311		
5		PLOT DATE = 1/4/2008	DATE -	REVISED -	C. JUCIUS 01-31-07		SCALE: NOONE	SHEET NO. 1	1 1 OF 1 1 SHEETS	STA.	TO STA.	FEO. ROA	AD DIST. NO. 1 ILLINOIS FED.	AID PROJECT	TE-00D1(823	