



NOTE: SEE STORM SEWER OUTFALL CONSTRUCTION SEQUENCE ON EROSION CONTROL & SEDIMENT PLANS.

DATE	
BY	
PLAN	
NO.	
DATE	
BY	
PROFILE	
NO.	
DATE	
BY	

DATE	
BY	
PROFILE	
NO.	
DATE	
BY	

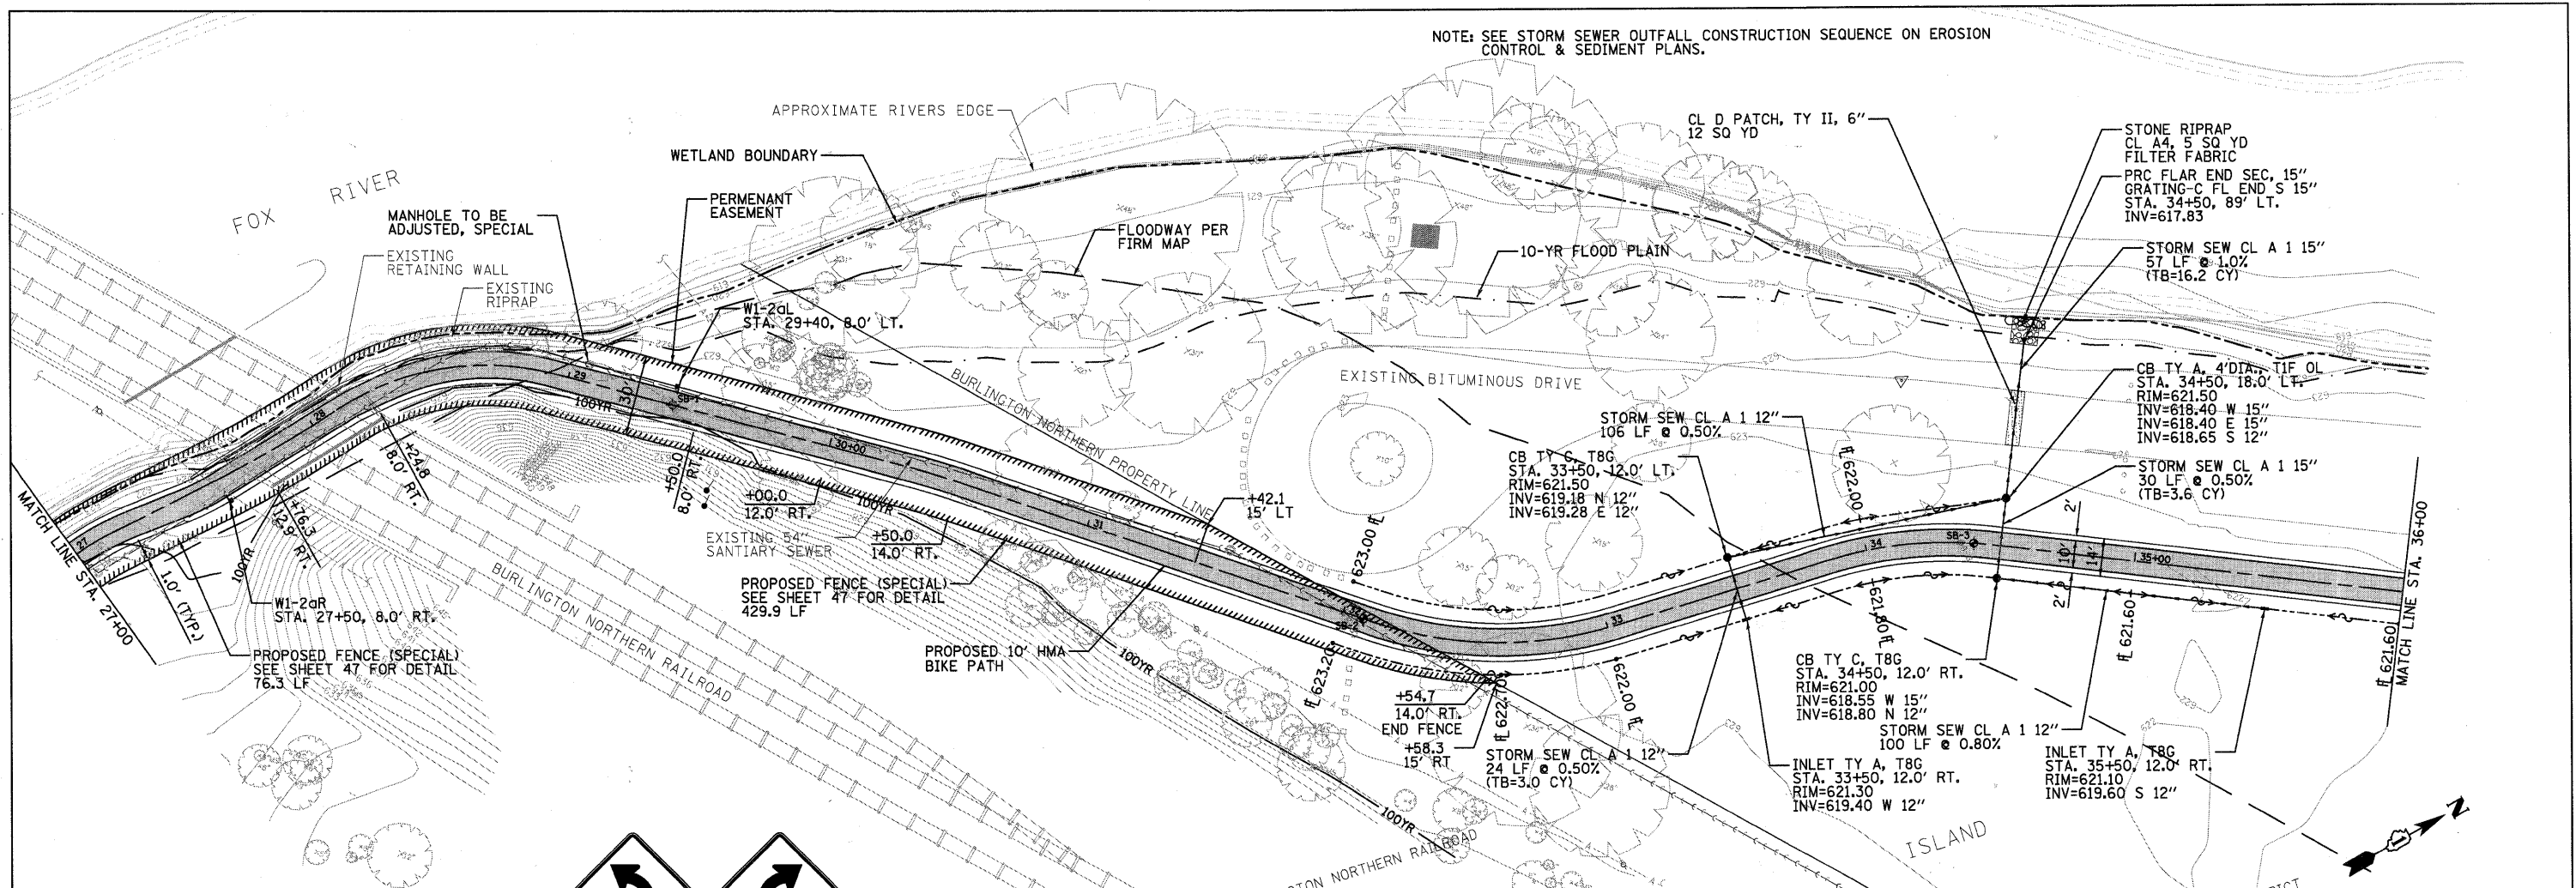

◌ PROP. CURVE 16
PI STA = 26+96.38
Δ = 32° 40' 05" (RT)
D = 57' 11" 45"
R = 100.00'
T = 29.31'
L = 57.02'
E = 4.21'
P.C. STA = 26+67.07
P.T. STA = 27+24.09


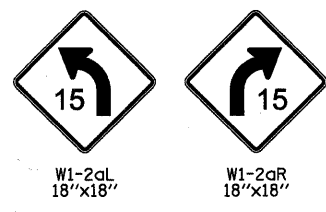


◌ PROP. CURVE 17
PI STA = 28+62.95
Δ = 39° 52' 50" (RT)
D = 63' 39' 43"
R = 90.00'
T = 32.65'
L = 62.64'
E = 5.74'
P.C. STA = 28+30.30
P.T. STA = 28+92.95

◌ PROP. CURVE 18
PI STA = 30+42.03
Δ = 4° 02' 22" (RT)
D = 19' 05' 55"
R = 300.00'
T = 10.58'
L = 21.15'
E = 0.19'
P.C. STA = 30+31.45
P.T. STA = 30+52.60

◌ PROP. CURVE 19
PI STA = 32+59.04
Δ = 35° 30' 57" (LT)
D = 38' 11' 50"
R = 150.00'
T = 48.04'
L = 92.98'
E = 7.50'
P.C. STA = 32+11.00
P.T. STA = 33+03.98

◌ PROP. CURVE 20
PI STA = 34+16.88
Δ = 23° 29' 42" (RT)
D = 38' 11' 50"
R = 150.00'
T = 31.19'
L = 61.51'
E = 3.21'
P.C. STA = 33+85.69
P.T. STA = 34+47.20

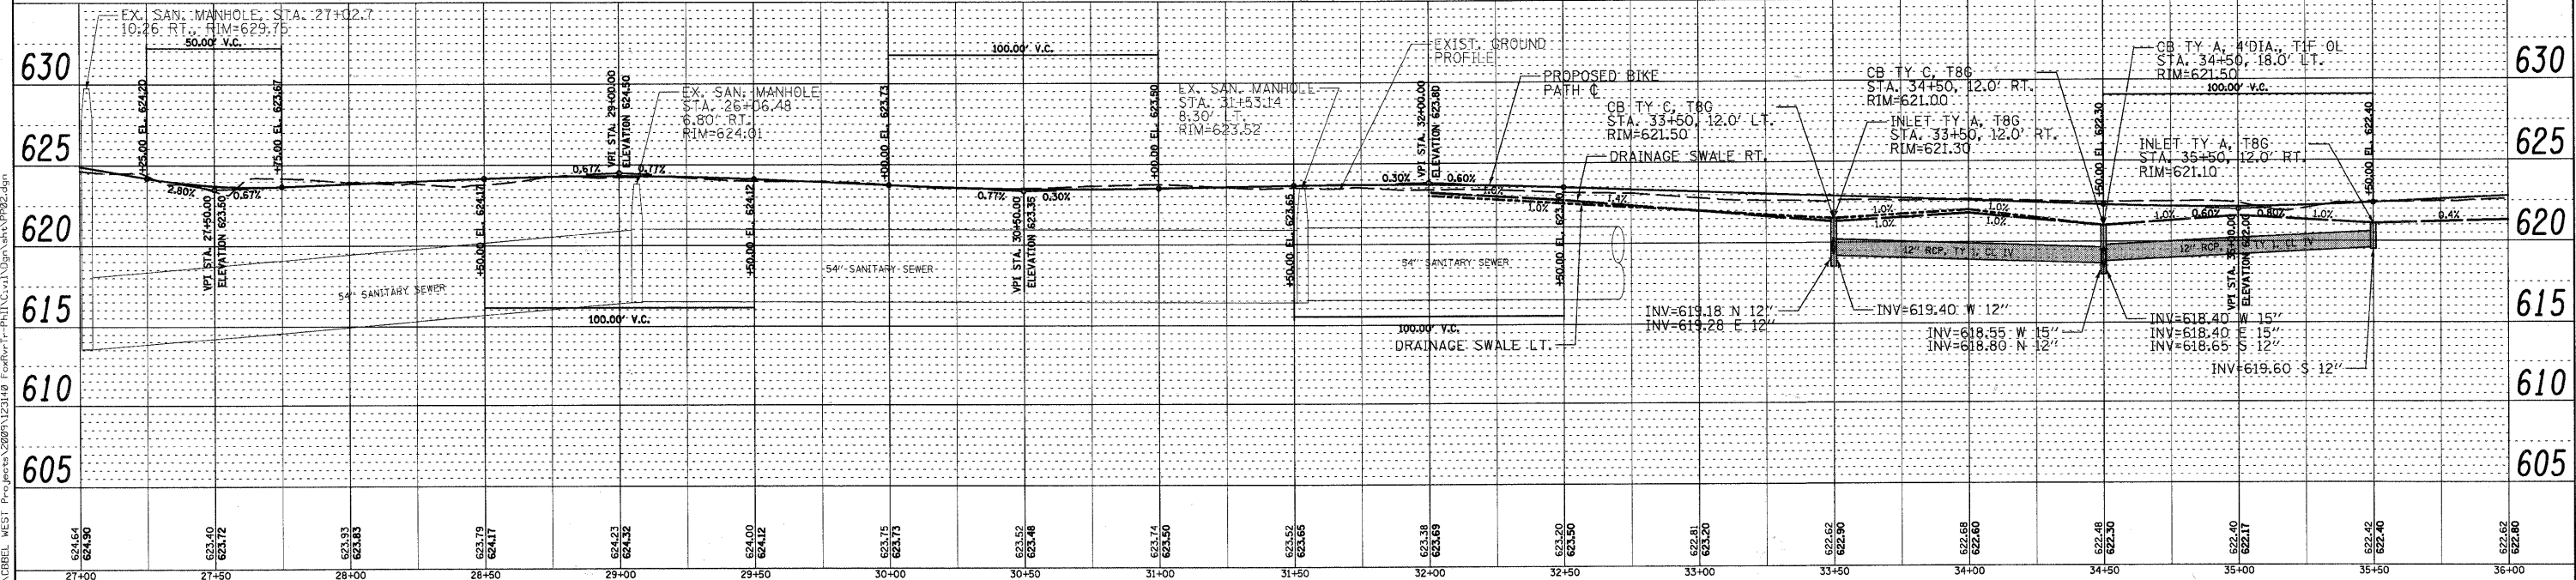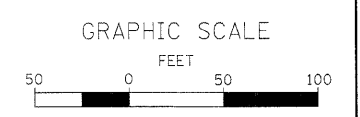

624.64 624.90	623.40 624.72	623.93 624.83	623.79 624.17	624.23 624.52	624.00 624.12	623.75 624.73	623.52 624.46	623.74 624.50	623.52 624.66	623.38 624.69	623.20 624.50	623.81 624.20	622.62 622.90	622.68 622.60	622.48 622.50	622.40 622.17	622.42 622.40	622.62 622.60
27+00	27+50	28+00	28+50	29+00	29+50	30+00	30+50	31+00	31+50	32+00	32+50	33+00	33+50	34+00	34+50	35+00	35+50	36+00

WILLS BURKE KELSEY ASSOCIATES LTD.
119 West Main Street, Suite 201
St. Charles, Illinois 60174
(630) 443-7785

USER NAME = #USER#	DESIGNED - DB	REVISED - 10/5/10
PLLOT SCALE = AS SHOWN	DRAWN - NP	REVISED -
PLLOT DATE = 12/20/10	CHECKED - DB	REVISED -
	DATE - 12/20/10	REVISED -

STATE OF ILLINOIS
DEPARTMENT OF TRANSPORTATION

PLAN & PROFILE

SCALE: AS SHOWN SHEET NO. 14 OF 58 SHEETS STA. 27+00 TO STA. 36+00

F.A. RTE.	SECTION	COUNTY	TOTAL SHEETS	SHEET NO.
	05-F3000-06-BT	KANE	58	14
CONTRACT NO. 63517				
FED. ROAD DIST. NO. ILLINOIS FED. AID PROJECT				