
ST. CLAIR COUNTY, ILLINOIS **CONSTRUCTION PLANS** FOR

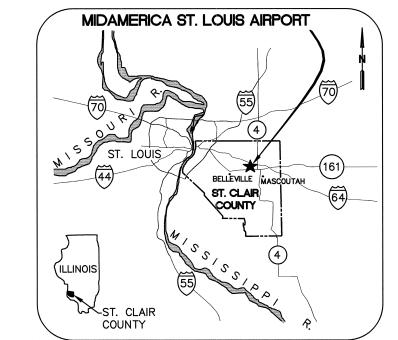


ILLINOIS PROJECT BLV - 4061 A. I. P. PROJECT 3-17-0146-XX

MIKE APRON EXPANSION - CONTRACT 1

JANUARY 14, 2011





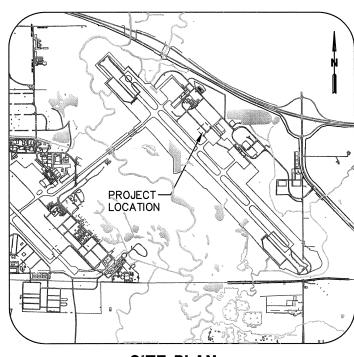

SITE PLAN

SC066 TOTAL SHEETS: 53

INDEX TO SHEETS

- 1. COVER SHEET
- SUMMARY OF QUANTITIES
- SITE PLAN
- CONSTRUCTION ACTIVITY PLAN
- DEMOLITION PLAN
- PROPOSED IMPROVEMENTS
- TYPICAL SECTIONS
- SERVICE ROAD PLAN AND PROFILE
- STAKING PLAN
- 10. JOINTING PLAN
- 11 JOINTING DETAILS
- 12. GRADING AND DRAINAGE PLAN
- 13. DRAINAGE DETAILS 1
- 14. DRAINAGE DETAILS 2
- 15. DRAINAGE DETAILS 3
- 16. TRENCH DRAIN DETAILS
- 17. UNDERDRAIN PROFILES
- 18. STORM SEWER PROFILES
- 19. GLYCOL COLLECTION DETAILS 1 20. GLYCOL CONTROL DETAILS 1
- 21. EROSION CONTROL PLAN PHASE 1
- 22. EROSION CONTROL PLAN PHASE 2
- 23. EROSION CONTROL DETAILS 1
- 24. EROSION CONTROL DETAILS 2
- 25. PAVEMENT MARKING PLAN
- 26. NOSE GEAR TETHER DETAIL 1 27. NOSE GEAR TETHER DETAIL 2
- 28. ELECTRICAL LAYOUT PLAN
- 29. ELECTRICAL DETAILS 1
- 30. ELECTRICAL DETAILS 2
- 31. ELECTRICAL DETAILS 3
- 32. ELECTRICAL DETAILS 4
- 33. FUMIGATION BLDG PLAN
- 34. EARTHWORK DISPOSAL AREA
- 35. INDEX TO CROSS SECTIONS
- 36-53. MIKE APRON EXPANSION CROSS

SECTIONS

1/14/11

062-058921 LICENSED PROFESSIONAL ENGINEER

Exp. 11/30/11

Brian W. Jaki





CRAWFORD MURPHY & TILLY, INC. CONSULTING ENGINEERS

- AURORA, IL CHICAGO, IL COLUMBUS, OH
- EDWARDSVILLE, IL INDIANAPOLIS, IN PEORIA, IL
- ROCKFORD, IL SPRINGFIELD, IL ST. LOUIS, MC

SUBMITTED BY Brian W. Sakie

CMT JOB NUMBER 10098-01



elow. JOINT UTILITY LOCATING re you dig. INFORMATION FOR EXCAVATORS www.illinois1call.com

HE LOCATION, SIZE AND TYPE OF MATERIAL OF EXISTING UNDERGROUND UTILITIES COMPANIES DEFINED INFORMATION AND ASSISTANCE RELATIVE TO THE ON OF THEIR FACILITIES AND THE WORKING SCHEDULE OF THE COMPANIE MOVAL OR ADJUSTMENT WHERE REDURED. IN THE EVENT AND UNEXPECT INTERFRENCE IS ENCOUNTERED DURING CONSTRUCTION. THACTOR SHALL IMMEDIATELY NOTIFY THE UTILITY COMPANY OF JURISDICTION OF THE ONE CALL NOTICE SYSTEM THE ENGINEER SHALL ASSO BE IMMEDIATELD. ANY SUCH UTILY OR SERVICES SHALL BE RESTORED TO SERVICE AND PAID FOR IT THE CONTRACTOR AT NO ADDITIONAL COST TO THAIR PRINCIPLE OF THE CONTRACTOR AT NO ADDITIONAL COST TO THE


CALL J.U.L.I.E. FOR UTILITY INFORMATION AT 811.

CALL J.U.L.I.E. BEFORE EXCAVATING 1-800-892-0123

ST. CLAIR COUNTY MASCOUTAH TOWNSHIP

TOWNSHIP: 1 NORTH TOWNSHIP: 1 NORTH RANGE: 6 WEST

RANGE: 7 WEST SECTION(S): 1, 12 SECTION(S): 7

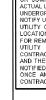

ITEM	DESCRIPTION	UNIT	QUANTITY
AR108108	1/C #8 5 KV UG CABLE	LF	976
AR108602	3/C #2 600 V UG CABLE	LF	332
	3/C #6 600 V UG CABLE	LF	64
	1/C #6 COUNTERPOISE	LF	1,014
	2" PVC DUCT, DIRECT BURY	LF	674
	1-WAY CONC. ENCASED DUCT	LF	305
	2-WAY CONCRETE ENCASED DUCT	LF	295
	3-WAY CONCRETE ENCASED DUCT	LF	38
	ELECTRICAL HANDHOLE	EA	2
	MITL-BASE MOUNTED	EA	4
	SPLICE CAN	EA	1
	RELOCATE BASE MOUNTED LIGHT	EA	3
	ENGINEER'S FIELD OFFICE	LS	1
	MOBILIZATION	LS	1
	UNCLASSIFIED EXCAVATION	CY	8,640
	BY-PRODUCT LIME	TON	381
	SOIL PROCESSING-12"	SY	15,108
	SILT FENCE	LF	1,500
	DITCH CHECK	EA	6
	EROSION CONTROL BLANKET	SY	2,310
	CRUSHED AGG. BASE COURSE- 9"	SY	16,355
	CRUSHED AGGREGATE BASE COURSE- 11"	SY	469
	ASPHALT TREATED PERMEABLE SUBBASE	SY	14,621
	ATPS TEST SECTION	EA	1
	BITUMINOUS SURFACE COURSE	TON	220
	BITUMINOUS PAVEMENT MILLING	SY	2,317
	BITUMINOUS BASE COURSE	TON	220
	9" PCC PAVEMENT	SY	1,000
	16" PCC PAVEMENT	SY	13,333
	PCC TEST BATCH	EA	1
	BITUMINOUS PRIME COAT	GAL	6,309
	BITUMINOUS TACK COAT	GAL	239
	PAVEMENT MARKING-WATERBORNE	SF	1,433
	PAVEMENT MARKING-BLACK BORDER	SF	1,883
	24" RCP, CLASS IV	LF	559
	30" RCP, CLASS IV	LF	415
	REMOVE PIPE	LF	68
	6" PERFORATED UNDERDRAIN W/SOCK	LF	1,578
	UNDERDRAIN COLLECTION STRUCTURE	EA	8
	UNDERDRAIN CLEANOUT	EA	8
	MANHOLE 4'	EA	2
	PRECAST REINFORCED CONC. FES 24"	EA	2
	PRECAST REINFORCED CONC. FES 30"	EA	1
	REMOVE END SECTION	EA	2
	8" SANITARY SEWER	LF	132
	15" SANITARY SEWER	LF	341
	SANITARY MANHOLE 4'	EA	1
	4' X 20' TRENCH DRAIN	EA	1
	8" VALVE & ACTUATOR	EA	1
	CONTROL SWITCHES	LS	1
	REMOVE FUMIGATION FACILITY	LS	1
	REINSTALL FUMIGATION FACILITY	LS	1
	AIRCRAFT NOSE TETHER ANCHOR	EA	2
	TYPE TC - 2-#12, 1-#12 GND, 600V	LF	495
	TYPE TC - 7-#14, 600V	LF	495
AR901510		AC	7.1
AR904510	SODDING	SY	500
ΔR908510	MULCHING	AC	7.1

REVISIONS		
NUMBER	BY	DATE
0	1	2

CONTRACT

APRON EXPANSION

MIKE

IL PROJECT; BLV-4061 AIP PROJ; 3-17-0146-XX

THIS BAR IS EQUAL TO 2" AT FULL SCALE (34X22). PLOT 1

ST. LOUIS AIRPORT COUNTY, ILLINOIS MIDAMERICA ST. CLAIR

CRAWFORD, MURPHY & TILLY, IN CONSULTING ENGINEERS





FILE: 02_QUANTITIES.dwg DESIGN BY: LEW DRAWN BY: ASA CHECKED BY: MJD/CET APPROVED BY: BWG DATE: JANUARY 14, 2011


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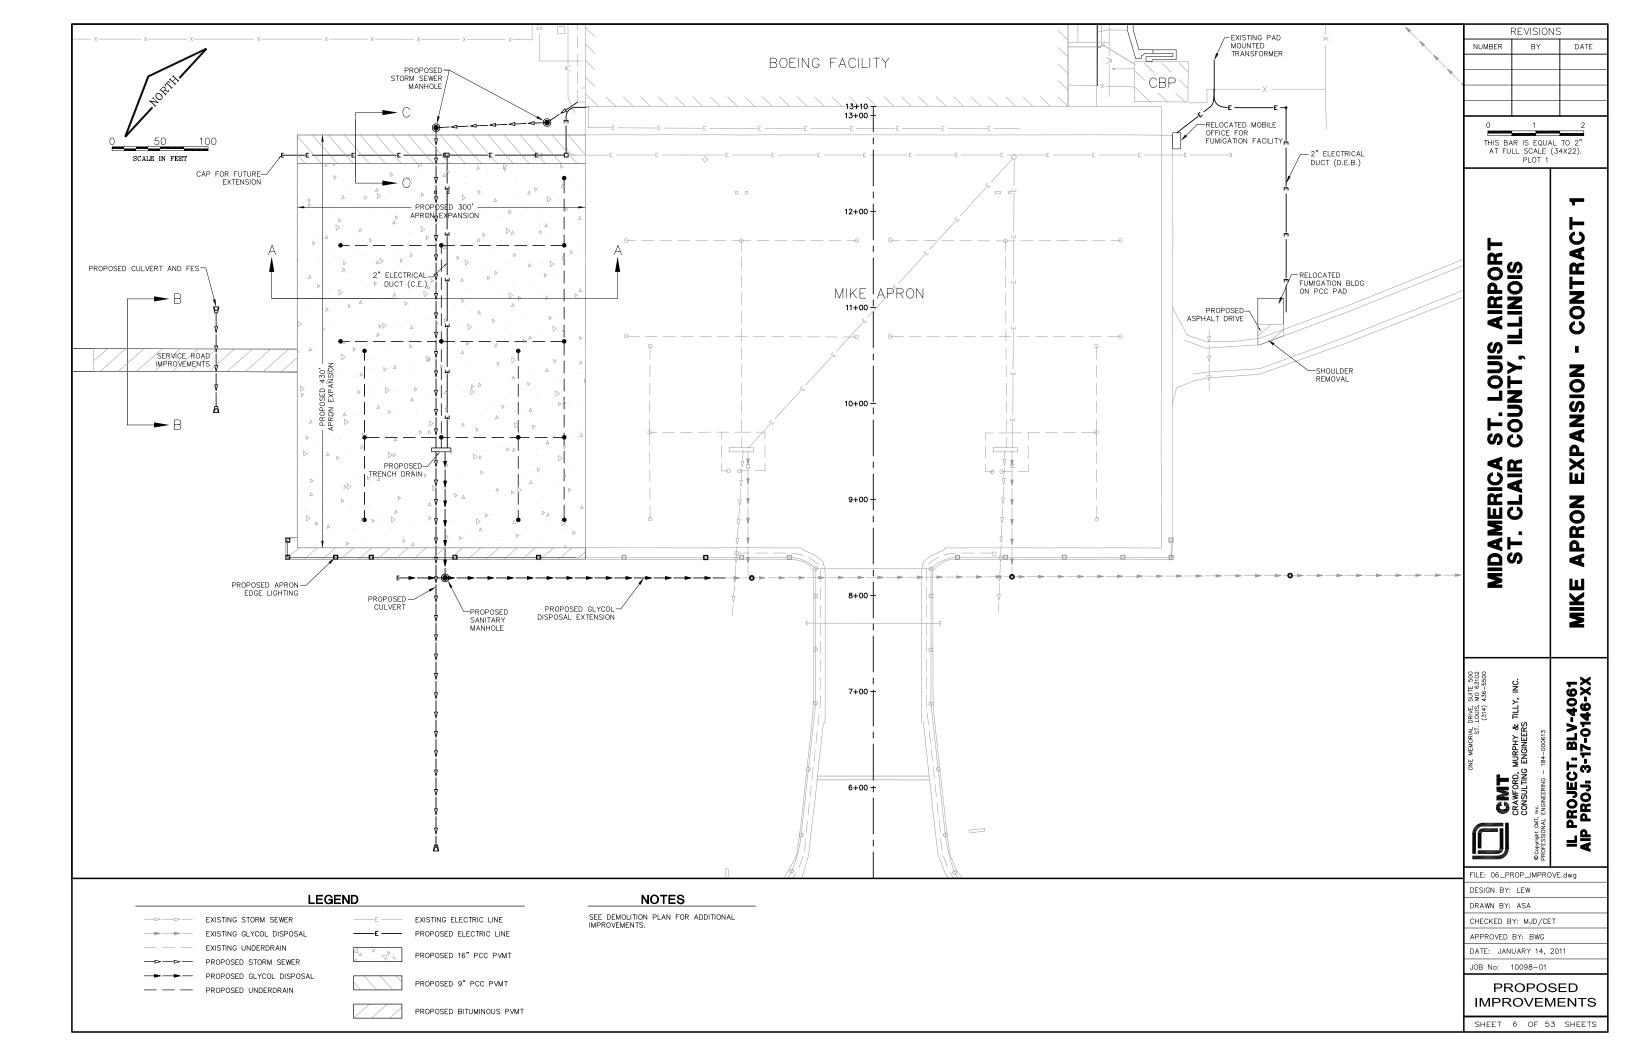
SUMMARY OF QUANTITIES


SHEET 2 OF 53 SHEETS




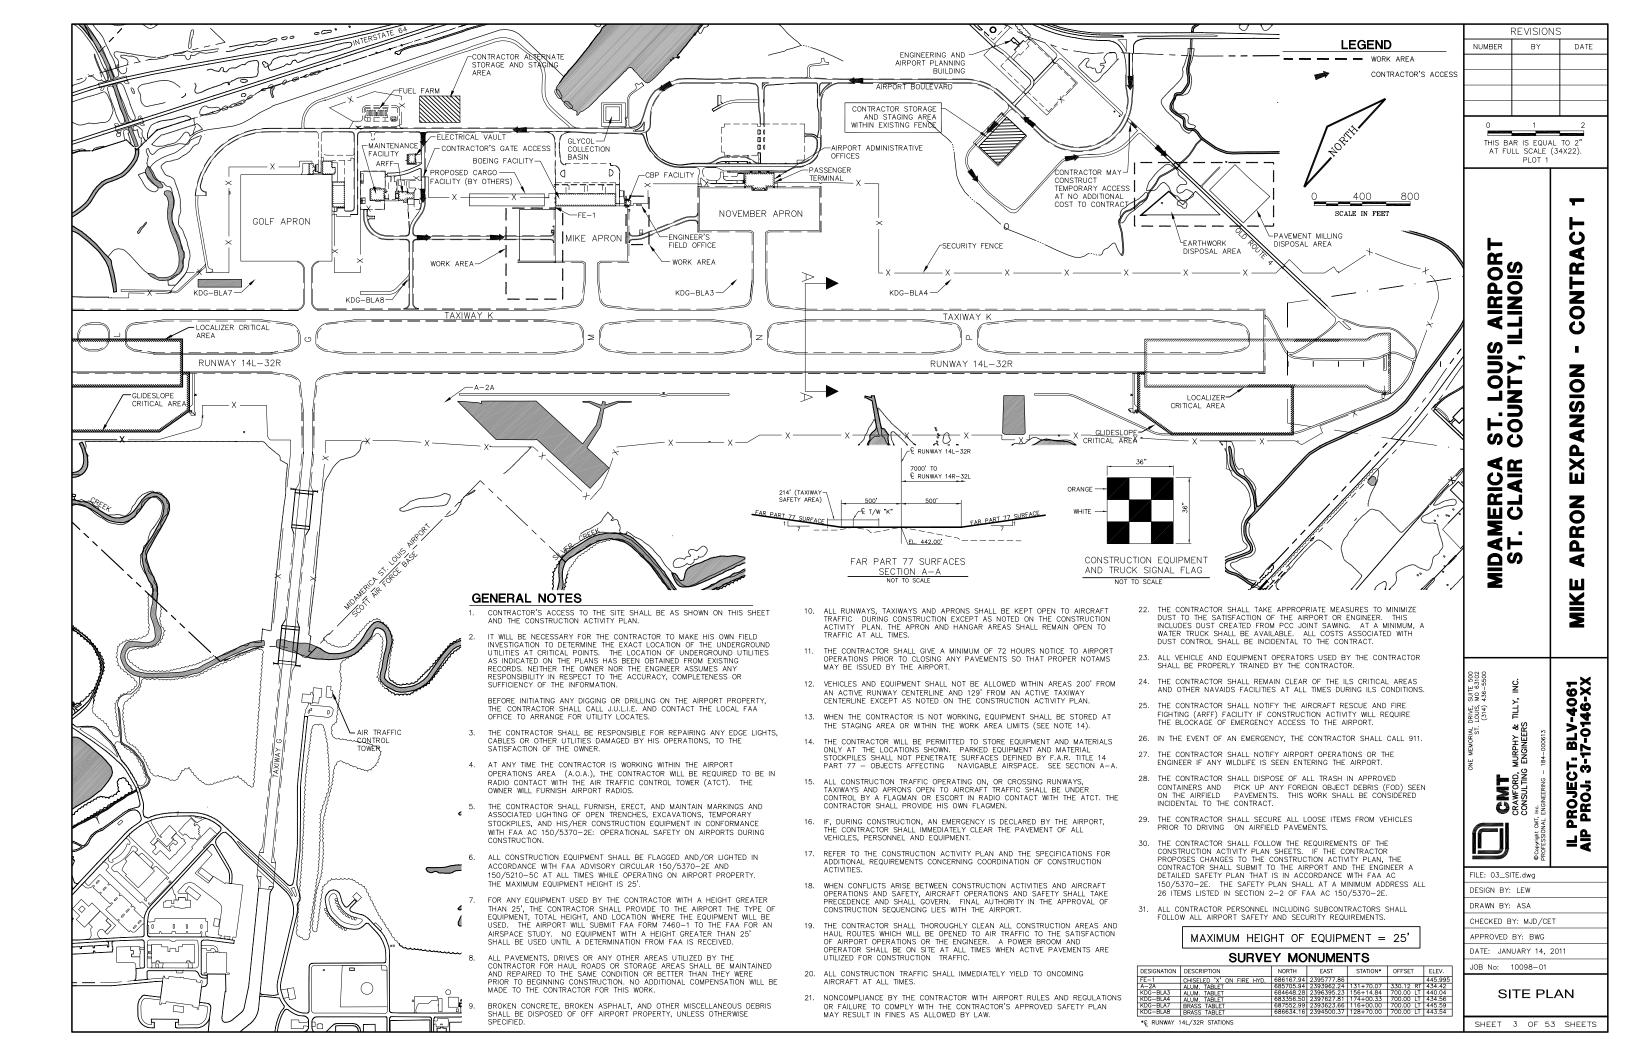


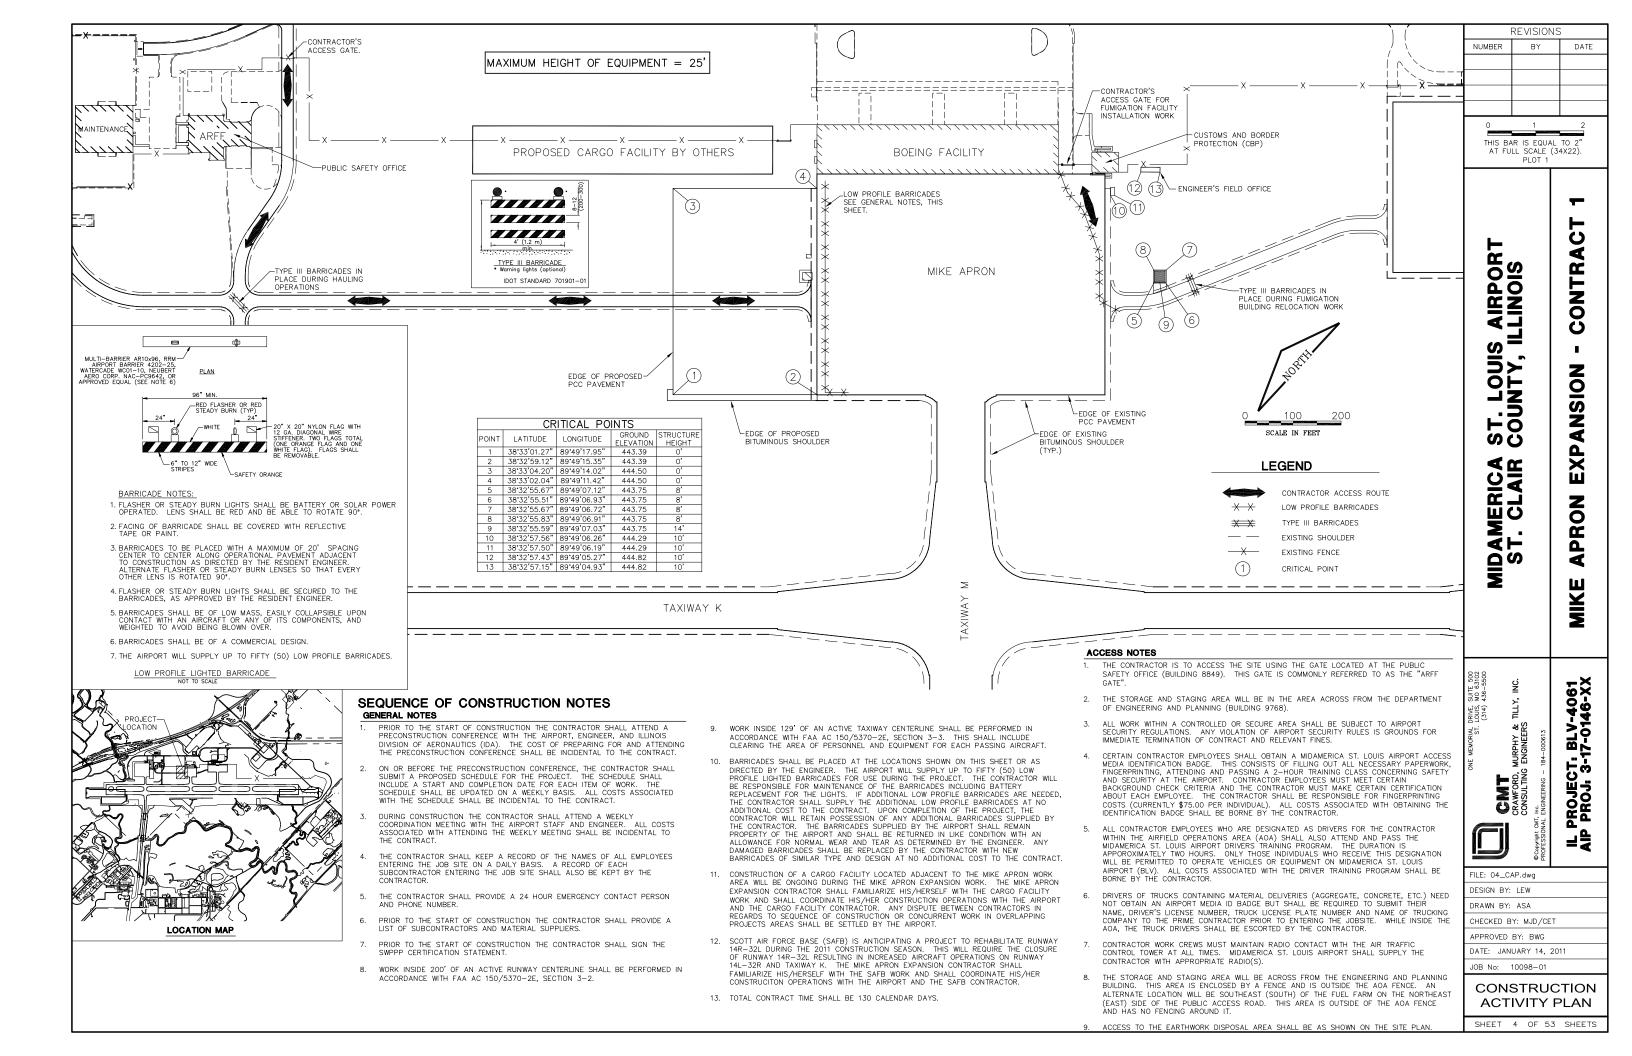


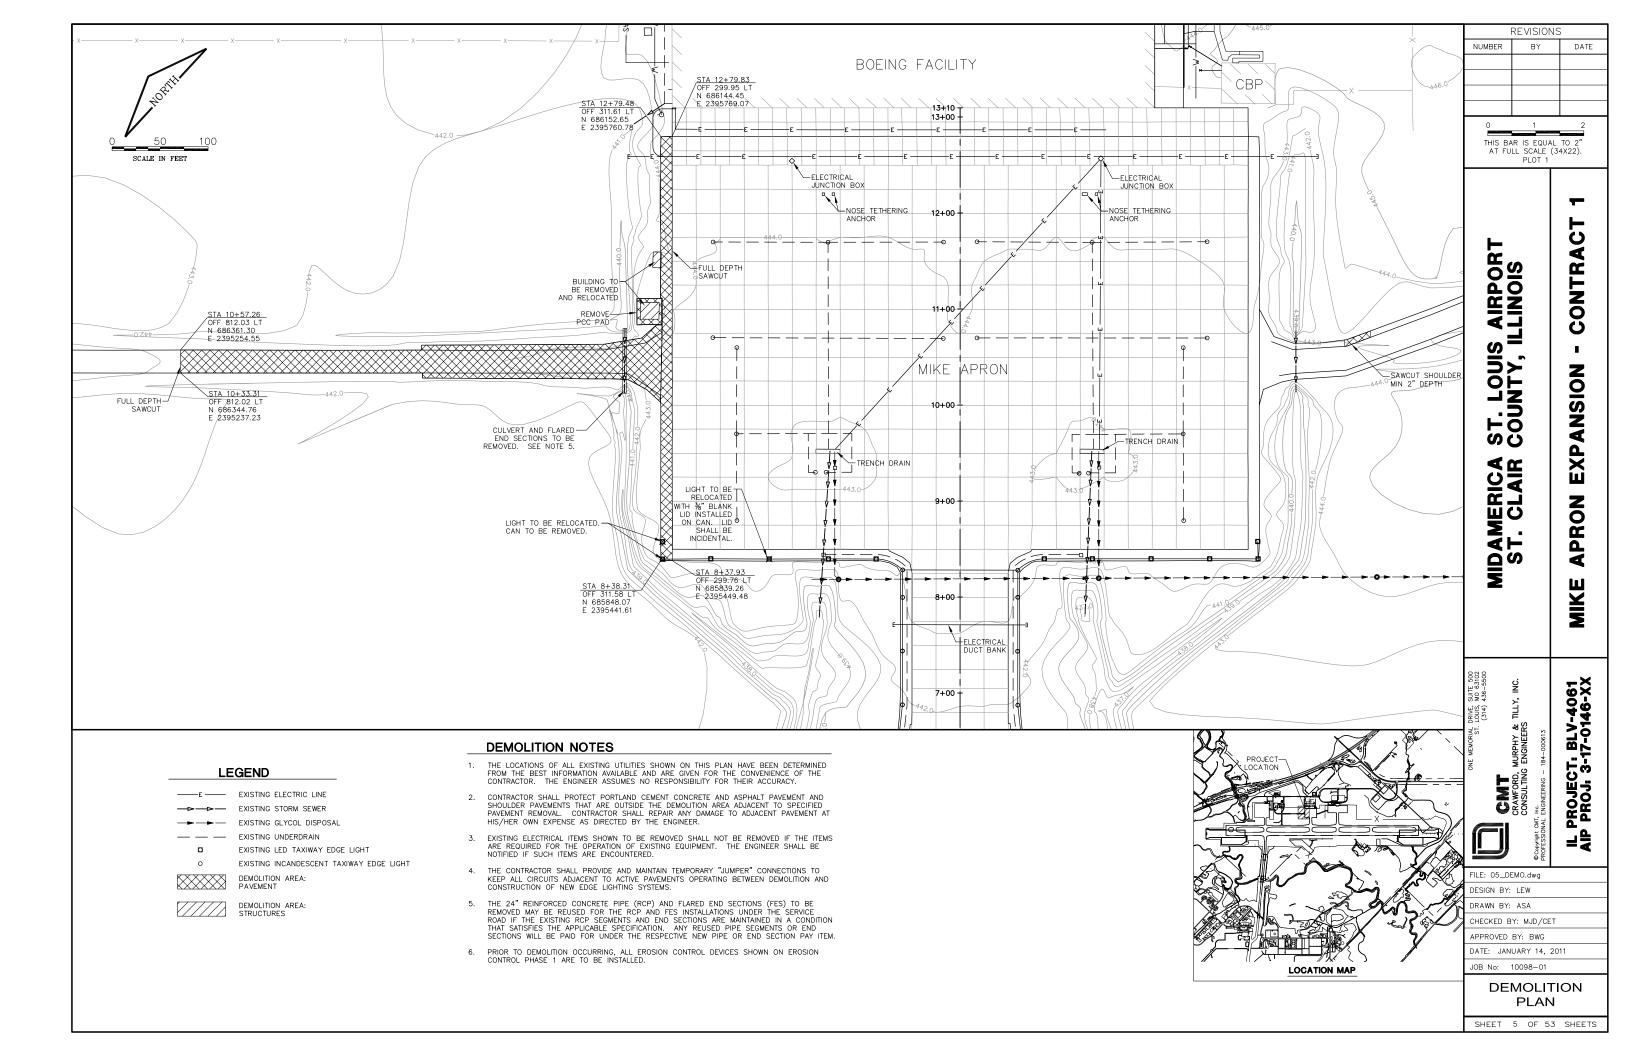

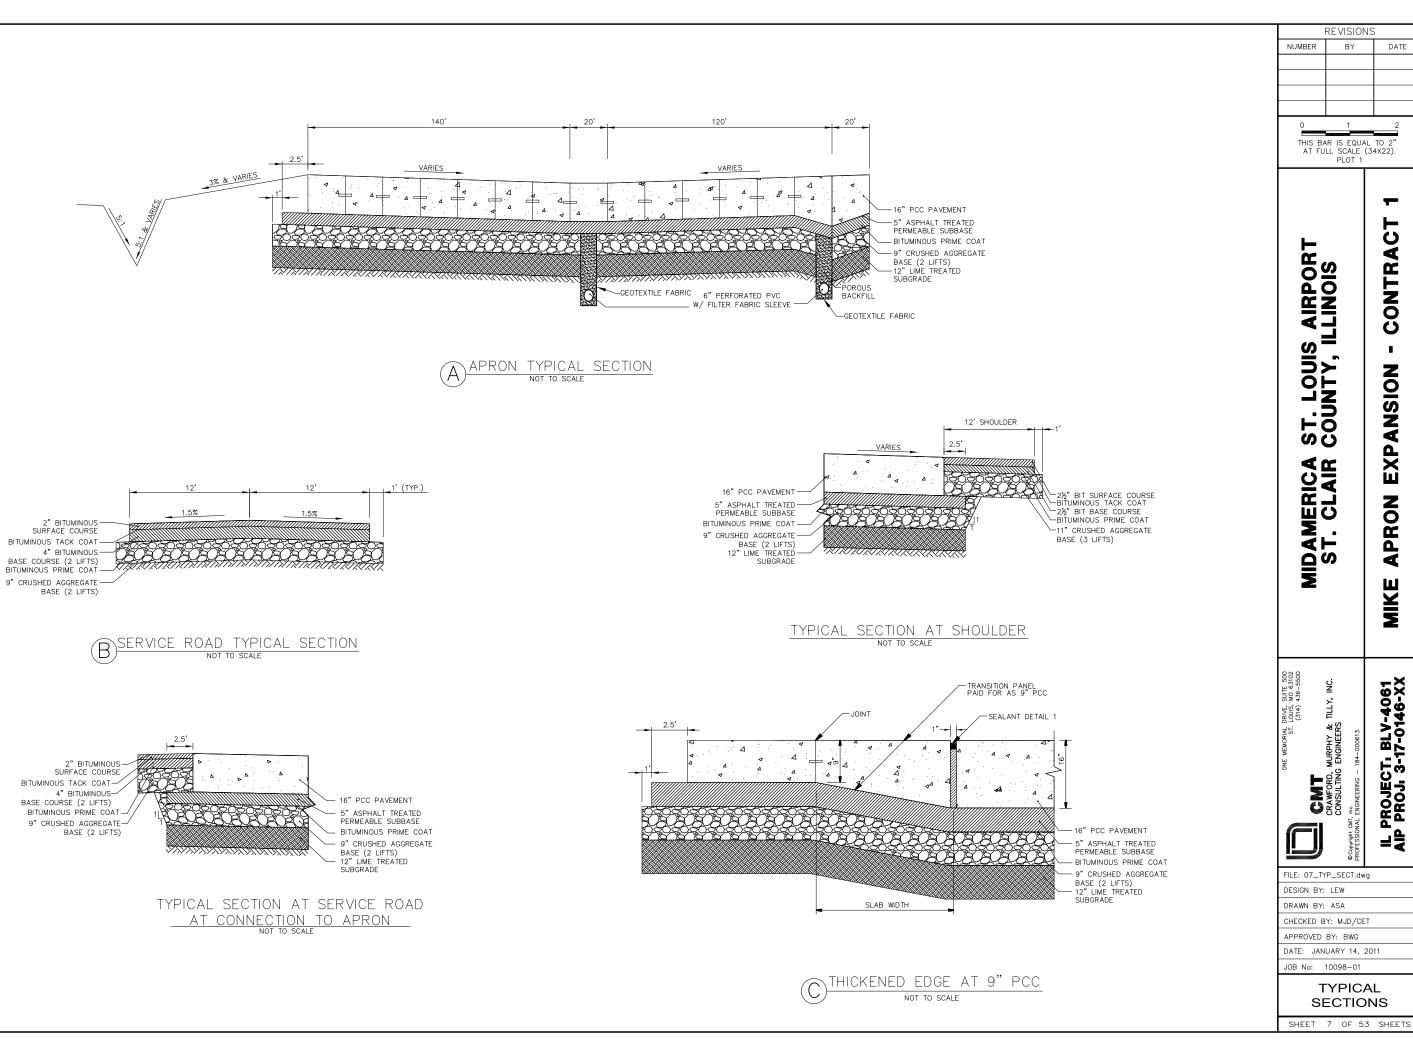

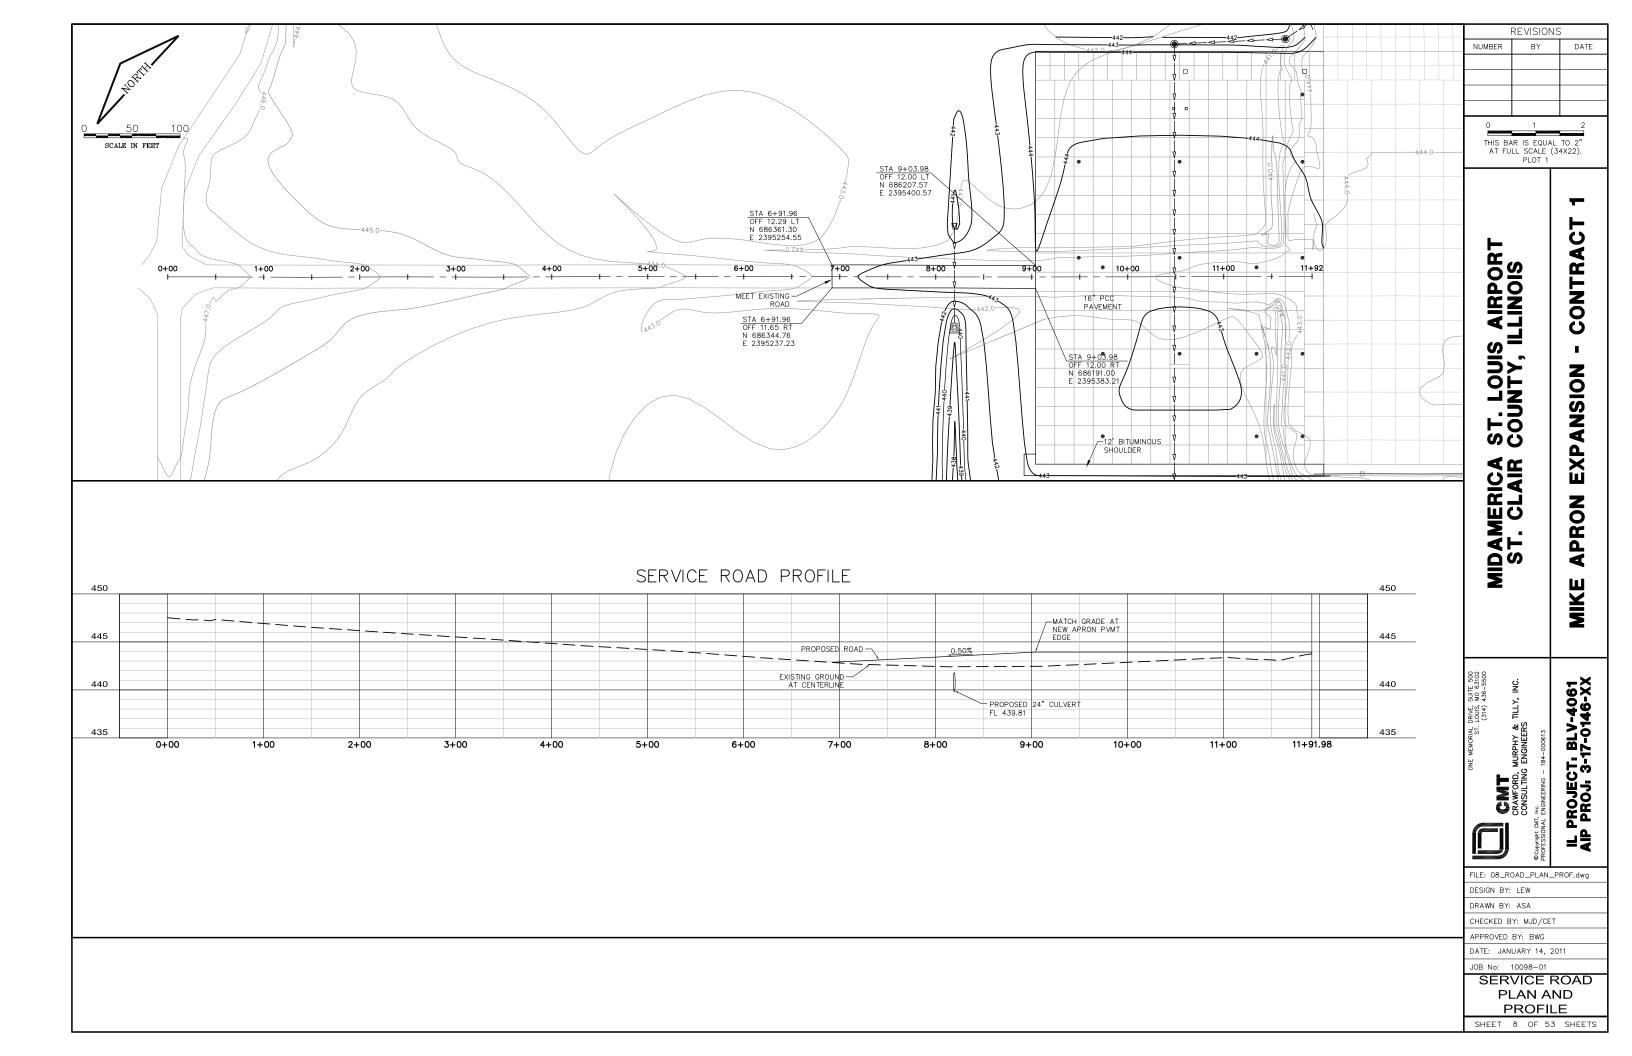

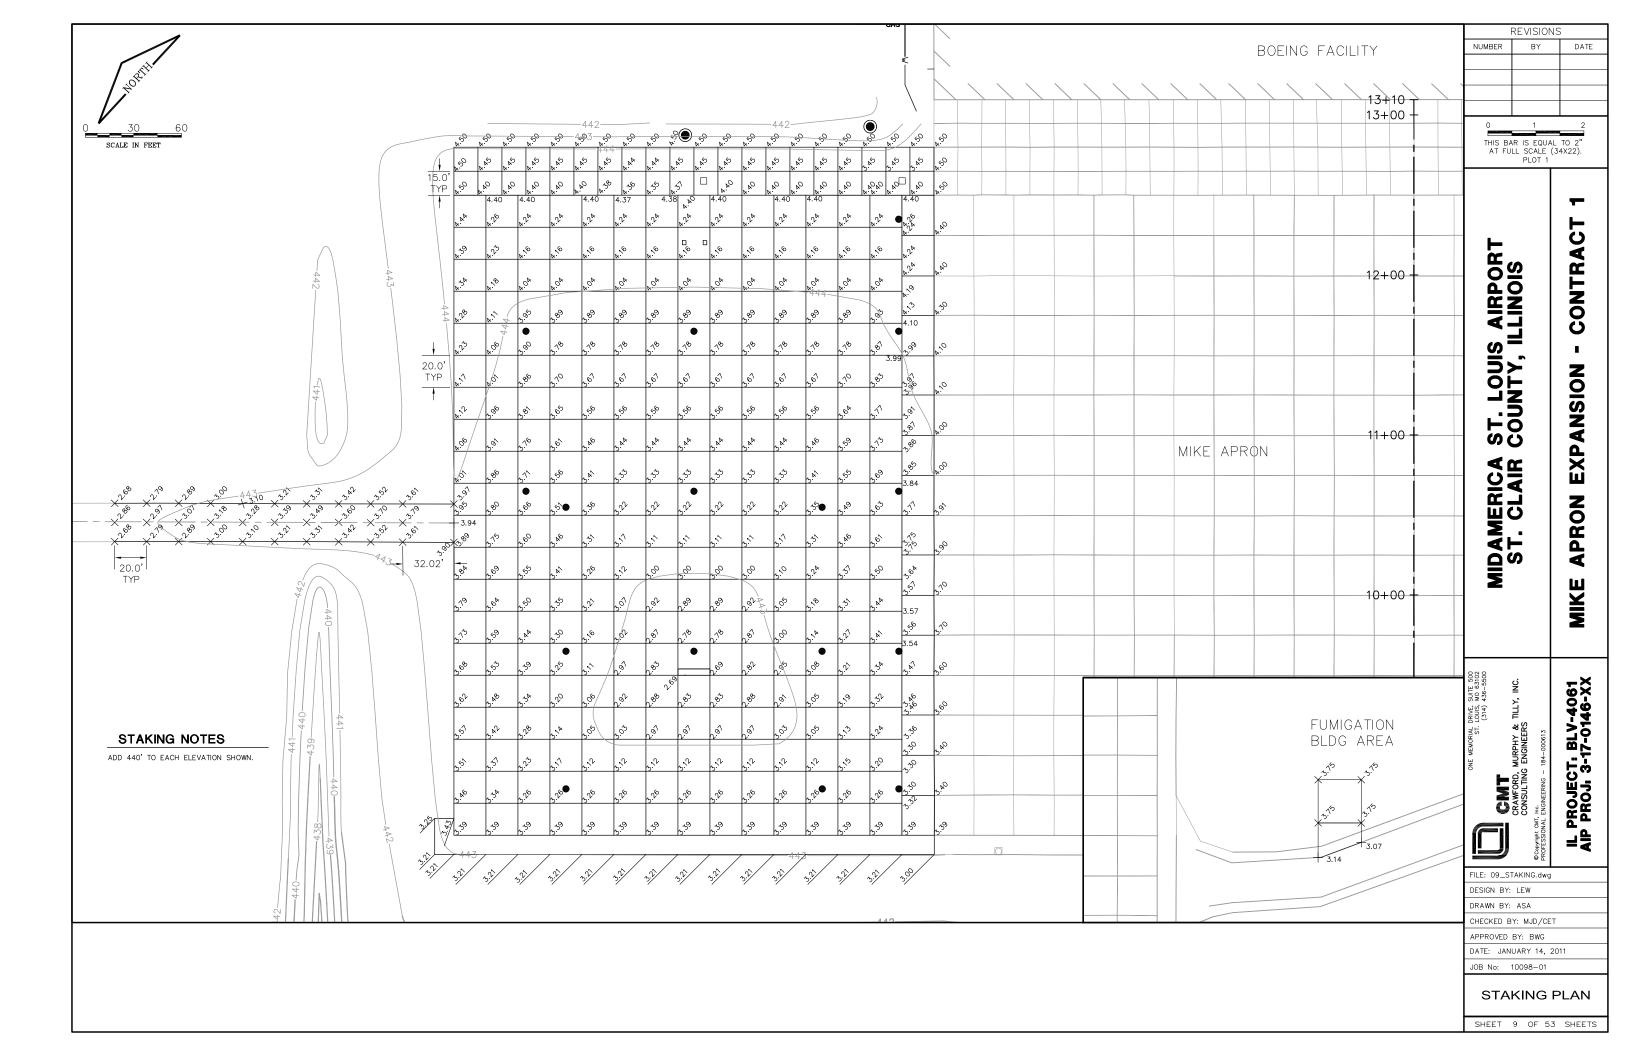

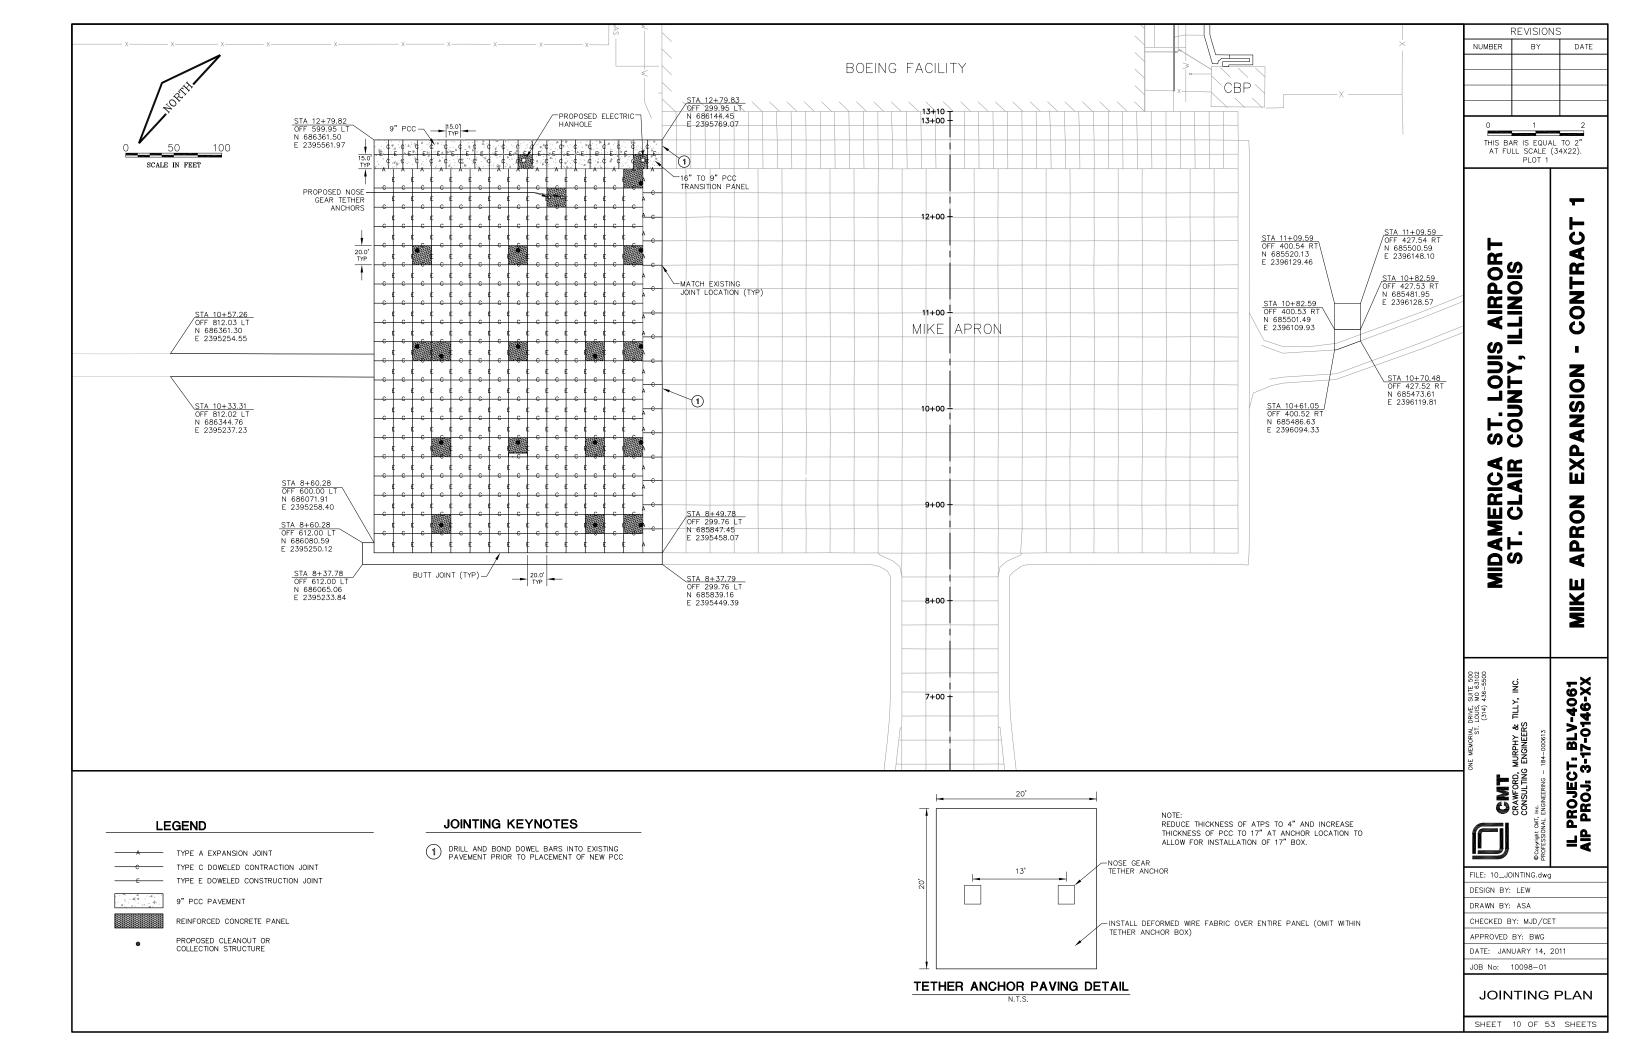


NON-EXTRUDING PREMOLDED-COMPRESSIBLE MATERIAL -SEALANT DETAIL 1 TYPE A-THICKENED EDGE

NOT TO SCALE


EXPANSION JOINTS

CONTRACTION JOINTS

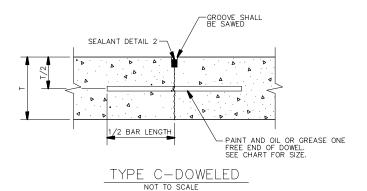

JOINTING NOTES

- 1.) ALL EDGES OF NEW SLABS, FREE STANDING OR CLOSURE, SHALL BE EDGED WITH AN APPROVED TOOL HAVING A RADIUS OF "A", TO FACILITATE SAWING OF THE SEALANT RESERVOIR.
- 2.) THE INITIAL SAW CUT FOR ALL TRANSVERSE CONTRACTION JOINTS SHALL BE SAWED AS SOON AS POSSIBLE AFTER PLACEMENT OF THE PAVEMENT.
- 3.) ALL DOWEL BARS IN TRANSVERSE JOINTS SHALL BE SECURELY HELD IN PLACE BY MEANS OF A DOWEL BAR ASSEMBLY WHICH WILL INSURE THAT THEY REMAIN PARALLEL TO THE PAYEMENT LANES. SHOP DRAWING SUBMITTAL OF THE DOWEL BAR ASSEMBLIES SHALL BE MADE PRIOR TO INSTALLATION.
- 4.) ALL REINFORCEMENT AND/OR FABRIC SHALL BE SECURELY HELD IN PLACE BY SUPPORT PINS OR OTHER APPROVED METHODS TO PREVENT SHIFTING DURING & AFTER CONCRETE PLACEMENT.
- 5.) TYPE E DOWELED CONSTRUCTION JOINT SHALL BE INSTALLED FOR ALL LONGITUDINAL JOINTS AND WHERE PAVING OPERATIONS ARE DELAYED OR STOPPED.

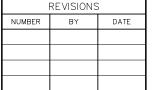

S AIRPORT ILLINOIS

ST. LOUIS COUNTY, II

ERICA CLAIR

MIDAME ST. (

THIS BAR IS EQUAL TO 2" AT FULL SCALE (34X22). PLOT 1

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EXPANSION

APRON

MIKE


PROJECT, BLV-4061 PROJ, 3-17-0146-XX

- LONGITUDINAL JOINT DOWEL PLACEMENT DETAIL

DOWEL BAR SIZES

THICKNESS OF SLAB	DIAMETER	LENGTH	SPACING
6-7 IN	¾ IN	18 IN	12 IN
8-12 IN	1 IN	19 IN	12 IN
13-16 IN	1-¼ IN	20 IN	15 IN
17-20 IN	1-½ IN (1)	20 IN	18 IN
21-24 IN	2 IN (1)	24 IN	18 IN

(1) DOWELS NOTED MAY BE A SOLID BAR OR HIGH-STRENGTH PIPE. HIGH STRENGTH PIPE DOWELS MUST BE PLUGGED ON EACH END WITH A TIGHT-FITTING PLASTIC CAP OR WITH BITUMINOUS OR MORTAR MIX.

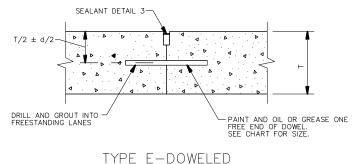


CONSTRUCTION JOINTS

PCC PAVEMENT -BITUMINOUS SHOULDER -DOW CORNING 888 OR APPROVED EQUAL
(¼" DEPTH TYP.) -%" BACKER ROAD

BUTT JOINT DETAIL AT SHOULDER


REINFORCED PANELS

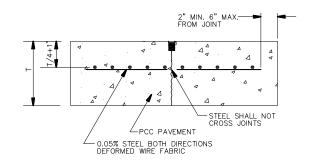

ODD SHAPED PANEL REINFORCEMENT

THICKNESS	SUGGESTED MINIMUM FABRIC SIZE
4"	6 x 6 - W1.2 x W1.2 OR 4 x 4 - W0.9 x W0.9
6"	6 x 6 - W2.1 x W2.1 OR 4 x 4 - W1.2 x W1.2
8"	6 x 6 - W2.5 x W2.5 OR 4 x 4 - W2.1 x W2.1
10"	6 x 6 - W3.5 x W3.5 OR 4 x 4 - W2.1 x W2.1
12"	6 x 6 - W4 x W4 OR 4 x 4 - W2.5 x W2.5
14"	6 x 6 - W4.5 x W4.5 OR 4 x 4 - W3 x W3
16"	6 x 6 - W5 x W5 OR 4 x 4 - W3.5 x W3.5

JOINT SEALANT DETAILS 1/4" x 1/4" CHAMFER 14" x 14" CHAMFER -BELOW PAVEMENT ¼" x ¼" CHAMFER - 14" BELOW PAVEMENT 1/4" BELOW PAVEMENT -ITEM AR605 JOINT SEALANT (D.S. BROWN E-1256 OR EQUAL) -ITEM AR605 JOINT SEALANT (D.S. BROWN E-686 OR EQUAL) -ITEM AR605 JOINT SEALANT (D.S. BROWN E-686 OR EQUAL) NON-EXTRUDING PREMOLDED COMPRESSIBLE MATERIAL CONSTRUCTION JOINT → CONTRACTION JOINT JOINT SEALANT DETAIL 1 JOINT SEALANT DETAIL 2 JOINT SEALANT DETAIL 3 NOT TO SCALE NOT TO SCALE

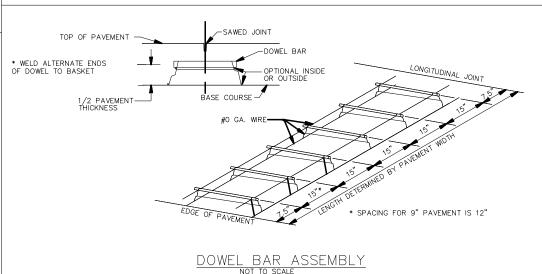

FILE: 11_JOINT_DETAILS.dwg DESIGN BY: LEW DRAWN BY: ASA


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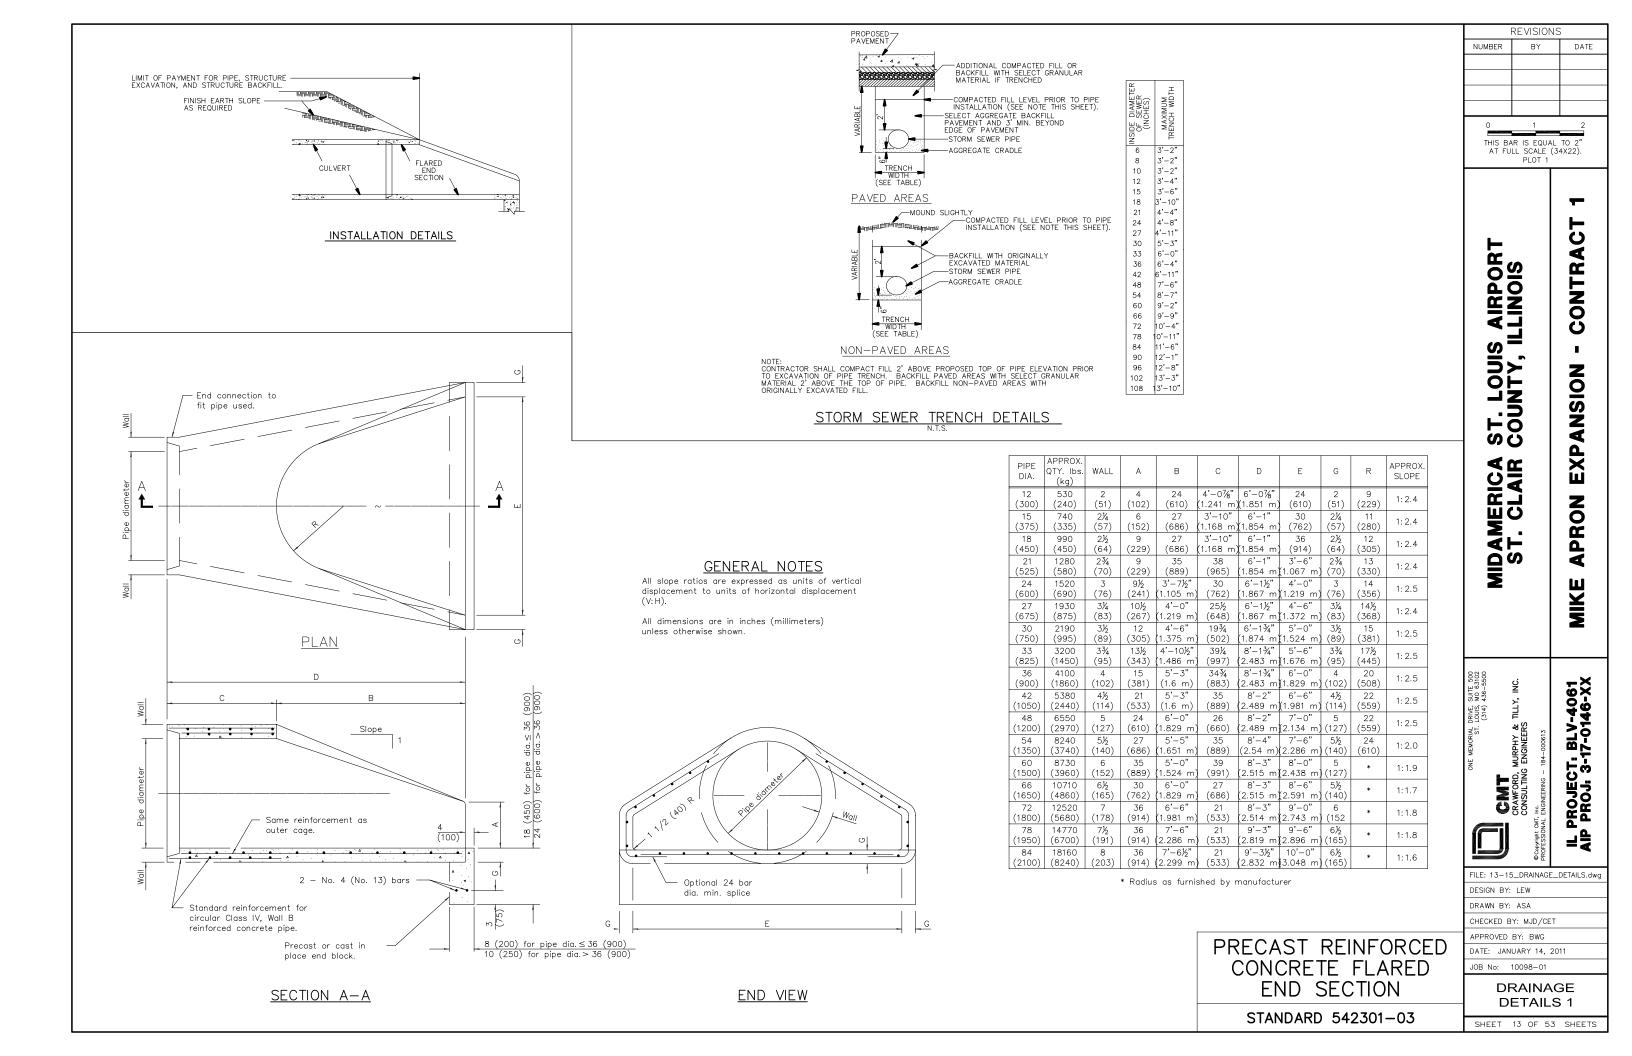
CRAWFORD, CONSULTING


CHECKED BY: MJD/CET APPROVED BY: BWG DATE: JANUARY 14, 2011 JOB No: 10098-01

> **JOINTING DETAILS**

SHEET 11 OF 53 SHEETS



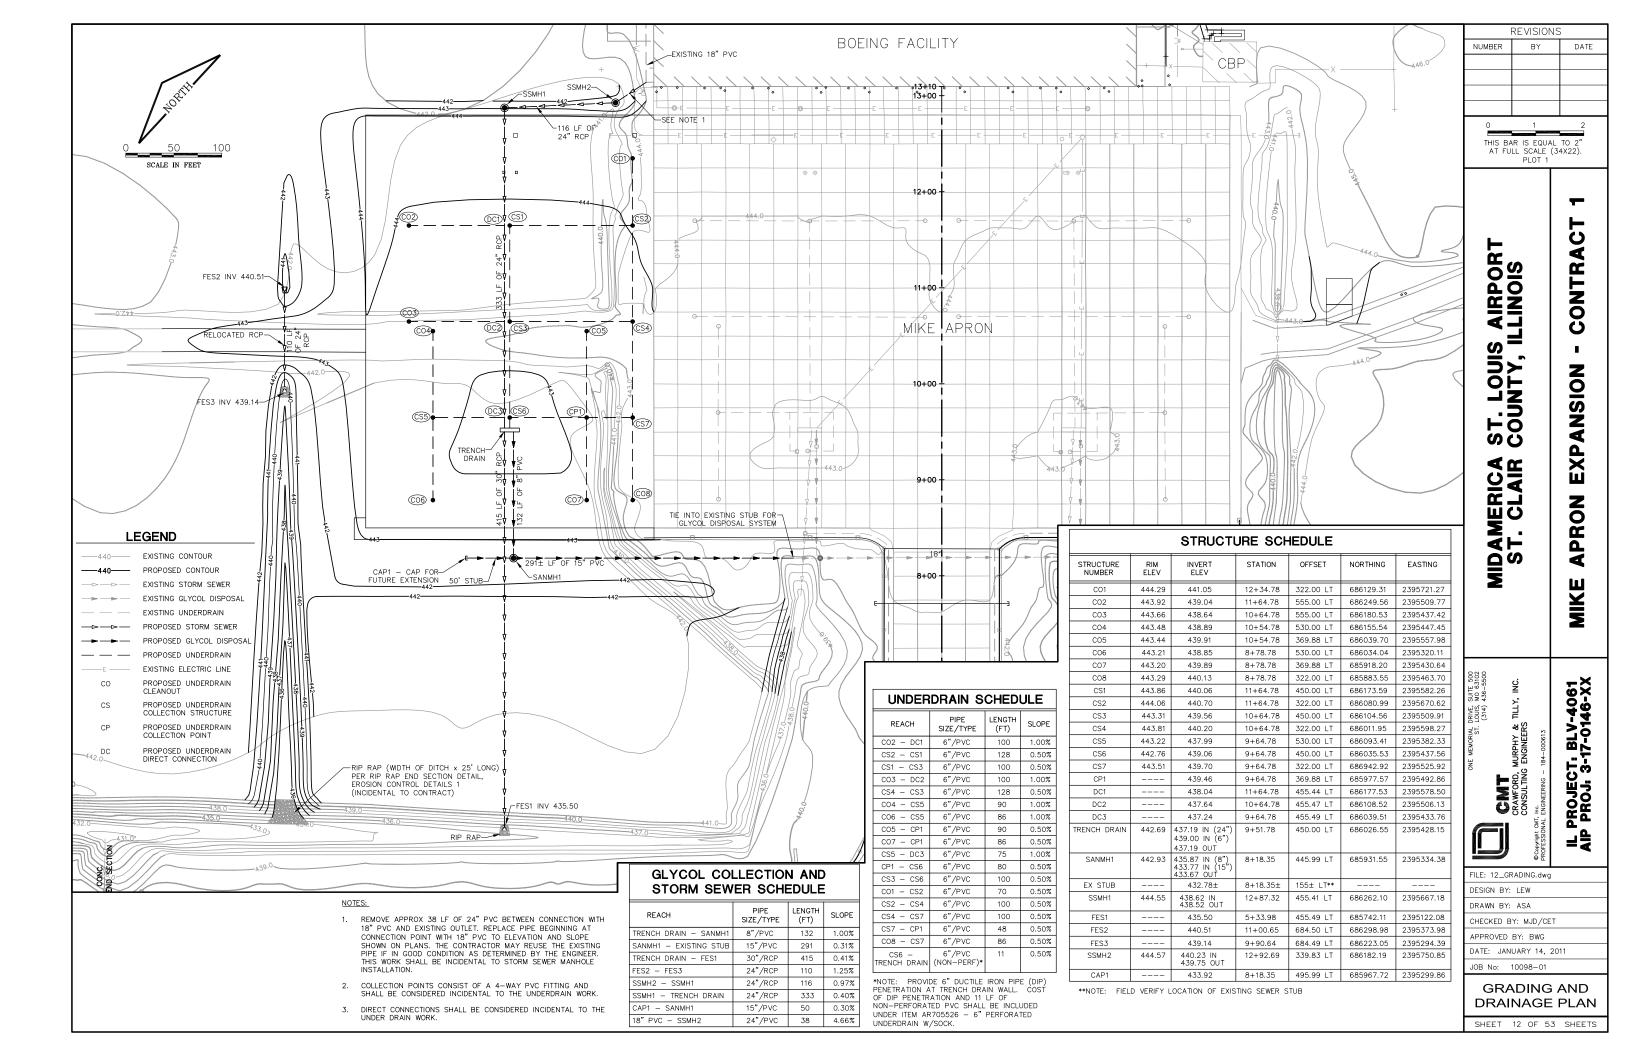

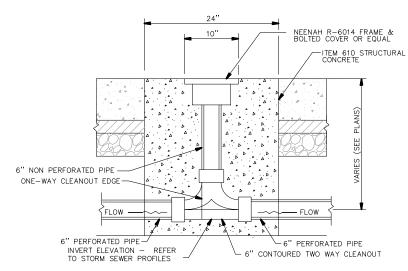

ONE-WAY OR TWO-WAY CLEANOUT ELEVATION

UNDERDRAIN CLEANOUT NOTES

- SEQUENCE OF CONSTRUCTION/PLACEMENT OF CLEANOUTS SHALL BE AS FOLLOWS:


 1.o. PAVE ASPHALT

 1.b. CORE THROUGH ASPHALT


 1.c. SET CLEANOUT WITH PCC COLLAR

 1.d. PAVE CONCRETE APRON


- 2. FINISHED GRADE OF CLEANOUTS AND COLLECTION STRUCTURES SHALL BE AT OR JUST BELOW PCC PAVEMENT SURFACE ELEVATION. ANY STRUCTURE EXTENDING ABOVE THE FINISHED PCC PAVEMENT ELEVATION SHALL BE ADJUSTED BY THE CONTRACTOR AT NO ADDITIONAL COST TO THE CONTRACT.

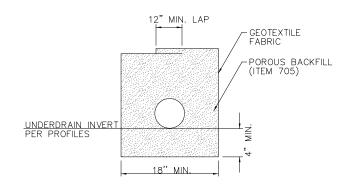

UNDERDRAIN TRENCH DETAIL

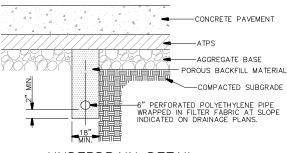

UNDERDRAIN DETAIL

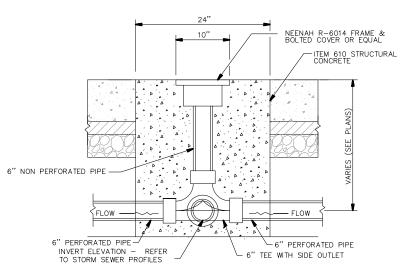

UNDERDRAIN COLLECTION STRUCTURE

UNDERDRAIN COLLECTION STRUCTURE NOTES


- SEQUENCE OF CONSTRUCTION/PLACEMENT OF CLEANOUTS SHALL BE AS FOLLOWS:

 1.0. PAVE ASPHALT


 1.b. CORE THROUGH ASPHALT

 1.c. SET CLEANOUT WITH PCC COLLAR

 1.d. PAVE CONCRETE APRON
- 2. FINISHED GRADE OF CLEANOUTS AND COLLECTION STRUCTURES SHALL BE AT OR JUST BELOW PCC PAVEMENT SURFACE ELEVATION. ANY STRUCTURE EXTENDING ABOVE THE FINISHED PCC PAVEMENT ELEVATION SHALL BE ADJUSTED BY THE CONTRACTOR AT NO ADDITIONAL COST TO THE CONTRACT.

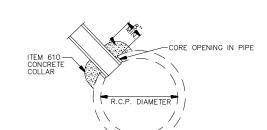

UNDERRAIN DIRECT CONNECTION AT RCP

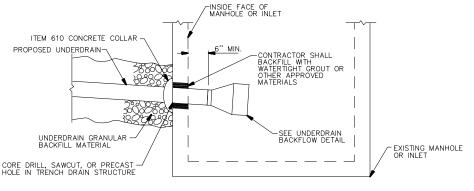


NOTES:
CONTRACTOR SHALL BACKFILL WITH WATERTIGHT GROUT
OR OTHER APPROVED MATERIALS

DIRECT CONNECTION DETAIL


DIRECT CONNECTION NOTES

1. HOLE IN STRUCTURE SHALL BE AT LEAST 1" WIDER THAN UD PIPE 2. FILL SPACE BETWEEN UNDERDRAIN AND STRUCTURE WITH NON-SHRINK GROUT OR ITEM 610 PCC COLLAR.

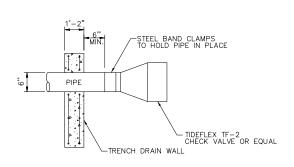


UNDERDRAIN BACKFLOW DETAIL

NOTE: CHECK VALVE SHALL BE INCIDENTAL TO UNDERDRAIN WORK.

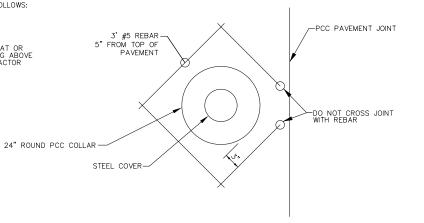

UNDERDRAIN PLAN VIEW

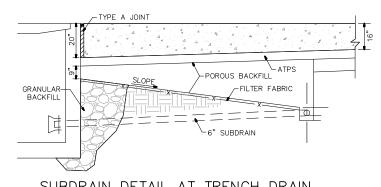

SUBDRAIN DETAIL AT TRENCH DRAIN

DATE: JANUARY 14, 2011

DETAILS 2

JOB No: 10098-01

NUMBER BY DATE

CONTRA

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MIKE

REVISIONS

THIS BAR IS EQUAL TO 2' AT FULL SCALE (34X22) PLOT 1

> S AIRPORT ILLINOIS ST. LOUIS COUNTY, II ERICA CLAIR ¥. **⊡**⊗ ₹


> > PROJECT: BLV-4061 PROJ: 3-17-0146-XX

MURPHY & 1 ENGINEERS CRAWFORD, CONSULTING

FILE: 13-15_DRAINAGE_DETAILS.dwg DESIGN BY: LEW DRAWN BY: ASA CHECKED BY: MJD/CET APPROVED BY: BWG

DRAINAGE

SHEET 14 OF 53 SHEETS

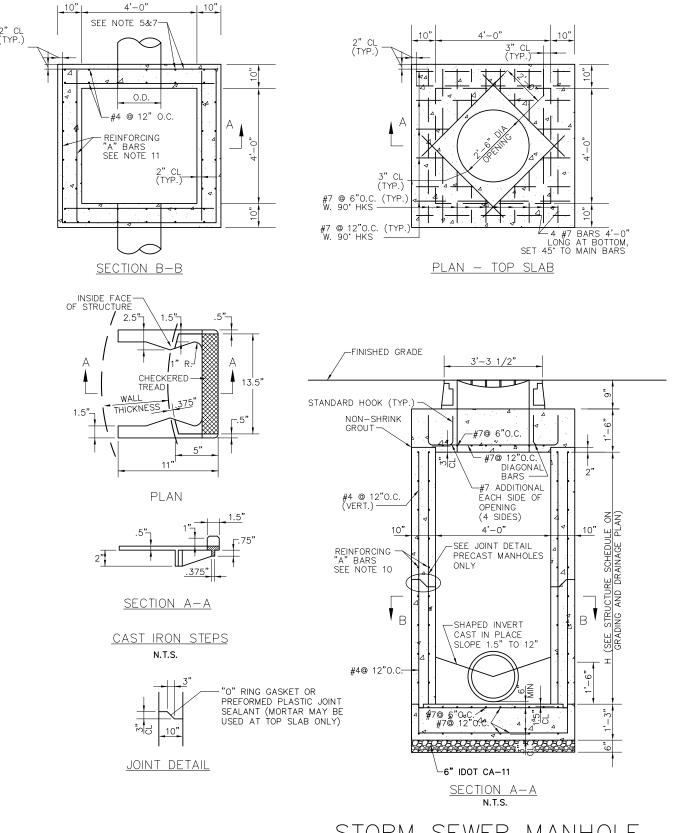

STORM SEWER MANHOLE

NOTES:

- 1. FRAME WITH COVER SHALL BE NEENAH R-3492-A WITH LEGEND "STORM."
- 2. ALL MANHOLE COVERS SHALL BE BOLTED TO THE FRAME.
- 3. OPENINGS IN THE WALLS FOR THE PIPE SHALL BE CAST-IN OR CUT CLEANLY WITHOUT PERCUSSION TO A MAXIMUM DIAMETER OF O.D. ±3". THE SPACE BETWEEN PIPE AND WALL SHALL THEN BE SEALED WITH MORTAR OR OTHER APPROVED
- 4. WHERE A PIPE PASSES THROUGH A WALL 2 ADDITIONAL "A" BARS SHALL BE PLACED ABOVE, BELOW, AND TO EACH SIDE OF THE OPENING, VERTICAL "A" BARS SHALL EXTEND A MINIMUM OF 2'-0" ABOVE AND BELOW THE EDGES OF THE OPENING. THE ADDITIONAL REINFORCING SHALL BE PLACED AT BOTH THE INSIDE AND OUTSIDE LAYER OF REINFORCING.
- 5. WHEN LIFTING THE PRE-CAST MANHOLE, A BAR SHALL BE PLACED HORIZONTALLY THROUGH THE LIFTING HOLES, PROVIDED AT THE TIME OF MANUFACTURE, THE LIFTING DEVICES SHALL BE PLACED ONLY ON THAT BAR. THE BAR AND HOLES SHALL BE APPROVED BY THE ENGINEER. THE LIFTING HOLES SHALL BE FILLED WITH GROUT AFTER THE MANHOLE IS IN POSITION.
- 6. SPLICE LENGTHS REQUIRED FOR REINFORCING BARS: #4 BAR, 1'-4"; #5 BAR, 1'-8"; #6 BAR, 2'-0"; #7 BAR, 2'-6".
- 7. JOINT AND WATERSTOP ARE AN OPTION FOR CAST—IN PLACE MANHOLES ONLY. PRE—CAST MANHOLES SHALL NOT BE JOINTED AT THIS LOCATION.
- 8. CONCRETE STRENGTH AT 28 DAYS SHALL BE A MINIMUM OF 4,000 PSI FOR CAST—IN PLACE MANHOLES, 5,000 PSI FOR
- 9. REINFORCING SHALL CONFORM TO ASTM A615, GRADE 60.
- 10. REINFORCING "A" BARS SHALL BE #5 @ 12".
- 11. CAST IRON STEPS SHALL BE NEENAH R-1982-1 FOR STRAIGHT WALLS, OR APPROVED EQUAL.
- 12. MANHOLE TO BE CONSTRUCTED OF STRUCTURAL P.C. CONCRETE. THE CONTRACT UNIT PRICE PER MANHOLE SHALL INCLUDE THE FRAME, GRATES, AND STEPS IN PLACE AND
- 13. THE CONTRACTOR IS REQUIRED TO SUBMIT MANUFACTURER'S SHOP DRAWING SHOWING DETAILS AND DESIGN CALCULATIONS FOR APPROVAL PRIOR TO INSTALLATION. (SEE SPECS - ITEM 751) SHOP DRAWINGS SHALL BE SEALED BY A REGISTERED PROFESSIONAL STRUCTURAL ENGINEER.
- 14. THIS MANHOLE FRAME REQUIRES AIRPORT LOADING TO CONFORM WITH AC 150/5320-6E. THIS IS 50,000 LBS PER TIRE LOAD SPREAD OVÉR 235 SQUARE INCHES. CASTINGS ARE TO SUPPORT 100,000 LBS WHEEL LOADS WITH 250 PSI TIRE PRESSURE. ALL OTHER INLETS, FRAMES, AND GRATES SHALL BE DESIGNED TO WITHSTAND AASHTO HS20-44 HIGHWAY LOADING.

REVISIONS			
NUMBER	BY	DATE	

THIS BAR IS FOUAL TO 2'

AT FULL SCALE (34X22) PLOT 1

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PROJECT: BLV-4061 PROJ: 3-17-0146-XX

AIRPOR-LINOIS S ST. LOUIS COUNTY, ERICA CLAIR ¥. **⊡** ⊗

MURPHY & 1 ENGINEERS

RIAL ST.

CRAWFORD, CONSULTING


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CHECKED BY: MJD/CET APPROVED BY: BWG


DATE: JANUARY 14, 2011 JOB No: 10098-01

DRAINAGE

DETAILS 3 SHEET 15 OF 53 SHEETS

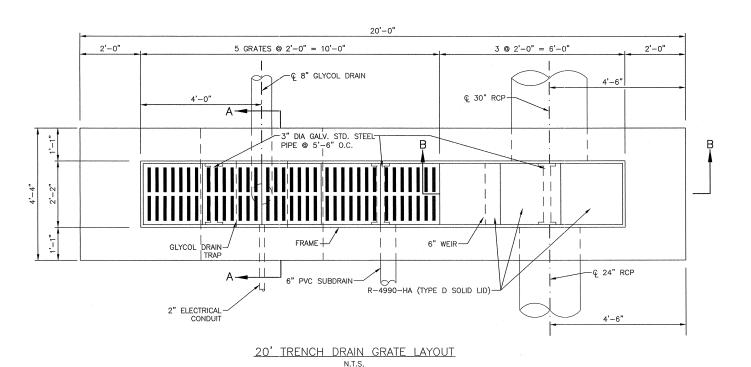


- NEENAH FRAME AND GRATE R-4990-HA TYPE A GRATE OPENING, BOLTED OR EQUAL. GRATE SHALL BE SECURED TO FRAME BEFORE CONCRETE IS 3" DIA GALV. STD. STEEL PIPE_

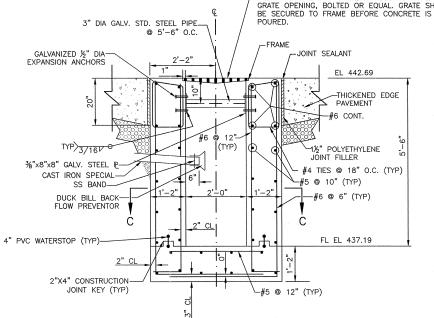


20' TRENCH DRAIN TYPICAL SECTION

AT OPENING (TYP) TYPICAL PIPE PENETRATION DETAIL N.T.S.

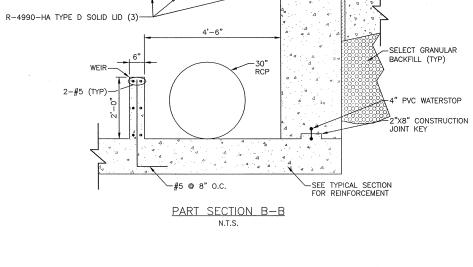


2'-0"


2'-0"

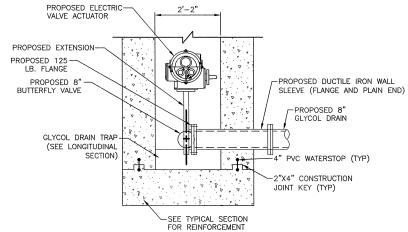

PART SECTION A-A N.T.S.

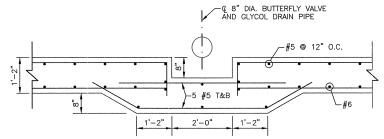

PART LONGITUDINAL SECTION THROUGH GLYCOL DRAIN TRAP

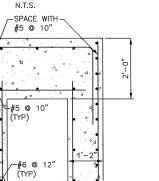

PART SECTION C-C

NOTES:

- 1. CAST IN PLACE CONCRETE SHALL HAVE A MINIMUM 14 DAY COMPRESSIVE STRENGTH OF 3500 PSI.
 2. ALL REINFORCEMENT SHALL BE ASTM A615 GRADE 60.
 3. REINFORCING BARS SHALL BE CUT AND/OR FIELD BENT AT ALL PIPE OPENINGS TO MAINTAIN 1" CLEARANCE FROM PIPES.
 4. MINIMUM CLEARANCE TO REINFORCING STEEL SHALL BE 11" INJURIES OTHERWISE SHOWN.
- MINIMUM CLEARANCE TO REINFORCING STEEL SHALL BE 1½" UNLESS OTHERWISE SHOWN.

 ALL CONCRETE, REINFORCING STEEL, EXCAVATION, BACKFILL, DUCTILE IRON FRAME AND GRATE, STEEL PIPES AND PLATES, ANCHORS, WATERSTOPS, JOINT FILLER AND JOINT SEALANT NECESSARY TO CONSTRUCT THE TRENCH DRAIN SHALL BE INCLUDED IN THE COST OF 4'X20' TRENCH DRAIN (EACH).

 6. FIELD VERIFY ALL SIZES AND LOCATIONS PRIOR TO
- CONSTRUCTION/INSTALLATION OF STRUCTURES AND PIPES.



REVISIONS		
NUMBER	BY	DATE
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THIS BAR IS EQUAL TO 2" AT FULL SCALE (34X22). PLOT 1

CONTRA

IS AIRPORT, ILLINOIS T. LOUIS **EXPANSION** S MIDAMERICA ST. CLAIR APRON MKE

> PROJECT, BLV-4061 PROJ, 3-17-0146-XX TILLY, MURPHY & ENGINEERS

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FILE: 16_TRENCH_DRAIN_DETAILS.dw DESIGN BY: JMW


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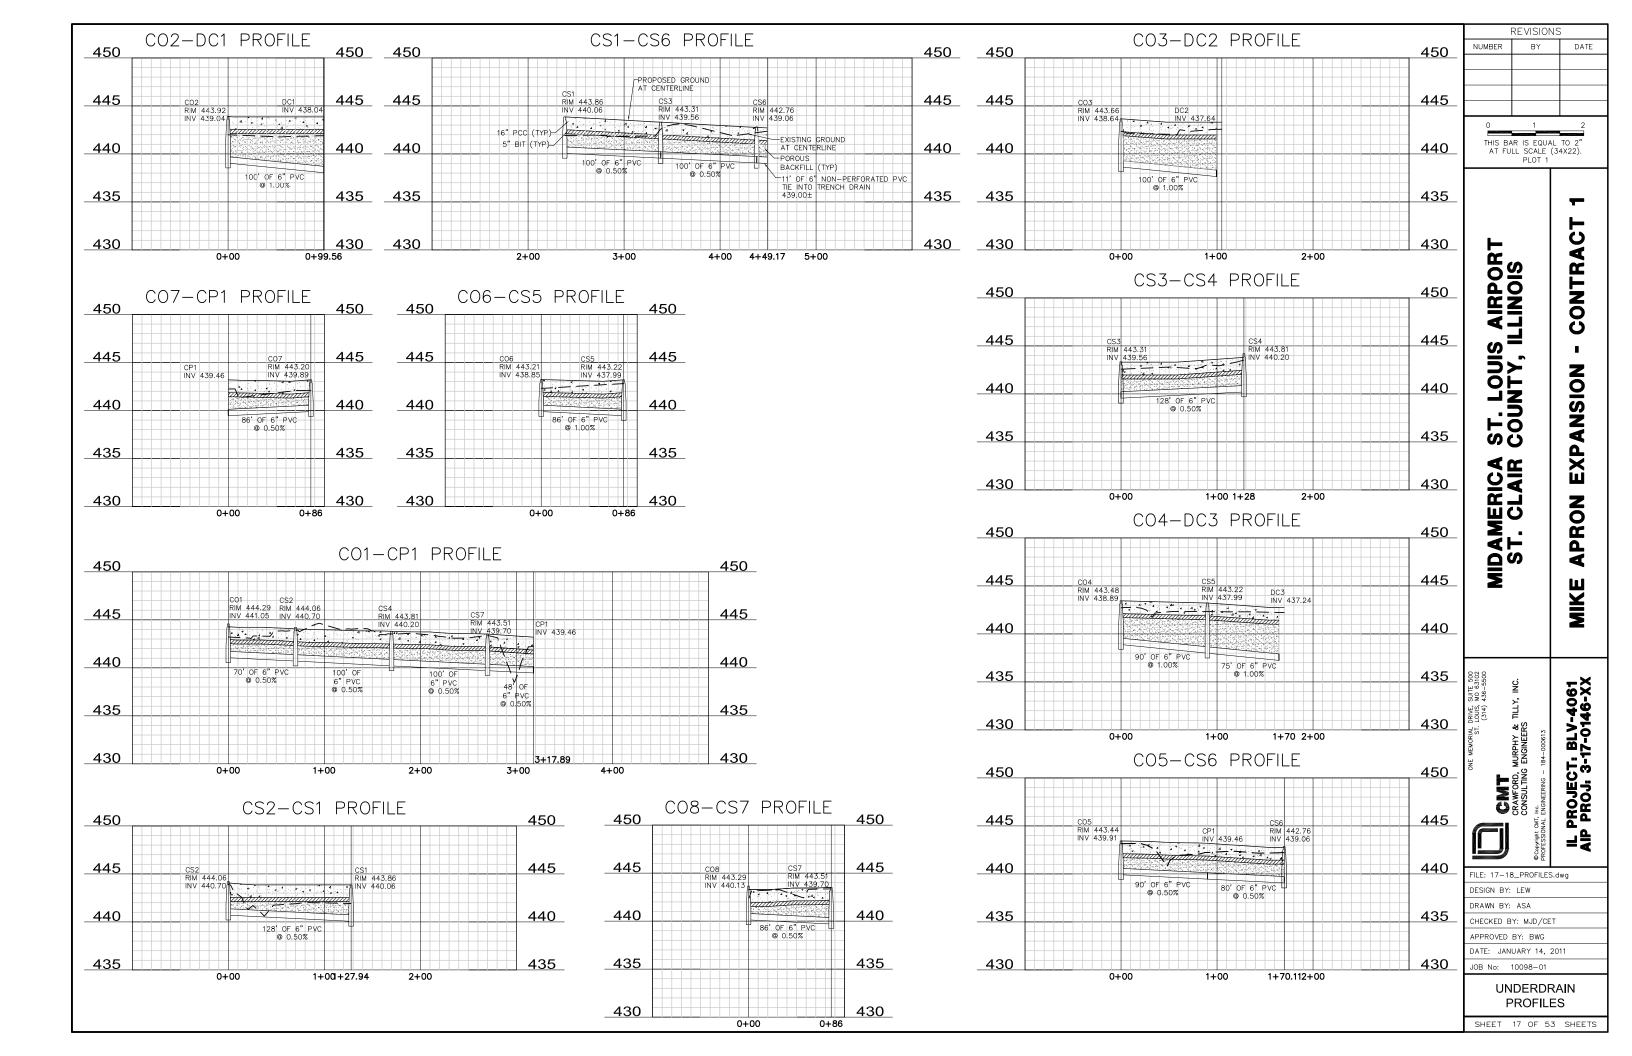
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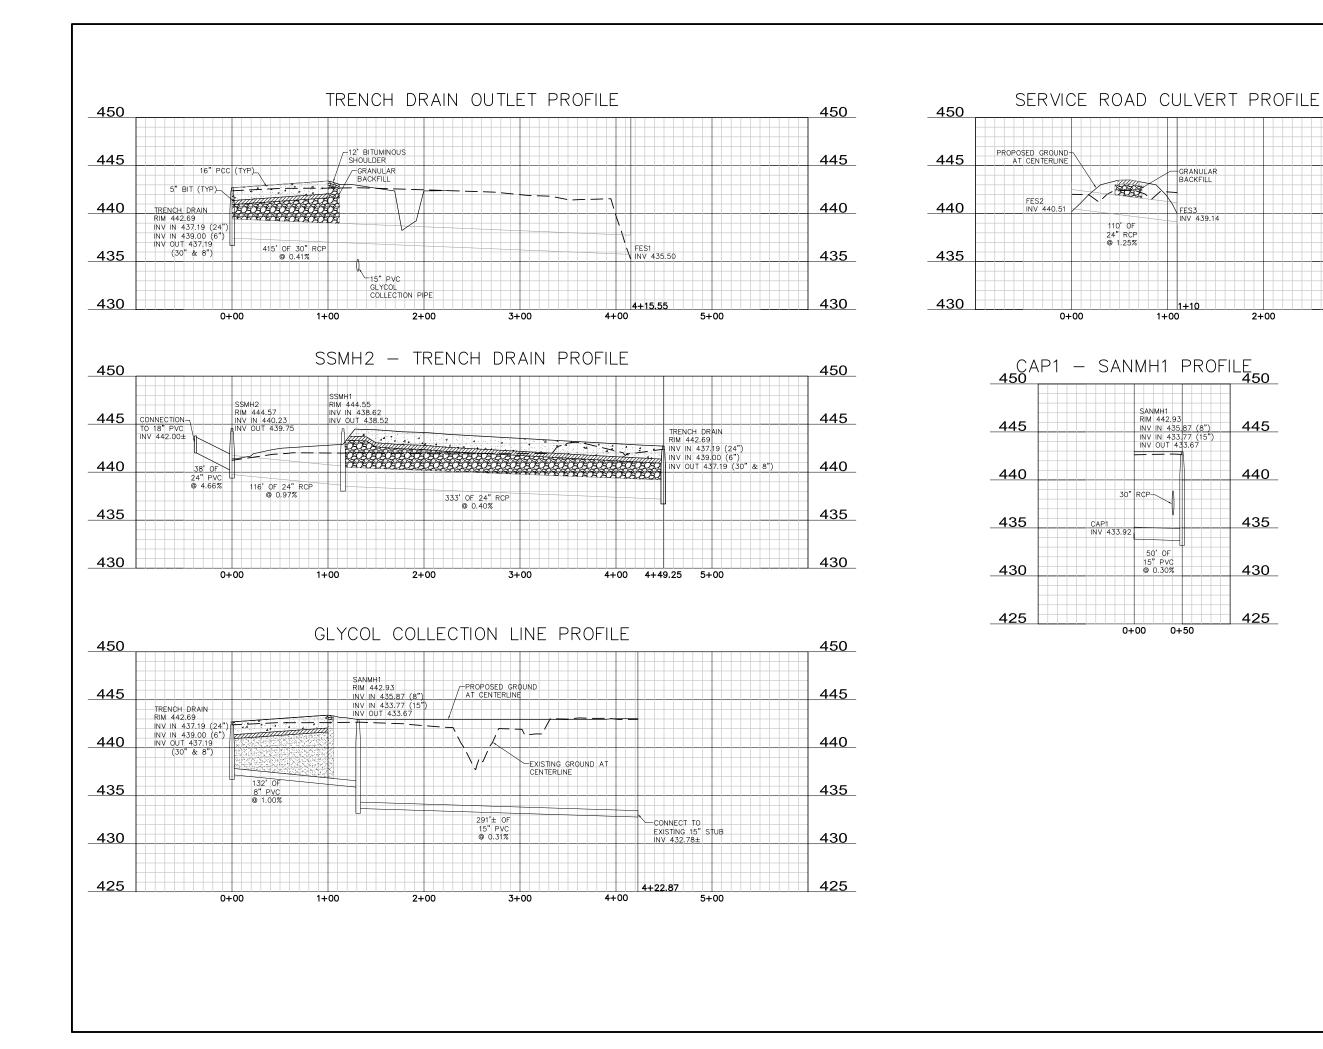
DATE: JANUARY 14, 2011 JOB No: 10098-01

TRENCH DRAIN **DETAILS**

SHEET 16 OF 53 SHEETS





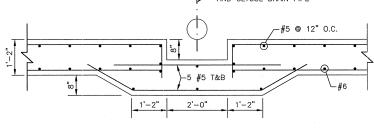

REVISIONS

THIS BAR IS EQUAL TO 2" AT FULL SCALE (34X22). PLOT 1

450

445

440

435

430

ST. LOUIS AIRPORT COUNTY, ILLINOIS

CONTRA

EXPANSION

APRON

MIKE

PROJECT: BLV-4061 PROJ: 3-17-0146-XX

ERICA CLAIR MIDAME ST. (

MURPHY & 1 CRAWFORD,



FILE: 17-18_PROFILES.dwg DESIGN BY: LEW


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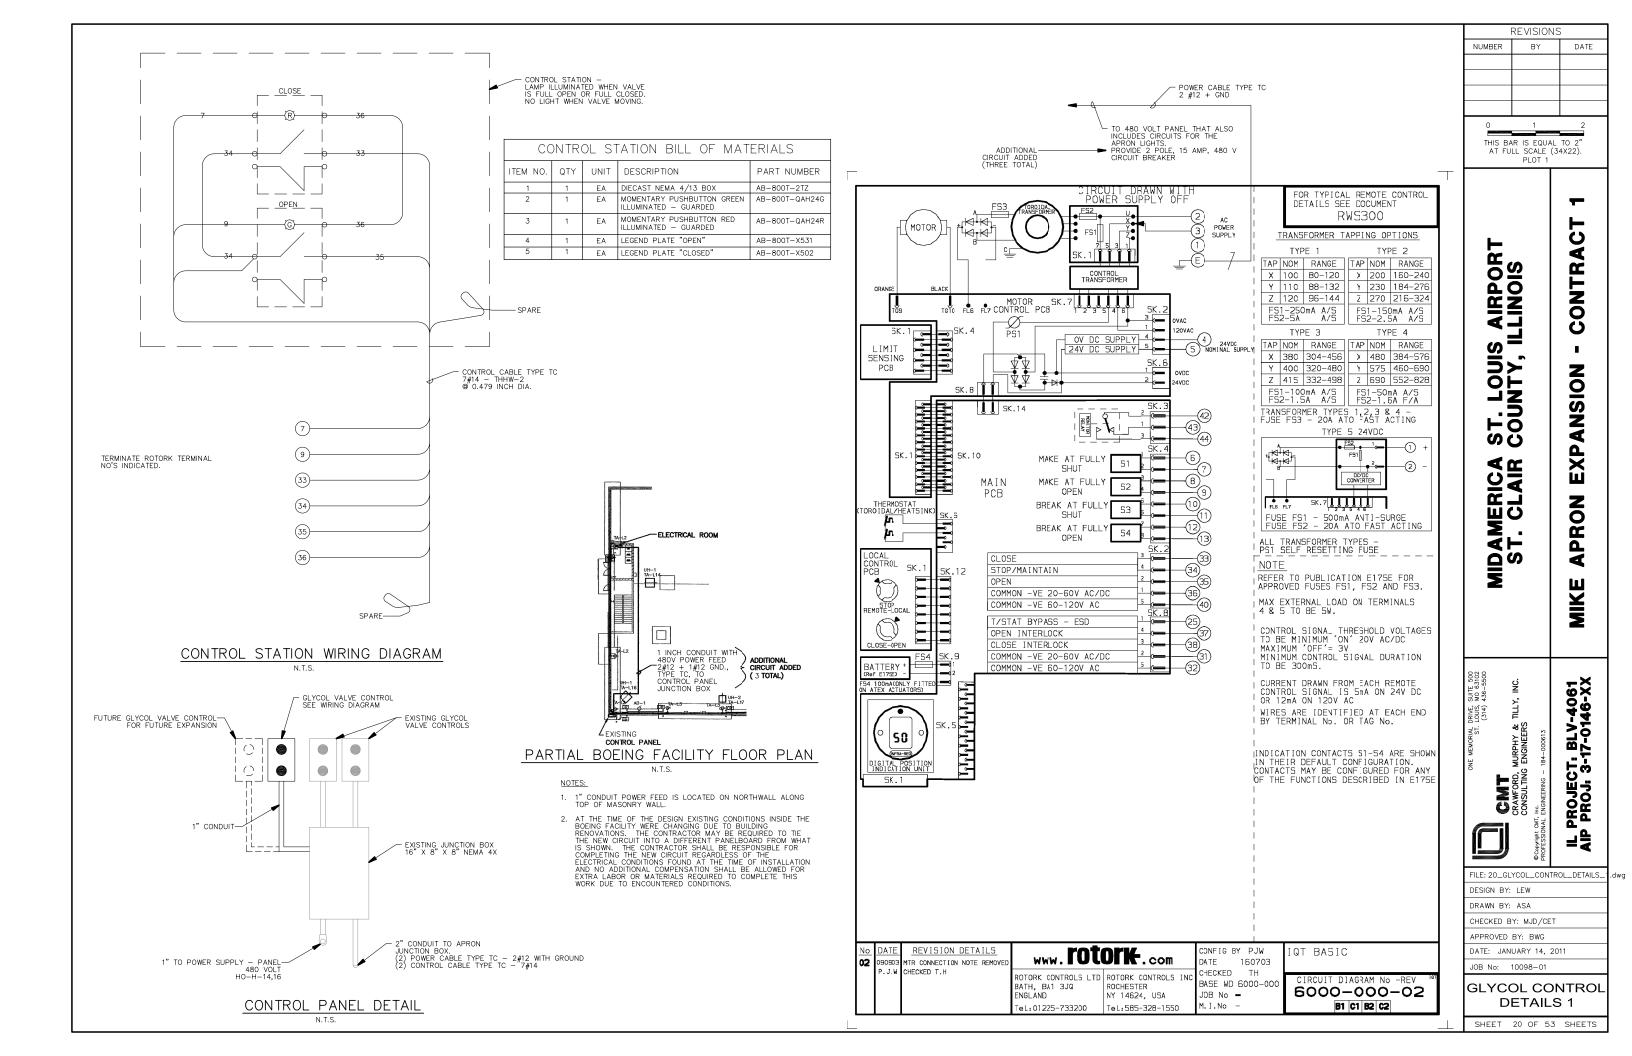
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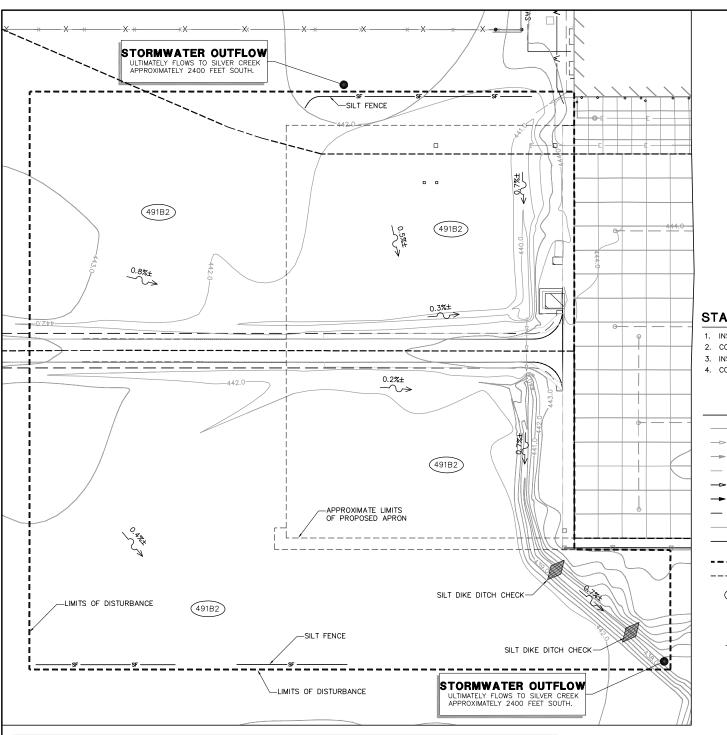
JOB No: 10098-01


STORM SEWER **PROFILES**

SHEET 18 OF 53 SHEETS





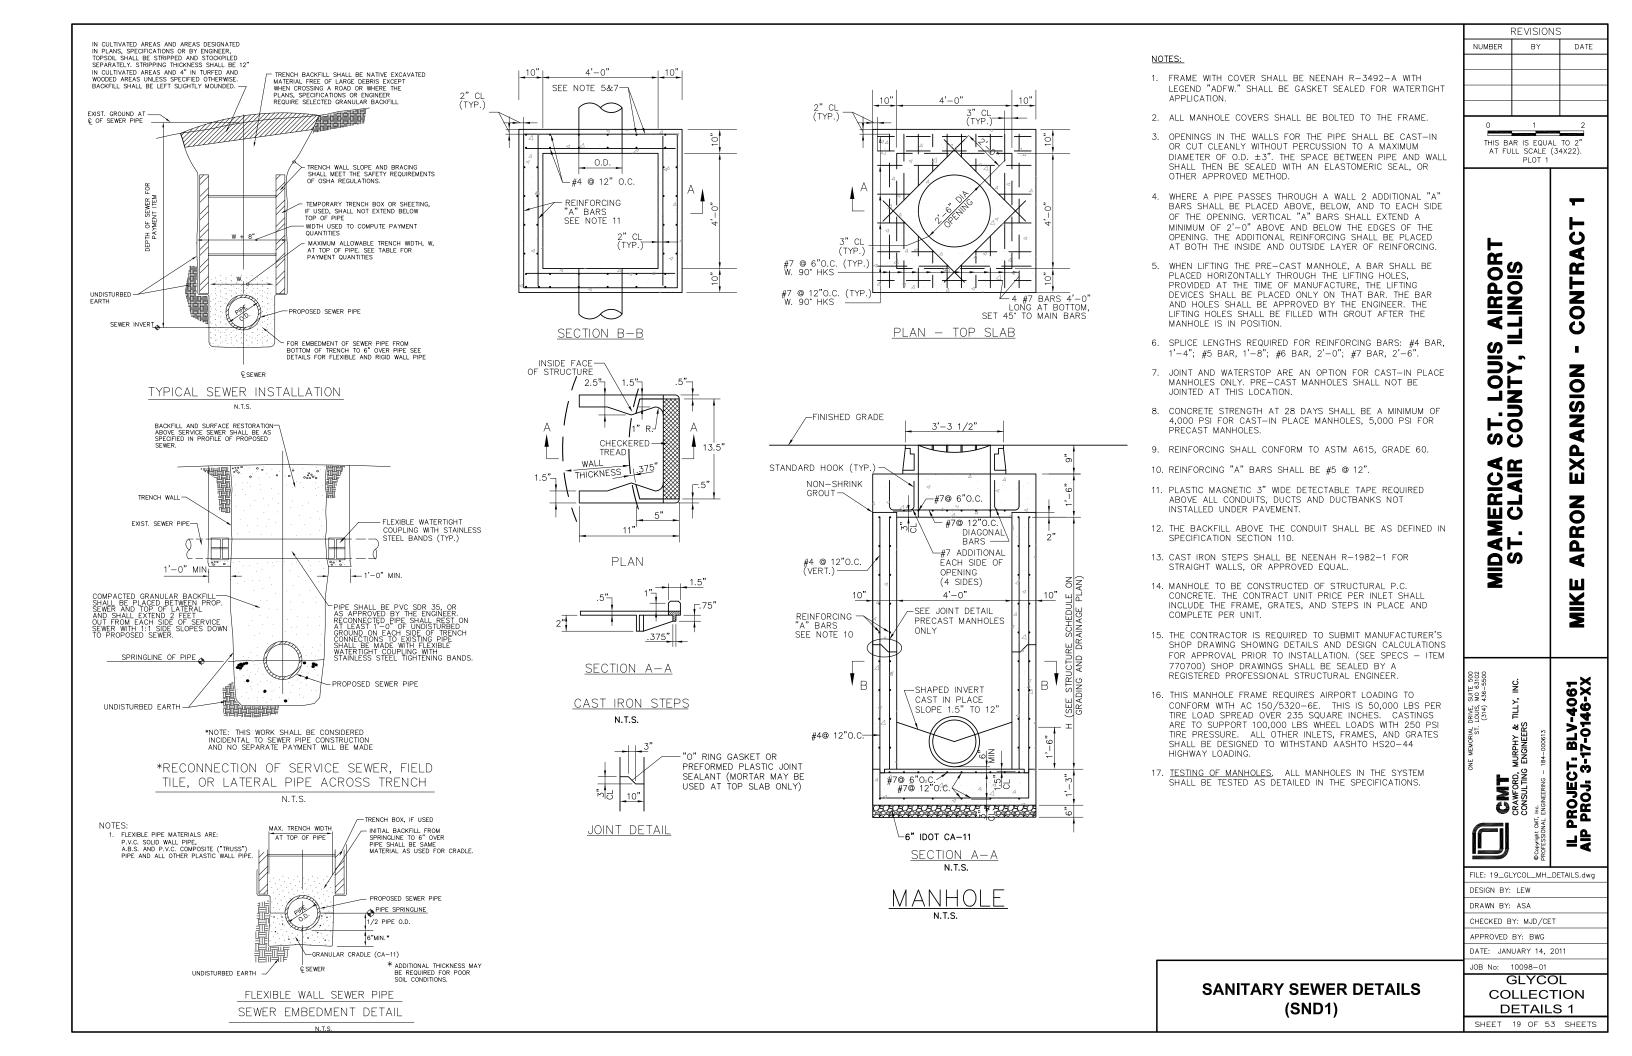

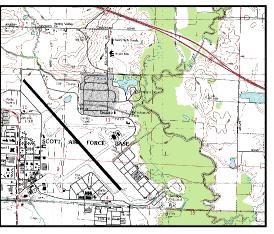

USGS QUADRANGLE MAP 1"=3000


(4) PROJECT LOCATION ardinal Creek 64 (4) Scott AFE cott AFB/ idamerica

LOCATION MAP

STAGE 1 SEQUENCE OF CONSTRUCTION

- 1. INSPECT/MODIFY CHECK DAMS AND SILT DIKES AS NEEDED
- 2. COMPLETE ANY CLEARING & GRUBBING
- 3. INSPECT/STABILIZE/SUPPLEMENT ALL BMPs
- 4. COMPLETE REMAINING WORK

LEGEND

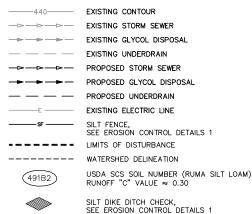



SLOPE ARROW

CONSTRUCTION SEQUENCE NOV DEC JAN FEB MAR APR MAY JUN JUL AUG SEP OCT NOV SEDIMENT CONTROL BASINS STRIP & STOCKPILE TOPSOIL ROUGH GRADE STORM FACILITIE PERMANENT CONTROL STRUCTURES FOUNDATION / BUILDING CONSTRUCTION FINISH GRADING LANDSCAPING/SEED/FINAL STABILIZATION

ST. CLAIR COUNTY PUBLIC

SITE OPERATOR/GENERAL CONTRACTOR

BUILDING COMMISSION

#10 PUBLIC SQUARE BELLEVILLE, IL 62222

SUPERINTENDENT:


SOIL EROSION/SEDIMENTATION CONTROL OPERATION TIME SCHEDULE

) CONTRACTOR SHALL UPDATE THE TABLE BY SHADING OR DATING THE APPLICABLE ACTIVITIES AS PROJECT PROGRESSES. 2) TIME SCHEDULE MUST COINCIDE WITH SEQUENCE OF CONSTRUCTION.

ACREAGE SUMMARY

TOTAL DISTURBED AREA = 9 AC

NOTE: GENERAL CONTRACTOR TO COMPLETE TABLE WITH THEIR SPECIFIC PROJECT SCHEDULE

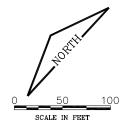

BMP MAINTENANCE NOTES

ALL MEASURES STATED ON THIS EROSION AND SEDIMENT CONTROL PLAN, AND IN THE STORM WATER POLLUTION PREVENTION PLAN, SHALL BE MAINTAINED IN FULLY FUNCTIONAL CONDITION UNTIL NO LONGER REQUIRED FOR A COMPLETED PHASE OF WORK OR FINAL STABILIZATION OF THE SITE. ALL EROSION AND SEDIMENTATION CONTROL MEASURES SHALL BE INSPECTED DAILY BY THE GENERAL CONTRACTOR'S SITE SUPERINTENDENT AND CLEANED AND REPAIRED IN

- 1. INLET PROTECTION DEVICES AND BARRIERS SHALL BE REPAIRED OR REPLACED IF THEY SHOW
- SIGNS OF UNDERMINING, OR DETERIORATION.
 ALL SEEDED AREAS SHALL BE CHECKED REGULARLY TO SEE THAT A GOOD STAND IS
 MAINTAINED. AREAS SHOULD BE FERTILIZED, WATERED, AND RESEDED AS NEEDED.
 SILT FENCES SHALL BE REPAIRED TO THEIR ORIGINAL CONDITIONS IF DAMAGED. SEDIM
- SEDIMENT SHALL BE REMOVED FROM THE SILT FENCES WHEN IT REACHES ONE—HALF THE HEIGHT OF THE SILT FENCE.

 THE CONSTRUCTION EXITS SHALL BE MAINTAINED IN A CONDITION WHICH WILL PREVENT
- TRACKING OF FLOW OF MUD ONTO PUBLIC RIGHTS-OF-WAY. THIS MAY REQUIRE PERIODIC TOP DRESSING OF THE CONSTRUCTION EXITS AS CONDITIONS DEMAND. THE TEMPORARY PARKING AND STORAGE AREA SHALL BE KEPT IN GOOD CONDITION
- (SUITABLE FOR PARKING AND STORAGE). THIS MAY REQUIRE PERIODIC TOP DRESSING OF CSUITABLE FOR PARKING AND STORAGE). THIS MAIT REQUIRE PERIODIC TOP DRESSING OF THE TEMPORARY PARKING AS CONDITIONS DEMAND.

 PRIOR TO LEAVING THE SITE, ALL VEHICLES SHALL BE CLEANED OF DEBRIS. ANY DEBRIS
- AND/OR SEDIMENT REACHING THE PUBLIC STREET SHALL BE CLEANED IMMEDIATELY BY A METHOD OTHER THAN FLUSHING.

GENERAL EROSION & SEDIMENT CONTROL NOTES

- A. THE STORMWATER POLLUTION PREVENTION PLAN IS COMPRISED OF THESE DRAWINGS ("SITE MAPS") THE STANDARD DETAILS, ATTACHMENTS INCLUDED IN SPECIFICATIONS, PLUS THE PERMIT AND ALL SUBSEQUENT REPORTS AND RELATED DOCUMENTS.
- B. ALL CONTRACTORS AND SUBCONTRACTORS INVOLVED WITH STORMWATER POLLUTION PREVENTION SHALL OBTAIN A COPY OF THE STORMWATER POLLUTION PREVENTION PLAN AND THE STATE OF ILLINOIS NATIONAL POLLUTANT DISCHARGE ELIMINATION SYSTEM GENERAL PERMIT (NPDES PERMIT) AND BECOME FAMILIAR WITH THEIR CONTENTS.
- C. CONTRACTOR SHALL IMPLEMENT BEST MANAGEMENT PRACTICES AS REQUIRED BY THE SWPPP. ADDITIONAL BEST MANAGEMENT PRACTICES SHALL BE IMPLEMENTED AS DICTATED BY CONDITIONS AT NO ADDITIONAL COST TO OWNER THROUGHOUT ALL PHASES OF CONSTRUCTION.
- BEST MANAGEMENT PRACTICES (BMP'S) AND CONTROLS SHALL CONFORM TO FEDERAL, STATE, OR LOCAL REQUIREMENTS OR MANUAL FOR PRACTICE, AS APPLICABLE CONTRACTOR SHALL IMPLEMENT ADDITIONAL CONTROLS AS DIRECTED BY PERMITTING AGENCY OR OWNER.
- E. SITE MAP MUST CLEARLY DELINEATE ALL STATE WATERS. PERMITS FOR ANY CONSTRUCTION ACTIVITY IMPACTING STATE WATERS OR REGULATED WETLANDS MUST BE MAINTAINED ON SITE AT ALL
- F. CONTRACTOR SHALL MINIMIZE CLEARING TO THE MAXIMUM EXTENT PRACTICAL OR AS REQUIRED BY
- G. GENERAL CONTRACTOR SHALL DENOTE ON PLAN THE TEMPORARY PARKING AND STORAGE AREA WHICH SHALL ALSO BE USED AS THE EQUIPMENT MAINTENANCE AND CLEANING AREA, EMPLOYEE PARKING AREA, AND AREA FOR LOCATING PORTABLE FACILITIES, OFFICE TRAILERS, AND TOILET
- H. ALL WASH WATER (CONCRETE TRUCKS, VEHICLE CLEANING, EQUIPMENT CLEANING, ETC.) SHALL BE DETAINED AND PROPERLY TREATED OR DISPOSED. ENSURE VEHICLE TIRES ARE CLEANED OFF BEFORE EXITING SITE.
- SUFFICIENT OIL AND GREASE ABSORBING MATERIALS AND FLOTATION BOOMS SHALL BE MAINTAINED ON SITE OR READILY AVAILABLE TO CONTAIN AND CLEAN-UP FUEL OR CHEMICAL SPILLS AND LEAKS.
- DUST ON THE SITE SHALL BE CONTROLLED. THE USE OF MOTOR OILS AND OTHER PETROLEUM BASED OR TOXIC LIQUIDS FOR DUST SUPPRESSION OPERATIONS IS PROHIBITED.
- RUBBISH, TRASH, GARBAGE, LITTER, OR OTHER SUCH MATERIALS SHALL BE DEPOSITED INTO SEALED CONTAINERS. CONTAINERS TO BE EMPTIED AND REMOVED REGULARLY. MATERIALS SHALL BE PREVENTED FROM LEAVING THE PREMISES THROUGH THE ACTION OF WIND OR STORMWATER DISCHARGE INTO DRAINAGE DITCHES OR WATERS OF THE STATE.
- ALL STORMWATER POLLUTION PREVENTION MEASURES PRESENTED ON THIS PLAN, AND IN THE STORMWATER POLLUTION PREVENTION PLAN, SHALL BE INITIATED AS SOON AS PRACTICABLE.
- M. ALL DENUDED AREAS THAT WILL BE INACTIVE FOR 7 DAYS OR MORE (UNLESS CONSTRUCTION ACTIVITY WILL RESUME ON THAT PORTION OF THE SITE WITHIN 14 DAYS), MUST BE STABILIZED TEMPORARILY WITH THE USE OF FAST-GERMINATING ANNUAL GRASS/GRAIN VARIETIES, STRAW/HA MULCH, WOOD CELLULOSE FIBERS, TACKIFIERS, NETTING OR BLANKETS AS SHOWN ON THE SITE MAP
- N. DISTURBED PORTIONS OF THE SITE WHERE CONSTRUCTION ACTIVITY HAS PERMANENTLY STOPPED SHALL BE PERMANENTLY SEEDED. THESE AREAS SHALL BE SEEDED NO LATER THAN 7 DAYS AFTER THE LAST CONSTRUCTION ACTIVITY OCCURRING IN THESE AREAS. REFER TO THE GRADING PLAN AND/OR LANDSCAPE PLAN.
- O. IF THE ACTION OF VEHICLES TRAVELING OVER THE GRAVEL CONSTRUCTION EXITS IS NOT SUFFICIENT TO REMOVE THE MAJORITY OF DIRT OR MUD, THEN THE TIRES MUST BE WASHED BEFORE THE VEHICLES ENTER A PUBLIC ROAD. IF WASHING IS USED, PROVISIONS MUST BE MADE TO INTERCEPT THE WASH WATER AND TRAP THE SEDIMENT BEFORE IT IS CARRIED OFF THE SITE.
- P. ALL MATERIALS SPILLED, DROPPED, WASHED, OR INTO STORM DRAINS MUST BE REMOVED IMMEDIATELY.
- Q. CONTRACTORS OR SUBCONTRACTORS WILL BE RESPONSIBLE FOR REMOVING SEDIMENT IN THE DITCH AND DOWNSTREAM DETENTION BASIN ALONG WITH ANY SEDIMENT THAT MAY HAVE COLLECTED IN THE STORM SEWER DRAINAGE SYSTEMS IN CONJUNCTION WITH THE STABILIZATION OF THE SITE.
- R. ON-SITE & OFF-SITE SOIL STOCKPILE AND BORROW AREAS SHALL BE PROTECTED FROM EROSION AND SEDIMENTATION THROUGH IMPLEMENTATION OF BEST MANAGEMENT PRACTICES. STOCKPILE AND BORROW AREA LOCATIONS SHALL BE NOTED ON THE SITE MAP AND PERMITTED IN ACCORDANCE WITH THE GENERAL PERMIT REQUIREMENTS.
- S. SLOPES SHALL BE LEFT IN A ROUGHENED CONDITION DURING THE GRADING PHASE TO REDUCE RUNOFF VELOCITIES AND EROSION.
- T. DUE TO GRADE CHANGES DURING THE DEVELOPMENT OF THE PROJECT, THE CONTRACTOR SHALL BE RESPONSIBLE FOR ADJUSTING THE EROSION CONTROL MEASURES (SILT FENCES, ETC.) TO PREVENT
- U. SEE SITE PLAN FOR PERMANENT AND TEMPORARY SIGNAGE
- V. GENERAL CONTRACTOR IS TO DESIGNATE/IDENTIFY AREAS ON THE SITE MAPS, INSIDE OF THE LIMITS OF DISTURBANCE, FOR WASTE DISPOSAL AND DELIVERY AND MATERIAL STORAGE.
- W. REFER TO THE SWPPP FOR REPORTABLE SPILL QUANTITIES OF PETROLEUM PRODUCTS AND/OR

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PROJECT, BLV-4061 PROJ: 3-17-0146-XX

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MURPHY & .: ENGINEERS


CHECKED BY: MJD/CET

DRAWN BY: ASA

APPROVED BY: BWG DATE: JANUARY 14, 2011

JOB No: 10098-01 **EROSION CONTROL**


PLAN PHASE 1 SHEET 21 OF 53 SHEETS

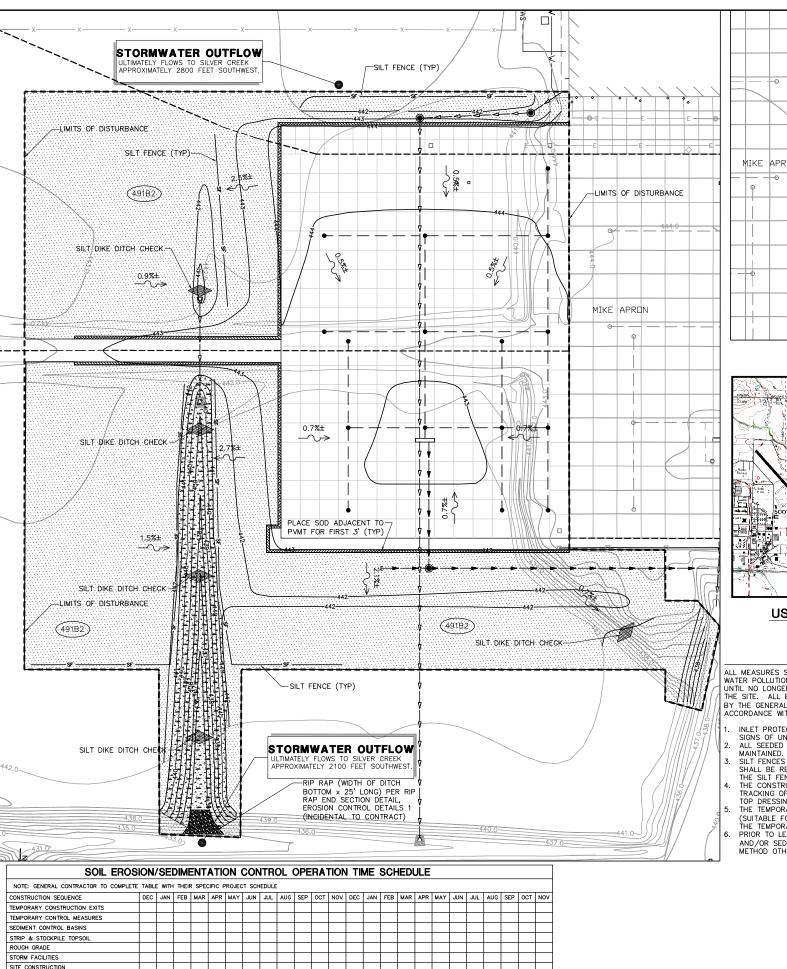


PERMANENT CONTROL STRUCTURES

FOUNDATION / BUILDING CONSTRUCTION

LANDSCAPING/SEED/FINAL STABILIZATION

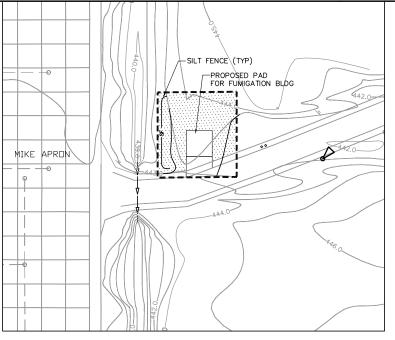

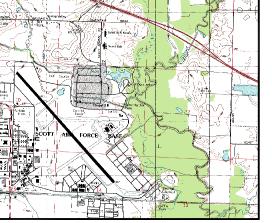


USGS QUADRANGLE MAP

CONTRACTOR SHALL UPDATE THE TABLE BY SHADING OR DATING THE APPLICABLE ACTIVITIES AS PROJECT PROGRESSES.
 TIME SCHEDULE MUST COINCIDE WITH SEQUENCE OF CONSTRUCTION.

BMP MAINTENANCE NOTES

ALL MEASURES STATED ON THIS EROSION AND SEDIMENT CONTROL PLAN, AND IN THE STORM WATER POLLUTION PREVENTION PLAN, SHALL BE MAINTAINED IN FULLY FUNCTIONAL CONDITION UNTIL NO LONGER REQUIRED FOR A COMPLETED PHASE OF WORK OR FINAL STABILIZATION OF THE SITE. ALL EROSION AND SEDIMENTATION CONTROL MEASURES SHALL BE INSPECTED DAILY BY THE GENERAL CONTRACTOR'S SITE SUPERINTENDENT AND CLEANED AND REPAIRED IN ACCORDANCE WITH THE FOLLOWING:

- INLET PROTECTION DEVICES AND BARRIERS SHALL BE REPAIRED OR REPLACED IF THEY SHOW SIGNS OF UNDERMINING, OR DETERIORATION.
- SIGNS OF UNDERMINING, OR DETERIORATION.
 ALL SEEDED AREAS SHALL BE CHECKED REGULARLY TO SEE THAT A GOOD STAND IS
 MAINTAINED. AREAS SHOULD BE FERTILIZED, WATERED, AND RESEEDED AS NEEDED.
 SILT FENCES SHALL BE REPAIRED TO THEIR ORIGINAL CONDITIONS IF DAMAGED. SEDIMENT
 SHALL BE REMOVED FROM THE SILT FENCES WHEN IT REACHES ONE—HALF THE HEIGHT OF
 THE SILT FENCE.
 THE CONSTRUCTION EXITS SHALL BE MAINTAINED IN A CONDITION WHICH WILL PREVENT
 TRACKING OF FLOW OF MUD ONTO PUBLIC RIGHTS—OF—WAY. THIS MAY REQUIRE PERIODIC
 TOP DRESSING OF THE CONSTRUCTION EXITS AS CONDITIONS DEMAND.
 THE TEMPORARY ARRENDE AND STORMED AREA CLAUL BE MEET IN COOD CONDITION.
- THE TEMPORARY PARKING AND STORAGE AREA SHALL BE KEPT IN GOOD CONDITION
- (SUITABLE FOR PARKING AND STORAGE). THIS MAY REQUIRE PERIODIC TOP DRESSING OF THE TEMPORARY PARKING AS CONDITIONS DEMAND.
 PRIOR TO LEAVING THE SITE, ALL VEHICLES SHALL BE CLEANED OF DEBRIS. ANY DEBRIS AND/OR SEDIMENT REACHING THE PUBLIC STREET SHALL BE CLEANED IMMEDIATELY BY A

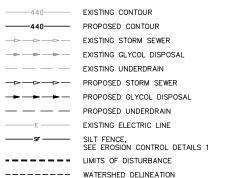

LEGEND

(491B2)

USDA SCS SOIL NUMBER (RUMA SILT LOAM) RUNOFF "C" VALUE ≈ 0.30 SILT DIKE DITCH CHECK, SEE EROSION CONTROL DETAILS 1

-1-1-

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AREA TO RECEIVE SODDING EROSION CONTROL BLANKET, SEE EROSION CONTROL DETAILS 2

AREA TO BE SEEDED

SLOPE ARROW



LOCATION MAP

1"=5000


STAGE 2 SEQUENCE OF CONSTRUCTION

- 1. INSPECT/MODIFY CHECK DAMS AND SILT DIKES AS NEEDED
- 2. COMPLETE ANY CLEARING & GRUBBING
- 3. INSPECT/STABILIZE/SUPPLEMENT ALL BMPs
- 4. COMPLETE REMAINING WORK

PHASE 2 NOTES

- 1. STOCKPILE AREA ALSO TO BE SEEDED AND MULCHED. 2. SEE EROSION CONTROL PLAN PHASE 1 FOR GENERAL EROSION & SEDIMENT CONTROL NOTES (TO REMAIN IMPLEMENTED THROUGHOUT PHASE 2).
- 3. CONTRACTOR IS RESPONSIBLE FOR ALL SITE MAINTENANCE UNTIL THE SITE IS TURNED OVER. THIS INCLUDES MOWING WHERE VEGETATION HAS BEGUN TO GROW BEFORE SUBSTANTIAL COMPLETION.

OWNER: ST. CLAIR COUNTY PUBLIC BUILDING COMMISSION #10 PUBLIC SQUARE BELLEVILLE, 16 62222 618-277-6600 SITE OPERATOR/GENERAL CONTRACTOR SUPERINTENDEN^{*}

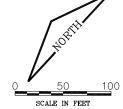

ACREAGE SUMMARY TOTAL DISTURBED AREA = 9 AC

	A CREEK	
0	50	100
	SCALE IN FEET	

EROSION CONTROL PLAN PHASE 2

PHASE 2 EROSION AND SEDIMENTATION CONTROL PLAN / SITE MAP

ST. LOUIS COUNTY, SION ¥ EXP, ERICA CLAIR ZO ¥. PR **∆**S ⋖ MIKE

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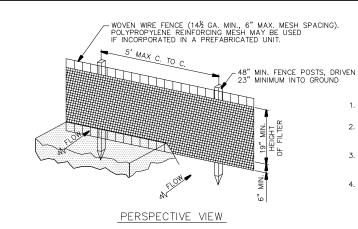
FILE: 22_EROSION_2.dwg DRAWN BY: ASA CHECKED BY: MJD/CET APPROVED BY: BWG DATE: JANUARY 14, 2011

MURPHY & 1 ENGINEERS

CRAWFORD, CONSULTING

SHEET 22 OF 53 SHEETS

JOB No: 10098-01



WOVEN WIRE FENCE (14-1/2 GA.— MIN. MAX. 6" MESH SPACING) WITH FILTER CLOTH COVER - 48" MIN. FENCE POST - UNDISTURBED GROUND EMBEDDED FILTER CLOTH MIN. 6" INTO GROUND SECTION

SILT FENCE DETAIL


- WOVEN WIRE FENCE TO BE FASTENED SECURELY TO FENCE POSTS WITH WIRE TIES OR STAPLES.
- 2. FILTER CLOTH TO BE FASTENED SECURELY TO WOVEN WIRE FENCE WITH TIES SPACED EVERY 24" AT TOP AND MID SECTION.
- 3. WHEN TWO SECTIONS OF FILTER CLOTH ADJOIN EACH OTHER, THEY SHALL BE OVER-LAPPED BY 6" MIN. AND FOLDED.
- 4. MAINTENANCE SHALL BE PERFORMED AS NEEDED AND MATERIAL REMOVED WHEN "BULGES" DEVELOP IN THE SILT FENCE. MAINTENANCE, WHICH INCLUDES THE REPLACEMENT OF DAMAGED FENCE SHALL BE CONSIDERED INCIDENTAL TO THE COST OF THE EROSION CONTROL FENCE.

POSTS: STEEL EITHER T OR U TYPE OR 2" HARDWOOD

FENCE: WOVEN WRE, 14-1/2 GA.
6" MAX MESH OPENING
POLYPROPYLENE MESH,
IF INCORPORATED IN PREFAB UNIT.

FILTER CLOTH: FILTER X, MIRAF1100X, STABILINKA T140N OR EQUAL

PREFABRICATED UNIT: GEOFAB ENVIROFENCE, GSI SILT FENCE WITH REINFORCING MESH OR EQUAL.

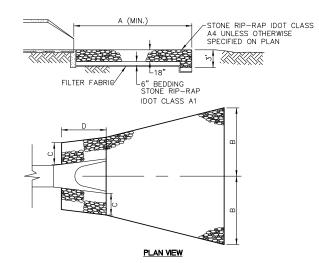


INSIDE DIAMETER STORM SEWER	ИІМ	I. DIMEN	ISION (FT)
(IN.)	А	В	С	D
12" thru 24"	15	4	1.5	4
27" thru 30"	18	5	2.0	6
36" thru 48"	22	6	2.5	8
54" thru 60"	25	7	3.0	10


MAINTENANCE NOTES:

- INSPECT RIP RAP AFTER STORM EVENTS FOR STONE DISPLACEMENT AND FOR EROSION AT THE SIDES AND ENDS OF THE APRON.
- 2. TAKE NEEDED REPAIRS IMMEDIATELY; USE APPROPRIATE SIZE STONE, AND DO NOT PLACE THEM ABOVE FINISHED GRADE.
- 3. THE ENGINEER SHALL DETERMINE THE FINAL RIP-RAP CONFIGURATION IN THE FIELD.
- 4. COST OF RIP-RAP SHALL BE INCIDENTAL TO FLARED END SECTION WORK.

RIP RAP AT END SECTIONS

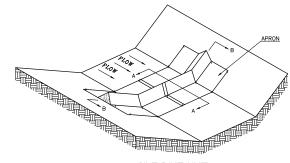

SILT DIKE UNIT CUT SECTION

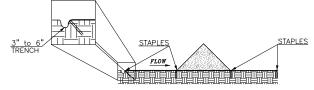

DETAIL A-A

OSTAPLES SHALL BE PLACED WHERE THE UNITS OVERLAP AND IN THE CENTER OF THE 7' UNIT AS SHOWN ONTHE DIAGRAMS OSTAPLES POINT "B"

OPOINT "A" MUST BE HIGHER THAN POINT "B" TO ENSURE THAT WATER FLOWS OVER THE DIKE AND NOT AROUND THE ENDS.

DIKE SECTION DETAIL B-B

SILT DIKE DITCH CHECK

THIS BAR IS EQUAL TO 2' AT FULL SCALE (34X22).
PLOT 1 AIRPORT LINOIS ST. LOUIS COUNTY, ERICA CLAIR ¥. **⊡**S ₹ MEMORIAL DRIVE, S ST. LOUIS, 1 (314) MURPHY & 1 CRAWFORD, CONSULTING FILE: 23-24_EC_DETAILS.dwg DESIGN BY: LEW DRAWN BY: ASA

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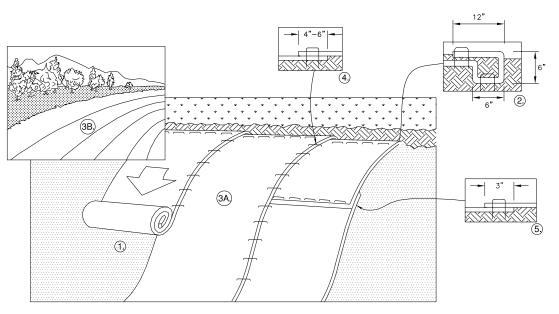
PROJECT, BLV-4061 PROJ, 3-17-0146-XX

CHECKED BY: MJD/CET APPROVED BY: BWG DATE: JANUARY 14, 2011 JOB No: 10098-01

EROSION

CONTROL **DETAILS 1** SHEET 23 OF 53 SHEETS

NUMBER




- 1. PREPARE SOIL BEFORE INSTALLING BLANKETS, INCLUDING ANY NECESSARY APPLICATION OF LIME, FERTILIZER, AND SEED.
- 2. BEGIN AT THE TOP OF THE SLOPE BY ANCHORING THE BLANKET IN A 6" DEEP X 6" WIDE TRENCH WITH APPROXIMATELY 12" OF BLANKET EXTENDED BEYOND THE UP-SLOPE PORTION OF THE TRENCH. ANCHOR THE BLANKET WITH A ROW OF STAPLES/STAKES APPROXIMATELY 12" APART IN THE BOTTOM OF THE TRENCH. BACKFILL AND COMPACT THE TRENCH AFTER STAPLING. APPLY SEED TO COMPACTED SOIL AND FOLD REMAINING 12" PORTION OF BLANKET BACK OVER SEED AND COMPACTED SOIL. SECURE BLANKET OVER COMPACTED SOIL WITH A ROW OF STAPLES/STAKES SPACED APPROXIMATELY 12" APART ACROSS THE WIDTH OF THE BLANKET.
- 3. ROLL THE BLANKETS (A.) DOWN OR (B.) HORIZONTALLY ACROSS THE SLOPE. BLANKETS WILL UNROLL WITH APPROPRIATE SIDE AGAINST THE SOIL SURFACE. ALL BLANKETS MUST BE SECURELY FASTENED TO SOIL SURFACE BY PLACING STAPLES/STAKES IN APPROPRIATE LOCATIONS AS PER MANUFACTURES RECOMMENDATION.
- 4. THE EDGES OF PARALLEL BLANKETS MUST BE STAPLED WITH MINIMUM 6" OVERLAP. TO ENSURE PROPER SEAM ALIGNMENT, PLACE THE EDGE OF THE OVERLAPPING BLANKET (BLANKET BEING INSTALLED ON TOP) EVEN WITH THE SEAM STITCH ON THE PREVIOUSLY INSTALLED BLANKET.
- 5. CONSECUTIVE BLANKETS SPLICED DOWN THE SLOPE MUST BE PLACED END OVER END (SHINGLE STYLE) WITH AN APPROXIMATE 3" OVERLAP. STAPLE THROUGH OVERLAPPED AREA, APPROXIMATELY 12" APART ACROSS ENTIRE
- 6. PLACE STAPLES/STAKES PER MANUFACTURE RECOMMENDATION FOR THE APPROPRIATE SLOPE BEING APPLIED.

1. IN LOOSE SOIL CONDITIONS, THE USE OF STAPLE OR STAKE LENGTHS GREATER THAN 6" MAY BE NECESSARY TO PROPERLY SECURE THE BLANKETS.

EROSION CONTROL BLANKET

CONCRETE WASHOUT AREA NOTES:

- IF THE CONTRACTOR CHOOSES TO WASHOUT THE CHUTE OF ANY CONCRETE TRUCK, AN APPROVED WASHOUT AREA SHALL BE CONSTRUCTED NEAR THE CONTRACTOR'S STAGING AREA.
- 2. THE WASHOUT AREA SHALL CONSIST OF A TEMPORARY PIT THAT IS LARGE ENOUGH TO CONTAIN ALL LIQUID AND WASTE CONCRETE MATERIALS FROM WASHOUT.
- 3. THE WASHOUT PIT SHALL BE LINED WITH 10 MIL POLYETHYLENE TO CONTROL SEEPAGE. THE LINING SHALL BE SEAMLESS WITH NO HOLES OR PUNCTURES.
- 4. ONLY WASHOUT OF CHUTES WILL BE PERMITTED ONSITE. TRUCK DRUMS AND BEDS SHALL BE WASHED OUT OFFSITE AT AN APPROVED LOCATION.
- 5. A SIGN SHALL BE POSTED AT THE WASHOUT LOCATION. SEE DETAIL THIS SHEET.
- PRIOR TO FINAL COMPLETION OF THE PROJECT THE CONTRACTOR SHALL REMOVE THE WASHOUT PIT, GRADE THE AREA BACK TO ITS ORIGINAL GROUND LINE, AND RESTORE ANY DISTURBED TURF TO THE SATISFACTION OF THE ENGINEER.
- 7. ALL COSTS ASSOCIATED WITH CONSTRUCTING, MAINTAINING, REMOVING, AND RESTORING THE TEMPORARY WASHOUT PIT SHALL BE CONSIDERED INCIDENTAL TO THE CONTRACT.

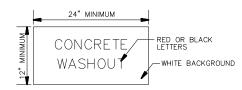

CONCRETE WASHOUT SIGN

- 1. LETTERS SHALL BE A MINIMUM OF 2" WIDE AND 3" TALL.
- 2. SIGN SHALL BE CONSTRUCTED OF A RIGID MATERIAL SUCH AS METAL, PLYWOOD, OR OUTDOOR SIGN BOARD.
- 3. SIGN SHALL BE PLACED IN A VISIBLE LOCATION NEAR THE APPROVED WASHOUT AREA.

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PROJECT, BLV-4061 PROJ, 3-17-0146-XX

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MURPHY & 1 ENGINEERS

SUITE 500 MO 63102 436-5500

MEMORIAL DRIVE, S ST. LOUIS, (314)

CRAWFORD, CONSULTING

FILE: 23-24_EC_DETAILS.dwg

DESIGN BY: LEW DRAWN BY: ASA


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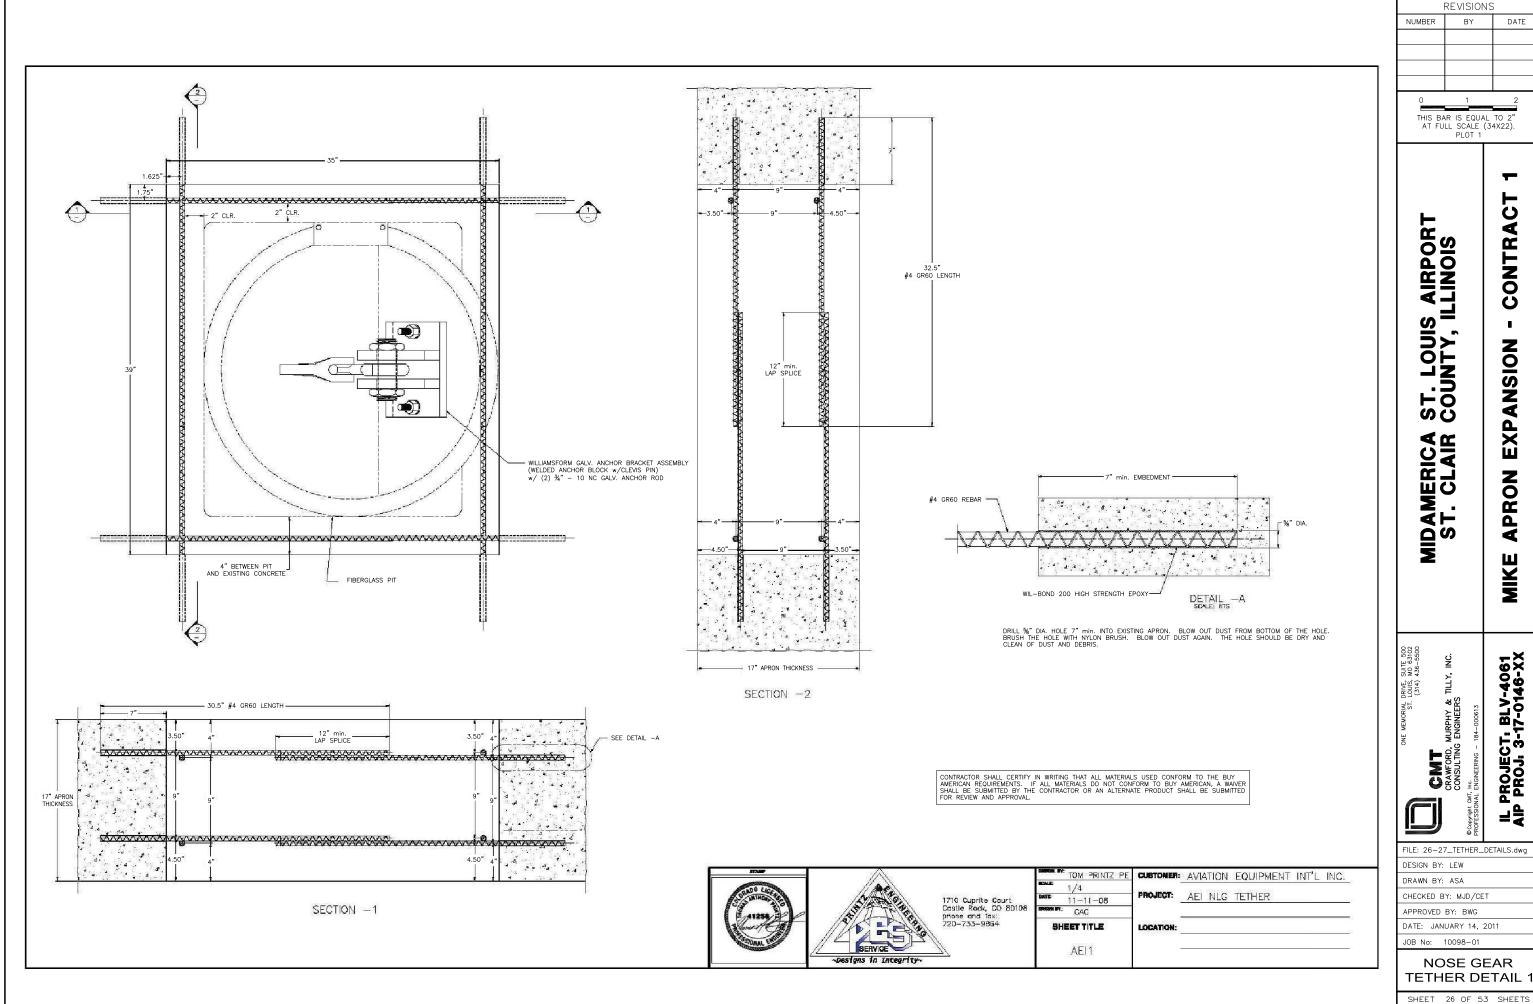
APPROVED BY: BWG DATE: JANUARY 14, 2011

JOB No: 10098-01


EROSION CONTROL **DETAILS 2**


SHEET 24 OF 53 SHEETS




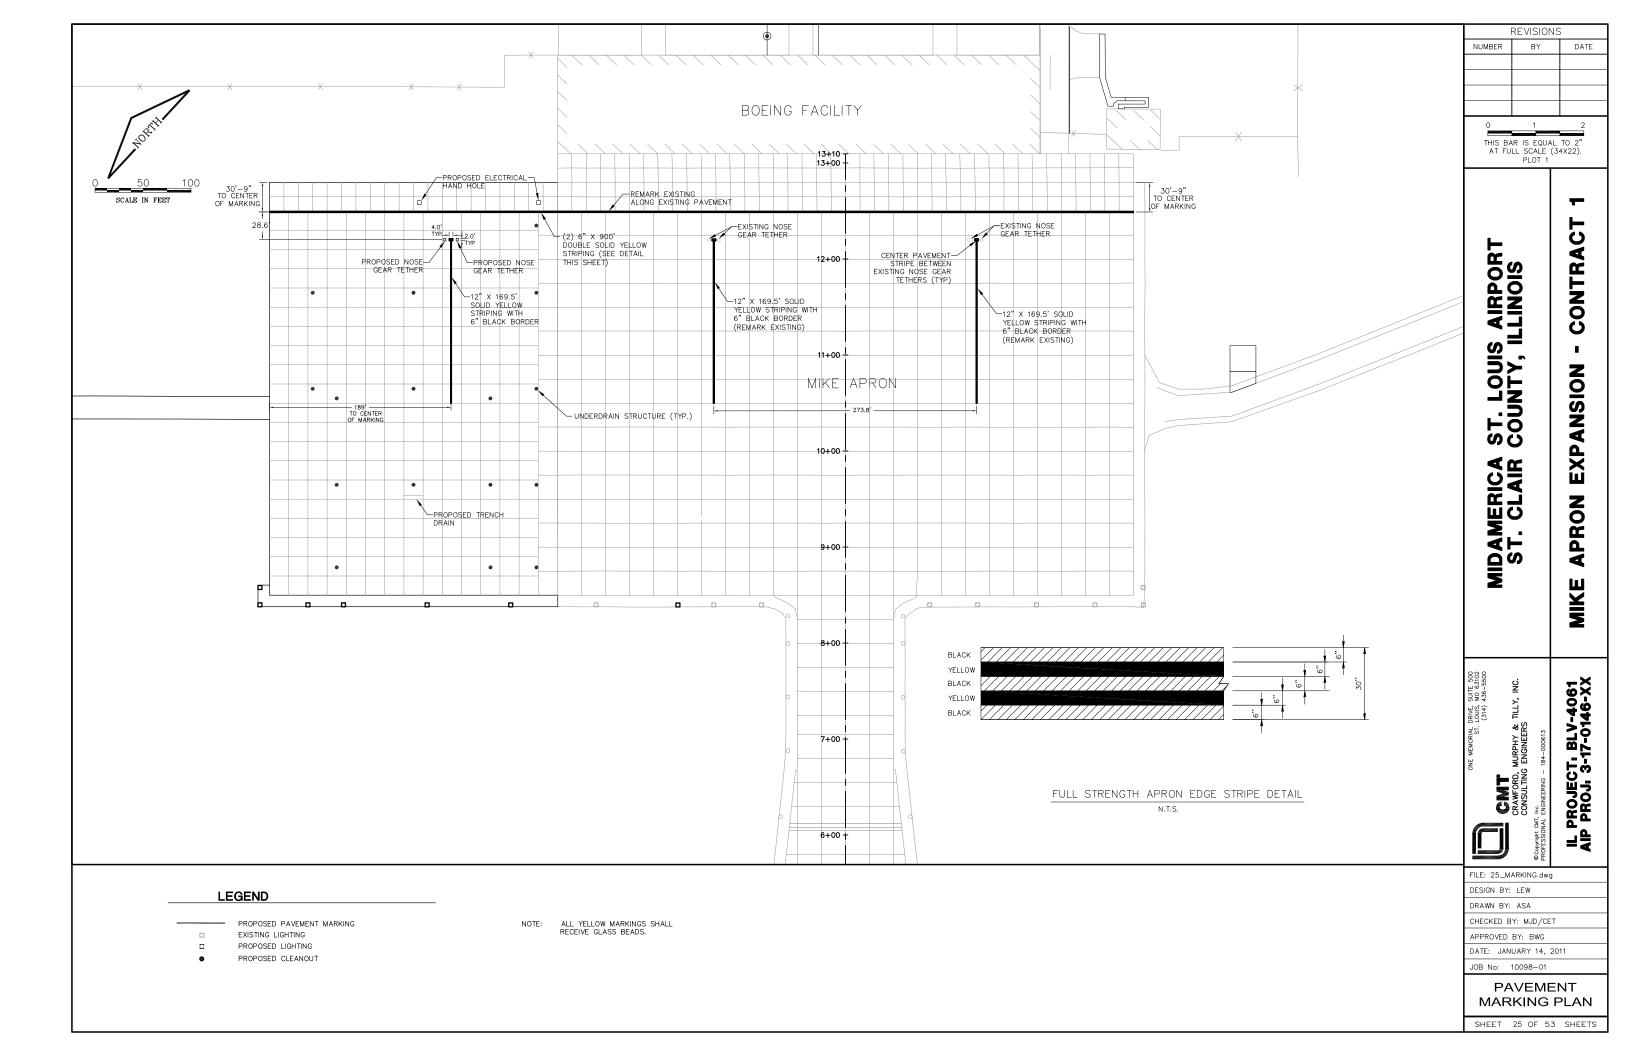

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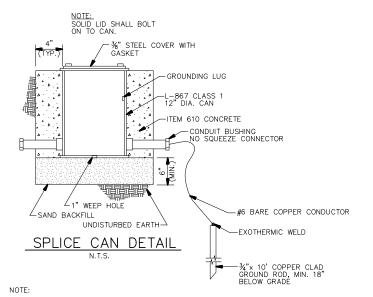
6" SAND CUSHION-COMPACTED

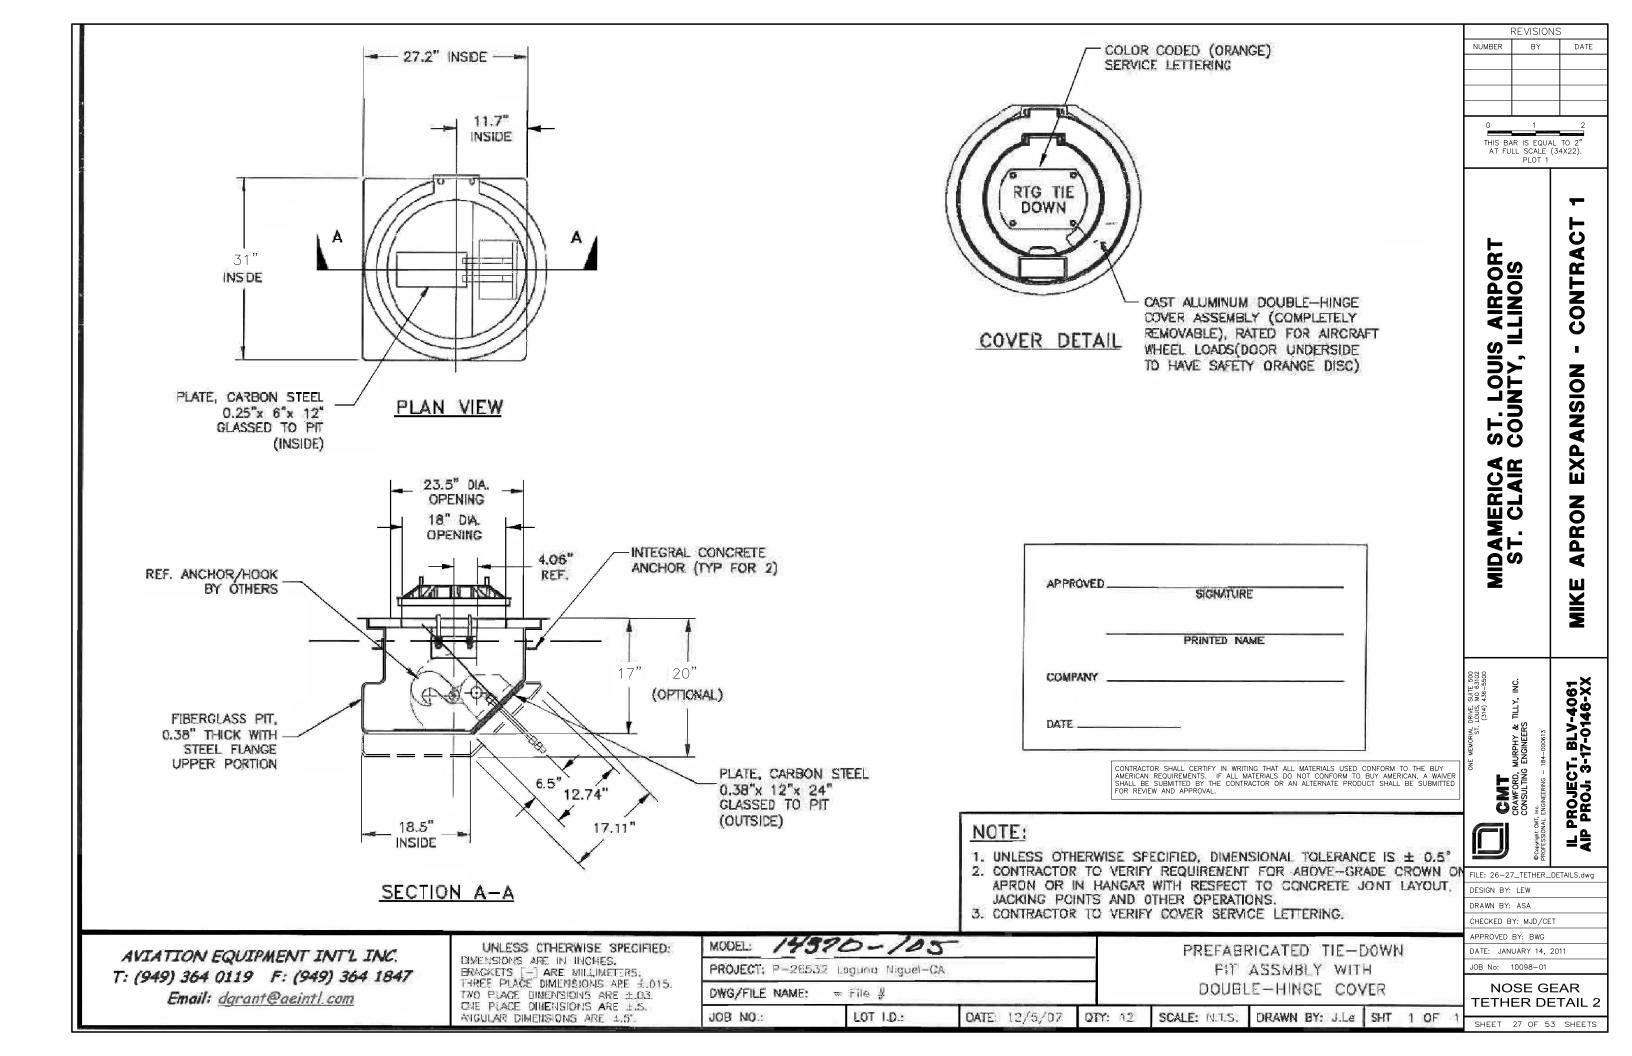BASE MOUNTED MEDIUM INTENSITY LED LIGHTS

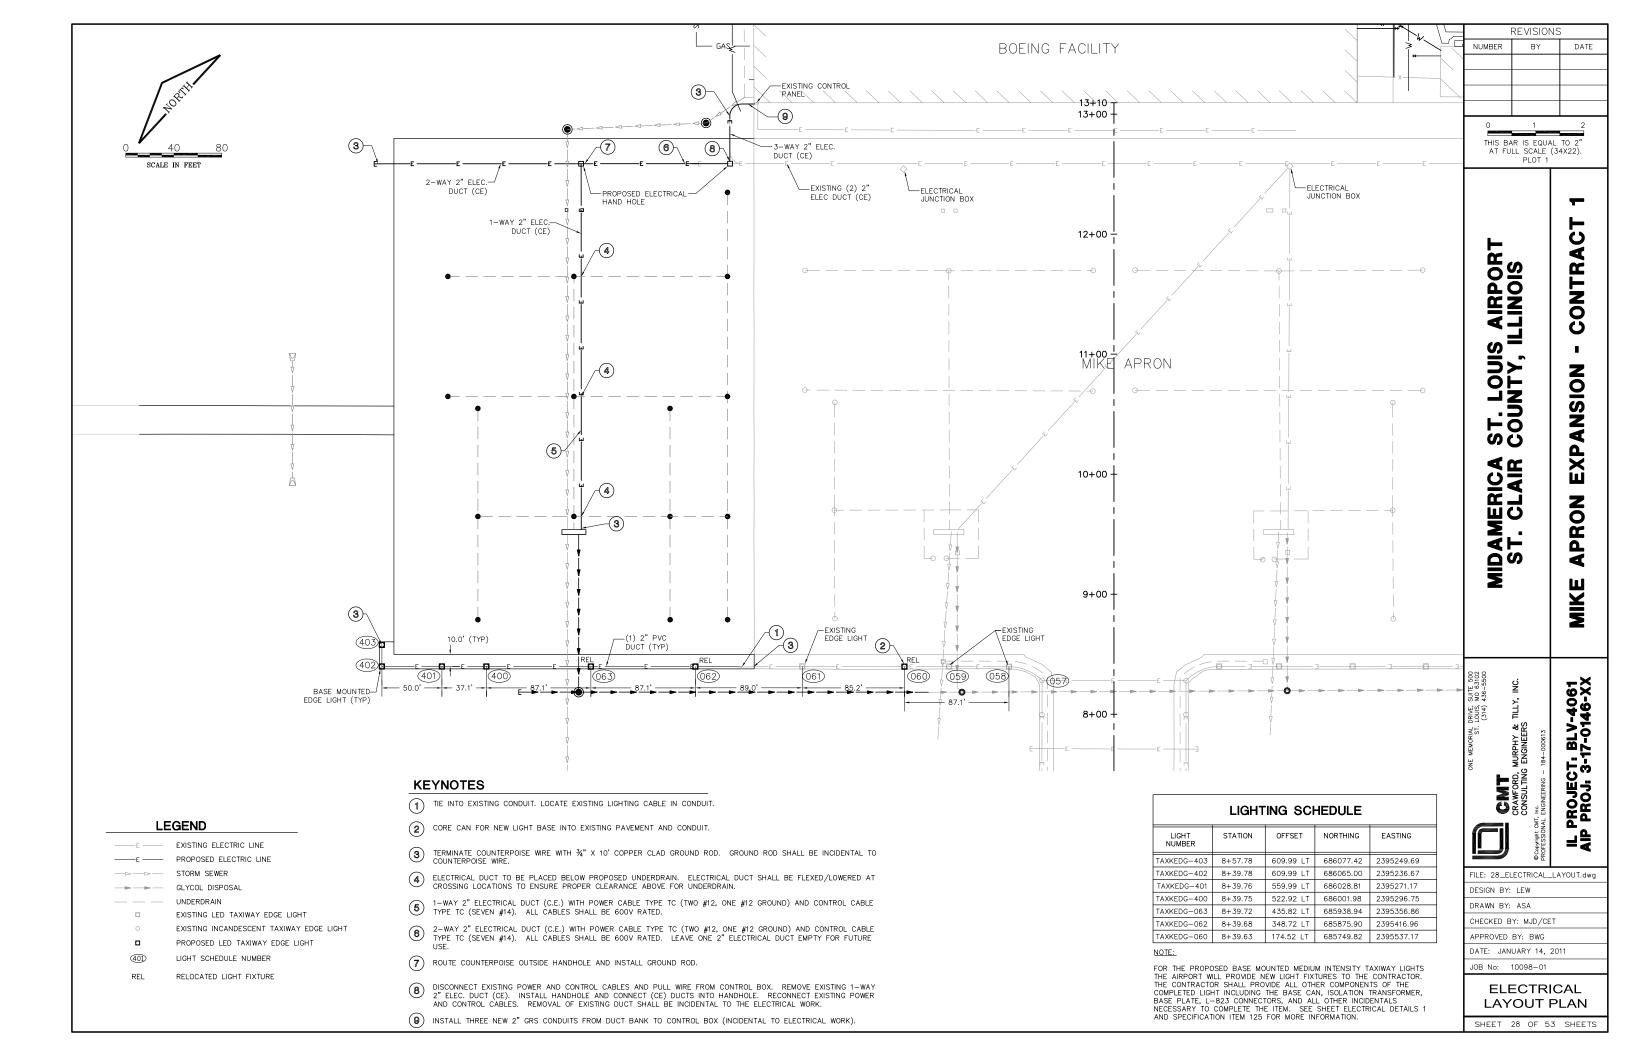∠3/4" DIA. WEEP HOLE 24" ROUND

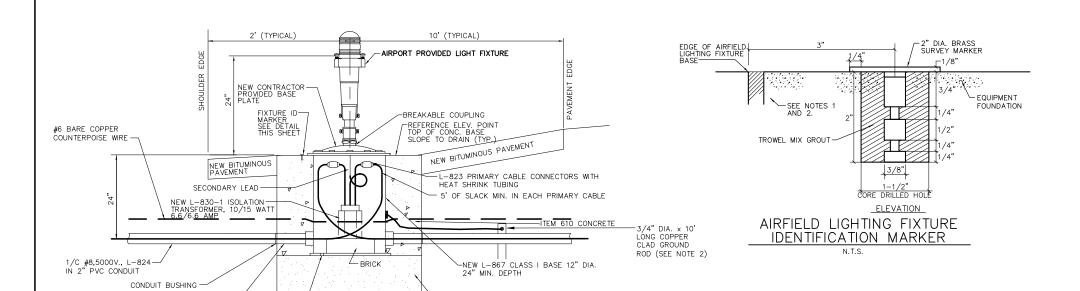2" CARLON P&C FLEX-CORRUGATED FLEXIBLE CONDUIT, OR EQUAL


- INSTALL 2" FLEXIBLE CONDUIT BETWEEN CAN AND PVC CONDUIT UNDER PAVED SHOULDER.
- INSTALL 1/C #6 AWG BARE COPPER GROUND JUMPER CONNECTED TO GROUND LUG OUTSIDE BASE CAN AND EXOTHERMICALLY WELD TO TO GROUND ROD.
- NEW TAXIWAY EDGE LIGHT WILL BE PROVIDED BY THE AIRPORT FOR INSTALLATION BY THE CONTRACTOR. THE LIGHT PROVIDED BY THE AIRPORT WILL BE CROUSE—HINDS (8615—T2—B—066—24) WITHOUT ABOVE VIEW.
- COPPER CLAD GROUND ROD SHALL BE LOCATED OPPOSITE COUNTERPOISE WIRE WITH RESPECT TO CAN AND THE TWO SEPARATED BY MIN. OF 12". COUNTERPOISE WIRE SHALL NOT BE BONDED TO CAN.
- INSTALL LIGHT AFTER COMPLETION OF NEW BITUMINOUS SHOULDER PAVEMENT BY CORING THROUGH PAVEMENT.
- CONTRACTOR MAY INSTALL AN ADJUSTABLE TWO PIECE CAN AND INSTALL THE BOTTOM HALF PRIOR TO PAVING THE BITUMINOUS SHOULDER. IF THIS METHOD IS USED, THE TOP HALF SHALL BE INSTALLED BY CORING THROUGH THE BITUMINOUS PAVEMENT TO EXPOSE THE BOTTOM HALF.



FOR USE WHEN EXISTING CABLE IS CUT AND SPLICED. SPLICES SHALL BE MADE INSIDE A NEW SPLICE CAN. COST OF SPLICE CAN WHEN USED TO REPAIR A CUT CABLE IS INCIDENTAL TO THE CONTRACT. ALSO FOR USE FOR THE INSTALLATION OF THE FUMIGATION FACILITY AS SHOWN ON THE FUMIGATION BLDG PLAN SHEET.



TOP VIEW AIRFIELD LIGHTING FIXTURE IDENTIFICATION MARKER

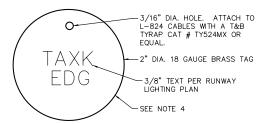

L-824 CABLE IDENTIFICATION TAG

NOTES:

- FOR IDENTIFICATION NUMBERS, SEE ELECTRICAL LAYOUT PLAN. CONTRACTOR SHALL VERIFY NUMBERING WITH AIRPORT PRIOR TO ORDERING MARKERS.
- 2. ALL AIRFIELD LIGHTING EQUIPMENT SHALL BE IDENTIFIED WITH A BRASS SURVEY MARKER. ITEMS REQUIRING ID MARKERS ARE:

JUNCTION BOXES MANHOLES TAXIWAY LIGHTS

- 3. L-823 CONNECTORS SHALL BE INSTALLED ON L-023 CONNECTORS SHALL BE INSTALLED ON ALL CABLES, IN EACH MANHOLE, BASE CANS, OR OTHER ACCESSIBLE LOCATIONS. L-823 CONNECTORS SHALL BE INSTALLED SO A PORTION OF THE LOOP CAN BE BYPASSED.
- 4. ALL AIRFIELD LIGHTING CIRCUITS SHALL BE IDENTIFIED WITH A BRASS TAG WITH ITS RESPECTIVE CIRCUIT/LOOP NUMBER AT ALL ACCESSIBLE LOCATIONS. ATTACH THE ID TAG TO BOTH CABLES 12" FROM THE

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CRAWFORD, CONSULTING

FILE: 29-32 FLECTRICAL DETAILS.dw


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CHECKED BY: MJD/CET APPROVED BY: BWG

DATE: JANUARY 14, 2011 JOB No: 10098-01


> **ELECTRICAL DETAILS 1**


SHEET 29 OF 53 SHEETS

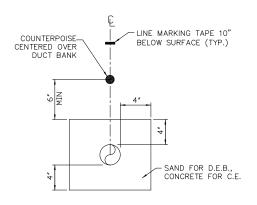

2" PVC (DEB) OR 2" PVC (CE) DETAIL


NOT TO SCALE

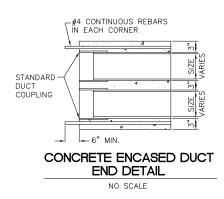

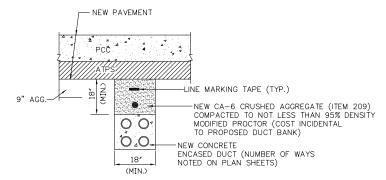

CONCRETE ENCASED DUCT BACKFILL

NOT TO SCALE

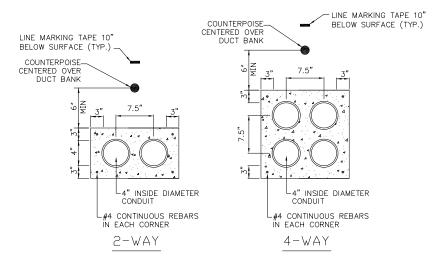



CONCRETE ENCASED DUCT BANKS

NOT TO SCALE

NOTES:

- 1. DIMENSIONS ARE MINIMUM.
- 2. CONCRETE SHALL CONFORM TO ITEM 610.
- 3. ALL CONDUIT SHALL BE SCHEDULE 40 PVC.
- 4. TOP OF CONCRETE ENCASEMENT IN TURF AREAS SHALL NOT BE LESS THAN 24" BELOW FINISHED

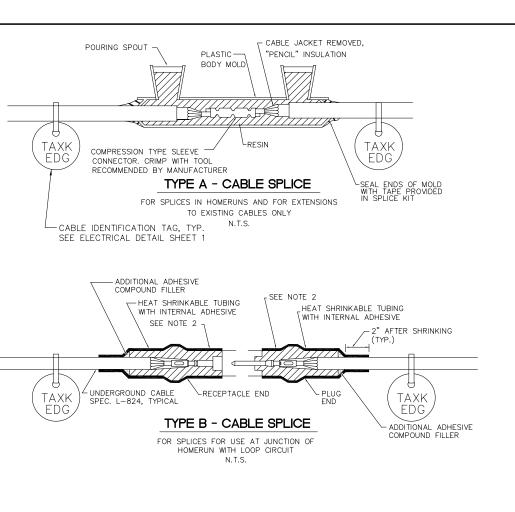

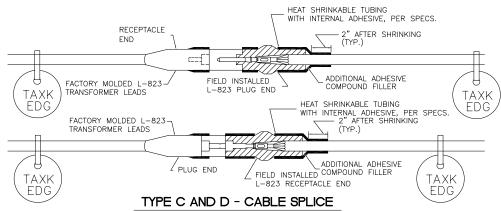

FOR SPLICES AT RUNWAY/TAXIWAY LIGHTS AND SIGNS N.T.S.

NOTES

- INSIDE DIAMETER OF CONNECTOR SHALL PROPERLY MATCH THE OUTSIDE DIAMETER OF CABLE.
- 2. WRAP WITH AT LEAST ONE LAYER OF RUBBER OR SYNTHETIC RUBBER TAPE AND ONE LAYER OF PLASTIC TAPE, ONE—HALF LAPPED, EXTENDING AT LEAST 1-1/2 INCHES ON EACH SIDE OF JOINT.
- 3. THE COST OF FURNISHING AND INSTALLING ALL SPLICE MATERIALS SHALL BE INCIDENTAL TO THE ASSOCIATED CABLE ITEMS.
- 4. THE CONTRACTOR SHALL HAVE A MINIMUM OF TWO (2) TYPE A SPLICE KITS ON THE JOB SITE AT ALL TIMES FOR EMERGENCY REPAIRS.

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> PROJECT, BLV-4061 PROJ, 3-17-0146-XX MURPHY & 1 ENGINEERS

CRAWFORD, CONSULTING

FILE: 29-32 ELECTRICAL DETAILS.dw DESIGN BY: LEW DRAWN BY: ASA


CHECKED BY: MJD/CET APPROVED BY: BWG

DATE: JANUARY 14, 2011 JOB No: 10098-01

> **ELECTRICAL DETAILS 2**

SHEET 30 OF 53 SHEETS

ELECTRICAL HANDHOLE SHALL BE AS SHOWN ON THIS SHEET OR AN APPROVED EQUAL.

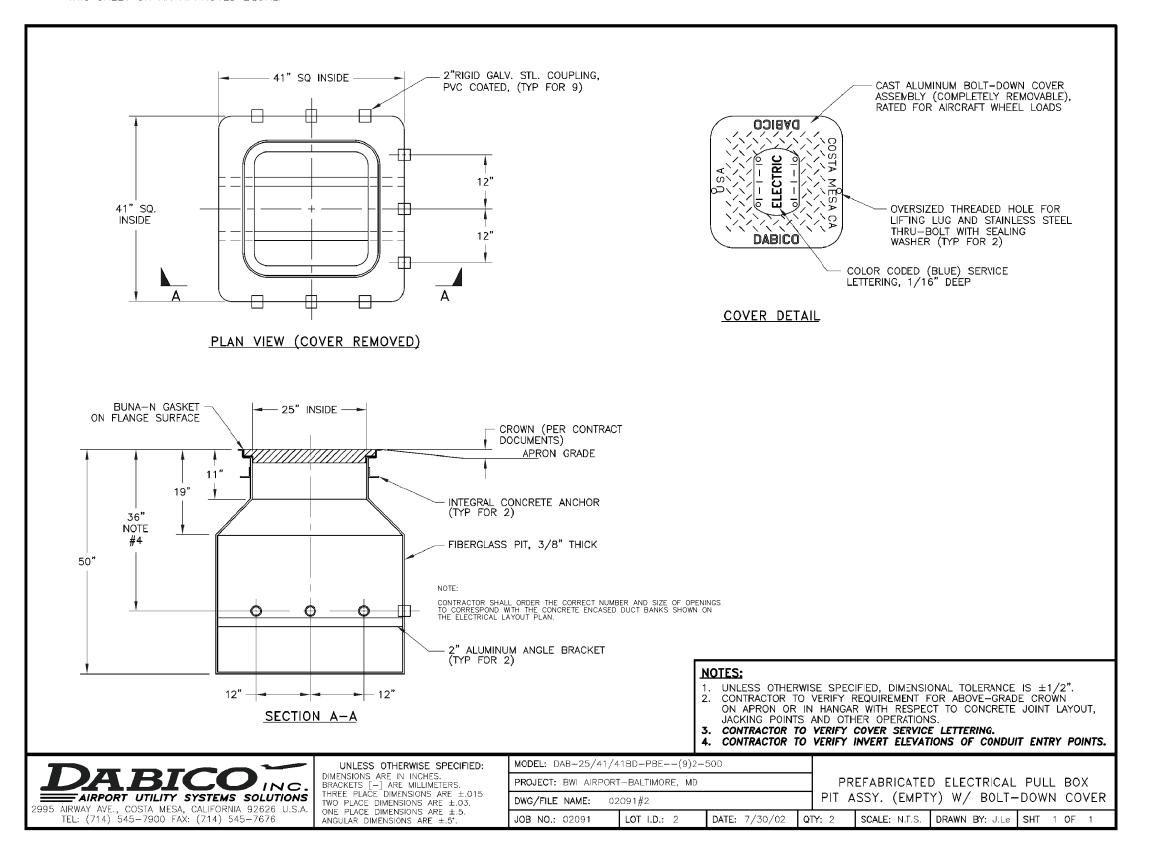

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PROJECT, BLV-4061 PROJ, 3-17-0146-XX TILLY, MURPHY & 1 CRAWFORD, CONSULTING

MEMORIAL DRIVE, SUITE 500 ST. LOUIS, MO 63102 (314) 436—5500

FILE: 29-32_ELECTRICAL_DETAILS.dw DESIGN BY: LEW


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APPROVED BY: BWG DATE: JANUARY 14, 2011

JOB No: 10098-01


ELECTRICAL DETAILS 3

SHEET 31 OF 53 SHEETS

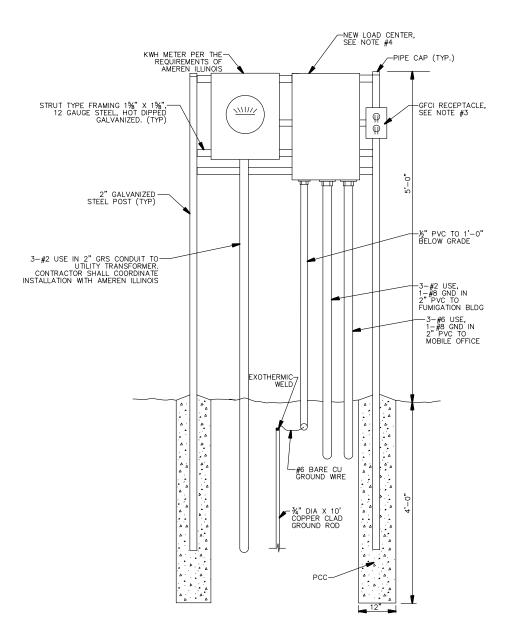

KWH METER AND LOAD CENTER DETAIL

- 1. CONTRACTOR SHALL PROVIDE ELECTRICAL CONDUITS IN ACCORDANCE WITH ITEM 110.
- 2. CONCRETE SHALL MEET REQUIREMENTS OF ITEM 610.
- 3. CONTRACTOR SHALL FURNISH AND INSTALL A SPECIFICATION GRADE WEATHER—RESISTANT AND CORROSION—RESISTANT GFCI NEMA 5—20R RECEPTACLE, PASS & SEYMOUR CAT. # 2095DSWRBK, MOUNTED IN FS DEVICE BOX, WITH AN EXTRA—DEEP, SUNLIGHT RESISTANT, PADLOCKABLE, POLYCARBONATE CONSTRUCTION WEATHERPROOF COVER WHICH COMPLIES WITH NEC ARTICLE 406.9B1 (UNITS SHALL REMAIN RAINTIGHT WHETHER OR NOT A PLUG AND CORD IS INSERTED) TAYMAC MM740C—B, OR EQUIVALENT.
- 4. CONTRACTOR SHALL FURNISH AND INSTALL A UL LISTED SERVICE ENTRANCE RATED LOAD CENTER, 100A, 120/240V, SINGLE-PHASE, 3-WIRE, IN NEMA 3R ENCLOSURE, WITH 100A-2P MAIN CIRCUIT BREAKER, SQUARE D TYPE NQ, OR EQUIVALENT. SEE DETAIL THIS SHEET FOR BRANCH CIRCUIT BREAKERS.
- KWH METER BASE, LOAD CENTER AND OTHER ELECTRICAL EQUIPMENT SHALL MEET THE "BUY AMERICAN" REQUIREMENT.

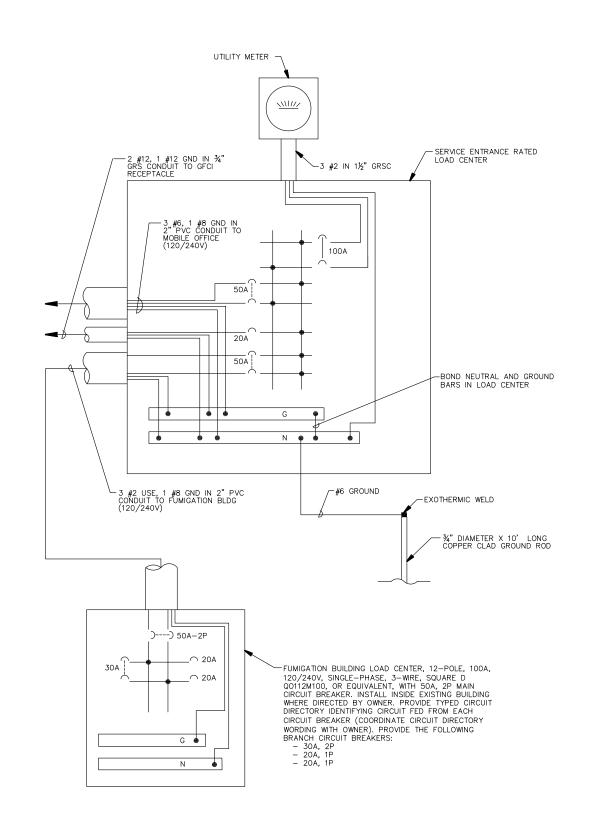

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APPROVED BY: BWG DATE: JANUARY 14, 2011

MEMORIAL DRIVE, S ST. LOUIS, 1 (314)

JOB No: 10098-01

ELECTRICAL DETAILS 4

SHEET 32 OF 53 SHEETS

