STATE OF ILLINOIS

DEPARTMENT OF TRANSPORTATION

DIVISION OF HIGHWAYS

PROPOSED HIGHWAY PLANS

F.A.I 57/1–57 AT NORTH PEOTONE—JOLIET RD **SECTION 99–2HB–1–1–2 BRIDGE REPAIR & RESURFACE APPROACHES**

> **WILL COUNTY** C-91-083-08

PROJECT: ESP-057-7(279)327

LOCATION OF IMPROVEMENT PEOTONE-JOLIET RD OVER 1-57 STRUCTURE NO. 099-0162

IMPROVEMENT LOCATED WITHIN THE VILLAGE OF PEOTONE

FOR INDEX OF SHEETS, SEE SHEET NO. 2

TRAFFIC DATA


PEOTONE-JOLIET RD 2004 ADT = 1,700SPEED LIMIT = 45 MPH




FULL SIZE PLANS HAVE BEEN PREPARED USING STANDARD ENGINEERING SCALES. REDUCED SIZED PLANS WILL NOT CONFORM TO STANDARD SCALES. IN MAKING MEASUREMENTS ON REDUCED PLANS, THE ABOVE SCALES MAY BE USED.

JOINT UTILITY LOCATION INFORMATION FOR EXCAVATION 1-800-892-0123 OR 811

DISTRICT ONE -PROJECT MANAGER: LONG TRAN (847) 705-4232 PROJECT ENGINEER: MICHELLE AQUINO (847) 705-4606

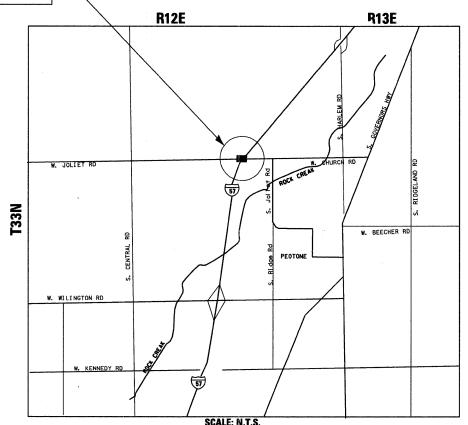

PEOTONE TOWNSHIP GROSS & NET LENGTH OF PROJECT = 360 FT = 0.0682 MILES

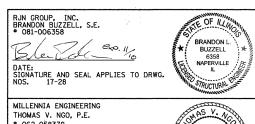


SIGNATURE AND SEAL APPLIES TO DRWG.

NOS. 1-16 & 28-33

SECTION 57 99-2HB-1-I-2 WILL 34 1 ILLINOIS CONTRACT NO. 60D65 FED. ROAD DIST. NO. 1

D-91-083-08



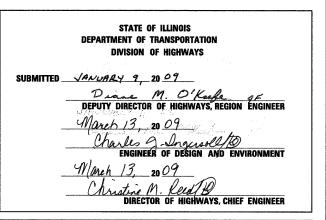



License # 184-000813

200 West Front Street Wheaton, II 60187



200 22ND Street, Suite 216, Lombard, IL 60148 630,705,0110 voice 630,839,2566 fax MILLENNIA ENGINEERING

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CONTRACT NO. 60D65

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- MAINTENANCE OF TRAFFIC NOTES AND DESCRIPTION
- SUGGESTED STAGES OF CONSTRUCTION AND TRAFFIC CONTROL - STAGE 1
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- 9-11 TEMPORARY TRAFFIC SIGNAL PLANS
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- ARTERIAL ROAD INFORMATION SIGN (TC-22)

HIGHWAY STANDARDS

LIST OF ILLINOIS DOT HIGHWAY STANDARDS

000001-05 STANDARD SYMBOLS, ABBREVIATIONS, AND PATTERNS

001001-02 AREAS OF REINFORCEMENT BARS

001006 DECIMAL OF AN INCH AND OF A FOOT

631031-**07** TRAFFIC BARRIER TERMINAL. TYPE 6

701311- **03** LANE CLOSURE 2 LANE 2 WAY MOVING OPERATIONS DAY ONLY

701316-04 LANE CLOSURE, 2L, 2W, BRIDGE REPAIR FOR SPEEDS >/= 45 MPH

701901*-01* TRAFFIC CONTROL DEVICES

701400-03 APPROACH TO LANE CLOSURE, FREEWAY/EXPRESSWAY

701401-05 LANE CLOSURE, FREEWAY/EXPRESSWAY

COMMITMENTS

NO COMMITMENTS FOR THIS PROJECT

GENERAL NOTES

- 1. BEFORE STARTING ANY EXCAVATION, THE CONTRACTOR SHALL CALL "J.U.L.I.E." AT 800-892-0123 FOR FIELD LOCATIONS OF BURIED ELECTRIC, TELEPHONE, AND GAS FACILITIES. (48 HOUR NOTIFICATION IS REQUIRED)
- 2. THESE PLANS HAVE BEEN PREPARED FROM NOTES RECEIVED FROM THE BUREAU OF MAINTENANCE BRIDGE INSPECTORS.
- 3. DO NOT SCALE PLANS FOR CONSTRUCTION DIMENSIONS.
- 4. ALL DAMAGE TO EXISTING PAVEMENT MARKING OR RAISED REFLECTIVE PAVEMENT MARKERS OUTSIDE THE REMOVAL LINE SHOWN ON THE PLANS SHALL BE REPLACED AT THE CONTRACTORS EXPENSE. NO ADDITIONAL COST TO THE DEPARTMENT.
- 5. THE CONTRACTOR SHALL COORDINATE CONSTRUCTION ACTIVITIES WITH THE UTILITY COMPANIES INCLUDING THE VILLAGE OF PEOTONE.
- 6. THE CONTRACTOR WILL NOT BE ALLOWED TO SET UP A YARD OR FIELD OFFICE ON STATE PROPERTY WITHOUT WRITTEN PERMISSION FROM THE DEPARTMENT.
- 7. THE CONTRACTOR SHALL BE RESPONSIBLE FOR VERIFYING ALL DIMENSIONS AND CONDITIONS EXISTING IN THE FIELD PRIOR TO CONSTRUCTION AND ORDERING MATERIALS.
- 8. BEFORE BEGINNING ANY WORK, THE CONTRACTOR SHALL RETAIN AND RECORD (FOR FUTURE REFERENCES), ALL EXISTING PAVEMENT MARKING LINES AND RAISED REFLECTIVE PAVEMENT MARKERS IN ORDER THAT THESE LOCATIONS CAN BE RE-ESTABLISHED FOR STRIPING. EXACT LOCATIONS OF ALL STRIPING SHALL BE AS DIRECTED BY THE ENGINEER.
- 9. THE CONTRACTOR SHALL CONTACT THE DISTRICT ONE TRAFFIC CONTROL SUPERVISOR AT (847) 705-4470 A MINIMUM OF 72 HOURS IN ADVANCE OF BEGINNING WORK ALONG PEOTONE ROAD.
- 10. THE CONTRACTOR SHALL CONTACT THE DISTRICT ONE TRAFFIC CONTROL SUPERVISOR AT (847) 705-4151 A MINIMUM OF 72 HOURS IN ADVANCE OF BEGINNING WORK ALONG I-57.
- 11. THE ENGINEER SHALL CONTACT CORA MATHIS TRAFFIC FIELD ENGINEER AT (815) 485-6475 A MINIMUM OF TWO WEEKS PRIOR TO PLACE OF PERMANENT PAVEMENT MARKINGS.
- 12. ALL PAVEMENT MARKINGS AND RAISED REFLECTORS AFFECTED BY THE BRIDGE REPAIRS AND MAINTENANCE OF TRAFFIC SHALL BE REPLACED. NOMINAL QUANTITIES HAVE BEEN INCLUDED IN THE PLANS.
- 13. THE "ADVANCE WARNING SIGN DETAIL FOR ARTERIAL TRAFFIC" LOCATED IN THE SPECIAL PROVISIONS FOR "TEMPORARY INFORMATION SIGNING FOR LANE CLOSURES" AND THE SPECIAL PROVISION FOR "PUBLIC CONVENIENCE IS/ARE APPLICABLE ONLY TO ARTERIAL ROADS AND SHALL NOT BE APPLIED TO EXPRESSWAYS/TOLLWAYS.
- 14. THE CONTRACTOR SHALL BE REQUIRED TO PROVIDE ACCESS TO ABUTTING PROPERTY AT ALL TIMES DURING THE CONSTRUCTION OF THIS PROJECT.
- 15. DOUBLE LANE MARKERS ARE TO BE USED AS SHOWN ON THE DISTRICT ONE DETAIL "TYPICAL APPLICATIONS - RAISED REFLECTIVE PAVEMENT MARKERS (SNOW-PLOW RESISTANT)" SHOWN ON THE PLANS.

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DESIGNED REVISED DRAWN REVISED CHECKED REVISED DATE 1/14/2009 REVISED

STATE OF ILLINOIS

FAI 57/1-57 AT NORTH PECTONE-

INDEX OF SHEETS, LIST OF IDOT HWAY STANDARDS, GENERAL NOTES, AND COMMITMENTS

SHEETS STA.

SECTION COUNTY 57 99-2HB-1-I-2 WILL 33 2 CONTRACT NO. 60D65

FED. ROAD DIST, NO. 1 JILLINOIS FED. AID PROJECT

DEPARTMENT OF TRANSPORTATION

SUMMARY OF QUANTITIES			URBAN 100% FEO.	CONSTRU TYPE	JCTION CODE
CODE NO.	ITEM DESCRIPTION	UNIT	TOTAL	099-0162 SFTY-2A QUANTITY	-
40600625	LEVELING BINDER (MACHINE METHOD), N50	TON	20.5	20.5	
40603310	HOT-MIX ASPHALT SURFACE COURSE, MIX "C", N50	TON	40.9	40.9	
40600982	HOT-MIX ASPHALT SURFACE REMOVAL - BUTT JOINT	SQ YD	240	240	
40800020	BITUMINOUS MATERIALS (PRIME COAT)	TON	4.8	4.8	
44000151	HOT-MIX ASPHALT SURFACE REMOVAL, 1/2"	SQ YD	241.5	241.5	
48101200	AGGREGATE SHOULDERS, TYPE B	TON	40	40	
50102400	CONCRETE REMOVAL	CU YD	11.6	11.6	
50300255	CONCRETE SUPERSTRUCTURE	CU YD	12.7	12.7	
50300260	BRIDGE DECK GROOVING	SQ YD	884	884	
50300300	PROTECTIVE COAT	SQ YD	34	34	
50300530	FLOOR DRAIN EXTENSION	EACH	13	13	
50500405	FURNISHING AND ERECTING STRUCTURAL STEEL	POUND	1271	1271	
50500715	JACK AND REMOVE EXISTING BEARINGS	EACH	12	12	
50800205	REINFORCEMENT BARS, EPOXY COATED	POUND	1450	1450	
50800515	BAR SPLICERS	EACH	20	20	
52000110	PREFORMED JOINT STRIP SEAL	FOOT	80	80	
52100020	ELASTOMERIC BEARING ASSEMBLY, TYPE II	EACH	12	12	
52100520	ANCHOR BOLTS, 1"	EACH	24	24	
63100085	TRAFFIC BARRIER TERMINAL, TYPE 6	EACH	4	4	
63200310	GUARDRAIL REMOVAL	FOOT	229	229	
67100100	MOBILIZATION	- L SUM	1	1	
70101800	TRAFFIC CONTROL AND PROTECTION, (SPECIAL)	L SUM	1	1	
70103815	TRAFFIC CONTROL SURVEILLANCE	CAL DA	70	70	
70106800	CHANGEABLE MESSAGE SIGN .	CAL MO	3	3	
70301000	WORK ZONE PAVEMENT MARKING REMOVAL	SQ FT	1199	1199	
78008210	POLYUREA PAVEMENT MARKING TYPE I - LINE 4"	FOOT	1729	1729	
78100100	RAISED REFLECTIVE PAVEMENT MARKER	EACH	16	16	
78100105	RAISED REFLECTIVE PAVEMENT MARKER (BRIDGE)	EACH	10	10	

	SUMMARY OF QUANTITIES	4RBAN 100% FED.	TYPE		
CODE NO.	ITEM DESCRIPTION	UNIT	TOTAL	099-0162 SFTY-2A QUANTITY	
78300100	PAVEMENT MARKING REMOVAL	SQ FT	286.2	286.2	
78300200	RAISED REFLECTIVE PAVEMENT MARKER REMOVAL	EACH	26	26	
X0321468	PLUG EXISTING DECK DRAINS	EACH	1	1	
X0322185	BRIDGE DECK LATEX CONCRETE OVERLAY, 2 1/4 INCHES	SQ YD	930	930	
X0322256	TEMPORARY INFORMATION SIGNING	SQ FT	52	52	
X0325305	STRUCTURAL REPAIR OF CONCRETE (DEPTH EQUAL TO OR LESS THAN 5 INCHES)	SQ FT	119	119	
X0325775	WET REFLECTIVE TEMPORARY TAPE, TYPE III, 4 INCH	FOOT	3609	3609	
X0325841	WET REFLECTIVE TEMPORARY TAPE, TYPE III, 24 INCH	FOOT	24	24	
X7011015	TRAFFIC CONTROL AND PROTECTION (EXPRESSWAYS)	L SUM	1	1	
X8900005	TEMPORARY BRIDGE TRAFFIC SIGNAL INSTALLATION	EACH	1	1	
Z0006204	BRIDGE DECK HYDRO-SCARIFICATION 1/2"	SQ YD	930	930	
Z0016001	DECK SLAB REPAIR (FULL DEPTH, TYPE I)	SQ YD	2	2	
Z0016002	DECK SLAB REPAIR (FULL DEPTH, TYPE II)	SQ YD	78	78	
Z0065700	SLOPE WALL REPAIR	SQ YD	15	15	

* SPECIALTY ITEM

* SPECIAL	TY ITEM
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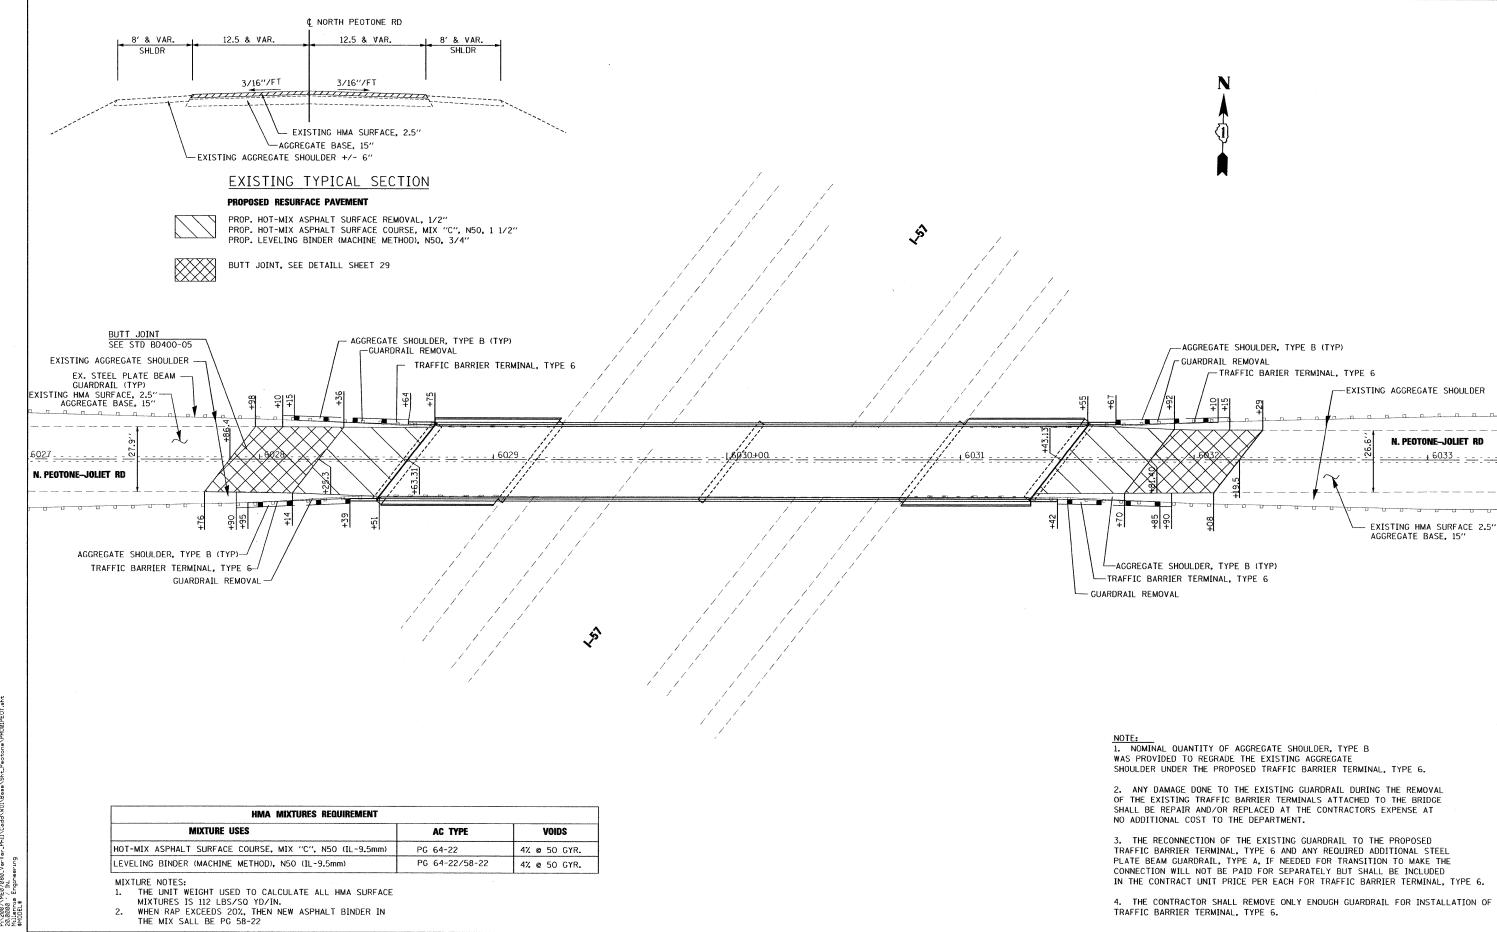


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STATE OF ILLINOIS
DEPARTMENT OF TRANSPORTATION

FAI 57/1-57 AT NORTH PEOTONE-JOILET RD SHEET NO. OF SHEETS STA.

SUMMARY OF QUANTITIES TO STA. 

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STATE OF ILLINOIS **DEPARTMENT OF TRANSPORTATION**

FAI 57/1-57 AT N. PEOTONE/JOLIET RD SCALE: 1"=20' SHEET NO. OF SHEETS STA.

SECTION **ROADWAY PLAN** 99-2H-1-I-2 WILL CONTRACT NO. 60D65 TO STA. FED. ROAD DIST. NO. 1 ILLINOIS FED. AID PROJECT

TOTAL SHEE' SHEETS NO.

34 4

- 2. THE ENGINEER SHALL BE INFORMED 48 HOURS IN ADVANCE OF ANY CHANGE TO THE MOT PLANS.
- 3. ALL EXISTING PAVEMENT MARKING IN CONFLICT WITH THE MAINTENANCE OF TRAFFIC STRIPING SHALL BE REMOVED THIS WORK WILL BE PAID FOR AT THE CONTRACT UNIT PRICE PER SQUARE FOOT. "PAVEMENT MARKING REMOVAL" ..
- 4. THE CONTRACTOR SHALL REMOVE ALL TEMPORARY PAVEMENT MARKING TAPE WHICH CONFLICTS WITH THE NEXT STAGE OR FINAL STRIPING. REMOVAL OF TEMPORARY PAVEMENT MARKING TAPE WILL BE PAID FOR AT THE CONTRACT UNIT PRICE PER FOOT, "WORK ZONE PAVEMENT MARKING REMOVAL".
- 5. ALL TRAFFIC CONTROL DEVICES USED FOR THE MAINTENANCE OF TRAFFIC. AS DETAILED ON THE PLANS. OR HIGHWAY STANDARDS SHALL BE REFLECTORIZED PRIOR TO INSTALLATION AND CLEANED AS SPECIFIED IN MAINTENANCE OF TRAFFIC SPECIAL PROVISIONS OR AS DIRECTED BY THE ENGINEER.
- 6. ALL DRUMS, VERTICAL PANELS AND BARRICADES ADJACENT TO THE EDGE OF TRAVELED WAY SHALL BE EQUIPPED WITH STEADY-BURNING LIGHTS.
- 7. ALL EXISTING SIGNS WITHIN THE LIMITS OF MAINTENANCE OF TRAFFIC WHICH ARE OBSCURED BY OR OTHERWISE INTERFERED WITH BY THE CONSTRUCTION OPERATIONS AND MAINTENANCE OF TRAFFIC. SHALL BE COVERED OR REMOVED BY THE CONTRACTOR UNLESS SPECIFIED IN THE PLANS OR WHEN DIRECTED BY THE ENGINEER. THIS WORK SHALL BE IN ACCORDANCE WITH ARTICLE 107.25 OF THE IDOT STANDARD SPECIFICATIONS.
- 8. TEMPORARY, OFF-PEAK HOUR LANE CLOSURES MUST BE REQUESTED THROUGH THE ENGINEER AND AS SPECIFIED IN THE SPECIAL PROVISIONS. WHEN OFF-PEAK HOUR OR WEEKEND LANE CLOSURES ARE REQUIRED. A PORTABLE CHANGEABLE MESSAGE SIGN SHALL BE INSTALLED ONE WEFK PRIOR TO THE CLOSURE. THE MESSAGE SIGN WORDING AND LOCATION WILL BE DETERMINED BY THE ENGINFER.
- 9. THE CONTRACTOR SHALL PLACE A CHANGEABLE MESSAGE SIGN AT EACH END OF THE PROJECT AND/OR AS DIRECTED BY THE ENGINEER TO INFORM MOTORISTS OF UPCOMING CONSTRUCTION ACTIVITIES. THE MESSAGE SIGNS WITH THE APPROPRIATE INFORMATION SHALL BE IN PLACED TWO WEEKS BEFORE START OF CONSTRUCTION ACTIVITY. THIS WORK IS TO BE PAID FOR AT THE CONTRACT UNIT PRICE PER CALENDAR MONTH, "CHANGEABLE MESSAGE SIGN".
- 10. ALL TEMPORARY INFORMATION SIGNS SHALL BE PAID FOR SEPARATELY AT THE CONTRACT UNIT PRICE PER SQUARE FEET FOR "TEMPORARY INFORMATION SIGNING".
- 11. FOR ADDITIONAL BRIDGE CONSTRUCTION STAGING INFORMATION, SEE STRUCTURAL PLANS.

MAINTENANCE OF TRAFFIC DESCRIPTION

PRESTAGE

CONSTRUCTION:

INSTALL TRAFFIC SIGNAL PER PLAN.

IMPLEMENT STAGE 1 MOT PAVEMENT MARKINGS

MAINTENANCE OF TRAFFIC:

UTILIZE HIGHWAY STANDARD LANE CLOSURE 2 LANE 2 WAY MOVING OPERATIONS DAY ONLY (701311)

STAGE 1

CONSTRUCTION:

CONDUCT BRIDGE REPAIRS AND OVERLAY ALONG EASTBOUND PEOTONE RD.

CONDUCT ABUTMENT AND PIER REPAIRS ALONG I-57.

MAINTENANCE OF TRAFFIC:

MAINTAIN ONE LANE ALONG WESTBOUND PEOTONE RD BY UTILIZING TEMPORARY BRIDGE SIGNALS SEE MOT PLANS AND TEMPORARY TRAFFIC SIGNAL PLANS.

MAINTAIN THROUGH TRAFFIC ALONG I-57 AT ALL TIMES. UTILIZE DISTRICT ONE DETAIL TC-17, TRAFFIC CONTROL DETAILS FOR FREEWAY DAY CLOSURES.

STAGE 2

CONSTRUCTION:

CONDUCT BRIDGE REPAIRS AND OVERLAY ALONG WESTBOUND PEOTONE RD.

COMPLETE ABUTMENT AND PIER REPAIRS ALONG I-57.

MAINTENANCE OF TRAFFIC:

MAINTAIN ONE LANE ALONG EASTBOUND PEOTONE RD BY UTILIZING TEMPORARY BRIDGE SIGNALS SEE MOT PLANS AND TEMPORARY TRAFFIC SIGNAL PLANS.

MAINTAIN THROUGH TRAFFIC ALONG I-57 AT ALL TIMES. UTILIZE DISTRICT ONE DETAIL TC-17, TRAFFIC CONTROL DETAILS FOR FREEWAY DAY CLOSURES.

STAGE 2A

CONSTRUCTION:


REMOVE TEMPORARY SIGNALS.

INSTALL FINAL PAVEMENT MARKINGS AND RAISED PAVEMENT REFLECTORS.

MAINTENANCE OF TRAFFIC:

UTILIZE 701311-02 LANE CLOSURE 2 LANE 2 WAY MOVING OPERATIONS DAY ONLY

SHEETS STA.

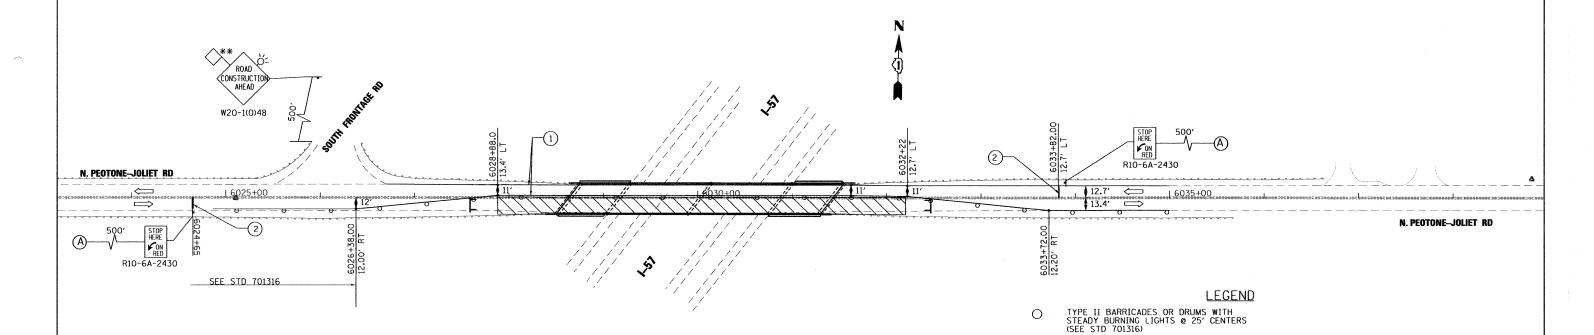

TYPE III BARRICADES WITH STEADY BURNING LIGHTS WORK ZONE

TRAFFIC DIRECTION

(1) WET REFLECTIVE TEMPORARY TAPE, TYPE III 4", SOLID WHITE LINE (TYP) (XO325775)

(2) WET REFLECTIVE TEMPORARY TAPE, TYPE III 24", (X0325841) 24" WHITE STOP BAR

1. UTILIZE IDOT DISTRICT ONE DETAIL TC-17 (DAYTIME SHOULDER CLOSURE)
DURING WORK ON ABUTMENTS AND PIERS.

2. SEE TEMPORARY SIGNAL PLANS FOR SIGNAL INFORMATION

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STATE OF ILLINOIS **DEPARTMENT OF TRANSPORTATION**


FAI 57/I-57 AT N. PEOTONE/JOLIET RD SCALE: 1"=50' SHEET NO. OF SHEETS STA.

SUGGESTED STAGES OF CONSTRUCTION F.A.I. & TRAFFIC CONTROL TO STA.

COUNTY TOTAL SHEET NO.
WILL 34 6 SECTION CONTRACT NO. 60D65 FED. ROAD DIST. NO. 1 | ILLINOIS| FED. AID PROJECT
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DATE "
NAME "
SCALE "
NAME "

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2. SEE TEMPORARY SIGNAL PLANS FOR SIGNAL INFORMATION

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CHECKED	-	RPD	REVISED	-
 DATE	-	01/14/09	REVISED	•

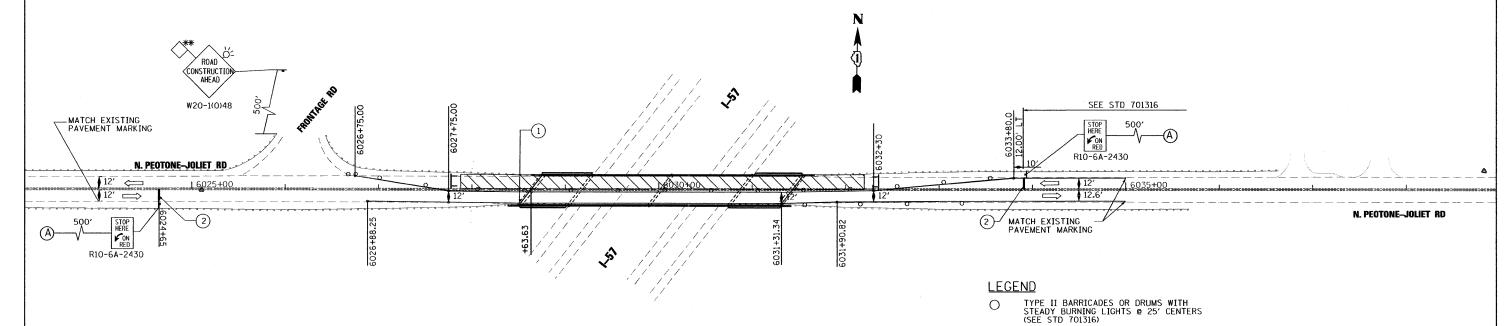STATE OF ILLINOIS **DEPARTMENT OF TRANSPORTATION**

FAI 57/1-57 AT N. PEOTONE/JOLIET RD SCALE: 1"=50' SHEET NO. OF SHEETS STA.

SUGGESTED STAGES OF CONSTRUCTION & TRAFFIC CONTROL STAGE 2


TYPE III BARRICADES WITH STEADY BURNING LIGHTS

(1) WET REFLECTIVE TEMPORARY TAPE, TYPE III 4", SOLID WHITE LINE (TYP) (X0325775) (2) WET REFLECTIVE TEMPORARY TAPE, TYPE III 24", (X0325841) 24" WHITE STOP BAR

WORK ZONE TRAFFIC DIRECTION

> COUNTY SHEETS NO.
> WILL 34 7
> CONTRACT NO. 60D65 SECTION 99-2H-1-I-2 FED. ROAD DIST. NO. 1 | ILLINOIS FED. AID PROJECT P:\2007\ME07080_Var\Var\PhII\Cadd\WDI\Bose\Sht_Po

1. UTILIZE IDOT DISTRICT ONE DETAIL TC-17 (DAYTIME SHOULDER CLOSURE) DURING WORK ON ABUTMENTS AND PIERS.

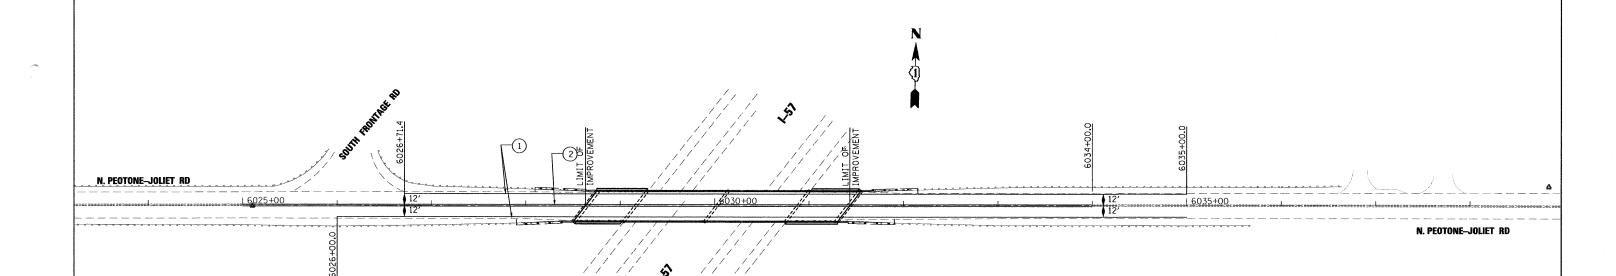

NOTE:
1. REFER TO DISTRICT 1 PAVEMENT MARKING DETAILS (TC-13)

FOR ADDITIONAL INFORMATION.

THE ENGINEER SHALL CONTACT: CORA MATHIS,
FIELD TRAFFIC ENGINEER, AT (815) 485-6475 A MINIMUM OF TWO (2) WEEKS PRIOR OF THE PLACEMENT OF PERMANENT PAVEMENT MARKINGS.

1) POLYUREA PAVEMENT MARKING, TYPE I LINE 4" (WHITE)

2 POLYUREA PAVEMENT MARKING, TYPE I DOUBLE YELLOW SOLID LINE 4"

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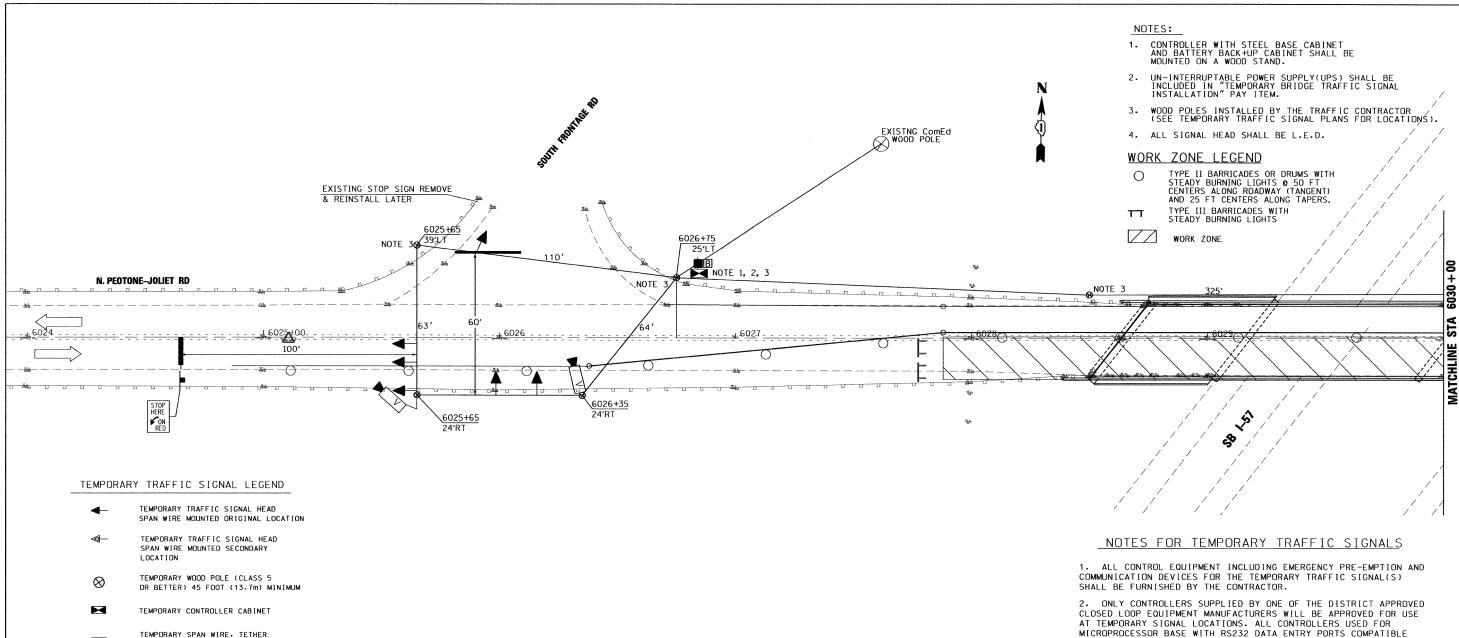
FAI 57/I-57 AT N. PEOTONE/JOLIET RD SCALE: 1"=50" SHEET NO. OF SHEETS STA.

PAVEMENT MARKING PLAN

TO STA.

COUNTY TOTAL SHEET NO. SECTION WILL FED. ROAD DIST. NO. 1 | ILLINOIS | FED. AID PROJECT
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MILLENNIA ENGINEERING



MICROPROCESSOR BASE WITH RS232 DATA ENTRY PORTS COMPATIBLE WITH EXISTING MONITORING SOFTWARE APPROVED BY IDOT DISTRICT 1
INSTALLED IN A NEMA TS1 OR TS2 CABINET. ONLY ONE BRAND OF CONTROLER WILL BE ACCEPTED FOR ANY ONE CONTRACT.

3. ALL TRAFFIC SIGNAL SECTIONS AND PEDESTRIAN SIGNAL SECTIONS SHALL BE 12". HEADS SHALL BE PLACED AS INDICATED ON THE TEMPORARY TRAFFIC SIGNAL PLAN OR AS DIRECTED BY THE ENGINEER. THE CONTRACTOR SHALL FURNISH ENOUGH CABLE SLACK TO RELOCATE HEADS TO ANY POSTION ON THE SPAN WIRE OR AT LOCATIONS ILLUSTRATED ONTHE PLANS FOR CONSTRUCTION STAGING. THE TEMPORARY TRAFFIC SIGNAL SHALL REMAIN IN OPERATION DURING ALL SIGNAL HEAD RELOCATIONS. EACH TEMPORARY TRAFFIC SIGNAL HEAD SHALL HAVE ITS OWN CABLE FROM THE CONTROLLER CABINET TO THE

4. ALL EXISTING STREET NAME AND INTERSECTION REGULATORY SIGNS SHALL BE REMOVED FROM EXISTING POLES, RELOCATED AND SECURELY FASTENED TO THE SIGNAL SPAN WIRE OR WOOD POLE AS DIRECTED BY THE ENGINEER.

5. 24" WHITE STOP BAR MUST BE IN PLACE AT THE TIME OF SIGNAL TURN ON.

		WIRE. AND CABLE
	-	TEMPORARY SERVICE INSTALLATION
	₽	TEMPORARY PEDESTRAIN SIGNAL HEAD. BRACKET MOUNTED
	•	PEDESTRIAN PUSHBUTTON DETECTOR
	CT UD	EMERGENCY VEHICLE LIGHT DETECTOR CONFIRMATION BEACON VEHICLE DETECTOR, INDUCTION LOOP COMMON TRENCH UNIT DUCT
	———— H	G.S. CONDUIT IN TRENCH OR PUSHED HEAVY DUTY HANDHOLE
	V	VIDEO VEHICLE SENSOR
Engineering	В	UNINTERTUPTABLE POWER SUPPLY
ELS ELS		

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DATE	-	01/14/09	REVISED -	

STATE OF ILLINOIS **DEPARTMENT OF TRANSPORTATION**

FAI 57/I-57	
AT N. PEOTONE/JOLIET	RD

TEMPORARY TRAFFIC SIGNAL PLAN

TO STA.

SECTION 99-2H-1-I-2 WILL 34 CONTRACT NO. 60D65 FED. ROAD DIST. NO. 1 | ILLINOIS FED. AID PROJECT

SCALE: 1"=20' SHEET NO. OF SHEETS STA.

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- SPAN WIRE MOUNTED ORIGINAL LOCATION
- TEMPORARY TRAFFIC SIGNAL HEAD SPAN WIRE MOUNTED SECONDARY
- TEMPORARY WOOD POLE (CLASS 5 \otimes OR BETTER) 45 FOOT (13.7m) MINIMUM
- TEMPORARY CONTROLLER CABINET
- TEMPORARY SPAN WIRE, TETHER WIRE, AND CABLE
- \Box TEMPORARY SERVICE INSTALLATION
- TEMPORARY PEDESTRAIN SIGNAL HEAD. BRACKET MOUNTED
- PEDESTRIAN PUSHBUTTON DETECTOR
- EMERGENCY VEHICLE LIGHT DETECTOR CONFIRMATION BEACON
- VEHICLE DETECTOR, INDUCTION LOOP
- CT COMMON TRENCH
- UD UNIT DUCT
- G.S. CONDUIT IN TRENCH OR PUSHED
- H HEAVY DUTY HANDHOLE
- V VIDEO VEHICLE SENSOR
 - UNINTERTUPTABLE POWER SUPPLY

DESIGNED	-	TVN	REVISED	-	
DRAWN	~	TVN	REVISED	-	
CHECKED	-	RPD	REVISED	~	
DATE	-	01/14/09	REVISED	*	

STATE OF ILLINOIS **DEPARTMENT OF TRANSPORTATION**

FAI 57/I-57 AT N. PEOTONE/JOLIET RD SCALE: 1"=20' SHEET NO. OF

COUNTY TOTAL SHEET NO. TEMPORARY TRAFFIC SIGNAL PLAN SECTION WILL 99-2H-1-I-2 CONTRACT NO. 60D65 TO STA.

1. ALL CONTROL EQUIPMENT INCLUDING EMERGENCY PRE-EMPTION AND COMMUNICATION DEVICES FOR THE TEMPORARY TRAFFIC SIGNAL(S)

2. ONLY CONTROLLERS SUPPLIED BY ONE OF THE DISTRICT APPROVED CLOSED LOOP EQUIPMENT MANUFACTURERS WILL BE APPROVED FOR USE

WITH EXISTING MONITORING SOFTWARE APPROVED BY IDOT DISTRICT 1
INSTALLED IN A NEMA TS1 OR TS2 CABINET. ONLY ONE BRAND OF
CONTROLER WILL BE ACCEPTED FOR ANY ONE CONTRACT.

3. ALL TRAFFIC SIGNAL SECTIONS AND PEDESTRIAN SIGNAL SECTIONS SHALL BE 12". HEADS SHALL BE PLACED AS INDICATED ON THE

TEMPORARY TRAFFIC SIGNAL PLAN OR AS DIRECTED BY THE ENGINEER. THE CONTRACTOR SHALL FURNISH ENOUGH CABLE SLACK TO RELOCATE

SIGNAL HEAD RELOCATIONS. EACH TEMPORARY TRAFFIC SIGNAL HEAD SHALL HAVE ITS OWN CABLE FROM THE CONTROLLER CABINET TO THE

4. ALL EXISTING STREET NAME AND INTERSECTION REGULATORY SIGNS SHALL BE REMOVED FROM EXISTING POLES, RELOCATED AND SECURELY FASTENED TO THE SIGNAL SPAN WIRE OR WOOD POLE AS DIRECTED BY

HEADS TO ANY POSTION ON THE SPAN WIRE OR AT LOCATIONS

ILLUSTRATED ONTHE PLANS FOR CONSTRUCTION STAGING. THE TEMPORARY TRAFFIC SIGNAL SHALL REMAIN IN OPERATION DURING ALL

5. 24" WHITE STOP BAR MUST BE IN PLACE AT THE TIME OF

AT TEMPORARY SIGNAL LOCATIONS. ALL CONTROLLERS USED FOR MICROPROCESSOR BASE WITH RS232 DATA ENTRY PORTS COMPATIBLE


SHALL BE FURNISHED BY THE CONTRACTOR.

200 22ND Street, Suite 216, Lombard, IL 60148 630.705.0110 voice, 630.839.2566 fax MILLENNIA ENGINEERING

SIGNAL HEAD.

SIGNAL TURN ON.

FED. ROAD DIST. NO. 1 ILLINOIS FED. AID PROJECT

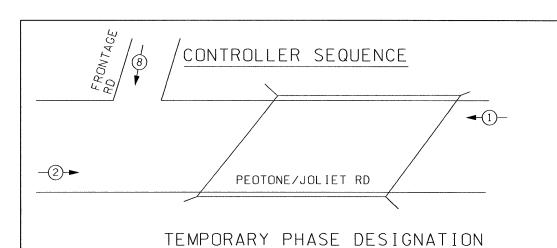

NOTES:

- CONTROLLER WITH STEEL BASE CABINET AND BATTERY BACK+UP CABINET SHALL BE MOUNTED ON A WOOD STAND.
- UN-INTERRUPTABLE POWER SUPPLY(UPS) SHALL BE INCLUDED IN "TEMPORARY BRIDGE TRAFFIC SIGNAL INSTALLATION" PAY ITEM.
- 3. WOOD POLES INSTALLED BY THE TRAFFIC CONTRACTOR (SEE TEMPORARY TRAFFIC SIGNAL PLANS FOR LOCATIONS).
- 4. ALL SIGNAL HEAD SHALL BE L.E.D.

SUMAMARY OF QUANTITIES

ITEM	DESCRIPTION	UNIT	QTY
x8900005	TEMPORARY BRIDGE TRAFFIC SIGNAL INSTALLATION	EACH	1



◆ ◆ DUAL ENTRY PHASE


PROTECTED LEFT TURN PHASE

PEDESTRIAN PHASE

NUMBER REFERS TO ASSOCIATED PHASE

NO. OF LAMPS

9

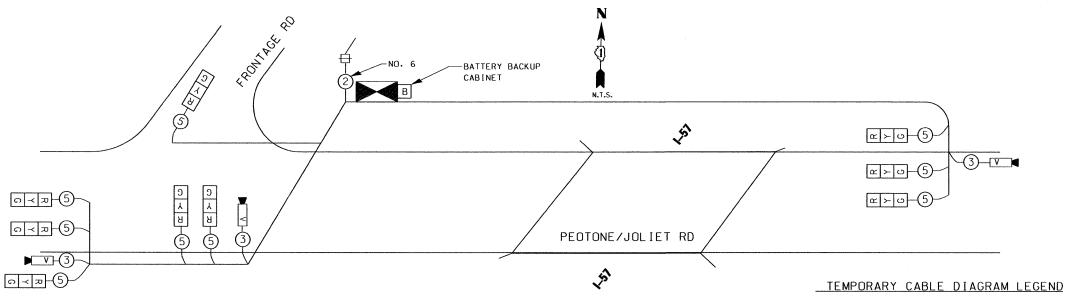

TEMPORARY CABLE PLAN

R	TEMPORARY	TRAFFIC	SIGNAL	SECTI	ON OR
الثا	TEMPORARY PEDESTRIAN	SIGNAL	SECTION	12"	(300mm)

TEMPORARY CONTROLLER CABINET

- INDICATES NUMBER OF CONDUCTORS IN CABLE. ALL CONDUCTORS TO BE NUMBER 14 AWG WIRE UNLESS OTHERWISE NOTED.
- □ TEMPORARY SERVICE INSTALLATION
- EMERGENCY VEHICLE LIGHT DETECTOR
- CONFIRMATION BEACON
- PEDESTRIAN PUSHBUTTON DETECTOR
- VEHICLE DETECTOR, INDUCTION LOOP
- 12" (300") PEDESTRIAN SIGNAL SECTION
- V VIDEO VEHICLE SENSOR
- M MICROWAVE VEHICLE SENSOR
- C CLOSED CIRCUT TV
- BB BATTERY BACK UP
- T TELEPHONE CONNECTION
- B UNINTERTUPTABLE POWER SUPPLY

PED. SIGNAL		90	25	1.00	
COTROLLER	1	100	100	1.00	
ILLUM. SIGN		84		0.05	
VIDEO VEH. SENSOR	3	15	15	1.00	
FLASHER				0.50	
				TOTAL	

(708) 235-2327

COMMONWEALTH EDISON

I.D.O.T

TRAFFIC SIGNAL INSTALLATION

ELECTRICAL SERVICE REQUIREMENTS

135

135

135

135

WATTAGE INCAND. | L.E.D.

17

25

15

12

D - CONTROLLER 4 , (1.2) E - M. ARM POLE 311.5 ENERGY COSTS - BILLED TO: I.D.O.T 24" (600mm) (ADDRESS) 201 CENTER CT. 30" (600mm) 15 , (4.5) SCHAUMBURG, IL 60196 ENERGY SUPP;Y - CONTACT:

OPERATION

0.50

0.25

0.25

0.10

TOTAL WATTAGE

76.5

56.3

33.8

100

45

HANDHOLE 6.5 , (2.0) DOUBLE HANDHOLE 13 , (4.0) SIGNAL POST CONTROLLER CAB. 1 , (0.5) FIBER OPTIC 13 , (4.0) ELECTRIC SERVICE , (0.5) GROUND CABLE 1 , (0.5)

CABLE SLACK

MAST ARM (1.) POLE	20'+L-2 = (6m+L-0.6m)=
BRACKET MOUTED	13 , (4.0)
PED. PUSHBOTTON	4 , (1.2)
ELECTRIC SERVICE	13.5 , (4.1)
SERVICE TO GROUND	13. , (4.1)
POST MOUNTED	6 , (1.8)

(FEET) (m)

1.0 , (2.0)

M	200 22ND Street, Suite 216, Lombard, IL 60148 630.705.0110 voice, 630.839.2566 fax www.millenuiseng.com		
1 VA	MILLENNIA ENGINEERING		

PHONE:

COMPANY:

DESIGNED	-	TVN	REVISED	-
DRAWN	-	TVN	REVISED	=
CHECKED	-	RPD	REVISED	
DATE	-	01/14/09	REVISED	*

FOUNDATION (DEPTH)

TYPE A - POST

(FEET) (m)

4 , (1.2)

STATE	OF	ILLINOIS
DEPARTMENT (OF '	TRANSPORTATION

(FEET) (m)

VERTICAL

ALL FOUNDATION

FAI 57/1-57		
AT N. PEOTONE/JOLIET	RD	

MPORARY	CABLE	PLAN	AND
TEMPO	RARY	PHASE	
DESIGNA	TION	DIAGRA	M

	F.A.I. RTE.	SECTION	COUNTY	TOTAL SHEETS	SHEE NO.
57 99-2H-1-I-2		WILL	34	11	
			CONTRACT	NO. 6	OD6
	FED. ROA	D DIST. NO. 1 ILLINOIS FED. AL	D PROJECT		**********

SCALE: N.T.S. SHEET NO. OF SHEETS STA. TO STA. P:\2007\ME07080_YarVar_Phil\Cadd\W01\Base\Sht_Peotone\PTEMPS03PEOT.sht

DATE NAME SCALE NAME


TYPE

ARROW


SIGNAL (RED)

(YELLOW)

(GREEN)

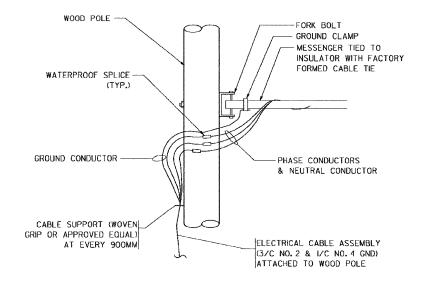


AERIAL CABLE CONNECTION DETAIL

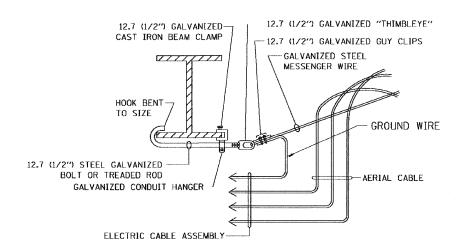

AFRIAL CABLE ATTACHED TO STRUCTURE NOT TO SCALE

NOTES:

- 1. ALL DIMENSIONS IN MILLIMETERS (INCHES) UNLESS OTHERWISE INDICATED.
- 2. SEE PROPOSED LIGHTING PLAN FOR CONDUIT, CABLE
- 3. THE CONTRACTOR SHALL PROVIDE INTERMEDIATE SUPPORTS TO MAINTAIN MINIMUM CLEARANCES. REFER TO AERIAL AERIAL CABLE ATTACHED TO STRUCTURE DETAIL.
- 4. COST OF SPLICES AND MOUNTING HARDWARE SHALL BE INCLUDED IN THE UNIT PRICE FOR AERIAL CABLE.

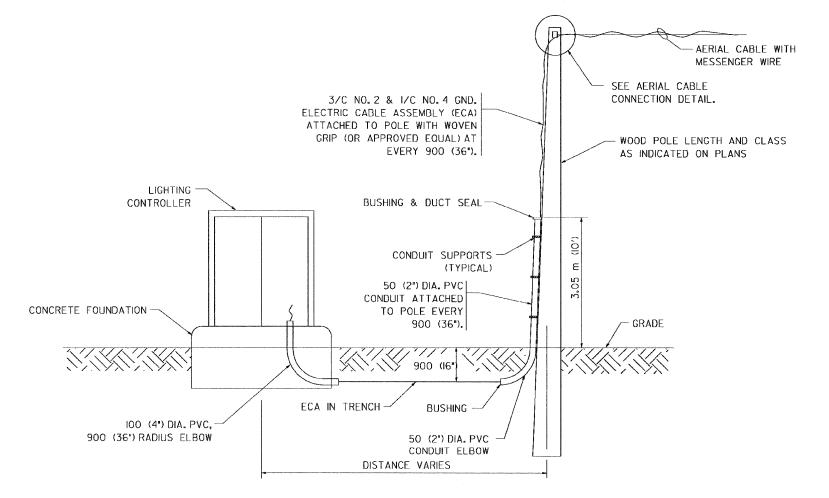

WOOD POLE TO LIGHTING CONTROLLER WIRING CONNECTION DETAIL

ILLINOIS DEPARTMENT OF TRANSPORTATION **TEMPORARY AERIAL CABLE INSTALLATION** SCALE: NONE DATE 05/21/2003 CHECKED BY

05/21/2003

200 22ND Street, Suite 216, Lombard, IL 60148 630.705.0110 voice, 630.839.2566 fax MILLENNIA ENGINEERING

DESIGNED TVN REVISED REVISED CHECKED RPD REVISED DATE 12/7/2007 REVISED

STATE OF ILLINOIS

FAI 57/I-57 AT N. PEOTONE/JOLIET RD DISTRICT ONE STANDARD DETAILS

TOTAL SHEE SHEETS NO. SECTION COUNTY WILL 99-2H-1-I-2 CONTRACT NO. 60D65


FED. ROAD DIST. NO. 1 ILLINOIS FED. AID PROJECT

DEPARTMENT OF TRANSPORTATION


SHEET NO.\$801 OF SHEETS STA.


- 1. EACH PAIR OF LOOP WIRES SHALL BE PLACED IN A SEPARATE UNIT DUCT FROM THE EDGE OF PAVEMENT TO THE HANDHOLE. SPACING BETWEEN THE HOLES DRILLED IN THE PAVEMENT SHALL NOT BE LESS THAN 6" (150 mm). UNIT DUCT SHALL BE INCLUDED IN THE COST OF THE LOOP WIRE.
- 2. THE NUMBER OF LOOP TURNS SHALL BE AS RECOMMENDED BY THE AMPLIFIER MANUFACTURER. ALL ADJACENT SIDES OF THE LOOPS SHALL BE INSTALLED IN SUCH A WAY THAT THE CURRENT FLOW IS IN THE SAME DIRECTION TO REINFORCE ITS MAGNETIC FIELDS FOR SMALL VEHICLE DETECTION.
- 3. EACH LOOP LEAD-IN SHALL BE IDENTIFIED AND PERMANENTLY TACCED IN THE HANDHOLE. EACH LEAD-IN CABLE TAG SHALL INDICATE THE LOCATION OF THE LOOP, LOOP ROTATION (CLOCKWISE/COUNTERCLOCKWISE), LOOP LEAD-IN DIRECTION (IN OR OUT), LOOP CABLE NUMBER AND LOCATION IN CABINET, AND NUMBER OF TURNS IN THE DETECTOR LOOPS IN WATER PROOF INK AS INDICATED ON THE DISTRICT 1 STANDARD TRAFFIC SIGNAL DESIGN DETAIL: THE CONTRACTOR SHALL MARK LOOP LOCATIONS ON RECORD DRAWINGS AND PRESENT TO THE ENGINEER AFTER FINAL INSPECTION. LOOPS SHALL BE MARKED BY LANE AND LOOP NUMBER. SEE DETAIL BELOW.
- 4. ALL LOOP CABLE SHALL BE FASTENED WITH PLASTIC TIE WRAP TO THE HANDHOLE HOOKS.
- 5. IN ASPHALT PAVEMENT, LOOPS SHOULD BE PLACED IN THE BINDER AND DIVEHOLES MARKED AT THE CURB WITH A SAW CUT. THE SAW CUT SHALL BE CUT IN ACCORDANCE WITH LOCAL AND E.P.A. DUST CONTROL REQUIREMENTS. DETECTOR LOOP(S) SHALL NOT BE INSTALLED IN WET CONDITIONS AND THE SAW-CUTS MUST BE FREE OF DEBRIS AND RESIDUE SUCH AS DUST AND WATER WHICH IS TO BE ACHIEVED BY THE USE OF COMPRESSED AIR, WIRE BRUSHING AND HEAT DRYING ACCORDING TO SEALANT MANUFACTURER REQUIREMENTS. THE DETECTOR WIRE SHALL BE HELD IN PLACE BY THE USE OF FORM WEDGES. WEDGES SHALL BE SPACED NO MORE THAN 18" (450 mm) APART.
- 6. LOOP SPLICES SHALL BE SOLDERED USING A SOLDERING IRON. BLOW TORCHES OR OTHER DEVICES WHICH OXIDIZE COPPER CABLE SHALL NOT BE ALLOWED FOR SOLDERING OPERATIONS. SEE DETAIL BELOW RIGHT.
- 7, PREFORMED DETECTOR LOOPS SHALL BE USED, AS SHOWN ON THE PLANS, WHERE NEW CONCRETE PAVEMENT IS PROPOSED. THE INSTALLATION OF PREFORMED LOOPS SHALL BE IN ACCORDANCE WITH THE DISTRICT 1 SPECIFICATIONS OR AS DIRECTED BY THE ENGINEER.

LOOP LEAD-IN CABLE TAG

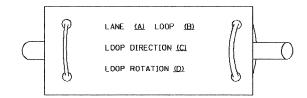


- A. LANE 1 IS THE LANE CLOSEST TO THE CENTERLINE OF THE ROADWAY
- B. LOOP "I IS THE LOOP IN THE LANE CLOSEST TO THE INTERSECTION.
- C. LABEL LOOP CABLE "IN" OR LOOP CABLE "OUT".
- D. LABEL LOOP CABLE CLOCKWISE OR LOOP CABLE COUNTERCLOCKWISE.

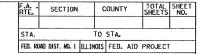


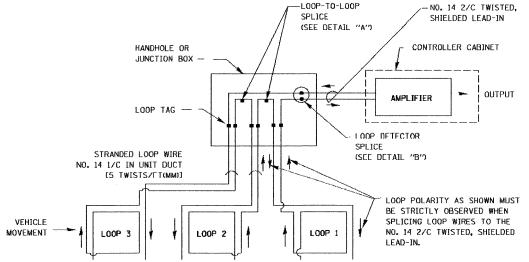


DETECTOR LOOP WIRING SCHEMATIC

- LOOPS SHALL BE SPLICED IN SERIES.
- SAW CUTS SHALL BE A MINIMUM WIDTH OF 5/16" (8 mm).
- SAW-CUIT DEPTHS SHALL BE 3" (75 mm), IE IN CONCRETE. THE SAW-CUT DEPTH SHALL BE TO THE TOP OF THE REINFORCEMENT.
- LOOP CORNERS SHALL BE DRILLED WITH A 2" (50 mm) DIAMETER CORE.

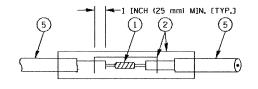

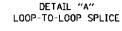

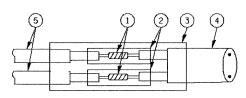

DETAIL "B" LOOP-TO-CONTROLLER SPLICE

LOOP DETECTOR SPLICE

- 1) WESTERN UNION SPLICE SOLDERED WITH ROSIN CORE FLUX. ALL EXPOSED SURFACES OF THE SOLDER SHALL BE SMOOTH.
- (2) WCSMW 30/100 HEAT SHRINK TUBE, MINIMUM LENGTH 3" (/5 mm), UNDERWATER GRADE.
- (3) WCS 200/750 HEAT SHRINK TUBE, MINIMUM LENCHT 6" (150 mm), UNDERWATER CRADE.
- (4) NO. 14 2/C TWISTED, SHIELDED CABLE.
- (5) LOOP CONDUCTOR WITH FLEXIBLE PLASTIC TUBE.

REVISIONS		
NAME	DATE	ILI
CADD	5/30/00	
ADD NOTE NO. 8	11/12/01	
BUREAU OF TRAFFIC	1-01-02	
		SCALE.

LINOIS DEPARTMENT OF TRANSPORTATION

DISTRICT ONE STANDARD TRAFFIC SIGNAL DESIGN DETAILS

HORIZ. NONE

DRAWN BY: RWP DESIGNED BY: DAD CHECKED BY: DAZ SHEET 1 OF 4

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DESIGNED TVN REVISED DRAWN TVN REVISED CHECKED RPD REVISED DATE 01/14/09 REVISED

STATE OF ILLINOIS

FAI 57/1-57 AT N. PEOTONE/JOLIET RD SHEET NO. OF SHEETS STA.

DISTRICT ONE STANDARD DETAILS TS-5A


TO STA.

TOTAL SHEE SHEETS NO. COUNTY 99-2H-1-I-2 CONTRACT NO. 60D65

DEPARTMENT OF TRANSPORTATION

TRAFFIC SIGNAL MAST ARM AND POST

PEDESTRIAN SIGNAL PUSHBUTTON

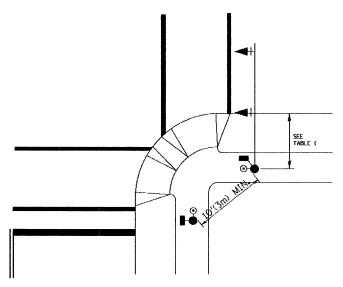

RECOMMENDED PUSHBUTTON LOCATIONS FOR ACCESSIBLE PEDESTRIAN SIGNALS SHALL BE IN ACCORDANCE WITH THE CURRENT MUTCO (SEE NOTE 1). TO MEET MUTCD REQUIREMENTS, PEDESTRIAN SIGNAL PUSHBUTTONS MAY HAVE TO BE MOUNTED ON A SEPARATE POST.

NOTES:

TOTAL SHEET SHEETS NO. TO STA FFD. ROAD DIST. NO. 1 |LLUNDIS FFD. AID PROJECT

COUNTY

SECTION

1. AT ACCESSIBLE PEDESTRIAN SIGNAL LOCATIONS WITH PEDESTRIAN ACTUATION, EACH PUSHBUTTON SHALL ACTIVATE BOTH THE WALK INTERVAL AND THE ACCESSIBLE PEDESTRIAN SIGNALS.

AT ACCESSIBLE PEDESTRIAN SIGNAL LOCATIONS, PUSHBUTTONS SHOULD CLEARLY INDICATE WHICH CROSSWALK SIGNAL IS ACTUATED BY EACH PUSHBUTTON, PUSHBUTTONS AND TACTILE ARROWS SHOULD HAVE HIGH VISUAL CONTRAST (SEE THE DEPARTMENT OF JUSTICE'S AMERICANS WITH DISABILITIES ACT STANDARDS FOR ACCESSIBLE DESIGN, 1991). TACTILE ARROWS SHOULD POINT IN THE SAME DIRECTION AS THE ASSOCIATED PROSSWALK. AT CORNERS OF SIGNAL/ZLD LOCATIONS WITH ACCESSIBLE PEDESTRIAN SIGNALS WHERE PEDESTRIAN PUSHBUTTONS ARE PROVIDED, THE PUSHBUTTONS SHOULD BE SEPARATED BY THE DISTANCE OF AT LEAST 10 FT (3m). THIS ENABLES PEDESTRIANS WHO HAVE VISUAL DISABILITIES TO DISTINGUISH AND LOCATE THE APPROPRIATE PUSHBUTTON.

PUSHBUTTONS FOR ACCESSIBLE PEDESTRIAN SIGNALS SHOULD BE LOCATED AS FOLLOWS:

- A: ADJACENT TO A LEVEL ALL-WEATHER SURFACE TO PROVIDE ACCESS FROM A WHEELCHAIR, AND WHERE THERE IS AN ALL WEATHER SURFACE, WHEELCHAIR ACCESSIBLE ROUTE TO THE RAMP.
- B: WITHIN 5 FT (1.5m) OF THE CROSSWALK EXTENDED.
- C: WITHIN 10 FT (3m) OF THE EDGE OF CURB, SHOULDER, OR PAVEMENT.
- D: PARALLEL TO THE CROSSWALK TO BE USED (SEE MUTCD FIGURE 4E-2).
- E: NORMAL PEDESTRIAN PUSHBUTTON MOUNTING HEIGHT SHOULD BE 3.5 FT (1.05m)
- 2. PEDESTRIAN SIGNAL FACES SHALL BE MOUNTED WITH THE BOTTOM OF THE HOUSING NOT LESS THAN 8 FT (2.4m) NOR MORE THAN 10 FT (3.0m) ABOVE THE SIDEWALK LEVEL AND SO THERE IS A PEDESTRIAN INDICATION IN THE LINE OF PEDESTRIANS
- 3. THE BOTTOM OF THE HOUSING OF A VEHICLE SIGNAL FACE, NOT MOUNTED OVER A ROADWAY, SHALL BE AT LEAST 10 FT (3.0m) BUT NOT MORE THAN 15 FT (4.5m) ABOVE THE SIDEWALK OR, ABOVE THE PAVEMENT GRADE AT THE CENTER OF THE HIGHWAY IF NO SIDEWALKS EXIST.
- 4. THE BOTTOM OF THE HOUSING OF A VEHICLE SIGNAL FACE, MOUNTED OVER A ROADWAY, SHALL BE ACCORDING TO CURRENT STATE STANDARDS 877001 AND 877006. (16 FT (5m) MIN., 18 FT (5.5m) MAX., FROM HIGHEST POINT OF PAVEMENT)

PEDESTRIAN SIGNAL POST

PEDESTRIAN SIGNAL HEAD AND PEDESIRIAN PUSHBUITON DETECTOR LOCATION

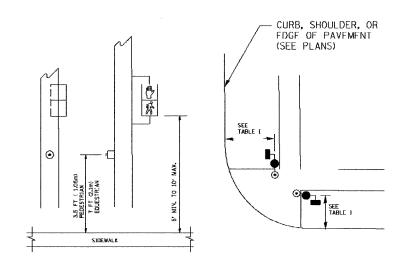


TABLE I

TRAFFIC SIGNAL EQUIPMENT	COMBINATION CONCRETE CURB AND GUTTER (MIN. DIST. FROM BACK OF CURB)	SHOULDER/NON-CURBED AREA (MIN. DIST. FROM FDGF OF PAVFMFNT)
TRAFFIC SIGNAL MAST ARM POLE	6 FT (I.8m)	SHOULDER WIDTH + 2FT(O.6m), MINIMUM 10FT(3.0m)
TRAFFIC SIGNAL POST	4 FT (1.2m)	SHOULDER WIDTH + 2FT(0.6m), MINIMUM 10FT(3.0m)
PEDESTRIAN SICNAL POST	4 FT (1,2m)	SHOULDER WIDTH + 2FT(0.6m), MINIMUM 10FT(3.0m)
PEDESTRIAN PUSHBUTTON	SEE NOTE 1	SEC NOTE 1

REVISIONS NAME ILLINOIS DEPARTMENT OF TRANSPORTATION BUREAU OF TRAFFIC 1/01/0 DISTRICT 1 STANDARD TRAFFIC SIGNAL DESIGN DETAILS DRAWN BY: RWP DESIGNED BY: DAD CHECKED BY: DAZ SHEET 2 OF 4 SCALE: VERT. NONE

200 22ND Street, Suite 216, Lombard, IL 60148 630.705.0110 voice, 630.839.2566 fax www.millenniaeng.com MILLENNIA ENGINEERING DESIGNED TVN REVISED TVN REVISED CHECKED RPD REVISED DATE 01/14/09 REVISED

STATE OF ILLINOIS **DEPARTMENT OF TRANSPORTATION**


FAI 57/1-57 AT N. PEOTONE/JOLIET RD SCALE: SHEET NO. OF SHEETS STA.


DISTRICT ONE STANDARD DETAILS

TO STA.

TS05 SECTION COUNTY WILL 34 14 99-2H-1-I-2 CONTRACT NO. 60D65

FED. ROAD DIST. NO. 1 ILLINOIS FED. AID PROJECT

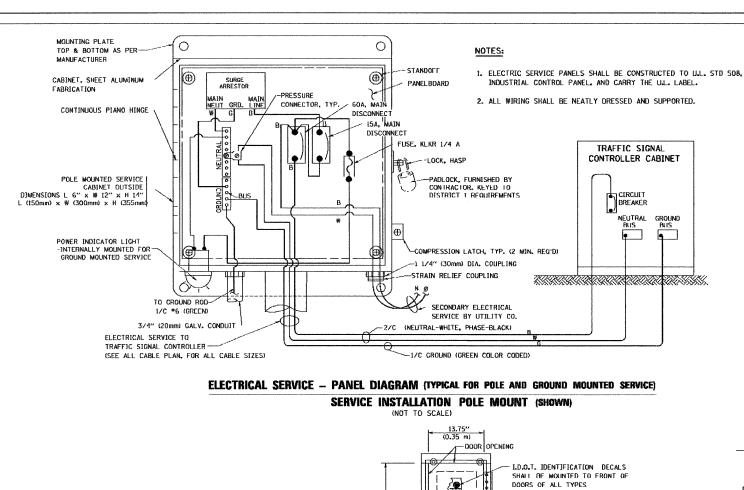

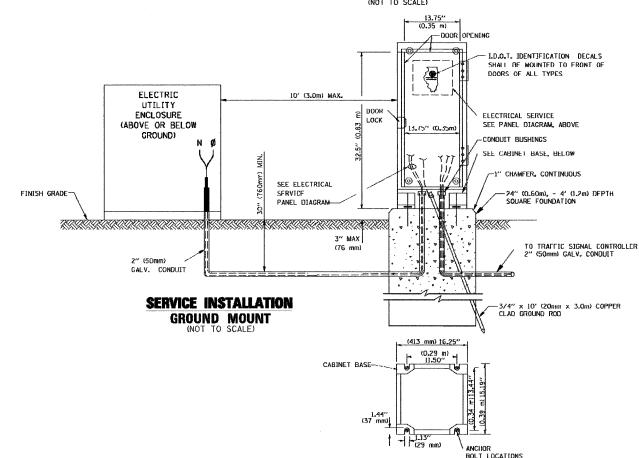

CABINET - BASE BOLT PATTERN

NOTES:

GROUNDING SYSTEM

10 STA

COUNTY

SECTION

F.A. . RTE.


FED. ROAD DIST. NO. | ILLINOIS | FED. AID PROJECT

1. THE GROLINDING SYSTEM SHALL CONSIST OF AN INSULATED CONDUCTOR TYPE XLP, NO. 6 A.W.G., STRANDED COPPER TO BE INSTALLED IN RACEWAYS. THE GROUNDING CABLE SHALL BE INSTALLED IN A CONTINUOUS MANNER AS SHOWN ON THE CABLE PLAN PROVIDED. ALL GROUNDING CONDUCTORS SHALL BE BONDED TO METAL ENCLOSURE. (HANDHOLE, POST, MAST ARM, CONTROLLER, ETC.), GROUND ROD SHALL BE 3/4" DIA. x 10' 0" (20mm x 3.0m) LONG, COPPER CLAD. ONE GROUND ROD SHALL BE INSTALLED AT ALL POST FOUNDATIONS, POLE FOUNDATIONS, CONTROLLER CABINET FOUNDATION AND ELECTRICAL SERVICE INSTALLATION AS INDICATED ON THE CABLE PLAN. IF THERE ARE ANY SPECIAL CONDITIONS SHICH AS SUR-SURFACE CONDITIONS OR INSTALLATION PROBLEMS, THE RESIDENT ENGINEER SHALL BE NOTIFIED OR CONTACT THE BUREAU OF TRAFFIC. ILLINOIS DEPARTMENT OF TRANSPORTATION DISTRICT ONE AT (847) 705-4139.


2. THE NEUTRAL CONDUCTOR AND THE GROUND CONDUCTOR SHALL BE CONNECTED IN THE SERVICE INSTALLATION. AT NO OTHER POINT IN THE TRAFFIC SIGNAL SYSTEM SHALL THE NEUTRAL AND GROUND

3. ALL EQUIPMENT GROUNDING CONDUCTORS SHALL TERMINATE AT THE GROUND BUS IN THE CONTROLLER CABINET.

4. THE CONTRACTOR SHALL PROVIDE A GROUND CABLE WITH CONNECTORS BETWEEN THE HANDHOLE COVER AND HANDHOLE FRAME.

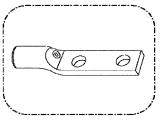


HEAVY-DUTY COMPRESSION TERMINAL (BURNDY TYPE YGHA OR APPROVED EQUAL)

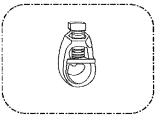

3/4" (20mm) HEAVY-DUTY GROUND ROD CLAMP (BURNDY TYPE GRC OR APPROVED EUAL)

· ALL CLAMPS SHALL BE BRONZE OR COPPER, UL APPROVED. GROUND CABLE SHALL BE LOOPED OVER HOOKS IN THE HANDHOLES 6.5' (2.0m) SLACK SHALL BE PROVIDED IN SINGLE HANDHOLES

13' (4.0m) OF SLACK SHALL BE PROVIDED IN DOUBLE HANDHOLES. 5' (1.4m) OF SLACK SHALL BE PROVIDED BETWEEN FRAME AND COVER.

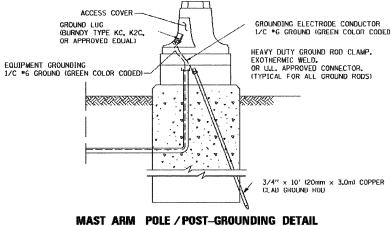

(NOT TO SCALE) REVISIONS ILLINOIS DEPARTMENT OF TRANSPORTATION

NAME	DATE	İ
CADD	5/30/00	
CADD	3/15/01	
BUREAU OF TRAFFIC	1/01/02	
		STAND
] 0,,,,,,
		Į Į
		SCALE: VERT.
~ ~~~~~~~~~~~~~~~~~~~~~~~~~~~~~~~~~~~~	T	I SCALLE

DISTRICT 1 DARD TRAFFIC SIGNAL DESIGN DETAILS

HORIZ. NONE DATE 10/18/2002

TSOS

10/18/2002

630.705.0110 voice, 630.839.2566 fax MILLENNIA ENGINEERING

TVN REVISED RAWN TVN REVISED CHECKED RPD REVISED 01/14/09 REVISED

STATE OF ILLINOIS **DEPARTMENT OF TRANSPORTATION**

CAST CORNER FRAME WEB:

ANTI-CORROSION COMPOUND:

STEEL WASHERS

REQUIRED, ALL:

HANDHOLES

FRAME AND TO COVER. (TYPICAL)

SHALL BE APPLIED ON ALL BOLT/ CONNECTION ASSEMBLIES.

STAINLESS STEEL NUT AND 2 STAINLESS

SEE DETAIL "A"

(2) 1/2" x 1 1/4" STAINLESS STEEL BOLT WITH SPLIT LOCK WASHER AND NYLON INSERT LOCKOUT WELDED TO

EXISTING HANDHOLE

EXISTING HANDHOLE COVER & FRAME - GROUNDING DETAIL

(NOT TO SCALE)

FRAME AND COVER

UL LISTED GROUND COMPRESSION CONNECTOR

UL LISTED GROUND COMPRESSION CONNECTOR — WITH STAINLESS STEEL NUT

Z1/C #6

HANDHOLE COVER & FRAME - GROUNDING DETAIL

(NOT TO SCALE)

DETAIL "A"

HANDHOLE COVER

HANDLE

DETAIL "B"

RECESSED COVER

-u.i. LISTED

DIRECT BURIAL

TO CONTROLLER

DOUBLE HANDHOLE

TO POLE OR

POST AS REQ'D.

SEE DETAIL "B"

FAI 57/I-57 AT N. PEOTONE/JOLIET RD SHEET NO. OF SHEETS STA.


GROUNDING CABLE
(PAID FOR SEPARATELY)


HEAVY DUTY COPPER COMPRESSION GROUNDING TERMINAL, (TYPICAL)

DISTRICT ONE STANDARD DETAILS TS-5C

TOTAL SHEET SHEETS NO. SECTION COUNTY 34 15 99-2H-1-I-2 57 WILL CONTRACT NO. 60D65 FED. ROAD DIST. NO. 1 | ILLINOIS FED. AID PROJECT

1/13/2009 P1/2007/1 1.00001

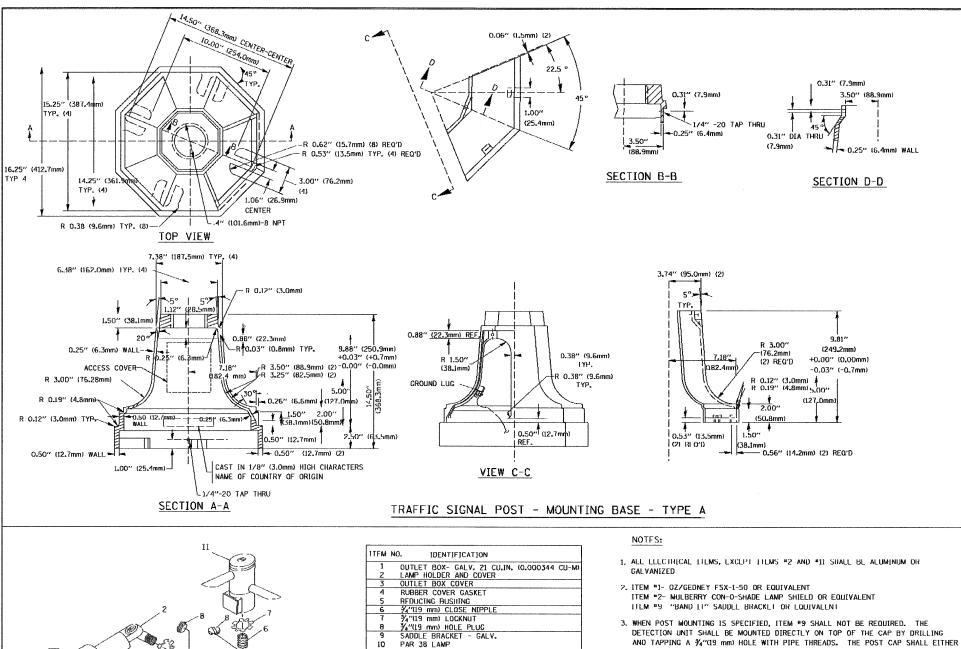


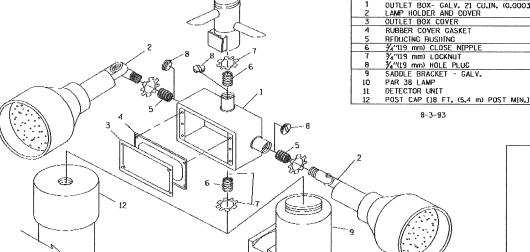

EMERGENCY VEHICLE DETECTOR WITH CONFIRMATION BEACON MOUNTING DETAIL


MAST ARM MOUNT

BE SCREWED TO THE TOP OF THE POST OR A MINIMUM OF 3 TIGHTENING SCREWS SHALL BE REQUIRED ON EACH CAP.

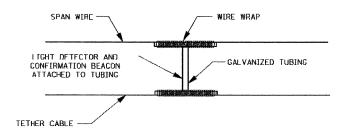


LIGHT DETECTOR AND CONFIRMATION BEACON MOUNTING FOR TEMPORARY TRAFFIC SIGNALS


(NOT TO SCALE)

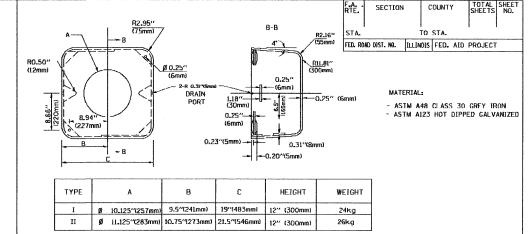

SHROUD DETAIL

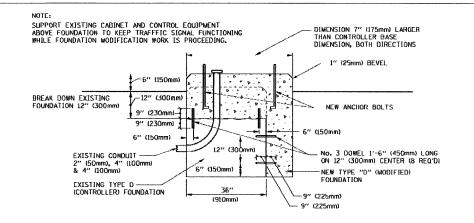

MODIFY EXISTING TYPE "D" FOUNDATION

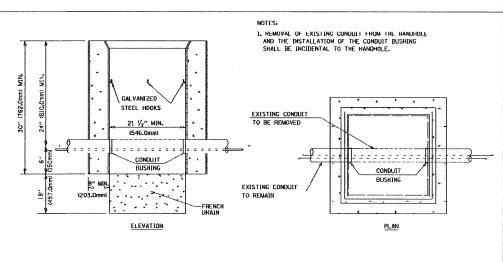

HANDHOLE TO INTERCEPT EXISTING CONDUIT

REVISIONS		ILLINOIS DEPARTMENT OF TRANSPORTATION	
NAME	DATE	TELINOIS DEFARTMENT OF TRANSPORTATION	
BUREAU OF TRAFFIC	5/30/00		
BUREAU OF TRAFFIC	3/15/01	DISTRICT 1	
BURCAU OF TRAFFIC	11/12/01	DIJTRICT I	
BUREAU OF TRAFFIC	1-01-02	STANDARD TRAFFIC SIGNAL	
		DESIGN DETAILS	
		SCALE: VERT. NONE DESIGNED BY: DAY	
		SCALE: NONE DESIGNED BY: DAI	ũ

HORIZ. N DATE 10/18/2002

COUNTY

POST CAP MOUNT

200 22ND Street, Suite 216, Lombard, IL 60148 630.705.0110 voice, 630.839.2566 fax www.millenniaeng.com MILLENNIA ENGINEERING DESIGNED TVN REVISED CHECKED RPD REVISED DATE 01/14/09 REVISED

STATE OF ILLINOIS **DEPARTMENT OF TRANSPORTATION**

FAI 57/I-57 AT N. PEOTONE/JOLIET RD

SHEET NO. OF SHEETS STA.

SCALE:

DISTRICT ONE STANDARD DETAILS

TOTAL SHEE SHEETS NO. SECTION WILL 99-2H-1-I-2 CONTRACT NO. 60D65 FED. ROAD DIST. NO. 1 ILLINOIS FED. AID PROJECT

The existing structure was built in 1967. It is a four span continuous structure with steel beams. The substructure consists of open stub abutments and reinforced column concrete piers. The rehabilitaion work will be done utilizing stage construction.

SHEET NO. ROUTE NO. TOTAL SHEET NO. 1 99-2HB 12 SHEETS FAI 57 34 WILL -1-I-2

Contract #60D65

The proposed improvements consist of hydroscarifying the deck, deck slab repairs, replacing the existing expansion joints, replacing the existing expansion bearings at the abutments, construction of a latex concrete overlay, providing drain extensions for existing drains, repair of the parapets, slope wall repair, and repair of the substructure.

€ I-57 N. bound lanes— ├──@ I-57 S. bound lanes INDEX OF SHEETS 1. General Plan and Elevation Typical Cross Sections with Staging Expansion Joint Rehabilitation at Deck Expansion Joint Rehabilitation at Parapet and Soffit

ELEVATION

- Preformed Joint Strip Seal
- Bar Splicer Assembly Details Bearing Replacement Details
- Floor Drain Details
- Deck and Parapet Repair Plan I
- Deck and Parapet Repair Plan II
- 11. Abutment and Slope Wall Repairs
- 12. Pier Repairs

- * Provide Floor Drain Extension (See Sheet 8 of 12 for Details)
- P Plug Existing Deck Drain (See Sheet 8 of 12 for Details)

 Existing Drains not indicated " * " or " P " are already plugged

Traffic Barrier Terminal Std. 631031 - Type 6 (Typ.) 283′-9" 52′-3" 85′-9" 85′-9" 53′-9" 3'-1₂" 8 Existing Floor Drains at ±6′ cts. (Typ.) 37°-58′-02"-N Joint Replacement North Peotone Road € Brg. E. Abut. (see sheet 3 of 12) Bk. of W. Abut .-& Stage Construction Line Brg. W. Abut. Pier #3 Joint Replacement Bk. of E. Abut. (see sheet 3 of 12) Limits of Protective Shield 171'-6" x 29'-7" width

PLAN

TOTAL BILL OF MATERIAL

ITEM	UNIT	SUPER	SUB	TOTAL
Concrete Removal	Cu. Yd.	11.6		11.6
Bridge Deck Hydro-Scarification, 1/2"	Sq. Yd.	930		930
Deck Slab Repair (Full Depth, Type I)	Sq. Yd.	2		2
De Slab Repair (Full Depth, Type II)	Sq. Yd.	78		78
Briage Deck Latex Concrete Overlay, 21/4"	Sq. Yd.	930		930
Jack and Remove Existing Bearings	Each	12		12
Anchor Bolt, 1"	Each	24		24
Elastomeric Bearing Assembly, Type II	Each	12		12
Furnishing and Erecting Structural Steel	Pound	1271		1271
Preformed Joint Strip Seal	Foot	80		80
Concrete Superstructure	Cu. Yd.	12.7		12.7
Protective Shield	Sq. Yd.	564		564
Protective Coat	Sq. Yd.	34		34
Bridge Deck Grooving	Sq. Yd.	884		884
Reinforcement Bars, Epoxy Coated	Pound	1450		1450
Bar Splicers	Each	20		20
Slope Wall Repair	Sg. Yd.		15	15
Plug Existing Deck Drains	Each	1		1
Floor Drain Extension	Each	13		13
Structural Repair of Concrete (Depth equal to or less than 5")	Sq. Ft.	, 14	105	119

GENERAL NOTES

Reinforcement bars shall conform to the requirements of ASTM A 706 Gr 60. See Special Provisions.

Reinforcement bars designated (E) shall be epoxy coated. Prior to pouring the new concrete deck, all heavy or loose rust, loose mill scale, and other loose or potentially detrimental foreign material shall be removed from the surfaces in contact with concrete. Tightly adhered paint may remain unless otherwise noted. Removal shall be accomplished by methods that will not damage the steel and the cost will be included in the pay item covering removal of the existing concrete.

Plan dimensions and details relative to existing plans are subject to routine variations. The Contractor shall field verify existing dimensions and details affecting new construction and make necessary approved adjustments prior to construction or ordering of materials. Such variations shall not be cause for additional compensation for a change in scope of the work, however, the Contractor will be paid for the quantity actually furnished based upon the unit

The existing structural steel coating contains lead. The Contractor shall take appropriate precautions to deal with the presence of lead on this project.

Two $^{\prime}_{8}$ in. adjusting shims shall be provided for each bearing in addition to all other plates or shims and placed as shown on bearing details.

All new structural steel shall be shop painted with an inorganic zinc rich primer per AASHTO M 300, Type 1.

These plans have been prepared from notes received from the Illinois Department of Transportation field maintenance Engineers. Protective Coat shall not be applied over Latex Concrete Overlay.

DESIGN SPECIFICATIONS

2002 AASHTO Standard Specifications for Highway Bridges

LOADING HS 20-44

DESIGN STRESSES

FIELD UNITS f'c = 3,500 psi

fy = 60,000 psi (Reinforcement) fy = 36,000 psi (M270 Grade 36)



2.5.09 Expires 11-30-10

200 West Front Street Wheaton, IL 60187

GENERAL PLAN AND ELEVATION NORTH PEOTONE ROAD OVER I-57 FAI RTE 57 SECTION 99-2HB-1-I-2

ILLINOIS DEPARTMENT OF TRANSPORTATION

Ranae 12E - 3rd PM

LOCATION SKETCH


WILL COUNTY STATION 1035+6.40 STRUCTURE NO. 099-0162

DATE: 1-14-2009


DRAWN BY WJV CHECKED BY BLB


ROU	TE NO.	SECTION	col	JNTY	TOTAL SHEETS	SHEET NO.	SHEET NO. 2
FA	NI 57	99-2HB -1-I-2	WILL		34	18	12 SHEETS
FED. ROAD DIST. NO. 7			ILLINOIS	FED. AID PR	ојест-		

Contract #60D65

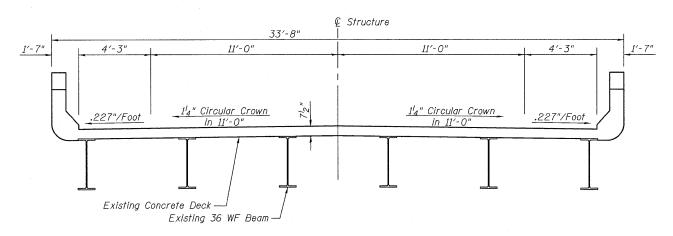


EXISTING CROSS SECTION

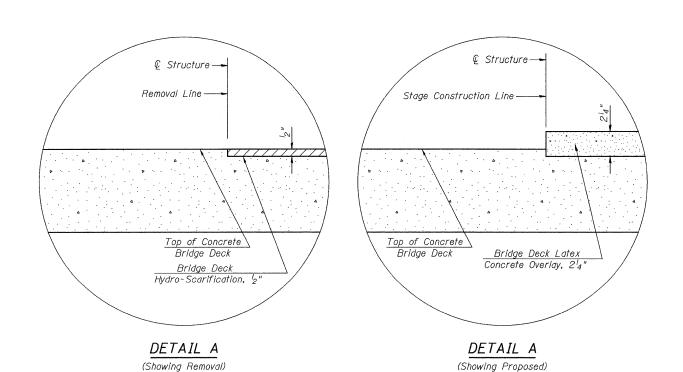

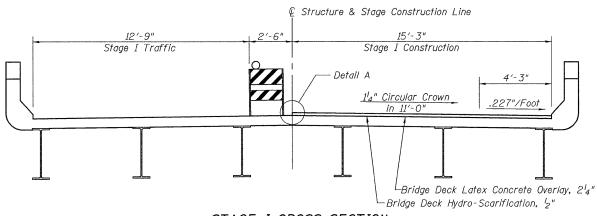

STAGE I CROSS SECTION (Looking West)

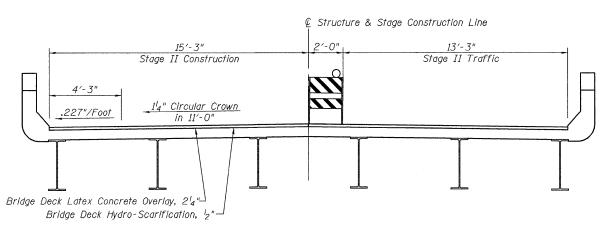


STAGE II CROSS SECTION
(Looking West)



200 West Front Street Wheaton, IL 60187 ILLINOIS DEPARTMENT OF TRANSPORTATION
TYPICAL CROSS SECTIONS
WITH STAGING
NORTH PEOTONE ROAD OVER I-57
FAI RTE 57 SECTION 99-2HB-1-I-2
WILL COUNTY
STATION 1035+6.40
STRUCTURE NO. 099-0162

DATE: 1-14-2009 DRAWN BY BLB

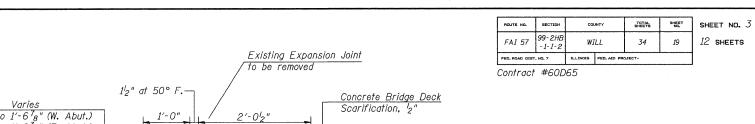


Varies 1'-3³g" to 1'-6⁷g" (W. Abut.) 1'-3⁵g" to 1'-6³g" (E. Abut.) Concrete Back of Abut. ⊷@ Brg. 9'4" 5'2", Measured along @ beam

> SECTION A-A (All dimensions are at right L's)

Existing longitudinal reinforcement to remain *2" at 50° F. -Preformed Joint Strip Seal See Sheet 5 of 12 $a_1(E)$ Appr. Pav't. u(E) -Construction low beam Joint $\frac{Varies}{1' - 5_{g}^{l}$ " to $1' - 8_{g}^{5}$ " (W. Abut.) $1' - 5_{g}^{3}$ " to $1' - 8_{g}^{l}$ " (E. Abut.) Concrete Superstructure Back of Abut. ---- € Brg. Existing vertical 9¹4["] 5¹2" Measured along € beam reinforcement to remain SECTION B-B

*See sheet 5 of 12 for Notes.

(All dimensions are at right L's)

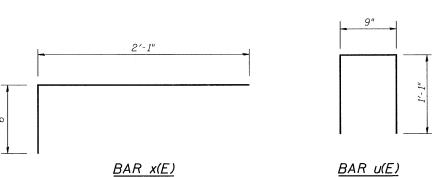

The End Diaphragms shall be cleaned per New White Blast Cleaning-SSPC-SP10 and shall be painted according to the requirements of paint system 1-0Z/E/U. The color of the final finish coat shall be Gray, Munsell No. 5B 7/1. See Speical Provision for Cleaning and Painting Existing Steel Structures. Cost of Blast Cleaning and Painting of Diaphragms under joints shall be included with Concrete Removal.

NOTES

Hatched areas indicate concrete sections to be removed. Care shall be exercised by the contractor during and following Concrete Removal operations to ensure that the existing rebar remaining in place are not damaged. All existing reinforcement to be incorporated into new construction shall be blast-cleaned, straightened, and properly positioned prior to concrete placement. Any reinforcement damaged during Concrete Removal shall be repaired or replaced using an approved Bar Splicer or Mechanical System. Cost included with Concrete Removal.

Existing reinforcement bars that are parallel to the expansion joint shall

Removal of the existing expansion joints will not be paid for separately, but shall be included with the cost of Concrete Removal.

BILL OF MATERIAL

Bar	No.	Size	Length	Shape
a(E)	24	#5	20′-6"	
a ₁ (E)	16	#6	20′-6"	
d(E)	12	#5	6'-9"	
$d_1(E)$	12	#5	3′-6"	
$d_2(E)$	6	#4	5′-3"	
x(E)	64	#5	2'-7"	
u(E)	40	#5	2'-11"	Π
Concre	te Remov	ral	Cu. Yd.	11.6
Reinforcement Bars, Epoxy Coated			Pound	1450
Concre Supers	te structure		Cu. Yd.	12.7
Protec	tive Coat		Sq. Yd.	34
Bar Sp	olicers		Each	20

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200 West Front Street Wheaton, IL 60187

ILLINOIS DEPARTMENT OF TRANSPORTATION **EXPANSION JOINT REHABILITATION** AT DECK NORTH PEOTONE ROAD OVER I-57 FAI RTE 57 SECTION 99-2HB-1-I-2 WILL COUNTY STATION 1035+6.40 STRUCTURE NO. 099-0162

DRAWN BY LM CHECKED BY WJV DATE: 1-14-2009

17'-4" Stage I Removal

16'-4" Stage II Removal

3-#5 a(E) at 10" cts. Top & bottom of slab

(Typ. each stage)

6 Bar Splicers (E), for #5 a(E) bars

16-#5 x(E) bars at 12" cts.

16'-10" Stage II Construction

Stage Removal Line

6"

JOINT REMOVAL PLAN

(West End Shown, East End Similar)

JOINT REPLACEMENT PLAN

(West End Shown, East End Similar)

© Roadway &

Stage Construction Line


16-#5 x(E) bars at 12" cts.


16'-10" Stage I Construction

4 Bar Splicers (E) for #6 a₁(E) bars

4-#6 a_I(E) Bars placed as shown in Section B-B


(Typ. each stage)

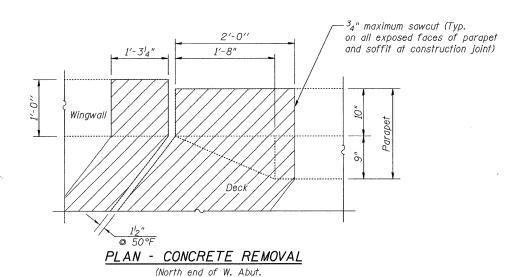


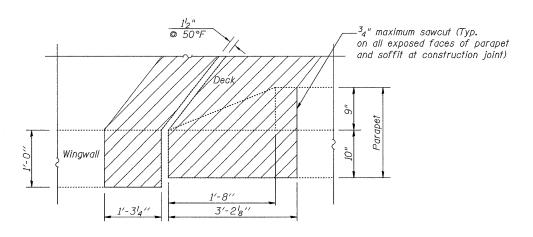

PLAN - CONCRETE REMOVAL

(South end of W. Abut. and North end of E. Abut.)

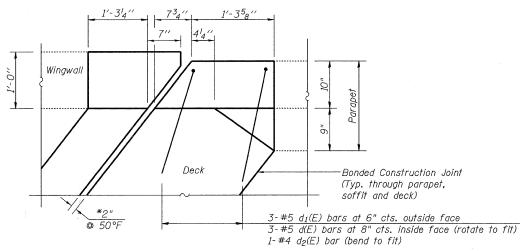

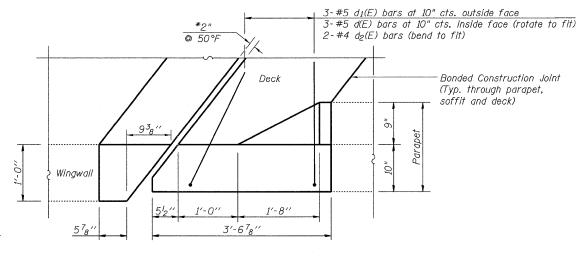

PLAN - CONCRETE REPLACEMENT


(South end of W. Abut. and North end of E. Abut.)


* See sheet 5 of 12 for Notes.

PLAN - CONCRETE REPLACEMENT

and South end of E. Abut.)

(North end of W. Abut. and South end of E. Abut.)

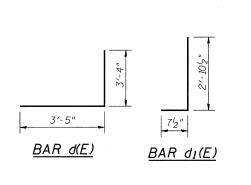

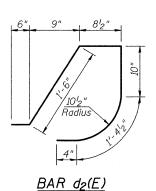

<u>NOTES</u>


Hatched areas indicate concrete sections to be removed. Care shall be exercised by the contractor during and following Concrete Removal operations to ensure that the existing rebar remaining in place are not damaged. All existing reinforcement to be incorporated into new construction shall be blast-cleaned, straightened, and properly positioned prior to concrete placement. Any reinforcement damaged during Concrete Removal shall be repaired or replaced using an approved Bar Splicer or Mechanical System. Cost included with Concrete Removal.

For simplicity, only proposed reinforcement critical to parapet replacement is shown.


See Sheet 3 of 12 for Bill of Material.

ROUTE NO.	SECTION	COUNTY		TOTAL SHRETS	SHEET NO.	SHEET NO. 4
FAI 57	99-2HB -1-I-2	WILL		34	20	12 SHEETS
FED. ROAD DIST	. NQ. 7	ILLINGIS	FED. AID PRI	JECT-		

Contract #60D65

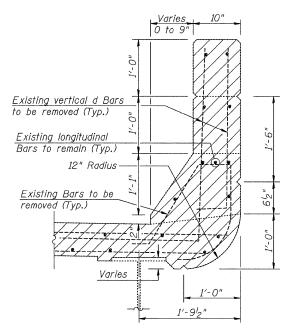

<u>SECTION THROUGH PARAPET &</u> SOFFIT - CONCRETE REMOVAL

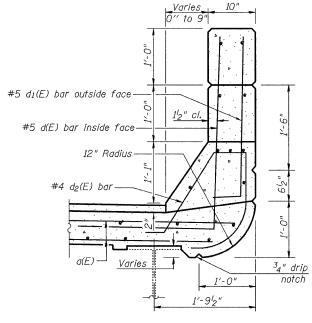

<u>SECTION THROUGH PARAPET &</u> <u>SOFFIT - CONCRETE REPLACEMENT</u>



200 West Front Street

Wheaton, IL 60187

ILLINOIS DEPARTMENT OF TRANSPORTATION
EXPANSION JOINT REHABILITATION
AT PARAPET AND SOFFIT
NORTH PEOTONE ROAD OVER I-57
FAI RTE 57 SECTION 99-2HB-1-I-2
WILL COUNTY
STATION 1035+6.40
STRUCTURE NO. 099-0162


DATE: 1-14-2009


DRAWN BY LM CHECKED BY WJV

POCTOR DESCRIPTION
14/2009 Kr


*Granular or solid flux filled headed studs conforming to Article 1006.32 of the Std.


Specs., automatically end welded. **When joint is fixed, dimension is set at $1_2^{\prime\prime}$.

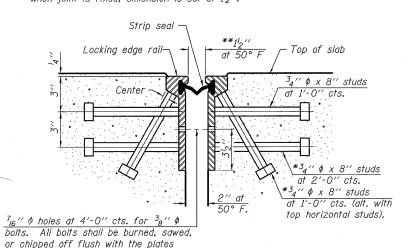

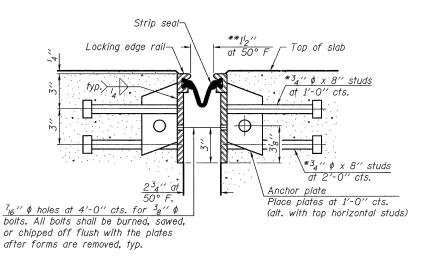


SECTION THRU ROLLED RAIL JOINT

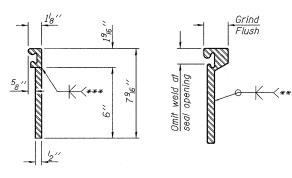

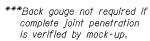

SECTION THRU WELDED RAIL JOINT

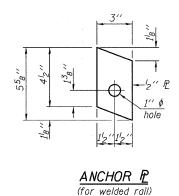


ROLLED WELDED RAIL (EXTRUDED) RAIL

after forms are removed, typ.


LOCKING EDGE RAIL SPLICE

The inside of the locking edge rail groove shall be free of weld residue.

LOCKING EDGE RAILS

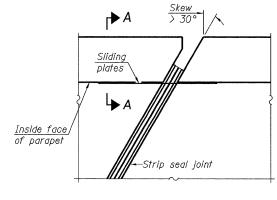

PLAN

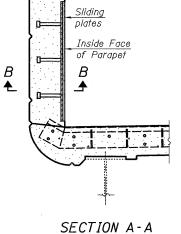



SECTION B-B

POINT BLOCK DETAILS (for skews > 30°)

TOTAL SHEET ROUTE NO. SHEET NO. 5 99-2HB -1-I-2 FAI 57 WILL 34 21 *12* SHEETS

Contract #60D65

Notes:


The strip seal shall be made continuous and shall have a minimum thickness of $\frac{1}{4}$ ". The configuration of the strip seal shall match the configuration of the Locking Edge Rails. Open or "webbed" strip seal gland configurations are not permitted. The gland shall be sized for a maximum rated movement of 4 inches.

The height and thickness of the Locking Edge Rails shown are minimum

dimensions. The actual configuration of the Locking Edge Rails and matching strip seal may vary from manufacturer to manufacturer. Flanged edge rails will not be allowed. Locking Edge Rails may be spliced at slope discontinuities and stage construction joints.


The manufacturer's recommended installation methods shall be followed. The joint opening and deck dimensions detailed on the superstructure are based on a rolled rail expansion joint. If the Contractor elects to use the welded rail expansion joint, the opening and deck dimensions shall be modified according to the dimensions detailed on this sheet. Required modifications shall be made at no additional cost to the State.

All steel components shall be galvanized after fabrication according to Article 520.03 of the Standard Specifications.

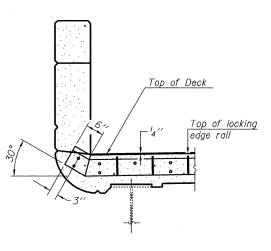

AT PARAPET

TYPICAL END TREATMENTS

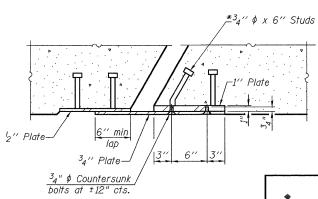

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> 200 West Front Street Wheaton, IL 60187

BILL OF MATERIAL

Unit Total Preformed Joint Strip Seal Foot

ILLINOIS DEPARTMENT OF TRANSPORTATION

PREFORMED JOINT STRIP SEAL NORTH PEOTONE ROAD OVER I-57 FAI RTE 57 SECTION 99-2HB-1-I-2 WILL COUNTY STATION 1035+6.40 STRUCTURE NO. 099-0162

DRAWN BY LM CHECKED BY WJV DATE: 1-14-2009

12 SHEETS

Contract #60D65

NOTES

Bar splicer assemblies shall be of an approved type and shall develop in tension at least 125 percent of the yield strength of the lapped reinforcement bars.

Splicer rods shall be of minimum 60 ksi yield strength, threaded or coiled full length. All reinforcement bars shall be lapped and tied to the splicer rods or dowel bars. Bar splicer assemblies shall be epoxy coated according to the requirements for reinforcement bars.

Other systems of similar design may be submitted to the Engineer for approval. Approval shall be based on certified test results from an approved testing laboratory that the proposed bar splicer assembly satisfies the following requirements:


Minimum Capacity (Tension in kips) = $1.25 \times fy \times A_t$

Minimum *Pull-out Strength = 0.66 x fy x A_t (Tension in kips)

Where fy = Yield strength of lapped reinforcement bars in ksi.

 A_t = Tensile stress area of lapped reinforcement bars. * = 28 day concrete

BAR SPLICER ASSEMBLIES							
		Strength Requirements					
Bar Size to be Spliced	Splicer Rod or Dowel Bar Length	Min. Capacity kips - tension	Min. Pull-Out Strength kips - tension				
#4	1'-8''	14.7	7.9				
#5	2'-0"	23.0	12.3				
#6	2'-7"	33.1	17.4				
#7	3′-5″	45.1	23.8				
#8	4'-6''	58.9	31.3				
#9 '	5′-9′′	75.0	39.6				
#10	7′-3′′	95.0	50.3				
#11	9'-0''	117.4	61.8				

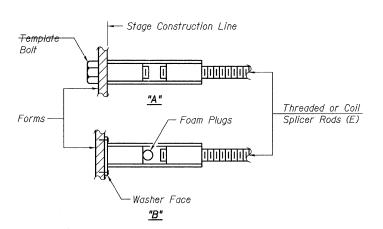

BAR SPLICER ASSEMBLY ALTERNATIVES

WELDED SECTIONS

ROLLED THREAD DOWEL BAR

** ONE PIECE

-Wire Connector

iiijiijijiji

The diameter of this part is

equal or larger than the

diameter of bar spliced.


** Heavy Hex Nuts conforming to ASTM A 563, Grade C, D or DH may be used.

The diameter of this part

is the same as the diameter of the bar spliced.


INSTALLATION AND SETTING METHODS


"A": Set bar splicer assembly by means of a template bolt. "B": Set bar splicer assembly by nailing to wood forms or cementing to steel forms. (E): Indicates epoxy coating.

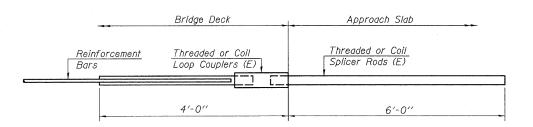

FOR INTEGRAL OR SEMI-INTEGRAL ABUTMENTS

Bar Splicer for #5 bar Min. Capacity = 23.0 kips - tension Min. Pull-out Strength = 12.3 kips - tension . Required = 0

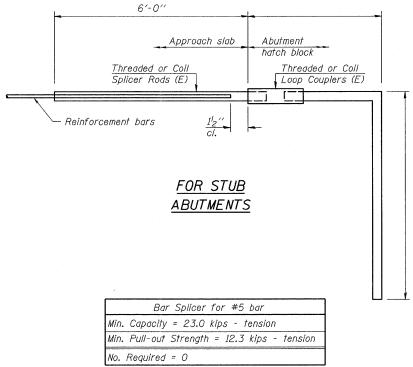

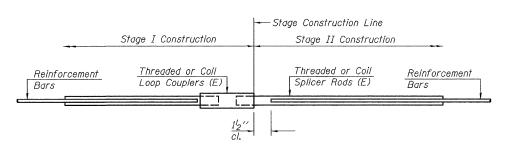

STANDARD

Bar Size	No. Assemblies Required	Location
#5	12	Deck
#6	8	T/Abut.

ringroup Excellence through Ownershi


200 West Front Street

Wheaton, IL 60187

ILLINOIS DEPARTMENT OF TRANSPORTATION


BAR SPLICER ASSEMBLY DETAILS NORTH PEOTONE ROAD OVER I-57 FAI RTE 57 SECTION 99-2HB-1-I-2 WILL COUNTY STATION 1035+6.40 STRUCTURE NO. 099-0162

DRAWN BY LM DATE: 1-14-2009 CHECKED BY WJV

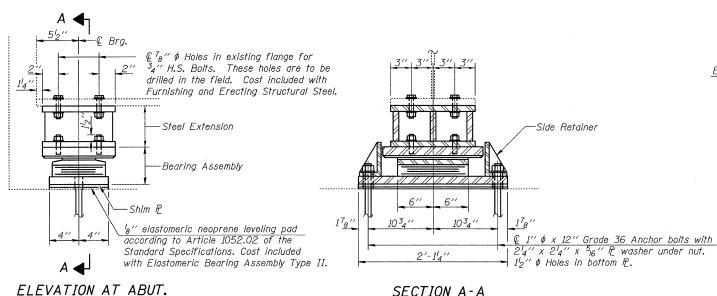


TYPE II ELASTOMERIC EXP. BRG.


18" PTFE unlubricat

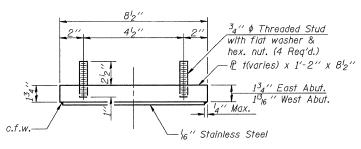


TOP BEARING ASSEMBLY

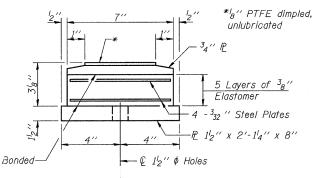

BOTTOM BEARING ASSEMBLY

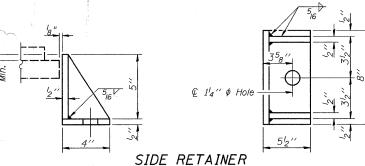

Equivalent rolled angle with stiffeners will be allowed in lieu of welded plates.

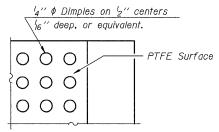

PLAN-PTFE SURFACE

SECTION A-A

with dimpled, 1"	
ed surface	_4
	2,,,
3 ₄ " P	

SECTION THRU PTFE


Abut. Abut. Ream 3 Beam 4 Ream F

SHIM TABLE Match plan dimensions of bottom bearing plate. Weight included with Furnishing and Erecting Structural Steel.

West Fast

BE	ARING F	REACTION TABLE
		Abutment
R Q	(k)	20.7
R4	(k)	<i>34.</i> 6
Imp.	(k)	10.4
R Total	(k)	64.6


← © Top Brg.

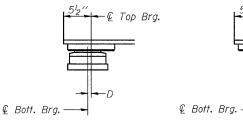

(Move bott. brg. away from fixed brg.) (Move bott. brg. toward fixed brg.)

SETTING ANCHOR BOLTS AT EXP. BRG.

 $D={}^{l}8''$ per each 100' of expansion for every 15° temp. change from the normal temp, of 50°F.

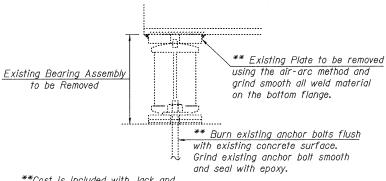

**Cost is included with Jack and Remove Existing Bearings

JACK AND REMOVE EXISTING BEARING AT ABUTMENTS

JACKING PROCEDURES

- 1. Prior to commencing any work at the bearings, the contractor shall submit plans for Jacking for approval by the Engineer.
- 2. Jacking shall be limited so that the maximum lift transversely between adjacent beams is \(\frac{1}{8} \). See Special Provision for Jack and Remove Existing Bearings.
- 3. Minimum Jack capacity is 35 Tons.

NOTES

Anchor bolts shall be ASTM F1554 all-thread (or Engineer-approved alternate material) of the grade(s) and diameter(s) specified. ASTM A307 Grade C anchor bolts may be used in lieu of ASTM F1554 Grade 36 (Fy=36ksi). The corresponding specified grade of AASHTO M314 anchor bolts may be used in lieu of ASTM F1554.

Anchor bolts for Type II bearings shall be placed in holes drilled through the bottom bearing plate after members are in place. Side retainers shall be placed after bolts are installed.

Drilled and set anchor bolts shall be installed according to Article 521.06 of the Standard Specifications.

Side retainers and other steel members required for the bearing assembly shall be included in the cost of Elastomeric Bearing Assembly, Type II.

The 18" PTFE sheet shall be bonded directly to the top steel plate with a two-component, medium viscosity epoxy resin, conforming to the requirements of the Federal Specification MMM-A-134, Type I. The bond agent shall be applied on the full area of the contact surfaces.

Bonding of 18" PTFE sheet during vulcanizing process will be permitted provided the process and method of adjusting assembly height is approved by the Engineer. Prior to ordering any material, the Contractor shall

verify in the field all bearing height and shim thickness


Weight of steel extensions included with Furnishing and Erecting Structural Steel.


ROUTE NO. SHEET NO. 99-2HB -1-I-2 FAI 57 WILL 34 23

SHEET NO. 7


12 SHEETS

Contract #60D65

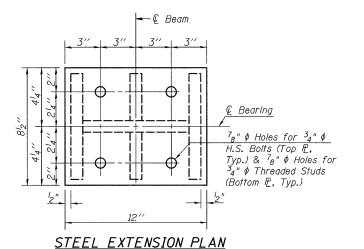

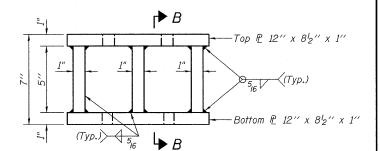

STEEL EXTENSION ELEVATION

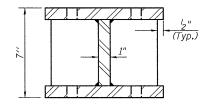

SECTION B-B

BILL OF MATERIAL

Item	Unit	Total
Jack and Remove Existing Bearings	Each	12
Elastomeric Bearing Assembly Type II	Each	12
Furnishing and Erecting Structural Steel	Pound	1271
Anchor Bolts, 1"	Each	24

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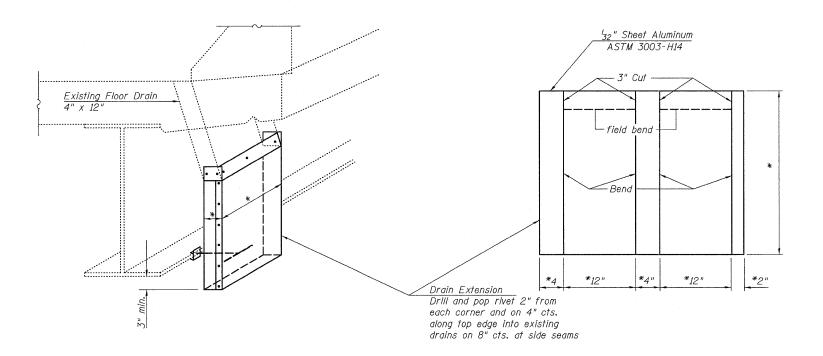
200 West Front Street Wheaton, IL 60187

ILLINOIS DEPARTMENT OF TRANSPORTATION


BEARING REPLACEMENT DETAILS NORTH PEOTONE ROAD OVER I-57 FAI RTE 57 SECTION 99-2HB-1-I-2 WILL COUNTY STATION 1035+6.40 STRUCTURE NO. 099-0162

DRAWN BY BLB CHECKED BY WJV DATE: 1-14-2009

Contract #60D65



*Field measure and cut to fit existing drain

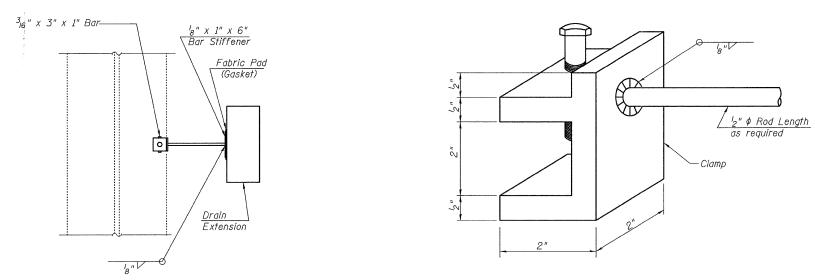

STEEL CLAMP

Field drill 3g " ϕ hole for 1g " ϕ threaded rod 1'-1" long with nuts & washers

Deck Drains shall be eliminated by field drilling a 3e " ϕ hole through the bottom of the drain, installing a l4 " ϕ threaded rod and filling the drain with concrete.

DRAIN PLUGGING DETAIL

<u>NOTES</u>

Pop rivet the $^{l}8$ " x 1" bar to drain extension. Weld or securely attach rod to both the clamp and bar stiffener. Use $^{3}_{16}$ " stainless steel pop rivets of sufficient length. Clamp shown in approximate dimensions. Similar commercially available may be substituted.

An aluminum extrusion drain extension of similar dimensions may be substituted.

If there is a floor drain extension already in place where a new floor drain extension is to be installed, Contractor shall remove it and properly dispose of it. Removal and disposal of the existing floor drain extensions shall be included with the cost of Floor Drain Extensions.

<u>BILL OF MATERIAL</u>

ITEM	UNIT	TOTAL
Plug Existing Deck Drains	Each	1
Floor Drain Extension	Each	13

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FLOOR DRAIN DETAILS
NORTH PEOTONE ROAD OVER I-57
FAI RTE 57 SECTION 99-2HB-1-I-2
WILL COUNTY
STATION 1035+6.40
STRUCTURE NO. 099-0162


DATE: 1-14-2009 DRAWN BY WJV CHECKED BY BLB

sheet no. 9TOTAL SHEETS SHEET NO. FAI 57 99-2HB -1-I-2 12 SHEETS WILL 34 25

Contract #60D65

3 Spaces at 14'-5 ³ g'' = 43'-4'g''	10'-0''	10'-0''	4 Spaces at 15'-11'4'' = 63'-9''	12'-0"
	·			
				<u> </u>

NORTH PARAPET ELEVATION

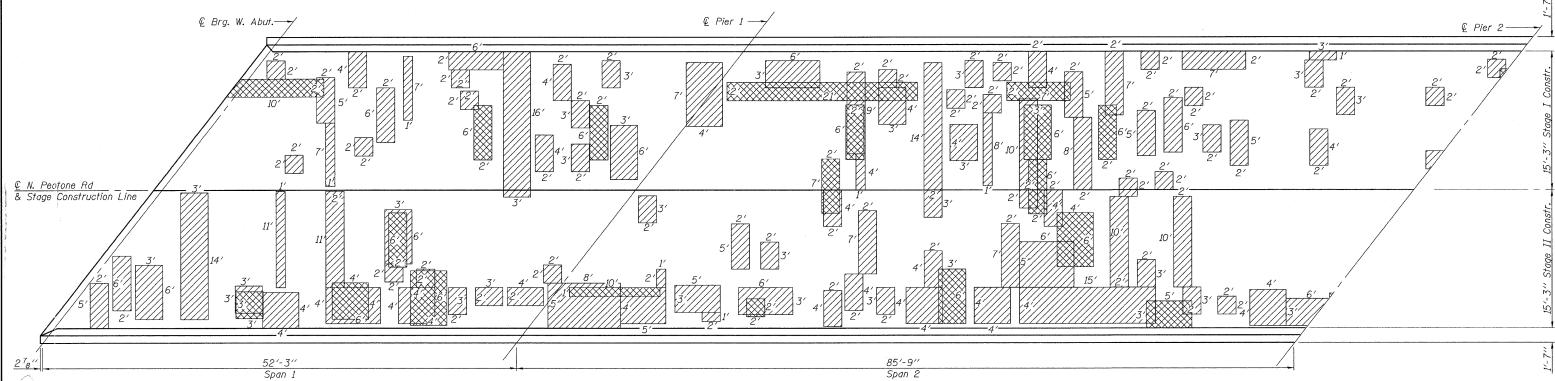

<u>NOTES</u>

- 1. Entire existing deck to be Hydro-Scarified $\frac{1}{2}$ " and overlayed with 2'4" Latex Concrete.
- 2. Existing reinforcement bars & dowel rods extending into new concrete are to be cleaned and incorporated into new construction.

 3. Deck repair areas are estimated from IDOT in the Fall of 2007.
- Actual locations of repairs made shall be shown by the Engineer on
- 4. See Sheet 1 of 12 for limits of protective shield.5. See Sheet 10 of 12 for location of structural repair of concrete.

<u>PLAN</u>

BILL OF MATERIAL (Quantity for entire deck)

Item Unit Quantity Deck Slab Repair (Full Sq. Yd. Depth, Type I) Deck Slab Repair (Full Depth, Type II) 78 Sq. Yd. Bridge Deck Latex Concrete Overlay, 2¹₄" 930 Sq. Yd. Sq. Yd. 930 Bridge Deck Hydro-Scarification, Bridge Deck Grooving
Protective Shield Sq. Yd. 884 Sq. Yd. 564 Structural Repair of Concrete Sq. Ft. 14 (Depth equal to or less than 5")

Full-Depth Patching

*Partial Depth Patching (231 Sq. Yd., for entire deck) *Partial Depth shown for information only.




200 West Front Street Wheaton, IL 60187

ILLINOIS DEPARTMENT OF TRANSPORTATION DECK AND PARAPET REPAIR PLAN - I NORTH PEOTONE ROAD OVER I-57 FAI RTE 57 SECTION 99-2HB-1-I-2 WILL COUNTY STATION 1035+6.40 STRUCTURE NO. 099-0162


DRAWN BY JMT CHECKED BY WJV DATE: 1-14-2009

SHEET NO. 10 TOTAL SHEETS FAI 57 99-2HB -1-I-2 12 SHEETS 34 26 WILL

Contract #60D65

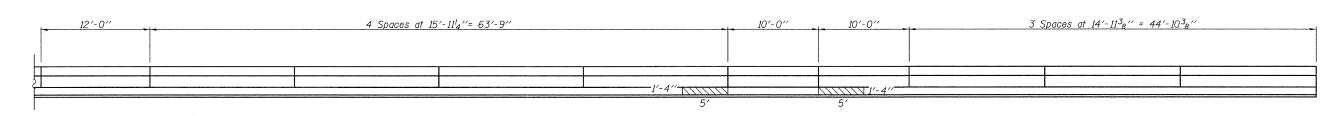

NORTH PARAPET ELEVATION

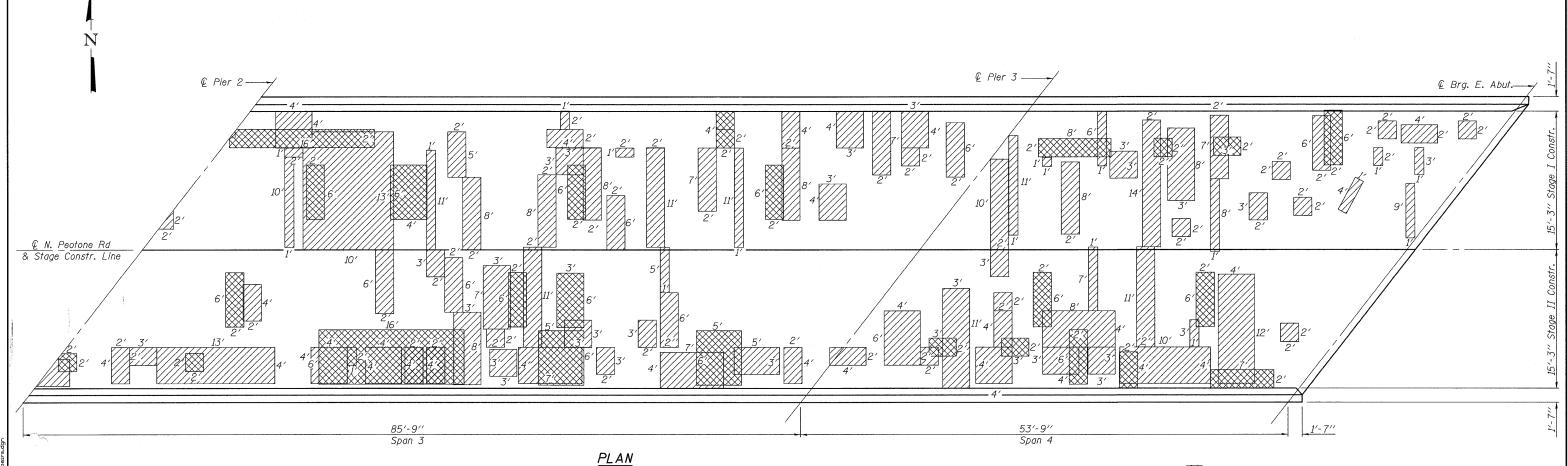

Full-Depth Patching

*Partial Depth Patching (See previous sheet for quantity of entire deck)

Structural Repair of Concrete (Depth equal to or less than 5")

*Partial Depth shown for information only.



200 West Front Street Wheaton, IL 60187

REPAIR PLAN - II NORTH PEOTONE ROAD OVER I-57 FAI RTE 57 SECTION 99-2HB-1-I-2 WILL COUNTY STATION 1035+6.40 STRUCTURE NO. 099-0162


DECK AND PARAPET

DATE: 1-14-2009


DRAWN BY JMT CHECKED BY WJV

<u>NOTES</u>


Quantities on this sheet are included in the Bill of Material on the previous sheet. See previous sheet for notes that also apply to this sheet.

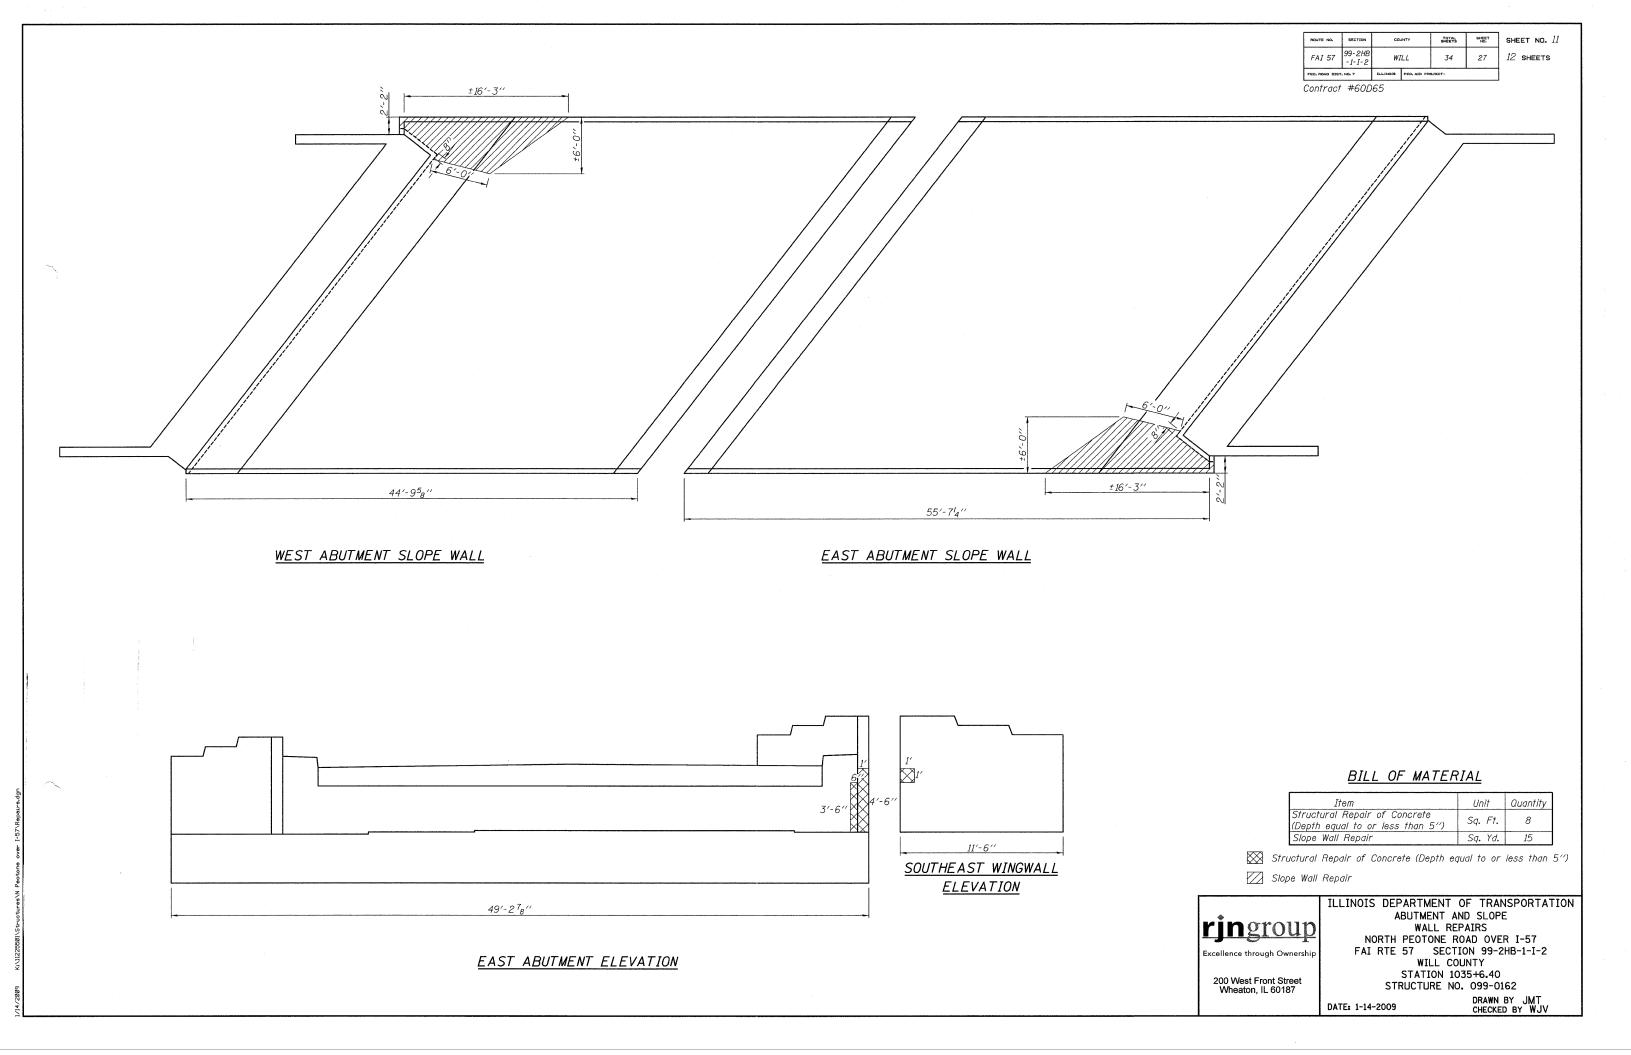


Contract #60D65

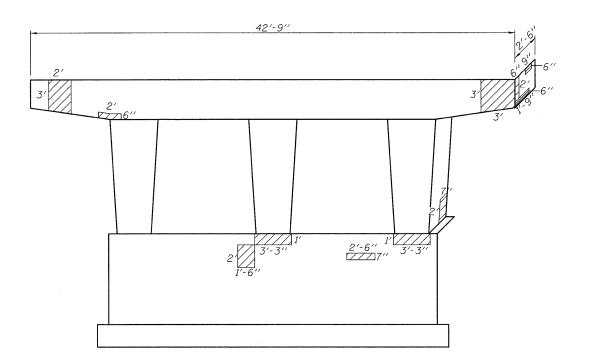

<u>WEST ELEVATION PIER #1</u>

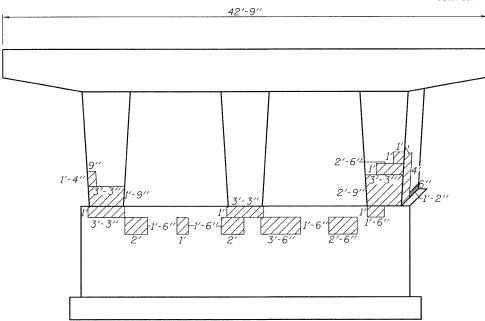

EAST ELEVATION PIER #1

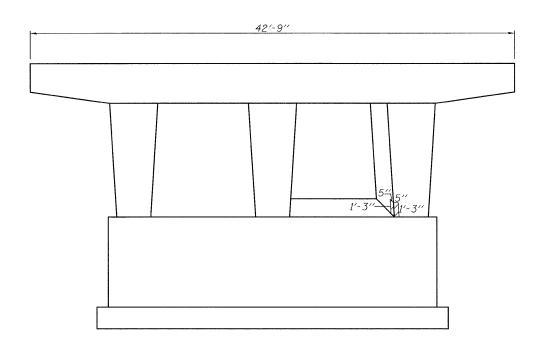


WEST ELEVATION PIER #2

BILL OF MATERIAL

Item	Unit	Quantity
Structural Repair of Concrete (Depth equal to or less than 5′′)	Sq. Ft.	97

Structural Repair of Concrete (Depth equal to or less than 5")

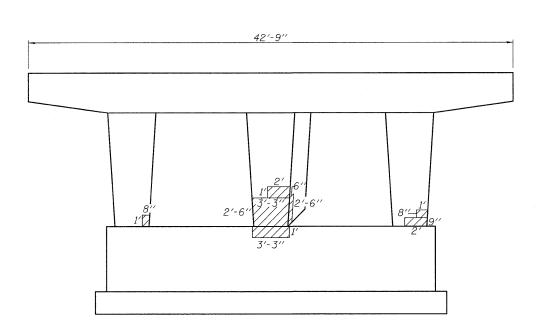

WEST ELEVATION PIER #3

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> 200 West Front Street Wheaton, IL 60187

ILLINOIS DEPARTMENT OF TRANSPORTATION

PIER REPAIRS

NORTH PEOTONE ROAD OVER I-57

FAI RTE 57 SECTION 99-2HB-1-I-2

WILL COUNTY

STATION 1035+6.40

STRUCTURE NO. 099-0162


DATE: 1-14-2009


DRAWN BY JMT CHECKED BY WJV

진 BUTT JOINT AND HMA TAPER

TYPICAL BUTT JOINT AND HMA TAPER FOR MILLING AND RESURFACING

TOTAL SHEET SHEETS NO. RTE. SECTION COUNTY FEO. ROAD DIST. NO. 1 ILLINOIS FED. AID PROJECT

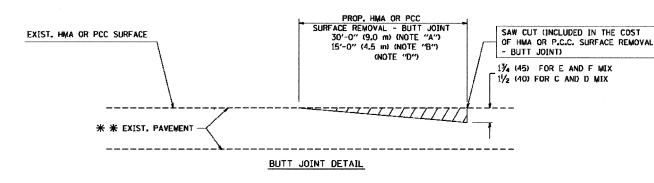

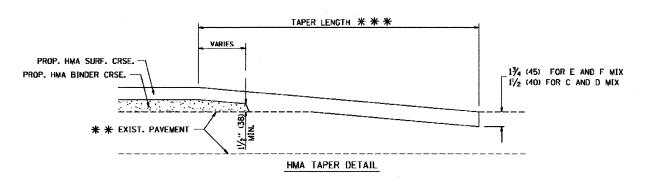

TYPICAL BUTT JOINT AND HMA TAPER FOR RESURFACING ONLY

* * PC CONCRETE, HMA OR HMA RESURFACED PAVEMENT.

- A: MAINLINE ROADWAYS AND MAJOR SIDE ROADS.
- B: MINOR SIDE ROADS.
- C: THE TEMP. RAMP SHALL BE CONSTRUCTED IMMEDIATELY UPON REMOVAL OF THE EXISTING HMA SURFACE.
- D: THE BUTT JOINT SHALL BE CONSTRUCTED IMMEDIATELY PRIOR TO PLACING THE PROPOSED HMA COURSES.
- Es TAPER THE TEMP. RAMP AT A RATE OF 3'-0" (900 mm) PER 1 INCH (25 mm) OF MILLING THICKNESS.
- F: INSTALLATION AND REMOVAL OF THE 4'-6" (1.35 m) TEMP. RAMP IS INCLUDED IN COST OF HMA SURFACE REMOVAL - BUTT JOINT
- G: SEE ARTICLE 406.08 AND 406.14 OF THE STANDARD SPECIFICATIONS FOR "HMA AND/OR PCC SURFACE REMOVAL, BUTT JOINT".
- * SEE TYPICAL SECTIONS FOR MILLING THICKNESS.
- ** ** * 20'-0" (6.1 m) PER 1 (25) RESURFACING (NOTE "A") 10'-0" (3.0 m) PER 1 (25) RESURFACING (NOTE "B")

ALL DIMENSIONS ARE IN INCHES (MILLIMETERS) UNLESS OTHERWISE SHOWN.

BASIS OF PAYMENTS

THE BUTT JOINT WILL BE PAID FOR AT THE CONTRACT UNIT PRICE PER SQUARE YARD (SQUARE METER) FOR "HOT-MIX ASPHALT SURFACE REMOVAL - BUTT JOINT" OR FOR "PORTLAND CEMENT CONCRETE SURFACE REMOVAL- BUTT JOINT".

NAME	DATE	
M. DE YONG	6-13-90	
M. DE YONG	7-3-90	
M. DE YONG	3-27-92	
R. SHAH	09/09/94	
R. SHAH	10/25/94	
A. ABBAS	03/21/97	
M. COMEZ	04/06/01	
R. BORO	01/01/07	er.
		SC

BUTT JOINT AND HMA TAPER DETAILS

ILLINOIS DEPARTMENT OF TRANSPORTATION

ALE: VERT. NONE DRAWN BY CHECKED BY

BD400-05 (VI=BD32)



266 22ND Street, Suite 216, Lombard, IL 60148 630.705.0110 voice, 630.839.2566 fax www.millenniaeng.com MILLENNIA ENGINEERING DESIGNED TVN REVISED DRAWN TVN REVISED CHECKED RPD REVISED DATE 01/14/09 REVISED


STATE OF ILLINOIS **DEPARTMENT OF TRANSPORTATION**


FAI 57/I-57 AT N. PEOTONE/JOLIET RD SHEET NO. OF SHEETS STA.


DISTRICT ONE STANDARD DETAILS BD400-05

COUNTY TOTAL SHEET NO. SECTION 99-2H-1-I-2 CONTRACT NO. 60D65

TO STA. FED. ROAD DIST. NO. 1 | ILLINOIS FED. AID PROJECT P:\2007\ME07080_VarVar_PhII\Cadd\WOI\Base\Sht_Peotone\BD400DI_DETAILS.sh

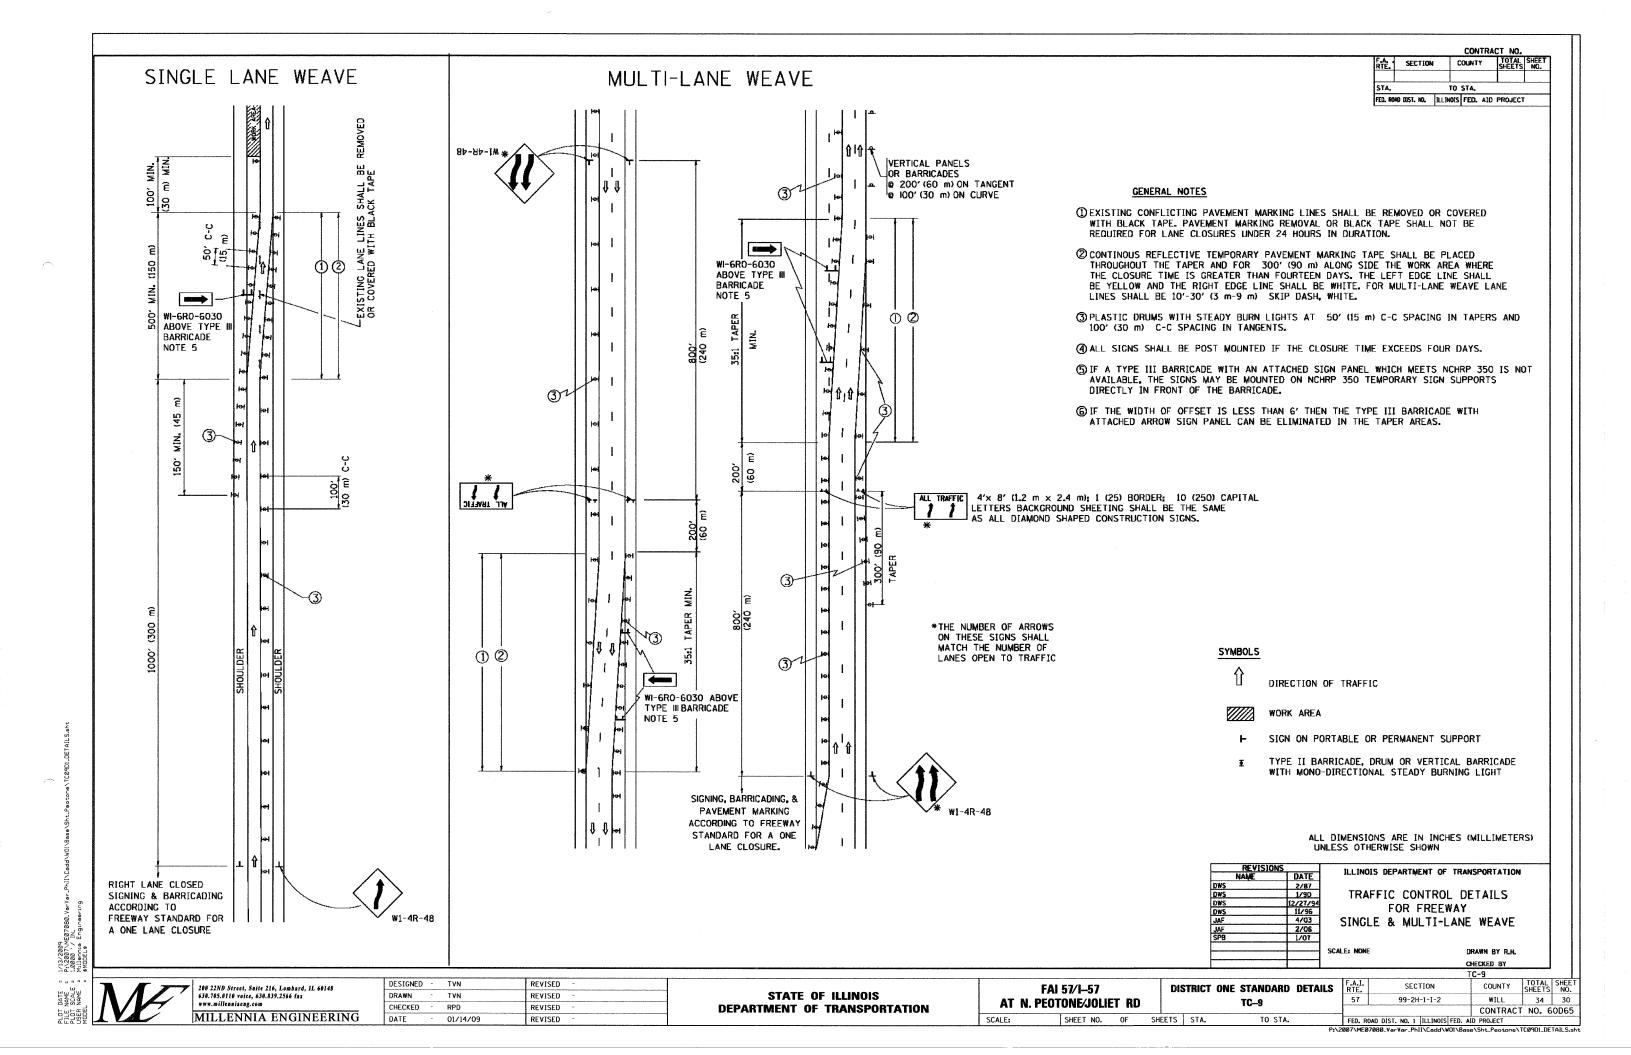


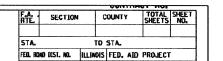


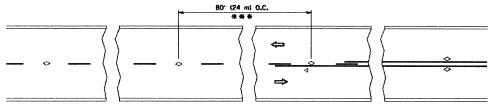


** ** REDUCE TO 40' (12 m) O.C. ON CURVES WITH POSTED OR ADVISORY SPEED 45 M.P.H. (70 km/h) OR LESS.

TWO-LANE/TWO-WAY

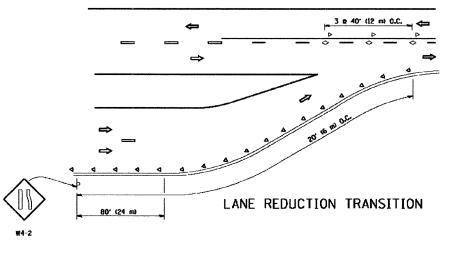


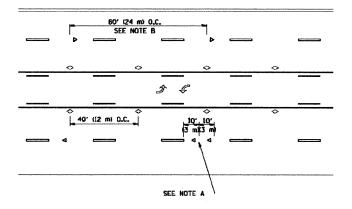

TWO-WAY LEFT TURN

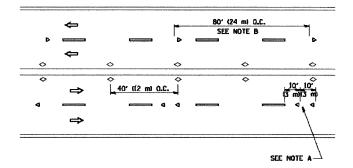

MULTI-LANE/UNDIVIDED

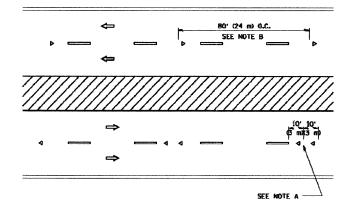

MULTI-LANE/DIVIDED

GENERAL NOTES

- 1. MARKERS USED WITH DASHED LINES SHALL BE CENTERED IN THE GAP BETWEEN SEGMENTS.
- 2. MARKERS USED ADJACENT TO SOLID LINES SHALL BE OFFSET 2 TO 3 (50 TO 75) TOWARD TRAFFIC AS SHOWN.
- 3. MARKERS THROUGH TANGENTS LESS THAN 500' (150 m) IN LENGTH BETWEEN CURVES SHALL BE INSTALLED AT THE LESSER OF THE TWO CURVE SPACINGS.

LANE MARKER NOTES

- B. REDUCE TO 40' (12 m) O.C. ON CURVES WHERE ADVISORY SPEEDS ARE 10 M.P.H (20 km/h) LOWER THAN POSTED SPEEDS.
- A. USE DOUBLE LANE LINE MARKERS SPACED AS SHOWN.

SYMBOLS

- YELLOW STRIPE


- ONE-WAY CRYSTAL MARKER (W/O)

DESIGN NOTES

- 1. DOUBLE LANE LINE MARKERS SHALL BE USED UNLESS SPECIFIED OTHERWISE.
- 2. EXCEPT AS SHOWN ON THE LANE REDUCTION TRANSITION AND FREEWAY EXIT RAMP DETAIL, MARKERS ARE NOT TO BE SPECIFIED ON RIGHT EDGE LINES.
- 3. THE EXACT MARKER LIMITS, SPACING, AND COLOR SHOULD BE INCLUDED IN THE PLANS.
- MARKERS SHOULD NOT BE USED ALONGSIDE CURBS EXCEPT FOR EXTREMELY SHORT SECTIONS OF CURBS WHERE NOT MORE THAN TWO MARKERS WOULD BE INVOLVED.

All dimensions are in inches (millimeters) unless otherwise shown.

REVISIONS		ILLINOIS DEPARTMENT OF TRANSPORTATION				
NAME	DATE	ILLINOIS DEPARTMENT OF TRANSPORTATION				
T. RANMACHER	09-19-94	TUDIO (
T. RAMMACHER	03-12-99	TYPICAL APPLICATIONS				
T, RAMMACHER	01-06-00	RAISED REFLECTIVE PAVEMENT				
	1 1					
		MARKERS (SNOW-PLOW RESISTANT)				
		SCALE: NONE DRAWN BY CADD				
		SCALE: NONE DRAWN BY CADD				
		CHECKED BY				

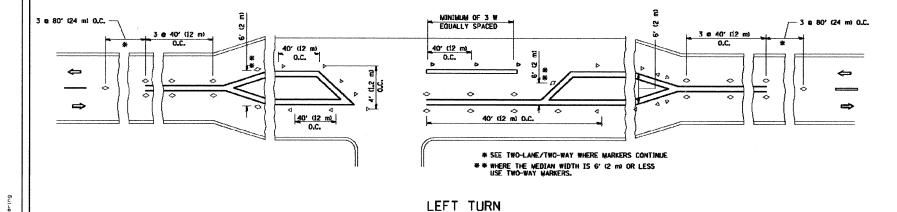

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DESIGNED TVN REVISED TVN REVISED CHECKED REVISED DATE 01/14/09 REVISED

STATE OF ILLINOIS


FAI 57/I-57 AT N. PEOTONE/JOLIET RD DISTRICT ONE STANDARD DETAILS

COUNTY SHEETS NO.
WILL 34 31 SECTION 99-2H-1-I-2 CONTRACT NO. 60D65 FED. ROAD DIST. NO. 1 | ILLINOIS FED. AID PROJECT

DEPARTMENT OF TRANSPORTATION


SHEET NO. OF SHEETS STA.

TO STA.

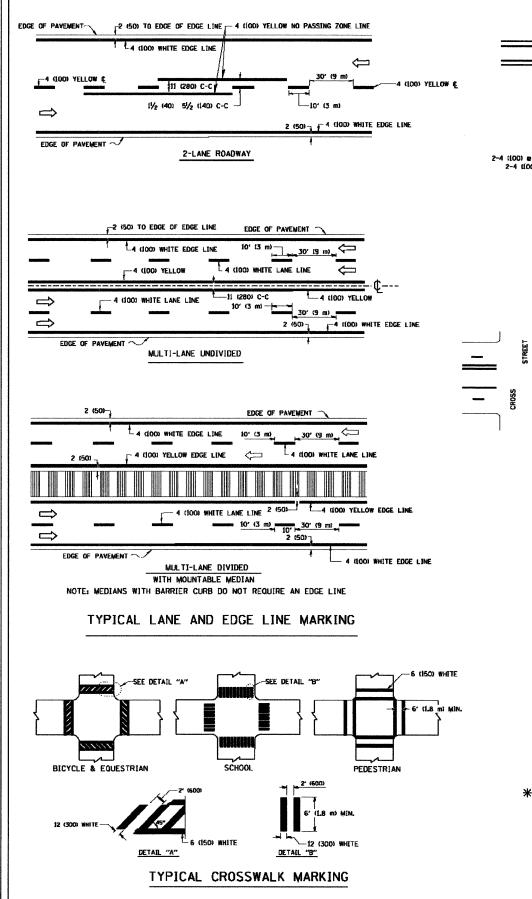


2-4 (100) YELLOW @ 11 (280) C-C-4' (1.2 m) OUTSIDE TO NO DIAGONALS OUTSIDE OF LINES - 2-4 (100) YELLOW @ 11 (280) C-C

4" (1.2 m) WIDE MEDIANS ONLY

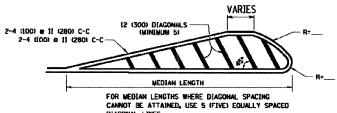


DIAGONAL LINE SPACING: 50' (15 m) C-C (LESS THAN 30MPH (50 km/h))
75' (25 m) C-C (MORE THAN 45MPH (70 km/h))
150' (45 m) C-C (MORE THAN 45MPH (70 km/h))

MEDIANS OVER 4' (1.2 m) WIDE

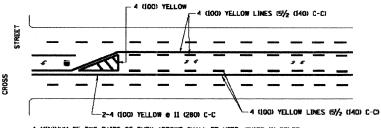


A MINIMUM OF TWO PAIRS OF TURN ARROWS SHALL BE USED, WHITE IN COLOR, ADDITIONAL PAIRS SHALL BE PLACED AT 200' (60 m) TO 300' (90 m) INTERVALS.

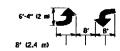

MEDIAN WITH TWO-WAY LEFT TURN LANE

TYPICAL PAINTED MEDIAN MARKING

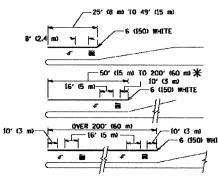


AREA = 15.6 SO. FT. (1.5 m²) MI AREA = 20.8 SO. FT. (1.9 m²)

* TURN LANES IN EXCESS OF 400' (120 m) IN LENGTH MAY HAVE AN ADDITIONAL SET OF ARROW - "ONLY" INSTALLED MIDWAY BETWEEN THE OTHER TWO SETS OF ARROW - "ONLY".

TYPICAL LEFT (OR RIGHT) TURN LANE

TYPICAL TURN LANE MARKING

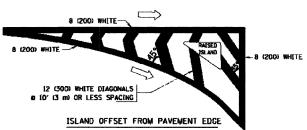

8 (200) WHITE -ISLAND ISLAND AT PAVEMENT EDGE

TYPICAL ISLAND MARKING

TYPE OF MARKING	WIDTH OF LINE	PATTERN	COLOR	SPACING / REMARKS	
CENTERLINE ON 2 LANE PAVEMENT	4 (100)	SKIP-DASH	YELLOW	10' (3 m) LINE WITH 30' (9 m) SPACE	
CENTERLINE ON MULTI-LANE UNDIVEDED PAVEMENT	2 @ 4 ((00)	SOLID	YELLO#	11 (280) C-C	
NO PASSING ZONE LINES: FOR DME DIRECTION FOR BOTH DIRECTIONS	4 (100) 2 0 4 (100)	SOL 10 SOL 10	YELLOW YELLOW	5½ (140) C-C FROM SKIP-DASH CENTERLINE 11 (280) C-C OMIT SKIP-DASH CENTERLINE BETWEEN	
LANE LINES	4 (100) 5 (125) ON FREEWAYS	SKIP-DASH SKIP-DASH	WHITE WHITE	10' (3 m) LINE WITH 30' (9 m) SPACE	
DOTTED LINES (EXTENSIONS OF CENTER, LANE OR TURN LANE MARKINGS)	SAME AS LINE BEING EXTENDED	SKJP-DASH	SAME AS LINE BEING EXTENDED	2' (600) LINE WITH 6' (1.8 m) SPACE	
EDGE LINES	4 (100)	SOL 1D	YELLOW-LEFT WHITE-RIGHT	OUTLINE MOUNTABLE MEDIANS IN YELLOW; EDGE LINES ARE NOT USED NEXT TO BARRIER CURB	
TURN LANE MARKINGS	6 (150) LINE, FULL SIZE LETTERS & SYMBOLS (8' (2.4m))	SOLID	WHITE	SEE TYPICAL TURN LANE MARKING DETAIL	
TWO WAY LEFT TURN MARKING	2 e 4 (100) EACH DIRECTION	SKIP-DASH AND SOLID	YELLOW	10' (3 m) LINE WITH 30' (9 m) SPACE FOR SKIP-DASH; 5½ (140) C-C BETWEEN SOLID LINE AND SKIP-DASH LINE	
	8' (2,4m) LEFT ARROW	IN PAIRS	WHITE	SEE TYPICAL TWO-WAY LEFT TURN MARKING DETAIL	
CROSSWALK LINES (PEDESTRIAN) A. DIAGONALS (BIRE & EQUESTRIAN) B. LONGITUDINAL BARS (SCHOOL)	2 e 6 (150) 12 (300) e 45° 12 (300) e 90°	SOLID SOLID SOLID	WHITE WHITE WHITE	NOT LESS THAN 6' (L8 m) APART 2' (SOD) APART 2' (SOD) APART SEE TYPICAL CROSSWALK MARKING DETAILS.	
STOP LINES	24 (600)	SOLID	WHI TE	PLACE 4" (1.2 m) IN ADVANCE OF AND PARALLEL TO CROSSMALK, IF PRESENT. OTHERWISE, PLACE AT DESIRED STOPPING POINT. PARALLEL TO CROSSROAD CENTERLINE, WHERE POSSIBLE	
PAINTED MEDIANS	2 @ 4 (100) WITH 12 (300) DIAGONALS © 45° ND DIAGONALS USED FOR 4' (1,2 m) WIDE MEDIANS	SOLID	YELLOWN TWO WAY TRAFFIC WHITE: ONE WAY TRAFFIC	11 (280) C-C FOR THE DOUBLE LINE SEE TYPICAL PAINTED MEDIAN MARKING.	
GORE MARKING AND CHANNELIZING LINES	8 (200) WITH 12 (300) DIAGONALS @ 45°	SOLID	WHITE	DIAGONALS: 15' (4.5 m) C-C (LESS THAN 30MPH (50 km/hi) 20' (6 m) C-C 30MPH (50 km/h) TO 45MPH (70 km/hi) 30' (9 m) C-C (OVER 45MPH (70 km/hi)	
RAILROAD CROSSING	24 (600) TRANSVERSE LINES, "RR" IS 6' (1.8 m) LETTERS, 16 (400) LINE FOR "X"	SOL 1D	WHITE	SEE STATE STANDARD 780001 AREA OF: "R"=3.6 SQ. FT. (0.33 m²) EACH "X"=54.0 SQ. FT. (5.0 m²)	
SHOULDER DIAGONALS	12 (300) a 45°	SOLID	WHITE - RIGHT YELLOW - LEFT	50' (15 m) C-C (LESS THAN 30MPH (50 km/h)) 75' (25 m) C-C (30 MPH (50 km/h) TO 45MPH (70 km/h) 150' (45 m) C-C (OVER 45MPH (70 km/h))	

FOR FURTHER DETAILS ON PAVEMENT MARKING REFER TO STANDARD SPECIFICATIONS FOR ROAD AND BRIDGE CONSTRUCTION AND STATE STANDARD 780001.

COUNTY TOTAL SHEET SHEETS NO.

TO STA.

FED. ROAD DIST. NO. ILLINOIS FED. AID PROJECT

RTE. SECTION

REVISIO		EL THO	C DEDARTHENT	OF TRANSPORTATION			
NAME	DATE	ILL140	2 RELAKTINENT	OF TRANSFORTALION			
EVERS	03-19-90						
T. RAMMACHER	10-27-94	DISTRICT ONE					
ALEX HOUSEH	10-09-96	TYPICAL PAVEMENT					
ALEX HOUSEH	10-17-96						
T. RANNACHER	01-06-00						
			MARKINGS				
		SCALE: NONE		MATERIA 200 0 100			
		JUALES NUNE		DRAWN BY CADD			

DRAWN BY CADD CHECKED BY TC-13

200 22ND Street, Suite 216, Lombard, IL 60148 630.705.0110 voice, 630.839.2566 fax www.millenniaeng.com MILLENNIA ENGINEERING

DESIGNED TVN REVISED CHECKED RPD REVISED DATE 01/14/09 REVISED

STATE OF ILLINOIS

FAI 57/I-57 AT N. PEOTONE/JOLIET RD

DISTRICT ONE STANDARD DETAILS


COUNTY TOTAL SHEE NO. SECTION WILL 99-2H-1-I-2 CONTRACT NO. 60D65


DEPARTMENT OF TRANSPORTATION

FED. ROAD DIST. NO. 1 | ILLINOIS | FED. AID PROJECT P:\2007\ME07080_VarVar_Phil\Codd\W01\Base\Sht_Peot

SHEET NO. 18 OF SHEETS STA.

TO STA.

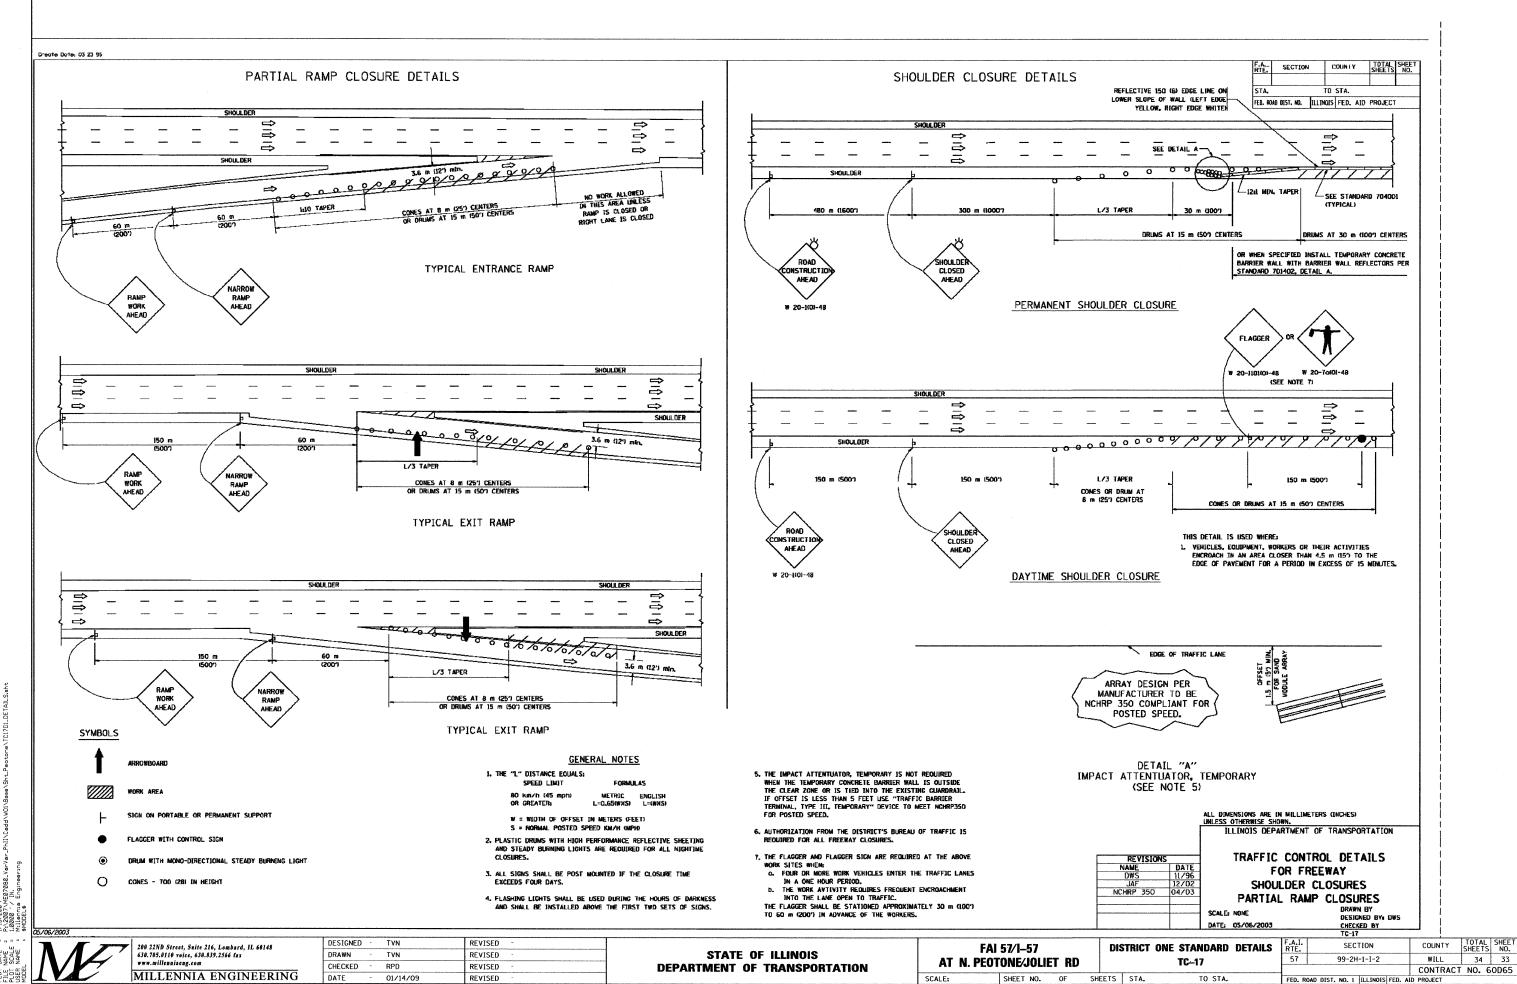

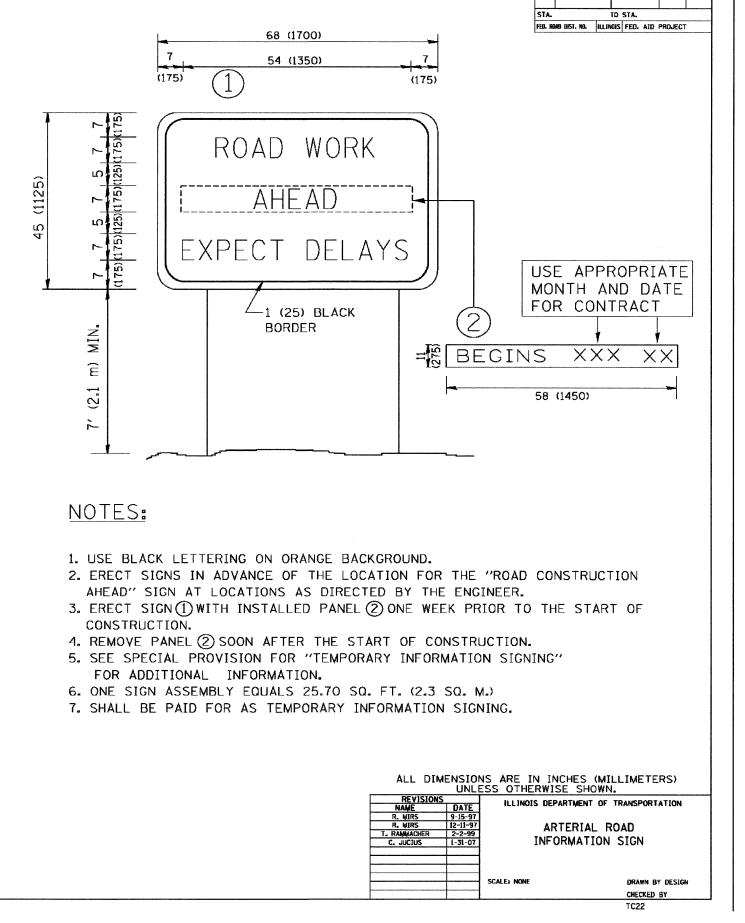

200 22ND Street, Suite 216, Lombard, IL 60148 630.705.0110 voice, 630.839.2566 fax

DESIGNED TVN REVISED DRAWN TVN REVISED CHECKED RPD REVISED DATE 01/14/09 REVISED

STATE OF ILLINOIS **DEPARTMENT OF TRANSPORTATION**

FAI 57/I-57 AT N. PEOTONE/JOLIET RD SHEET NO. OF SHEETS STA.

DISTRICT ONE STANDARD DETAILS

TO STA.

SECTION COUNTY 99-2H-1-I-2 WILL CONTRACT NO. 60D65

MILLENNIA ENGINEERING

SECTION