04-23-2021 LETTING ITEM 067

FOR INDEX OF SHEETS, SEE SHEET NO. 2

FUNCTIONAL CLASSIFICATION:

33,800

13,000

2900

2000

1750

CITY OF EDWARDSVILLE

IL 143 OTHER PRINCIPAL ARTERIAL

I-55 & RAMPS INTERSTATE

POSTED SPEED LIMIT I-55 = 70 MPH

IL 143 = 40 MPHRAMPS = 50 MPH

ADT/MV (TRUCKS)

SB ENTR 3150

MUNICIPALITY:

I-55

IL 143

NB EXIT

NB ENTR

SB EXIT

FOR LIST OF HIGHWAY STANDARDS, SEE SHEET NO. 2

(2019) 7000

(2019) 195

(2016) 60

(2016) 30

(2016) 60

(2016) 70

(2019)

(2019)

(2016) (TRUCKS)

(2016) (TRUCKS)

(2016) (TRUCKS)

(2016) (TRUCKS)

IMPROVEMENT

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STATE OF ILLINOIS

DEPARTMENT OF TRANSPORTATION

PROPOSED HIGHWAY PLANS


FAI ROUTE 55 (I-55) SECTION 60-1L-1 PROJECT NHPP-YGTV(370) I-55 AT IL 143-LIGHTING

MADISON COUNTY BEGIN I-55

END I-55

IMPROVEMENT

STA 1130 + 60

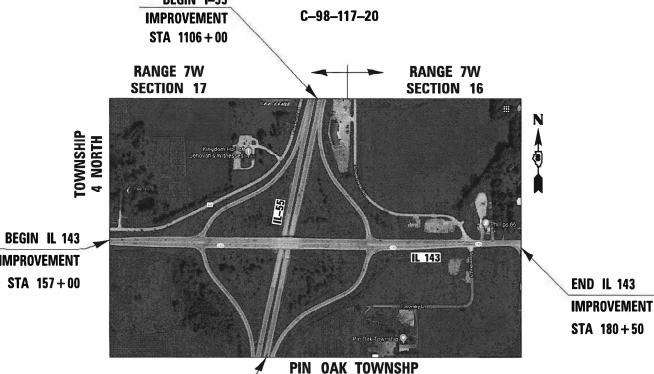

LOCATION MAP

NOT TO SCALE

ENGINEERING SCALES. REDUCED SIZED PLANS WILL NOT CONFORM TO STANDARD SCALES. IN MAKING MEASUREMENTS ON REDUCED PLANS, THE ABOVE SCALES MAY BE USED.

J.U.L.I.E. JOINT UTILITY LOCATION INFORMATION FOR EXCAVATION 1-800-892-0123 OR 811

PROJECT ENGINEER: HERVE GELIN 618-346-3179 PROJECT MANAGER: SQUAD LEADER: MICHAEL PRESTON 618-346-3143 **ELECTRICAL SERVICES SUPERVISOR: KENNETH DAVIS 618–346–3274**

CONTRACT NO. 76N80

PROFESSIONAL ENGINEER'S SIGN & SEAL

Bald. 2 01/28/2021 BRENDA D LOWERY, P.E. EXPIRES 11-30-2021

CONSULTING ENGINEERS

Downers Grove, IL 60515

6330 Belmont Road, Suite 4B


AMES Engineering, Inc.

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REV. - MS

SECTION COUNTY 60-1L-1 MADISON 6 D-98-106-20



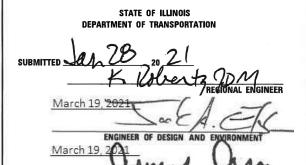

INDEX OF SHEETS

- COVER SHEET
- 2. INDEX OF SHEETS, HIGHWAY STANDARDS AND GENERAL NOTES
- 3. SUMMARY OF QUANTITIES
- 4. REMOVAL LIGHTING PLAN
- 5. PROPOSED LIGHTING PLAN
- WIRING DIAGRAM

HIGHWAY STANDARDS

000001-08	STANDARD SYMBOLS, ABBREVIATIONS AND PATTERNS
701001-02	OFF-RD OPERATIONS, 2L, 2W, MORE THAN 15' AWAY
701006-05	OFF-RD OPERATIONS, 2L, 2W, 15' TO 24" FROM PAVEMENT EDGE
701101-05	OFF-RD OPERATIONS, MULTILANE, 15' TO 24" FROM PAVEMENT EDGE
701106-02	OFF-RD OPERATIONS, MULTILANE, MORE THAN 15' AWAY
701301-04	LANE CLOSURE, 2L, 2W, SHORT TIME OPERATIONS
701421-08	LANE CLOSURE, MULTILANE, DAY OPERATIONS ONLY, FOR SPEEDS \geq 45 MPH TO 55MPH
701422-10	LANE CLOSURE, MULTILANE, FOR SPEEDS ≥ 45 MPH TO 55 MPH
701901-08	TRAFFIC CONTROL DEVICES
821101-02	LUMINAIRE WIRING IN POLE
825026-04	LIGHTING CONTROLLER BASE MOUNT 480V
835001-01	LIGHT TOWER
837001-05	LIGHT TOWER FOUNDATION

GENERAL NOTES

- THIS PROJECT INCLUDES THE INSTALLATION OF A NEW LIGHTING SYSTEM ALONG THE INTERCHANGE OF I-55 AND IL-143. PROPOSED LIGHTING SHALL BE OWNED AND MAINTAINED BY THE STATE OF ILLINOIS.
- 2. THE CONTRACTOR SHALL CONTACT THE LOCAL ELECTRIC UTILITY COMPANY TO COORDINATE THE ELECTRIC SERVICE CONSTRUCTION WORK.
- 3. THE QUANTITIES OF RACEWAY WHERE INDICATED ON THESE PLANS ARE APPROXIMATIONS ONLY. THE CONTRACTOR SHALL FIELD VERIFY ALL LENGTHS AND SHALL INSTALL RACEWAYS IN COMPLETE COMPLIANCE WITH THE SPECIFIED REQUIREMENTS.
- 4. THE CONTRACTOR SHALL NOTIFY J.U.L.I.E. TO LOCATE AND MARK/STAKE ALL UNDERGROUND UTILITIES.
- 5. THE CONTRACTOR SHALL VERIFY LOCATIONS OF UNDERGROUND/OVERHEAD UTILITIES PRIOR TO INSTALLATION OF LIGHT POLES AND CONDUITS. IF THERE IS A CONFLICT WITH THE LIGHT POLES/CONDUITS AS SHOWN ON PLANS, THE CONTRACTOR SHALL SUGGEST THE ALTERNATIVE LOCATIONS AND COORDINATE WITH THE ENGINEER PRIOR TO PERFORMING CONSTRUCTION WORK.
- 6. TRENCHES FOR LIGHTING RACEWAYS SHALL HAVE A MINIMUM DEPTH OF 30".
- LIGHTING SYSTEM INSTALLATION SHALL CONFORM TO THE LATEST IDOT STANDARDS, NEC AND LOCAL CODES.
- 8. ALL ELECTRICAL EQUIPMENT AND PRODUCTS SHALL BE U/L LISTED AND LABELED.
- 9. THE CONTRACTOR SHALL TAKE CARE WHEN INSTALLING UNIT DUCT TO AVOID CONFLICTS WITH EXISTING UNDERGROUND UTILITIES, TREES AND ROOTS. THE CONTRACTOR SHALL BE RESPONSIBLE FOR ANY DAMAGE AS DETERMINED BY THE ENGINEER.
- 10. THE CONTRACTOR SHALL TAKE CARE WHEN INSTALLING LIGHT POLE FOUNDATIONS
 TO AVOID CONFLICTS WITH UNDERGROUND UTILITIES. WHEN CONFLICTS ARE
 ENCOUNTERED, THE CONTRACTOR SHALL REQUEST TO RELOCATE THE FOUNDATION.
 THE NEW LOCATION SHALL BE APPROVED BY THE ENGINEER PRIOR TO INSTALLATION.
- 11. GROUND RODS SHALL BE INSTALLED AT EACH LIGHTING UNIT.

sfault

AMES Engineering, Inc.
CONSULTING ENGINEERS
6330 Belmont Road, Suite 4B
Downers Grove, IL 60515

USER NAME = Srahman DESIGNED - MH REVISED -	
DRAWN - MD REVISED -	
PLOT SCALE = 2,0000 ' / in. CHECKED - BL REVISED -	
PLOT DATE = 12/11/2020 DATE - 12-11-2020 REVISED -	

STATE OF ILLINOIS
DEPARTMENT OF TRANSPORTATION

SCALE:

INDEX OF S	SHEETS, HI	GHWAY	STANDA	RDS AN	D GENERAL NOTES	F.A.I RTE	SECTION	
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LT-01

MADISON 6 2

CONTRACT NO. 76N80

COUNTY

SUMMARY OF QUANTITIES						SUMMARY OF QUANTITIES							
CODE NO	ITEM	UNIT	URBAN TOTAL	0021	RUCTION CODE	CODE NO	ITEM	UNIT	URBAN TOTAL	CONSTRUCTION TYPE CODE 0021			
67100100	MOBILIZATION	L SUM	QUANTITIES 1	10% STATE	=	X1400273	REMOVAL OF EXISTING TOWER LUMINAIRE, NO SALVAGE	EACH	QUANTITIES 16	10% STATE			
80400100	ELECTRIC SERVICE INSTALLATION	EACH	1	1		X7010216	TRAFFIC CONTROL AND PROTECTION, (SPECIAL)	L SUM	1	1			
80400200	ELECTRIC UTILITY SERVICE CONNECTION	L SUM	1	1		X8420502	REMOVAL OF LIGHT TOWER, NO SALVAGE	EACH	4	4			
81028240	UNDERGROUND CONDUIT, GALVANIZED STEEL, 4" DIA.	FOOT	497	497		X8420510	REMOVAL OF TOWER FOUNDATION	EACH	4	4			
81603032	UNIT DUCT, 600V, 2-1C NO.4, 1/C NO.6 GROUND, (XLP-TYPE USE), 1 1/4" DIA. POLYETHYLENE	FOOT	5501	5501		Z0013798	CONSTRUCTION LAYOUT	L SUM	1	1			
81603000	UNIT DUCT, 600V, 2-1C NO.8, 1/C NO.8 GROUND, (XLP-TYPE USE), 3/4" DIA. POLYETHYLENE	FOOT	270	270		89502300	REMOVE ELECTRIC CABLE FROM CONDUIT	FOOT	5905	5905			
82110018	LUMINAIRE, LED, HIGHMAST, OUTPUT DESIGNATION K	EACH	19	19									
82500360	LIGHTING CONTROLLER, BASE MOUNTED, 480VOLT, 100AMP	EACH	1	1									
83502300	LIGHT TOWER, 100 FT. MOUNTING HEIGHT, LUMINAIRE MT 4	EACH	2	2									
82110008	LUMINAIRE, LED, HIGHMAST, OUTPUT DESIGNATION H	EACH	2	2					1				
83502200	LIGHT TOWER, 100 FT. MOUNTING HEIGHT, LUMINAIRE MT 3	EACH	2	2									
83700300	LIGHT TOWER FOUNDATION, 48" DIAMETER	FOOT	74.4	74.4									
84500110	REMOVAL OF LIGHTING CONTROLLER	EACH	1	1									
84500130	REMOVAL OF LIGHTING CONTROLLER FOUNDATION	EACH	1	1									


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lacksquare	CONSULTING ENGINEERS	
	6330 Belmont Road, Suite 4B	
	Downers Grove, IL 60515	


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PLOT DATE = 12/11/2020	DATE	-	12-11-2020	REVISED -


STATE OF ILLINOIS
DEPARTMENT OF TRANSPORTATION

SCALE: NTS

SU	MMARY OF QUANTITIES		F.A.I RTE.	SECTION	COUNTY	TOTAL SHEETS	SHEET NO.
1–55 AT IL 143			55	60-1L-1	MADISON	6	3
,		ĺ		CONTRACT	NO. 7	6N80	
SHEET 1	OF 1 SHEETS STA	TO STA		LILLINOIS LEED A	ID DDOJECT		

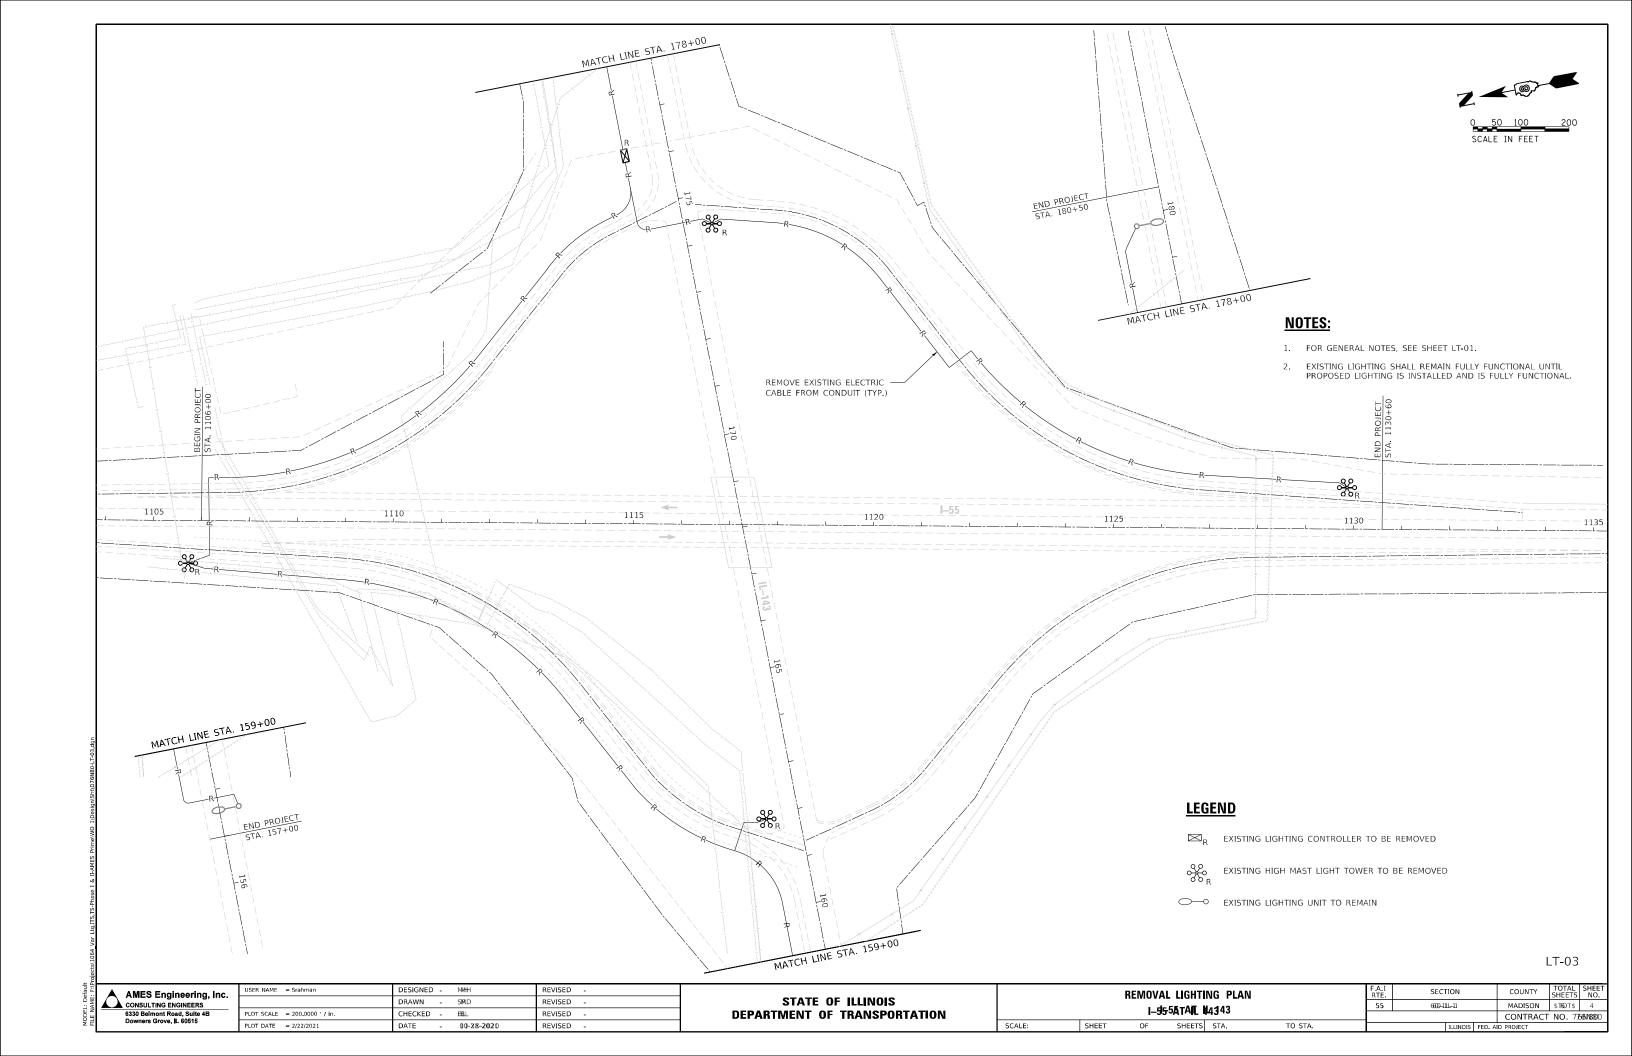

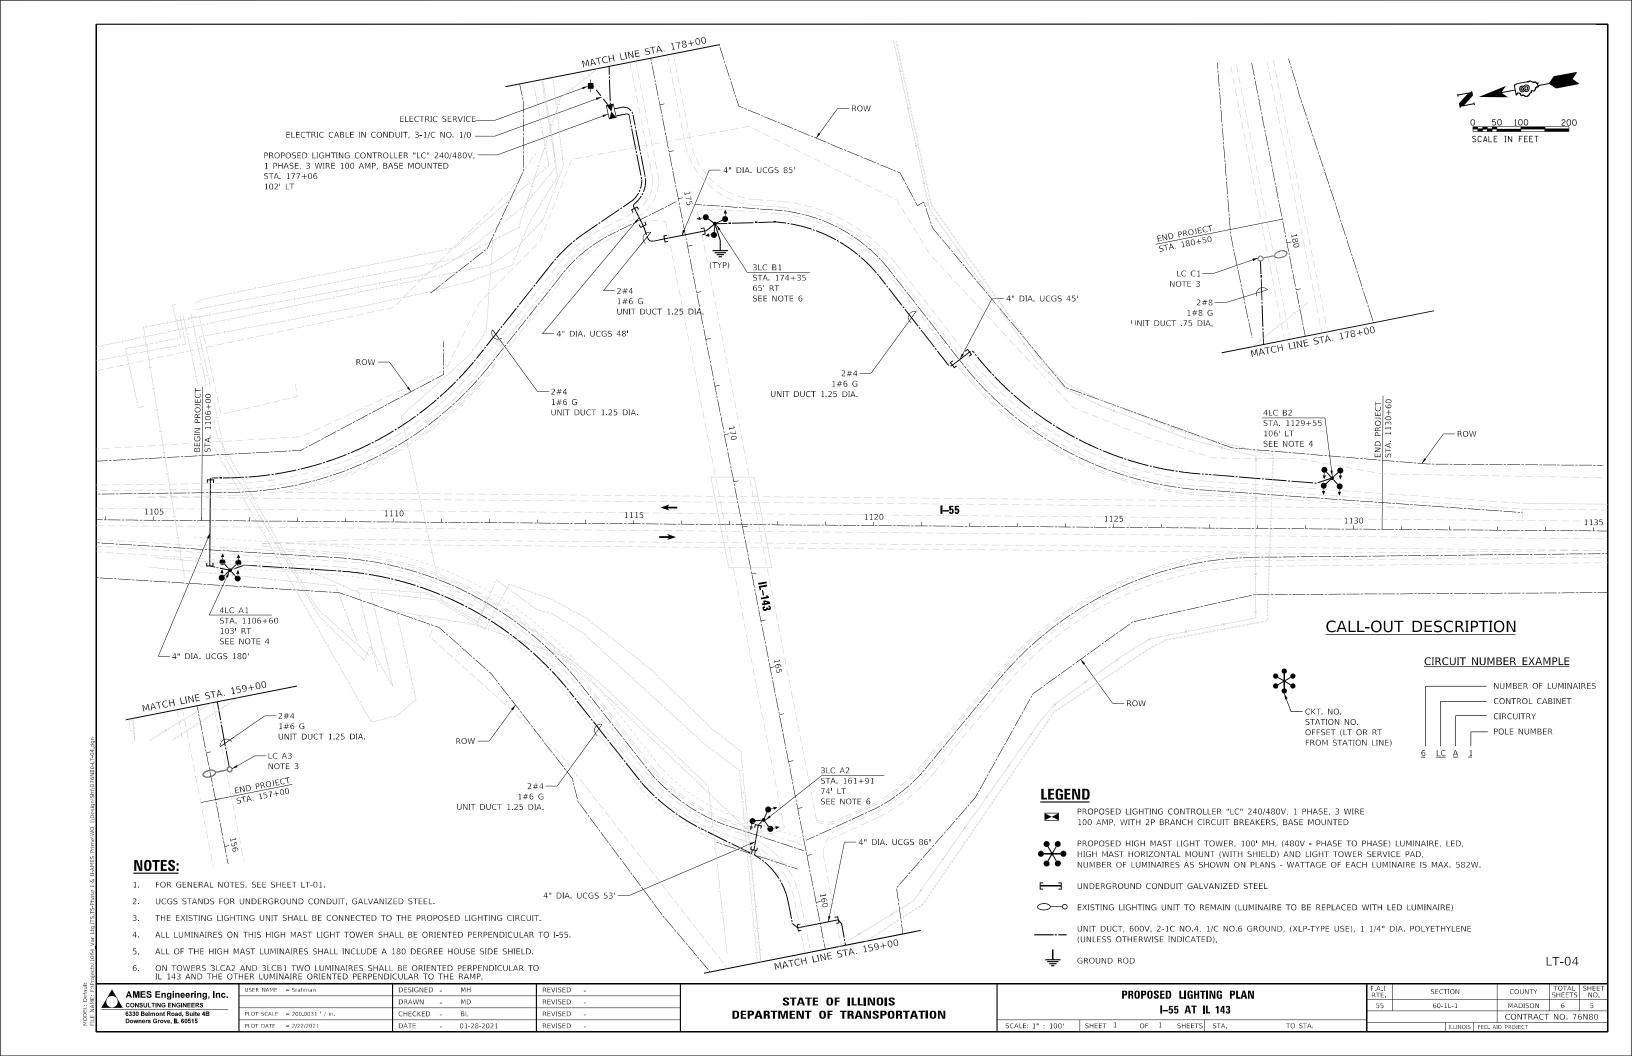

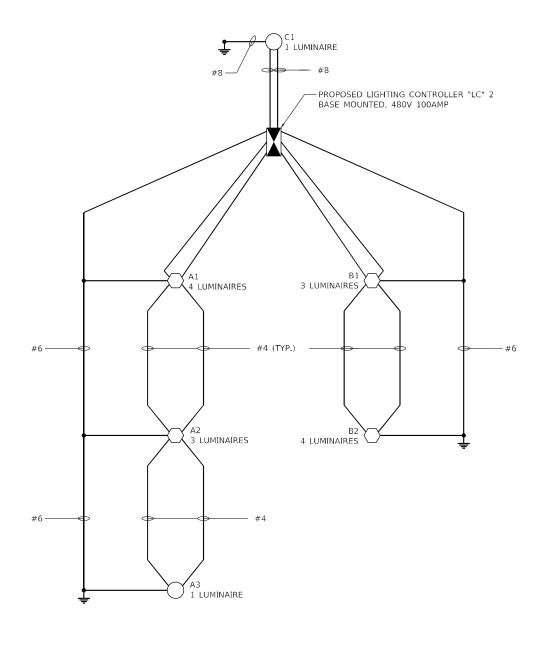

LEGEND:



PROPOSED LIGHTING CONTROLLER "LC" 240/480V, 1 PHASE, 3 WIRE 100 AMP, WITH 2P BRANCH CIRCUIT BREAKERS, BASE MOUNTED

- UNIT DUCT, 600V, 2-1C NO.4, 1/C NO.6 GROUND, (XLP-TYPE USE), 1 1/4" DIA. POLYETHYLENE

PROPOSED LIGHT TOWER

EXISTING LIGHTING UNIT WITH RETROFITTED LED LUMINAIRE

GROUND ROD

LOAD TABLE LIGHTING CONTROLLER "LC"

240/480V, A.C. 1 PHASE, 3 WIRE, 100A WITH 2P BRANCH CIRCUIT BREAKERS

CIRCUIT	TOTAL LUM.	TOTAL CURRENT IN AMPS	TOTAL WATTAGE
А	8	9.76	4239
В	7	9.10	3955
С	1	0.66	284
D	-	SPARE	SPARE
E	-	SPARE	SPARE
F	-	SPARE	SPARE
TOTAL		19.52	8478

TOTAL LOAD IN WATTS 8478 TOTAL LOAD IN AMPS 19.52

02/10/21	76N80		60-1L-1	Madison		¥
Marked Rout	e Number		Muni	cipality		
55			Edw	/ardsville		
Roadway Lane Width	# of Lanes	Median Widt	h I.E.S. Surface 0	Classification Q-Zero Value		
12FT.	5	N/A	R3	0.07		
Structure Mounting Hei	ight Arm Length	Set-Back	Number of Lumina (Highmast & Sign			
100FT.	1FT.	31FT.	4			
Luminaire Description				5. Lateral Distribution		rtical Distribution
-	Output Desig		Тур		Medium	1
Total Light Lo	Output Desig	B-U-G F		Shields	Din	nming Protocol
					Din	1
Total Light Lo	oss Factor (LLF)	B-U-G F U=0	Rating	Shields	Din	nming Protocol
Total Light Lo 0.7 Layout Spacing (to N 180 FT.	pss Factor (LLF)	B-U-G F U=0 onfiguration (0 one Sided	Rating	Shields House side	Din	nming Protocol
Total Light Lo 0.7 Layout Spacing (to N 180 FT. Performanc Average Illum	pss Factor (LLF)	B-U-G F U=0 onfiguration ((ine Sided	Rating Dpposite, Staggered	Shields House side	Din	nming Protocol
Total Light Le 0.7 Layout Spacing (to N 180 FT. Performanc Average Illum 0.9	pss Factor (LLF)	B-U-G F U=0 onfiguration ((one Sided	Rating Deposite, Staggered Iniformity Ratio, Em	Shields House side	Oin 0-1	nming Protocol

Luminaire Performance Table Print Form Reset Form

Illinois Department of Transportation

Contract Number

a. Compliance with performance criteria shall be held to one significant digit.

Distance to ROW (behind pole) Max. Horizontal Illuminance at ROW, EH

.3 fc

Performance requirements shall be the given conditions listed above.

Initial lumens of the proposed luminaire may vary from the values specifies in the table given in Article 1067.06 of the BDE Special Provision for Luminaire, LED.

Notes

1. Set-Back is from Edge of Pavement (white line) except for sign luminaires when it is vertical and horizontal distance from the sign

Total Light Loss Factor (LLF) = the product of "Lumen Maintenance" (LLD) = 0.9, "Dirt Depreciation" (LDD) = 0.8, and "Equipment Factors" (EF) = 0.95.

to the luminaire.

2. Lighting calculations shall be performed with all luminaires oriented toward and perpendicular to the roadway

Max. Vertical Illuminance at ROW, Ev

.3 fc

LT-05

▲ AMES Engineering, Inc. CONSULTING ENGINEERS

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	DRAWN	-	MD	REVISED -
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PLOT DATE = 2/22/2021	DATE	-	01-28-2021	REVISED -

STATE OF ILLINOIS **DEPARTMENT OF TRANSPORTATION**

	WIRING DIAGRAM AND LUMINAIRE PERFORMANCE TABLE						F.A.I RTE.	SEC.	TION		COUNTY	TOTAL SHEETS	SHEET NO.	
	I–55 AT IL 143					55	60-1L-1			MADISON	6	6		
L	I-33 A1 JL 143										CONTRACT	NO. 76	6N80	
	SCALE: NTS	SHEET 1	OF	1	SHEETS	STA.	TO STA.			ILLINOIS	FED. A	ID PROJECT		