STATE OF ILLINOIS

DEPARTMENT OF TRANSPORTATION

DIVISION OF HIGHWAYS

PROPOSED HIGHWAY PLANS

FAP ROUTE 334 : US 12 (MAIN ST)

WISCONSIN STATE LINE TO IL 173 (KENOSHA RD)

SECTION: 111 RS-7

RESURFACING (MAINTENANCE)

PROJECT: ESP-0334(0/8)

MC HENRY COUNTY C-91-017-08

FOR INDEX OF SHEETS, SEE SHEET NO. 2

THE PROJECT IS LOCATED IN THE VILLAGE OF RICHMOND


0 100' 200' 300' — 1" = 100'
0 10' 20' 30' — 1" = 10'
0 50' 100' — 1" = 50'
0 50' 100' — 1" = 40'
0 50' 100' — 1" = 30' — 1" = 20'

FULL SIZE PLANS HAVE BEEN PREPARED USING STANDARD ENGINEERING SCALES. REDUCED SIZED PLANS WILL NOT CONFORM TO STANDARD SCALES. IN MAKING MEASUREMENTS ON REDUCED PLANS, THE ABOVE SCALES MAY BE USED.

J.U.L.I.E. JOINT UTILITY LOCATION INFORMATION FOR EXCAVATION 1-800-892-0123 OR 811

PROJECT ENGINEER ROBERT BORO (847)705-4178
PROJECT MANAGER KEN ENG

CONTRACT NO. 60D41

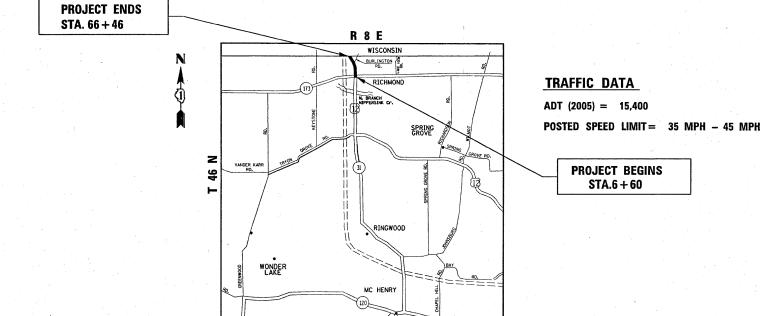

RICHMOND TOWNSHIP

GROSS LENGTH OF PROJECT = 5,986 LINEAL FEET = 1.134 MILES NET LENGTH OF PROJECT = 5,986 LINEAL FEET = 1.134 MILES

D-91-017-08



STATE OF ILLINOIS
DEPARTMENT OF TRANSPORTATION
DIVISION OF HIGHWAYS

SUBMITTED FEBRUARY 3, 20 09

DEPUTY DIRECTOR OF HIGHWAYS, REGION ENGINEE

Charles Janaeroll B

ENGINEER OF BESIGN AND ENVIRONMENT

Mristine M. Reed BD

DIRECTOR OF HIGHWAYS, CHIEF ENGINE

PRINTED BY THE AUTHORITY OF THE STATE OF ILLINOIS

INDEX OF SHEETS

DISTRICT ONE DETECTOR LOOP INSTALLATION DETAILS

FOR ROADWAY RESURFACING (TS-07)

20

STANDARDS

SHEE	T NO.	DESCRIPTION	STANDARD NO.	DESCRIPTION
			442201 <i>-03</i>	CLASS C AND D PATCHES
	2	TITLE SHEET INDEX OF SHEETS, STATE STANDARDS, AND GENERAL NOTES	482011 <i>-0</i> 3	BIT. SHLD STRIPS / SHLDS WITH RESURFACING AND WIDENING AND RESURFACING PROJECTS
	3	SUMMARY OF QUANTITIES	606001 <i>-04</i>	CONCRETE CURB TYPE B AND COMBINATION CONCRETE
	4	TYPICAL SECTIONS & HOT-MIX ASPHALT MIXTURE REQUIREMENTS	630301 <i>-05</i>	SHOULDER WIDENING FOR TYPE 1 (SPECIAL) GUARDRAIL TERMINALS
	5-9	ROADWAY & PAVEMENT MARKING PLANS	635006 <i>-03</i>	REFLECTOR AND TERMINAL MARKER PLACEMENT
	10 11	DETECTOR LOOP PLANS PAVEMENT PATCHING FOR HOT-MIX ASPHALT SURFACED PAVEMENT(BD-22)	701006 <i>-03</i>	OFF ROAD OPERATIONS, 2L, 2W, 4.5m (15') TO 600mm (24') FROM PAVEMENT EDGE
	12	CURB OR CURB AND GUTTER REMOVAL AND REPLACEMENT (BD-24)	701011-02	OFF-ROAD MOVING OPERATIONS 2L, 2W DAY ONLY
	13	BUTT JOINT AND HOT-MIX ASPHALT TAPER DETAILS (BD-32)	701301-03	LANE CLOSURE, 2L, 2W, SHORT TIME OPERATIONS
	14	TRAFFIC CONTROL AND PROTECTION FOR	701311- <i>03</i>	LANE CLOSURE, 2L, 2W MOVING OPERATIONS - DAY ONLY
		SIDE ROADS, INTERSECTIONS, AND DRIVEWAYS (TC-10)	701606-06	URBAN LANE CLOSURE, MULTILANE 2W WITH MOUNTABLE MEDIAN
	15	TYPICAL APPLICATIONS RAISED REFLECTIVE PAVEMENT MARKERS (SNOW-PLOW RESISTANT) (TC-11)	701701- 06	URBAN LANE CLOSURE MULTILANE INTERSECTION
	16	DISTRICT ONE TYPICAL PAVEMENT MARKINGS (TC-13)	701901- 0/	TRAFFIC CONTROL DEVICES
	17	TRAFFIC CONTROL AND PROTECTION OF TURN BAYS	780001 - <i>02</i>	TYPICAL PAVEMENT MARKINGS
		(TO REMAIN OPEN TO TRAFFIC) (TC-14)	781001- <i>03</i>	TYPICAL APPLICATIONS RAISED REFLECTIVE PAVEMENT MARKERS
	18	PAVEMENT MARKING LETTERS AND SYMBOLS FOR TRAFFIC STAGING (TC-16)	635001-01	DELINEATORS
	19	ARTERIAL ROAD INFORMATION SIGN (TC-22)		

GENERAL NOTES

BEFORE STARTING ANY EXCAVATION, THE CONTRACTOR SHALL CALL "JULIE" AT 1-800-892-0123 OR 811 FOR FIELD LOCATIONS OF BURIED ELECTRIC, TELEPHONE, AND GAS FACILITIES. (48 HOUR NOTIFICATION IS REQUIRED).

THE CONTRACTOR SHALL COORDINATE CONSTRUCTION ACTIVITIES WITH UTILITY COMPANIES AND THE VILLAGE OF RICHMOND.

THE CONTRACTOR WILL NOT BE ALLOWED TO SET UP A YARD OR FIELD OFFICE ON STATE PROPERTY WITHOUT WRITTEN PERMISSION FROM THE DEPARTMENT.

WHEN MILLED PAVEMENT IS OPEN TO TRAFFIC THE MAXIMUM GRADE DIFFERENTIAL BETWEEN PASSES OF THE MILLING MACHINE SHALL NOTEXCEED 1 1/2 INCHES (40 MM) WHERE THE SPEED LIMIT IS 40 MPH (80 KM/H) OR LESS AND 1 INCH (25 MM) WHERE THE SPEED LIMIT IS GREATER THAN 45 MPH (80 KM/H). WITH WRITTEN APPROVAL FROM THE ENGINEER, A MAXIMUM GRADE DIFFERENTIAL OF 3 INCHES (75MM) MAY BE ALLOWED IF THE EDGE OF THE MILLING IS SLOPED A MINIMUM 1: 3 (V: H).

BUTT JOINTS WILL BE INSTALLED AT THE ENDS OF ALL RESURFACING (WHERE RESURFACING MEETS EXISTING PAVEMENT), IN ACCORDANCE WITH THE "BUTT JOINT AND HOT-MIX ASPHALT TAPER DETAILS" SHEET INCLUDED IN THE PLANS, UNLESS OTHERWISE SPECIFIED.

UNLESS OTHER CONDITIONS WARRANT EXTENDED LANE CLOSURE AS DETERMINED AND APPROVED IN WRITING BY THE ENGINEER OR AS PROVIDED FOR IN THE CONTRACT SPECIFICATIONS, OVERNIGHT CLOSURES SHALL NOT BE ALLOWED FOR REHABILITATION PROJECTS INVOLVING DAYTIME MILLING AND RESURFACING OPERATIONS AND CLASS D PATCHING.

ALL DAMAGE TO EXISTING PAVEMENT MARKINGS OR RAISED REFLECTIVE PAVEMENT MARKERS OUTSIDE THE REMOVAL LINE SHOWN ON THE PLANS SHALL BE REPLACED AT NO ADDITIONAL COST TO THE DEPARTMENT.

BEFORE BEGINNING ANY WORK, THE CONTRACTOR SHALL RETAIN AND RECORD FOR FUTURE REFERENCE, ALL EXISTING PAVEMENT MARKING LINES AND RAISED REFLECTIVE PAVEMENT MARKERS IN ORDER THAT THESE LOCATIONS CAN BE RE-ESTABLISHED FOR STRIPING. EXACT LOCATIONS OF ALL PAVEMENT MARKINGS SHALL BE AS DIRECTED BY THE ENGINEER.

ALL PAVEMENT PATCHING LOCATIONS WILL BE DETERMINED IN THE FIELD BY THE ENGINEER.

LOCATION OF COMBINATION ONCRETE CURB AND GUTTER REMOVAL AND COMBINATION CURB AND GUTTER (THE TYPE SPECIFIED ON THE PLANS), WILL BE DETERMINED IN THE FIELD BY THE ENGINEER.

IT SHALL BE THE CONTRACTOR'S RESPONSIBILITY TO VERIFY ALL DIMENSIONS AND CONDITIONS EXISTING IN THE FIELD PRIOR TO CONSTRUCTION AND ORDERING OF MATERIALS.

THE CONTRACTOR SHALL CONTACT THE DISTRICT ONE TRAFFIC CONTROL SUPERVISOR AT (847)705- 4470 A MINIMUM OF 72 HOURS IN ADVANCE OF BEGINNING WORK.

THE ENGINEER SHALL CONTACT DEBBIE HANLON AREA TRAFFIC FIELD ENGINEER, AT (847) 438-2300 A MINIMUM OF TWO (2) WEEKS PRIOR TO PLACEMENT OF PERMANENT PAVEMENT MARKINGS.

THE CONTRACTOR SHALL BE REQUIRED TO PROVIDE ACCESS TO ABUTTING PROPERTY AT ALL TIMES DURING THE CONSTRUCTION OF THIS PROJECT.

DO NOT SCALE PLANS FOR CONSTRUCTION DIMENSIONS.

DOUBLE LANE MARKERS ARE TO BE USED AS SHOWN ON THE DISTRICT ONE DETAIL "TYPICAL APPLICATIONS - RAISED REFLECTIVE PAVEMENT MARKERS (SNOW-PLOW RESISTANT)" SHOWN IN THE PLANS.

PAVEMENT MARKING TAPE, TYPE III SHALL BE USED FOR SHORT TERM PAVEMENT MARKINGS ON ALL FINAL SURFACES. THE COST OF THE PAVEMENT MARKING TAPE, TYPE III AND ITS REMOVAL SHALL BE INCLUDED IN THE COST OF SHORT TERM PAVEMENT MARKING.

THE REMOVAL OF GUARDRAIL TERMINAL SECTIONS SHALL BE INCLUDED IN THE UNIT PRICE PER FOOT FOR "GUARDRAIL REMOVAL"

FILE NAME =	USER NAME = gorengautab	DESIGNED -	REVISED -	Т
c:\pw_work\PWIDOT\GORENGAUTAB\dØ119364\	d101708-sht-plan.dgn	DRAWN -	REVISED -	٦.
	PLOT SCALE = 50.0000 '/ IN.	CHECKED -	REVISED -	7
	PLOT DATE = 2/13/2009	DATE -	REVISED -	7

STATE OF ILLINOIS
DEPARTMENT OF TRANSPORTATION

SCALE:

U.S. 12.

INDEX OF SHEETS LIST OF STATE STANDARDS
PLAN NOTES

| SHEET NO. 1 OF 1 SHEETS | STA. 6+60 TO STA. 66+46

F.A.P. RTE.	SECTION	COUNT	Υ	TOTAL SHEETS	SHEET NO.		
334	111 RS - 7	MC HENRY		RY	20	3	
FED.	FED. ROAD DIST. NO. 1		INOIS	HIG	CHWAY PROJECT		
				CON	TRACT NO	.60D41	

	SUMMARY OF QUANTITIES		URBAN	Т	 ONSTRUCT		T		
	SUMMENT OF GOART 17120		<i>1001. FEO</i> . TOTAL						
CODE NO	ITEM	UNIT	QUANTITIES	I000-2A	. !				
								-	
201006	GRADING AND SHAPING SHOULDERS	UNIT	102	102		1.			
201200	REMOVAL AND DISPOSAL OF UNSUITABLE	CU YD	20	20					
400800	FURNISHED EXCAVATION	CU YD	80	80					
101615	TOPSOIL FURNISH AND PLACE, 4"	SO YD	212	212					
000210	SEEDING, CLASS 2A	ACRE	0.04	0.04					
000400	NITROGEN FERTILIZER NUTRIENT	POUND	4	4					
5000500	PHOSPHORUS FERTILIZER NUTRIENT	POUND	3	3		:			
5000600	POTASSIUM FERTILIZER NUTRIENT	POUND	2	2					
100630	EROSION CONTROL BLANKET	SO YD	212	212					
600200	BITUMINOUS MATERIALS (PRIME COAT)	TON	10	10					
600300	AGGREGATE (PRIME COAT)	TON	49	49					
600400	MIXTURE FOR CRACKS, JOINTS, AND FLANGEWAYS	TON	7.5	7.5					
0600895	CONSTRUCTING TEST STRIP	EACH	1	1					
0600982	HOT-MIX ASPHALT SURFACE REMOVAL - BUTT	SO YD	64	64					
0603340	HOT-MIX ASPHALT SURFACE COURSE. MIX "D", N70	TON	2030	2030					
2001300	PROTECTIVE COAT	SQ YD	15	15					
4000158	HOT-MIX ASPHALT SURFACE REMOVAL. 2 1/4"	SO YD	24163	24163					
14001700	COMBINATION CONCRETE CURB AND GUTTER REMOVAL AND REPLACEMENT	FOOT	300	300					
14201803	CLASS D PATCHES, TYPE II, 13 INCH	SO YD	484	484					
14201807	CLASS D PATCHES. TYPE III. 13 INCH	SO YD	362	362					
14201809	CLASS D PATCHES, TYPE IV. 13 INCH	SO YD	362	362					
48101500	AGGREGATE SHOULDERS, TYPE B 6"	SO YD	120	120					
48102100	AGGREGATE WEDGE SHOULDER. TYPE B	TON	273	273					
63100167	TRAFFIC BARRIER TERMINAL, TYPE 1 (SPECIAL) TANGENT	EACH	2	2					
67000400	ENGINEER'S FIELD OFFICE, TYPE A	CAL MO	1	1					
67100100	MOBILIZATION	L SUM	1	1					
70102625	TRAFFIC CONTROL AND PROTECTION. STANDARD 701606	L SUM	1	1					


	THE PARTY OF CHANTITIES		URBAN	URBAN CONSTRUCTION TYPE CODE				
	SUMMARY OF QUANTITIES		100.1. FEO.					
CODE NO	ITEM	UNIT	QUANTITIES	I000-2A				
								7
0102635	TRAFFIC CONTROL AND PROTECTION. STANDARD 701701	L SUM	1	1				
0300100	SHORT-TERM PAVEMENT MARKING	FOOT	14560	14560	14.7			
0300210	TEMPORARY PAVEMENT MARKING - LETTERS AND SYMBOLS	SQ FT	218	218	1 (1) 1 (1)			
0300220	TEMPORARY PAVEMENT MARKING - LINE 4"	FOOT	26687	26687				
0300240	TEMPORARY PAVEMENT MARKING	FOOT	866	866				
0300260	- LINE 6" TEMPORARY PAVEMENT MARKING - LINE 12"	FOOT	119	119	·			
0300280	TEMPORARY PAVEMENT MARKING - LINE 24"	FOOT	85	85				
8000100	THERMOPLASTIC PAVEMENT MARKING - LETTERS AND SYMBOLS	SQ FT	218	218				
78000200	THERMOPLASTIC PAVEMENT MARKING - LINE 4"	FOOT	26687	26687				
78000400	THERMOPLASTIC PAVEMENT MARKING - LINE 6"	FOOT	866	866				
78000600	THERMOPLASTIC PAVEMENT MARKING - LINE 12"	FOOT	119	119				
78000650	THERMOPLASTIC PAVEMENT MARKING - LINE 24"	FOOT	85	85				
78100100	RAISED REFLECTIVE PAVEMENT MARKER	EACH	527	527				
78201000	TERMINAL MARKER - DIRECT APPLIED	EACH	2	2				
78300200	RAISED REFLECTIVE PAVEMENT MARKER	EACH	527	527			1	
88600600	DETECTOR LOOP REPLACEMENT	FOOT	400	400				
X0322256	TEMPORARY INFORMATION SIGNING	SQ FT	129	129			We are	
X4067107	POLYMERIZED LEVELING BINDER (MACHINE METHOD), IL-4.75, N50	TON	952	952	1. A.			
ettiller Tilba K								


NAME DATE		REVISIONS
	DATE	NAME
.1.		7


ILLINOIS DEPARTMENT OF TRANSPORTATION SUMMARY OF QUANTITIES


* Specially Hems

PLOT DATE: 2/13/2009

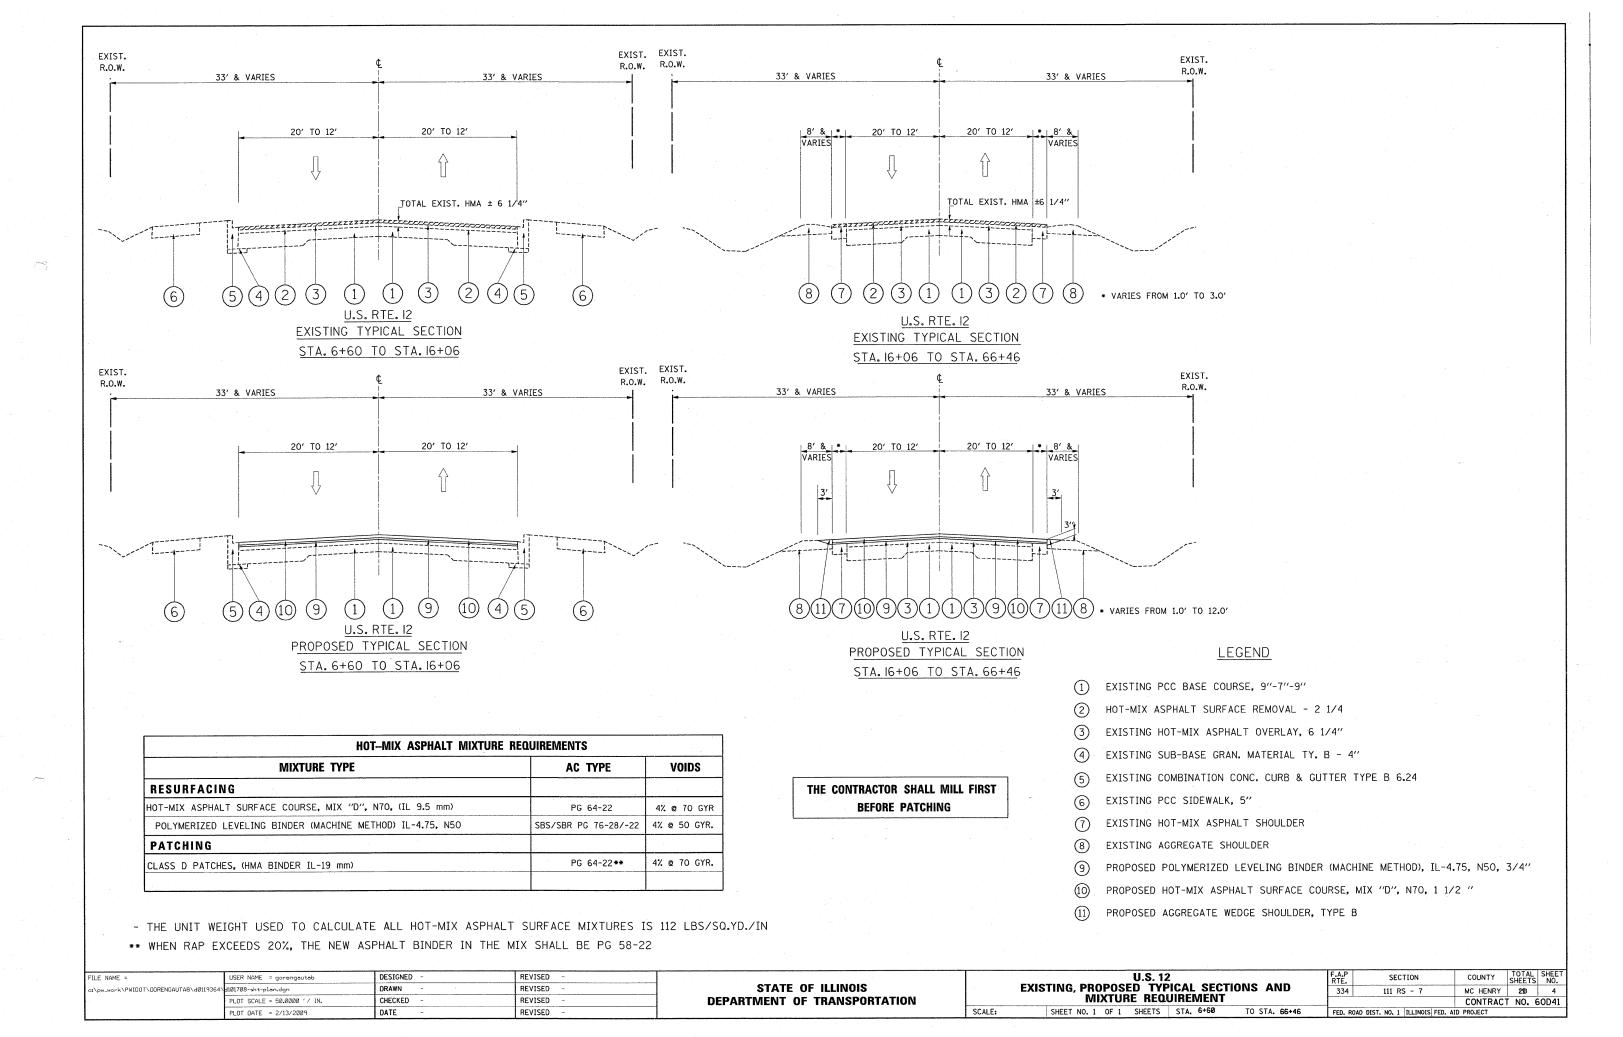

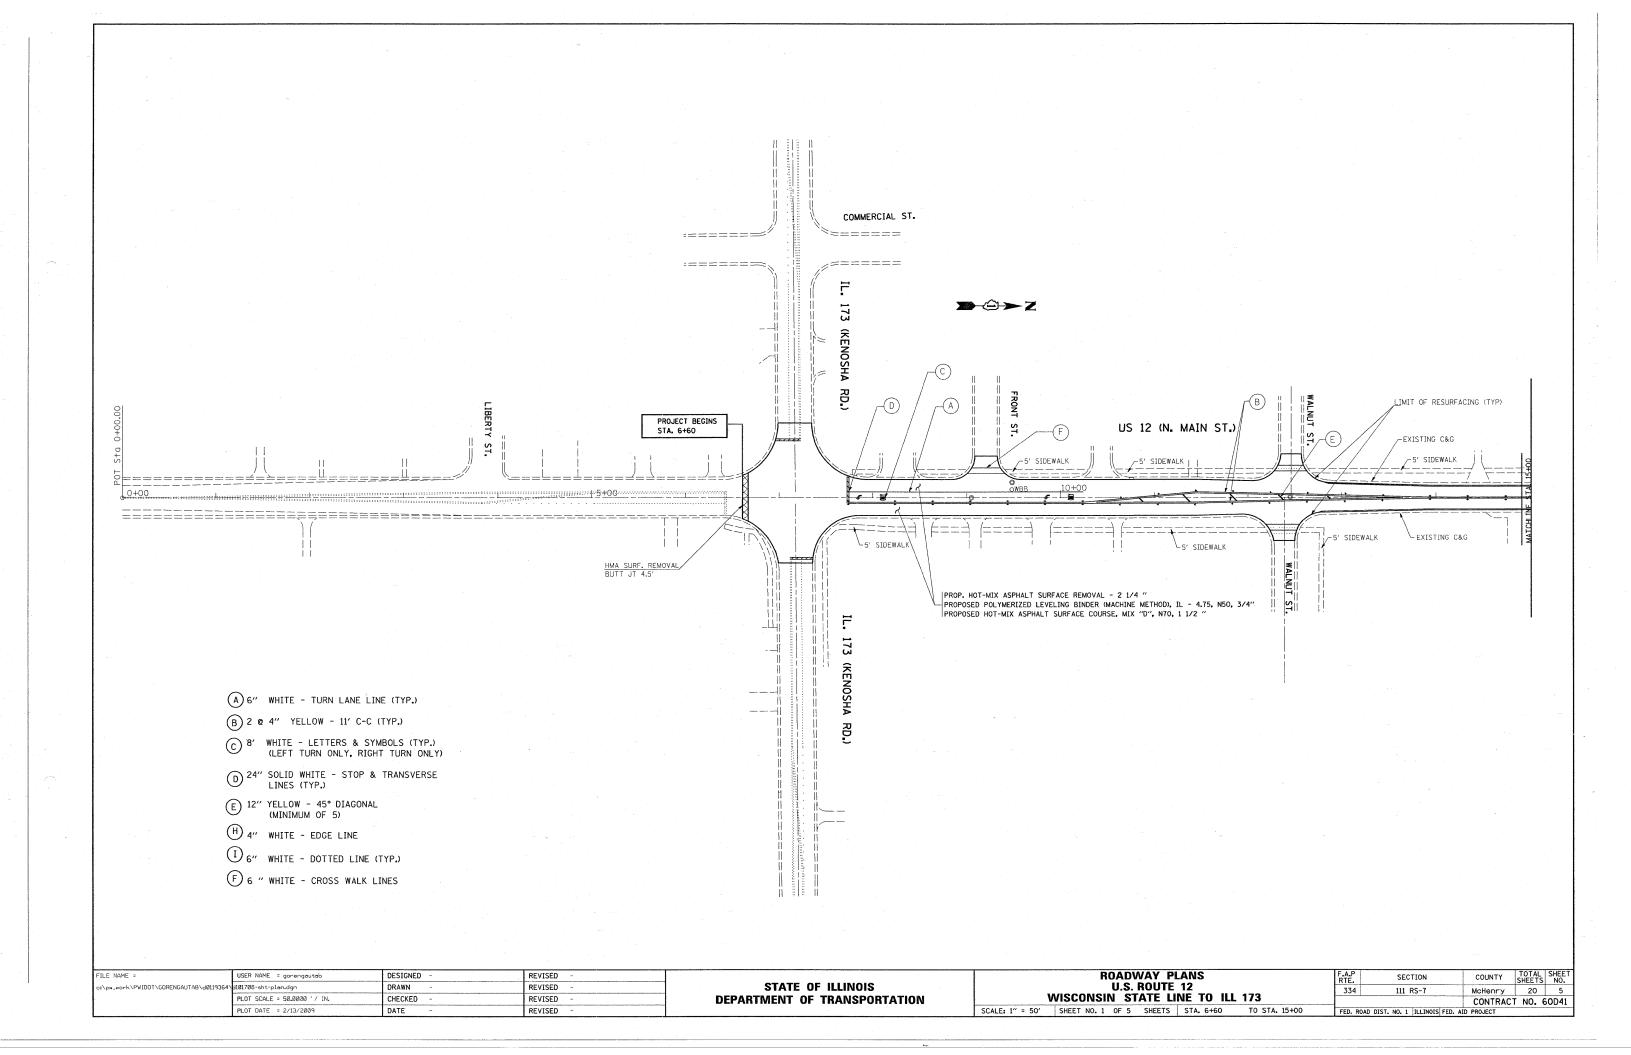


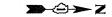


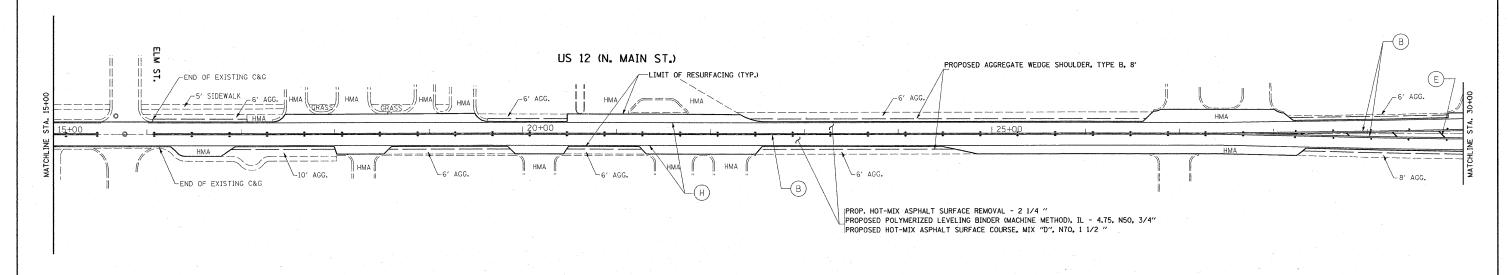



- A 6" WHITE TURN LANE LINE (TYP.)
- (B) 2 @ 4" YELLOW 11' C-C (TYP.)
- © 8' WHITE LETTERS & SYMBOLS (TYP.)
 (LEFT TURN ONLY, RIGHT TURN ONLY)
- D 24" SOLID WHITE STOP & TRANSVERSE LINES (TYP.)
- E 12" YELLOW 45° DIAGONAL (MINIMUM OF 5)
- H 4" WHITE EDGE LINE
- 1 6" WHITE DOTTED LINE (TYP.)
- F 6 " WHITE CROSS WALK LINES


FILE NAME =	USER NAME = gorengautab	DESIGNED -	REVISED -		ROADWAY PLANS	F.A.P SECTION COUNTY SHEETS NO.
c:\pw.work\PWIDOT\GORENGAUTA8\dØ119364\	d101708-sht-plan.dgn	DRAWN -	REVISED -	STATE OF ILLINOIS	U.S. ROUTE 12	334 111 RS-7 McHenry 20 6
	PLOT SCALE = 50.0000 '/ IN.	CHECKED -	REVISED -	DEPARTMENT OF TRANSPORTATION	WISCONSIN STATE LINE TO ILL 173	CONTRACT NO. 60D41
	PLOT DATE = 2/13/2009	DATE -	REVISED -		SCALE: 1" = 50' SHEET NO. 2 OF 5 SHEETS STA. 15+00 TO STA. 30+00	FED. ROAD DIST. NO. 1 ILLINOIS FED. AID PROJECT

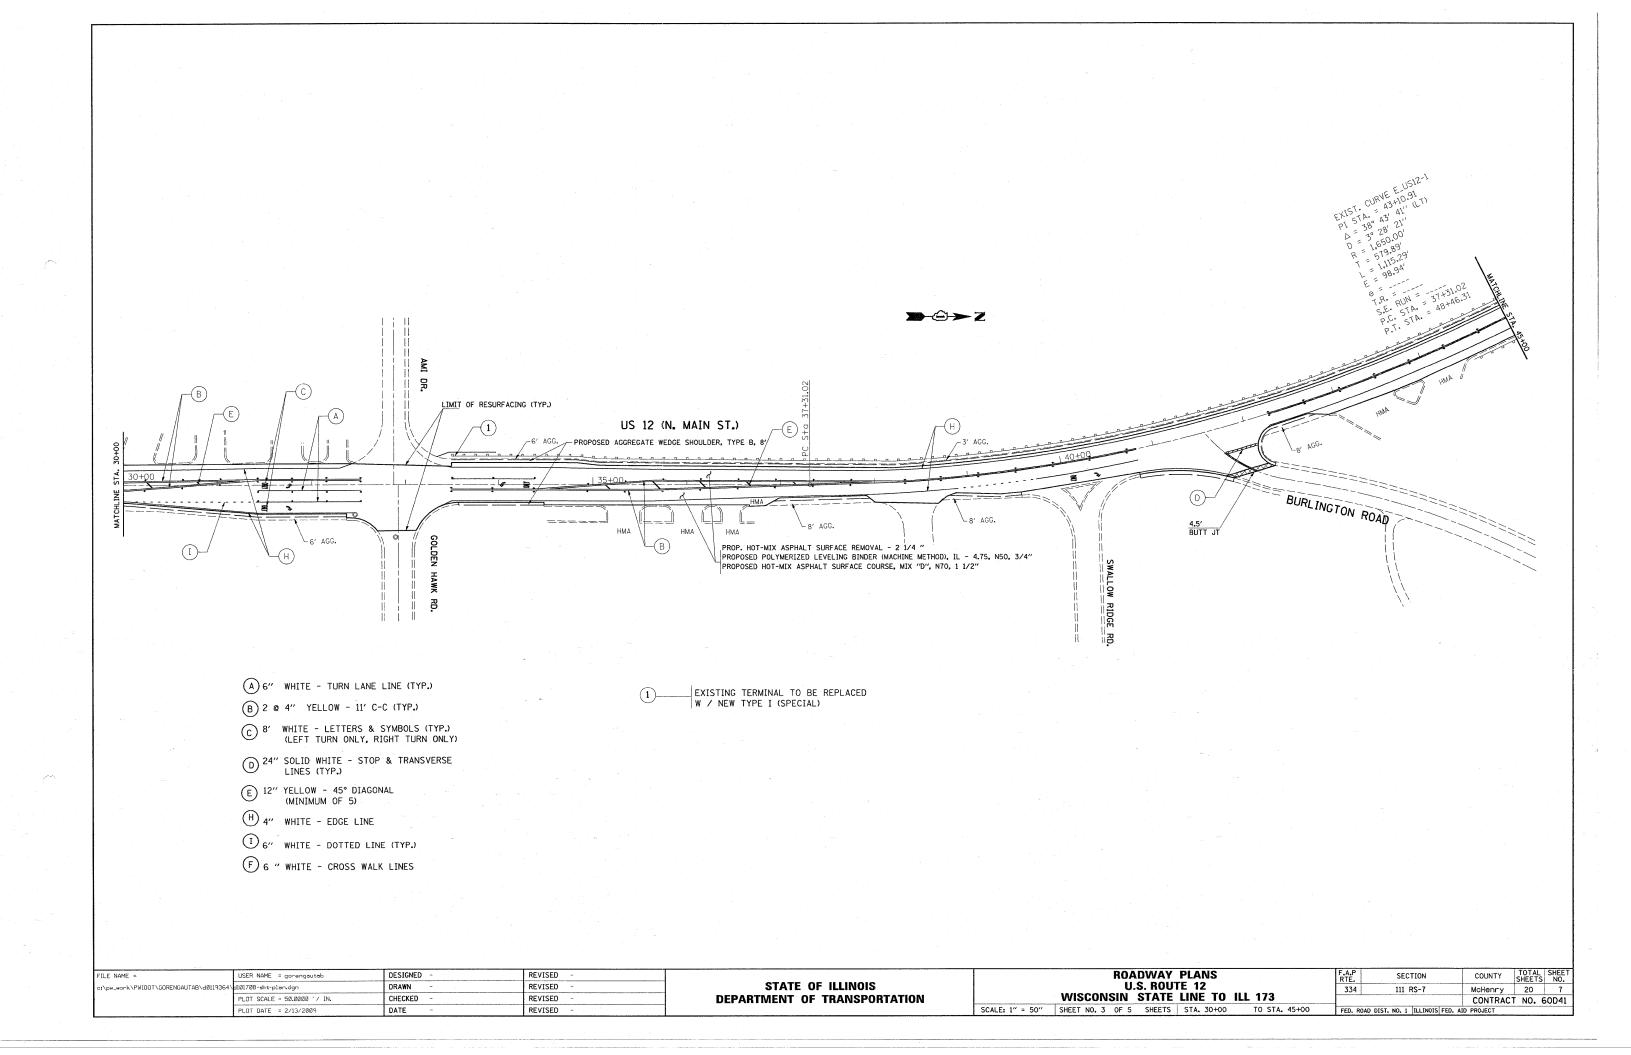

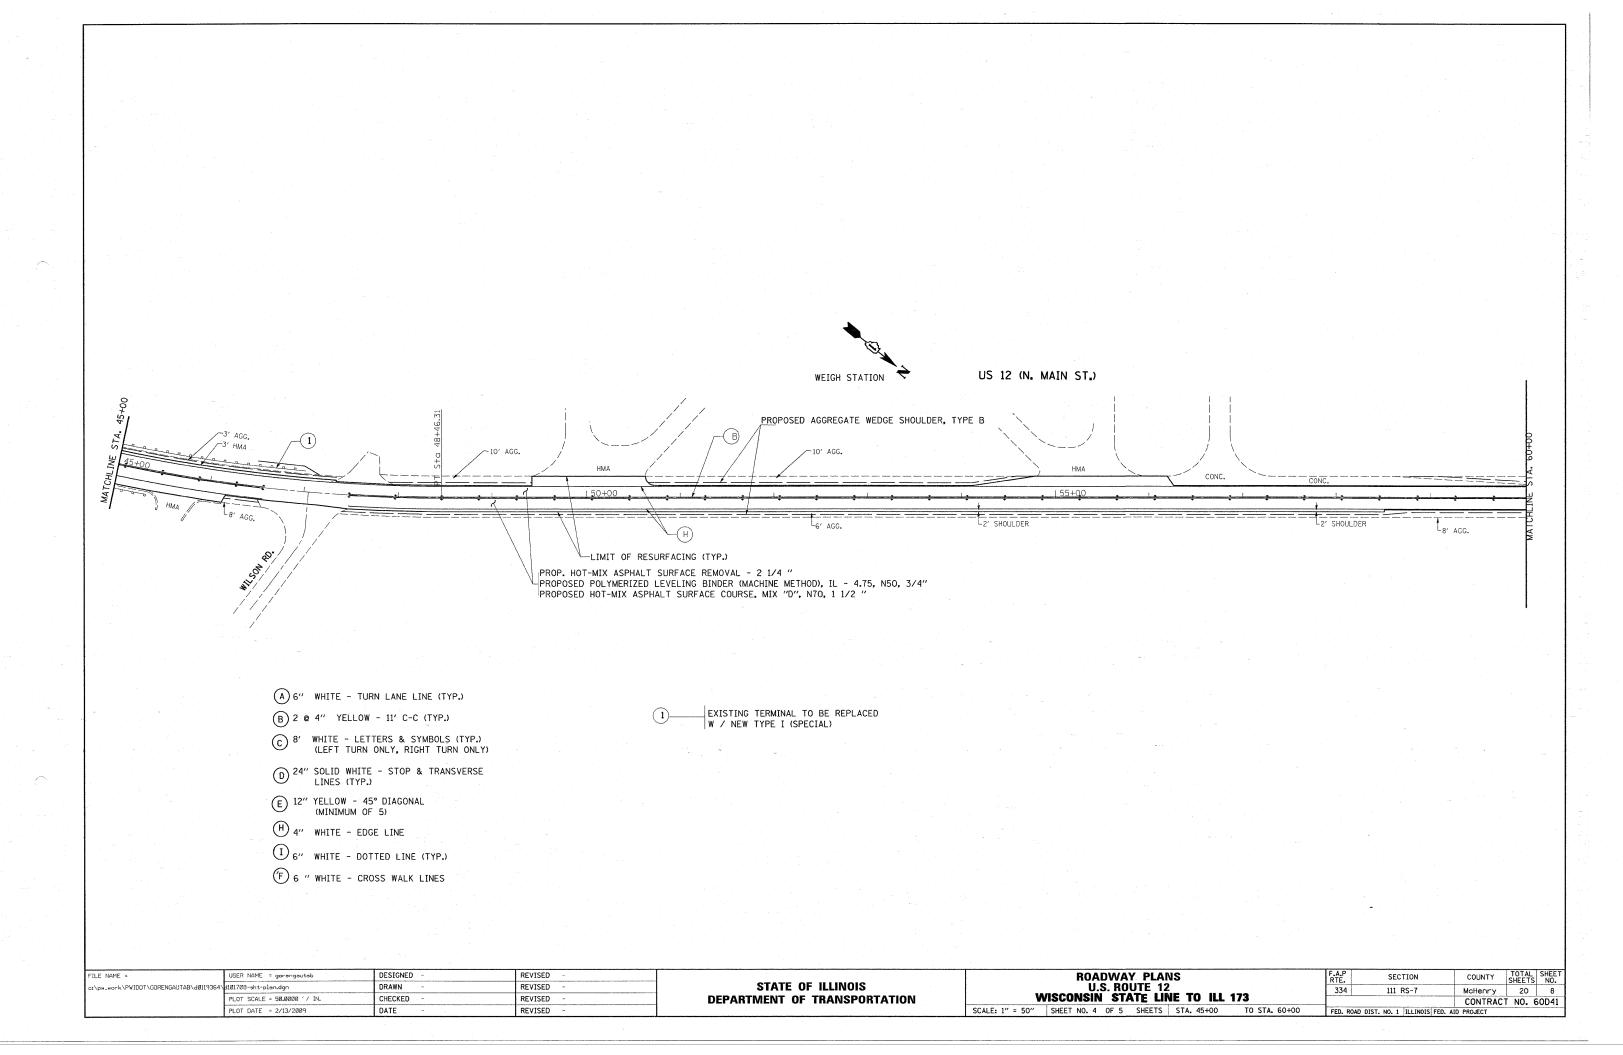

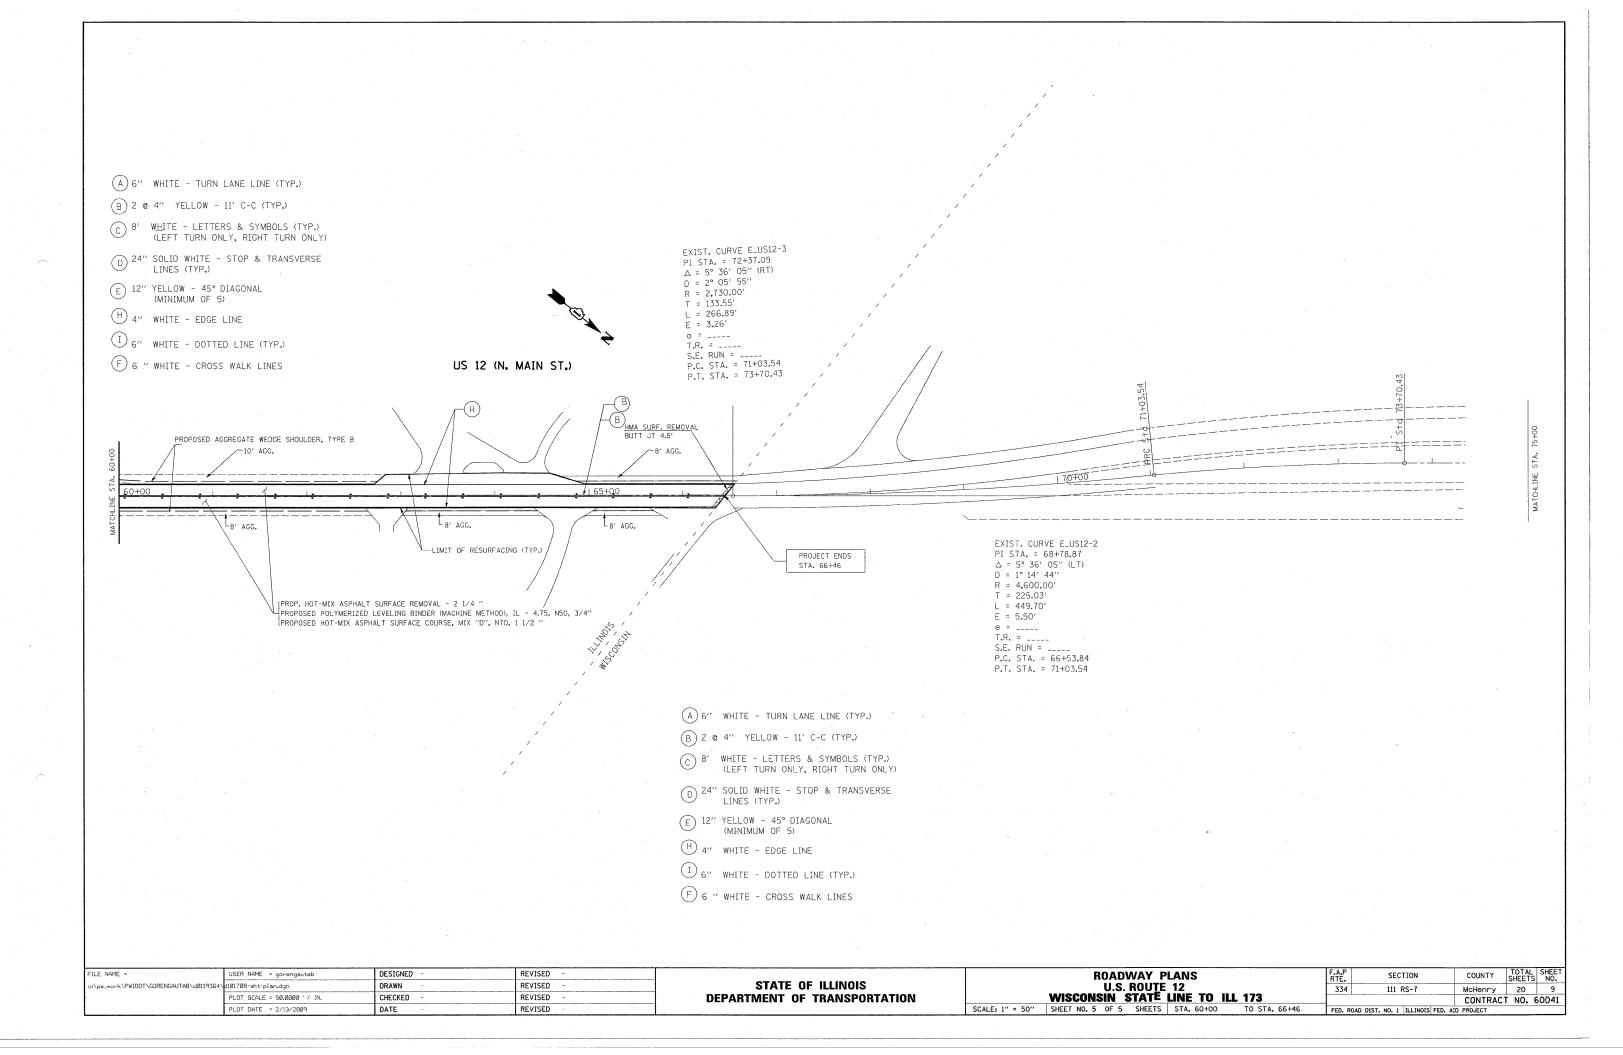

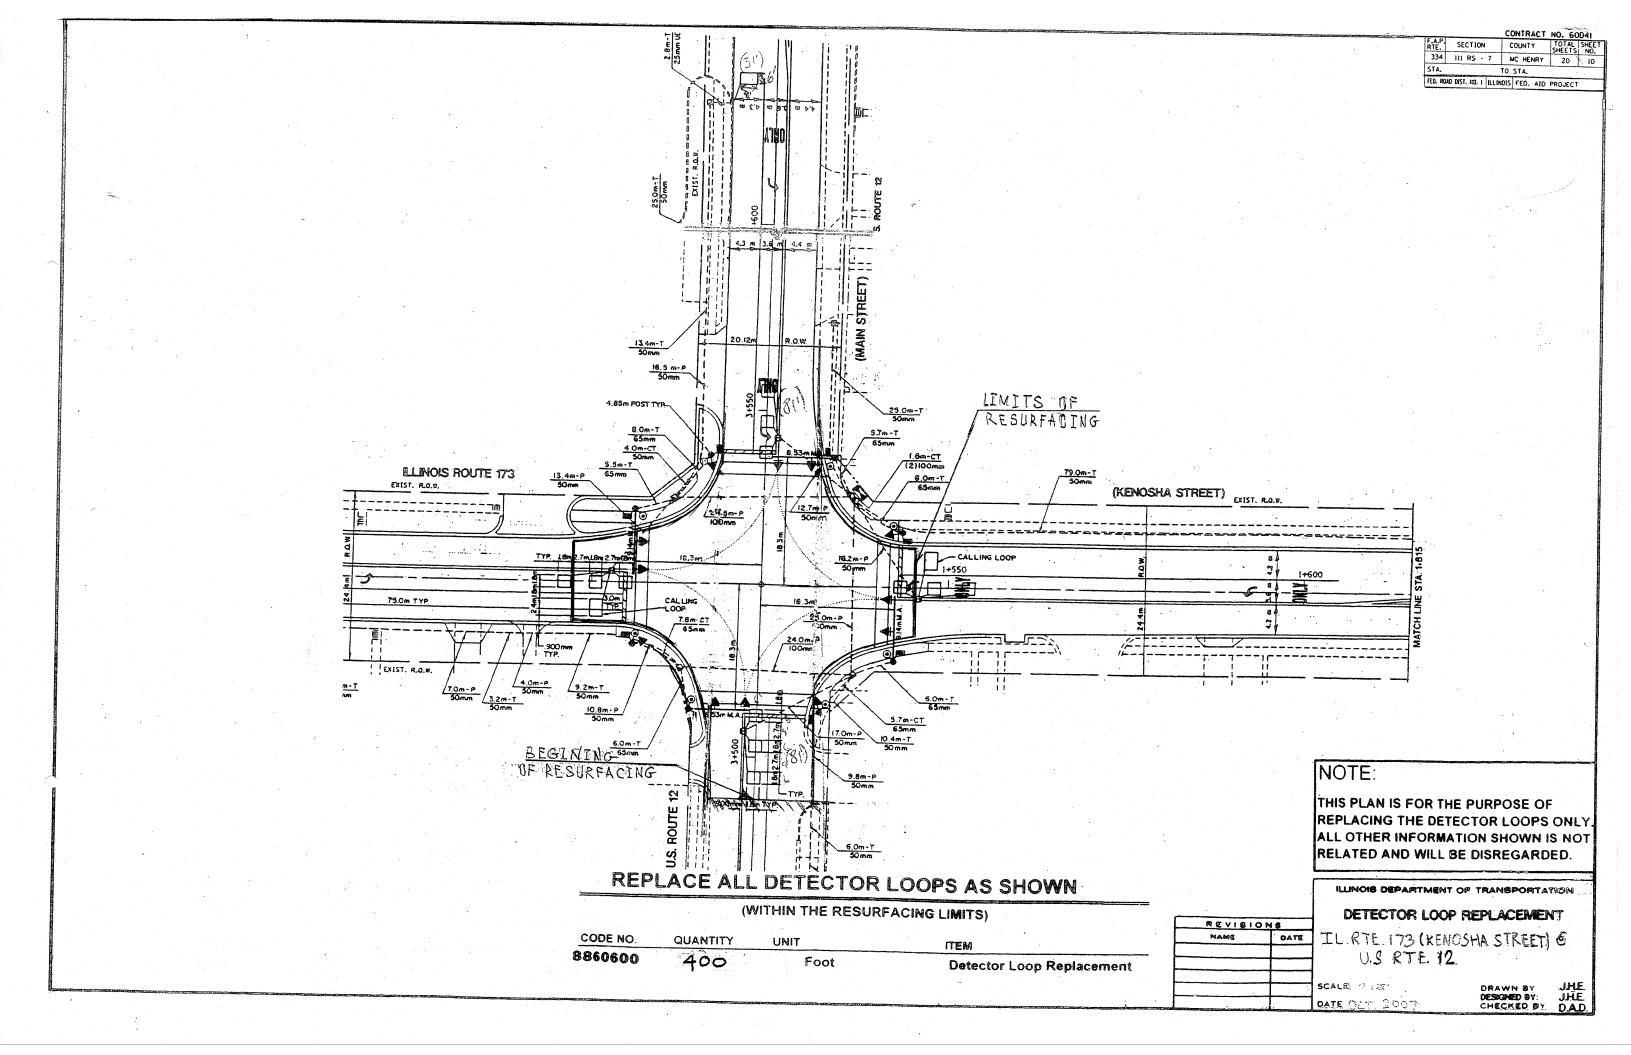

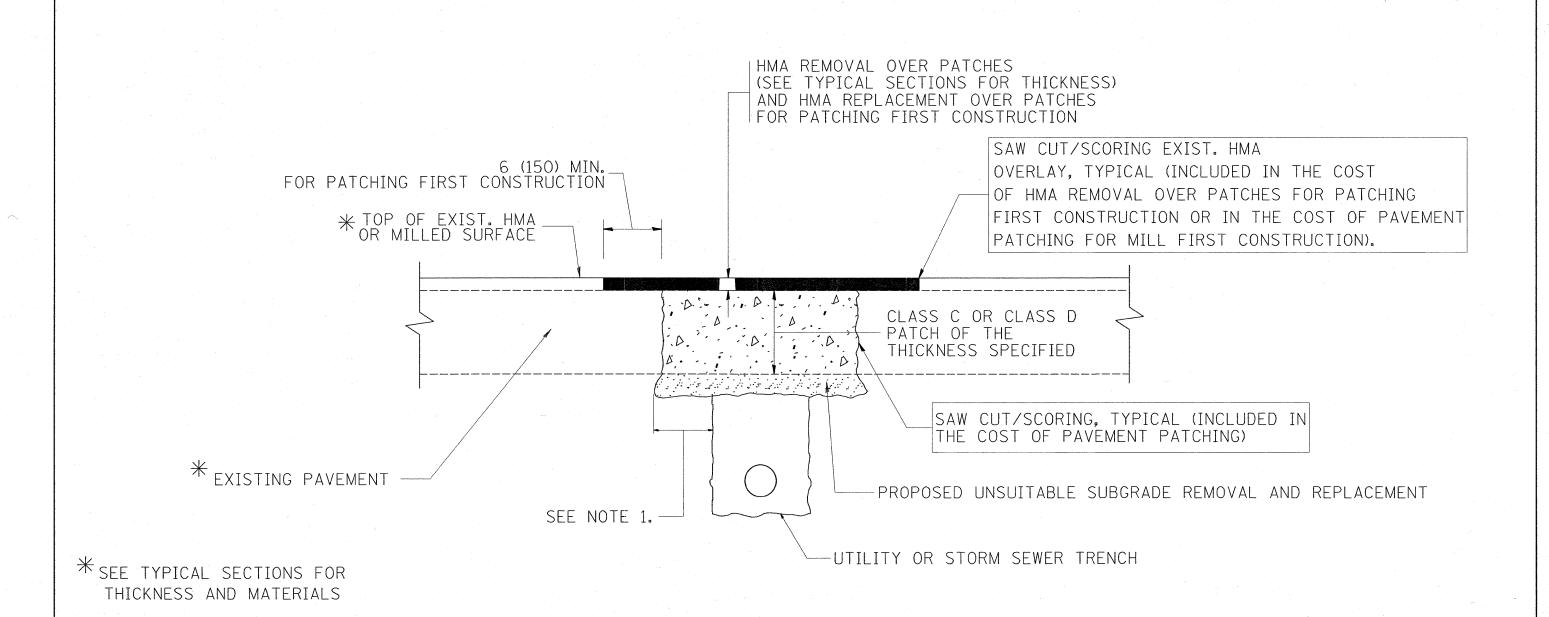

NOTES:

- 1. THE WIDTH OF THE FULL DEPTH PATCH OVER A TRENCH SHALL BE 12 (300) WIDER ON EACH SIDE OF THE TRENCH.
- 2. FOR METHOD OF MEASUREMENT AND BASIS OF PAYMENT, SEE RECURRING SPECIAL PROVISION "PATCHING WITH HOT-MIX ASPHALT OVERLAY REMOVAL".


SEQUENCE OF CONSTRUCTION (PATCHING FIRST)

- 1. REMOVE THE EXISTING HMA MATERIAL OVER THE AREA TO BE PATCHED.
- 2. REMOVE AND REPLACE WITH CLASS C OR D PATCH.
- 3. REPLACE HMA MATERIAL OVER THE AREA TO BE PATCHED.

SEQUENCE OF CONSTRUCTION (MILLING FIRST)


- 1. MILL HMA FIRST IF THERE IS AT LEAST 41/2 INCHES OR MORE OF HMA MATERIAL ON TOP OF THE EXISTING PAVEMENT OR IF THE PAVEMENT IS FULL DEPTH HMA. A MINIMUM OF 2 INCHES OF HMA MATERIAL SHALL BE IN PLACE AFTER MILLING.
- 2. REMOVE AND REPLACE WITH FULL DEPTH CLASS D PATCHES TO TOP OF MILLED SURFACE.

FILE NAME =	USER NAME = gorengoutab	DESIGNED - R. SHAH	REVISED - A. ABBAS 04-27-98		PAVEMENT PATCHING FOR	F.A.P. SECTION COUNTY SHEET NO.
c:\pw_work\PWIBOT\GORENGAUT	TAB\dØ119364\DistStd.dgn	DRAWN -	REVISED - R. BORO 01-01-07	STATE OF ILLINOIS		334 111 RS - 7 MC HENRY 20 11
	PLOT SCALE = 50.0000 '/ IN.	CHECKED -	REVISED - R. BORO 09-04-07	DEPARTMENT OF TRANSPORTATION	HMA SURFACED PAVEMENT	BD400-04 (BD-22) CONTRACT NO. 60D41
	PLOT DATE = 2/13/2009	DATE - 10-25-94	REVISED - K. ENG 10-27-08		SCALE: NONE SHEET NO. 1 OF 1 SHEETS STA. 6+60 TO STA. 66+4	

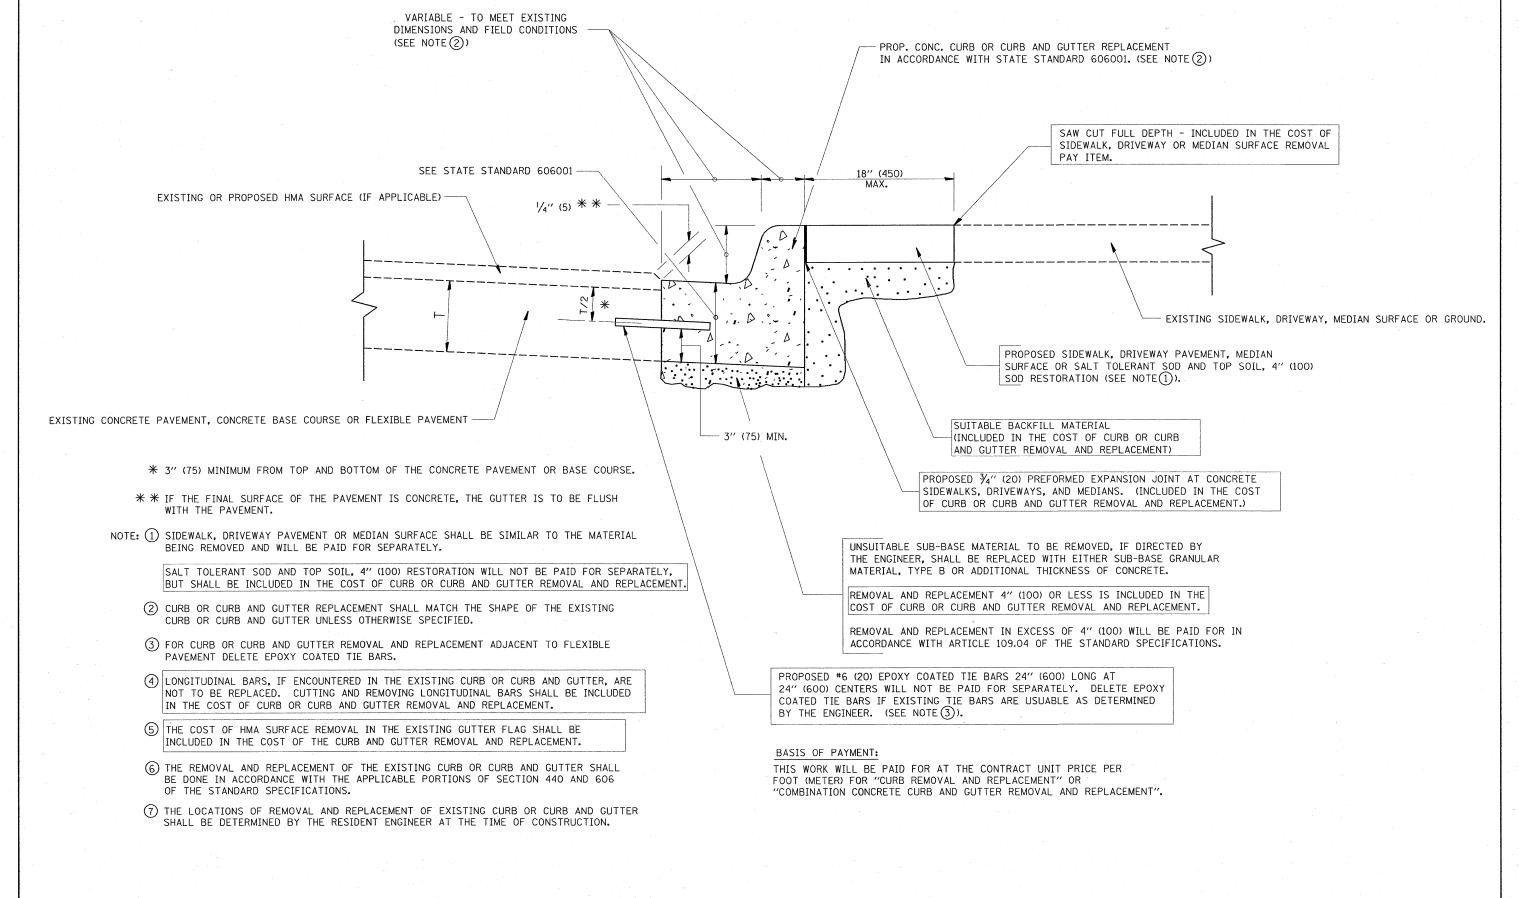

CURB OR CURB AND GUTTER REMOVAL AND REPLACEMENT


FILE NAME =	USER NAME = gorengautab	DESIGNED - A. HOUSEH	REVISED - R. SHAH 10-03-96		CURB OR CURB AND GUTTER	F.A.P. SECTION	COUNTY TOTAL SHEET
c:\pw_work\PWIDOT\GORENGAUTAB\d0119364\	DistStd.dgn	DRAWN -	REVISED - A. ABBAS 03-21-97	STATE OF ILLINOIS		334 111 RS - 7	MC HENRY 20 12
	PLOT SCALE = 50.0000 '/ IN.	CHECKED -	REVISED - M. GOMEZ 01-22-01	DEPARTMENT OF TRANSPORTATION	REMOVAL AND REPLACEMENT	BD600-06 (BD-24)	CONTRACT NO. 60D41
	PLOT DATE = 2/13/2009	DATE - 03-11-94	REVISED - R. BORO 01-01-07		SCALE: NONE SHEET NO. 1 OF 1 SHEETS STA. 6+60 TO STA. 66+46	FED. ROAD DIST. NO. 1 ILLINOIS FED. AID	PROJECT

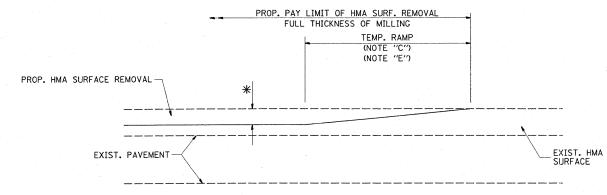

MILLED TEMPORARY RAMP

(FOR BUTT JOINT AND HMA TAPER SEE DETAIL BELOW)


OPTION 1

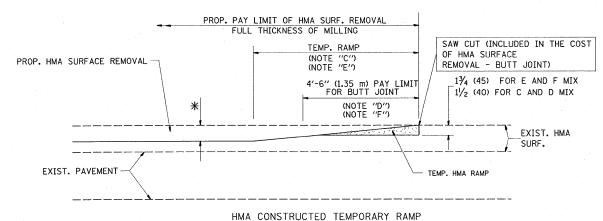

(FOR BUTT JOINT AND HMA TAPER SEE DETAIL BELOW)

OPTION 2

TYPICAL TEMPORARY RAMP

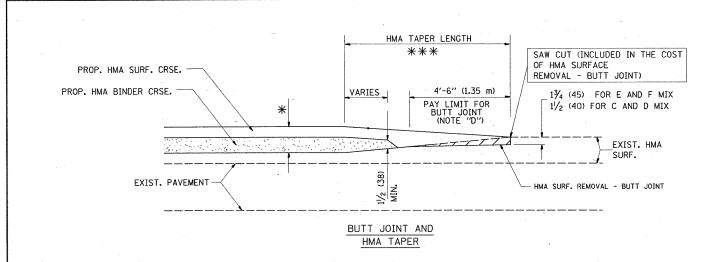

TYPICAL BUTT JOINT AND HMA TAPER FOR MILLING AND RESURFACING


PROP. HMA OR PCC

SURFACE REMOVAL - BUTT JOINT
30'-0" (9.0 m) (NOTE "B")

(NOTE "D")

** * EXIST. PAVEMENT

BUTT JOINT DETAIL

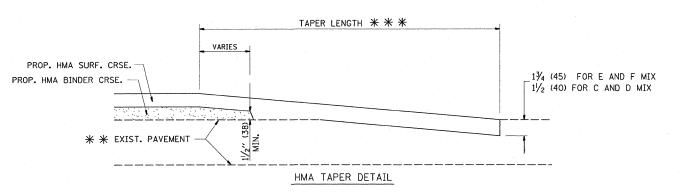

TYPICAL BUTT JOINT AND HMA TAPER FOR RESURFACING ONLY

PC CONCRETE, HMA OR HMA RESURFACED PAVEMENT.


NOTES

- A: MAINLINE ROADWAYS AND MAJOR SIDE ROADS.
- B: MINOR SIDE ROADS.
- C: THE TEMP. RAMP SHALL BE CONSTRUCTED IMMEDIATELY UPON REMOVAL OF THE EXISTING HMA SURFACE.
- D: THE BUTT JOINT SHALL BE CONSTRUCTED IMMEDIATELY PRIOR TO PLACING THE PROPOSED HMA COURSES.
- E: TAPER THE TEMP. RAMP AT A RATE OF 3'-0" (900 mm) PER 1 INCH (25 mm) OF MILLING THICKNESS.
- F: INSTALLATION AND REMOVAL OF THE 4'-6" (1.35 m) TEMP. RAMP IS INCLUDED IN COST OF HMA SURFACE REMOVAL BUTT JOINT
- G: SEE ARTICLE 406.08 AND 406.14 OF THE STANDARD SPECIFICATIONS FOR "HMA AND/OR PCC SURFACE REMOVAL, BUTT JOINT".
- * SEE TYPICAL SECTIONS FOR MILLING THICKNESS.
- ** * 20'-0" (6.1 m) PER 1 (25) RESURFACING (NOTE "A") 10'-0" (3.0 m) PER 1 (25) RESURFACING (NOTE "B")

BASIS OF PAYMENT:

THE BUTT JOINT WILL BE PAID FOR AT THE CONTRACT UNIT PRICE PER SQUARE YARD (SQUARE METER) FOR "HOT-MIX ASPHALT SURFACE REMOVAL - BUTT JOINT" OR FOR "PORTLAND CEMENT CONCRETE SURFACE REMOVAL- BUTT JOINT".

FILE NAME =	USER NAME = gorengauteb	DESIGNED - M. DE YONG	REVISED - R. SHAH 10-25-94		BUTT JOINT AND	RTF. SECTION COUNTY TOTAL SHEET NO.
c:\pw_work\PWIDOT\GORENGAUTAB\dØ11936	DistStd.dgn	DRAWN -	REVISED - A. ABBAS 03-21-97	STATE OF ILLINOIS	HMA TAPER DETAILS	111 RS - 7 MC HENRY 20 13
and the second s	PLOT SCALE = 50.0000 '/ IN.	CHECKED -	REVISED - M. GOMEZ 04-06-01	DEPARTMENT OF TRANSPORTATION		BD400-05 BD32 CONTRACT NO. 60D41
· ·	PLOT DATE = 2/13/2009	DATE - 06-13-90	REVISED - R. BORO 01-01-07		SCALE: NONE SHEET NO. 1 OF 1 SHEETS STA. 6+60 TO STA. 66+46	FED. ROAD DIST. NO. 1 ILLINOIS FED. AID PROJECT

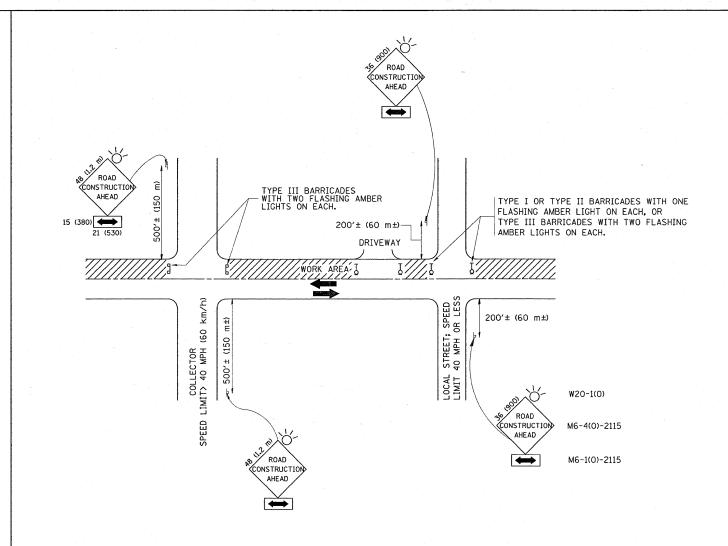

TRAFFIC CONTROL AND PROTECTION FOR SIDE ROADS, INTERSECTIONS, AND DRIVEWAYS

NOTES:


- A. FOR NO LANE RESTRICTION ON THE SIDE ROAD OR DRIVEWAYS
- 1. SIDE ROAD WITH A SPEED LIMIT OF 40 MPH (60 km/h) OR LESS AS SHOWN ON THE DRAWING AND AS DIRECTED BY THE ENGINEER:
- G) ONE ROAD CONSTRUCTION AHEAD SIGN 36 x 36 (900x900) WITH A FLASHER AND FLAG MOUNTED ON IT APPROXIMATELY 200' (60 m) IN ADVANCE OF THE MAIN ROUTE.
- b) THE CLOSED PORTION OF THE MAIN ROUTE SHALL BE PROTECTED BY BLOCKING WITH TYPE I, TYPE II OR TYPE III BARRICADES, 1/3 OF THE CROSS SECTION OF THE CLOSED PORTION.
- 2. SIDE ROAD WITH A SPEED LIMIT GREATER THAN 40 MPH (60 km/h)
 AS SHOWN ON THE DRAWING AND AS DIRECTED BY THE ENGINEER:
- a) ONE ROAD CONSTRUCTION AHEAD SIGN 48 \times 48 (1.2 m \times 1.2 m) WITH A FLASHER MOUNTED ON IT APPROXIMATELY 500' (150 m) IN ADVANCE OF THE MAIN ROUTE.
- b) THE CLOSED PORTION OF THE MAIN ROUTE SHALL BE PROTECTED BY BLOCKING WITH TYPE III BARRICADES, 1/2 OF THE CROSS SECTION OF THE CLOSED PORTION.
- 3. WHEN THE SIDE ROAD LIES BETWEEN THE BEGINNING OF THE MAINLINE SIGNING AND THE WORK ZONE, A SINGLE HEADED ARROW (M6-1) SHALL BE USED IN LIEU OF THE DOUBLE HEADED ARROW (M6-4).

- B. FOR A LANE CLOSURE ON A SIDE ROAD OR DRIVEWAY:
- USE APPLICABLE PORTIONS OF THE TYPICAL APPLICATION OF TRAFFIC CONTROL DEVICES (STD. 701501, STD. 701606 OR THE APPROPRIATE STANDARD). THE SPACING OF SIGNS AND BARRICADES SHALL BE ADJUSTED FOR FIELD CONDITIONS AS DIRECTED BY THE ENGINEER. THE DIRECTIONAL ARROW SHALL BE COVERED OR REMOVED WHEN NO LONGER CONSISTENT WITH THE SIDE ROAD LANE CLOSURE.
- C. ADVANCE WARNING SIGNS ARE TO BE OMITTED ON DRIVEWAY UNLESS OTHERWISE NOTED.
- D. THE TRAFFIC CONTROL AND PROTECTION FOR SIDE ROADS, INTERSECTIONS, AND DRIVEWAYS SHALL BE INCIDENTAL TO THE COST OF SPECIFIED TRAFFIC CONTROL STANDARDS OR ITEMS.

All dimensions are in millimeters (inches) unless otherwise shown.


COUNTY TOTAL SHEETS NO.


MC NENRY 20 14 USER NAME = gorengautab DESIGNED - LHA REVISED - J. OBERLE 10-18-95 TRAFFIC CONTROL AND PROTECTION FOR STATE OF ILLINOIS DRAWN REVISED - A. HOUSEH 03-06-96 c:\pw_work\PWIDOT\GORENGAUTAB\dØ119364 DıstStd.dgn 111 RS - 7 SIDE ROADS, INTERSECTIONS, AND DRIVEWAYS **DEPARTMENT OF TRANSPORTATION** PLOT SCALE = 50.0000 '/ IN. CHECKED REVISED - A. HOUSEH 10-15-96 TC-10 CONTRACT NO. 60D41 SHEET NO. 1 OF 1 SHEETS STA. 6+60 TO STA. 66+46 FED. ROAD DIST. NO. 1 | ILLINOIS FED. AID PROJECT PLOT DATE = 2/13/2009 DATE 06-89 REVISED -T. RAMMACHER 01-06-00 SCALE: NONE

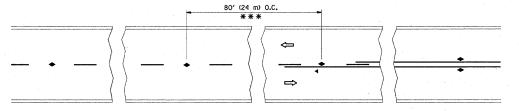

*** REDUCE TO 40' (12 m) O.C. ON CURVES WITH POSTED OR ADVISORY SPEED 45 M.P.H. (70 km/h) OR LESS.

TWO-LANE/TWO-WAY

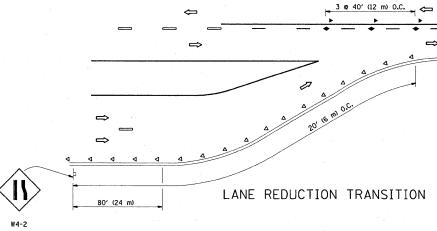

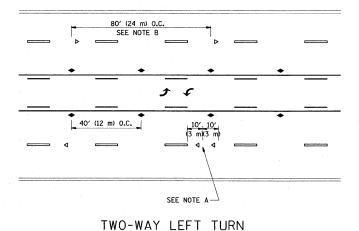

80' (24 m) 0.C.

SEE NOTE B

40' (12 m) 0.C.

3 m)(3 m)

SEE NOTE A

MULTI-LANE/UNDIVIDED

SEE NOTE A

GENERAL NOTES

- 1. MARKERS USED WITH DASHED LINES SHALL BE CENTERED IN THE GAP BETWEEN SEGMENTS.
- 2. MARKERS USED ADJACENT TO SOLID LINES SHALL BE OFFSET 2 TO 3 (50 TO 75) TOWARD TRAFFIC AS SHOWN.
- MARKERS THROUGH TANGENTS LESS THAN 500' (150 m) IN LENGTH BETWEEN CURVES SHALL BE INSTALLED AT THE LESSER OF THE TWO CURVE SPACINGS.

LANE MARKER NOTES

- B. REDUCE TO 40' (12 m) O.C. ON CURVES WHERE ADVISORY SPEEDS ARE 10 M.P.H (20 km/h) LOWER THAN POSTED SPEEDS.
- A. USE DOUBLE LANE LINE MARKERS SPACED AS SHOWN.

SYMBOLS

---- YELLOW STRIPE


WHITE STRIPE

- ONE-WAY AMBER MARKER
- ONE-WAY CRYSTAL MARKER (W/O)
- TWO-WAY AMBER MARKER

DESIGN NOTES

- 1. DOUBLE LANE LINE MARKERS SHALL BE USED UNLESS SPECIFIED OTHERWISE.
- 2. EXCEPT AS SHOWN ON THE LANE REDUCTION TRANSITION AND FREEWAY EXIT RAMP DETAIL, MARKERS ARE NOT TO BE SPECIFIED ON RIGHT EDGE LINFS.
- 3. THE EXACT MARKER LIMITS, SPACING, AND COLOR SHOULD BE INCLUDED IN THE PLANS.
- MARKERS SHOULD NOT BE USED ALONGSIDE CURBS EXCEPT FOR EXTREMELY SHORT SECTIONS OF CURBS WHERE NOT MORE THAN TWO MARKERS WOULD BE INVOLVED.


MULTI-LANE/DIVIDED

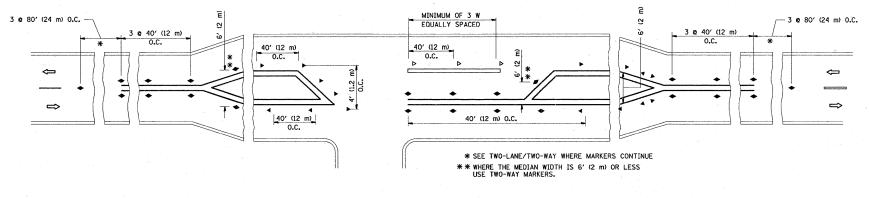

LEFT TURN


All dimensions are in inches (millimeters) unless otherwise shown.

f	FILE NAME = .	USER NAME = gorengautab	DESIGNED -	REVISED - T. RAMMACHER 09-19-94		TYPICAL APPLICATIONS	F.A.P. SECTION	COUNTY SHEET
	o:\pw_work\PWIDOT\GORENGAUTAB\dØ119364\	DistStd.dgn	DRAWN -	REVISED - T. RAMMACHER 03-12-99	STATE OF ILLINOIS		334 111 RS - 7	MC HENRY 20 15
	2	PLOT SCALE = 50.0000 '/ IN.	CHECKED -	REVISED -T. RAMMACHER 01-06-00	DEPARTMENT OF TRANSPORTATION	RAISED REFLECTIVE PAVEMENT MARKERS (SNOW-PLOW RESISTANT)	TC11	CONTRACT NO. 60D41
- 1		PLOT DATE = 2/13/2009	DATE -	REVISED -		SCALE: NONE SHEET NO. 1 OF 1 SHEETS STA. 6+60 TO STA. 66+46		FED. AID PROJECT

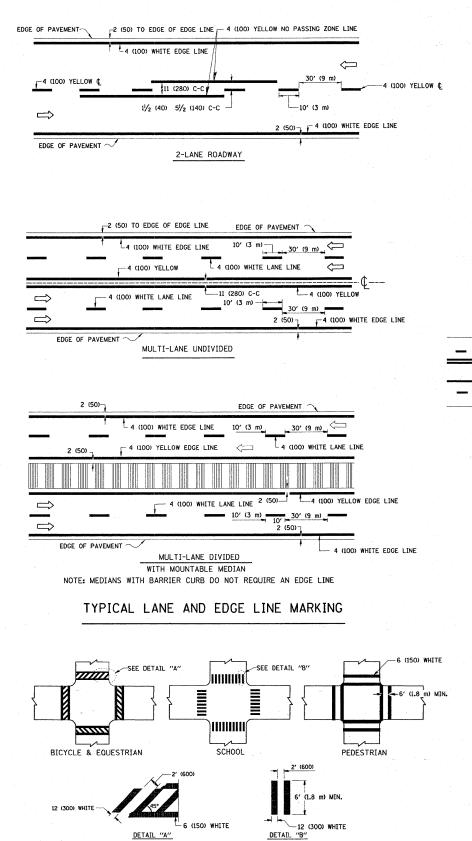


ETAIL "A" DETAIL "B"

TYPICAL CROSSWALK MARKING

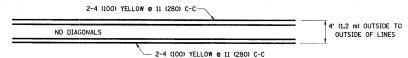


4' (1.2 m) WIDE MEDIANS ONLY

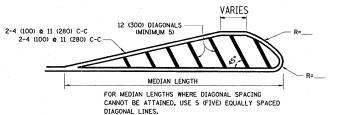


DIAGONAL LINE SPACING: 50′ (15 m) C-C (LESS THAN 30MPH (50 km/h))
75′ (25 m) C-C 30MPH (50 km/h) T0 45MPH (70 km/h))
150′ (45 m) C-C (MORE THAN 45MPH (70 km/h))

MEDIANS OVER 4' (1.2 m) WIDE

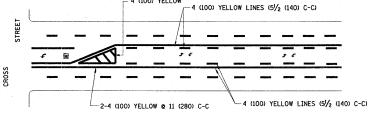


A MINIMUM OF TWO PAIRS OF TURN ARROWS SHALL BE USED, WHITE IN COLOR. ADDITIONAL PAIRS SHALL BE PLACED AT 200' (60 m) TO 300' (90 m) INTERVALS.

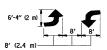

MEDIAN WITH TWO-WAY LEFT TURN LANE

TYPICAL PAINTED MEDIAN MARKING

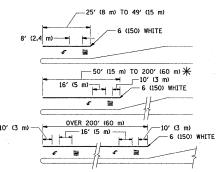


FULL SIZE LETTERS 8' (2.4 m) AND ARROWS SHALL BE USED. \P AREA = 15.6 SO. FT. (1.5 m²) \P AREA = 20.8 SO. FT. (1.9 m²)

* TURN LANES IN EXCESS OF 400' (120 m) IN LENGTH MAY HAVE AN ADDITIONAL SET OF ARROW - "ONLY" INSTALLED MIDWAY BETWEEN THE OTHER TWO SETS OF ARROW - "ONLY".

TYPICAL LEFT (OR RIGHT) TURN LANE

TYPICAL TURN LANE MARKING

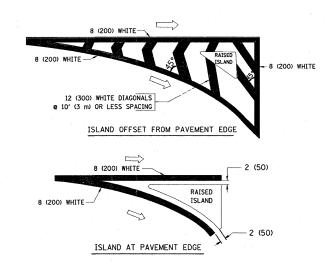

TYPICAL ISLAND MARKING

TYPE OF MARKING	WIDTH OF LINE	PATTERN	COLOR	SPACING / REMARKS
CENTERLINE ON 2 LANE PAVEMENT	4 (100)	SKIP-DASH	YELLOW	10' (3 m) LINE WITH 30' (9 m) SPACE
CENTERLINE ON MULTI-LANE UNDIVEDED PAVEMENT	2 @ 4 (100)	SOLID	YELLOW	11 (280) C-C
NO PASSING ZONE LINES: FOR ONE DIRECTION FOR BOTH DIRECTIONS	4 (100) 2 2 4 (100)	SOLID SOLID	YELLOW YELLOW	5½ (140) C-C FROM SKIP-DASH CENTERLINE 11 (280) C-C OMIT SKIP-DASH CENTERLINE BETWEEN
LANE LINES	4 (100) 5 (125) ON FREEWAYS	SKIP-DASH SKIP-DASH	WHITE WHITE	10' (3 m) LINE WITH 30' (9 m) SPACE
DOTTED LINES (EXTENSIONS OF CENTER, LANE OR TURN LANE MARKINGS)	SAME AS LINE BEING EXTENDED	SKIP-DASH	SAME AS LINE BEING EXTENDED	2' (600) LINE WITH 6' (1.8 m) SPACE
EDGE LINES	4 (100)	SOLID	YELLOW-LEFT WHITE-RIGHT	OUTLINE MOUNTABLE MEDIANS IN YELLOW; EDGE LINES ARE NOT USED NEXT TO BARRIER CURB
TURN LANE MARKINGS	6 (150) LINE; FULL SIZE LETTERS & SYMBOLS (8' (2.4m))	SOLID	WHITE	SEE TYPICAL TURN LANE MARKING DETAIL
TWO WAY LEFT TURN MARKING	2 & 4 (100) EACH DIRECTION	SKIP-DASH AND SOLID	YELLOW	10' (3 m) LINE WITH 30' (9 m) SPACE FOR SKIP-DASH; 5½ (140) C-C BETWEEN SOLID LINE AND SKIP-DASH LINE
	8' (2.4m) LEFT ARROW	IN PAIRS	WHITE	SEE TYPICAL TWO-WAY LEFT TURN MARKING DETAIL
CROSSWALK LINES (PEDESTRIAN) A. DIAGONALS (BIKE & EQUESTRIAN) B. LONGITUDINAL BARS (SCHOOL)	2 @ 6 (150) 12 (300) @ 45° 12 (300) @ 90°	SOLID SOLID SOLID	WHITE WHITE WHITE	NOT LESS THAN 6' (1.8 m) APART 2' (600) APART 2' (500) APART SEE TYPICAL CROSSWALK MARKING DETAILS.
STOP LINES	24 (600)	SOLID	WHITE	PLACE 4' (1.2 m) IN ADVANCE OF AND PARALLEL TO CROSSWALK, IF PRESENT. OTHERWISE, PLACE AT DESIRED STOPPING POINT. PARALLEL TO CROSSROAD CENTERLINE, WHERE POSSIBLE
PAINTED MEDIANS	2 @ 4 (100) WITH 12 (300) DIAGONALS	SOLID	YELLOW: TWO WAY TRAFFIC	11 (280) C-C FOR THE DOUBLE LINE
	e 45° NO DIAGONALS USED FOR 4' (1.2 m) WIDE MEDIANS		WHITE: ONE WAY TRAFFIC	SEE TYPICAL PAINTED MEDIAN MARKING.
GORE MARKING AND CHANNELIZING LINES	8 (200) WITH 12 (300) DIAGONALS @ 45°	SOLID	WHITE	DIAGONALS: 15' (4.5 m) C-C (LESS THAN 30MPH (50 km/h)) 20' (6 m) C-C 30MPH (50 km/h) TO 45MPH (70 km/h)) 30' (9 m) C-C (OVER 45MPH (70 km/h))
RAILROAD CROSSING	24 (600) TRANSVERSE LINES; "RR" IS 6' (1.8 m) LETTERS; 16 (400) LINE FOR "X"	SOLID	WHITE	SEE STATE STANDARD 780001 AREA OF: "R"=3.6 SQ. FT. (0.33 m ²) EACH "X"=54.0 SQ. FT. (5.0 m ²)
SHOULDER DIAGONALS	12 (300) @ 45°	SOLID	WHITE - RIGHT YELLOW - LEFT	50' (15 m) C-C (LESS THAN 30MPH (50 km/h)) 75' (25 m) C-C (30 MPH (50 km/h) TO 45MPH (70 km/h)) 150' (45 m) C-C (OVER 45MPH (70 km/h))


FOR FURTHER DETAILS ON PAVEMENT MARKING REFER TO STANDARD SPECIFICATIONS FOR ROAD AND BRIDGE CONSTRUCTION AND STATE STANDARD 780001.


All dimensions are in inches (millimeters) unless otherwise shown.


FILE NAME =	USER NAME = gorengautab	DESIGNED - EVERS	REVISED -T. RAMMACHER 10-27-94
c:\pw_work\PWIDOT\GORENGAUTAB\dØ119364\	DistStd.dgn	DRAWN -	REVISED -A. HOUSEH 10-09-96
	PLOT SCALE = 50.0000 '/ IN.	CHECKED -	REVISED -A. HOUSEH 10-17-96
·	PLOT DATE = 2/13/2009	DATE - 03-19-90	REVISED -T. RAMMACHER 01-06-00

STATE	OF	ILLINOIS
DEPARTMENT	OF 1	TRANSPORTATION


DISTRICT ONE							F.A.P. RTE.	SECTION	COUNTY	TOTAL SHEETS	SHEET NO.	
TYPICAL PAVEMENT MARKINGS						334	111 RS - 7	MC HENRY	20	16		
ITPICAL PAVENICIVI MARKINGS							TC-13	CONTRACT	NO. 1	60D41		
SCALE: NONE	SHEET NO.	1 OF	1 SHEETS	STA.	6+60	TO STA.	66+46	FED. ROAD DIST. NO. 1 ILLINOIS FED. AID PROJECT				

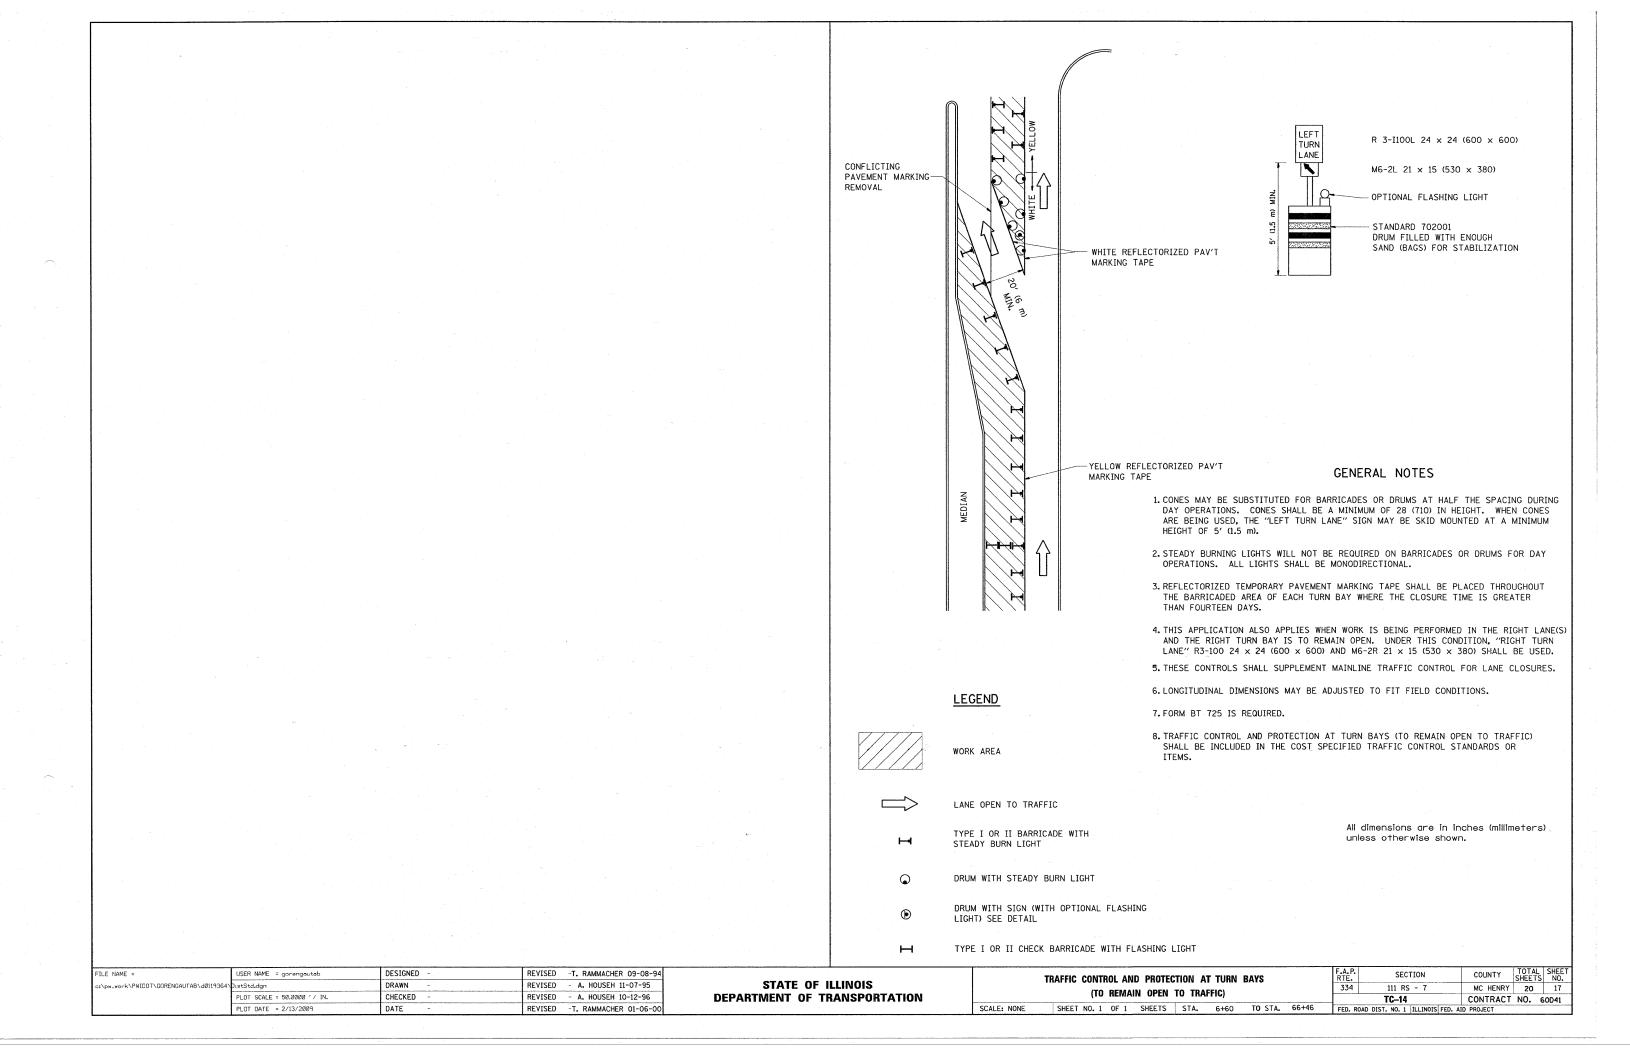

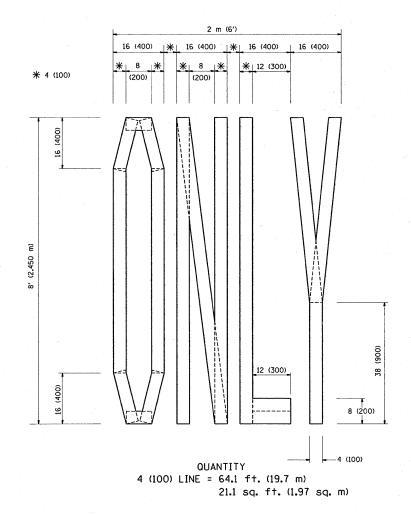

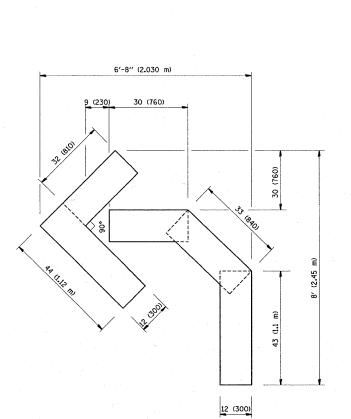

OUANTITY 4 (100) LINE = 45.5 ft. (13.9 m) 15.2 sq. ft. (1.39 sq. m)

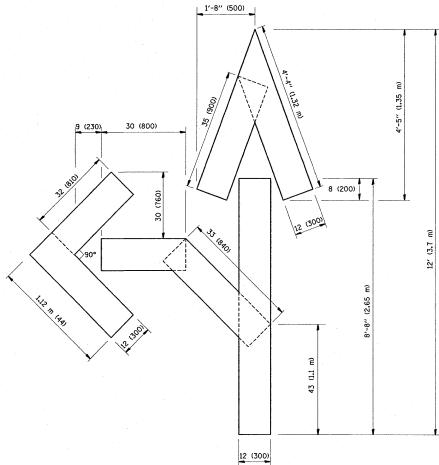


OUANTITY
4 (100) LINE = 82.5 ft. (25.3 m)
27.5 sq. ft. (2.53 sq. m)

All dimensions are in inches (millimeters) unless otherwise shown.

FILE NAME =	USER NAME = gorengautab	DESIGNED ~	REVISED -T. RAMMACHER 06-05-96	
c:\pw_work\PWIDOT\GORENGAUTAB\dØ119364\	DistStd.dgn	DRAWN -	REVISED -T. RAMMACHER 11-04-97	STATE OF ILLINOIS
	PLOT SCALE = 50.0000 '/ IN.	CHECKED -	REVISED -T. RAMMACHER 03-02-98	DEPARTMENT OF TRANSPORTATION
	PLOT DATE = 2/13/2009	DATE - 09-18-94	REVISED - E. GOMEZ 08-28-00	

OTATE OF HUMOIO	PAVEMENT MARKING LETTERS AND SYMBOLS						F.A.P. RTE.	SECTION	COÚNTY	TOTAL SHEETS	SHEET NO.	
STATE OF ILLINOIS DEPARTMENT OF TRANSPORTATION	FOR TRAFFIC STAGING					334	111 RS - 7	MC HENRY	20	18		
DEFARINCENT OF TRANSPORTATION	SCALE: NONE	SHEET NO. 1 OF 1	SHEETS	STA.	6+60	TO STA.	66+46	FED. ROAD	TC-16 DIST. NO. 1 ILLINOIS FED. A	CONTRACT ID PROJECT	NO. 6	OD41

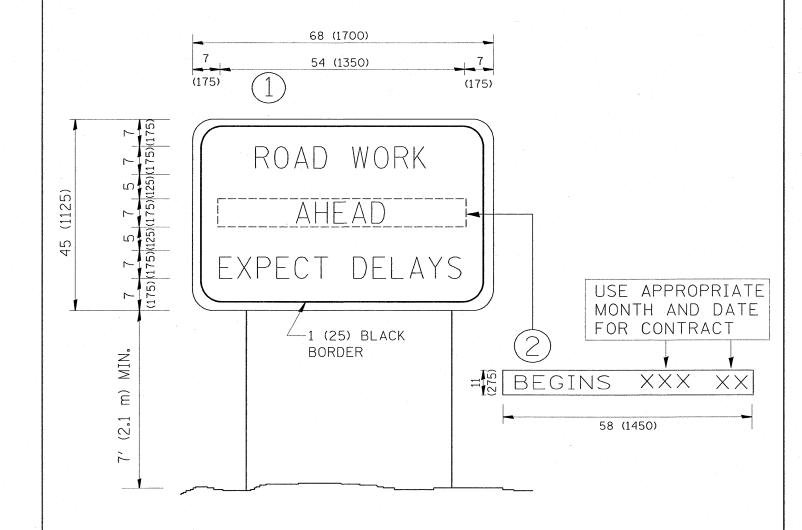


NOTES:

- 1. USE BLACK LETTERING ON ORANGE BACKGROUND.
- 2. ERECT SIGNS IN ADVANCE OF THE LOCATION FOR THE "ROAD CONSTRUCTION AHEAD" SIGN AT LOCATIONS AS DIRECTED BY THE ENGINEER.
- 3. ERECT SIGN (1) WITH INSTALLED PANEL (2) ONE WEEK PRIOR TO THE START OF CONSTRUCTION.
- 4. REMOVE PANEL (2) SOON AFTER THE START OF CONSTRUCTION.
- 5. SEE SPECIAL PROVISION FOR "TEMPORARY INFORMATION SIGNING" FOR ADDITIONAL INFORMATION.
- 6. ONE SIGN ASSEMBLY EQUALS 25.70 SQ. FT. (2.3 SQ. M.)
- 7. SHALL BE PAID FOR AS TEMPORARY INFORMATION SIGNING.

FILE NAME =	USER NAME = gorengautab	DESIGNED -	REVISED - R. MIRS 09-15-97		ARTERIAL ROAD	F.A.P. SECTION COUNTY TOTAL SHEET NO.
c:\pw_work\PWIDOT\GORENGAUTAB\dØ119364\	DistStd.dgn	DRAWN -	REVISED - R. MIRS 12-11-97	STATE OF ILLINOIS		334 111 RS - 7 MC HENRY 20 19
	PLOT SCALE = 50.0000 '/ IN.	CHECKED -	REVISED -T. RAMMACHER 02-02-99	DEPARTMENT OF TRANSPORTATION	INFORMATION SIGN	TC-22 CONTRACT NO. 60D41
	PLOT DATE = 2/13/2009	DATE -	REVISED - C. JUCIUS 01-31-07		SCALE: NONE SHEET NO. 1 OF 1 SHEETS STA. 6+60 TO STA.66+46	FED. ROAD DIST. NO. 1 ILLINOIS FED. AID PROJECT

LOOPS NEXT TO SHOULDERS

PROVIDE A PAVEMENT REPLACEMENT NOTE WHICH SHOULD EQUAL 3' (900 mm) X WIDTH OF PAVED SHOULDER.

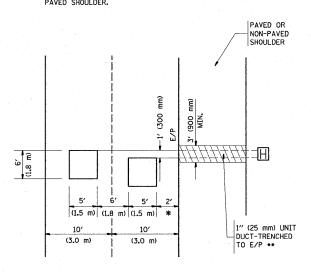


* = (600 mm)

* * UNIT DUCT IS TO BE SHOWN ON PLAN SHEETS BUT SHALL NOT BE INCLUDED IN THE PAY ITEMS.

LEFT TURN LANES WITH MEDIANS VOLUME DENSITY ("FAR OUT" DETECTION) ON SAME APPROACH

(PROTECTED / PERMITTED LEFT TURN PHASING)

HANDHOLE LOCATION MAY VARY DEPENDING ON GEOMETRICS AND DESIGN OF TRAFFIC SIGNALS. HEAVY-DUTY HANDHOLES TO BE USEO WHEN THE MEDIAN IS MOUNTABLE. REFER TO STANDARD 814001 TO ENSURE THAT HANDHOLE FITS IN MEDIAN.

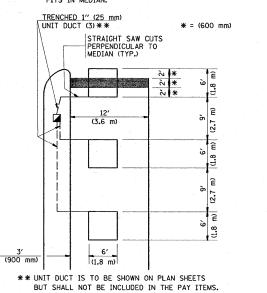


NOTE: DUAL LEFT TURNS NOT SHOWN REFER TO

PLAN SHEET FOR DETECTOR LOOP REPLACEMENT

LEFT TURN LANES WITHOUT MEDIANS
VOLUME DENSITY ("FAR OUT" DETECTION)
ON SAME APPROACH

(PROTECTED / PERMITTED LEFT TURN PHASING)

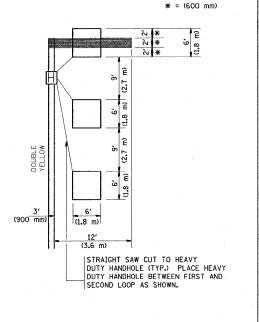


NOTE: DUAL LEFT TURNS NOT SHOWN REFER TO PLAN SHEET FOR DETECTOR LOOP REPLACEMENT


SCALE: NONE

SHE

ARTERIAL-VOLUME DENSITY ("FAR OUT" DETECTION)
CROSS STREET-VOLUME DENSITY ("FAR OUT" DETECTION)

ARTERIAL-VOLUME DENSITY ("FAR OUT" DETECTION)
CROSS STREET-NON VOLUME DENSITY ("UPTIGHT" PRESENCE DETECTION)

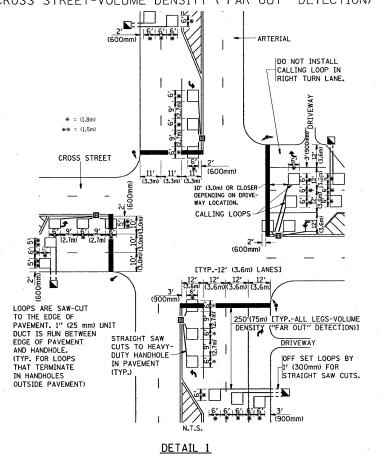

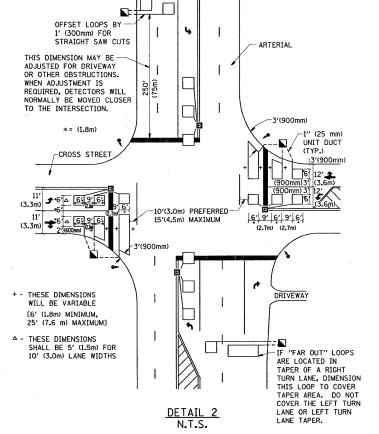

NOTES:

VEHICLES LOOP DETECTORS

- * ALL LEAD IN CABLE SHALL BE TWO CONDUCTOR NO. 14 TWISTED, SHIELDED.
- * EACH DETECTOR LOOP SHALL HAVE ITS OWN SAW CUT FROM THE LOOP TO THE EDGE OF PAVEMENT OR TO A HANDHOLE IN THE PAVEMENT.
- * EACH DETECTOR LOOP SHALL HAVE ITS OWN ONE INCH (25 mm) UNIT DUCT BETWEEN THE EDGE OF PAVEMENT AND THE FIRST HANDHOLE OR JUNCTION BOX. EACH UNIT DUCT RUN SHALL BE SHOWN ON THE PLANS BY THE DESIGNER, BUT SHALL NOT BE PAID FOR SEPARATLY. THIS ITEM IS INCIDENTAL TO THE PAY ITEM FOR DETECTOR LOOPS.
- * ONE DIMENSION OF <u>ALL</u> DETECTOR LOOPS SHALL BE SIX FEET (1.8 m)
- * EACH LANE OF NON-LOCKING, PRESENCE DETECTION AND EACH LANE OF A DOUBLE LEFT TURN LANE REQUIRES A SEPARATE INDUCTIVE LOOP DETECTOR AND LEAD IN CABLE.
- * WHEN NON-LOCKING, PRESENCE DETECTION IS USED, MORE THAN ONE LOOP PER LANE IS REQUIRED BEHIND THE STOP BAR (i.e. 1-1/2, 1-3/4, 2).
- * WHEN SYSTEM LOOPS ARE REQUIRED ON AN APPROACH OF AN INTERSECTION, THE LOOPS USED FOR VOLUME DENSITY AND INTERSECTION TIMING SHALL ALSO BE USED AS SYSTEM DETECTORS. EACH ONE OF THESE TYPE OF LOOPS REQUIRES A SEPARATE TWO CONDUCTOR NO. 14 TWISTED SHIELDED CABLE AND A SEPARATE INDUCTIVE LOOP DETECTOR WHEN NEW CONTROLLERS ARE UTILIZED. THE DESIGNER SHALL LABEL THESE TYPES OF LOOPS AS "INTERSECTION AND SAMPLING (SYSTEM) DETECTORS" ON THE SIGNAL LAYOUT, THE INTERCONNECT PLAN AND THE SYSTEM CABLE PLAN. WHEN AN EXISTING CONTROLLER IS UTILIZED FOR THIS TYPE OF DETECTION, THE PAY ITEM "INDUCTIVE LOOP DETECTOR WITH SYSTEM OUTPUT" SHOULD BE USED.

PLACEMENT OF DETECTORS

THE FOLLOWING FIGURES REPRESENT THE MOST COMMON DETECTOR LOOP LOCATIONS AND SIZES. ADJUSTMENTS WILL BE NECESSARY FOR SPECIFIC GEOMETRIC CONSIDERATIONS.

LOCATIONS AND DEMENSIONS OF DETECTOR LOOPS ARE REQUIRED ON <u>ALL</u> SIGNAL LAYOUT PLAN SHEETS.

"FAR OUT" DETECTION REFERS TO LOCKING, PRESENCE TYPE DETECTION LOCATED IN THRU LANES, RIGHT TURN LANES, AND RIGHT TURN LANE TAPER AREAS (IF APPLICABLE), USUALLY 250' (75 m) IN ADVANCE OF STOP BARS. "UPTIGHT" DETECTION REFERS TO NON-LOCKING PRESENCE TYPE DETECTION LOCATED IN ALL LANES AND 10'-15' (3.0 m-4.5 m) BEHIND THE CROSSING STREET'S EDGE OF PAVEMENT EXTENDED.

NOTE:

ALL DETAILS AND NOTES SHOWN ARE FROM THE I.D.O.T. DISTRICT 1
TRAFFIC SIGNAL DESIGN GUIDELINES DATED JANUARY 1995

THIS DRAWING HAS BEEN PREPARED TO ASSIST THE RESIDENT ENGINEER FOR ALL ROADWAY RESURFACING OR S.M.A.R.T. PROJECTS WHERE THE DIMENSIONS ARE NOT SHOWN ON THE PLANS AND THE FINAL LOCATIONS FOR CROSSWALKS OR STOP BARS ARE NOT DETERMINED.

	N.T.	S	
FILE NAME =	USER NAME = gorengautab	DESIGNED -	REVISED -
;\pw_work\PWIDOT\GORENGAUTAB\dØ119364\	DistStd.dgn	DRAWN -	REVISED -
	PLOT SCALE = 50.0000 '/ IN.	CHECKED - R.K.F.	REVISED -
	PLOT DATE = 2/13/2009	DATE -	REVISED -

STATE OF ILLINOIS
DEPARTMENT OF TRANSPORTATION

DISTRICT 1 - DETECTOR LOOP INSTALLATION	F.A.P. RTE.	SECTION	COUNTY	TOTAL	SHEE NO.
DETAILS FOR ROADWAY RESURFACING	334	111 RS - 7	MC HENRY	20	20
DETAILS FOR HUADANAL BESONEACHING		TS-07	CONTRACT	NO. 6	0D41
EET NO. 1 OF 1 SHEETS STA. 6+60 TO STA. 66+46	FED. RO	AD DIST. NO. 1 ILLINOIS FED. A	ID PROJECT		