$\bigcirc$ 

0

### 04-24-2020 LETTING ITEM 021

FOR INDEX OF SHEETS, SEE SHEET NO. 2

FOR LIST OF HIGHWAY STANDARDS, SEE SHEET NO. 2

PROJECT IS LOCATED IN THE VILLAGES OF BOLINGBROOK AND BURR RIDGE

### TRAFFIC DATA:

### INTERSTATE 55

S.N. 099-0260 2018 ADT = 133,600 S.N. 099-0028 2018 ADT = 122,900 S.N. 022-0003 2018 ADT = 168,700

**DESIGN CLASSIFICATION = INTERSTATE (I-55) (URBAN)** 

DESIGN SPEED = 60 MPH (ASSUMED)


POSTED SPEED = 55 MPH

# STATE OF ILLINOIS DEPARTMENT OF TRANSPORTATION

# PROPOSED HIGHWAY PLANS


FAI ROUTE 55 OVER IL-53, JOLIET RD AND S. MADISON ST SECTION: 2019-177-BR BRIDGE DECK REPAIRS AND SHOULDER RECONSTRUCTION DUPAGE AND WILL COUNTIES

C-91-143-20

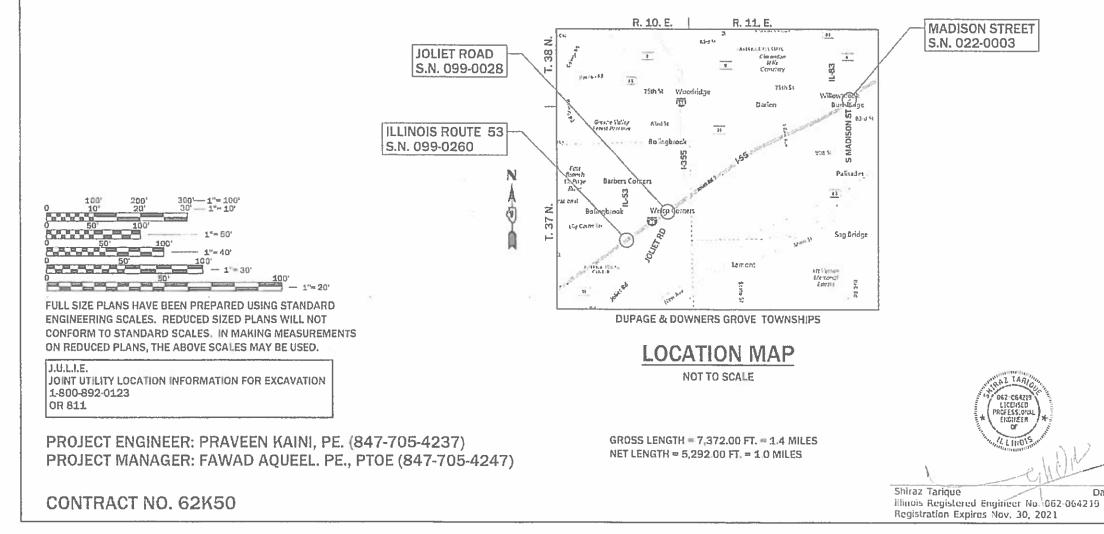

0

0

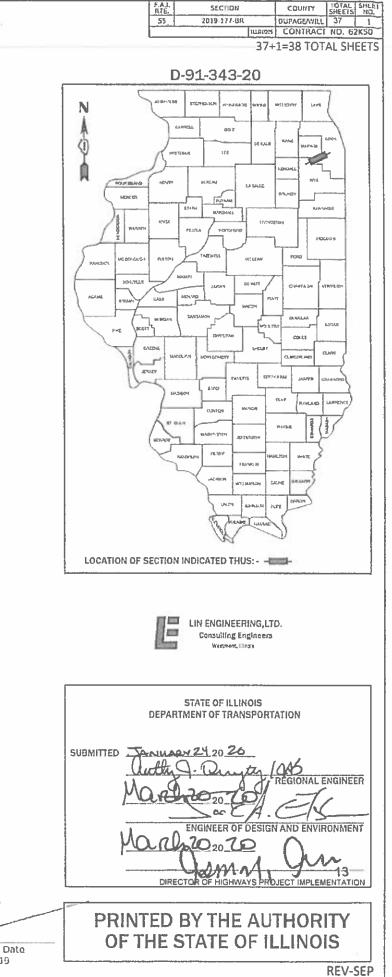

#### **INDEX OF SHEETS**

- COVER SHEET
- INDEX, HIGHWAY STANDARDS & GENERAL NOTES
- 3 7 SUMMARY OF QUANTITIES
- 8 10 SCHEDULES OF QUANTITIES
- 11 12 TYPICAL SECTIONS
- 13 17 STAGING PLAN
- 18 20 ROADWAY PLANS
- 21 27 STRUCTURAL SHEETS
- 28 38 DISTRICT ONE STANDARDS

#### **HIGHWAY STANDARDS**

- 000001-07 STANDARD SYMBOLS, ABBREVIATIONS AND PATTERNS
- 001006 DECIMAL OF AN INCH AND OF A FOOT
- TEMPORARY EROSION CONTROL SYSTEMS 280001-07
- SHOULDER RUMBLE STRIPS, 16 IN. 642001-02
- PIPE UNDERDRAINS 601001-05
- CONCRETE HEADWALL FOR PIPE UNDERDRAIN 601101-02 701106-02 OFF RD OPERATIONS, MULTILANE, MORE THAN 15 (4.5 M) AWAY
- APPROACH TO LANE CLOSURE, FREEWAY/EXPRESSWAY 701400-09
- 701401-12 LANE CLOSURE, FREEWAY/EXPRESSWAY
- LANE CLOSURE, MULTILANE, AT ENTRANCE OR EXIT RAMP, FOR SPEEDS  $\geq$  45 MPH 701411-09
- 701428-01 TRAFFIC CONTROL SETUP AND REMOVAL FREEWAY/EXPRESSWAY
- 701446-10 TWO LANE CLOSURE, FREEWAY / EXPRESSWAY
- 701501-06 URBAN LANE CLOSURE 2L, 2W, UNDIVIDED
- 701601-09 URBAN LANE CLOSURE MULTILANE, 1W OR 2W WITH NONTRAVERSABLE MEDIAN
- 701701-10 URBAN LANE CLOSURE MULTILANE INTERSECTION
- 701901-08 TRAFFIC CONTROL DEVICES
- 704001-08 TEMPORARY CONCRETE BARRIER
- 780001-05 TYPICAL PAVEMENT MARKINGS
- TYPICAL APPLICATIONS RAISED REFLECTIVE PAVEMENT MARKERS 781001-04
- GUARDRATE AND BARRIER WALL REFLECTOR MOUNTING DETAILS 782006-01

#### **DISTRICT STANDARDS**

- TC-08 ENTRANCE AND EXIT RAMP CLOSURE DETAILS
- ТС-09 ТС-10 TRAFFIC CONTROL DETAILS FOR FREEWAY SINGLE & MULTI-LANE WEAVE
- TRAFFIC CONTROL AND PROTECTION FOR SIDE ROADS, INTERSECTIONS, AND DRIVEWAYS
- TYPICAL APPLICATIONS RAISED REFLECTIVE PAVEMENT MARKERS (SNOW-PLOW RESISTANT) TC-11
- TC-12 MULTI-LANE FREEWAY PAVEMENT MARKING DETAILS
- TC-13 DISTRICT ONE TYPICAL PAVEMENT MARKINGS
- TRAFFIC CONTROL AND PROTECTION AT TURN BAYS (TO REMAIN OPEN TO TRAFFIC) TC-14 TC-17 TRAFFIC CONTROL DETAILS FOR FREEWAY SHOULDER CLOSURES AND PARTIAL RAME
- CLOSURES FREEWAY/EXPRESSWAY SIGNING FOR FLAGGING OPERATIONS AT WORK TC-18 ZONE OPENINGS ON FREEWAYS/EXPRESSWAYS
- TC-22 ARTERIAL ROAD INFORMATION SIGN

**GENERAL NOTES** 

THE THICKNESS OF HMA SHOWN ON THE PLANS IS THE NOMINAL THICKNESS. DEVIATIONS FROM THE NOMINAL THICKNESS WILL BE PERMITTED WHEN SUCH DEVIATIONS OCCUR DUE TO IRREGULARITIES IN THE EXISTING SURFACE OR BASE ON WHICH THE HMA IS PLACED.

SEEDING WILL NOT BE PERMITTED AT ANY TIME WHEN THE GROUND IS FROZEN, WET, OR IN AN UNTILLABLE CONDITION. LOCATIONS TO BE SEEDED WILL BE DETERMINED BY THE ENGINEER.

ANY REFERENCE TO A STANDARD IN THESE PLANS SHALL BE INTERPRETED TO MEAN THE EDITION AS INDICATED BY THE SUBNUMBER SHOWN IN THE LIST OF STANDARDS OR THE COPY INCLUDED IN THESE DIANS

THE CONTRACTOR SHALL CALL "J.U.L.I.E" AT (800) 892-0123 OR 811 AT LEAST 48 HOURS PRIOR TO EXCAVATION TO DETERMINE WHICH BURIED ELECTRIC, TELEPHONE, AND GAS UTILITIES ARE IN THE AREA. 48 HOUR NOTIFICATION IS REQUIRED.

BEFORE BEGINNING ANY WORK, THE CONTRACTOR SHALL RETAIN AND RECORD FOR FUTURE REFERENCE, ALL EXISTING PAVEMENT MARKING LINES AND RAISED REFLECTIVE PAVEMENT MARKERS THAT CONFLICT WITH TEMPORARY MARKINGS, IN ORDER THAT THESE LOCATIONS CAN BE RE-ESTABLISHED FOR PROPOSED STRIPING AT THE COMPLETION OF THIS CONTRACT. EXACT LOCATIONS OF ALL PROPOSED PAVEMENT MARKINGS SHALL BE DIRECTED BY THE RESIDENT ENGINEER.

THE CONTRACTOR WILL NOT BE ABLE TO SET UP A YARD OR FIELD OFFICE ON STATE PROPERTY WITHOUT WRITTEN PERMISSION FROM THE DEPARTMENT.

ALL PAVEMENT PATCHING LOCATIONS SHALL BE AS SHOWN IN THE PLANS OR AS DETERMINED BY THE ENGINEER

IT SHALL BE THE CONTRACTORS RESPONSIBILITY TO VERIFY ALL DIMENSIONS AND CONDITIONS EXISTING IN THE FIELD PRIOR TO CONSTRUCTION AND ORDERING MATERIALS

ALL DAMAGE TO EXISTING PAVEMENT MARKINGS OR RAISED REFLECTIVE PAVEMENT MARKERS OUTSIDE THE REMOVAL LINE SHOWN ON THE PLANS SHALL BE REPLACED AT NO ADDITIONAL COST TO THE DEPARTMENT.

THE CONTRACTOR SHALL COORDINATE CONSTRUCTION ACTIVITIES WITH AFFECTED UTILITY COMPANIES AND THE VILLAGES OF BOLINGBROOK AND WILLOWBROOK

THE CONTRACTOR SHALL CONTRACT THE DISTRICT ONE TRAFFIC CONTROL SUPERVISOR FOR ARTERIALS AT KALPANA KANNAN-HOSADURGA@ILLINOIS.GOV AT LEAST 72 HOURS BEFORE BEGINNING WORK.

THE CONTRACTOR SHALL MAINTIAN ALL ROADWAYS OPEN TO TRAFFIC AS SHOWN ON THE MAINTENANCE OF TRAFFIC PLANS.

THE CONTRACTOR SHALL USE CARE IN GRADING OR EXCAVATING NEAR ANY AND ALL EXISTING ITEMS THAT WILL NOT BE REMOVED ANY DAMAGE DONE TO EXISTING ITEMS BY THE CONTRACTOR SHALL BE REPAIRED OR REPLACED TO THE SATISFACTION OF THE ENGINEER AT THE CONTRACTOR'S OWN EXPENSE

DO NOT SCALE PLANS FOR CONSTRUCTION DIMENSIONS.

DURING CONSTRUCTION OPERATIONS, IF ANY LOOSE MATERIAL IS DEPOSITED IN THE FLOW LINE OF DRAINAGE STRUCTURES SUCH THAT THE NATURAL FLOW OF WATER IS OBSTRUCTED, THE MATERIAL SHALL BE REMOVED AT THE CLOSE OF EACH WORKDAY. AT THE CONCLUSION OF CONSTRUCTION OPERATIONS, ALL UTILITY STRUCTURES SHALL BE FREE FROM DUST AND DEBRIS. THE WORK SPECIFIED ABOVE WILL NOT BE PAID SEPARATELY BUT SHALL BE INCLUDED IN THE COST OF THE CONTRACT.

PERMANENT PAVEMENT MARKINGS SHALL BE AS SPECIFIED IN THE PLANS AND SHALL BE PLACED IN ACCORDANCE WITH THE "DISTRICT ONE TYPICAL PAVEMENT MARKINGS" DETAILS. (TC-13 AND TC-12).

THE SUBGRADE STABILITY SHALL BE VERIFIED BY PROOF ROLLING WITH A FULLY LOADED TANDEM-AXLE TRUCK.

GEOTECHNICAL FABRIC FOR GROUND STABILIZATION AND/OR AGGREGATE SUBGRADE IMPROVEMENT (CU YD) HAVE BEEN PROVIDED FOR USE AT THE LOCATIONS INDICATED FOR SOILS THAT TEND TO BE UNSTABLE AND/OR UNSUITABLE THE ACTUAL NEED FOR REMOVAL AND REPLACEMENT WITH ABOVE ITEM WILL BE DETERMINED IN THE FIELD AT THE TIME OF CONSTRUCTION BY THE GEOTECHNICAL ENGINEER. ALL POTENTIALLY UNSTABLE SOILS SHOULD BE TESTED WITH A STATIC OR DYNAMIC CONE PENETROMETER AND TREATED IN ACCORDANCE WITH ARTICLE 301.04 OF THE SSRBC AND IDOT SUBGRADE STABILITY MANUAL. IF UNSTABLE AND/OR UNSUITABLE SOILS ARE NOT ENCOUNTERED, THEN THE QUANTITY SHALL BE DEDUCTED AND NO ADDITIONAL COMPENSATION WILL BE DUE TO THE CONTRACTOR.

ANY AGGREGATE SUBGRADE IMPROVEMENT CONTAMINATED AND/OR DAMAGED BY THE CONTRACTOR'S VEHICLES AND/OR EQUIPMENTS IS TO BE REMOVED AND REPLACED AS DIRECT BY THE ENGINEER AT CONTRACTOR EXPENSE

PIPE UNDERDRAINS SHALL BE INSTALLED ACCORDING TO SECTION 601 OF THE SSRBC AND STANDARD 601001-05. TOP OF PIPE UNDERDRAINS SHALL BE PLACED MINIMUM 6" BELOW THE AGGREGATE SUBGRADE IMPROVEMENT LAYER. THE COST OF MAKING PIPE UNDERDRAINS CONNECTIONS TO DRAINAGE STRUCTURES SHALL BE INCLUDED IN THE COST OF THE PIPE UNDERDRAINS.

		DESIGNED - NH REVISED -			F.A.I. ROUTE 55 (I-55)	F.A.I. BTE	SECTION	COUNTY TOTAL	SHEET
Consulting Engineers		DRAWN - NH	REVISED -	STATE OF ILLINOIS	INDEX, HIGHWAY STANDARDS & GENERAL NOTES		2019-177-BR	DUPAGE/WILL 37	2
Westmont, Illinois	PLOT SCALE = 2.0000 / in.	CHECKED - ST	REVISED -	DEPARTMENT OF TRANSPORTATION				CONTRACT NO. 62	2K50
westmont, names	PLOT DATE = 3/10/2020	DATE - 1/2020	REVISED -		SCALE: N.T.S. SHEET 1 OF 1 SHEETS STA. TO STA.		ILLINOIS FE	ED. AID PROJECT	

#### COMMITMENTS

NONE

HOT- MIX ASPHALT MIXTURE REQUIREMENTS									
MIXTURE TYPE AIR VOIDS QUALITY MANAGEMENT @ NDES PROGRAM (QMP)									
HOT-MIX ASPHALT SHOULDER, 15"									
HOT-MIX ASPHALT SURFACE COURSE, 2", MIX "D", N70, (IL-9.5) 4% @ 70 GYR. QC/QA									
HOT-MIX ASPHALT BINDER COURSE, 13", N70, (IL-19.0)	4% @ 70 GYR.	QC/QA							
FILLING EXISTING RUMBLE STRIP									
HOT-MIX ASPHALT SURFACE COURSE, 2", MIX "D", N70, (IL-9.5) 4% @ 70 GYR. QC/QA									
QMP DESIGNATION: QUALITY CONTROL/QUALITY ASSURANCE; QUA	LITY CONTROL FO	DR PERFORMANCE (QCP)							

### **MIXTURE TABLE NOTES**

SEEDING, CLASS 2

TEMPORARY EROS

NITROGEN FERTILI PHOSPHORUS FER

POTASSIUM FERTIL

GRANULAR MATER

MULCH SHORT TERM PAVE

1. THE UNIT WEIGHT USED TO CALCUALTE ALL HOT-MIX ASPHALT SURFACE MIXTURE QUANTITIES IS 112 LBS/SQYD/IN.

- 2. THE AC TYPE FOR POLYMERIZED HMA MIXES SHALL BE "SBS/SBR PG 76-22" AND FOR NON-POLYMERIZED HMA THE AC TYPE SHALL BE "PG 64-22" UNLESS MODIFIED
- BY DISTRICT ONE SPECIAL PROVISIONS
- 3. FOR USE OF RECYCLED MATERIALS SEE SPECIAL PROVISIONS.
- 4. OUALITY MANAGEMENT PROGRAM (OMP) IDENTIFIES THE PARTICULAR
- CONTROL SPECIFICATION THAT APPLIES TO THE HMA MIXTURE.

FACTORS FOR ESTIMATING PLAN QUANTITIES ARE AS FOLLOWS AND SHALL NOT BE USED FOR THE BASIS OF FINAL QUANTITIES

	200 LB/ACRE
ION CONTROL SEEDING	100 LB/ACRE
ZER NUTRIENT	90 LB/ACRE
TILIZER NUTRIENT	90 LB/ACRE
IZER NUTRIENT	90 LB/ACRE
	2 TON/ACRE
EMENT MARKING	10 FT/100 FT
IAL	2.05 TONS/CU YD

					CONSTRUCTION CODE	E
				100% STATE	100% STATE	100% STATE
0005			TOTAL	ROADWAY	SN 099-0260	SN 099-002
CODE NO .	ITEM	UNIT	TOTAL QUANTITY	0004	0047	0047
				URBAN	URBAN	URBAN
20101400	NITROGEN FERTILIZER NUTRIENT	POUND	45	45		
20101500	PHOSPHORUS FERTILIZER NUTRIENT	POUND	45	45		
20101600	POTASSIUM FERTILIZER NUTRIENT	POUND	45	45		
20200100	EARTH EXCAVATION	CU YD	8,155	8,155		
21001000	GEOTECHNICAL FABRIC FOR GROUND STABILIZATION	SQ YD	1,087	1,087		
25000210	SEEDING, CLASS 2A	ACRE	0.50	0.50		
25100630	EROSION CONTROL BLANKET	SQ YD	1,627	1,627		
30300001	AGGREGATE SUBGRADE IMPROVEMENT	CU YD	3,625	3,625		
40600275	BITUMINOUS MATERIALS (PRIME COAT)	POUND	24,465	24,465		
40600290	BITUMINOUS MATERIALS (TACK COAT)	POUND	7,340	7,340		
40000290		r ound	7,540	7,540		
44004250	PAVED SHOULDER REMOVAL	SQ YD	10,874	10,874		
48203057	HMA SHOULDERS, 15"	SQ YD	10,874	10,874		
60100060	CONCRETE HEADWALLS FOR PIPE DRAINS	ЕАСН	28	28		
60108200	PIPE UNDERDRAINS 6"(SPECIAL)	FOOT	840	840		
60108206	PIPE UNDERRAINS TYPE 2, 6"	FOOT	8 , 500	8,500		<u> </u>

LIN ENGINEERING.LTD.	USER NAME = rober	DESIGNED - NH	REVISED _		F.A.I. ROUTE 55 (I-55)	F.A.I. RTE.	SECTION	COUNTY TOTAL SHEET NO.
Consulting Engineers		DRAWN - NH	REVISED -	STATE OF ILLINOIS	SUMMARY OF QUANTITIES	55	2019-177-BR	DUPAGE/WILL 37 3
Westmont, Illinois	PLOT SCALE = 2.0000 ' / in.	CHECKED - ST	REVISED -	DEPARTMENT OF TRANSPORTATION	SUMMART OF QUANTITIES			CONTRACT NO. 62K50
westmont, minois	PLOT DATE = 2/7/2020	DATE - 1/2020	REVISED -	S	SCALE: N.T.S. SHEET 1 OF 5 SHEETS STA. TO STA.		ILLINOIS FE	ED. AID PROJECT

					CONSTRUCTION COD	1
				100% STATE	100% STATE	100% STATE
CODE NO .	ITEM	UNIT	TOTAL QUANTITY	ROADWAY 0004 URBAN	SN 099-0260 0047 URBAN	SN 099-0028 0047 URBAN
63301210	REMOVE AND REERECT STEEL PLATE BEAM GUARDRAIL, TYPE A	FOOT	2,137.5	2,137.5		
63301990	REMOVE AND REERECT TRAFFIC BARRIER TERMINALS, TYPE 1	EACH	6	6		
63302000	REMOVE AND REERECT TRAFFIC BARRIER TERMINALS, TYPE 2	EACH	4	4		
63302720	REMOVE AND REERECT TRAFFIC BARRIER TERMINALS, TYPE 6B	EACH	3	3		
63302905	REMOVE AND REERECT TRAFFIC BARRIER TERMINALS, TYPE 10	EACH	6	6		
63800920	MODULAR GLARE SCREEN SYSTEM, TEMPORARY	FOOT	6,650.0	6,650.0		
64200116	SHOULDER RUMBLE STRIPS, 16 INCH	FOOT	8,499	8,499		
66900200	NON-SPECIAL WASTE DISPOSAL	CU YD	4,630	4,630		
66900530	SOIL DISPOSAL ANALYSIS	EACH	6	6		
66901001	REGULATED SUBSTANCES PRE-CONSTRUCTION PLAN	L SUM	1	1		
66901003	REGULATED SUBSTANCES FINAL CONSTRUCTION REPORT	L SUM	1	1		
66901006	REGULATED SUBSTANCES MONITORING	CAL DA	12	12		
67000400	ENGINEER'S FIELD OFFICE, TYPE A	CAL MO	12	12		
67100100	MOBILIZATION	L SUM	1	1		

LIN ENGINEERING.LTD.	USER NAME = rober	DESIGNED - NH	REVISED -		F.A.I. ROUTE 55 (I-55)	F.A.I. RTE.	SECTION	COUNTY TOTAL SHEET SHEETS NO.	
Consulting Engineers		DRAWN - NH	REVISED -	STATE OF ILLINOIS	SUMMARY OF QUANTITIES		55	2019-177-BR	DUPAGE/WILL 37 4
Westmont, Illinois	PLOT SCALE = 2.0000 ' / in. PLOT DATE = 2/7/2020	CHECKED - ST DATE - 1/2020	REVISED - REVISED -	DEPARTMENT OF TRANSPORTATION	SCALE: N.T.S. SHEET 2 OF 5 SHEETS STA.	TO STA.			CONTRACT NO. 62K50
				_ DEPARTMENT OF TRANSPORTATION				ILLINOIS   FED	). AID

			CONSTRUCTION CODE				
			100% STATE	100% STATE	100% STATE		
		τοται	ROADWAY	SN 099-0260	SN 099-0028		
ITEM	UNIT	QUANTITY	0004	0047	0047		
			URBAN	URBAN	URBAN		
TRAFFIC CONTROL AND PROTECTION, STANDARD 701501	L SUM	1	1				
TRAFFIC CONTROL AND PROTECTION, STANDARD 701601	L SUM	1	1				
		1	1				
			1				
CHANGEABLE MESSAGE SIGN	CAL DA	300	300				
SHORT TERM PAVEMENT MARKING	FOOT	3,300	3,300				
CHORT TERM DAVEMENT MARKING REMOVAL	SO ET	12 100	12 100				
		12,100	12,100				
PAVEMENT MARKING TAPE, TYPE IV 4"	FOOT	22,399	22,399				
PAVEMENT MARKING TAPE, TYPE IV 5"	FOOT	6,223	6,223				
PAVEMENT MARKING TAPE TYPE IV 8"	FOOT	4 377	4 377				
PAVEMENT MARKING TAPE , TYPE IV , 12"	FOOT						
TEMPORARY CONCRETE BARRIER	FOOT	10,487.5	10,487.5				
IMPACT ATTENUATORS, TEMPORARY (FULLY REDIRECTIVE, NARROW), TEST LEVEL 3	EACH	6	6				
THERMOPLASTIC PAVEMENT MARKING - LINE 4"	FOOT	21,488	21,488				
THERMOPLASTIC PAVEMENT MARKING - LINE 8"	FOOT	1,605	1,605				
THERMOPLASTIC PAVEMENT MARKING - LINE 12"	FOOT	236	236				
	TRAFFIC CONTROL AND PROTECTION, STANDARD 701501  TRAFFIC CONTROL AND PROTECTION, STANDARD 701601  TRAFFIC CONTROL AND PROTECTION, STANDARD 701701  CHANGEABLE MESSAGE SIGN  SHORT TERM PAVEMENT MARKING REMOVAL  PAVEMENT MARKING TAPE, TYPE IV 4*  PAVEMENT MARKING TAPE, TYPE IV 4*  PAVEMENT MARKING TAPE, TYPE IV 5*  PAVEMENT MARKING TAPE, TYPE IV 8* PAVEMENT MARKING TAPE, TYPE IV 8* PAVEMENT MARKING TAPE, TYPE IV 8* PAVEMENT MARKING TAPE, TYPE IV 12* TEMPORARY CONCRETE BARRIER  IMPACT ATTENUATORS, TEMPORARY (FULLY REDIRECTIVE, NARROW), TEST LEVEL 3  THERMOPLASTIC PAVEMENT MARKING - LINE 4*	Image: State of the state o	Image: Control and PROTECTION, STANDARD 701501Image: Control and PROTECTION, STANDARD 701501Image: Control and PROTECTION, STANDARD 701601Image: Control and PROTECTION, STANDARD 701601Image: Control and PROTECTION, STANDARD 701701Image: Control and Protection, Standard 701701 <td>TESMUNITQUARTITYTRAFFIC CONTROL AND PROTECTION, STANDARD 701501L SUM11TRAFFIC CONTROL AND PROTECTION, STANDARD 701501L SUM11TRAFFIC CONTROL AND PROTECTION, STANDARD 701601L SUM11TRAFFIC CONTROL AND PROTECTION, STANDARD 701703L SUM11Charge LaborationL SUM111Charge LaborationL SUM111Short TERM PAVEMENT MARKING REMOVALStort12,10012,210Charge LaborationL SUM111PAVEMENT MARKING TAPE, TYPE IV 4*C C22,39922,399PAVEMENT MARKING TAPE, TYPE IV 5*FOOT6,2236,223Charge LaborationL SUM111PAVEMENT MARKING TAPE, TYPE IV 5*FOOT1,4374,377PAVEMENT MARKING TAPE,</td> <td>TEMOUNTITYOU</td>	TESMUNITQUARTITYTRAFFIC CONTROL AND PROTECTION, STANDARD 701501L SUM11TRAFFIC CONTROL AND PROTECTION, STANDARD 701501L SUM11TRAFFIC CONTROL AND PROTECTION, STANDARD 701601L SUM11TRAFFIC CONTROL AND PROTECTION, STANDARD 701703L SUM11Charge LaborationL SUM111Charge LaborationL SUM111Short TERM PAVEMENT MARKING REMOVALStort12,10012,210Charge LaborationL SUM111PAVEMENT MARKING TAPE, TYPE IV 4*C C22,39922,399PAVEMENT MARKING TAPE, TYPE IV 5*FOOT6,2236,223Charge LaborationL SUM111PAVEMENT MARKING TAPE, TYPE IV 5*FOOT1,4374,377PAVEMENT MARKING TAPE,	TEMOUNTITYOU		

LIN ENGINEERING.LTD.	USER NAME = rober		REVISED -	F.A.I. ROUTE 55 (I-55)		F.A.I. RTE.	SECTION	COUNTY TOTAL SHEET SHEETS NO.	
LIN ENGINEERING,LTD. Consulting Engineers		DRAWN - NH	REVISED -	STATE OF ILLINOIS	SUMMARY OF QUANTITIES		55	2019-177-BR	DUPAGE/WILL 37 5
Westmont, Illinois	PLOT SCALE = 2.0000 ' / in.	CHECKED - ST	REVISED -	DEPARTMENT OF TRANSPORTATION	SUMIMART OF QUANTITIES				CONTRACT NO. 62K50
	PLOT DATE = 2/7/2020	DATE - 1/2020	REVISED -		SCALE: N.T.S. SHEET 3 OF 5 SHEETS STA.	TO STA.		ILLINOIS FED.	AID PROJECT

			-		CONSTRUCTION CODE	<u> </u>
				100% STATE	100% STATE	100% STATE
CODE			TOTAL	ROADWAY	SN 099-0260	SN 099-0028
NO.	ITEM	UNIT	TOTAL QUANTITY	0004	0047	0047
				URBAN	URBAN	URBAN
7800312	PREFORMED PLASTIC PAVEMENT MARKING, TYPE B - LINE 5"	FOOT	5,667	5,667		
7800314	PREFORMED PLASTIC PAVEMENT MARKING, TYPE B - LINE 8"	FOOT	574	574		
7800900	MODIFIED URETHANE PAVEMENT MARKING - LINE 4"	FOOT	2,237	2,237		
7800901	MODIFIED URETHANE PAVEMENT MARKING - LINE 12"	FOOT	460	460		
7810010	RAISED REFLECTIVE PAVEMENT MARKER	EACH	1,239	1,239		
7820001	BARRIER WALL REFLECTORS, TYPE C	EACH	421	421		
78300200	RAISED REFLECTIVE PAVEMENT MARKER REMOVAL	EACH	1,239	1,239		
X032007	PROTECTIVE SHIELD REMOVAL	L SUM	1		1	
X032665	FILLING EXISTING RUMBLE STRIP	FOOT	12,446	12,446		
X0327980	PAVEMENT MARKING REMOVAL - WATER BLASTING	SQ FT	10,395	10,395		
X501730	PROTECTIVE SHIELD (PERMANENT)	SQ YD	2,085		2,085	
X603020	FRAMES AND GRATES TO BE ADJUSTED (SPECIAL)	EACH	4	4		
X701021	TRAFFIC CONTROL AND PROTECTION, (SPECIAL)	L SUM	1	1		
X701101	TRAFFIC CONTROL AND PROTECTION (EXPRESSWAYS)	L SUM	1	1		
X704012		EACH	2,481	2,481		

	USER NAME = rober	DESIGNED - NH	REVISED -		F.A.I. ROUTE 55 (I-55)		F.A.I. RTE.	SECTION	COUNTY TOTAL SHEET SHEETS NO.
Consulting Engineers		DRAWN - NH	REVISED -	STATE OF ILLINOIS	SUMMARY OF QUANTITIES		55	2019-177-BR	DUPAGE/WILL 37 6
Westmont, Illinois	PLOT SCALE = 2.0000 ' / in.	CHECKED - ST	REVISED -	DEPARTMENT OF TRANSPORTATION				· · ·	CONTRACT NO. 62K50
	PLOT DATE = 2/7/2020	DATE - 1/2020	REVISED -		SCALE: N.T.S. SHEET 4 OF 5 SHEETS STA.	IU SIA.		ILLINOIS FED	D. AID PROJECT

									100% STATE
									ROADWAY
	CODE				ITEM		UNIT	TOTAL	0004
	NO.							QUANTITY	URBAN
	Z0001700	APPROA	CH SLAB REPAI	R (FULL DE	PTH)		SQ YD	14	
	Z0013798	CONSTR	UCTION LAYOUT	-			L SUM	1	1
	Z0016002		LAB REPAIR (F		TYPE II)		SQ YD	9	
		DECK 3					30 10	9	
	Z0016200	DECK S	LAB REPAIR (P	PARTIAL)			SQ YD	37	
	Z0030850	TEMPOR	ARY INFORMATI	ON SIGNING			SQ FT	416	416
							-		
	Z0064800	SELECT	IVE CLEARING				UNIT	5	5
ø	Z0076604	TRAINE	S TRAINING PROG	RAM GRADUA	TE		HOUR	500	500
Ø (	SPECIALTY IT	EM	DEGIGNED MU		WIGED		_		
LTD.	R NAME = rober		DESIGNED - NH DRAWN - NH		VISED - VISED -	STATE OF ILLINOIS			F.A.I. ROUTE 5
rs <sub>PLOT</sub>	SCALE = 2.0000 / in.		CHECKED - ST	RE	VISED -	DEPARTMENT OF TRANSPORTATION			SUMMARY OF QU

LIN ENGINEERING, LTD. Consulting Engineers Westmont, Illinois PLOT SCALE = 2.0000 ' / in. PLOT DATE = 2/7/2020

DATE - 1/2020

REVISED -

|=

F.A.I. ROUTE 5 SUMMARY OF QU SCALE: N.T.S. SHEET 5 OF 5 SHEETS

CONSTRUCTION CODE							
100% STATE	100% STATE						
SN 099-0260	SN 099-0028						
0047	0047						
URBAN	URBAN						
12	2						
9							
26	11						

# REV. - MS

55 (I-55) UANTITIES		F.A.I. RTE				COUNTY	TOTAL SHEETS	SHEET NO.
		55	55 2019-177-BR			DUPAGE/WILL	37	7
			•			CONTRACT I	NO. 62k	(50
IS STA.	TO STA.		ILLINOIS FED. AID PROJECT					

#### LANDSCAPING TABLE

FROM STATION	TO STATION	LT/RT	NITROGEN FERTILIZER NUTRIENT	PHOSPHORUS FERTILIZER NUTRIENT	POTASSIUM FERTILIZER NUTRIENT	SEEDING, CLASS 2A	EROS I ON CONTROL BLANKET
			POUND	POUND	POUND	ACRE	SQ YD
201+66.20	209+09.07	LT	3.42	3.42	3.42	0.04	184.00
201+72.07	208+45.44	RT	4.80	4.80	4.80	0.05	258.20
210+80.50	217+66.19	RT	3.34	3.34	3.34	0.04	179.60
294+03.42	300+55.42	LT	2.66	2.66	2.66	0.03	143.24
294+86.26	298+60.85	RT	4.26	4.26	4.26	0.05	228.85
303+11.73	309+48.68	LT	2.68	2.68	2.68	0.03	144.16
630+00.00	639+68.82	LT	3.95	3.95	3.95	0.04	212.33
636+43.14	638+45.20	RT	1.00	1.00	1.00	0.01	53.56
640+67.54	641+45.64	RT	0.39	0.39	0.39	0.00	21.05
641+83.12	647+02.21	LT	3.74	3.74	3.74	0.04	201.39
ROUNDED TOTAL			45	45	45	0.50	1,627

REMOVE AND	REERECT	STEEL	PLATE	BEAM
GUARDRAIL,	ΤΥΡΕ Α			

FROM STATION	TO STATION	LT/RT	FOOT
204+14.00	208+39.00	RT	400.00
206+82.00	209+11.00	LT	225.00
210+78.00	213+18.00	RT	237.50
295+11.00	298+61.00	RT	325.00
303+12.00	306+81.00	LT	287.50
636+43.00	638+45.00	RT	100.00
639+31.00	639+83.00	LT	50.00
640+50.00	641+46.00	RT	87.50
641+84.00	646+65.00	LT	425.00
	ROUN	IDED TOTAL	2,137.5

# REMOVE AND REERECT TRAFFICBARRIER TERMINALS, TYPE1

FROM STATION	LT/RT	EACH
204+14.00	RT	1
295+11.00	RT	1
295+11.00	RT	1
306+81.00	LT	1
636+81.00	RT	1
646+65.00	LT	1
	TOTAL	6

# REMOVE AND REERECT TRAFFIC BARRIER TERMINALS, TYPE 2

FROM STATION	LT/RT	EACH
206+82.00	LT	1
213+18.00	RT	1
639+31.00	LT	1
641+66.00	RT	1
	4	

#### PAVEMENT MARKING TAPE, TYPE IV 4"

FROM STATION	TO STATION	LT/RT	FOOT		
	STA	GE 2			
198+58.41	219+85.22	RT	2,126.81		
200+72.15	217+71.50	RT	1,699.35		
199+48.23	220+71.87	LT	2,123.64		
201+61.99	218+58.15	LT	1,696.16		
288+34.83	307+47.49	RT	1,912.67		
290+48.63	305+33.74	RT	1,485.11		
291+80.32	306+67.48	LT	1,487.15		
293+94.03	296+06.79	LT	212.76		
626+44.99	650+95.16	RT	2,450.17		
626+88.05	26+88.05 651+23.27		2,435.22		
627+87.60 652+11.50		LT	2,423.90		
628+23.31	651+68.43 LT		2,345.13		
	RO	UNDED TOTAL	22,399		

#### MODULAR GLARE SCREEN SYSTEM, TEMPORARY

FROM STATION	TO STATION	LT/RT	FOOT			
STAGE 2						
198+58.41	220+71.87	CL	2,213.46			
288+34.83	307+47.49	CL	1,912.67			
626+45.14	651+68.53	CL	2,523.39			
ROUNDED TOTAL 6,650.0						

REVISED -		F.A.I. ROUTE 55 (I-55)	F.A.I. BTE	SECTION	COUNTY	TOTAL	SHEET NO.
REVISED -	STATE OF ILLINOIS	SCHEDULE OF QUANTITIES		2019-177-BR	DUPAGE/WILL	37	8
REVISED -	DEPARTMENT OF TRANSPORTATION	SCHEDOLE OF QUANTILES			CONTRACT	NO. 62	K50
REVISED -		SCALE N.T.S. SHEET 1 OF 3 SHEETS STA. TO STA.		ILLINOIS FED.	AID PROJECT		

PAVEMENT	SCHEDULE

FROM STATION	TO STATION	LT/RT	EARTH EXCAVATION	AGGREGATE SUBGRADE IMPROVEMENT	BITUMINOUS MATERIALS (PRIME COAT)	BITUMINOUS MATERIALS (TACK COAT)	PAVED SHOULDER REMOVAL	HMA SHOULDERS, 15"	SHOULDER RUMBLE STRIPS, 16 INCH
			CU YD	CU YD	POUND	POUND	SQ YD	SQ YD	FOOT
201+66.20	209+09.07	LT	667.04	296.46	2,001.12	600.34	889.39	889.39	742.87
201+72.07	208+45.44	RT	543.66	241.63	1,630.98	489.29	724.88	724.88	670.85
210+80.50	217+66.19	RT	626.23	278.33	1,878.70	563.61	834.98	834.98	685.69
211+43.04	217+58.52	LT	512.11	227.60	1,536.32	460.90	682.81	682.81	615.48
291+48.63	298+60.85	RT	749.97	333.32	2,249.91	674.97	999.96	999.96	712.22
294+03.42	300+55.42	LT	546.92	243.07	1,640.75	492.22	729.22	729.22	652.17
301+14.00	305+28.71	RT	481.41	213.96	1,444.24	433.27	641.88	641.88	414.71
303+11.73	309+48.68	LT	559.30	248.58	1,677.90	503.37	745.73	745.73	637.22
630+00.00	638+45.20	RT	827.84	367.93	2,483.53	745.06	1,103.79	1,103.79	845.20
630+00.00	639+68.82	LT	1,010.32	449.03	3,030.97	909.29	1,347.10	1,347.10	968.82
640+67.54	649+00.00	RT	911.22	404.99	2,733.65	820.09	1,214.96	1,214.96	832.46
641+83.12	649+00.00	LT	718.80	319.47	2,156.40	646.92	958.40	958.40	720.62
	ROU	JNDED TOTAL	8,155	3,625	24,465	7,340	10,874	10,874	8,499

#### BARRIER WALL REFLECTORS, TYPE C

FROM STATION	TO STATION	LT/RT	EACH
	STA	GE 2	
200+71.95	217+71.50	RT	68
201+61.99	218+48.76	LT	68
290+34.22	305+33.74	RT	60
293+94.02	310+05.58	LT	65
629+26.69	649+08.99	RT	79
630+00.00	650+05.49	LT	81
		TOTAL	421

#### TEMPORARY CONCRETE BARRIER

FROM STATION	TO STATION	LT/RT	FOOT
	STAG	GE 2	
200+71.95	217+71.50	RT	1,700.00
201+61.99	218+48.76	LT	1,687.50
290+34.22	305+33.74	RT	1,500.00
293+94.02	310+05.58	LT	1,612.50
629+26.69	649+08.99	RT	1,975.00
630+00.00	650+05.49	LT	2,012.50
	ROUN	IDED TOTAL	10,487.5

#### IMPACT ATTENUATORS, TEMPORARY (FULLY REDIRECTIVE, NARROW), TEST LEVEL 3

FROM STATION	LT/RT	EACH
	STAGE 2	
200+71.95	RT	1
218+48.76	LT	1
290+34.22	RT	1
310+05.58	LT	1
629+26.69	RT	1
650+05.49	LT	1
	TOTAL	6

LIN ENGINEERING, LT
Consulting Engineers
Westmont, IIInols

DESIGNED - NH JSER NAME = rober TD. DRAWN - NH LOT SCALE = 2.0000 / in CHECKED - ST PLOT DATE = 3/10/2020 DATE - 1/2020

# REMOVE AND REERECT TRAFFIC BARRIER TERMINALS, TYPE 6B

FROM STATION	LT/RT	EACH
303+12.00	LT	1
638+03.00	RT	1
641+84.00	LT	1
TOTAL		3

#### REMOVE AND REERECT TRAFFIC BARRIER TERMINALS, TYPE 10

FROM STATION	LT/RT	EACH
208+39.00	RT	1
209+11.00	LT	1
210+78.00	RT	1
298+61.00	RT	1
639+83.00	LT	1
640+67.00	RT	1
TOTAL		6

#### PAVEMENT MARKING TAPE, TYPE IV 5"

FROM STATION	TO STATION	LT/RT	FOOT
	STA	GE 2	
198+58.41	219+85.22	RT	1,063.41
199+48.23	220+71.87	LT	1,061.82
288+34.83	307+47.49	RT	956.33
291+80.32	306+67.48	LT	743.58
626+44.99	650+95.16	RT	1,225.09
628+23.31	651+68.43	LT	1,172.56
	RO	JNDED TOTAL	6,223

#### PAVEMENT MARKING TAPE, TYPE IV 8"

FROM STATION	TO STATION	LT/RT	FOOT
	STA	GE 2	
198+58.41	200+72.15	RT	213.75
199+48.23	201+61.99	LT	213.75
217+71.50	219+85.22	RT	213.72
218+58.15	220+71.87	LT	213.72
288+34.83	290+48.63	RT	213.80
291+80.32	293+94.03	LT	213.70
296+06.79	311+84.22	LT	1,578.17
301+60.00	306+67.48	LT	1,014.96
305+33.74	307+47.49	RT	213.76
624+03.26	626+88.05	RT	287.23
ROUNDED TOTAL 4,			

#### FILLING EXISTING RUMBLE STRIP

FROM STATION	TO STATION	LT/RT	FOOT
198+58.41	219+85.22	RT	2,126.81
199+48.23	220+71.87	LT	2,123.64
288+34.83	307+47.49	RT	1,912.67
291+80.32	306+67.48	LT	1,487.15
626+44.99	650+95.16	RT	2,450.17
628+23.31	651+68.43	LT	2,345.13
	12,446		

#### TEMPORARY INFORMATION SIGNING

STATION	LT/RT	TYPE	SQ FT	
196+59.00	RT	ALL TRAFFIC	32.00	
196+59.00	RT	ALL TRAFFIC	32.00	
222+72.00	LT	ALL TRAFFIC	32.00	
222+72.00	LT	ALL TRAFFIC	32.00	
286+36.00	RT	ALL TRAFFIC	32.00	
286+36.00	RT	ALL TRAFFIC	32.00	
308+67.00	LT	ALL TRAFFIC	32.00	
308+67.00	LT	ALL TRAFFIC	32.00	
313+84.00	LT	ALL TRAFFIC	32.00	
622+03.00	RT	ALL TRAFFIC	32.00	
624+87.00	RT	ALL TRAFFIC	32.00	
654+12.00	LT	ALL TRAFFIC	32.00	
654+12.00	LT	ALL TRAFFIC	32.00	
	ROUNDED TOTAL			

#### PAVEMENT MARKING TAPE, TYPE IV 12"

FROM STATION	TO STATION	LT/RT	FOOT
	STA	GE 2	
198+58.41	200+72.15	RT	59.16
199+48.23	201+61.99	LT	42.93
217+71.50	219+85.22	RT	81.01
218+58.15	220+71.87	LT	102.53
288+34.83	290+48.63	RT	48.90
291+80.32	293+94.03	LT	100.41
305+33.74	307+47.49	RT	115.17
	RO	JNDED TOTAL	551

#### PAVEMENT MARKING REMOVAL - WATER BLASTING

FROM STATION	TO STATION	LT/RT	SQ FT	
198+58.00	219+85.00	RT	709.00	
198+58.00	219+85.00	RT	709.00	
198+58.00	219+85.00	RT	354.50	
199+49.00	220+67.00	LT	706.00	
199+49.00	220+67.00	LT	706.00	
199+49.00	220+67.00	LT	353.84	
288+35.00	307+47.00	RT	637.42	
288+35.00	307+47.00	RT	318.71	
290+02.00	307+47.00	RT	581.67	
291+81.00	309+84.00	LT	667.96	
291+81.00	306+07.00	LT	475.33	
291+81.00	306+07.00	LT	237.71	
626+45.00	650+94.00	RT	815.67	
626+45.00	650+94.00	RT	756.12	
626+45.00	650+94.00	RT	408.17	
628+23.00	651+68.00	LT	784.13	
628+23.00	651+68.00	LT	782.63	
628+23.00	651+68.00	LT	390.83	
ROUNDED TOTAL 10,395				

#### PINNING TEMPORARY CONCRETE BARRIER

FROM STATION	TO STATION	LT/RT	EACH
	STAC	GE 2	
200+71.95	217+71.50	RT	402
201+61.99	218+48.76	LT	399
290+34.22	305+33.74	RT	354
293+94.02	310+05.58	LT	381
629+26.69	649+08.99	RT	468
630+00.00	650+05.49	LT	477
	ROUN	DED TOTAL	2,481

# FRAMES AND GRATES TO BE ADJUSTED

FROM STATION	LT/RT	EACH
208+30.00	RT	1
208+87.00	LT	1
211+00.00	RT	1
211+52.00	LT	1
	TOTAL	4

#### PAVEMENT MARKING SCHEDULE


FROM	то		THERMOPLA	STIC PAVEMEN	IT MARKING		D PLASTIC KING, TYPE B		URETHANE MARKING	RAISED REFLECTIVE PAVEMENT	RAISED REFLECTIVE PAVEMENT MARKER
STATION	STATION	LT/RT	LINE 4"	LINE 8"	LINE 12"	LINE 5"	LINE 8"	LINE 4"	LINE 12"	MARKER	REMOVAL
			FOOT	FOOT	FOOT	FOOT	FOOT	FOOT	FOOT	EACH	EACH
98+58.00	208+98.00	RT	1,040.00								
98+58.00	208+76.00	RT	1,018.00								
98+58.00	201+72.00	RT		314.00							
98+58.00	208+91.00	RT				516.50					
98+58.00	219+85.00	RT								213	213
99+49.00	209+09.00	LT	960.00								
99+49.00	209+24.00	LT				487.50					
99+49.00	220+67.00	LT								212	212
99+66.00	209+32.00	LT	966.00								
99+89.00	201+66.00	LT		177.00							
05+45.00		LT			14.94						
5+55.00		RT			12.92			10			
08+76.00	210+57.00	RT					45.05	181.00			
08+83.00	210+64.00	RT					45.25		F7 07		
08+86.00	210+46.00	RT					45.25		57.07		
08+91.00	210+72.00	RT					45.25	102.00			
08+98.00	210+80.00	RT						182.00			
09+09.00	210+90.00	LT					15 25	181.00			
)9+16.00	210+97.00	LT					45.25				
)9+24.00 )9+32.00	211+05.00	LT					45.25	181.00			
9+32.00	211+13.00 211+02.00	LT						101.00	65.78		
10+57.00	211+02.00	RT	709.00						05.70		
0+57.00	217+66.00	RT	,09.00			460.50					
0+80.00	219+85.00	RT	905.00			400.50					
0+90.00	220+67.00	LT	977.00								
10+97.00	220+67.00	LT				485.00					
11+13.00	217+59.00	LT	646.00								
12+45.00		LT			14.60						
12+56.00		RT			11.79						
17+55.00		RT			16.11						
17+59.00	220+67.00	LT		308.00							
17+66.00	219+85.00	RT		219.00							
88+35.00	299+57.00	RT	1,122.00								
88+35.00	299+35.00	RT				550.00					
88+35.00	307+47.00	RT								191	191
00+02.00	291+48.00	RT		146.00							
91+48.00	298+94.00	RT	746.00								
91+81.00	299+86.00	LT	805.00								
91+81.00	294+04.00	LT		223.00							
91+81.00	300+28.00	LT				423.50					
91+81.00	306+07.00	LT								143	143
4+04.00	300+72.00	LT	668.00								
98+00.00		LT			14.72						
98+03.00		RT			10.36						
98+94.00	301+05.00	RT						211.00			
98+94.00	300+94.00	RT							85.34		
99+13.00	301+52.00	RT					59.75				
	ATE OF ILI					F.A.I. ROUTE			F.A.I. RTE	SECTION	COUN
		ANSPORT			50	HEDULE OF C			55	2019-177-B	R DUPAGE

	USER NAME = rober	DESIGNED -	NH	REVISED -			F.A.I. ROUTE 55
LIN ENGINEERING, LTD		DRAWN -	NH	REVISED -	STATE OF ILLINOIS		
	PLOT SCALE = 2.0000 / in.	CHECKED -	ST	REVISED -	DEPARTMENT OF TRANSPORTATION		SCHEDULE OF QUA
Westmont, IIInols	PLOT DATE = 3/24/2020	DATE -	1/2020	REVISED -		SCALE: N.T.S.	SHEET 2 OF 3 SHEETS


FROM	то		THERMOPLA	STIC PAVEME	NT MARKING		D PLASTIC RKING, TYPE B		) URETHANE T MARKING	RAISED REFLECTIVE PAVEMENT	RAISED REFLECTIN PAVEMENT
STATION	STATION	LT/RT	LINE 4"	LINE 8"	LINE 12"	LINE 5"	LINE 8"	LINE 4	LINE 12"	MARKER	MARKER REMOVAL
			FOOT	FOOT	FOOT	FOOT	FOOT	FOOT	FOOT	EACH	EACH
299+35.00	301+73.00	RT					59.50				
299+57.00	301+67.00	RT						210.00			
299+86.00	301+96.00	LT						210.00			
300+06.00	302+17.00	LT					52.75				
300+28.00	302+39.00	LT					52.75				
300+72.00	302+90.00	LT						218.00			
300+73.00	302+73.00	LT							54.97		
301+05.00	305+29.00	RT	424.00								
301+52.00	307+47.00	LT				297.50					
301+67.00	307+47.00	RT	580.00								
301+96.00	306+07.00	LT	411.00								
301+96.00	306+07.00	RT				205.50					
302+90.00	309+48.00	LT	658.00								
303+21.00		RT			26.09						
305+29.00	307+47.00	RT		218.00							
308+11.00		LT			12.16						
626+45.00	639+13.00	RT	1,268.00								
626+45.00	639+02.00	RT				628.50					
626+45.00	650+94.00	RT								245	245
628+17.00	638+77.00	RT	1,060.00								
628+23.00	639+83.00	LT	1,160.00								
628+23.00	639+49.00	LT	1,126.00								
628+23.00	639+72.00	LT				574.50					
628+23.00	651+68.00	LT								235	235
630+03.00		RT			16.29						
630+65.00		LT			14.62						
635+04.00		RT			17.41						
635+65.00		LT			17.41						
638+77.00	640+48.00	RT						171.00			
638+85.00	640+45.00	RT							95.08		
638+90.00	640+59.00	RT					42.25		55.00		
639+02.00	640+70.00	RT					42.00				
639+13.00	640+81.00	RT						168.00			
639+49.00	641+17.00	LT						168.00			
639+60.00	641+28.00	LT					42.00				
639+72.00	641+39.00	LT					41.75				
639+83.00	641+39.00	LT						156.00			
639+94.00	641+54.00	LT							100.86		
640+48.00	651+94.00	RT	1,146.00								
640+59.00	650+94.00	RT	_,			517.50					
640+81.00	650+94.00	RT	1,013.00								
641+17.00	651+68.00	LT	1,051.00								
641+28.00	651+68.00	LT	1,001.00			520.00					
641+39.00	651+68.00	LT	1,029.00			520.00					
645+67.00		LT	1,020.00		17.78						
646+02.00		RT			18.05						
3-0102.00		ED TOTAL									1,239

#### PAVEMENT MARKING SCHEDULE (CONTINUED)

	USER NAME = rober	DESIGNED - NH	REVISED -			F.A.I. ROUTE 55 (I-55)		F.A.I. BTE	SECTION	COUNTY TOTAL SHEET SHEETS NO.
		DRAWN - NH	REVISED -	STATE OF ILLINOIS	SCHEDULE OF QUANTITIES			55	2019-177-BR	DUPAGE/WILL 37 10
Consulting Engineers Westmont, Illinois	PLOT SCALE = 2.0000 ' / in	CHECKED - ST	REVISED -	DEPARTMENT OF TRANSPORTATION						CONTRACT NO. 62K50
westmont, minors	PLOT DATE = 2/7/2020	DATE - 1/2020	REVISED -		SCALE: N.T.S. SHEET 3 OF 3 SHEETS STA. TO STA.				ILLINOIS FED	AID PROJECT

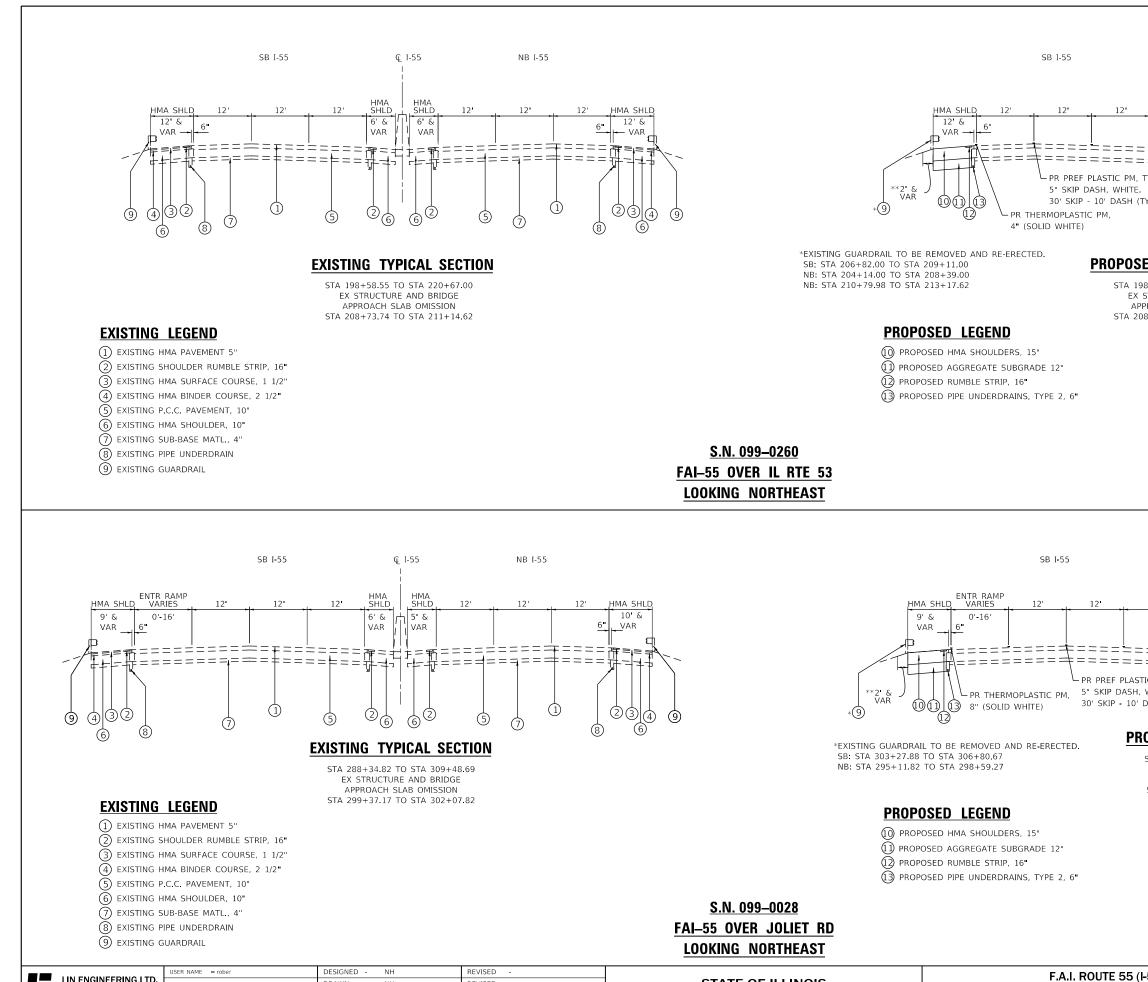


F.A.I. ROUTE 5 LIN ENGINEERING, LTD. STATE OF ILLINOIS DRAWN NH REVISED TYPICAL SEC **Consulting Engineers** HECKED ST REVISED **DEPARTMENT OF TRANSPORTATION** OT SCALE = 20.0000 / in Westmont, Illinois SCALE: N.T.S. SHEET 1 OF 2 SHEET REVISED LOT DATE = 3/10/2020 DATE 1/2020

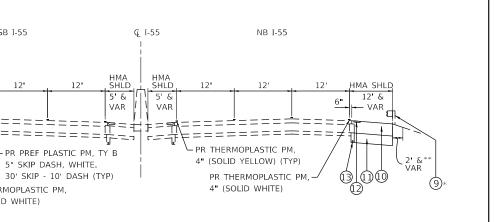

### **PROPOSED TYPICAL SECTION**


STA 198+58.55 TO STA 220+67.00 EX STRUCTURE AND BRIDGE APPROACH SLAB OMISSION STA 208+73.74 TO STA 211+14.62 \*\* SEEDING CLASS 2A & MULCH (METHOD 2). SB: STA 201+66.00 TO STA 209+11.00 NB: STA 201+72.00 TO STA 208+39.00 NB: STA 210+78.00 TO STA 217+66.00

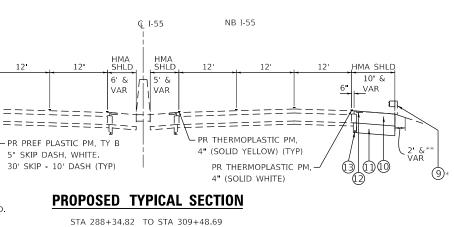

STA 288+34.82 TO STA 309+48.69 EX STRUCTURE AND BRIDGE APPROACH SLAB OMISSION STA 299+37.17 TO STA 302+07.82

\*\* SEEDING CLASS 2A & MULCH (METHOD 2). SB: STA 294+10.70 TO STA 300+55.00 SB: STA 303+11.56 TO STA 309+48.32 NB: STA 294+86.26 TO STA 298+60.87

55	( <b>I-</b> 55)		F.A.I. RTE	SEC	ΠON		COUNTY	TOTAL SHEETS	SHEET NO.
CTIONS		55	2019-1	l77-BR		DUPAGE/WILL	37	11	
			_				CONTRACT	NO. 62k	<50
TS STA. TO STA.				<b>ILLINOIS</b>	FED. A	D PROJECT			

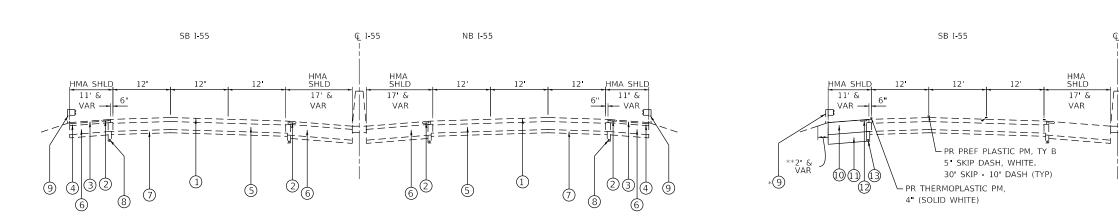

#### **EXISTING TYPICAL SECTION**

STA 626+45.00 TO STA 651+68.42 EX STRUCTURE AND BRIDGE APPROACH SLAB OMISSION STA 639+01.47 TO STA 641+33.66

### EXISTING LEGEND

- () EXISTING HMA PAVEMENT 5"
- (2) EXISTING SHOULDER RUMBLE STRIP, 16"
- (3) EXISTING HMA SURFACE COURSE, 1 1/2"
- (4) EXISTING HMA BINDER COURSE, 2 1/2"
- (5) EXISTING P.C.C. PAVEMENT, 10"
- (6) EXISTING HMA SHOULDER, 10"
- (7) EXISTING SUB-BASE MATL., 4
- (8) EXISTING PIPE UNDERDRAIN
- 9 EXISTING GUARDRAIL


\*EXISTING GUARDRAIL TO BE REMOVED AND RE-ERECTED. NB: STA 636+81.27 TO STA 638+53.33 NB: STA 640+50.58 TO STA 641+43.91 SB: STA 639+30.86 TO STA 639+81.33 SB: STA 641+76.47 TO STA 646+64.72

#### **PROPOSED LEGEND**

() PROPOSED HMA SHOULDERS, 15" (1) PROPOSED AGGREGATE SUBGRADE 12" (12) PROPOSED RUMBLE STRIP, 16" (13) PROPOSED PIPE UNDERDRAINS, TYPE 2, 6"

<u>S.N. 022–0003</u> FAI-55 OVER MADISON ST LOOKING NORTHEAST

	USER NAME = rober	DESIGNED - NH	REVISED -			F.A.I. ROUTE 55 (I-55)		F.A.I. BTE	SECTION	COUNTY TOTAL SHEET
LIN ENGINEERING,LTD.		DRAWN - NH	REVISED -	STATE OF ILLINOIS		TYPICAL SECTIONS				DUPAGE/WILL 37 12
Westmont, Illinois	PLOT SCALE = 20.0000 / in	CHECKED - ST	REVISED -	DEPARTMENT OF TRANSPORTATION	ITFICAL SECTIONS					CONTRACT NO. 62K50
	PLOT DATE = 3/10/2020	DATE - 1/2020	REVISED -		SCALE: N.T.S.	SHEET 2 OF 2 SHEETS STA.		ILLINOIS FED. /	AID PROJECT	

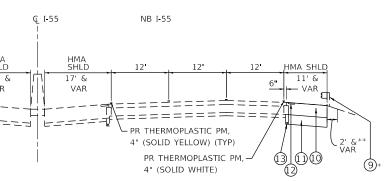

### **PROPOSED TYPICAL SECTION**

STA 626+45.00 TO STA 651+68.42 EX STRUCTURE AND BRIDGE APPROACH SLAB OMISSION STA 639+01.47 TO STA 641+33.66 \*\* SEEDING CLASS 2A & MULCH (METHOD 2). SB: STA 630+00.00 TO STA 639+70.00 SB: STA 641+97.48 TO STA 647+02.20 NB: STA 636+43.44 TO STA 638+33.17 NB: STA 640+65.56 TO STA 641+45.96

#### MAINTENANCE OR TRAFFIC GENERAL NOTES

BRIDGE DECK PATCHING AND SHOULDER RECONSTRUCTION

- 1. THE MAINTENANCE OF TRAFFIC PLANS SHALL SERVE AS A GUIDE FOR THE SAFE DIVERSION OF TRAFFIC DURING THE EXECUTION OF THIS CONTRACT. THE CONTRACTOR MAY MODIFY THE MAINTENANCE OF TRAFFIC PLANS TO MEET CONSTRUCTION NEEDS BUT NOT AT THE EXPENSE OF PUBLIC SAFETY OR CONVENIENCE. ANY CHANGES TO THE TRAFFIC CONTROL PLANS SHALL BE SUBMITTED TO THE ENGINEER FOR APPROVAL.
- 2. EXISTING PAVEMENT MARKINGS THAT CONFLICT WITH TEMPORARY MARKINGS SHALL BE REMOVED. THIS WORK WILL BE PAID FOR AT THE CONTRACT UNIT PRICE PER SQUARE FOOT FOR PAVEMENT MARKING REMOVAL - WATER BLASTING.
- 3. EXISTING RAISED REFLECTIVE PAVEMENT MARKER REFLECTORS THAT CONFLICT WITH THE REVISED TRAFFIC PATTERN SHALL BE REMOVED FROM THE EXISTING CASTINGS LOCATED IN THE PAVEMENT. THIS WORK WILL BE PAID FOR AT THE CONTRACT UNIT PRICE EACH FOR RAISED REFLECTIVE PAVEMENT MARKER REMOVAL.
- 4. THE REMOVAL OF ALL PAVEMENT MARKING TAPE WILL BE PAID FOR AT THE CONTRACT UNIT PRICE SQUARE FOOT FOR SHORT TERM PAVEMENT MARKING REMOVAL.
- 5. PAVEMENT MARKING TAPE, TYPE IV SHALL BE USED FOR ANY SHORT TERM PAVEMENT MARKINGS ON FINAL SURFACES.
- 6. ALL TRAFFIC CONTROL DEVICES SHALL BE REFLECTORIZED PRIOR TO INSTALLATION AND CLEANED AS SPECIFIED IN THE TRAFFIC CONTROL SPECIAL PROVISIONS OR AS DIRECTED BY THE ENGINEER.
- 7. ALL DRUMS, VERTICAL PANELS, AND BARRICADES ADJACENT TO THE EDGE OF THE TRAVELED WAY SHALL BE EQUIPPED WITH MONO-DIRECTIONAL STEADY BURNING LIGHTS.
- 8. FOR STABILIZATION, ANY REQUIRED TYPE III BARRICADES SHALL REQUIRE A MINIMUM OF FOUR SAND BAGS PER BARRICADE.
- 9. EXISTING SIGNS WITHIN THE LIMITS OF TRAFFIC CONTROL WHICH ARE OBSTRUCTED BY OR OTHERWISE INTERFERED WITH BY CONSTRUCTION OPERATIONS OF DESIGNATED TRAFFIC CONTROL, SHALL BE COVERED OR REMOVED BY THE CONTRACTOR UNLESS SPECIFIED IN THE PLANS OR WHEN DIRECTED BY THE ENGINEER. THIS WORK SHALL BE AS SPECIFIED IN ARTICLE 107.25 OF THE STANDARD SPECIFICATIONS.
- 10. CHANGEABLE MESSAGE BOARDS WILL BE PLACED 2 WEEKS PRIOR TO START OF WORK, AT LOCATIONS DETERMINED BY THE ENGINEER, FOR ADVANCED WARNING.
- 11. SEE STRUCTURAL PLANS FOR BRIDGE DECK REPAIR INFORMATION.
- 12. THE CONTRACTOR SHALL CONTACT THE DISTRICT ONE EXPRESSWAY TRAFFIC CONTROL SUPERVISOR AT (847) 705-4155 A MINIMUM OF 72 HOURS IN ADVANCE OF BEGINNING ANY WORK.
- 13. THE CONTRACTOR SHALL CONTACT RICK WILLMAN, PACE TRANSPORTATION ENGINEER, VIA EMAIL AT RICHARD.WILLMAN@PACEBUS.COM A MINIMUM OF 2 WEEKS IN ADVANCE OF BEGINNING ANY WORK.
- 14. THE ENGINEER SHALL CONTACT REGINA COOPER, AREA EXPRESSWAY TRAFFIC ENGINEER, VIA EMAIL AT REGINA.COOPER2@ILLINOIS.GOV A MINIMUM OF 2 WEEKS PRIOR TO PLACEMENT OF PERMANENT PAVEMENT MARKINGS.

#### SUGGESTED SEQUENCE OF OPERATIONS

### <u>STAGE 1</u>

- 1. RESURFACE EXISTING RUMBLE STRIPS UTILIZING HIGHWAY STANDARD 701400, 701401, 701428, AND 701446.
- 2. INSTALL TRAFFIC CONTROL DEVICES AND TEMPORARY PAVEMENT MARKINGS AS SHOWN IN THE PLANS.
- 3. AT EACH LOCATION, SHIFT NB AND SB TRAFFIC ONTO THE RESPECTIVE INSIDE SHOULDER UTILIZING DISTRICT STANDARD TC-09 AND AS SHOWN IN THE PLANS.
- 4. CLOSE NB AND SB OUTSIDE SHOULDERS UTILIZING DISTRICT STANDARD TC-17 AND AS SHOWN IN THE PLANS.
- REMOVE EXISTING GUARDRAILS AND REMOVE AND RECONSTRUCT OUTSIDE SHOULDERS IN THE NB AND SB DIRECTION AT ALL THREE LOCATIONS AS SHOWN IN THE PLANS.
- INSTALL PROTECTIVE SHIELD (PERMANENT) AT LOCATIONS SHOWN IN THE PLANS UTILIZING HIGHWAY STANDARDS 701501, 701601, 701701 AS WELL AS DISTRICT STANDARD TC-10, TC-14, AND TC-22.
- 7. ADJUST EXISTING DRAINAGE STRUCTURES AS REQUIRED.
- 8. RE-ERECT EXISTING GUARDRAILS AS REQUIRED.


#### STAGE 2

1. PERFORM BRIDGE DECK REPAIRS UTILIZING HIGHWAY STANDARDS 701400, 701401, 701428, & 701446 AS WELL AS DISTRICT STANDARDS TC-09 & TC-17.

#### POST-STAGE

1. PLACE PERMANENT PAVEMENT MARKINGS AND RESTORE SHOULDER RUMBLE STRIPS UTILIZING HIGHWAY STANDARD 701400, 701401, 701428, AND 701446 AS WELL AS DISTRICT STANDARD TC-09 & TC-17.

	USER NAME = rober	DESIGNED - RC	REVISED -			F.A.I. ROUTE 55 (I-55)		F.A.I. BTE	SECTION	COUNTY TOTAL SHEET
Consulting Engineers		DRAWN - RC	REVISED -	STATE OF ILLINOIS		STAGING GENERAL NOTES		55	2019-177-BR	DUPAGE/WILL 37 13
Westmont, Illinois	PLOT SCALE = 100.0000 / in.	CHECKED - ST	REVISED -	DEPARTMENT OF TRANSPORTATION						CONTRACT NO. 62K50
	PLOT DATE = 3/24/2020	DATE - 1/2020	REVISED -		SCALE: N.T.S.	SHEET 1 OF 5 SHEETS STA.	TO STA.		ILLINOIS FEC	). AID PROJECT

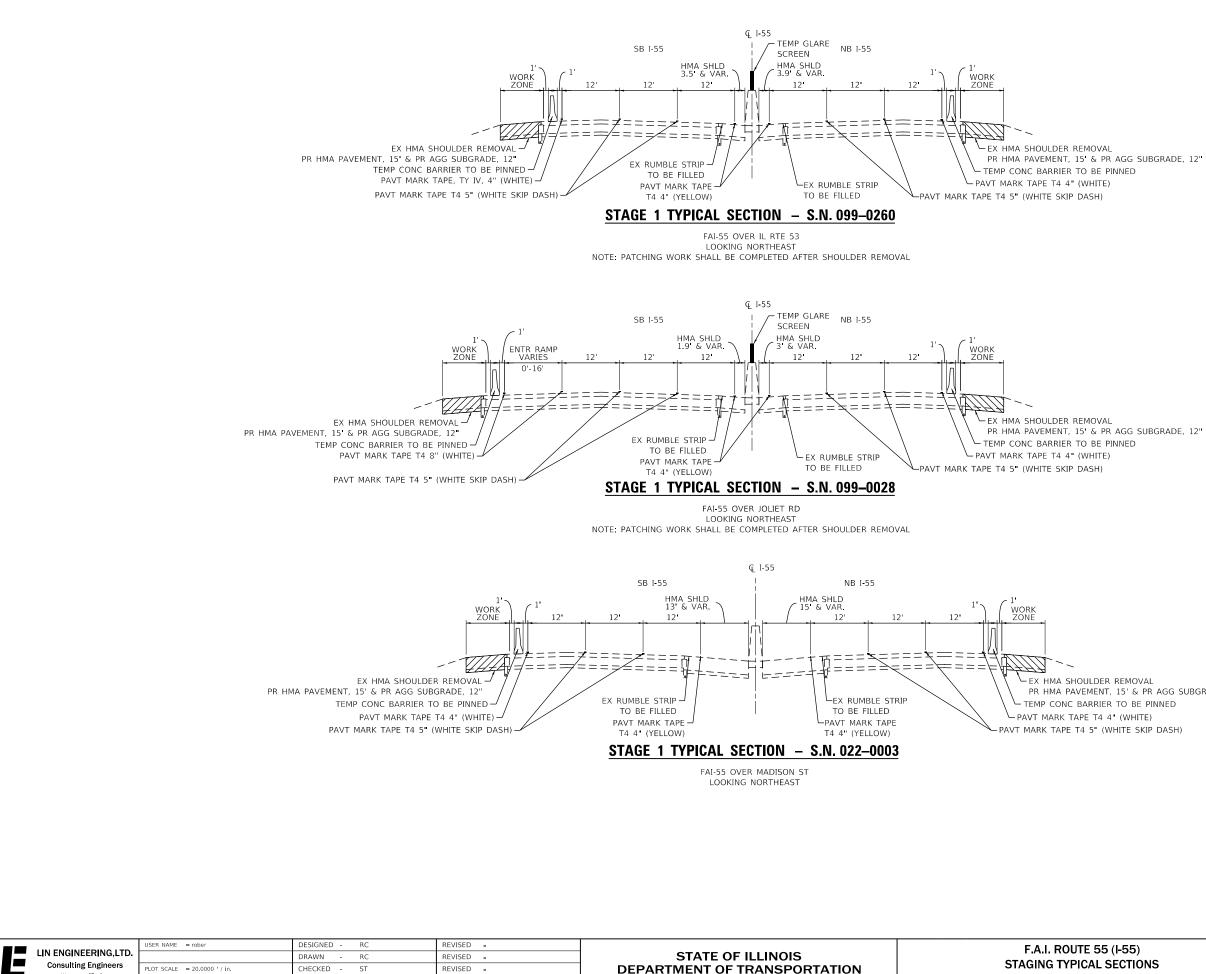

REVISED -

Westmont, IIInol

LOT DATE = 3/10/2020


DATE


1/2020


**DEPARTMENT OF TRANSPORTATION** SCALE: N.T.S. SHEET 2 OF 5 SHEET


PR HMA PAVEMENT, 15' & PR AGG SUBGRADE, 12"


F.A.I. RTE	SEC	SECTION		COUNTY	TOTAL SHEETS	SHEET NO.
55	2019-1	77-BR		DUPAGE/WILL	37	14
				CONTRACT	NO. 62k	<50
		ILLIN015	FED. AI	D PROJECT		
	RTE.	RTE. SEC	RTE.         SECTION           55         2019-177-BR	RTE.         SECTION           55         2019-177-BR	RTE.         SECTION         COUNT           55         2019-177-BR         DUPAGE/WILL           CONTRACT         CONTRACT	RTE.         SECTION         COUNTY         SHEETS           55         2019-177-BR         DUPAGE/WILL         37           CONTRACT NO. 621

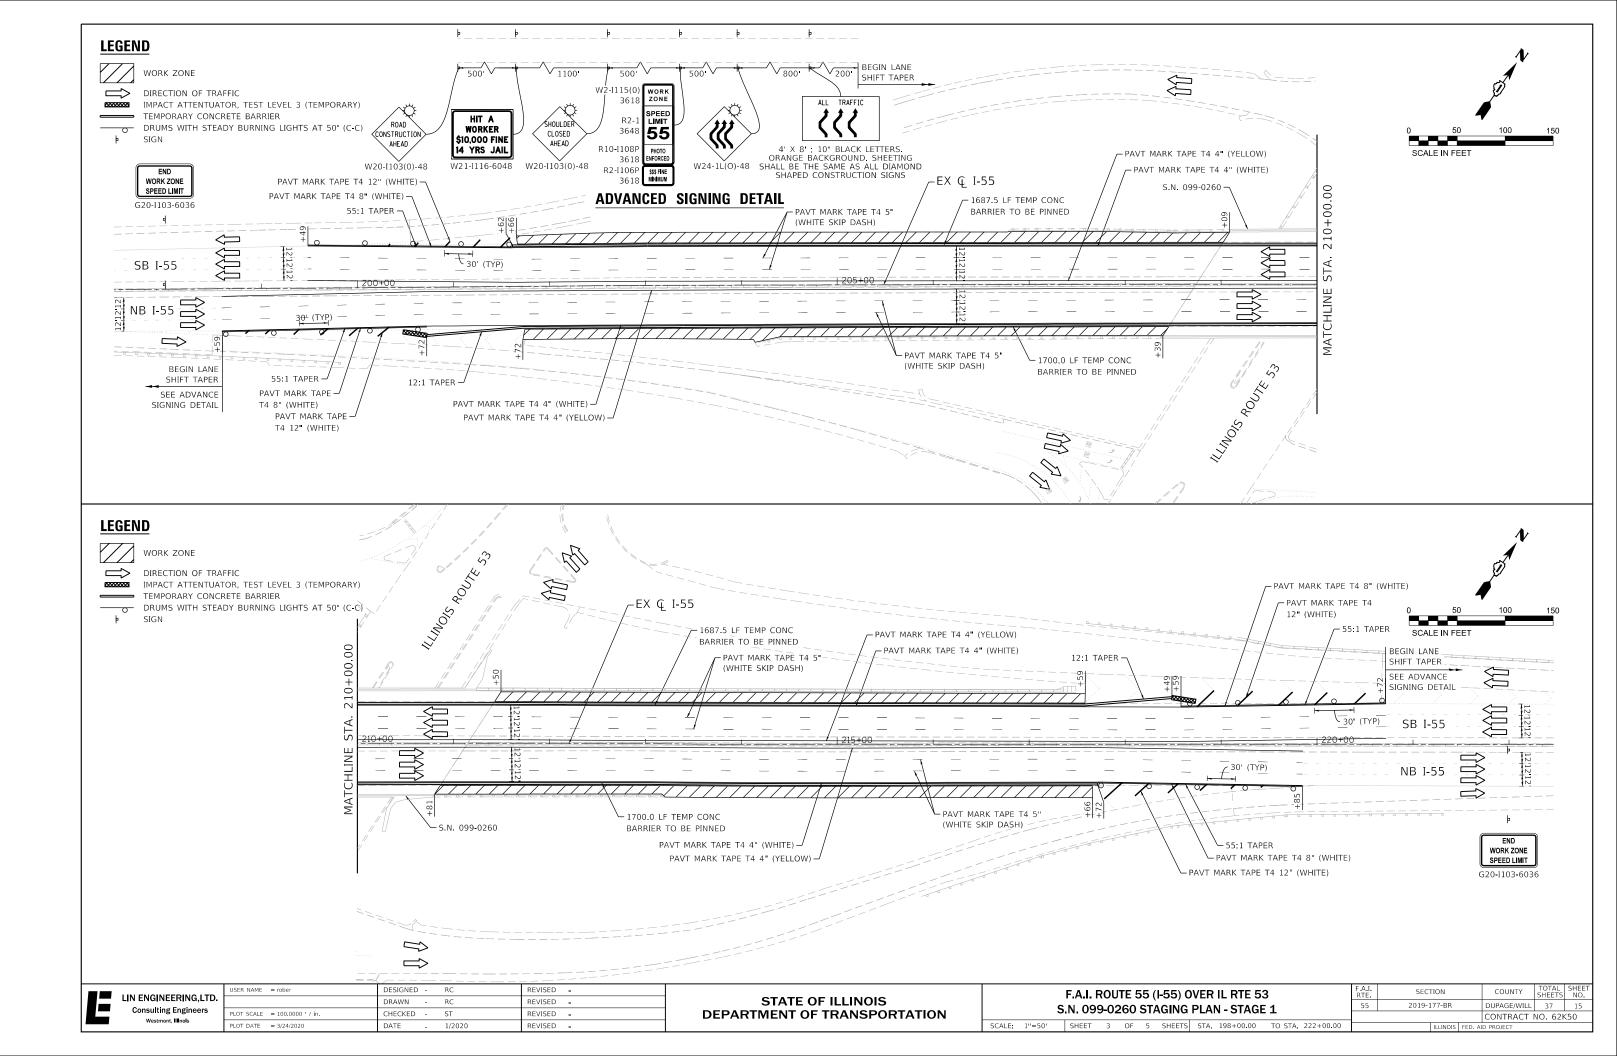

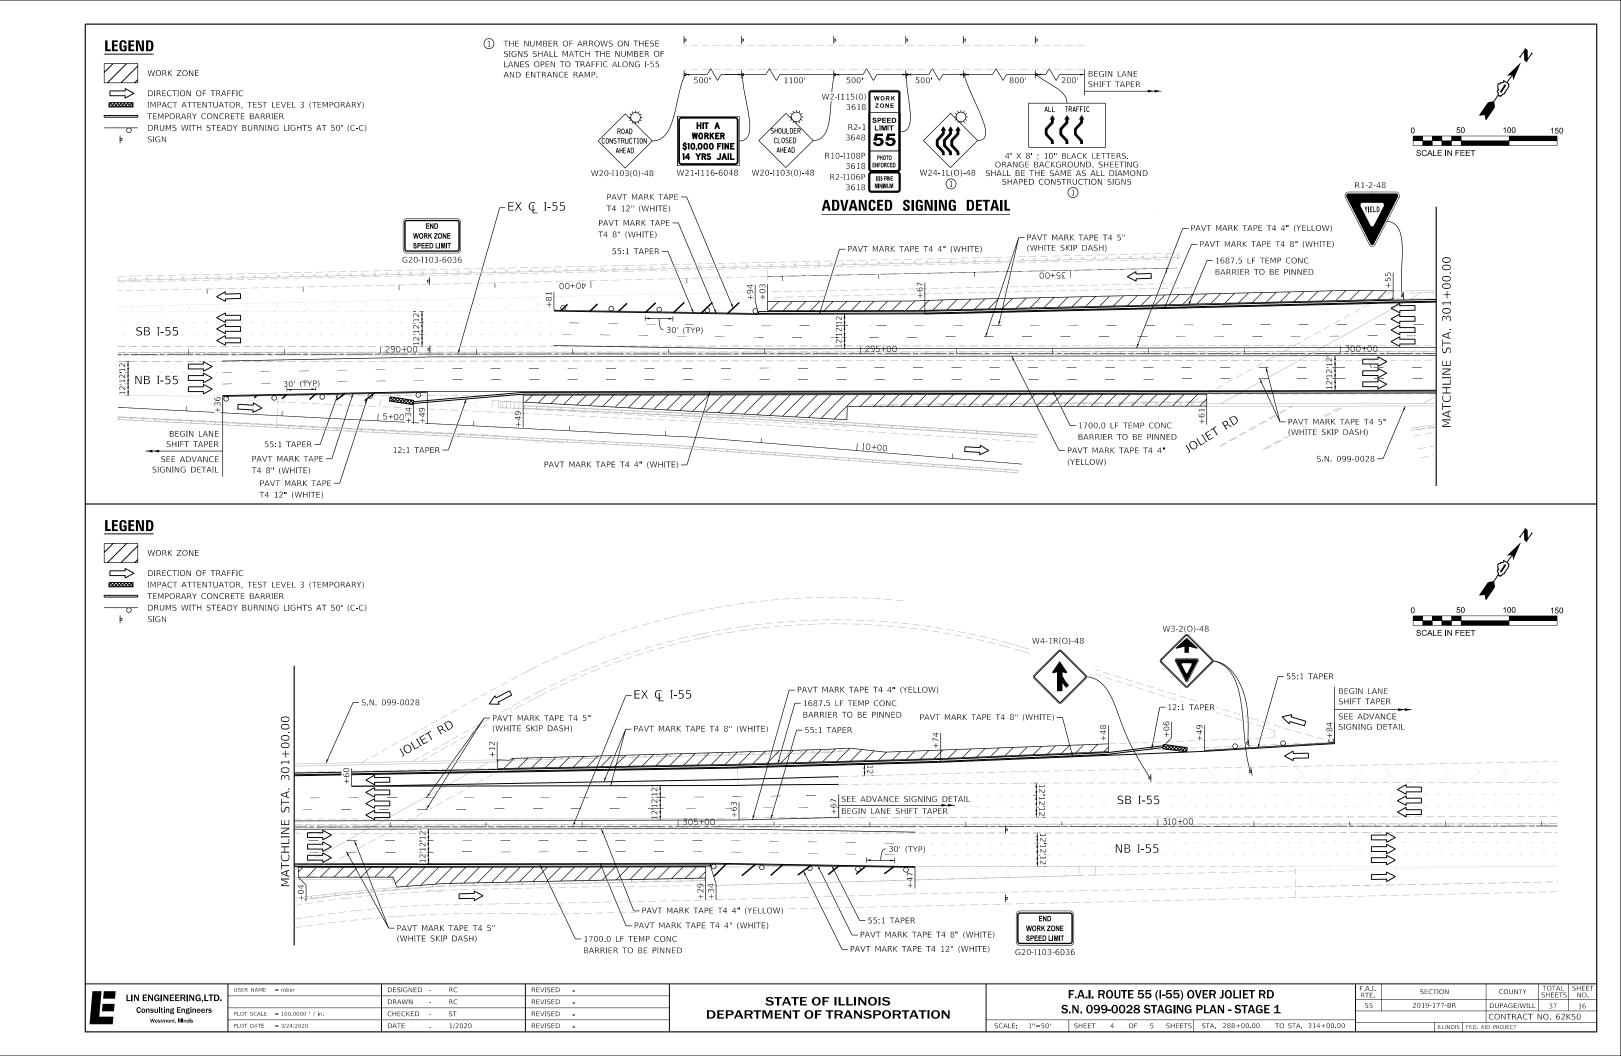


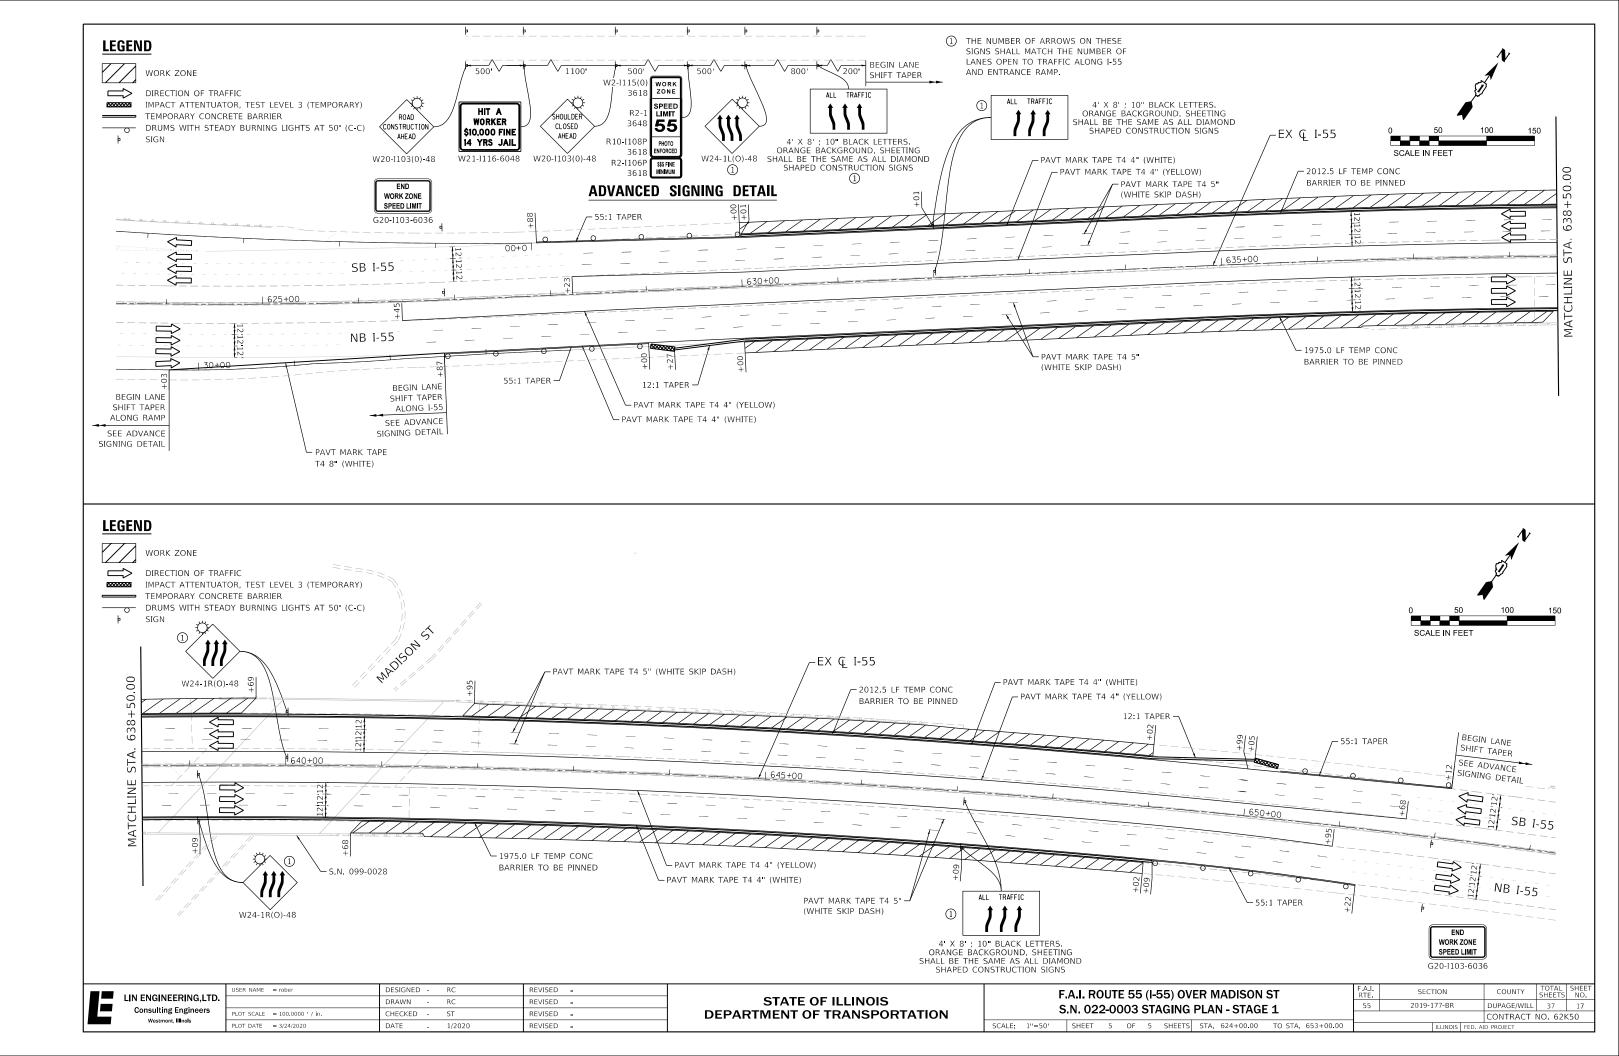


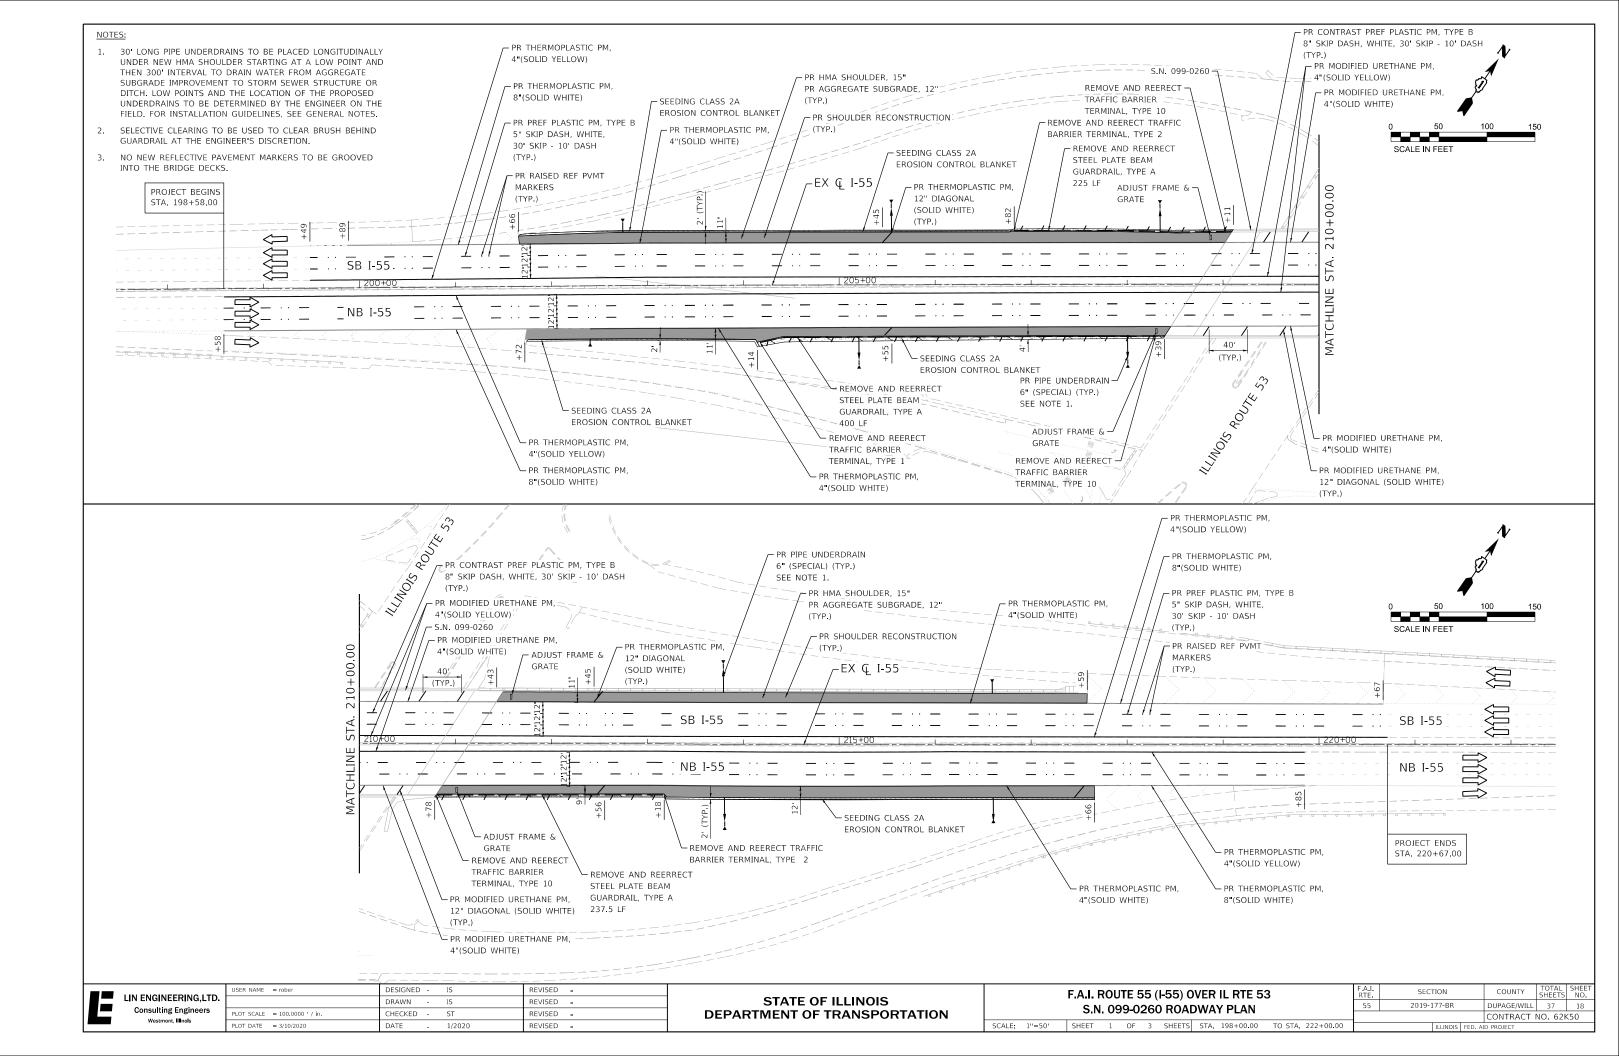

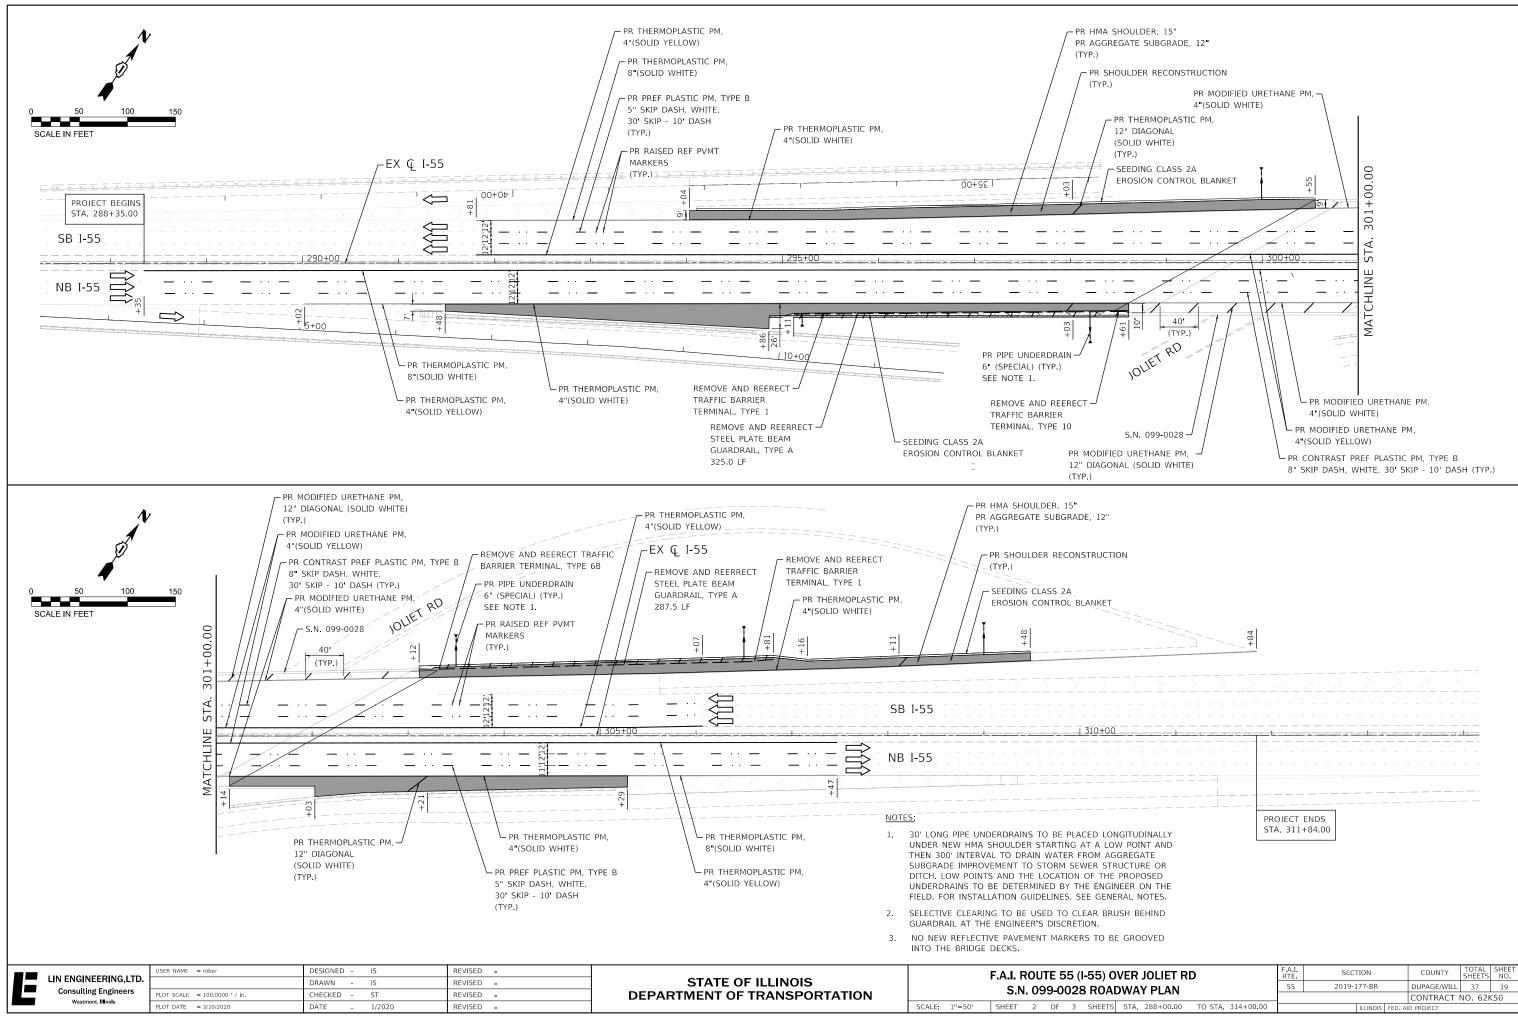

) U	VER JOLIET RI	)	RTE.	JLC	non		COONT	SHEETS	NO.
ΔΓ	WAY PLAN		55	2019-1	77-BR		DUPAGE/WILL	37	19
						CONTRACT	NO. 62k	<50	
ETS	STA. 288+00.00	TO STA. 314+00.00			<b>ILLINOIS</b>	FED. A	D PROJECT		

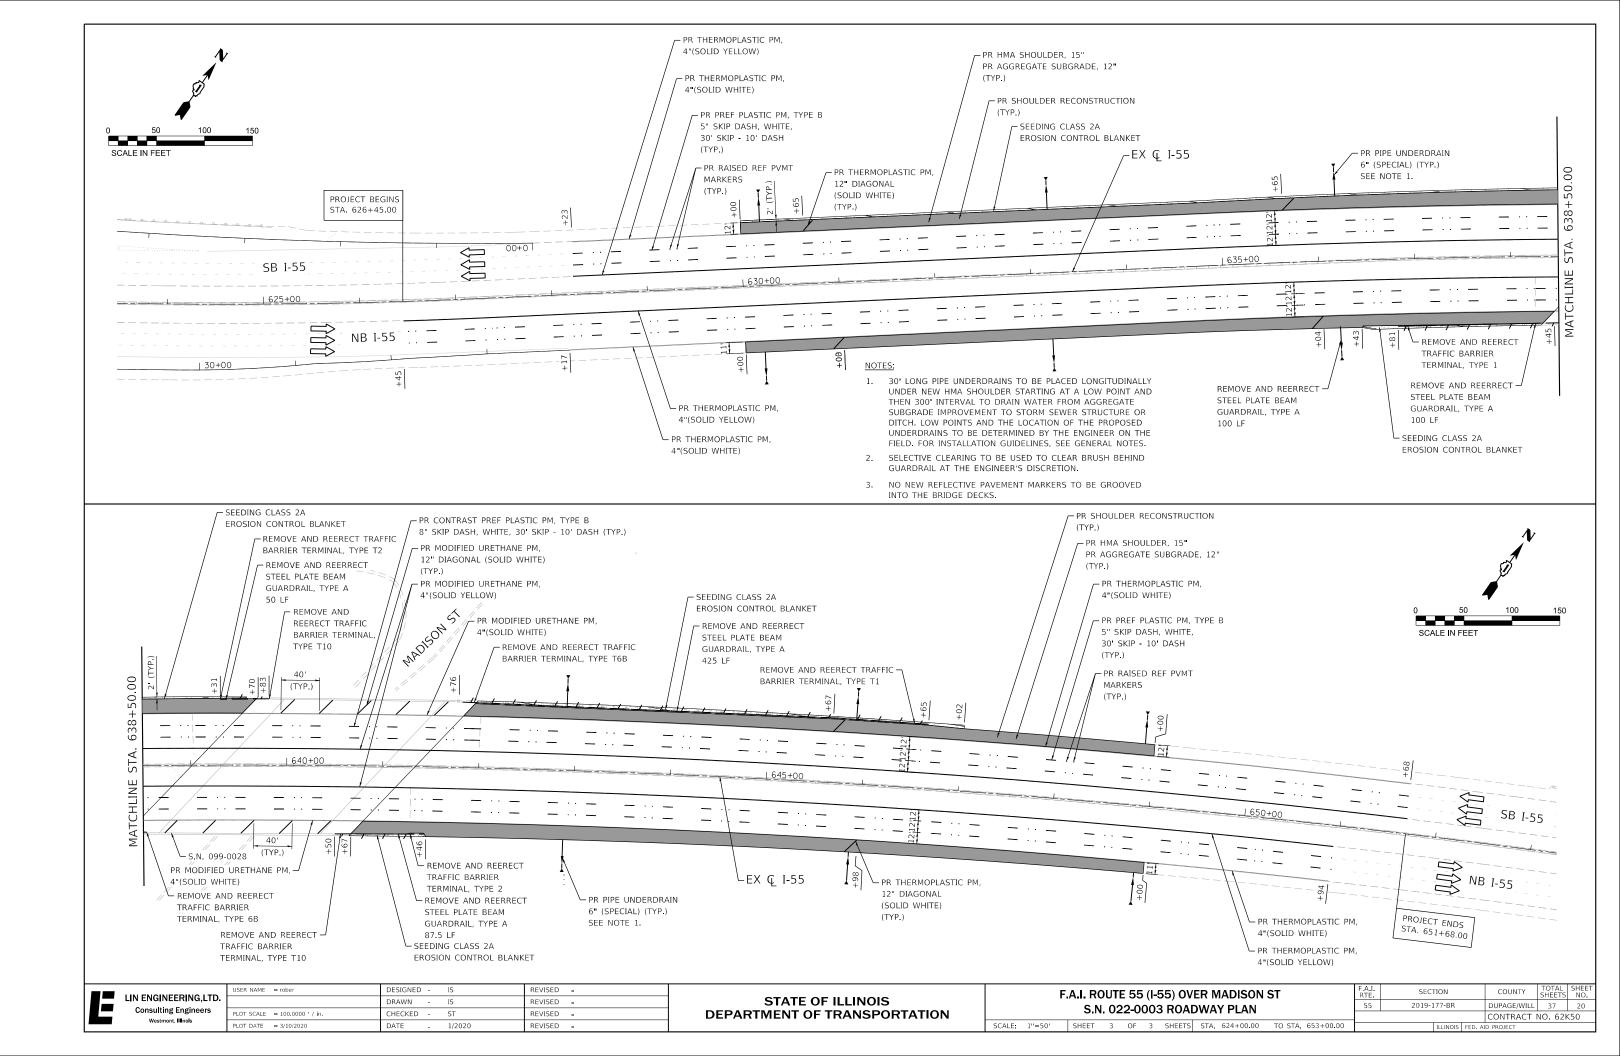

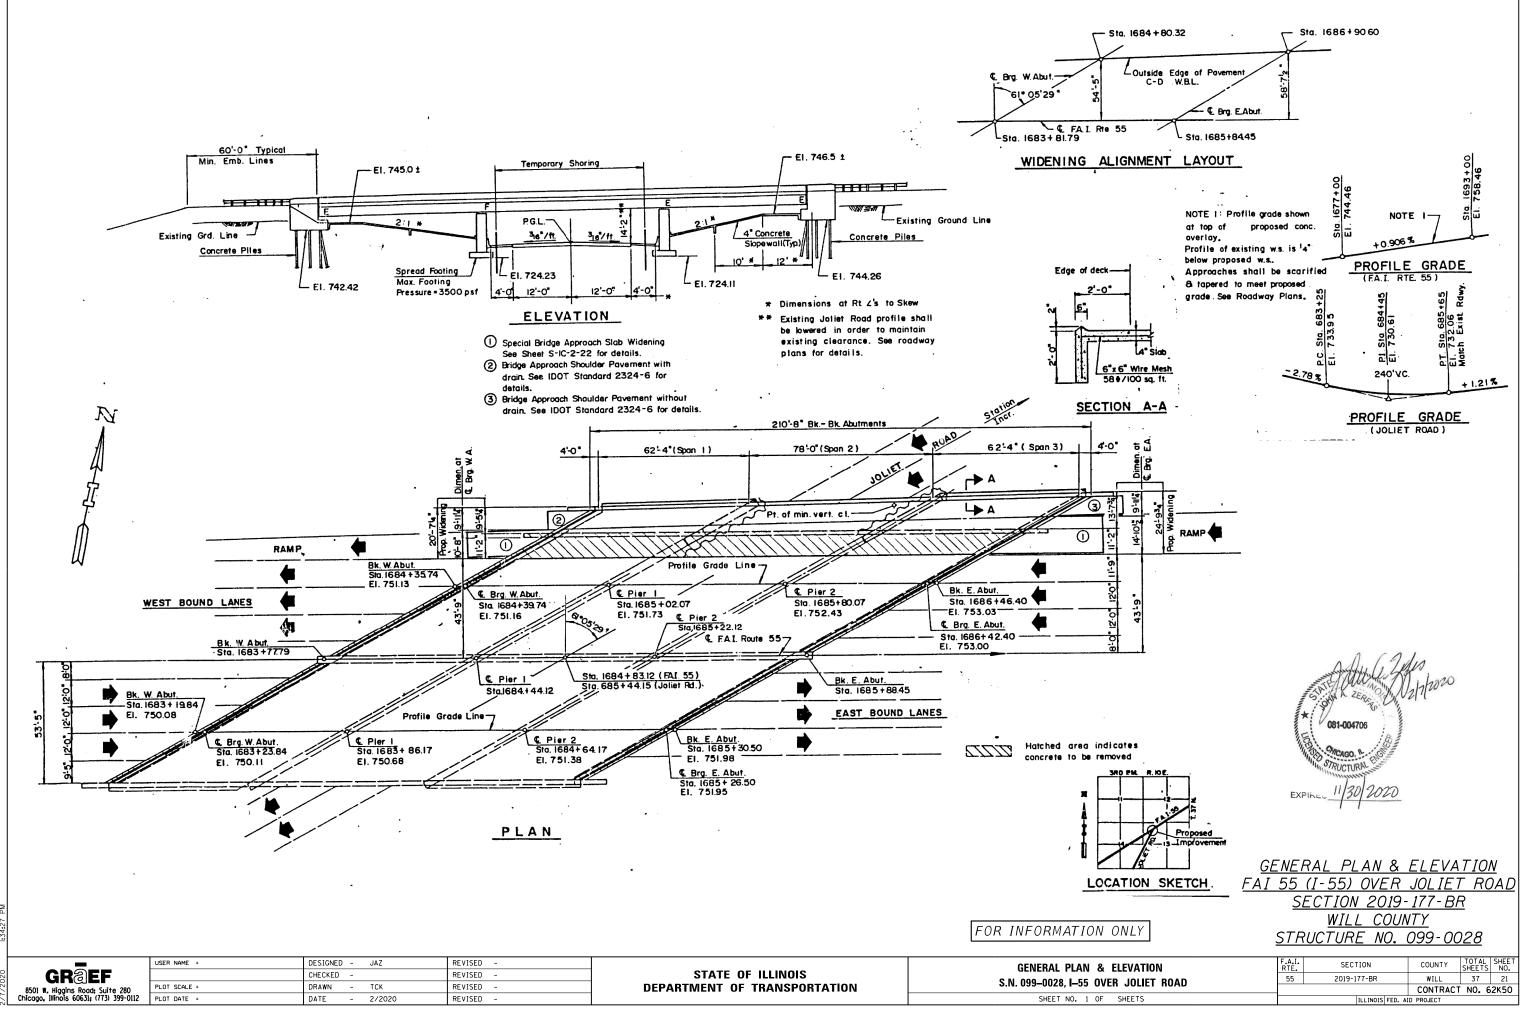

#### GENERAL NOTES

- 1. Repair quantities have been prepared from notes received from IDOT Engineers.
- 2. Plan dimensions and details relative to existing plans are subject to nominal construction variations. The Contactor shall field verify existing dimensions and details affecting new construction and make necessary approved adjustments prior to construction or ordering of materials. Such variations shall not be cause for additional compensation for a change in scope of the work, however, the Contractor will be paid for the quantity actually furnished at the unit price bid for the work.
- 3. The Contractor shall use PP-1, PP-2, PP-3 or PP-4 Concrete for all deck and approach slab patches.
- 4. For construction staging see Maintenance of Traffic Sheets.

### SCOPE OF WORK


1. Partial depth repair of bridge decks and full depth repair of approach slabs utilizing staged construction.

### TOTAL BILL OF MATERIAL

ITEM	UNIT	TOTAL
DECK SLAB REPAIR (PARTIAL)	SQ YD	11
APPROACH SLAB REPAIR (FULL DEPTH)	SQ YD	2


	USER NAME =	DESIGNED – JAZ	REVISED -		GENERAL NOTES & TOTAL BILL OF MATERIAL	F.A.I. RTF.	SECTION	COUNTY TOTAL SHEET
<b>GR</b> @EF		CHECKED -	REVISED -	STATE OF ILLINOIS	S.N. 099–0028, I–55 OVER JOLIET ROAD	55	2019-177-BR	WILL 37 22
8501 W. Higgins Road; Suite 280	PLOT SCALE =	DRAWN - TCK	REVISED -	DEPARTMENT OF TRANSPORTATION				CONTRACT NO. 62K50
Chicago, Illinois 60631; (773) 399-0112	PLOT DATE =	DATE - 2/2020	REVISED -		SHEET NO. 2 OF 3 SHEETS		ILLINOIS FED.	. AID PROJECT

ITEM	UNIT	TOTAL
DECK SLAB REPAIR (PARTIAL)	SQ YD	11
APPROACH SLAB REPAIR (FULL DEPTH)	SQ YD	2

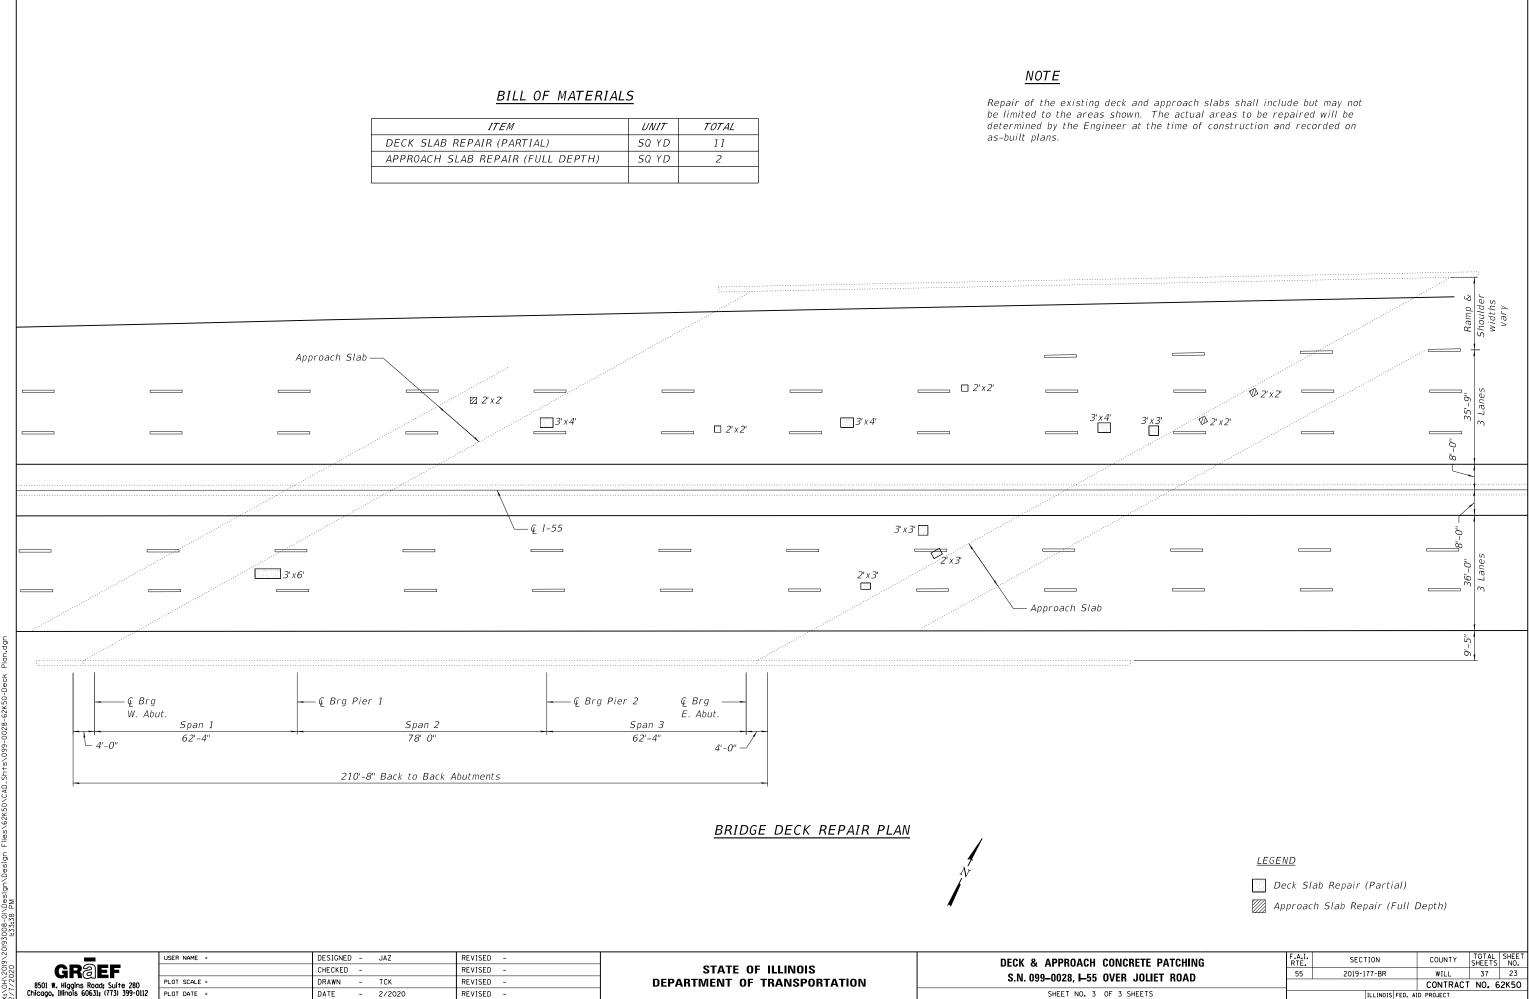

SHEET NO. 3 OF 3 SHEETS

ILLINOIS FED. AID PROJECT

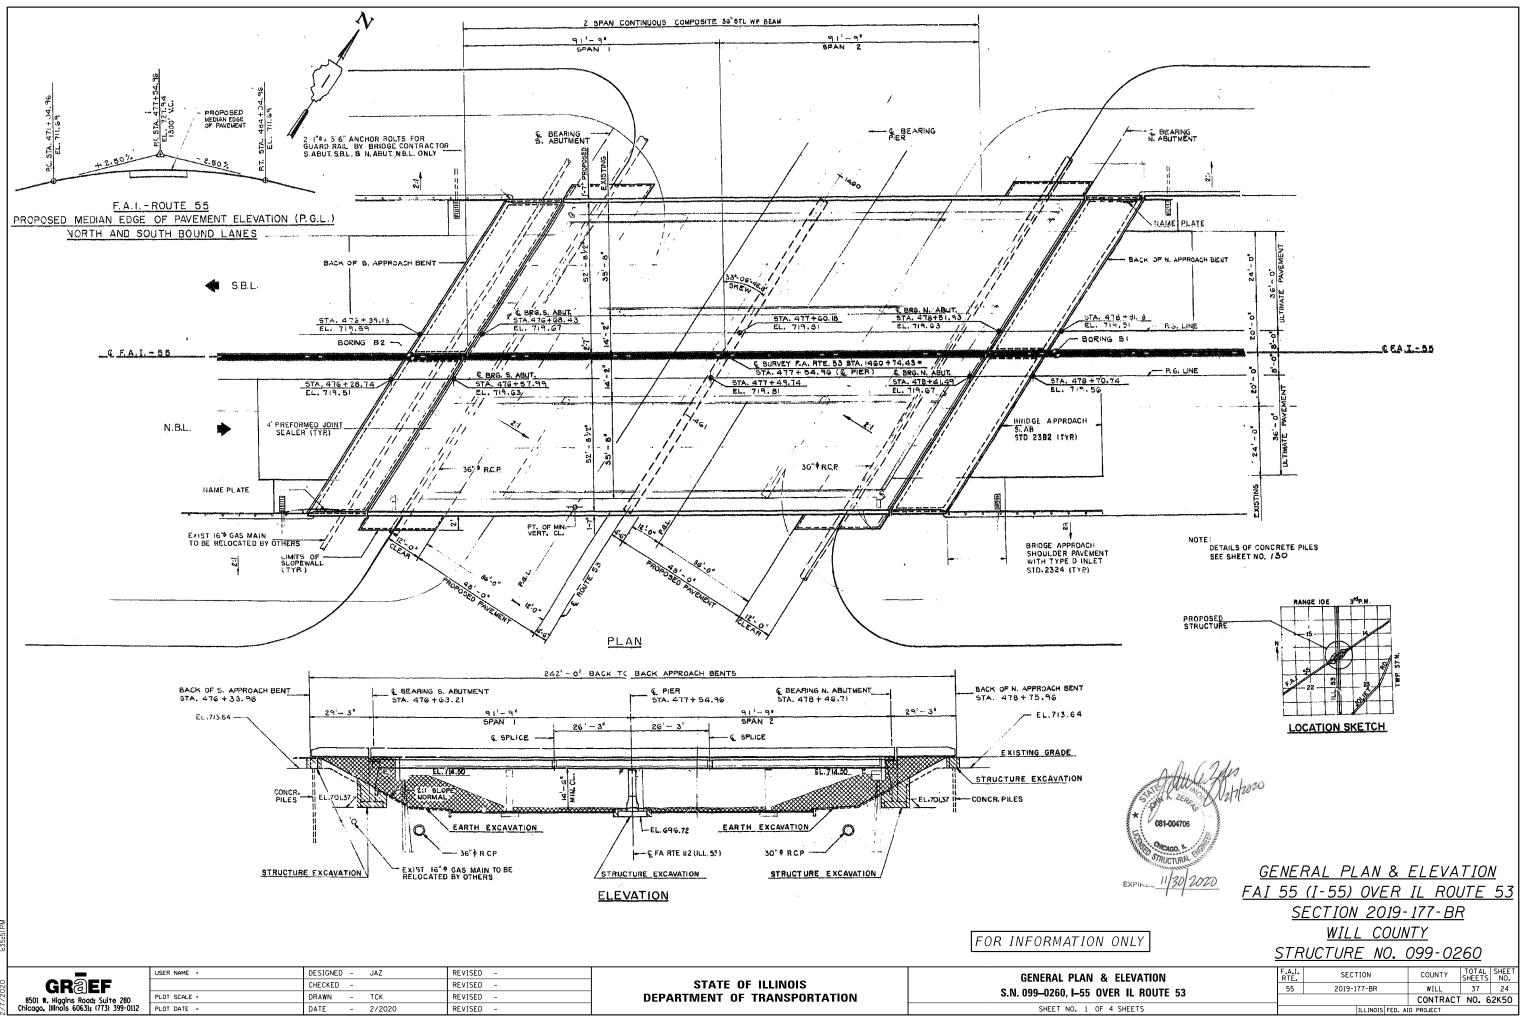

)H\2019\20193008-01\Design\Design Files\62K50\CAD\_Shts\099-0260-62K50-6P8

### **GENERAL NOTES**

- 1. Repair quantities have been prepared from notes received from IDOT Engineers.
- 2. Plan dimensions and details relative to existing plans are subject to nominal construction variations. The Contactor shall field verify existing dimensions and details affecting new construction and make necessary approved adjustments prior to construction or ordering of materials. Such variations shall not be cause for additional compensation for a change in scope of the work, however, the Contractor will be paid for the quantity actually furnished at the unit price bid for the work.
- 3. The Contractor shall use PP-1, PP-2, PP-3 or PP-4 Concrete for all deck and approach slab patches.
- 4. The Contractor must use extreme caution during full depth deck slab repair and must not nick, cut or damage, in any way, any of the steel beams. The existing reinforcement bars shall be cleaned. If any of these reinforcement bars are damaged they must be replaced with an approved bar splicer or anchorage system. The cost of this work is included with Deck Slab Repair (Full Depth, Type II).
- 5. The bridge over IL 53 has temporary protective shield in-place. The Contractor must remove the temporary protective shield and replace it with Protective Shield (Permanent). The Protective Shield (Permanent) shall be installed from face-to-face of existing abutments. The width to be protected shall be from the centerline of the west fascia beam to the centerline of the east fascia beam. The removal and disposal of the existing temporary protective shield shall be paid for as Protective Shield Removal.
- 6. For construction staging see Maintenance of Traffic Sheets.

#### SCOPE OF WORK


- 1. Removal of existing temporary protective shield and replacement with Protective Shield (Permanent).
- 2. Partial depth and full depth repair of bridge decks and full depth repair of approach slabs utilizing staged construction.

	1	
ITEM	UNIT	TOTAL
PROTECTIVE SHIELD REMOVAL	L SUM	1
PROTECTIVE SHIELD (PERMANENT)	SQ YD	2,085
DECK SLAB REPAIR (FULL DEPTH, TYPE II)	SQ YD	9
DECK SLAB REPAIR (PARTIAL)	SQ YD	26
APPROACH SLAB REPAIR (FULL DEPTH)	SQ YD	12

#### TOTAL BILL OF MATERIAL


L BILL OF MATERIAL	F.A.I. RTE.	SECTION	COUNTY	TOTAL SHEETS	SHEET NO.
/ER IL ROUTE 53	55	2019-177-BR	WILL	37	25
			CONTRACT	NO. 6	2K50
4 SHEETS		ILLINOIS FED. A	D PROJECT		


ITEM	UNIT	TOTAL
DECK SLAB REPAIR (FULL DEPTH, TYPE II)	SQ YD	9
DECK SLAB REPAIR (PARTIAL)	SQ YD	26
APPROACH SLAB REPAIR (FULL DEPTH)	SQ YD	12

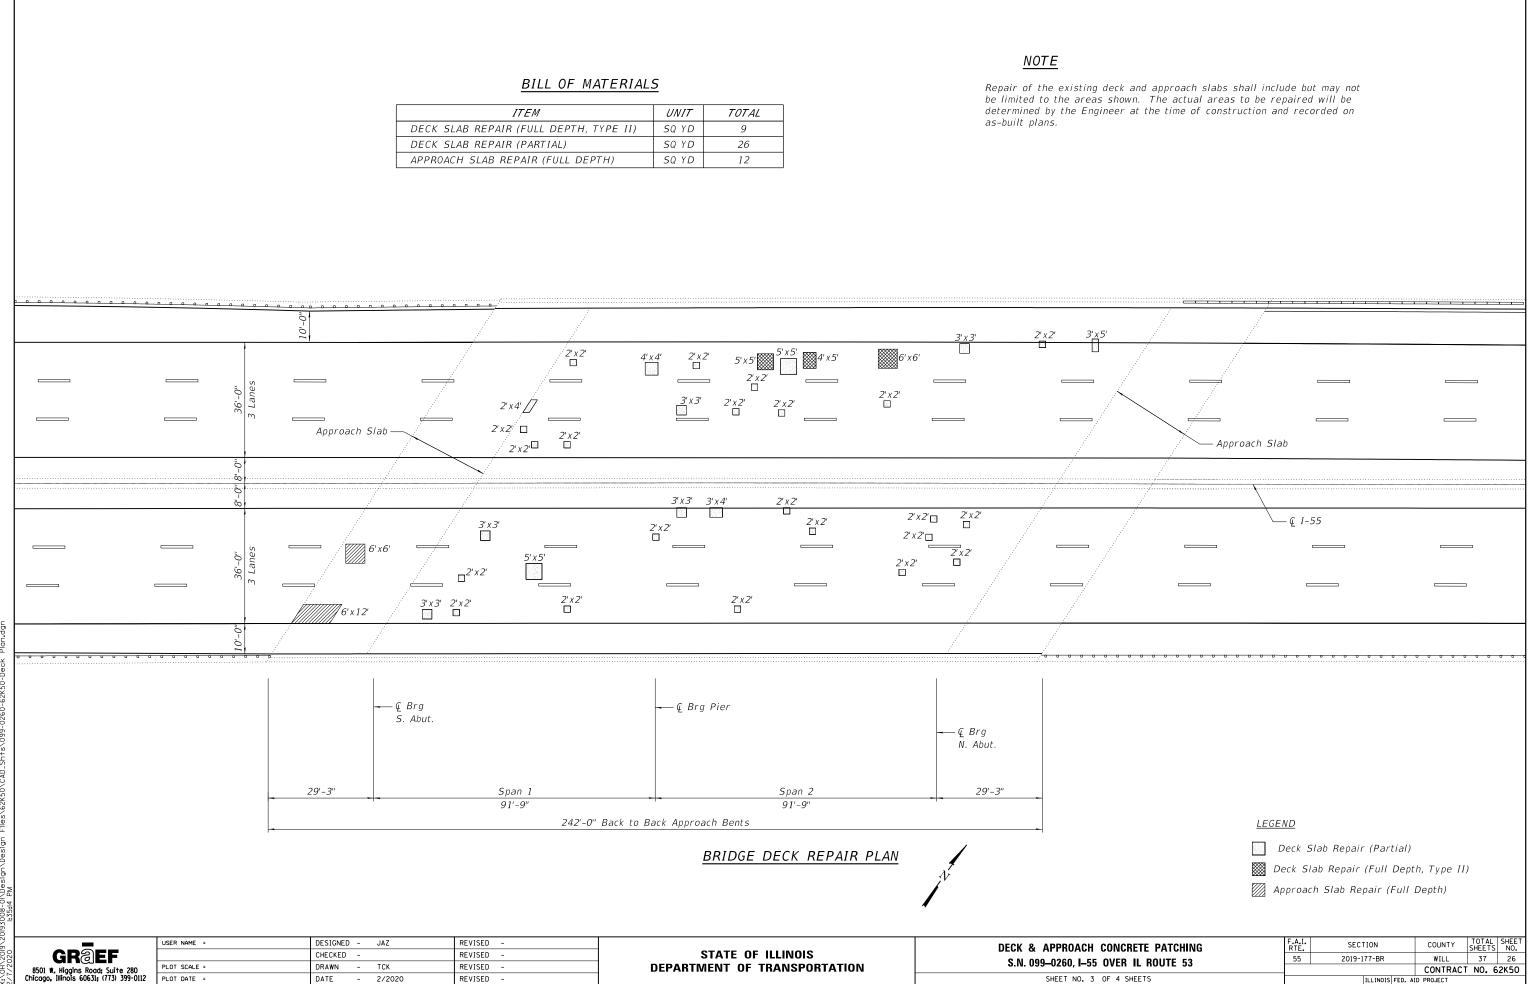

SHEET NO. 3 OF 4 SHEETS

#### STATE OF ILLINOIS DEPARTMENT OF TRANSPORTATION

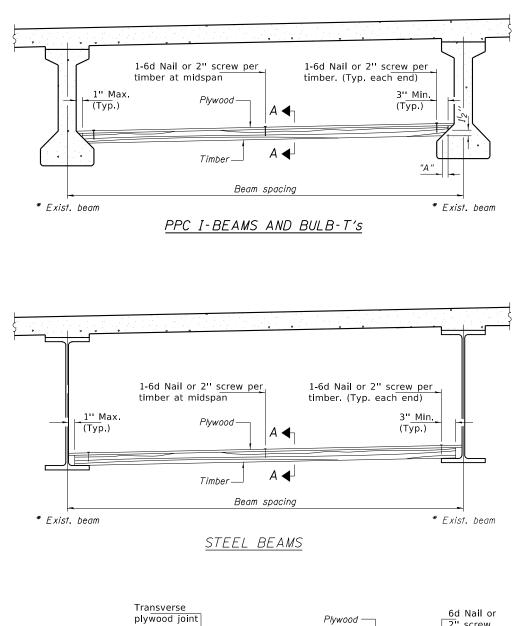

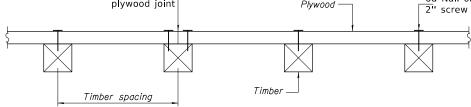

SECTION A-A

#### TIMBER SPACING Timber Sizes (in.) 4'' x 6'' 4" x 4" 6" x 6" with min. Beam with min. with min. Spacing Fb=775 psi Fb=775 psi Fb=575 psi Fv=135 psi Fv=135 psi Fv=125 psi (ft.)

	10-155 psi 10-155 psi		1 v – 125 psi
	Maximui	m Timber Spac	ing (in.)
4.5	16	16	16
4.75	16	16	16
5.0	16	16	16
5.25	16	16	16
5.5	16	16	16
5.75	16	16	16
6.0	16	16	16
6.25	12	16	16
6.5	12	16	16
6.75	12	16	16
7.0	8	16	16
7.25	8	16	16
7.5	8	16	16
7.75	8	16	16
8.0	8	12	16
8.25	8	12	16
8.5	6	12	12
8.75	6	12	12
9.0	6	8	12

PPC I-BEAMS AND BULB-T's

BEAM	"A "
36″ I-Beam	1'2''
42′′ I-Beam	1'2''
48'' I-Beam	1'2''
54″ I-Beam	1 <sup>5</sup> 8″
63'' Bulb-T	3 <sup>3</sup> 8''
72'' Bulb-T	3 <sup>3</sup> 8''

PPS-1	01-22-09							
	USER NAME =	DESIGNED - JAZ	REVISED -	CTATE OF ULINOIS	PERMANENT PROTECTIVE SHIELD	F.A. RTE	SECTION	COUNTY TOTAL SHEET SHEETS NO.
GR@EF		CHECKED -	REVISED -	STATE OF ILLINOIS		55	2019-177-BR	WILL 37 27
	PLOT SCALE =	DRAWN - TCK	REVISED -	DEPARTMENT OF TRANSPORTATION	S.N. 099-0260, I-55 OVER IL ROUTE 53			CONTRACT NO. 62K50
8501 W. Higgins Road; Suite 280 Chicago, Illinois 60631; (773) 399-0112	PLOT DATE =	DATE - 2/2020	REVISED -		SCALE: SHEET 4 OF 4 SHEETS STA. TO STA.		ILLINOIS FED	AID PROJECT

<u>Notes</u>: See special provision for Permanent Protective Shield System.

Timber sizes shown are nominal sizes. Rough sawn timber of the dimensions shown will also be considered acceptable.

The minimum Fb and Fv values shown are the tabulated design values given in the National Design Specification for Wood Construction for No. 2 Spruce-Pine-Fir without adjustment factors applied. Better grades or other species with equal or higher allowable stresses will also be considered acceptable.

The timber spacings shown have been determined using allowable stresses with all adjustment factors necessary for the anticipated service conditions. All timber shall be treated.

Plywood shall be  $\frac{5}{6}$ " rated Exterior type plywood by APA.

Plywood shall be placed such that the face grain is perpendicular to the timber supports. When less than a full sheet (4' width) of plywood is used, the width of the strip used shall not be less than 2'.


Transverse plywood joints shall be supported by timbers.


When 4" x 6" timbers are used, they shall be placed such that the wide face is horizontal and the narrow face is vertical.

Design load = 200 psf.

Item	Unit	Total
Protective Shield (Permanent)	Sq. Yd.	2,085

#### PERMANENT PROTECTIVE SHIELD

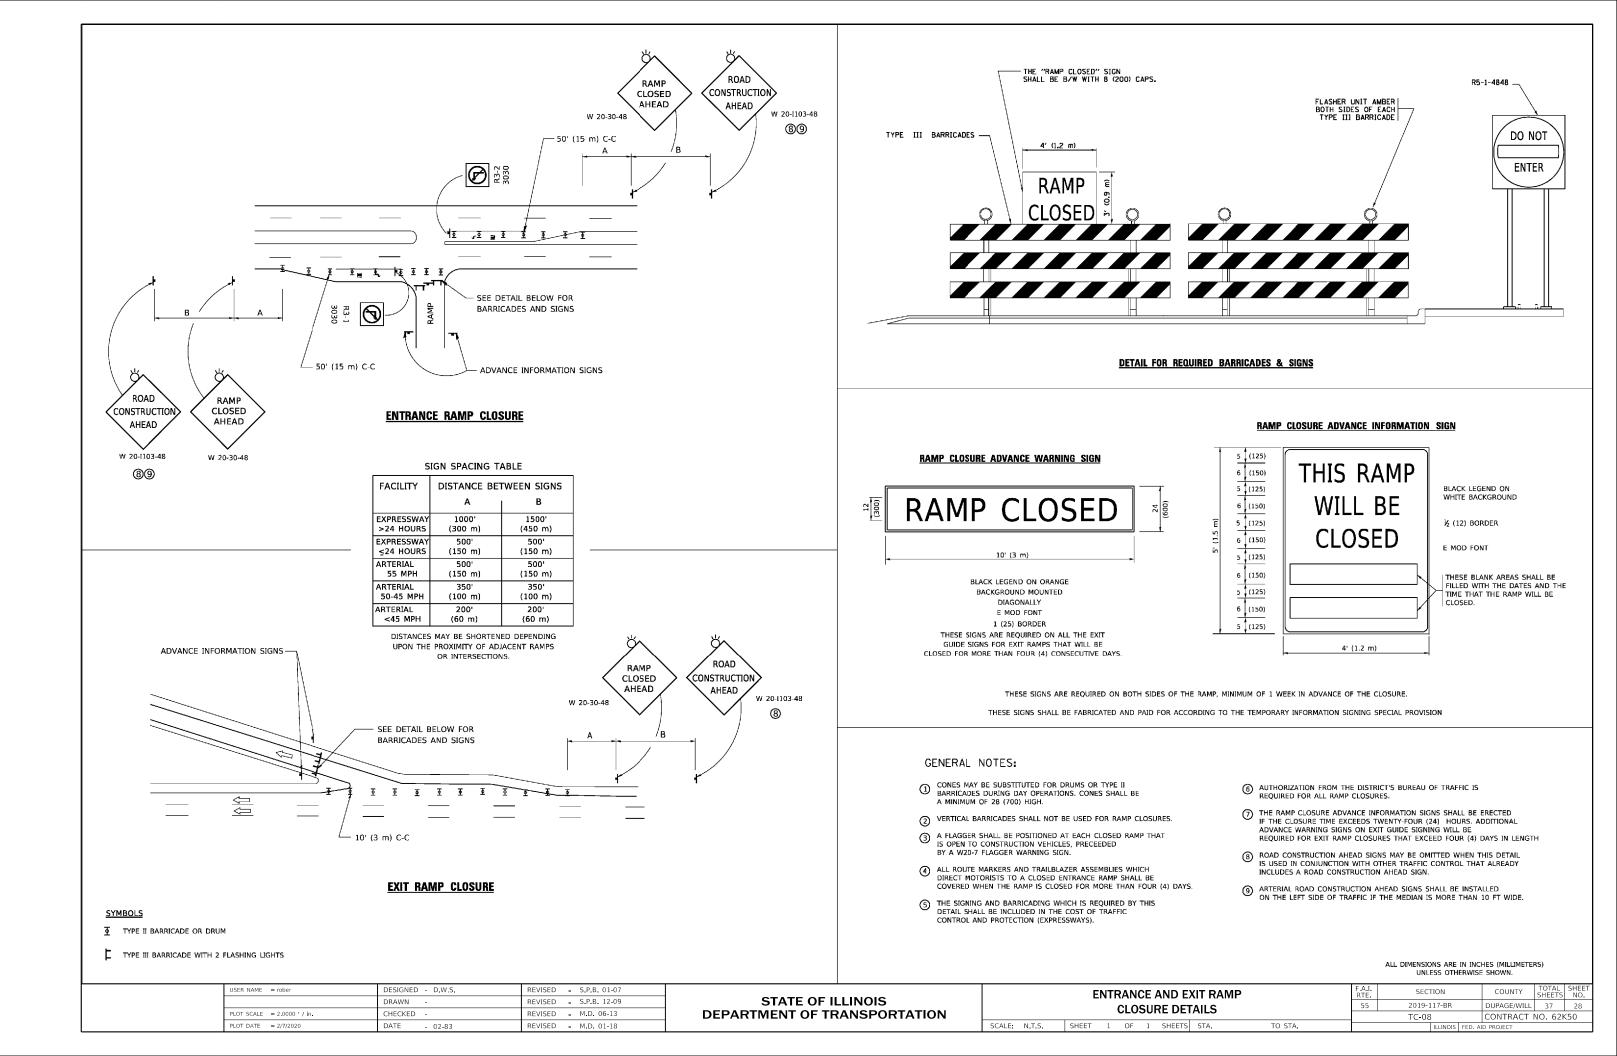

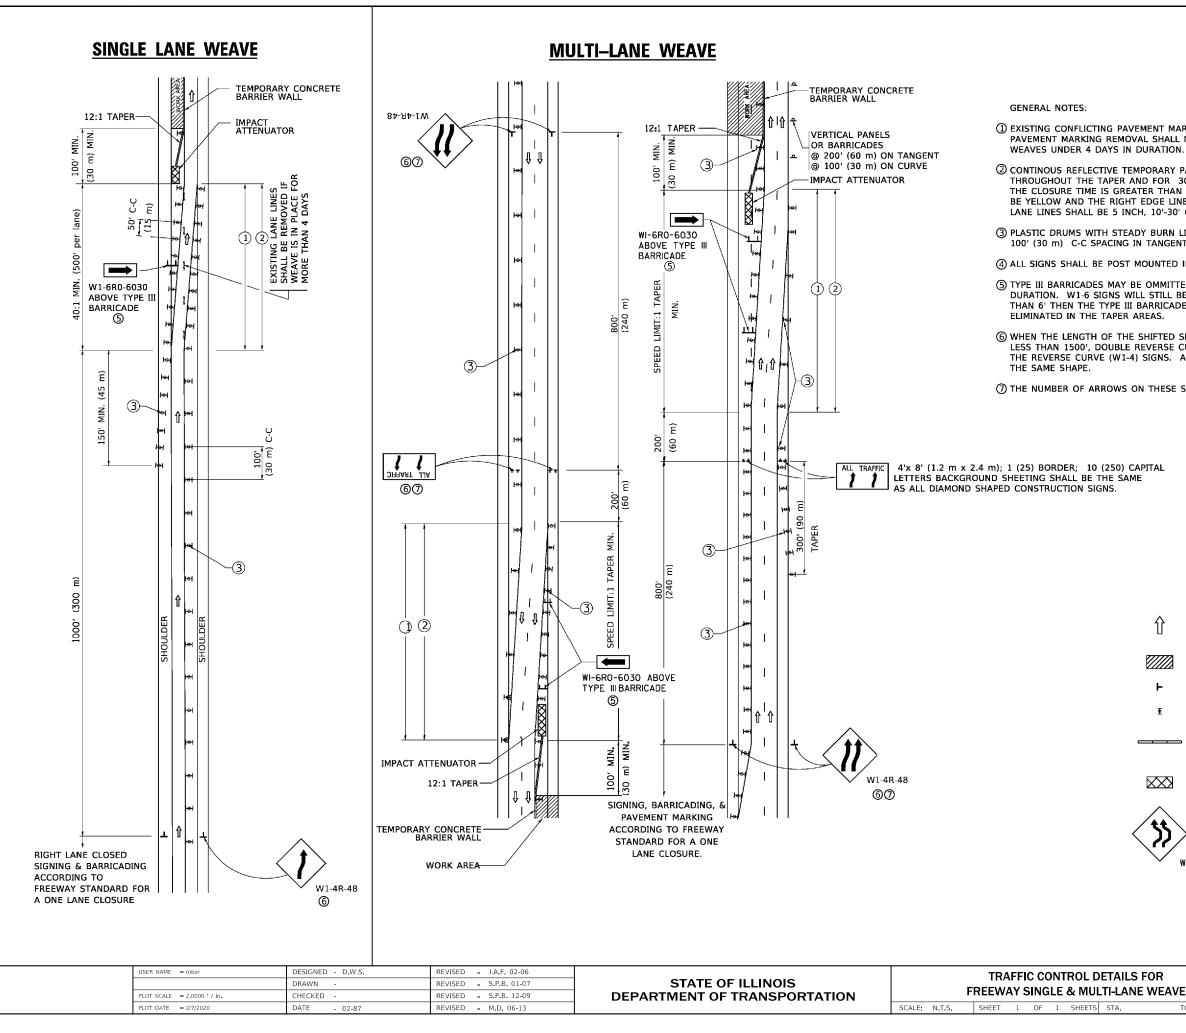

(1) EXISTING CONFLICTING PAVEMENT MARKING LINES SHALL BE REMOVED. PAVEMENT MARKING REMOVAL SHALL NOT BE REQUIRED FOR SINGLE LANE

(2) CONTINOUS REFLECTIVE TEMPORARY PAVEMENT MARKING TAPE SHALL BE PLACED THROUGHOUT THE TAPER AND FOR 300' (90 m) ALONG SIDE THE WORK AREA WHERE THE CLOSURE TIME IS GREATER THAN FOURTEEN DAYS. THE LEFT EDGE LINE SHALL BE YELLOW AND THE RIGHT EDGE LINE SHALL BE WHITE. FOR MULTI-LANE WEAVES LANE LINES SHALL BE 5 INCH, 10'-30' (3 m-9 m) SKIP DASH, WHITE.

(3) PLASTIC DRUMS WITH STEADY BURN LIGHTS AT 50' (15 m) C-C SPACING IN TAPERS AND 100' (30 m) C-C SPACING IN TANGENTS.

(4) ALL SIGNS SHALL BE POST MOUNTED IF THE CLOSURE TIME EXCEEDS FOUR DAYS.

(5) TYPE III BARRICADES MAY BE OMMITTED FOR SINGLE-LANE WEAVES UNDER 24-HOURS IN DURATION. W1-6 SIGNS WILL STILL BE REQUIRED. IF THE WIDTH OF OFFSET IS LESS THAN 6' THEN THE TYPE III BARRICADE WITH ATTACHED ARROW SIGN PANEL CAN BE

(6) WHEN THE LENGTH OF THE SHIFTED SEGMENT (DISTANCE BETWEEN WEAVE POINTS) IS LESS THAN 1500', DOUBLE REVERSE CURVE SIGNS (W24-1) SHOULD BE USED INSTEAD OF THE REVERSE CURVE (W1-4) SIGNS. ARROWS ON THE 4'X8' "ALL TRAFFIC" SIGNS SHALL BE

(7) THE NUMBER OF ARROWS ON THESE SIGNS SHALL MATCH THE NUMBER OF LANES OPEN TO TRAFFIC.

#### SYMBOLS

- DIRECTION OF TRAFFIC
- WORK AREA
- SIGN ON PORTABLE OR PERMANENT SUPPORT н
- TYPE II BARRICADE OR DRUM WITH MONO-DIRECTIONAL ¢ STEADY BURNING LIGHT

TEMPORARY CONCRETE BARRIER WALL

 $\times$ 

IMPACT ATTENUATOR




ALL DIMENSIONS ARE IN INCHES (MILLIMETERS) UNLESS OTHERWISE SHOWN

		F.A.I. RTE	SECT	SECTION COUNTY		TOTAL SHEETS	SHEET NO.		
ULTI-LANE WEAVE		55	2019-117-BR		DUPAGE/WILL	37	29		
			TC-09	)		CONTRACT I	VO. 62k	<50	
TS	STA.	TO STA.			<b>ILLINOIS</b>	FED. A	D PROJECT		

USER NAME = footemj	DESIGNED - L.H.A.	REVISED - A. HOUSEH 10-15
	DRAWN -	REVISED - T. RAMMACHER 01
PLOT SCALE = 50.0000 ' / in.	CHECKED -	REVISED - A. SCHUETZE 07-0


	<b>NOTES:</b> 1 SIDE ROAD WITH A SPEED LIMIT OF A MPH (60 km/h) OR LESS AS SECTION OF THE CLOSED PORTION AFLEAD' SIGN 35 & x 36 (900x900) with a Limit of the main the main close to provide the ma
	<ul> <li>3. CONES MAY BE SUBSTITUTED FOR BARRICADES OR DRUMS AT HALF THE SPACING DURING DAY OPERATIONS. CONES SHALL BE A MINIMUM OF 28 (7 IN HEIGHT.</li> <li>WHEN THE SIDE ROAD LIES BETWEEN THE BEGINNING OF THE MAINLINE</li> <li>4. SIGNING AND THE WORK ZONE, A SINGLE HEADED ARROW (M6-1) SHALL BE USED IN LIEU OF THE DOUBLE HEADED ARROW (M6-4).</li> </ul>
STATE OF II Department of Tr	

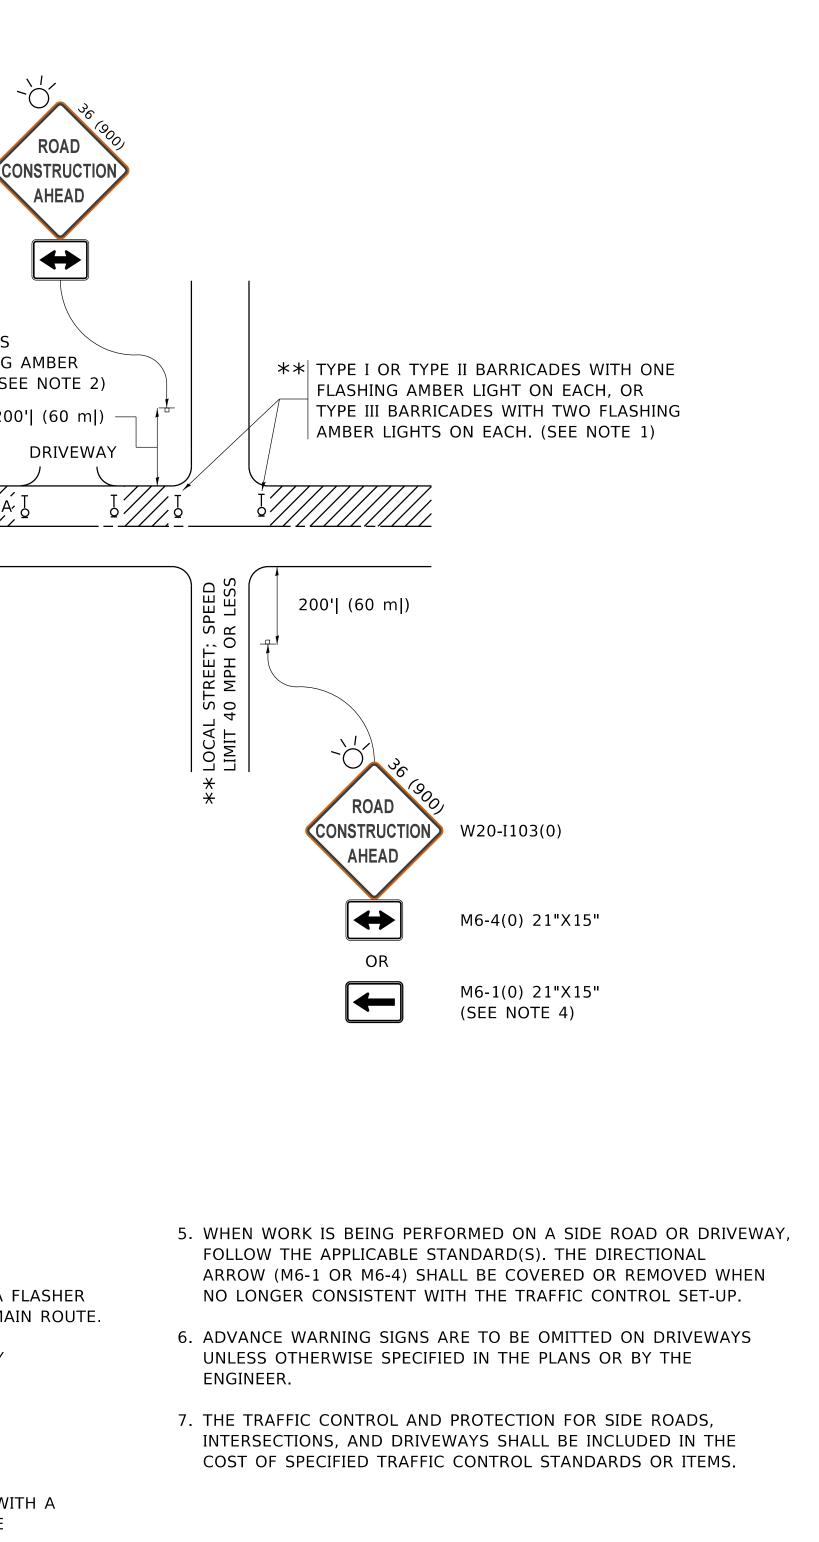


710)

## All dimensions are in inches (millimeters) unless otherwise shown.

F.A.I. RTE.	SECTION 1		COUNTY	TOTAL SHEETS	SHEET NO.
55	2019-117-BR	DUPAGE/WILL	37	30	
	TC-10		CONTRACT	NO. 62	2K50
	ILLINOIS	FED. A	ID PROJECT		
	RTE.	RTE.         SECTION           55         2019-117-BR <b>TC-10</b>	RTE. SECTION 55 2019-117-BR <b>TC-10</b>	RTE.SECTIONCOUNTY552019-117-BRDUPAGE/WILLTC-10CONTRACT	RTE.         SECTION         COUNTY         SHEETS           55         2019-117-BR         DUPAGE/WILL         37           TC-10         CONTRACT NO. 62

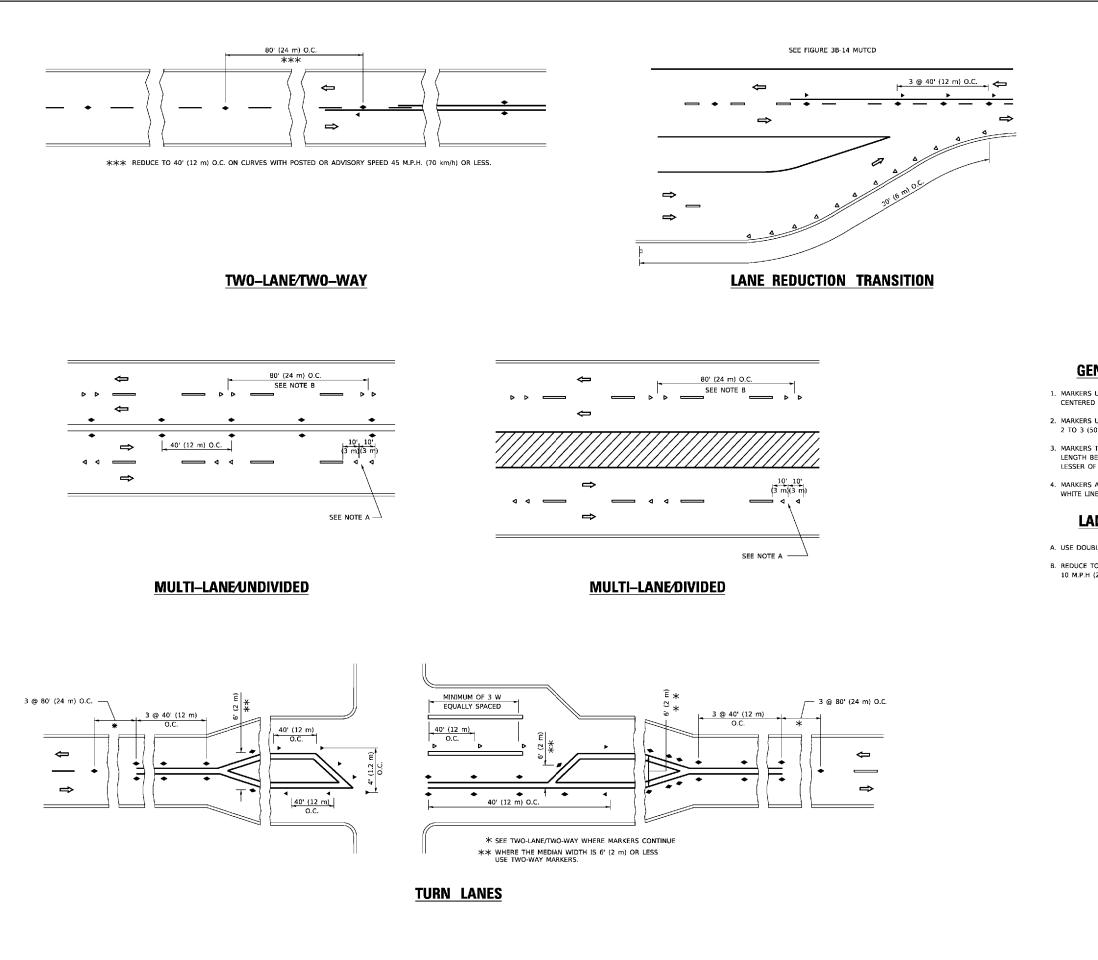

 	USER NAME = rober	DESIGNED -	REVISED - T. RAMMACHER 03-12-99			тури	CAL APPLIC	
LIN ENGINEERING, LTD		DRAWN -	REVISED - T. RAMMACHER 01-06-00	STATE OF ILLINOIS				
Consulting Engineers	PLOT SCALE = 2.0000 ' / in.	CHECKED -	REVISED - C. JUCIUS 09-09-09	DEPARTMENT OF TRANSPORTATION	RAISED REFLE		IENT MARK	.ER
Westmont, Illinois	PLOT DATE = 2/7/2020	DATE -	REVISED _ C. JUCIUS 07-01-13		SCALE: N.T.S.	SHEET 1 OF	F 1 SHEETS	5

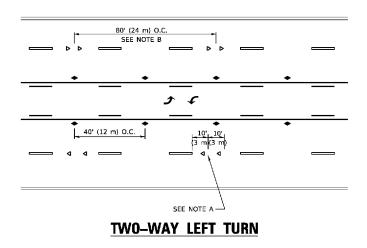

### **GENERAL NOTES**

- 1. MARKERS USED WITH DASHED LINES SHALL BE CENTERED IN THE GAP BETWEEN SEGMENTS.
- 2. MARKERS USED ADJACENT TO SOLID LINES SHALL BE OFFSET 2 TO 3 (50 TO 75) TOWARD TRAFFIC AS SHOWN.
- 3. MARKERS THROUGH TANGENTS LESS THAN 500' (150 m) IN LENGTH BETWEEN CURVES SHALL BE INSTALLED AT THE LESSER OF THE TWO CURVE SPACINGS.
- 4. MARKERS ARE TO BE USED ADJACENT TO BOTH SOLID WHITE LINES IN DUAL LEFT TURN LANES

### LANE MARKER NOTES

A. USE DOUBLE LANE LINE MARKERS SPACED AS SHOWN.

B. REDUCE TO 40' (12 m) O.C. ON CURVES WHERE ADVISORY SPEEDS ARE 10 M.P.H (20 km/h) LOWER THAN POSTED SPEEDS.

### **SYMBOLS**


- \_\_\_\_\_ YELLOW STRIPE
- WHITE STRIPE
- ONE-WAY AMBER MARKER
- ⊲ ONE-WAY CRYSTAL MARKER (W/O)
- TWO-WAY AMBER MARKER


#### **DESIGN NOTES**


- 1. DOUBLE LANE LINE MARKERS SHALL BE USED UNLESS SPECIFIED OTHERWISE.
- 2. EXCEPT AS SHOWN ON THE LANE REDUCTION TRANSITION AND FREEWAY EXIT RAMP DETAIL, MARKERS ARE NOT TO BE SPECIFIED ON RIGHT EDGE LINES.
- THE EXACT MARKER LIMITS, SPACING, AND COLOR SHALL BE INCLUDED IN THE PLANS WHEN STANDARD SPECIFICATIONS ARE NOT BEING USED.
- MARKERS SHOULD NOT BE USED ALONGSIDE CURBS EXCEPT FOR EXTREMELY SHORT SECTIONS OF CURBS WHERE NOT MORE THAN TWO MARKERS WOULD BE INVOLVED.


## All dimensions are in inches (millimeters) unless otherwise shown.

C/	CATIONS (ERS (SNOW-PLOW RESISTANT)			F.A.I. SECTION COUNTY			SHEET NO.
ĸF				2019-117-BR	DUPAGE/WILL	37	31
KERS (SNOW-FLOW RESISTANT)				TC-11	CONTRACT	NO. 62k	<50
TS	STA.	TO STA.		ILLINOIS FED. AI	D PROJECT		

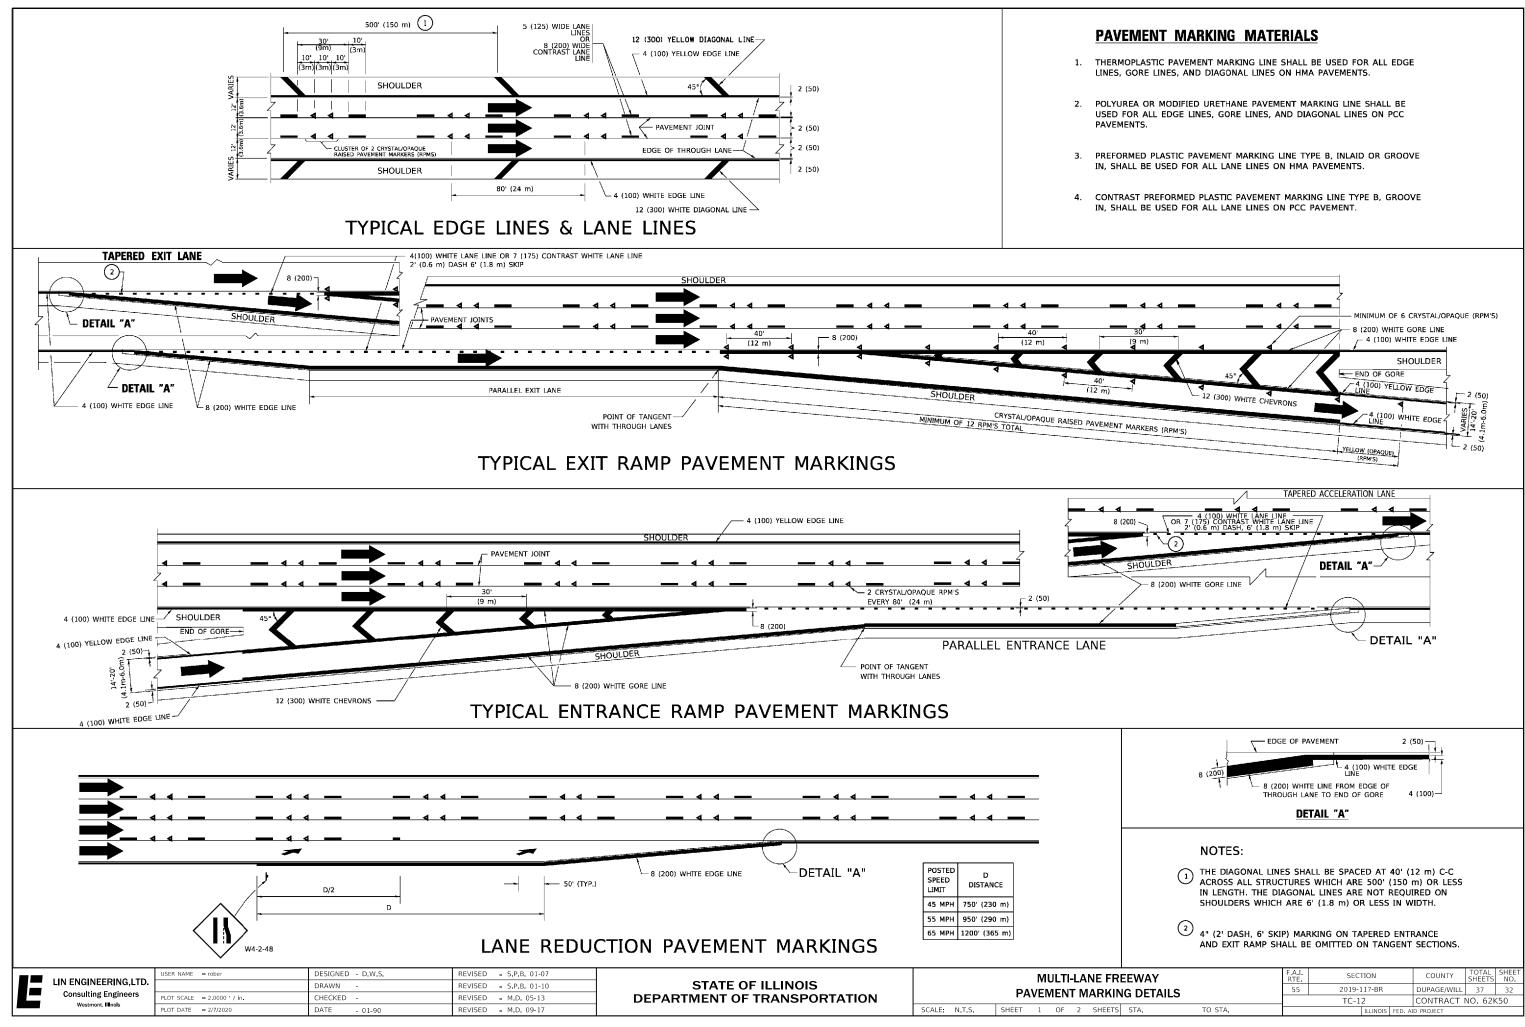

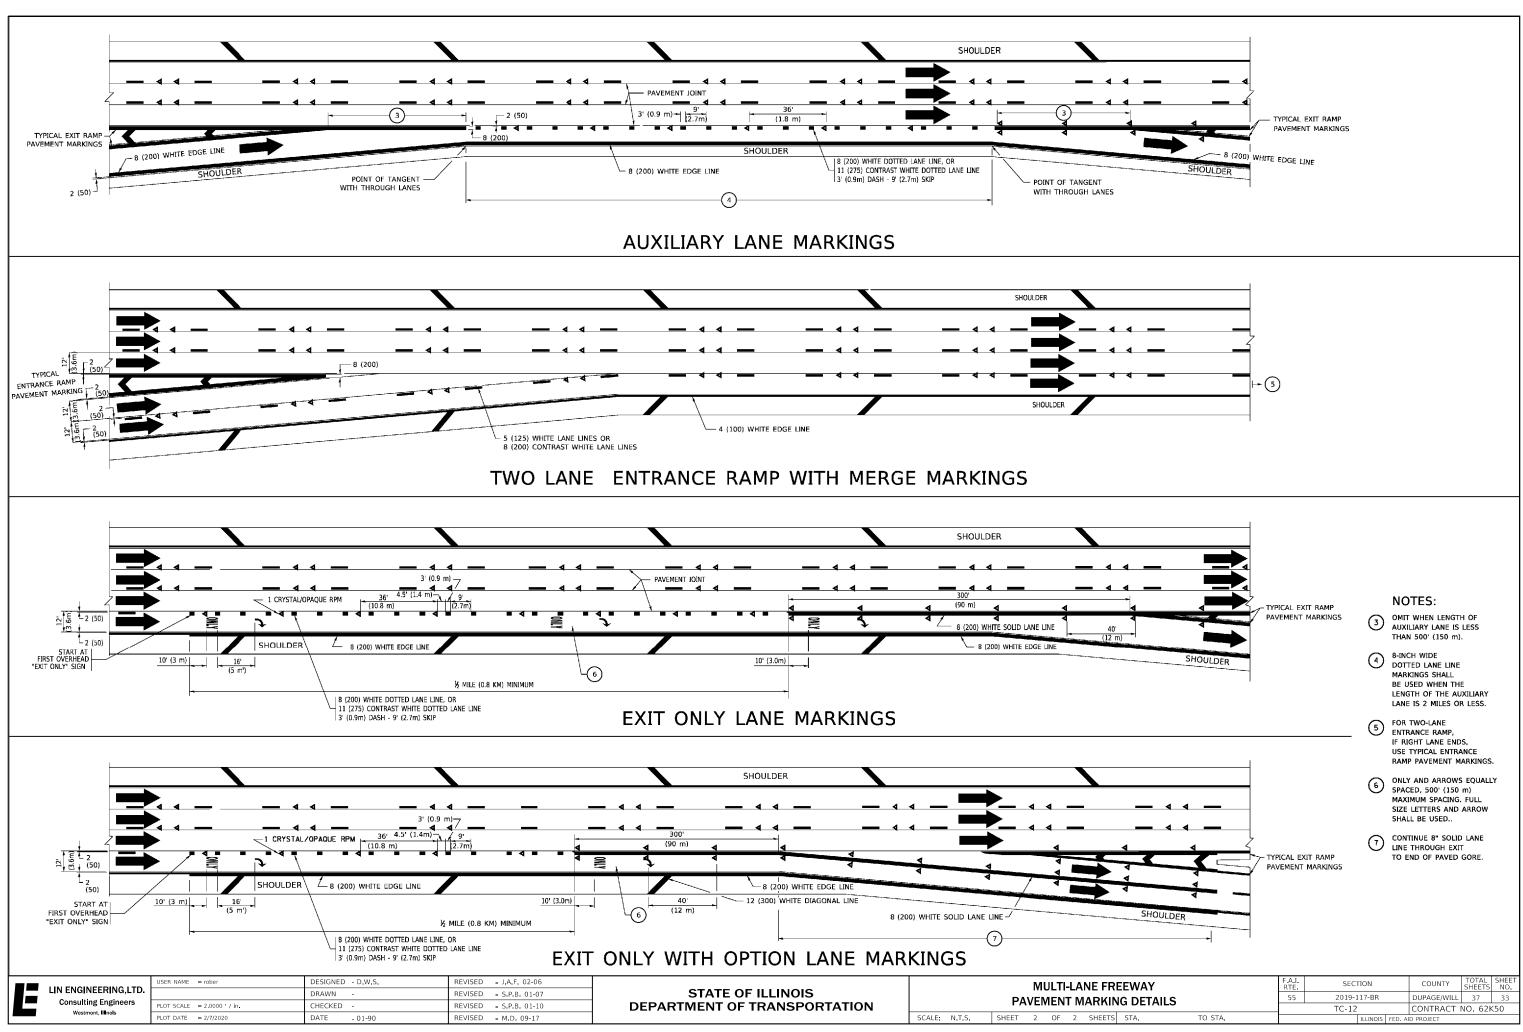

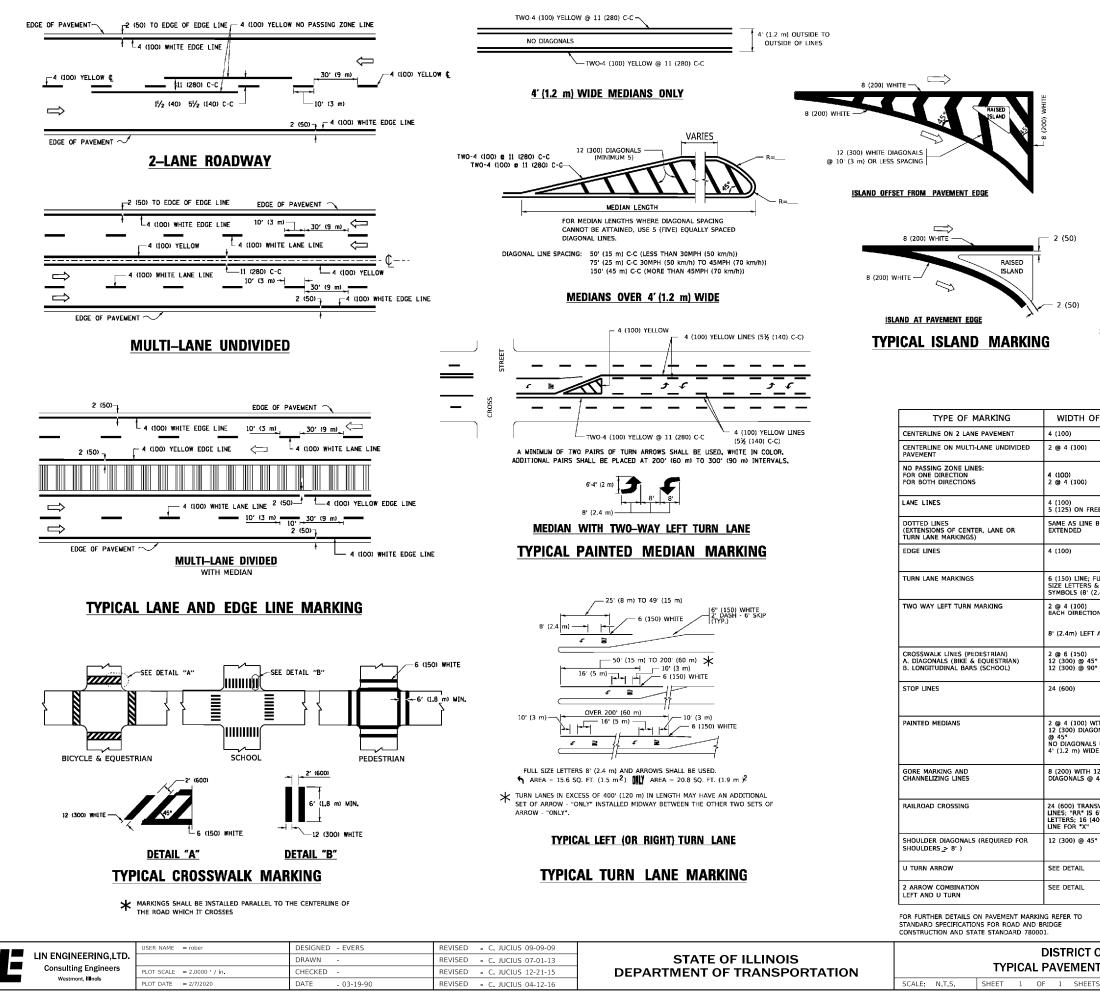


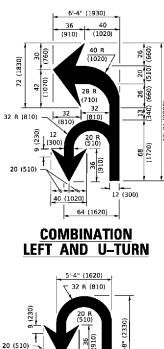

40 (1020

12 (300)

**U-TURN** 

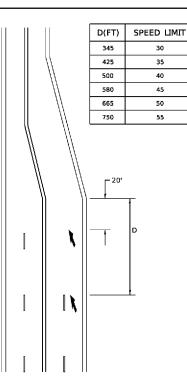

#### LANE REDUCTION TRANSITION


\* LANE REDUCTION ARROWS REQUIRED AT SPEEDS OF 45 MPH OR GREATER OR WHEN SPECIFIED IN PLANS.


F LINE	PATTERN	COLOR	SPACING / REMARKS
	SKIP-DASH	YELLOW	10' (3 m) LINE WITH 30' (9 m) SPACE
	SOLID	YELLOW	11 (280) C-C
	SOLID SOLID	YELLOW YELLOW	5½ (140) C-C FROM SKIP-DASH CENTERLINE 11 (280) C-C OMIT SKIP-DASH CENTERLINE BETWEEN
EEWAYS	SKIP-DASH SKIP-DASH	WHITE WHITE	10' (3 m) LINE WITH 30' (9 m) SPACE
BEING	SKIP-DASH	SAME AS LINE BEING EXTENDED	2' (600) LINE WITH 6' (1.8 m) SPACE
	SOLID	YELLOW-LEFT WHITE-RIGHT	OUTLINE MEDIANS IN YELLOW
=ULL & 2.4m))	SOLID	WHITE	SEE TYPICAL TURN LANE MARKING DETAIL
ON ARROW	SKIP-DASH AND SOLID IN PAIRS	YELLOW	10' (3 m) LINE WITH 30' (9 m) SPACE FOR SKIP-DASH; 5½ (140) C-C BETWEEN SOLID LINE AND SKIP-DASH LINE SEE TYP[CAL TWO-WAY LEFT TURN MARKING DETAIL
0 9	SOLID SOLID SOLID	WHITE WHITE WHITE	NOT LESS THAN 6' (1.8 m) APART 2' (600) APART 2' (600) APART SEE TYPICAL CROSSWALK MARKING DETAILS.
	SOLID	WHITE	PLACE 4' (1.2 m) IN ADVANCE OF AND PARALLEL TO CROSSWALK, IF PRESENT. OTHERWISE, PLACE AT DESIRED STOPPING POINT. PARALLEL TO CROSSROAD CENTERLINE, WHERE POSSIBLE
ATH ONALS 5 USED FOR 9E MEDIANS	SOLID	YELLOW: TWO WAY TRAFFIC WHITE: ONE WAY TRAFFIC	11 (280) C-C FOR THE DOUBLE LINE SEE TYPICAL PAINTED MEDIAN MARKING.
12 (300) 45°	SOLID	WHITE	DIAGONALS: 15' (4.5 m) C-C (LESS THAN 30MPH (50 km/h)) 20' (6 m) C-C 30MPH (50 km/h) TO 45MPH (70 km/h)) 30' (9 m) C-C (OVER 45MPH (70 km/h))
SVERSE 6' (1.8 m) 100)	SOLID	WHITE	SEE STATE STANDARD 780001 AREA OF: "R"=3.6 SQ, FT. (0.33 m ŽEACH "X"=54.0 SQ, FT. (5.0 m Ž
٠	SOLID	WHITE - RIGHT Yellow - Left	50' (15 m) C-C (LESS THAN 30MPH (50 km/h)) 75' (25 m) C-C (30 MPH (50 km/h) TO 45MPH (70 km/h)) 150' (45 m) C-C (0VER 45MPH (70 km/h))
	SOLID	WHITE	16.3 SF
	SOLID	WHITE	30.4 SF

All dimensions are in inches (millimeters) unless otherwise shown.

0	ONE		F.A.I. RTE	SECTION		COUNTY	TOTAL SHEETS	SHEET NO.	
IT MARKINGS		55	2019-117-BR			DUPAGE/WILL	37	34	
•••				TC-1	3		CONTRACT	NO. 62k	<50
ГS	STA.	TO STA.		ILLINOIS FED. /		FED. A	D PROJECT		


# TURN BAY ENTRANCE AT START **OF LANE CLOSURE TAPER**

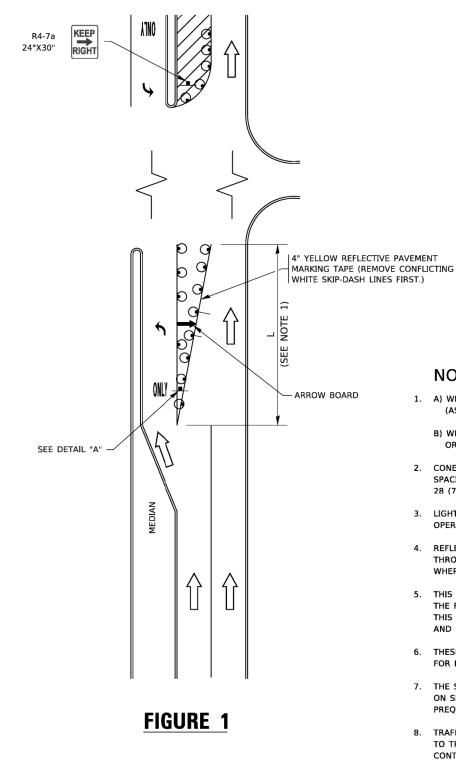

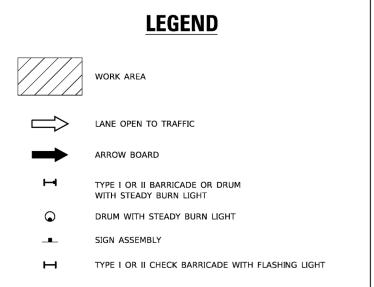


### NOTES:

- 1. A) WHEN "L" IS ≤ THE STORAGE LENGTH OF THE TURN LANE (AS SHOWN IN FIG. 1), USE FIGURE 1.
  - B) WHEN "L" IS > THE STORAGE LENGTH OF THE TURN LANE OR THE TURN LANE IS WITHIN THE LANE CLOSURE. USE FIGURE 2.
- 2. CONES MAY BE SUBSTITUTED FOR BARRICADES OR DRUMS AT HALF THE SPACING DURING DAY OPERATIONS. CONES SHALL BE A MINIMUM OF 28 (710) IN HEIGHT.
- 3. LIGHTS WILL NOT BE REQUIRED ON BARRICADES OR DRUMS FOR DAY OPERATIONS. ALL LIGHTS SHALL BE MONODIRECTIONAL.
- 4. REFLECTIVE TEMPORARY PAVEMENT MARKINGS SHALL BE PLACED THROUGHOUT THE BARRICADED AREAS OF EACH TURN BAY AS SHOWN WHERE THE CLOSURE TIME IS GREATER THAN FOURTEEN (14) DAYS.
- 5. THIS APPLICATION ALSO APPLIES WHEN WORK IS BEING PERFORMED IN THE RIGHT LANE(S) AND THE RIGHT TURN BAY IS TO REMAIN OPEN. UNDER THIS CONDITION, "RIGHT TURN LANE" R3-I100R 24 x 24 (600 x 600) AND M6-2R 21 x 15 (530 x 380) SHALL BE USED.
- 6. THESE CONTROLS SHALL SUPPLEMENT MAINLINE TRAFFIC CONTROL FOR LANE CLOSURES.
- 7. THE SIGNS SHALL BE MOUNTED ABOVE THE BARRICADES/DRUMS ON SEPARATE SIGN SUPPORTS THAT MEET NCHRP 350 OR MASH PREQUIREMENTS.
- 8. TRAFFIC CONTROL AND PROTECTION AT TURN BAYS (TO REMAIN OPEN TO TRAFFIC) SHALL BE INCLUDED IN THE COST OF SPECIFIED TRAFFIC CONTROL STANDARDS OR ITEMS.

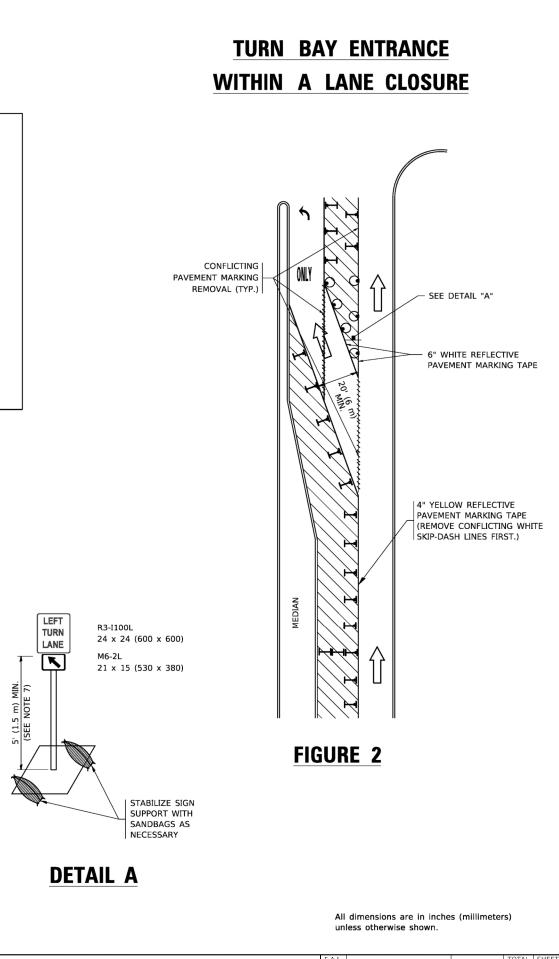


LIN ENGINEERING.LTD.	USER NAME = rober	DESIGNED - T. RAMMACHER 09-08-94	REVISED - R. BORO 09-14-09		TRAFFIC CONTROL AND PROTECTION AT TURN BAYS	F.A.I. RTE	SECTION	COUNTY TOTAL SHEET SHEETS NO.
Consulting Engineers		DRAWN - A HOUSEH 11-07-95	REVISED - A. SCHUETZE 07-01-13		(TO REMAIN OPEN TO TRAFFIC)	55	2019-117-BR	DUPAGE/WILL 37 34A
Westment IIInols	PLOT SCALE = 2.0000 / in	CHECKED - A HOUSEH 10-12-96	REVISED - A. SCHUETZE 09-15-16	DEPARTMENT OF TRANSPORTATION			TC-14	CONTRACT NO. 62K50
westhold, innois	PLOT DATE = 3/10/2020	DATE _ T. RAMMACHER 01-06-00	REVISED -		SCALE: N.T.S. SHEET 1 OF 1 SHEETS STA. TO STA.		ILLINOIS FED. /	AID PROJECT

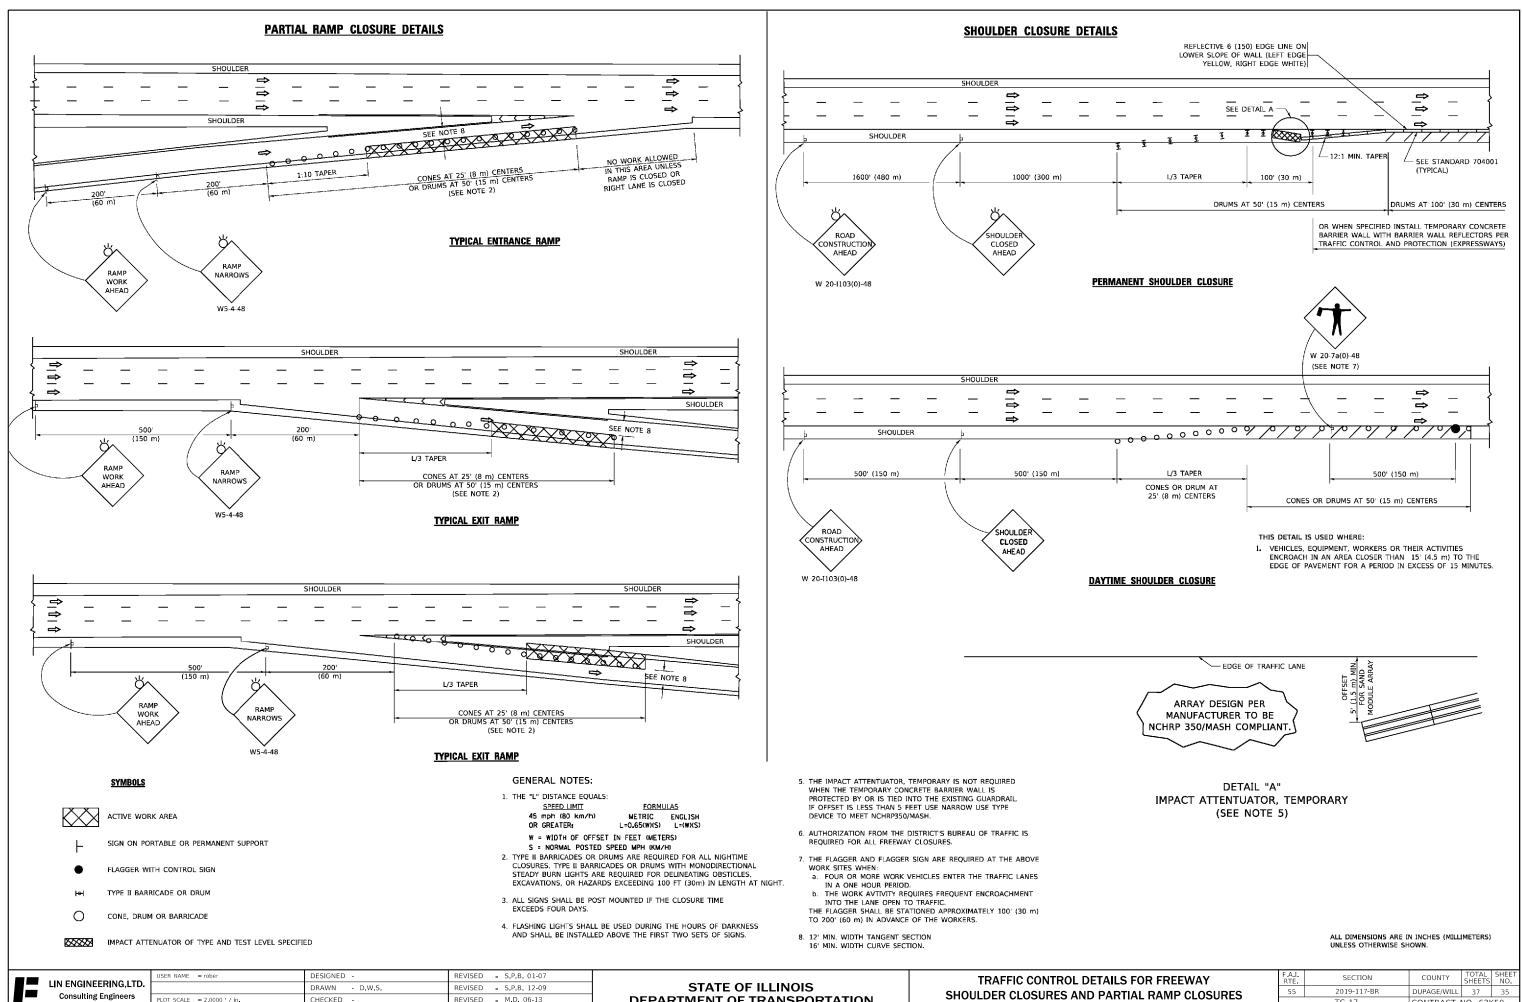


ſ		USER NAME = rober	DESIGNED -	REVISED S.P.B. 01-07		ТР	AFFIC CONTROL DETAI
	LIN ENGINEERING,LTD. Consulting Engineers		DRAWN D.W.S.	REVISED _ S.P.B. 12-09	STATE OF ILLINOIS		
	Consulting Engineers	PLOT SCALE = 2.0000 / in.	CHECKED -	REVISED M.D. 06-13	DEPARTMENT OF TRANSPORTATION	SHOULD	ER CLOSURES AND PA
	Westmont, Illinois	PLOT DATE = 2/7/2020	DATE - 11-96	REVISED - M.D. 01-18		SCALE: N.T.S.	SHEET 1 OF 1 SHEETS

ETS STA. TO STA 2019-117-BR TC-17 CONTRACT NO. 62K50

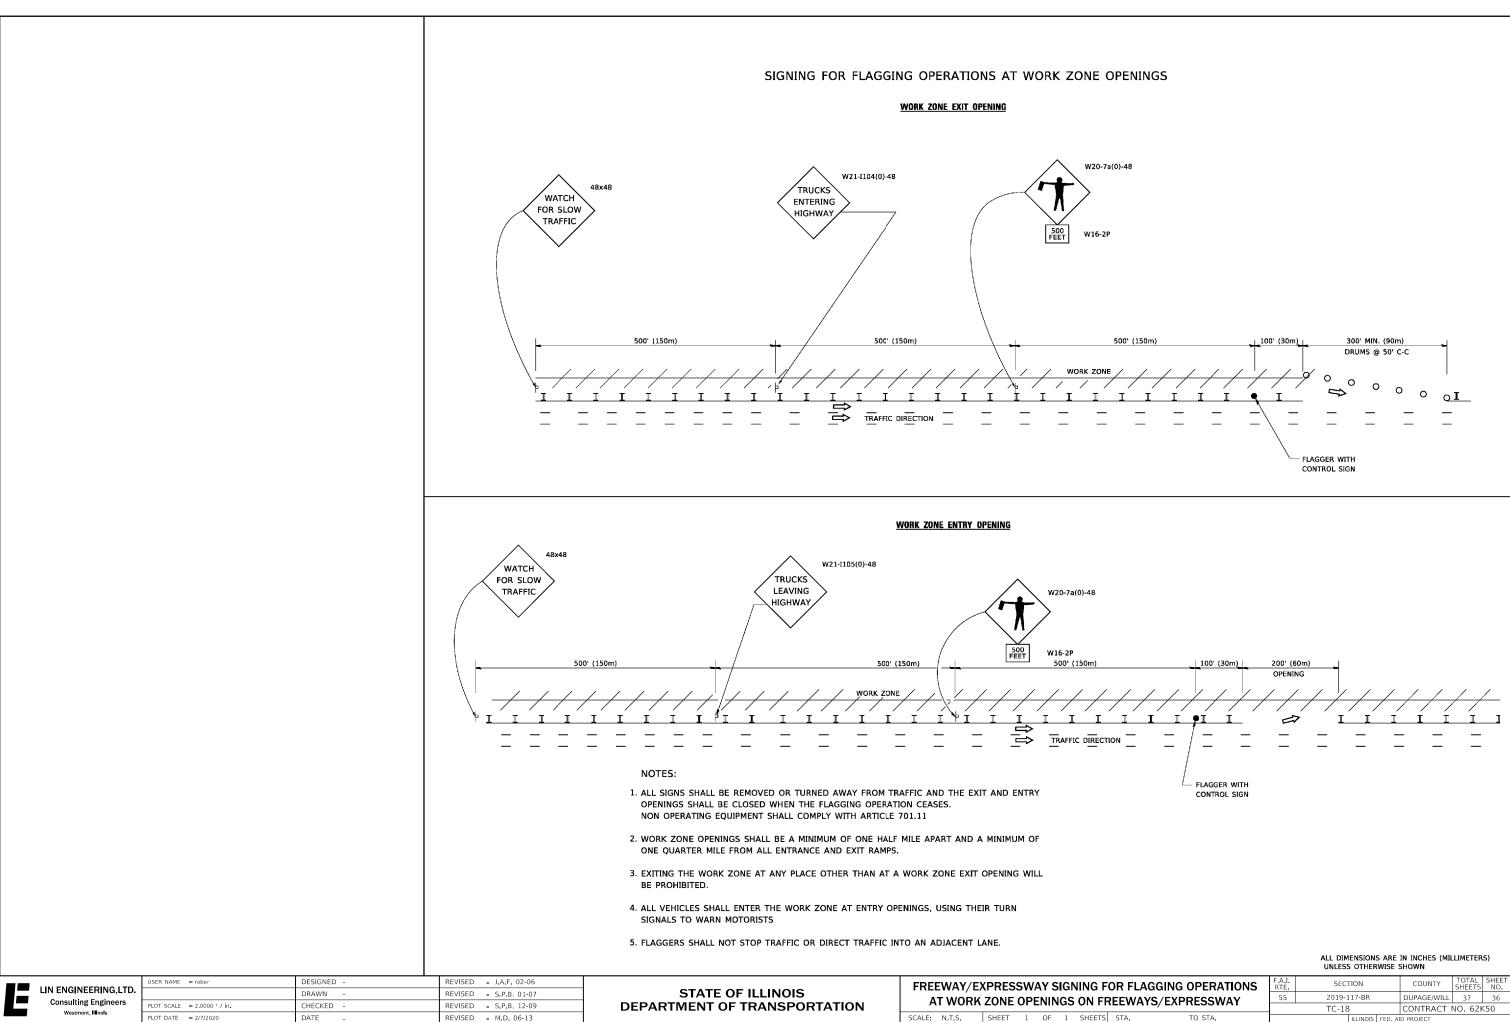

FOR FLA	GGING OPERATIONS	F.A.I. RTE	SEC	ΠΟΝ		COUNTY	TOTAL SHEETS	SHEET NO.
FREEWAYS/EXPRESSWAY		55	2019-117-BR			DUPAGE/WILL	37	36
			TC-18	3		CONTRACT	NO. 62k	<50
TS STA.	TO STA.			<b>ILLINOIS</b>	FED. A	D PROJECT		

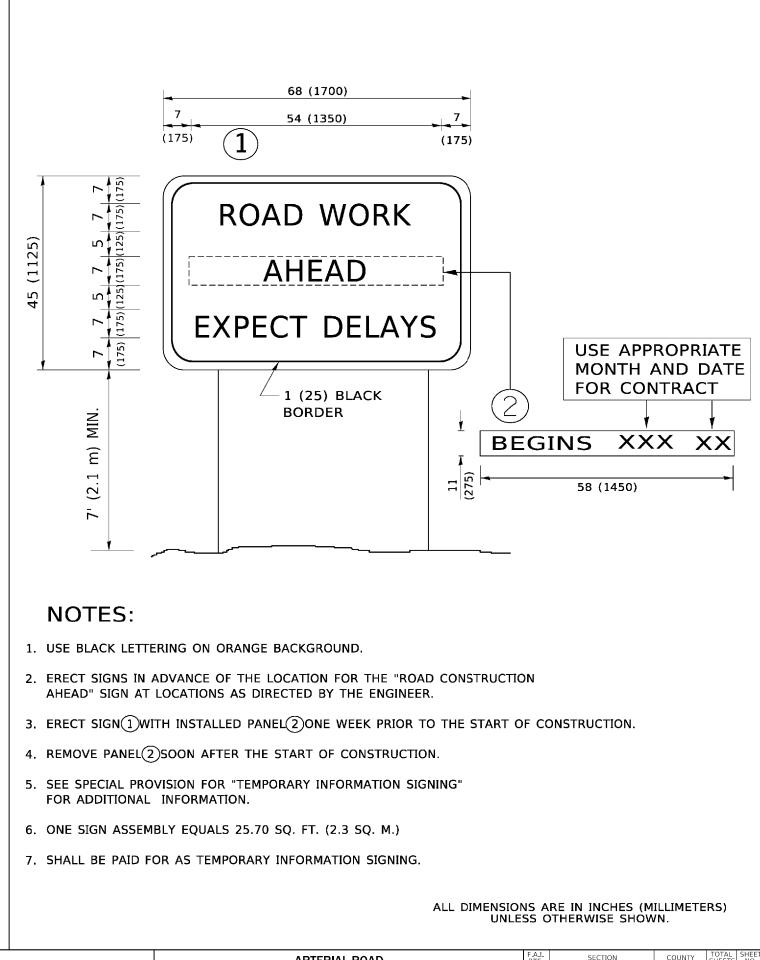

LIN ENGINEERING.LTD.	USER NAME = rober	DESIGNED -	REVISED J.A.F. 02-06		ARTERIAL ROAD	F	F.A.I. RTE	SECTION	COUNTY TOTAL SHEET SHEETS NO.
Consulting Engineers		DRAWN -	REVISED - S.P.B. 01-07	STATE OF ILLINOIS	INFORMATION SIGN		55	2019-117-BR	DUPAGE/WILL 37 37
Westmont, Illinois	PLOT SCALE = 2.0000 / in	CHECKED -	REVISED S.P.B. 12-09	DEPARTMENT OF TRANSPORTATION				TC-22	CONTRACT NO. 62K50
	PLOT DATE = 2/7/2020	DATE -	REVISED _ M.D. 06-13		SCALE: N.T.S. SHEET 1 OF 1 SHEETS STA. TO S	STA.		ILLINOIS FED.	AID PROJECT

ALL	DIMENSIONS	ARE IN	INCHES	(MILLIMETERS)
	UNLESS	OTHER	WISE SH	OWN.