
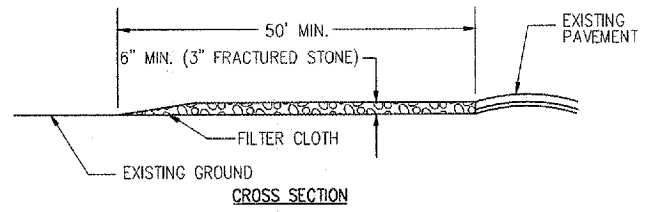
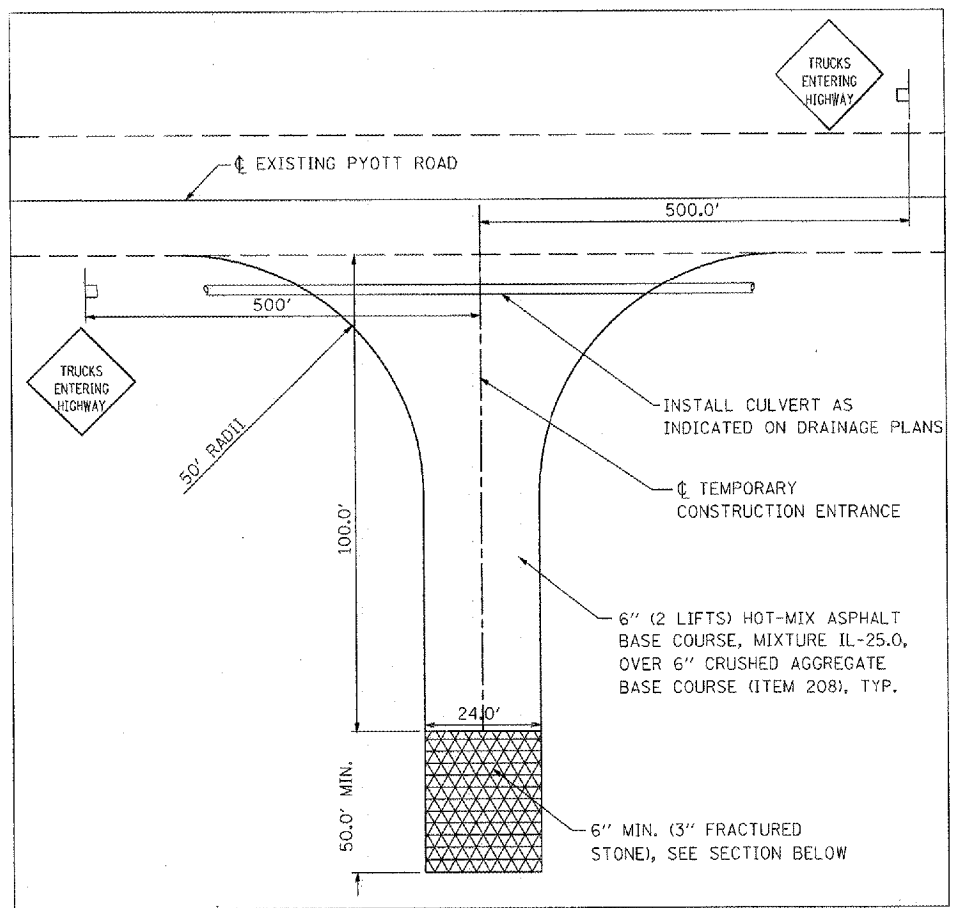
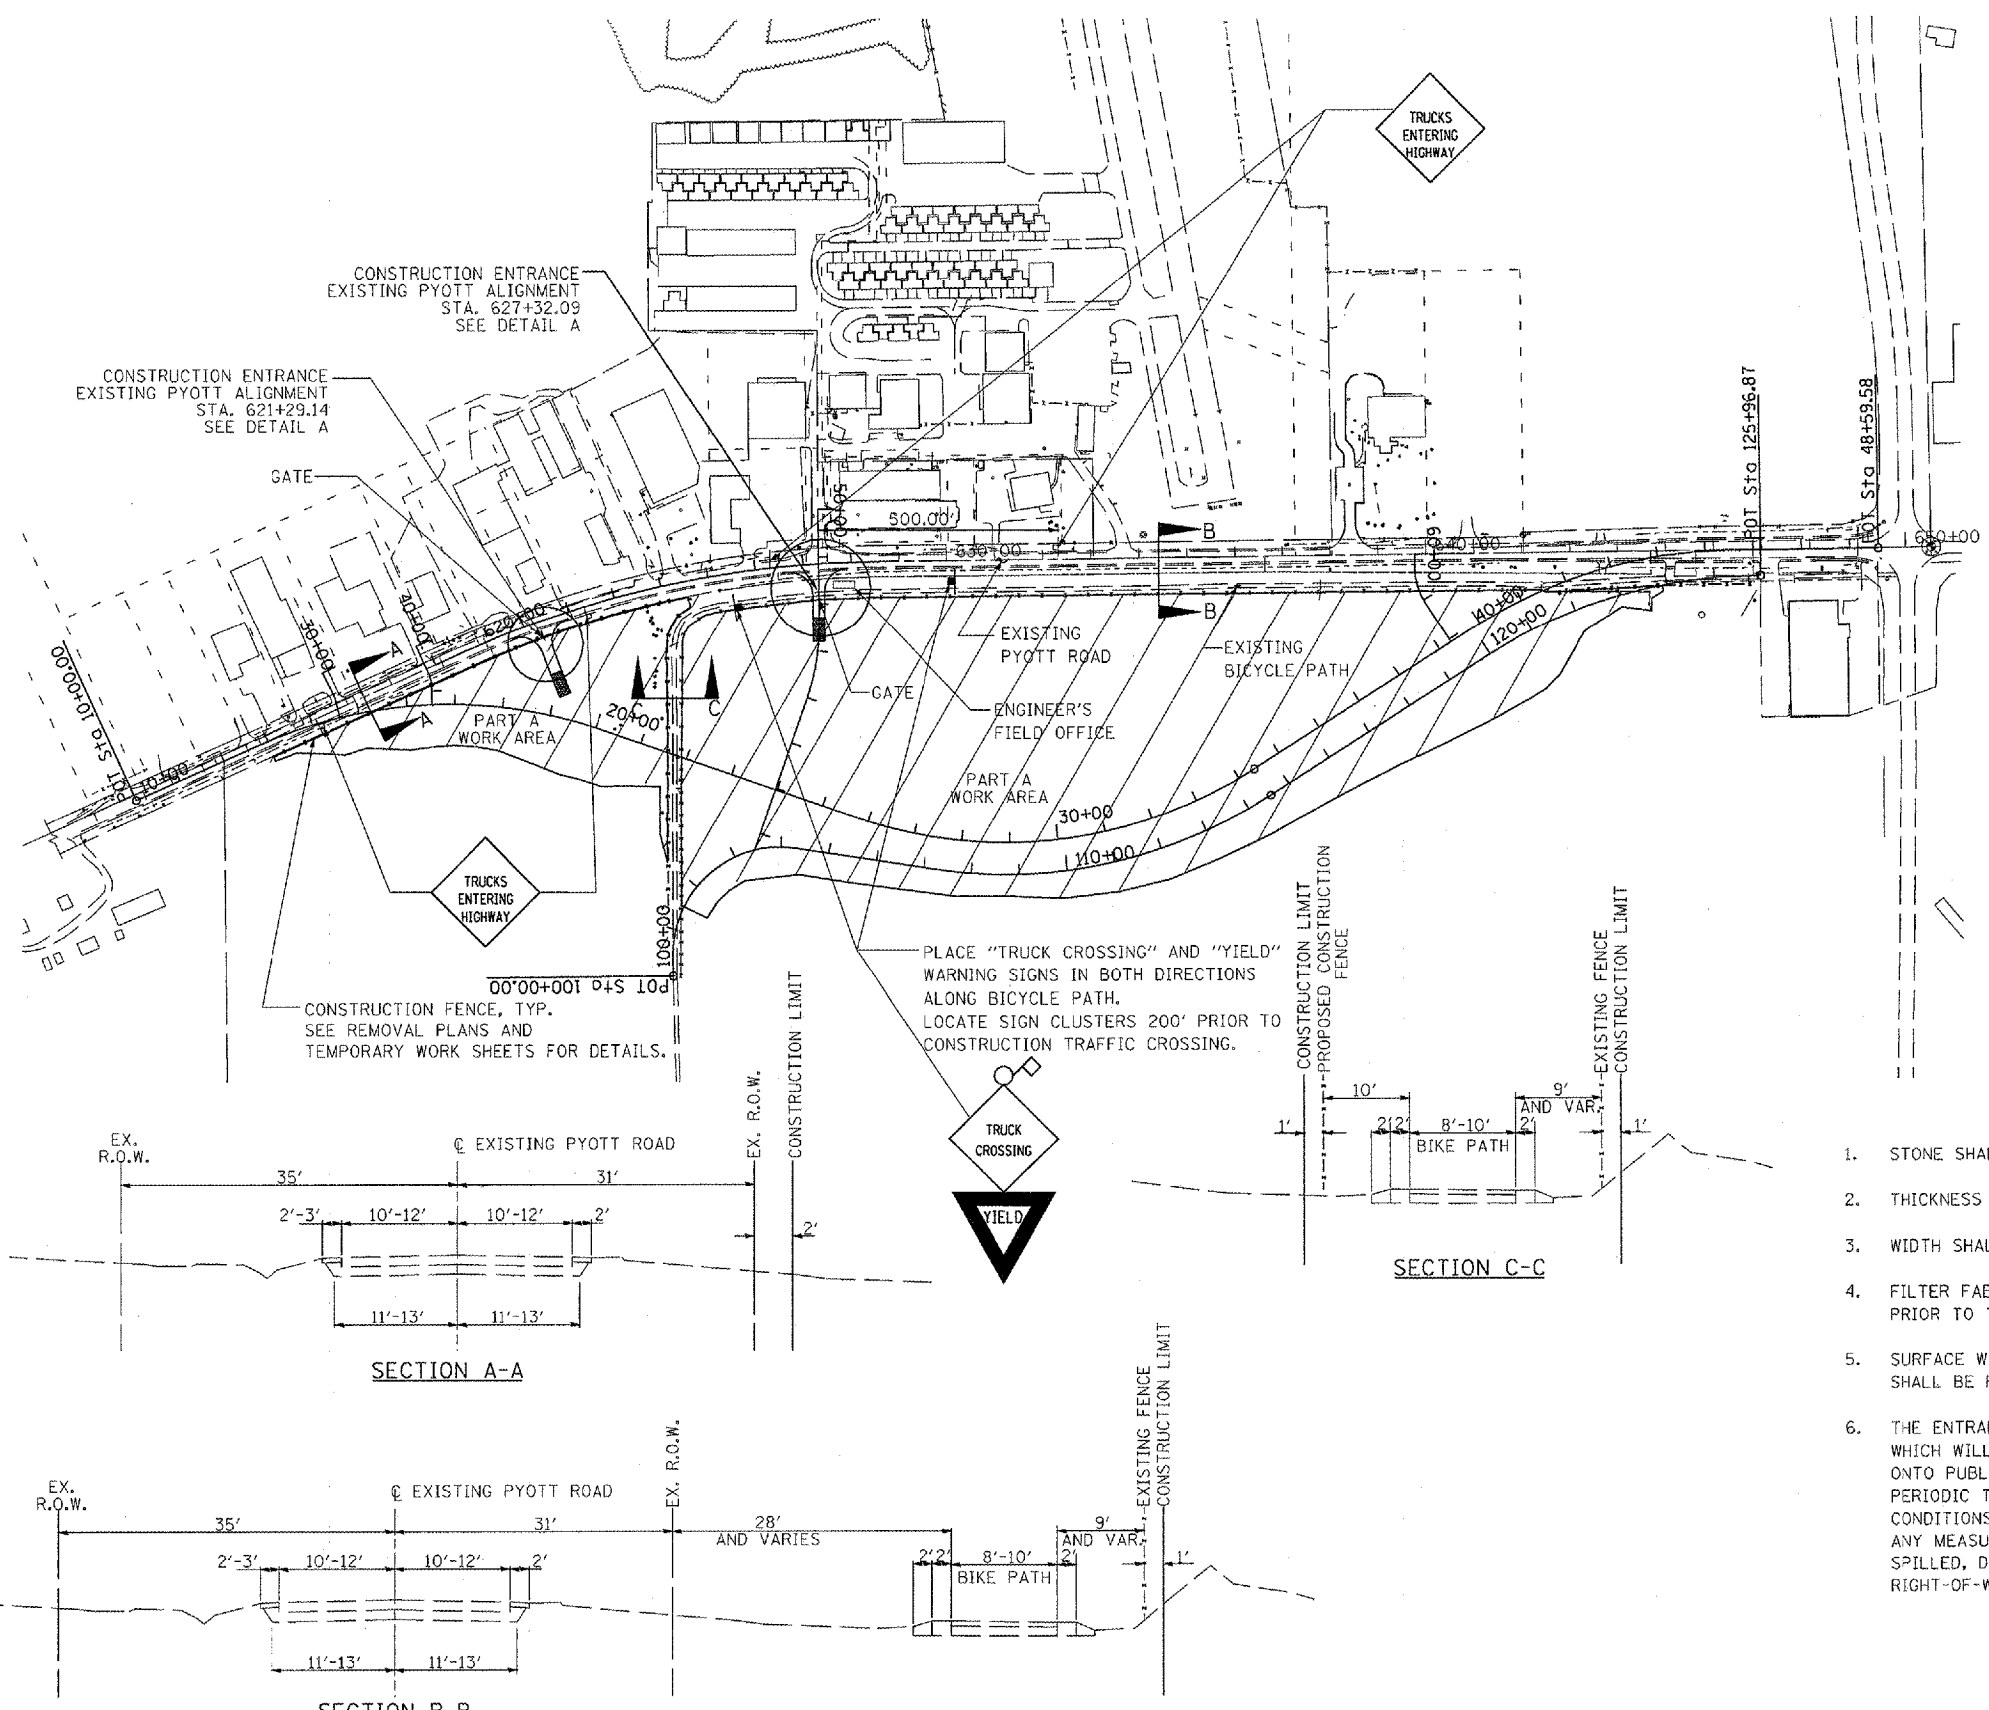
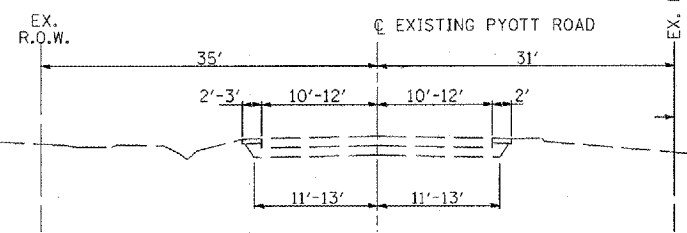


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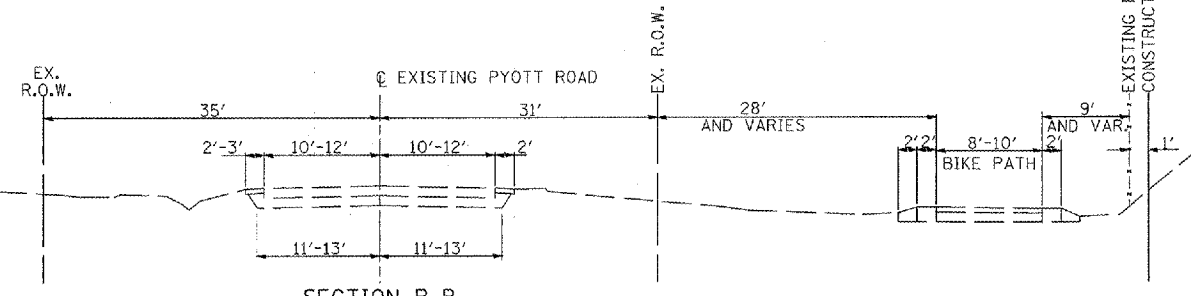


CONSTRUCTION FENCE, TYP. SEE REMOVAL PLANS AND TEMPORARY WORK SHEETS FOR DETAILS.

PLACE "TRUCK CROSSING" AND "YIELD" WARNING SIGNS IN BOTH DIRECTIONS ALONG BICYCLE PATH. LOCATE SIGN CLUSTERS 200' PRIOR TO CONSTRUCTION TRAFFIC CROSSING.

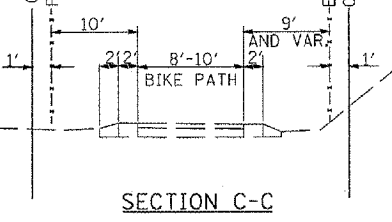

SECTION A-A



SECTION B-B

1. STONE SHALL BE 3" FRACTURED STONE.
2. THICKNESS SHALL NOT BE LESS THAN SIX INCHES.
3. WIDTH SHALL BE THE MINIMUM WIDTH OF THE ENTRANCE.
4. FILTER FABRIC SHALL BE PLACED OVER THE ENTIRE AREA PRIOR TO THE PLACEMENT OF STONE.
5. SURFACE WATER FLOWING OR DIVERTED TOWARD ENTRANCE SHALL BE PIPED ACROSS THE ENTRANCE.
6. THE ENTRANCE SHALL BE MAINTAINED IN A CONDITION WHICH WILL PREVENT TRACKING OR FLOWING OF SEDIMENT ONTO PUBLIC RIGHT-OF-WAYS. THIS MAY REQUIRE PERIODIC TOP DRESSING WITH ADDITIONAL STONE AS CONDITIONS DEMANDS AND REPAIR AND/OR CLEAN OUT OF ANY MEASURE USED TO TRAP SEDIMENT. ALL SEDIMENT SPILLED, DROPPED, WASHED OR TRACKED ONTO PUBLIC RIGHT-OF-WAYS MUST BE REMOVED IMMEDIATELY.
7. WHEELS SHALL BE CLEANED TO REMOVE SEDIMENT PRIOR TO ENTRANCE ONTO PUBLIC RIGHT-OF-WAYS. WHEN WASHING IS REQUIRED, IT SHALL BE DONE ON AN AREA STABILIZED WITH STONE WHICH DRAINS INTO AN APPROVED SEDIMENT TRAPPING DEVICE.
8. PERIODIC INSPECTION SHALL BE PERFORMED AND REQUIRED MAINTENANCE SHALL BE PROVIDED AFTER EACH RAIN EVENT.
9. ENTRANCE SHALL BE REMOVED AT PROJECT END AND SITE RESTORED TO THE SATISFACTION OF THE RESIDENT ENGINEER.
10. COST OF INSTALLING, MAINTAINING, REMOVING AND RESTORING ENTRANCE SHALL BE INCIDENTAL TO THE CONTRACT.
11. THE CONSTRUCTION ENTRANCE IS NOT MEANT TO SERVE AS A PERMANENT ACCESS DRIVEWAY.

TEMPORARY CONSTRUCTION ENTRANCE

PAID UNDER ITEM AR803017

FILE NAME =	USER NAME = McLa010958	DESIGNED - CBP	REVISED -
J:\05\Jobs\00841\0589021\Civil Part A\Sheet\A-C-SITEPLAN.dwg		DRAWN - CBP	REVISED -
PLOT SCALE = 100.0000 ' / IN.		CHECKED - BLB	REVISED -
PLOT DATE = 02/28/2008, 08:39 AM		DATE - 02/29/08	REVISED -

VILLAGE OF LAKE IN THE HILLS, ILLINOIS

SITE PLAN PYOTT ROAD

SCALE: 1"=200'

COUNTY	TOTAL SHEETS	SHEET NO.
MCHENRY	120	5