

F.A.S. RTE.	SECTION	COUNTY	TOTAL SHEETS	SHEET NO.
459	PARK ROADS	TAZEWELL	10	1
FED. ROAD DIST. NO.	ILLINOIS	CONTRACT NO. 46261		

INDEX OF SHEETS

- 1 COVER SHEET
- 2 GENERAL NOTES, TYPICAL SECTIONS & PAVEMENT STRUCTURE
- 3 SUMMARY OF QUANTITIES
- 4 ROADWAY PLAN AND PROFILE
- 5 CONSTRUCTION STAGING AND TRAFFIC CONTROL
- 6 EROSION CONTROL PLAN
- 7 RECORD STRUCTURAL PLANS
- 8 SOIL BORINGS
- 9 MISCELLANEOUS DETAILS
- 10 ROADWAY CROSS SECTIONS

HIGHWAY STANDARDS

- 000001-06 STANDARD SYMBOLS, ABBREVIATIONS AND PATTERNS
- 001006 DECIMAL OF AN INCH AND OF A FOOT
- 280001-07 TEMPORARY EROSION CONTROL SYSTEMS
- 701901-02 TRAFFIC CONTROL DEVICES
- 720001-01 SIGN PANEL MOUNTING DETAILS
- 720006-03 SIGN PANEL ERECTION DETAILS
- BLR 21-9 TYPICAL APPLICATION OF TRAFFIC CONTROL DEVICES FOR CONSTRUCTION ON RURAL LOCAL HIGHWAYS
- BLR 22-7 TYPICAL APPLICATION OF TRAFFIC CONTROL DEVICES FOR RURAL LOCAL HIGHWAYS (2-LANE 2-WAY RURAL TRAFFIC) (ROAD CLOSED TO THRU TRAFFIC)

PROJECT DESCRIPTION

THE PROPOSED PROJECT CONSISTS OF REMOVING STRUCTURE NO 090-3041, AN EXISTING CONCRETE DECK BEAM BRIDGE SUPPORTED UPON CLOSED TIMBER ABUTMENTS AND TIMBER PILES, AND THE PARTIAL REMOVAL OF THE ADJACENT SHEET PILING AND STOP LOG STRUCTURE AND REPLACEMENT WITH A 36" DIAMETER DUCTILE IRON PIPE CULVERT, ROADWAY ROCK AND EARTH EMBANKMENT AND A BITUMINOUS SURFACE TREATMENT ROAD SURFACE.

0 50' 100' 150' — 1" = 50' (CONSTRUCTION STAGING & TRAFFIC CONTROL)

0 20' 50' 100' — 1" = 20' (PLAN AND PROFILE SHEET) (EROSION CONTROL (SWPPP) PLAN)

0 5' 10' 15' — 1" = 5' (CROSS SECTION)



FULL SIZE PLANS HAVE BEEN PREPARED USING STANDARD ENGINEERING SCALES. REDUCED SIZED PLANS WILL NOT CONFORM TO STANDARD SCALES. IN MAKING MEASUREMENTS ON REDUCED PLANS, THE ABOVE SCALES MAY BE USED.

J.U.L.I.E.
JOINT UTILITY LOCATION INFORMATION FOR EXCAVATION
1-800-892-0123
OR 811

PROJECT ENGINEER: LANCE KIDD (217) 785-2933
CONTRACT NO. 46261

STATE OF ILLINOIS
DEPARTMENT OF TRANSPORTATION
DIVISION OF HIGHWAYS
IDOT / IDNR STATEWIDE
SPRING LAKE STATE PARK
CAUSEWAY STRUCTURE REMOVAL
SECTION PARK ROADS
TAZEWELL COUNTY

IDNR PROJECT NO. 1-12-011
C-30-019-13
3RD. P.M.

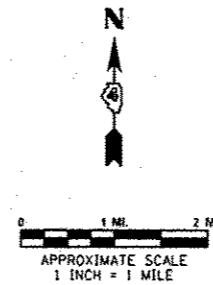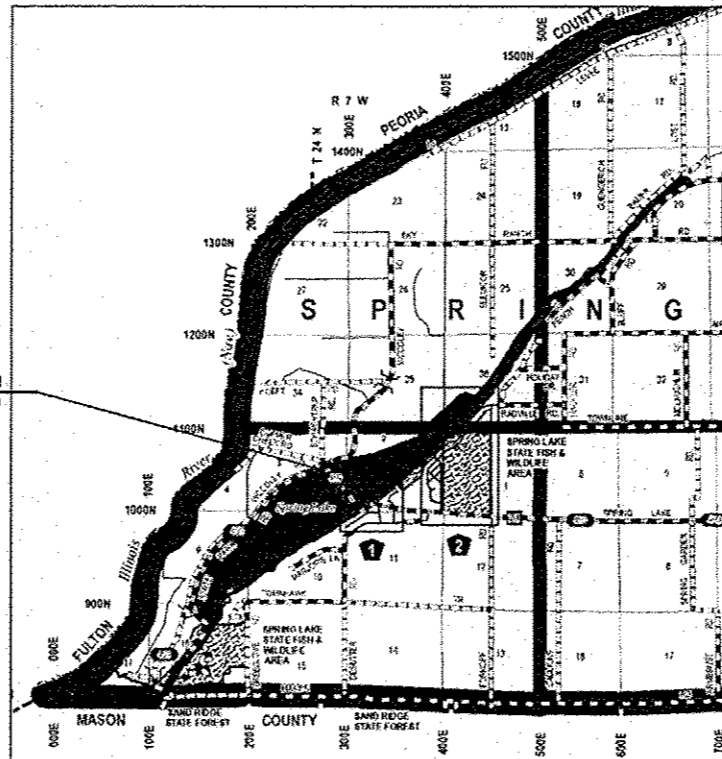


LOCATION MAP

GROSS LENGTH OF PROJECT = 120.00 FT. (0.0023 MILES)

TRAFFIC DATA

FUNCTIONAL CLASS: MAJOR COLLECTOR
ADT: 225 (2012)
DHV: 30 (2012)
DESIGN SPEED: 40 MPH
POSTED SPEED: 40 MPH

TOWNSHIP: SPRING LAKE

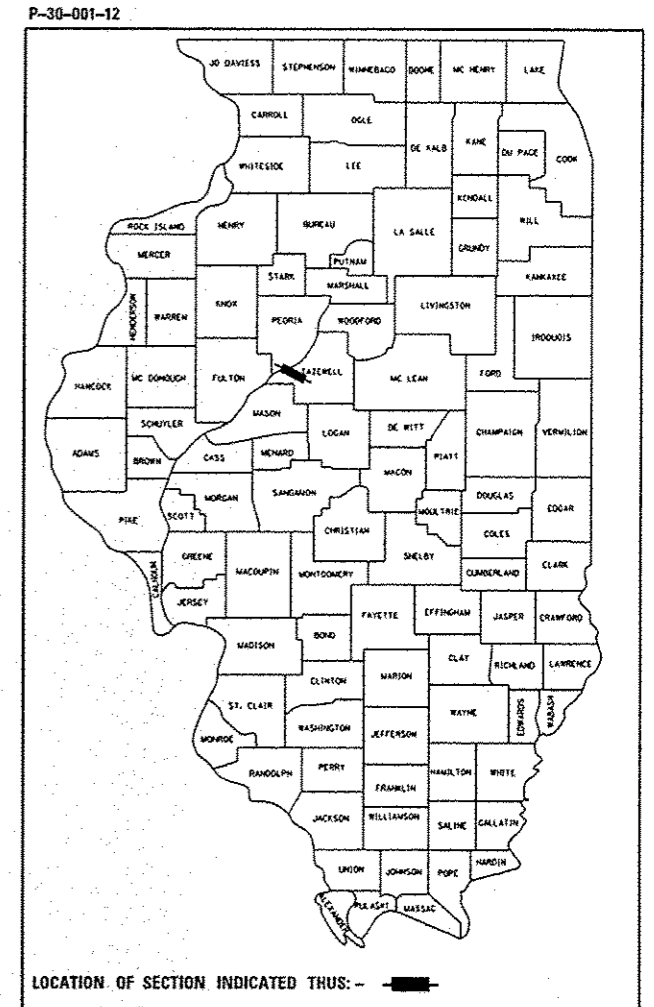

SIGNATURE: *James M. Michalec*
DATE SIGNED: 2/5/2013
LICENSE EXPIRATION DATE: 11/30/2013

STATE OF ILLINOIS
DEPARTMENT OF TRANSPORTATION
DIVISION OF HIGHWAYS

SUBMITTED March 22 20 13
William R. Frey, Jr.
DEPUTY DIRECTOR OF HIGHWAYS DESIGN ENGINEER

March 22 20 13
John D. Baranzelli, P.E., Jr.
ENGINEER OF DESIGN AND ENVIRONMENT

March 22 20 13
Omer Osman, P.E., Jr.
DIRECTOR OF HIGHWAYS, CHIEF ENGINEER

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