

# MAINTENANCE OF TRAFFIC GENERAL NOTES

- 1. THE CONTRACTOR SHALL PROVIDE AND MAINTAIN TWO THROUGH TRAFFIC LANES IN EACH DIRECTION ON LAGRANGE ROAD.
- 2. THE CONTRACTOR SHALL PROVIDE ALL SIGNS, VERTICAL PANELS, TYPE III BARRICADES, DRUMS, OR TYPE II BARRICADES, ALL TEMPORARY CONCRETE BARRIERS AND PROTECTION NECESSARY FOR THE MAINTENANCE OF TRAFFIC, OR AS DIRECTED BY THE ENGINEER.
- 3. THE CONTRACTOR SHALL INSTALL AND MAINTAIN PROPOSED AND TEMPORARY DRAINAGE SYSTEMS, AND EROSION CONTROL THROUGHOUT STAGE CONSTRUCTION DURING THE DURATION OF THE PROJECT.
- 4. THE CONTRACTOR SHALL PROVIDE AND MAINTAIN ACCESS TO ALL COMMERCIAL AND PRIVATE ENTRANCES. PAY ITEMS ARE INCLUDED IN THE PLANS FOR THIS ITEM. SEE IDOT DISTRICT 1 STANDARD TC-26 FOR TEMPORARY INFORMATION SIGNING REQUIREMENTS AT DRIVEWAYS.
- 5. THE CONTRACTOR SHALL USE WET REFLECTIVE TEMPORARY TAPE, TYPE III, ON EXISTING SURFACES TO REMAIN, AREAS IN CONFLICT WITH OTHER STAGES, AND PERMANENT SURFACES, EXCEPT FOR WINTER STAGING, WHICH SHALL USE ONLY PERMANENT MARKING MATERIALS. THE CONTRACTOR SHALL USE EPOXY PAVEMENT MARKING FOR TEMPORARY PAVEMENT MARKINGS ON TEMPORARY PAVEMENT OR PAVEMENT THAT WILL BE REMOVED.
- 6. 4 INCH SOLID WHITE PAVEMENT MARKING LINES SHALL BE USED TO DEFINE EDGE LINE.
- 7. 6 INCH SOLID WHITE PAVEMENT MARKING LINES ARE TO BE USED TO DEFINE TURN LANES.
- 8. 12 INCH SOLID YELLOW PAVEMENT MARKING LINES ARE TO BE USED FOR TEMPORARY MEDIAN DIAGONAL LINES AT LOCATIONS AS SHOWN ON THE PLANS.
- 9. 24 INCH SOLID WHITE PAVEMENT MARKING LINES ARE TO BE USED FOR ALL STOP BARS. INCLUDING TEMPORARY AND SHORT-TERM INSTALLATIONS.
- 10. ALL TYPE II BARRICADES, DRUMS, AND VERTICAL PANELS SHALL BE EQUIPPED WITH MONO-DIRECTIONAL STEADY BURNING LIGHTS IN MULTI-LANE SECTIONS AND BI-DIRECTIONAL STEADY BURNING LIGHTS IN TWO-LANE SECTIONS.
- 11. ALL TYPE II BARRICADES, VERTICAL PANELS, AND DRUMS SHALL BE SPACED AT 50 FEET CENTER TO CENTER THROUGHOUT THE WORK ZONE. EXCEPT IN TAPER AREAS. GORE AREAS. AND ALONG CORNER RADII, WHERE THEY SHALL BE SPACED AT 25 FEET CENTER TO CENTER.
- 12. TEMPORARY CONCRETE BARRIERS SHALL BE EQUIPPED WITH TYPE "C" REFLECTORS IN ACCORDANCE WITH HIGHWAY STANDARD 635011 AT 20' CENTERS, AND SHALL BE CONTINUOUSLY PINNED TO THE PAVEMENT IN ALL 3 SLOTS ALONG THE TRAFFIC SIDE WHEREVER A DROP-OFF. FIXED OBJECT, OR OTHER HAZARD MUST REMAIN WITHIN 3.5 FEET OF THE WALL.
- 13. ALL CONSTRUCTION WARNING SIGNS SHALL BE BLACK LEGEND ON ORANGE BACKGROUND.
- 14. ALL CONSTRUCTION WARNING SIGN DIMENSIONS SHALL BE 48" X 48".
- 15. THE FIRST TWO WARNING SIGNS IN EACH DIRECTION SHALL HAVE AN AMBER FLASHING BEACON MOUNTED ON THE TRAFFIC SIDE.
- 16. THE CONTRACTOR SHALL INSTALL AND COVER ALL TEMPORARY SIGNING BEFORE EXISTING SIGNS ARE REMOVED.
- 17. THE CONTRACTOR SHALL INSTALL AND COVER ALL PERMANENT SIGNING BEFORE TEMPORARY SIGNS ARE REMOVED.
- 18. EXISTING TRAFFIC SIGNS IN CONFLICT WITH STAGING SHALL BE REMOVED. RELOCATED OR COVERED AS DIRECTED BY THE ENGINEER.
- 19. DIRECTION INDICATOR BARRICADES SHALL BE USED AT TAPER LOCATIONS AS DIRECTED BY THE ENGINEER.
- 20. VERTICAL PANELS OR DRUMS SHALL BE INSTALLED AS DIRECTED BY THE ENGINEER, TO DELINEATE THE TRAVEL EDGE OF PAVEMENT AFTER TEMPORARY PAVEMENT HAS BEEN CONSTRUCTED IN THE PRE-STAGE.

- 21. THE CONTRACTOR SHALL MAINTAIN DRIVEWAY, FIELD ENTRANCE, AND SIDE ROAD ACCESS AT ALL TIMES AT THE LOCATIONS SHOWN ON THE PLANS OR WHERE DIRECTED BY THE ENGINEER. THIS WORK SHALL BE PAID FOR AT THE CONTRACT UNIT PRICE PER EACH FOR TEMPORARY ACCESS (PRIVATE ENTRANCE), TEMPORARY ACCESS (COMMERCIAL ENTRANCE), TEMPORARY ACCESS (FIELD ENTRANCE), AND TEMPORARY ACCESS (ROAD). EACH DRIVEWAY, FIELD ENTRANCE, AND SIDE ROAD SHALL ONLY BE MEASURED FOR PAYMENT ONCE.
- 22. THE CONTRACTOR SHALL PLACE A TEMPORARY PAVEMENT PATCH WHERE THE PROPOSED STORM SEWER AND UTILITY TRENCHES CROSS EXISTING DRIVEWAYS, FIELD ENTRANCES, AND ROADWAYS. THIS WORK SHALL BE PAID FOR AT THE CONTRACT UNIT PRICE FOR CLASS D PATCHES. DEPTH OF PATCHES SHALL BE AS DIRECTED BY THE ENGINEER.
- 23. THE CONTRACTOR SHALL SUBMIT TO THE ENGINEER FOR APPROVAL A MAINTENANCE OF TRAFFIC CONTROL AND PROTECTION PLAN FOR THE CONSTRUCTION STAGING REQUIRED TO CONSTRUCT THE PROPOSED IMPROVEMENTS FOR ALL SIDE ROADS AND THE COMMERCIAL ENTRANCES LOCATED WITHIN THE CONTRACT LIMITS. SEE TRAFFIC CONTROL PLAN SPECIAL PROVISION FOR ADDITIONAL REQUIREMENTS. THIS WORK SHALL BE INCLUDED IN THE CONTRACT UNIT PRICE FOR TEMPORARY ACCESS (ROAD) AND TEMPORARY ACCESS (COMMERCIAL ENTRANCE). SUGGESTED MAINTENANCE OF TRAFFIC PLANS ARE PROVIDED FOR THE FOLLOWING MAJOR INTERSECTIONS:
  - 179TH STREET
  - 175TH STREET: REFER TO DETOUR PLAN
  - 171ST STREET; REFER TO DETOUR PLAN
  - 167TH STREET
  - 165TH STREET; REFER TO DETOUR PLAN
  - 163RD STREET; REFER TO DETOUR PLAN

24. ALL TRAFFIC CONTROL DEVICES SUCH AS BARRICADES, DRUMS, VERTICAL PANELS, SIGNS, ETC. REQUIRED FOR THE MAINTENANCE OF TRAFFIC AS SHOWN IN THE PLANS SHALL BE INCLUDED IN THE LUMP SUM CONTRACT UNIT PRICE FOR TRAFFIC CONTROL AND PROTECTION (SPECIAL).

- 25. AT THE END OF EACH WORK DAY, THE CONTRACTOR SHALL BACKFILL OR COVER ALL TRENCHES AND OPEN EXCAVATION HOLES FOR PROPOSED STORM SEWER, DRAINAGE STRUCTURES, AND UTILITIES IN ORDER TO PROVIDE A SAFE CONDITION FOR MOTORISTS AND THE PUBLIC DURING NON-WORKING HOURS. THE COST OF THIS WORK SHALL BE INCLUDED IN THE CONTRACT UNIT PRICE FOR TRAFFIC CONTROL AND PROTECTION (SPECIAL).
- 26. CONTRACTOR SHALL COORDINATE CONSTRUCTION STAGING AND MAINTENANCE OF TRAFFIC WITH ADJACENT IDOT CONTRACT NO. 60M61. CONSTRUCTION LIMITS BEGIN NORTH OF 159TH STREET.
- 27. THE CONTRACTOR SHALL CONTACT THE DISTRICT ONE TRAFFIC CONTROL SUPERVISOR AT (847) 705-4470 A MINIMUM OF 72 HOURS IN ADVANCE OF BEGINNING WORK.

# MAINTENANCE OF TRAFFIC - INDEX OF SHEETS

DRAWING NO.	TITLE
MN-01	GENERAL NOTES
MN-02 TO MN-03	SUGGESTED CONSTRUCTION SEQUENCING
MN-04 TO MN-08	TYPICAL SECTIONS
MN-09 TO MN-13	DETOUR PLANS
MT-01 TO MT-06 MT-07 TO MT-12 MT-13 TO MT-18 MT-19 TO MT-24 MT-25 TO MT-30	MOT US 45 - PRE-STAGE 1 - STAGE 1 - STAGE 2 - STAGE 3 - STAGE 4

DESIGNED WHI REVISED USER NAME = Nicholas\_Talarico FILE NAME STATE OF ILLINOIS MAINTENANCE OF TRAFFIC DRAWN ASI REVISED PLOT SCALE = 100.00 ' / in. CHECKED НΑ REVISED **DEPARTMENT OF TRANSPORTATION** SCALE: NONE SHEET NO. 1 OF 1 SHEETS PLOT DATE = 3/14/2013 03/13/13 DATE REVISED

DRAWING NO.	TITLE
MT-31 TO MT-34	MOT SIDE ROADS - PRE-STAGE 1
MT-35 TO MT-38	- STAGE 1
MT-39 TO MT-41	- STAGE 1A
MT-42 TO MT-44	- STAGE 1B
MT-45 TO MT-48	- STAGE 2
MT-49 TO MT-52	- STAGE 2A
MT-53 TO MT-55	- STAGE 2B
MT-56 TO MT-59	- STAGE 3
MT-60 TO MT-62	- STAGE 3A
MT-63 TO MT-65	- STAGE 3B
MT-66 TO MT-68	- STAGE 3C
MT-69 TO MT-72	- STAGE 4

_	05115		F.AS S	SECTION	COUNTY	TOTAL SHEETS	SHEET NO.
U	C – GENERAL NOTES			103R-3	COOK	932	106
_				MN-01	CONTRACT	NO. 6	0F05
S	STA.	TO STA.		ILLINOIS FED. A	ID PROJECT		

SEE SHEETS DN-02 AND DN-03 FOR SUGGESTED SEQUENCE OF DRAINAGE INSTALLATION.

# PRE-STAGE 1

TRAFFIC

TRAFFIC CONTROL SHALL BE IN ACCORDANCE WITH THE FOLLOWING STANDARDS. AS APPLICABLE:

•	701011	•	701306	•	701501
•	701101	•	701311	•	701502
•	701106	•	701422	•	701701
•	701201	•	701426	•	701901
•	701301	•	701427	•	704001

179TH STREET - SHIFT TRAFFIC TO THE SOUTH SIDE OF THE EXISTING PAVEMENT AND PROVIDE AN 11' TRAVEL LANE AND LEFT TURN LANE IN EACH DIRECTION. KEEP EASTBOUND TURNING ROADWAY OPEN.

#### CONSTRUCTION

US 45 (LAGRANGE ROAD) - CONSTRUCT TEMPORARY PAVEMENT AND TEMPORARY CURB AND GUTTER ON THE WEST SIDE AT THE LOCATIONS SHOWN ON THE PLANS.

CONSTRUCT RETAINING WALL NO. 8

- 179TH STREET CONSTRUCT TEMPORARY PAVEMENT AND TEMPORARY CURB AND GUTTER ON THE NORTH SIDE AS SHOWN ON THE PLANS. REMOVE RAISED CHANNELIZATION ISLAND AT DRIVEWAY (STA. 915+00) AND REPLACE WITH TEMPORARY PAVEMENT. CONSTRUCT RETAINING WALL AND PROPOSED PAVEMENT WIDENING ON THE NORTH SIDE, WEST LEG.
- 167TH STREET REMOVE EXISTING RAISED MEDIAN AND REPLACE WITH TEMPORARY PAVEMENT. CONSTRUCT TEMPORARY PAVEMENT AND TEMPORARY CURB AND GUTTER ON THE NORTH SIDE AS SHOWN ON THE PLANS.
- 163RD STREET CONSTRUCT TEMPORARY PAVEMENT AND TEMPORARY CURB AND GUTTER ON THE SOUTH SIDE AS SHOWN ON THE PLANS.

# STAGE 1

TRAFFIC

- US 45 (LAGRANGE ROAD) SHIFT TRAFFIC TO THE WEST EDGE OF TEMPORARY PAVEMENT / EXISTING PAVEMENT. PROVIDE TWO TRAVEL LANES IN EACH DIRECTION AND AN 11' FLUSH MEDIAN WITH LEFT TURN LANES AT MAJOR INTERSECTIONS.
- 179TH STREET SHIFT TRAFFIC TO THE NORTH SIDE OF THE PROPOSED AND TEMPORARY PAVEMENT AND PROVIDE AN 11' TRAVEL LANE AND LEFT TURN LANE IN EACH DIRECTION. KEEP EASTBOUND RIGHT TURN LANE OPEN.
- 175TH STREET CLOSED FOR CONSTRUCTION; SEE DETOUR PLAN.
- 171ST STREET CLOSED FOR CONSTRUCTION; SEE DETOUR PLAN.
- 167TH STREET SHIFT TRAFFIC TO THE SOUTH SIDE OF THE EXISTING PAVEMENT AND PROVIDE AN 11' TRAVEL LANE AND LEFT TURN LANE IN EACH DIRECTION.
- 163RD STREET THE EAST LEG IS CLOSED FOR CONSTRUCTION; SEE DETOUR PLAN.

# CONSTRUCTION

- US 45 (LAGRANGE ROAD) CONSTRUCT THE PROPOSED NORTHBOUND LANES AS SHOWN ON THE PLANS.
- 179TH STREET CONSTRUCT PROPOSED PAVEMENT ON THE SOUTH SIDE OF THE EAST LEG.
- 175TH STREET CONSTRUCT PROPOSED PAVEMENT.
- 171ST STREET CONSTRUCT PROPOSED PAVEMENT.
- 167TH STREET CONSTRUCT PROPOSED PAVEMENT ON THE NORTH SIDE OF THE EAST LEG. CONSTRUCT TEMPORARY PAVEMENT AND TEMPORARY CURB AND GUTTER ON THE NORTH SIDE AS SHOWN ON THE PLANS.

163RD STREET - CONSTRUCT PROPOSED PAVEMENT ON THE EAST LEG.

# SUGGESTED CONSTRUCTION SEQUENCING

STAGE 1A		STAGE 2
TRAFFIC		TRAFFIC
US 45 (LAGRANGE	E ROAD) - TRAFFIC TO REMAIN IN CONFIGURATION ESTABLISHED IN STAGE 1.	167TH STR
179TH STREET -	MAINTAIN AN 11' TRAVEL LANE IN EACH DIRECTION AND KEEP EASTBOUND RIGHT TURN LANE OPEN.	
167TH STREET -	MAINTAIN AN 11' TRAVEL LANE IN EACH DIRECTION.	163RD STF
CONSTRUCTION		
179TH STREET -	CONSTRUCT THE PROPOSED CENTER LANE PAVEMENT ON THE EAST LEG.	US 45 (LA
167TH STREET -	CONSTRUCT THE PROPOSED CENTER LANE PAVEMENT ON THE EAST LEG.	
		STAGE 2
STAGE 1B		TRAFFIC
		US 45 (LA
TRAFFIC		179TH STF
	E ROAD) - TRAFFIC TO REMAIN IN CONFIGURATION ESTABLISHED IN STAGE 1.	
ILALH ZIKEEL -	SHIFT TRAFFIC TO THE SOUTH SIDE. PROVIDE AN 11' TRAVEL LANE IN EACH DIRECTION. KEEP EASTBOUND TURNING ROADWAY OPEN.	167TH STF
167TH STREET -	SHIFT TRAFFIC TO THE NORTH SIDE. PROVIDE AN 11' TRAVEL LANE WESTBOUND. PROVIDE AN 11' TRAVEL LANE AND RIGHT TURN LANE EASTBOUND.	165TH STR
CONSTRUCTION		
179TH STREET -	CONSTRUCT THE PROPOSED PAVEMENT ALONG THE NORTH SIDE ON THE EAST LEG.	CONSTRUC
167TH STREET -	CONSTRUCT THE PROPOSED PAVEMENT ALONG THE SOUTH SIDE ON THE EAST LEG.	US 45 (LA
STAGE 2		STAGE 2
TRAFFIC		TRAFFIC
	ROAD) - SHIFT TWO NORTHBOUND TRAVEL LANES ONTO THE PROPOSED	US 45 (LA
UU TU NEADNANGE	PAVEMENT CONSTRUCTED IN STAGE 1. SOUTHBOUND TRAFFIC SHALL REMAIN IN THE SAME CONFIGURATION AS IN STAGE 1.	179TH STF
	AT SIGNALIZED INTERSECTIONS, LEFT TURN PHASING SHALL BE PROTECTED ONLY AND CONFIGURED IN A LEAD-LAG SEQUENCE SO	167TH STF
179TH STREET -	THAT BOTH TURN LANES DO NOT TIME CONCURRENTLY. MAINTAIN TRAFFIC ON THE SOUTH SIDE. PROVIDE AN 11' TRAVEL LANE AND LEFT TURN LANE IN EACH DIRECTION. KEEP EASTBOUND TURNING ROADWAY OPEN.	165TH STR
175TH STREET -	TRAFFIC TO BE IN THE PROPOSED CONFIGURATION.	
17167 670557	TRAFFIC TO BE IN THE PROPOSED CONFIGURATION. CLOSE INNER LEFT TURN LANE.	US 45 (LA

FILE NAME =	USER NAME = Nicholas_Talarico	DESIGNED	WHI	REVISED					SECTION	COUNTY	TOTAL SHEET SHEETS NO.
-		DRAWN	ASI	REVISED	STATE OF ILLINOIS	MAINTENANCE OF TRAFFIC – SUGGESTED CONSTRUCTION SEQUENCE	330	103R-3	СООК	932 107	
	PLOT SCALE = 100.00 ' / in.	CHECKED	HA	REVISED	DEPARTMENT OF TRANSPORTATION			MN-02	CONTRACT	NO. 60F05	
	PLOT DATE = 3/14/2013	DATE	03/13/13	REVISED		SCALE: NONE	SHEET NO. 1 OF 2 SHEETS STA. TO STA.			ID PROJECT	

(CONTINUED)

- REET MAINTAIN TRAFFIC ON THE NORTH SIDE. PROVIDE AN 11' TRAVEL LANE AND LEFT TURN LANE WESTBOUND. PROVIDE AN 11' TRAVEL LANE, LEFT TURN LANE AND RIGHT TURN LANE EASTBOUND.
- REET TRAFFIC TO BE IN THE PROPOSED CONFIGURATION.

#### CTION

AGRANGE ROAD) - CONSTRUCT PROPOSED LEFT TURN LANE PAVEMENT AND PLACE TEMPORARY PAVEMENT IN LOCATIONS AS SHOWN ON THE PLANS.

#### 2A

AGRANGE ROAD) - TRAFFIC TO REMAIN IN CONFIGURATION ESTABLISHED IN STAGE 2.

- REET MAINTAIN TRAFFIC ON THE SOUTH SIDE. PROVIDE AN 11' TRAVEL LANE IN EACH DIRECTION. KEEP EASTBOUND TURNING ROADWAY OPEN.
- REET MAINTAIN TRAFFIC ON THE NORTH SIDE. PROVIDE AN 11' TRAVEL LANE WESTBOUND. PROVIDE AN 11' TRAVEL LANE AND RIGHT TURN LANE EASTBOUND.
- REET PROVIDE ONE LANE IN EACH DIRECTION WITH A RIGHT-IN / RIGHT-OUT CONFIGURATION.

#### CTION

AGRANGE ROAD) - CONSTRUCTION OF PROPOSED INTERSECTION PAVEMENT AT 179TH ST., 167TH ST., 165TH ST. AND 163RD ST. CONTINUES.

#### 2B

AGRANGE ROAD) - TRAFFIC TO REMAIN IN CONFIGURATION ESTABLISHED IN STAGE 2.

- REET SHIFT TRAFFIC TO THE NORTH SIDE. PROVIDE AN 11' TRAVEL LANE IN EACH DIRECTION. KEEP EASTBOUND TURNING ROADWAY OPEN.
- REET SHIFT TRAFFIC TO THE SOUTH SIDE. PROVIDE AN 11' TRAVEL LANE AND RIGHT TURN LANE WESTBOUND. PROVIDE AN 11' TRAVEL LANE EASTBOUND.
- REET TRAFFIC TO REMAIN IN CONFIGURATION ESTABLISHED IN STAGE 2A.

#### CTION

- AGRANGE ROAD) CONSTRUCTION OF PROPOSED INTERSECTION PAVEMENT AT 179TH ST., 167TH ST., 165TH ST. AND 163RD ST. CONTINUES.
- 167TH STREET REMOVE TEMPORARY PAVEMENT ON THE NORTH SIDE, EAST LEG AND CONSTRUCT PROPOSED CURB AND GUTTER AS SHOWN ON THE PLANS.

# SUGGESTED CONSTRUCTION SEQUENCING

## STAGE 3

# TRAFFIC

- US 45 (LAGRANGE ROAD) SHIFT TRAFFIC TO THE EAST EDGE OF NEW PROPOSED PAVEMENT. PROVIDE TWO TRAVEL LANES IN EACH DIRECTION WITH AN 11' FLUSH MEDIAN WITH LEFT TURN LANES AT MAJOR INTERSECTIONS.
- 179TH STREET MAINTAIN TRAFFIC ON THE NORTH SIDE. PROVIDE AN 11' TRAVEL LANE AND LEFT TURN LANE IN EACH DIRECTION.
- 175TH STREET TRAFFIC TO BE IN THE PROPOSED CONFIGURATION.
- 171ST STREET TRAFFIC TO BE IN THE PROPOSED CONFIGURATION. CLOSE INNER LEFT TURN LANE.
- 167TH STREET MAINTAIN TRAFFIC ON THE SOUTH SIDE. PROVIDE AN 11' TRAVEL LANE, LEFT TURN LANE AND RIGHT TURN LANE WESTBOUND. PROVIDE AN 11' TRAVEL LANE AND LEFT TURN LANE EASTBOUND.
- 165TH STREET PROVIDE ONE LANE IN EACH DIRECTION AND ALLOW ALL TRAFFIC MOVEMENTS.
- 163RD STREET WEST LEG CLOSED FOR CONSTRUCTION; SEE DETOUR PLAN.

#### CONSTRUCTION

- US 45 (LAGRANGE ROAD) CONSTRUCT THE PROPOSED SOUTHBOUND LANES AS SHOWN ON THE PLANS.
- 179TH STREET CONSTRUCT PROPOSED PAVEMENT ON THE SOUTH SIDE OF THE WEST LEG. REMOVE EXISTING RAISED CORNER ISLAND AND PLACE TEMPORARY PAVEMENT AS SHOWN ON THE PLANS.
- 167TH STREET CONSTRUCT PROPOSED PAVEMENT ON THE NORTH SIDE OF THE WEST LEG. CONSTRUCT TEMPORARY PAVEMENT ON THE NORTH SIDE, WEST LEG AS SHOWN ON THE PLANS.
- 163RD STREET CONSTRUCT PROPOSED PAVEMENT ON THE WEST LEG.

## STAGE 3A

#### TRAFFIC

- US 45 (LAGRANGE ROAD) TRAFFIC TO REMAIN IN CONFIGURATION ESTABLISHED IN STAGE 3.
- 179TH STREET MAINTAIN TRAFFIC ON THE NORTH SIDE. PROVIDE AN 11' TRAVEL LANE IN EACH DIRECTION.
- 167TH STREET EAST LEG: MAINTAIN TRAFFIC ON THE SOUTH SIDE. PROVIDE AN 11' TRAVEL LANE AND RIGHT TURN LANE WESTBOUND.
  - WEST LEG: EASTBOUND LANE TO REMAIN IN SAME LOCATION AS STAGE 3. SHIFT WESTBOUND LANE TO THE NORTH SIDE. PROVIDE AN 11' TRAVEL LANE IN EACH DIRECTION.

165TH STREET - CLOSED FOR CONSTRUCTION; SEE DETOUR PLAN.

#### CONSTRUCTION

179TH STREET	- CONSTRUCT	THE PROPOSED	CENTER LANE	PAVEMENT	ON THE WEST LEG.
167TH STREET	- CONSTRUCT	THE PROPOSE	CENTER LANE	PAVEMENT	ON THE WEST LEG.

165TH STREET - CONSTRUCT THE PROPOSED PAVEMENT.

# STAGE 3B

# TRAFFIC

US 45 (LAGRANGE ROAD)	- TRAFFIC	TO REMAIN IN	CONFIGURATION	ESTABLISHED	IN STAGE 3.	

179TH STREET - SHIFT TRAFFIC TO THE SOUTH SIDE. PROVIDE AN 11' TRAVEL LANE IN EACH DIRECTION.

167TH STREET - EAST LEG: MAINTAIN TRAFFIC ON THE SOUTH SIDE. PROVIDE AN 11' TRAVEL LANE AND RIGHT TURN LANE WESTBOUND.

> WEST LEG: EASTBOUND LANE TO REMAIN IN SAME LOCATION AS STAGE 3. SHIFT WESTBOUND LANE TO THE NORTH SIDE (TAPER LOCATION MOVES EAST). PROVIDE AN 11' TRAVEL LANE IN EACH DIRECTION.

### CONSTRUCTION

- 179TH STREET CONSTRUCT THE PROPOSED PAVEMENT ALONG THE NORTH SIDE ON THE WEST LEG. CONSTRUCT PROPOSED CURB AND GUTTER ALONG THE NORTH SIDE OF THE EAST LEG.
- 167TH STREET CONSTRUCT THE PROPOSED CENTER LANE PAVEMENT ON THE WEST LEG.

# STAGE 3C

## TRAFFIC

- US 45 (LAGRANGE ROAD) TRAFFIC TO REMAIN IN CONFIGURATION ESTABLISHED IN STAGE 3.
- 179TH STREET SHIFT THE TRAFFIC TO THE NORTH. PROVIDE AN 11' TRAVEL LANE AND RIGHT TURN LANE EASTBOUND. PROVIDE AN 11' TRAVEL LANE WESTBOUND.
- 167TH STREET SHIFT TRAFFIC TO THE NORTH SIDE. PROVIDE AN 11' TRAVEL LANE IN EACH DIRECTION.

# CONSTRUCTION

- 179TH STREET CONSTRUCT THE PROPOSED RAISED CORNER ISLAND LOCATED IN THE SOUTHWEST QUADRANT OF THE INTERSECTION.
- 167TH STREET CONSTRUCT THE PROPOSED PAVEMENT ALONG THE SOUTH SIDE ON THE WEST LEG.

FILE NAME =	USER NAME = Nicholas_Talarico	DESIGNED	WHI	REVISED				F.ASS SS RTE.	SECTION	COUNTY	TOTAL SHEET SHEETS NO.
		DRAWN	ASI	REVISED	STATE OF ILLINOIS	MAINTENANCE OF TRAFFIC – SUGGESTED CONSTRUCTION SEQUENCE			103R-3	СООК	932 108
	PLOT SCALE = 100.00 ' / in.	CHECKED	HA	REVISED	DEPARTMENT OF TRANSPORTATION				MN-03	CONTRAC	T NO. 60F05
	PLOT DATE = 3/14/2013	DATE	03/13/13	REVISED		SCALE: NONE	SHEET NO. 2 OF 2 SHEETS STA. TO STA.		ILLINOIS FED. AI	ID PROJECT	

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# STAGE 4

## TRAFFIC

US 45 (LAGRANGE ROAD) - PROVIDE TWO TRAVEL LANES IN EACH DIRECTION AND A SINGLE LEFT TURN LANE AT MAJOR INTERSEDTIONS. TRAFFIC TO BE IN THE FINAL CONFIGURATION IN THE CENTER AND RIGHT LANES. THE LEFT LANE WILL BE CLOSED IN EACH DIRECTION.
179TH STREET - TRAFFIC TO BE IN THE PROPOSED CONFIGURATION.
175TH STREET - TRAFFIC TO BE IN THE PROPOSED CONFIGURATION.
171ST STREET - TRAFFIC TO BE IN THE PROPOSED CONFIGURATION. CLOSE INNER LEFT TURN LANE.

167TH STREET - EAST LEG: TRAFFIC TO BE IN THE PROPOSED CONFIGURATION. WEST LEG: SHIFT TRAFFIC TO THE SOUTH SIDE AS SHOWN ON THE PLANS. PROVIDE AN 11' TRAVEL LANE IN EACH DIRECTION. ALL PROPOSED TURN LANES TO BE OPEN TO TRAFFIC AT LAGRANGE ROAD.

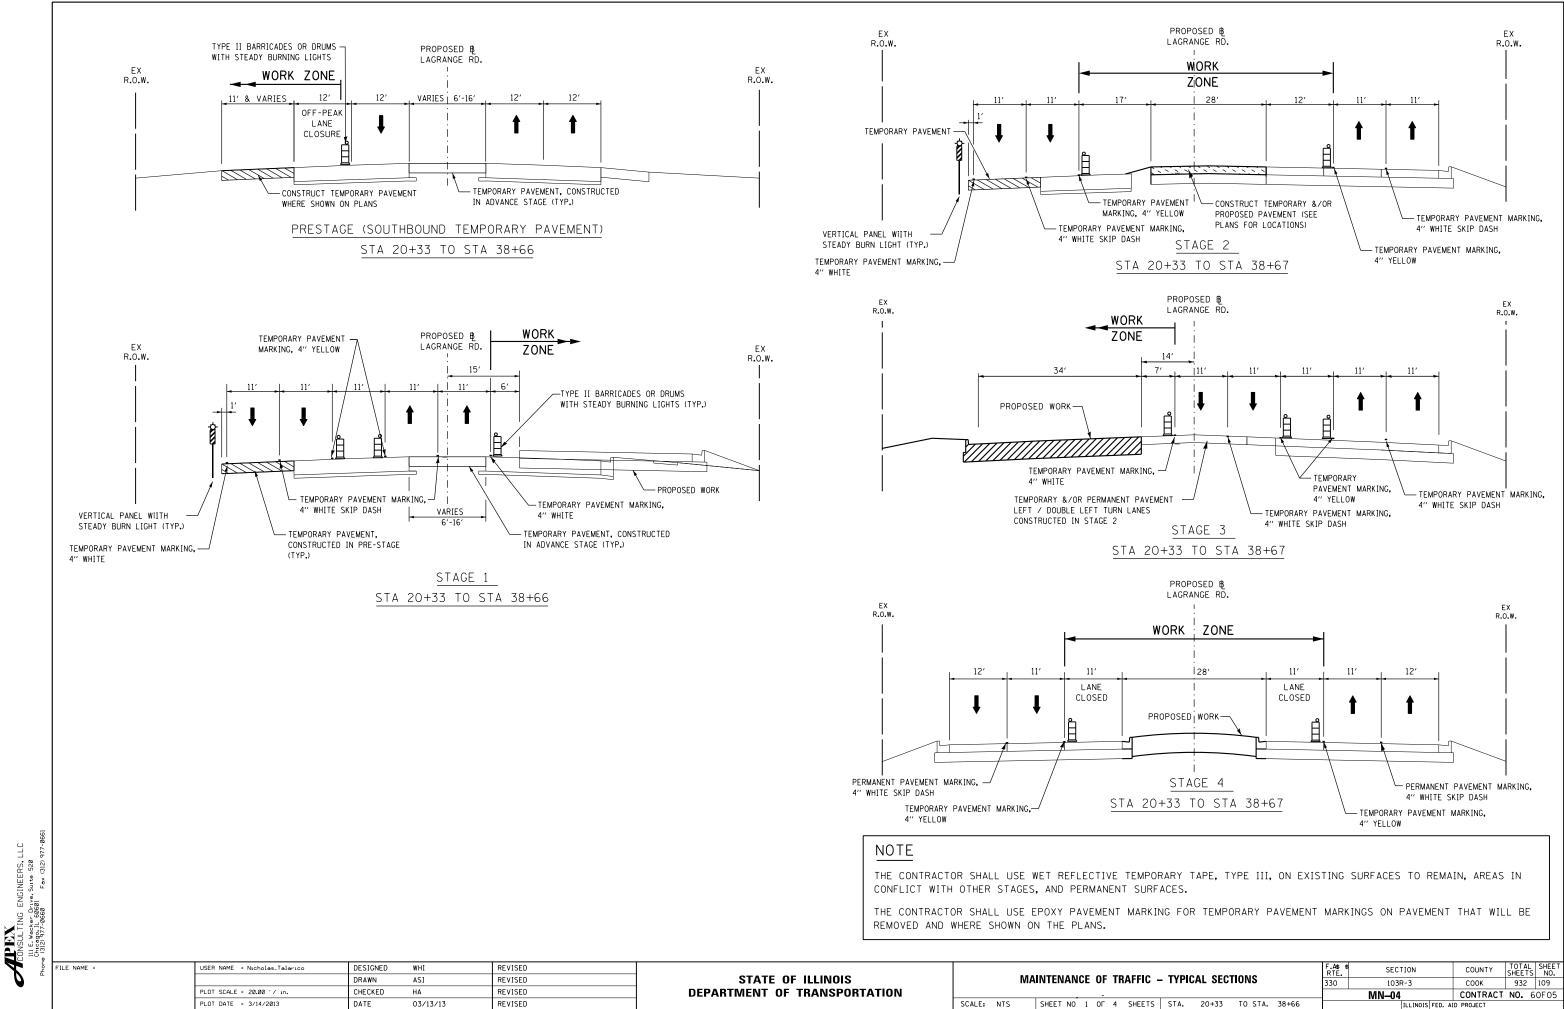
165TH STREET - TRAFFIC TO BE IN THE PROPOSED CONFIGURATION.

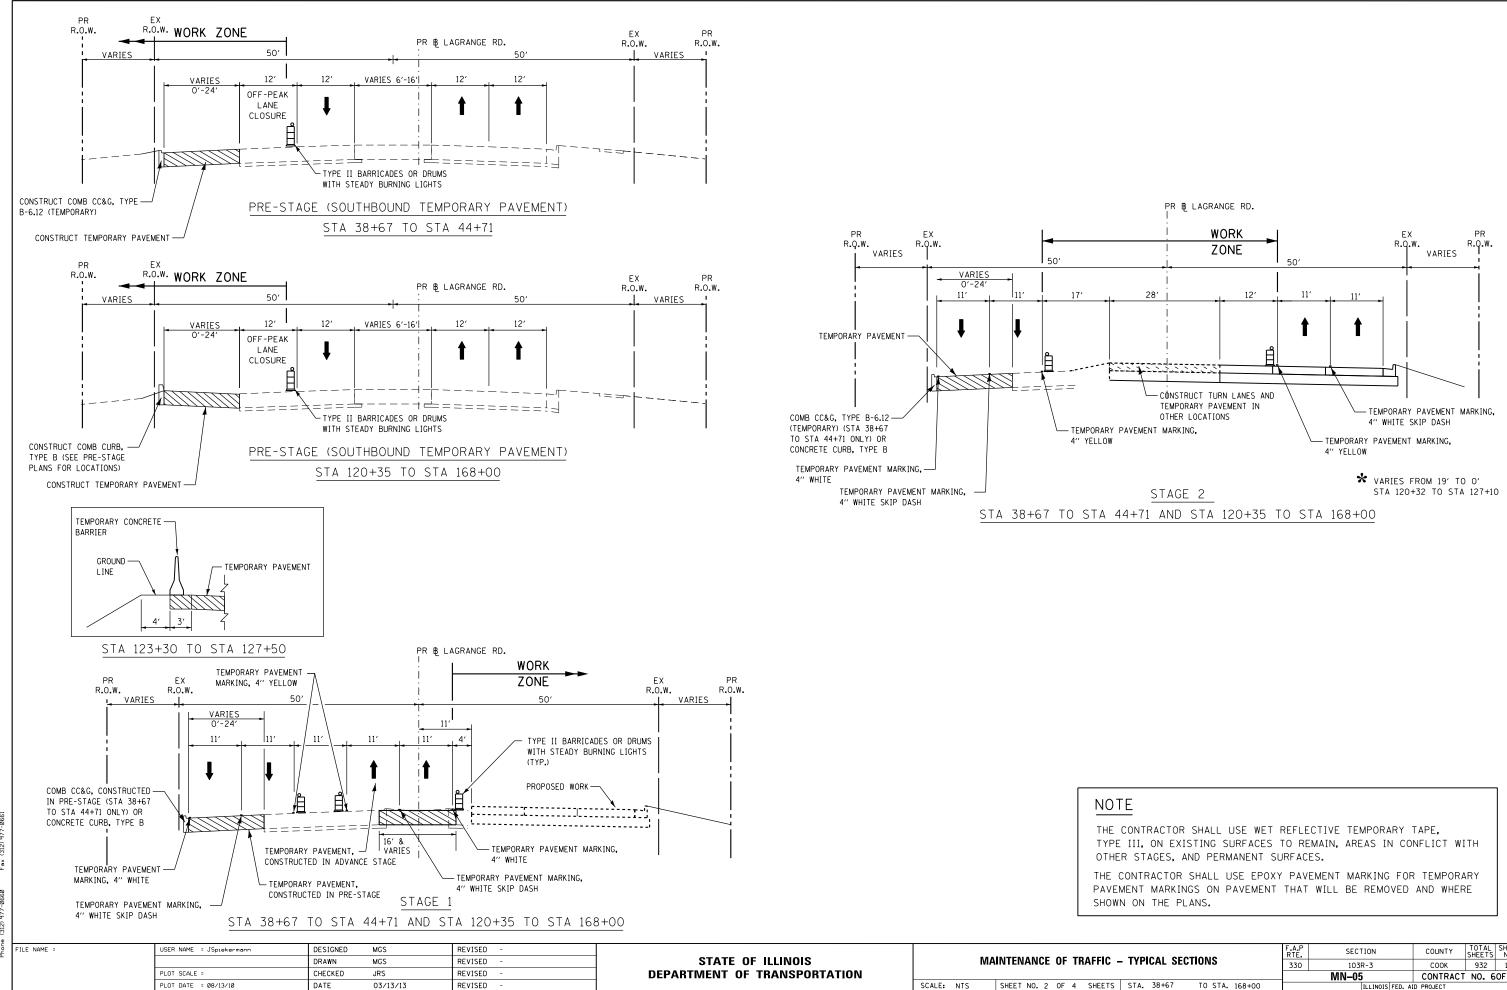
163RD STREET - TRAFFIC TO BE IN THE PROPOSED CONFIGURATION.

#### CONSTRUCTION

US 45 (LAGRANGE ROAD) - CONSTRUCT THE PROPOSED RAISED MEDIAN.

167TH STREET - REMOVE TEMPORARY PAVEMENT AND CONSTRUCT PROPOSED CURB AND GUTTER AND DRIVEWAY ON THE NORTH SIDE, WEST LEG.







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SHEET NO. 2 OF 4 SHEETS

	NO	F.A.P RTE.	SECTION	COUNTY	TOTAL SHEETS	SHEET NO.	
– TYPICAL SECTIONS			330 103R-3 СООК 932				
			MN-05 CONTRACT NO. 60F0				
S STA. 38+67 TO	D STA. 168+00	ILLINOIS FED. AID PROJECT					



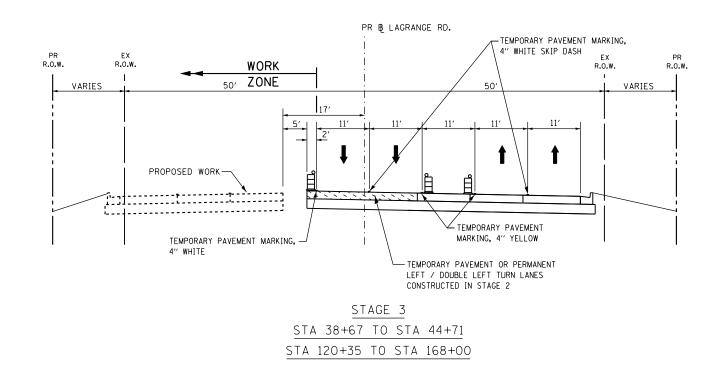

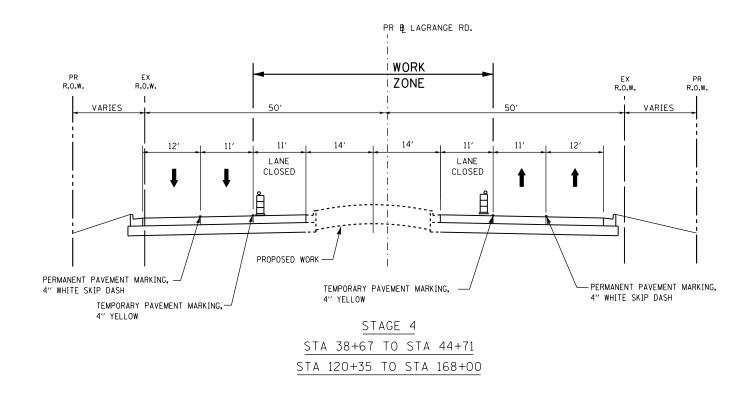
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THE CO PAVEME SHOWN


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Ph			DRAWN	MGS	REVISED -	STATE OF ILLINOIS	MAINTENANCE OF TRAFFIC – TYPICAL SECTIONS	330	103R-3	СООК	932 111
		PLOT SCALE =	CHECKED	JRS	REVISED -	DEPARTMENT OF TRANSPORTATION			MN-06	CONTRACT	NO. 60F05
		PLOT DATE = 08/13/10	DATE	03/13/13	REVISED -		SCALE: NTS SHEET NO. 2 OF 4 SHEETS STA. 38+67 TO STA. 168+00		ILLINOIS FED. A	ID PROJECT	


CONTRACTOR SHALL USE WET REFLECTIVE TEMPORARY TAPE, III, ON EXISTING SURFACES TO REMAIN, AREAS IN CONFLICT WITH R STAGES, AND PERMANENT SURFACES. CONTRACTOR SHALL USE EPOXY PAVEMENT MARKING FOR TEMPORARY MENT MARKINGS ON PAVEMENT THAT WILL BE REMOVED AND WHERE N ON THE PLANS.	<u> </u>	
IENT MARKINGS ON PAVEMENT THAT WILL BE REMOVED AND WHERE	III, ON EXISTING SURFACES TO REMAIN, AREAS IN CONFLICT W	(TH
	IENT MARKINGS ON PAVEMENT THAT WILL BE REMOVED AND WHEF	

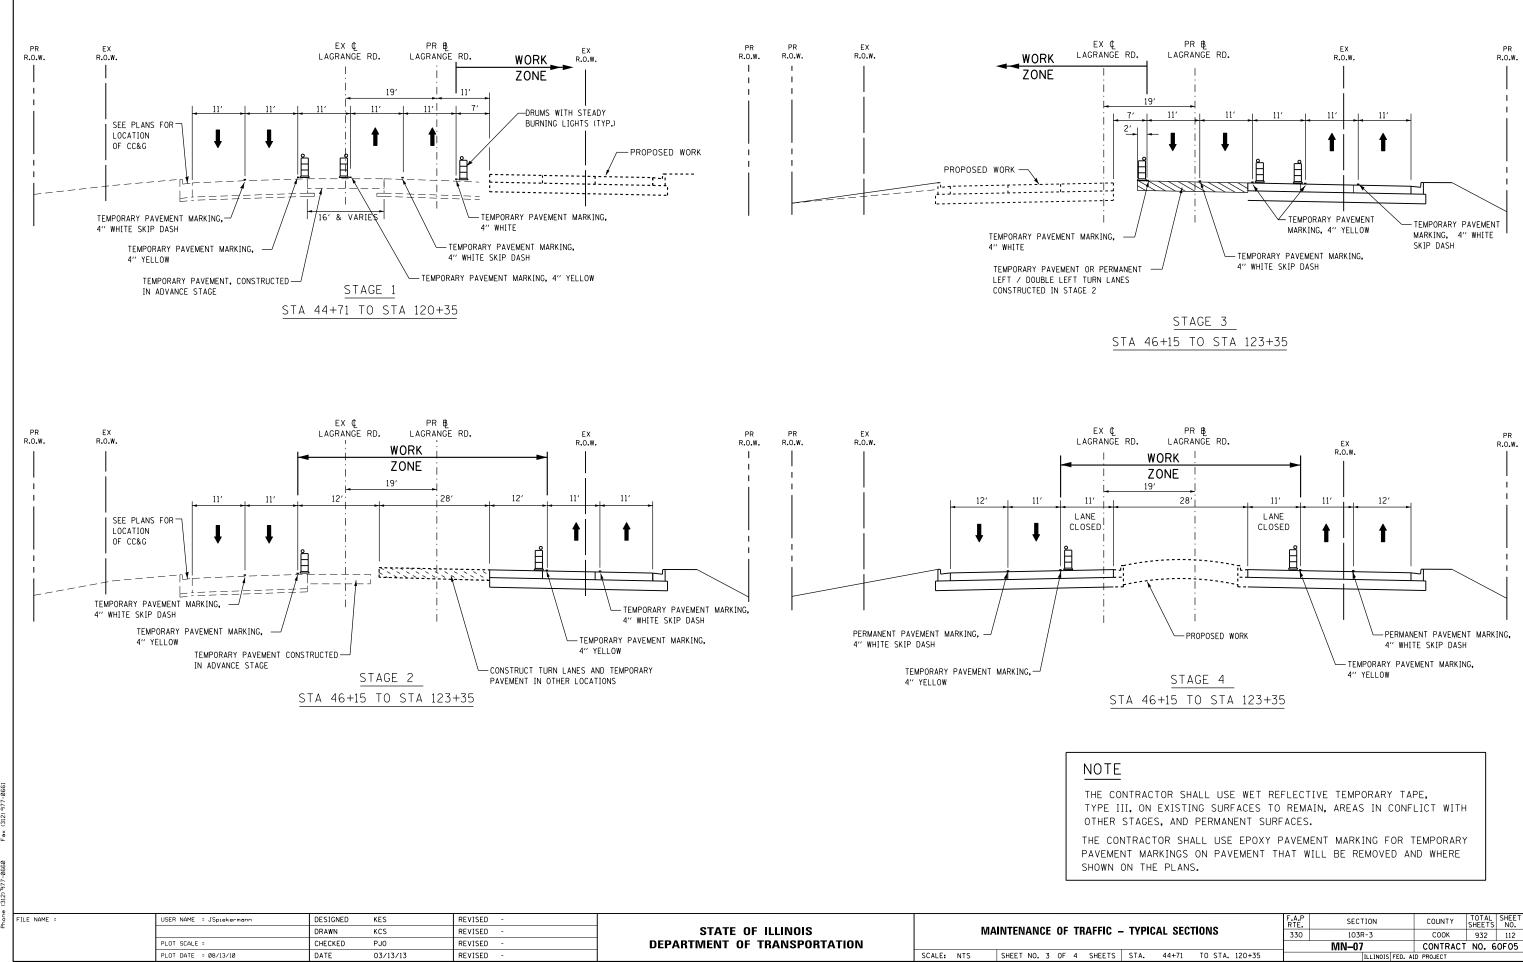

CONSULTING ENGINEERS, LLC III E. Wacker Drive. Suite 520 Phone (312) 977-96801 F. 54 (312) 977-9

	F.A.P RTE.	SECTION	COUNTY	TOTAL SHEETS	SHEET NO.			
– TYPICAL SECTIONS	330 103R-3 СООК				112			
	_	MN-07 CONTRACT N			NO. 60F05			
5 STA. 44+71 TO STA. 120+35	ILLINOIS FED. AID PROJECT							

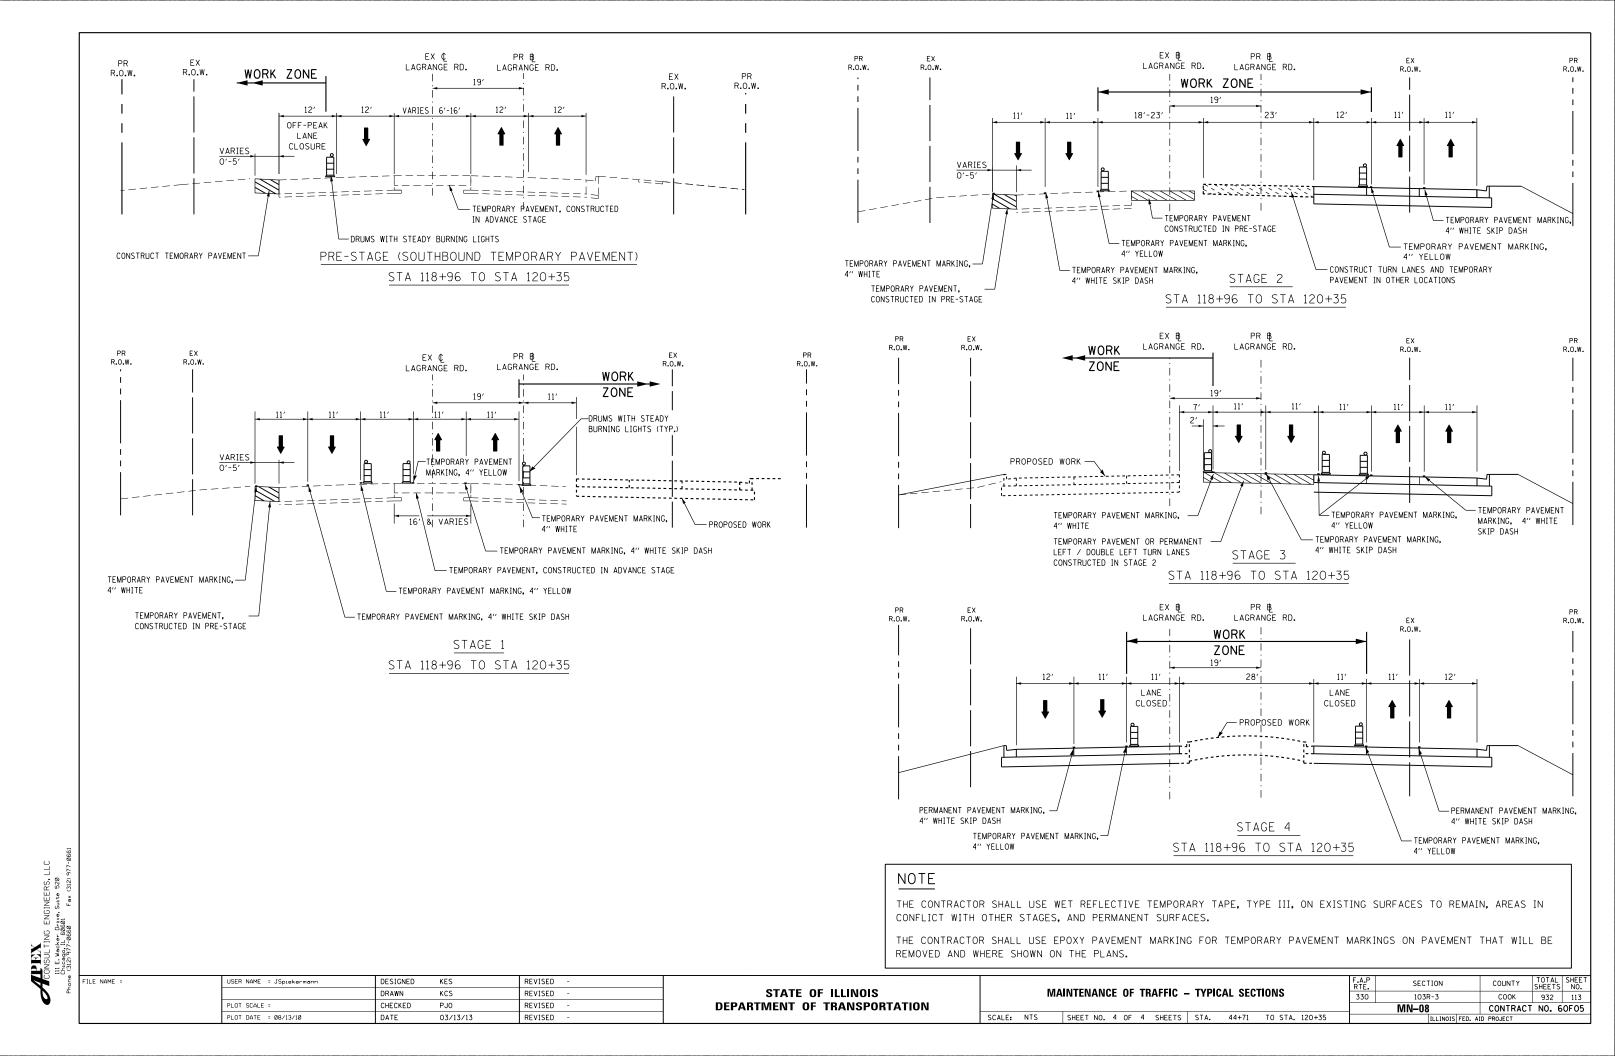

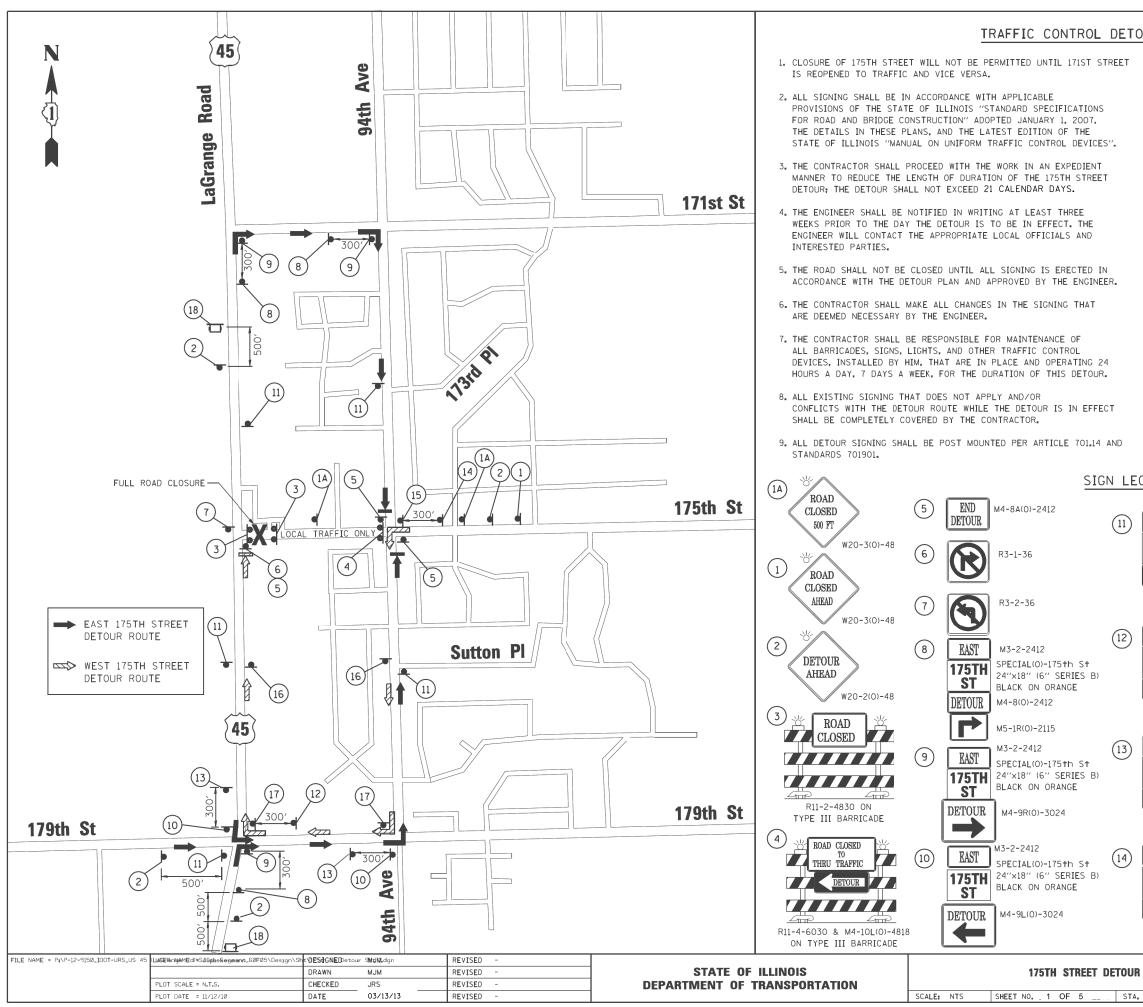


# TRAFFIC CONTROL DETOUR GENERAL NOTES

RET	10.	ALL	DETOUR	SIGNING	DESIGN	ATEC	WITH	l ''(0)''	IN THE	SIGN CO	DE		
		SHAL	L HAVE	BLACK L	EGENDS	ON	ORANG	E HIGH	INTENS	TY BACK	GRC	)UNDS	5
		AND	STANDA	RD BLACK	BORDE	RS.	ALL (	DETOUR	SIGNIN	5 SHALL	ΒE	NEW	OR
		LIKE	NEW CC	NDITION.									

- 11. THE SIZES OF ALL SIGNS NOT SPECIFIED IN THESE PLANS SHALL BE IN ACCORDANCE WITH THE ILLINOIS MANUAL ON UNIFORM TRAFFIC CONTROL DEVICES.
- 12. TYPE III BARRICADES, AND THEIR APPLICATION, SHALL CONFORM TO HIGHWAY STANDARD 701901.
- 13. THE "ROAD CLOSED" SIGN ON A TYPE III BARRICADE SHALL BE MOUNTED ABOVE THE TOP OF THE BARRICADE AS SHOWN IN THE SIGN LEGEND. ALL TYPE III BARRICADES SHALL HAVE TWO AMBER TYPE 'A' LOW INTENSITY FLASHING LIGHTS SPACED NEAR THE CENTERLINE OF THE SUPPORTS.
- 14. CONSTRUCTION EQUIPMENT SHALL NOT BE PARKED IMMEDIATELY BEHIND THE TYPE III BARRICADES AT ANY TIME. ARTICLE 701.11 OF THE STANDARD SPECIFICATIONS SHALL APPLY.
- 15. THE ENGINEER SHALL BE NOTIFIED AT LEAST THREE (3) DAYS PRIOR TO THE REMOVAL OF THE DETOUR. THE ENGINEER WILL CONTACT. THE APPROPRIATE LOCAL OFFICIALS AND INTERESTED PARTIES.
- 16. PORTABLE CHANGEABLE MESSAGE SIGNS SHALL FLASH THE MESSAGE SHOWN IN THE SIGN LEGEND, TWO PHASES SHALL BE USED. EACH PHASE SHALL BE DISPLAYED FOR 3 SECONDS WITH A MAXIMUM CYCLE OF 6 SECONDS. LETTERS SHALL BE 18 INCHES HIGH AND ALL UPPER-CASE. CHANGEABLE MESSAGE SIGNS SHALL COMPLY WITH THE REQUIREMENTS IN SECTION 6F.60 OF THE 2009 MUTCD.

# SIGN LEGEND

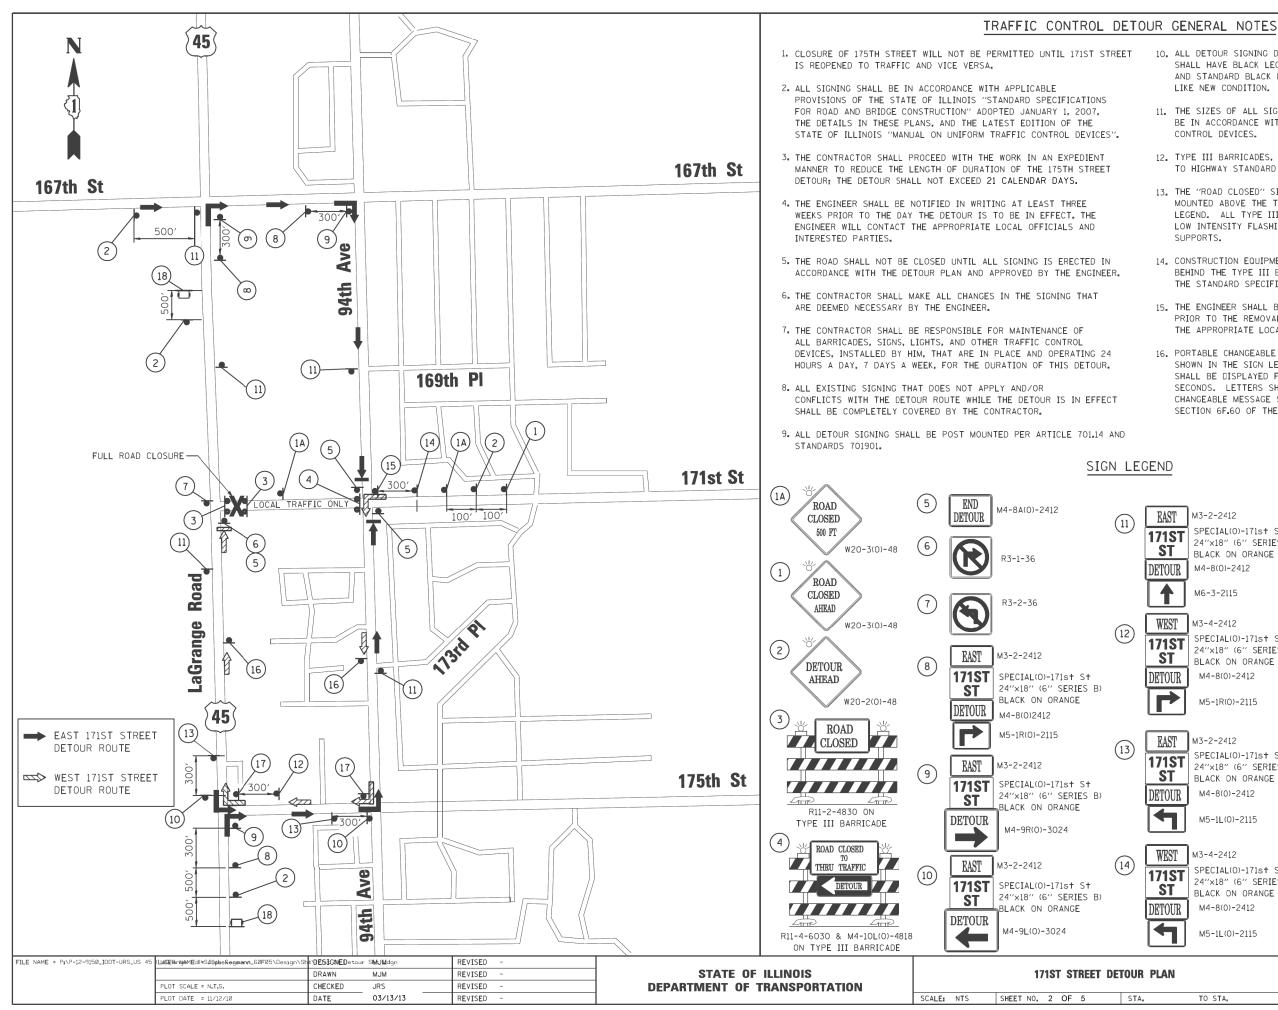	EAST 175TH ST BLACK ON ORAN M4-8(0)-2412 M6-3-2115	IES B)	M3-4-2412 SPECIAL(0)-175th St 24"x18" (6" SERIES B) BLACK ON ORANGE M4-9L(0)-3024
	WEST   M3-4-2412     175TH ST   SPECIAL(0)-1751 24"x18" (6" SE BLACK ON ORAN M4-8(0)-2412	IST IES B)	M3-4-2412   SPECIAL(0)-175+h S+   24"x18" (6" SERIES B)   BLACK ON ORANGE   TOUR   M4-8(0)-2412   M6-3-2115
	M5-1R(0)-2115 M3-2-2412 SPECIAL(0)-1751 24"x18" (6" SE BLACK ON ORAN M4-8(0)-2412 M5-1L(0)-2115	n St IES B)	M3-4-2412 SPECIAL(0)-175th St 24"x18" (6" SERIES B) BLACK ON ORANGE M4-9R(0)-3024
	WEST   M3-4-2412     SPECIAL(0)-1751   SPECIAL(0)-1751     24"x18"   (6" SE     BLACK ON ORAN   M4-8(0)-2412     M5-1L(0)-2115   M5-1L(0)-2115	CL IES B) IES B) IES B) IES B) P 3-SE (18"	FOLLOW   MARKED   HASE I PHASE II   C DISPLAY 3-SEC DISPLAY   LETTERS) (18" LETTERS)   TABLE CHANGEABLE MESSAGE SIGN
DETOUR	PLAN TO STA,	F.A.P RTE.   SECTIO     330   103R-3     MN-09   ILL	SHEETS NU.




- 10. ALL DETOUR SIGNING DESIGNATED WITH "(0)" IN THE SIGN CODE SHALL HAVE BLACK LEGENDS ON ORANGE HIGH INTENSITY BACKGROUNDS AND STANDARD BLACK BORDERS. ALL DETOUR SIGNING SHALL BE NEW OR LIKE NEW CONDITION.
  - 11. THE SIZES OF ALL SIGNS NOT SPECIFIED IN THESE PLANS SHALL BE IN ACCORDANCE WITH THE ILLINOIS MANUAL ON UNIFORM TRAFFIC CONTROL DEVICES.
  - 12. TYPE III BARRICADES, AND THEIR APPLICATION, SHALL CONFORM TO HIGHWAY STANDARD 701901.
  - 13. THE "ROAD CLOSED" SIGN ON A TYPE III BARRICADE SHALL BE MOUNTED ABOVE THE TOP OF THE BARRICADE AS SHOWN IN THE SIGN LEGEND. ALL TYPE III BARRICADES SHALL HAVE TWO AMBER TYPE 'A' LOW INTENSITY FLASHING LIGHTS SPACED NEAR THE CENTERLINE OF THE SUPPORTS.
  - 14. CONSTRUCTION EQUIPMENT SHALL NOT BE PARKED IMMEDIATELY BEHIND THE TYPE III BARRICADES AT ANY TIME. ARTICLE 701.11 OF THE STANDARD SPECIFICATIONS SHALL APPLY.
  - 15. THE ENGINEER SHALL BE NOTIFIED AT LEAST THREE (3) DAYS PRIOR TO THE REMOVAL OF THE DETOUR. THE ENGINEER WILL CONTACT. THE APPROPRIATE LOCAL OFFICIALS AND INTERESTED PARTIES.
  - 16. PORTABLE CHANGEABLE MESSAGE SIGNS SHALL FLASH THE MESSAGE SHOWN IN THE SIGN LEGEND. TWO PHASES SHALL BE USED. EACH PHASE SHALL BE DISPLAYED FOR 3 SECONDS WITH A MAXIMUM CYCLE OF 6 SECONDS. LETTERS SHALL BE 18 INCHES HIGH AND ALL UPPER-CASE. CHANGEABLE MESSAGE SIGNS SHALL COMPLY WITH THE REQUIREMENTS IN SECTION 6F.60 OF THE 2009 MUTCD.

# SIGN LEGEND

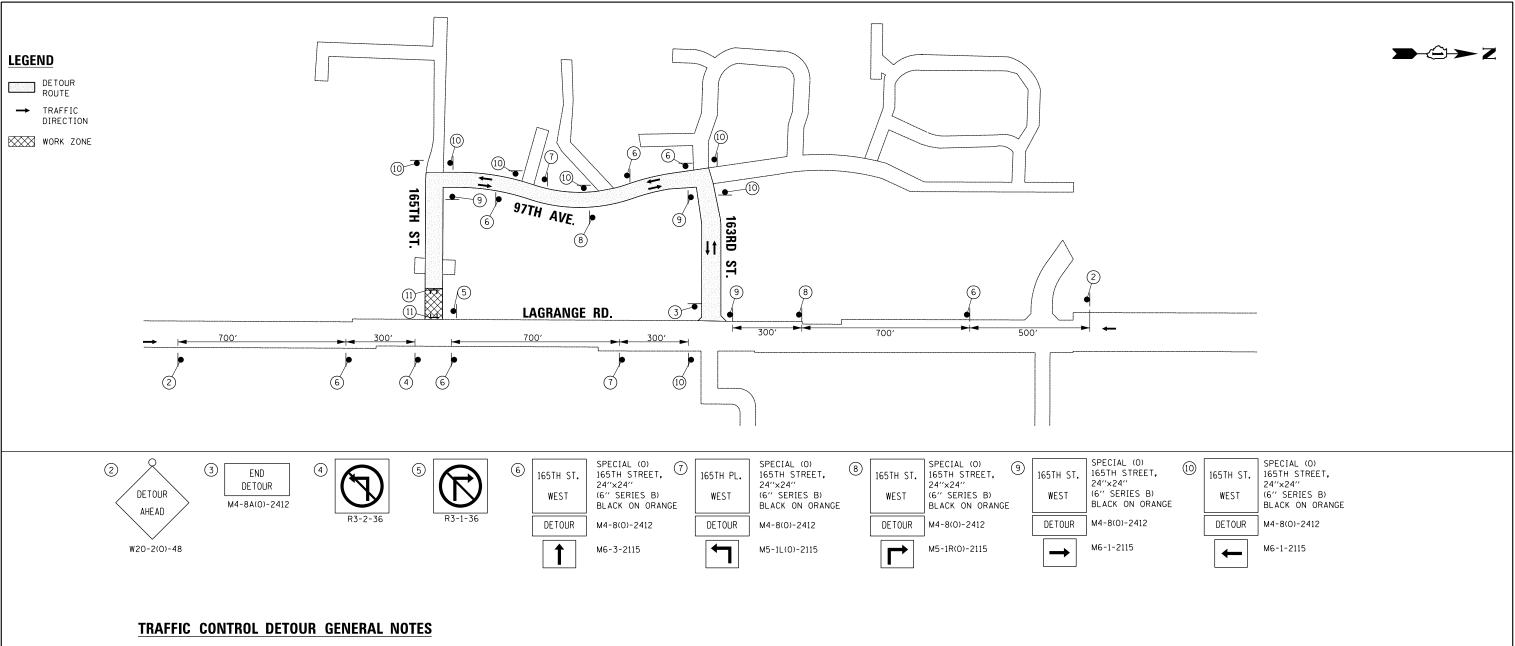				MN–10	CONTRACT	NO. 60	)F05
DETOUR	PLAN		F.A.P RTE. 330	SECTION 103R-3	СООК	932	NO. 115
	171ST ST DETOUR	SPECIAL(0)-171s+ S+ 24"×18" (6" SERIES BLACK ON ORANGE M4-8(0)-2412 M5-1L(0)-2115		AHEAD PHASE I 3-SEC DISPLAY (18" LETTERS) PORTABLE CHAN	DET( PHAS 3-SEC D (18" LE GEABLE MESSA	OUR E II IISPLAY TTERS) GE SIGN	SHEET
(14)	WEST	M3-4-2412		18 171ST ST CLOSED	FOLI		
(13)	EAST 171ST ST DETOUR	M3-2-2412 SPECIAL(0)-171s† S+ 24"×18" (6" SERIES BLACK ON ORANGE M4-8(0)-2412 M5-1L(0)-2115		(17) TTIST SPEC 171ST 24"S ST BLAC DETOUR	-2412 CIAL(0)-171s† (18" (6" SER CK ON ORANG -9R(0)-3024	IES B)	
(12)	WEST 171ST ST DETOUR	M3-4-2412 SPECIAL(0)-171s† S- 24"×18" (6" SERIES BLACK ON ORANGE M4-8(0)-2412 M5-1R(0)-2115		(16) WILDI SPEC 24"> ST DETOUR M4-8	-2412 CIAL(0)-171s+ (18" (6" SER CK ON ORANG 8(0)-2412 3-2115	IES B)	
	EAST 171ST ST DETOUR	M3-2-2412 SPECIAL(0)-171s† S+ 24"×18" (6" SERIES BLACK ON ORANGE M4-8(0)-2412 M6-3-2115		(15) TTIST ST DETOUR	I-2412 CIAL(0)-171s† x18" (6" SER CK ON ORANC •9L(0)-3024	IES B)	

TO STA.

ILLINOIS FED. AID PROJECT



- 1. ALL SIGNING SHALL BE IN ACCORDANCE WITH APPLICABLE PROVISIONS OF THE STATE OF ILLINOIS "STANDARD SPECIFICATIONS FOR ROAD AND BRIDGE CONSTRUCTION" ADOPTED JANUARY 1, 2012, THE DETAILS IN THESE PLANS, AND THE LATEST EDITION OF THE STATE OF ILLINOIS "MANUAL ON UNIFORM TRAFFIC CONTROL DEVICES".
- 2. THE CONTRACTOR SHALL PROCEED WITH THE WORK IN AN EXPEDIENT MANNER TO REDUCE THE LENGTH OF DURATION OF THE 165TH STREET DETOUR; THE DETOUR SHALL NOT EXCEED TWENTY-ONE (21) CALENDAR DAYS ...
- 3. THE ENGINEER SHALL BE NOTIFIED IN WRITING AT LEAST THREE WEEKS PRIOR TO THE DAY THE DETOUR IS TO BE IN EFFECT. THE ENGINEER WILL CONTACT THE APPROPRIATE OFFICIALS AND INTERESTED PARTIES.
- 4. THE ROADS SHALL NOT BE CLOSED UNTIL ALL SIGNING IS ERECTED IN ACCORDANCE WITH THE DETOUR PLAN AND APPROVED BY THE ENGINEER.
- 5. THE CONTRACTOR SHALL MAKE ALL CHANGES IN THE SIGNING THAT ARE DEEMED NECESSARY BY THE ENGINEER.
- 6. THE CONTRACTOR SHALL BE RESPONSIBLE FOR MAINTENANCE OF ALL BARRICADES, SIGNS, LIGHTS, AND OTHER TRAFFIC CONTROL DEVICES, INSTALLED BY HIM, THAT ARE IN PLACE AND OPERATING 24 HOURS A DAY, 7 DAYS A WEEK, FOR THE DURATION OF THIS DETOUR.
- 7. ALL EXISTING SIGNING THAT DOES NOT APPLY AND/OR CONFLICTS WITH THE DETOUR ROUTE WHILE THE DETOUR IS IN EFFECT SHALL BE COMPLETELY COVERED BY THE CONTRACTOR.
- 8. ALL DETOUR SIGNING SHALL BE POST MOUNTED PER ARTICLE 701.14 AND STANDARD 701901.

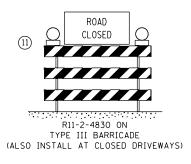
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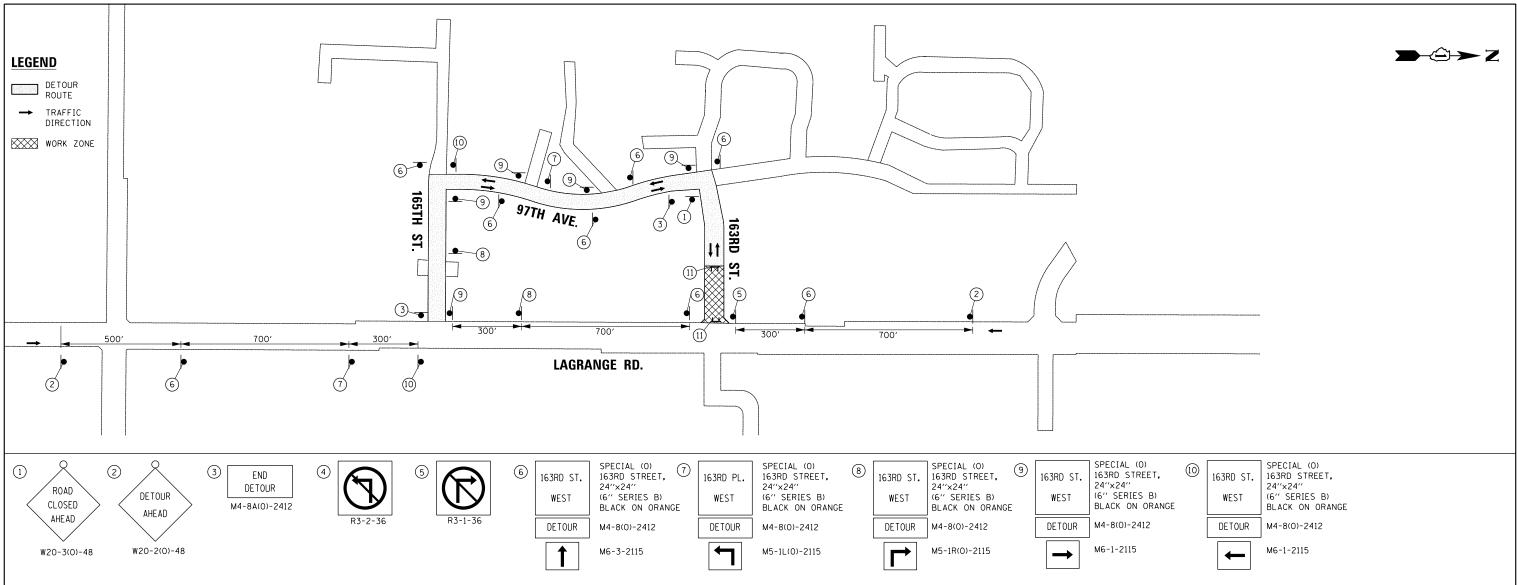
9. ALL DETOUR SIGNING DESIGNATED WITH "(O)" IN THE SIGN CODE SHALL HAVE BLACK LEGENDS ON ORANGE HIGH INTENSITY BACKGROUNDS AND STANDARD BLACK BORDERS. ALL DETOUR SIGNING SHALL BE NEW OR LIKE NEW CONDITION.

- 10. THE SIZES OF ALL SIGNS NOT SPECIFIED IN THESE PLANS SHALL BE IN ACCORDANCE WITH THE ILLINOIS MANUAL ON UNIFORM TRAFFIC CONTROL DEVICES.
- 11. TYPE III BARRICADES, AND THEIR APPLICATION, SHALL CONFORM TO HIGHWAY STANDARD 701901.
- 12. THE "ROAD CLOSED" SIGN ON A TYPE III BARRICADES SHALL BE MOUNTED ABOVE THE TOP OF THE BARRICADE AS SHOWN IN THE SIGN LEGEND. ALL TYPE III BARRICADES SHALL HAVE TWO AMBER TYPE 'A' LOW INTENSITY FLASHING LIGHTS SPACED NEAR THE CENTERLINE OF THE SUPPORTS.
- 13. CONSTRUCTION EQUIPMENT SHALL NOT BE PARKED IMMEDIATELY BEHIND THE TYPE III BARRICADES AT ANY TIME. ARTICLE 107.14 OF THE STANDARD SPECIFICATIONS SHALL APPLY.
- 14. THE ENGINEER SHALL BE NOTIFIED AT LEAST THREE (3) DAYS PRIOR TO THE REMOVAL OF THE DETOUR. THE ENGINEER WILL CONTACT THE APPROPRIATE LOCAL OFFICIALS AND INTERESTED PARTIES.
- 15. PORTABLE CHANGEABLE MESSAGE SIGNS SHALL FLASH THE MESSAGE SHOWN IN THE SIGN LEGEND. TWO PHASES SHALL BE USED. EACH PHASE SHALL BE DISPLAYED FOR 3 SECONDS WITH A MAXIMUM CYCLE OF 6 SECONDS, LETTERS SHALL BE 18 INCHES HIGH AND ALL UPPER-CASE, CHANGEABLE MESSAGE SIGNS SHALL COMPLY WITH THE REQUIREMENTS IN SECTION 6F.60 OF THE 2009 MUTCD.
- 16. NO CONSECUTIVE STREETS SHALL BE COMPLETELY CLOSED DURING THE CONSTRUCTION.
- 17. DRIVEWAYS EXITING TO SIDE STREET CLOSURES SHALL BE CLOSED WITH TYPE III BARRICADES. THE LAGRANGE ROAD DRIVEWAY SERVING A PROPERTY SHALL REMAIN OPEN AT ALL TIMES DURING CLOSURE OF THE SIDE STREET DRIVEWAY. FOR PROPERTIES WITH ONLY ONE DRIVEWAY EXITING TO A SIDE STREET CLOSURE, ACCESS SHALL BE PROVIDED AS SPECIFIED IN THE SPECIAL PROVISION FOR "AGGREGATE SURFACE COURSE FOR TEMPORARY ACCESS".

<b>V</b> 4									
	FILE NAME =	USER NAME = Nicholas_Talarico	DESIGNED -	BA	REVISED -		DETOUR PLAN - WEST LEG CLOSURE	F.A.P SECTION	COUNTY TOTAL SHEET
	D160F05-SHT-DETOUR 1 165th.dgn		DRAWN -	BA	REVISED -	STATE OF ILLINOIS	165TH STREET AT	330 103R-3	СООК 932 116
		PLOT SCALE = 400.0000 ' / in.	CHECKED -	RCH	REVISED -	DEPARTMENT OF TRANSPORTATION	US 45 (LAGRANGE ROAD)	MN–11	CONTRACT NO. 60F05
	SHT_PLAN	PLOT DATE = 3/14/2013	DATE -	03/13/13	REVISED -		SCALE: NTS SHEET 3 OF 5 SHEETS STA. TO STA.		ND PROJECT







# TRAFFIC CONTROL DETOUR GENERAL NOTES

- 1. ALL SIGNING SHALL BE IN ACCORDANCE WITH APPLICABLE PROVISIONS OF THE STATE OF ILLINOIS "STANDARD SPECIFICATIONS FOR ROAD AND BRIDGE CONSTRUCTION" ADOPTED JANUARY 1, 2012, THE DETAILS IN THESE PLANS, AND THE LATEST EDITION OF THE STATE OF ILLINOIS "MANUAL ON UNIFORM TRAFFIC CONTROL DEVICES".
- 2. THE CONTRACTOR SHALL PROCEED WITH THE WORK IN AN EXPEDIENT MANNER TO REDUCE THE LENGTH OF DURATION OF THE 163RD STREET DETOUR; THE DETOUR SHALL NOT EXCEED TWENTY-ONE (21) CALENDAR DAYS ...
- 3. THE ENGINEER SHALL BE NOTIFIED IN WRITING AT LEAST THREE WEEKS PRIOR TO THE DAY THE DETOUR IS TO BE IN EFFECT. THE ENGINEER WILL CONTACT THE APPROPRIATE OFFICIALS AND INTERESTED PARTIES.
- 4. THE ROADS SHALL NOT BE CLOSED UNTIL ALL SIGNING IS ERECTED IN ACCORDANCE WITH THE DETOUR PLAN AND APPROVED BY THE ENGINEER.
- 5. THE CONTRACTOR SHALL MAKE ALL CHANGES IN THE SIGNING THAT ARE DEEMED NECESSARY BY THE ENGINEER.
- 6. THE CONTRACTOR SHALL BE RESPONSIBLE FOR MAINTENANCE OF ALL BARRICADES, SIGNS, LIGHTS, AND OTHER TRAFFIC CONTROL DEVICES, INSTALLED BY HIM, THAT ARE IN PLACE AND OPERATING 24 HOURS A DAY, 7 DAYS A WEEK, FOR THE DURATION OF THIS DETOUR.
- 7. ALL EXISTING SIGNING THAT DOES NOT APPLY AND/OR CONFLICTS WITH THE DETOUR ROUTE WHILE THE DETOUR IS IN EFFECT SHALL BE COMPLETELY COVERED BY THE CONTRACTOR.
- 8. ALL DETOUR SIGNING SHALL BE POST MOUNTED PER ARTICLE 701.14 AND STANDARD 701901.

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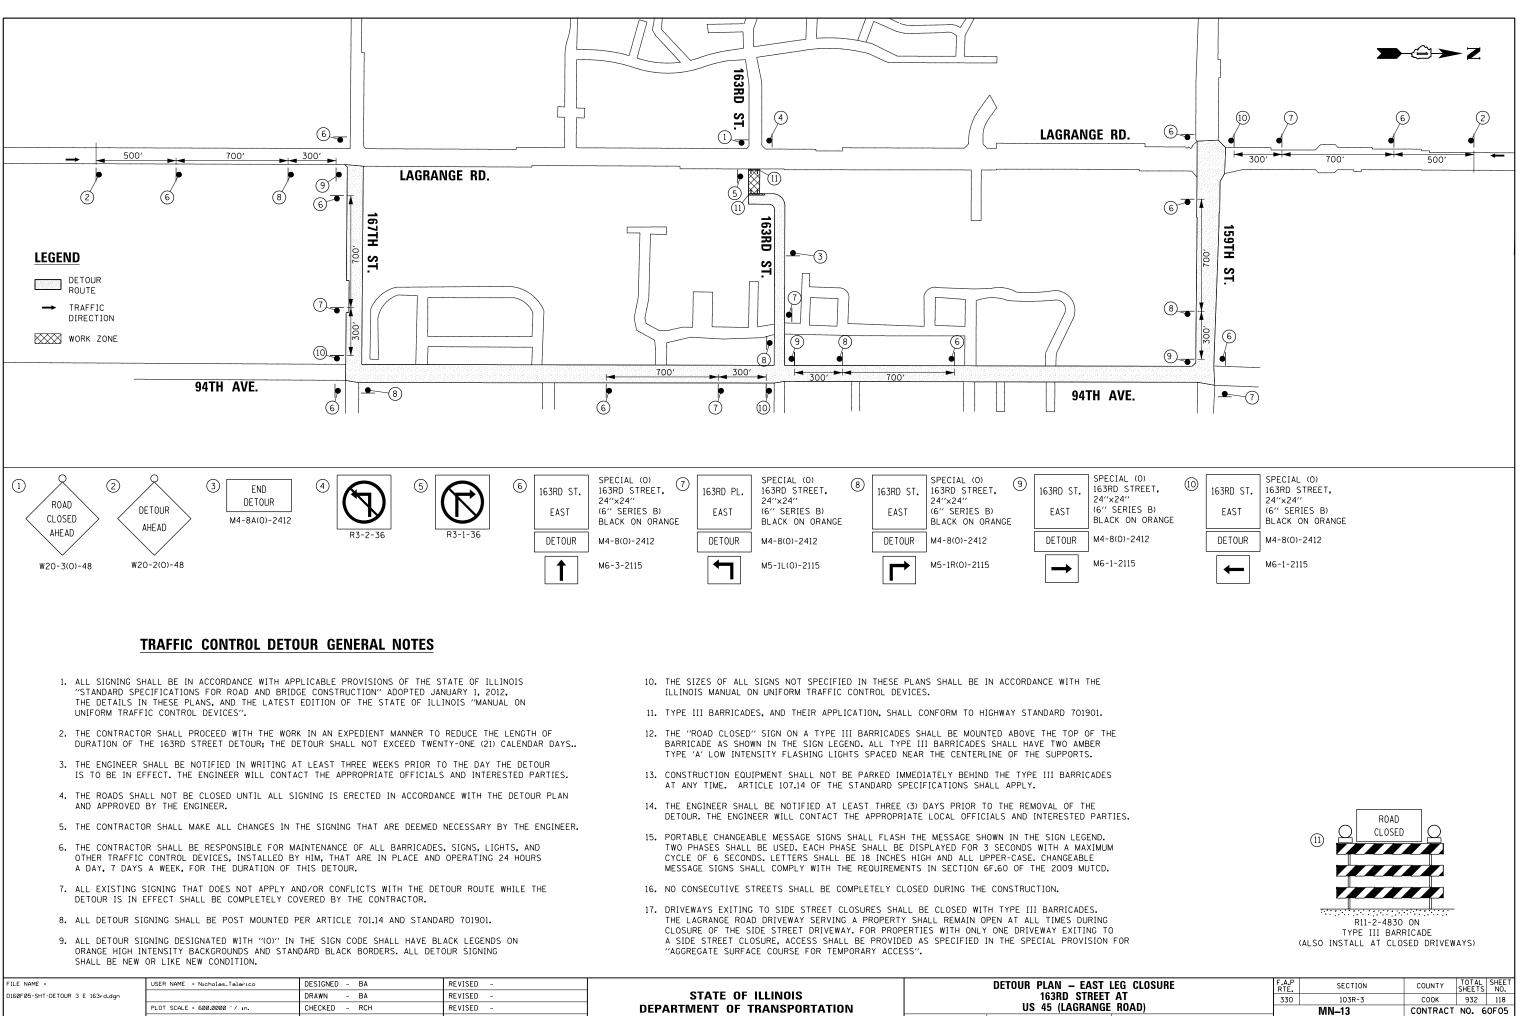
9. ALL DETOUR SIGNING DESIGNATED WITH "(O)" IN THE SIGN CODE SHALL HAVE BLACK LEGENDS ON ORANGE HIGH INTENSITY BACKGROUNDS AND STANDARD BLACK BORDERS. ALL DETOUR SIGNING SHALL BE NEW OR LIKE NEW CONDITION.

- 10. THE SIZES OF ALL SIGNS NOT SPECIFIED IN THESE PLANS SHALL BE IN ACCORDANCE WITH THE ILLINOIS MANUAL ON UNIFORM TRAFFIC CONTROL DEVICES.
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- 15. PORTABLE CHANGEABLE MESSAGE SIGNS SHALL FLASH THE MESSAGE SHOWN IN THE SIGN LEGEND. TWO PHASES SHALL BE USED. EACH PHASE SHALL BE DISPLAYED FOR 3 SECONDS WITH A MAXIMUM CYCLE OF 6 SECONDS, LETTERS SHALL BE 18 INCHES HIGH AND ALL UPPER-CASE, CHANGEABLE MESSAGE SIGNS SHALL COMPLY WITH THE REQUIREMENTS IN SECTION 6F.60 OF THE 2009 MUTCD.
- 16. NO CONSECUTIVE STREETS SHALL BE COMPLETELY CLOSED DURING THE CONSTRUCTION.
- 17. DRIVEWAYS EXITING TO SIDE STREET CLOSURES SHALL BE CLOSED WITH TYPE III BARRICADES. THE LAGRANGE ROAD DRIVEWAY SERVING A PROPERTY SHALL REMAIN OPEN AT ALL TIMES DURING CLOSURE OF THE SIDE STREET DRIVEWAY. FOR PROPERTIES WITH ONLY ONE DRIVEWAY EXITING TO A SIDE STREET CLOSURE, ACCESS SHALL BE PROVIDED AS SPECIFIED IN THE SPECIAL PROVISION FOR "AGGREGATE SURFACE COURSE FOR TEMPORARY ACCESS".

<b>V</b> 4								
	FILE NAME =	USER NAME = Nicholas_Talarico	DESIGNED - BA	REVISED -		DETOUR PLAN - WEST LEG CLOSURE	F.A.P SECTION	COUNTY TOTAL SHEET
	D160F05-SHT-DETOUR 2 163rd.dgn		DRAWN - BA	REVISED -	STATE OF ILLINOIS	163RD STREET AT	330 103R-3	СООК 932 117
		PLOT SCALE = 400.0000 ' / in.	CHECKED - RCH	REVISED -	DEPARTMENT OF TRANSPORTATION	US 45 (LAGRANGE ROAD)	MN-12	CONTRACT NO. 60F05
	SHT_PLAN	PLOT DATE = 3/14/2013	DATE - 03/13/13	REVISED -		SCALE: NTS SHEET 4 OF 5 SHEETS STA. TO STA.		ED. AID PROJECT








TO STA.


ILLINOIS FED AID PROJECT

<b>A</b>	FILE NAME = D160F05-SHT-DETOUR 3 E 163rd.don	USER NAME = Nicholas_Talarico	DESIGNED – BA DRAWN – BA	REVISED - REVISED -	STATE OF ILLINOIS		DETOUR PLAN - EAST LEG CLO 163RD STREET AT
5	DI60F05-SHI-DETUUR 3 E I63rd.dgn	PLOT SCALE = 600.0000 ′ / In.	CHECKED - RCH	REVISED -	DEPARTMENT OF TRANSPORTATION		US 45 (LAGRANGE ROAD)
	SHT_PLAN	PLOT DATE = 3/14/2013	DATE - 03/13/13	REVISED -		SCALE: NTS	SHEET 5 OF 5 SHEETS STA.




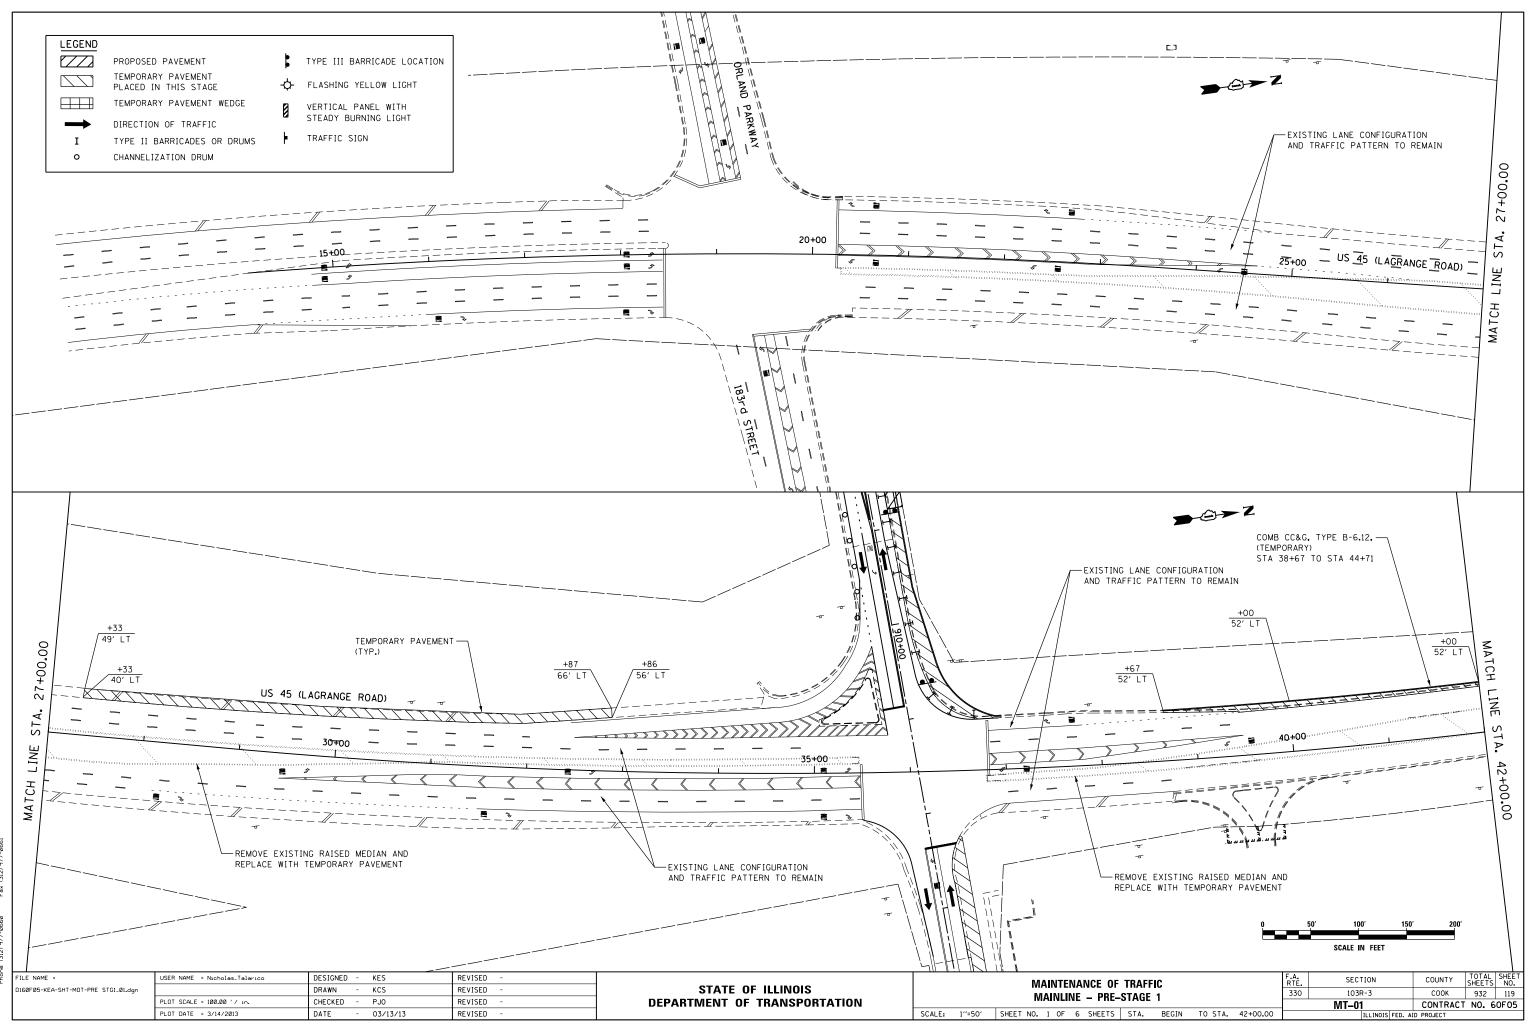

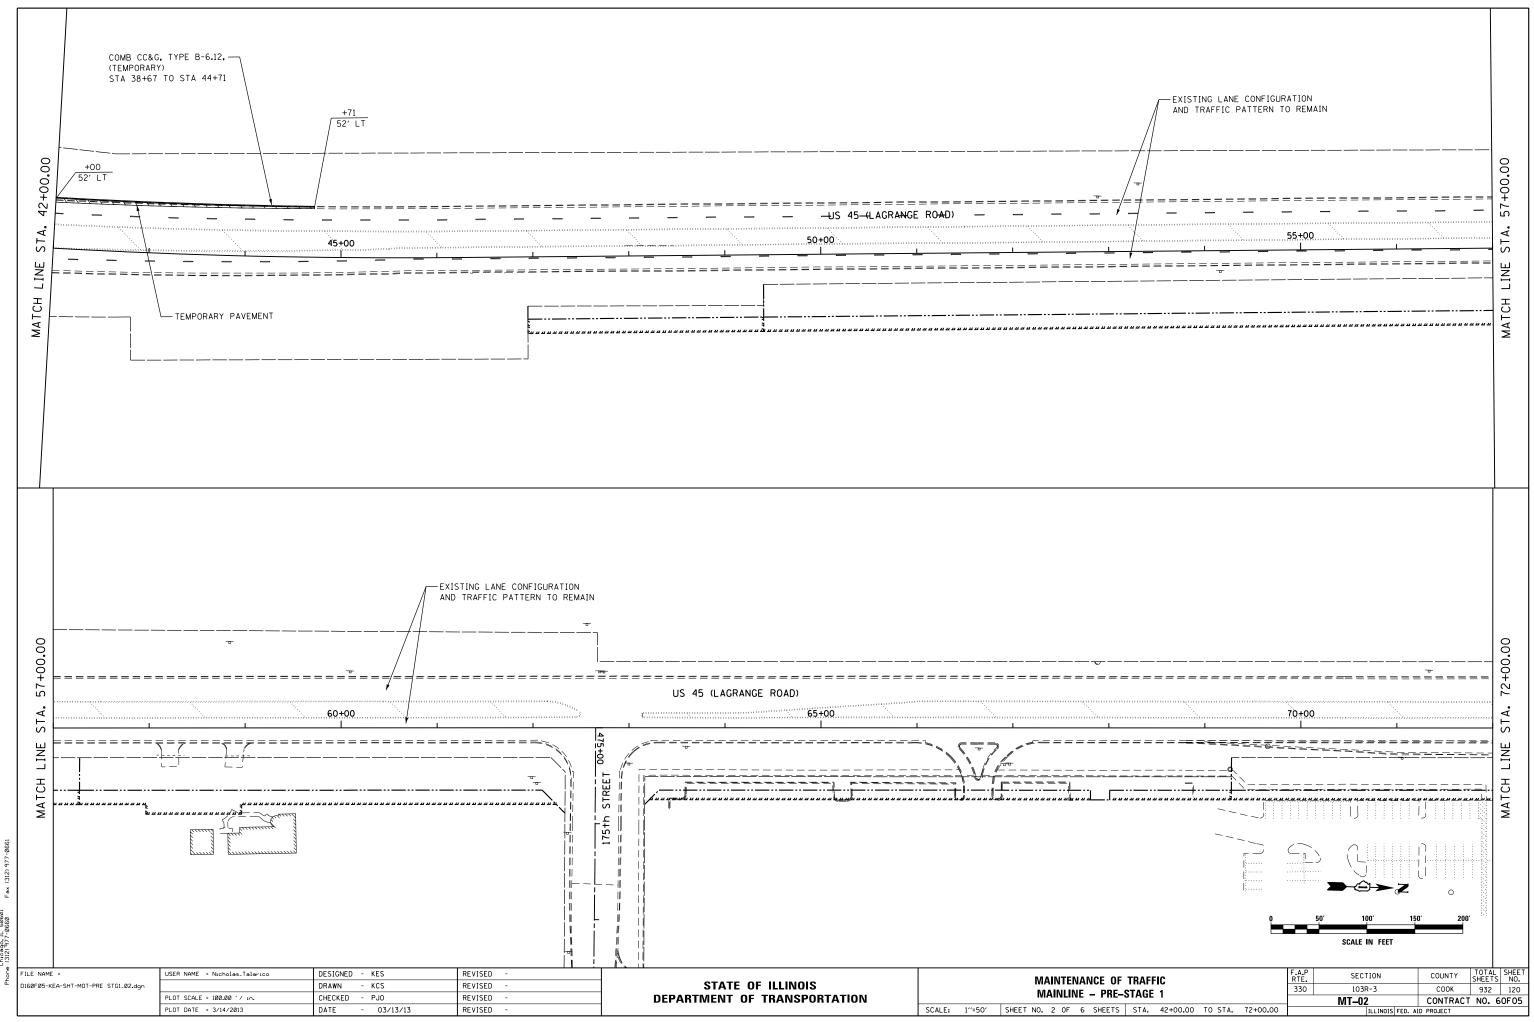
ACONSULTING ENGINEERS, LLC III E. Worker Drive, Sure 520 Phone (1312) 77-0660 F.x. (312) 977-0661




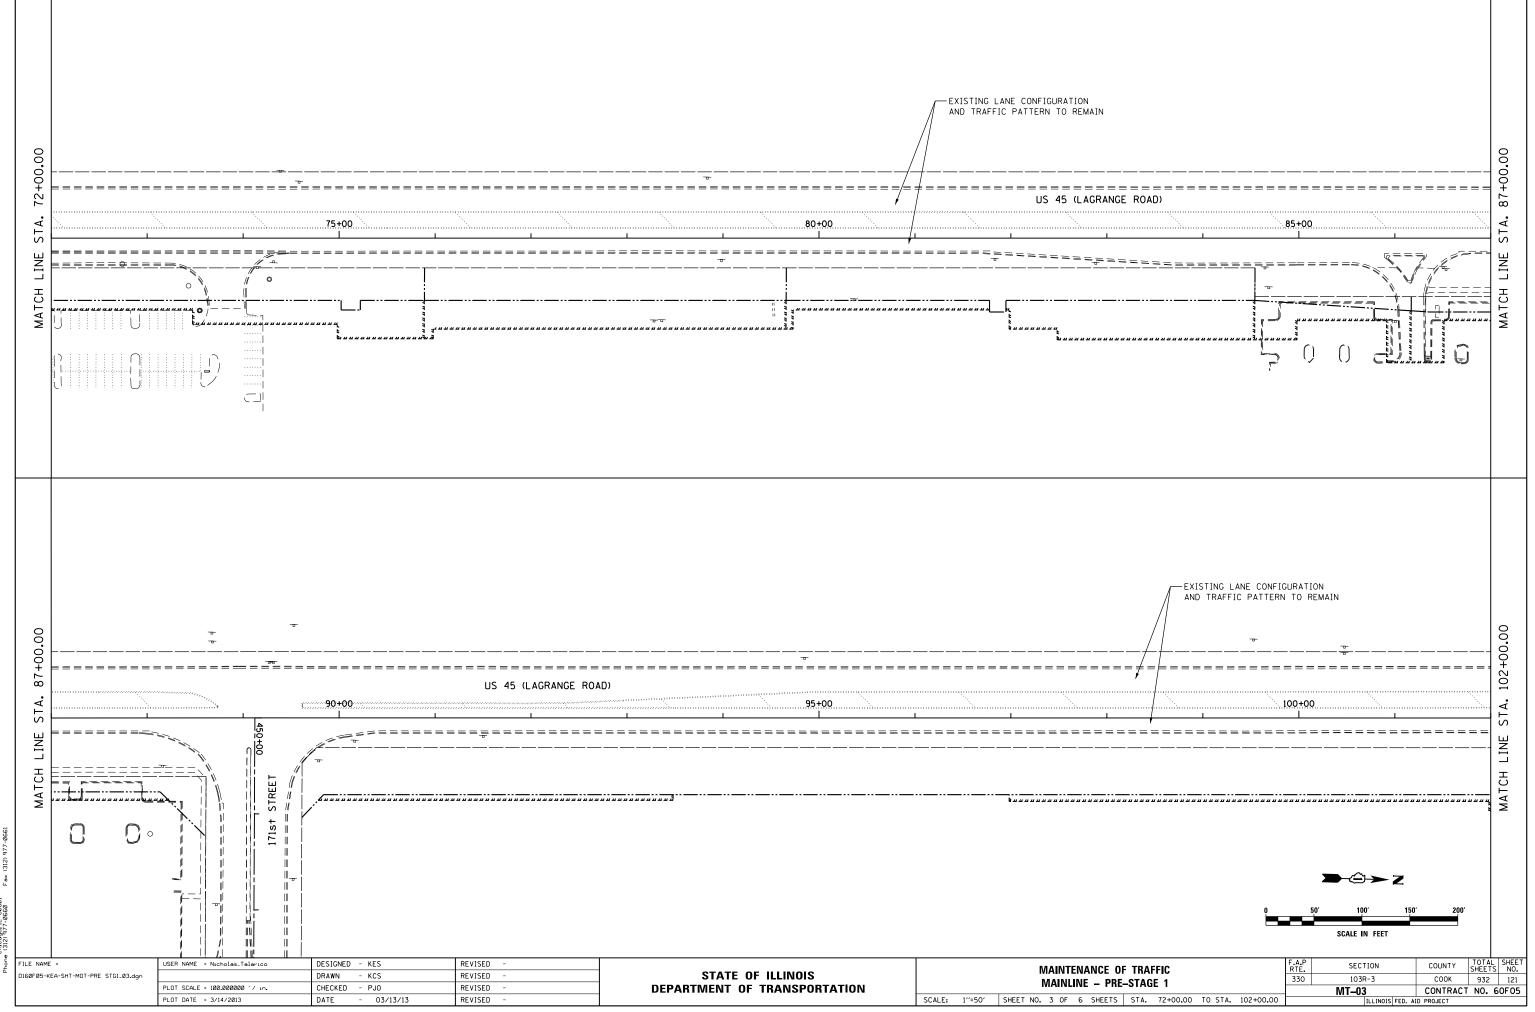CONSULTING ENGINEERS, LLC CONSULTING ENGINEERS, LLC THE, WORD, DAVE, SUITE 520 Phone (312) 477-0660 Fax (312) 977-066




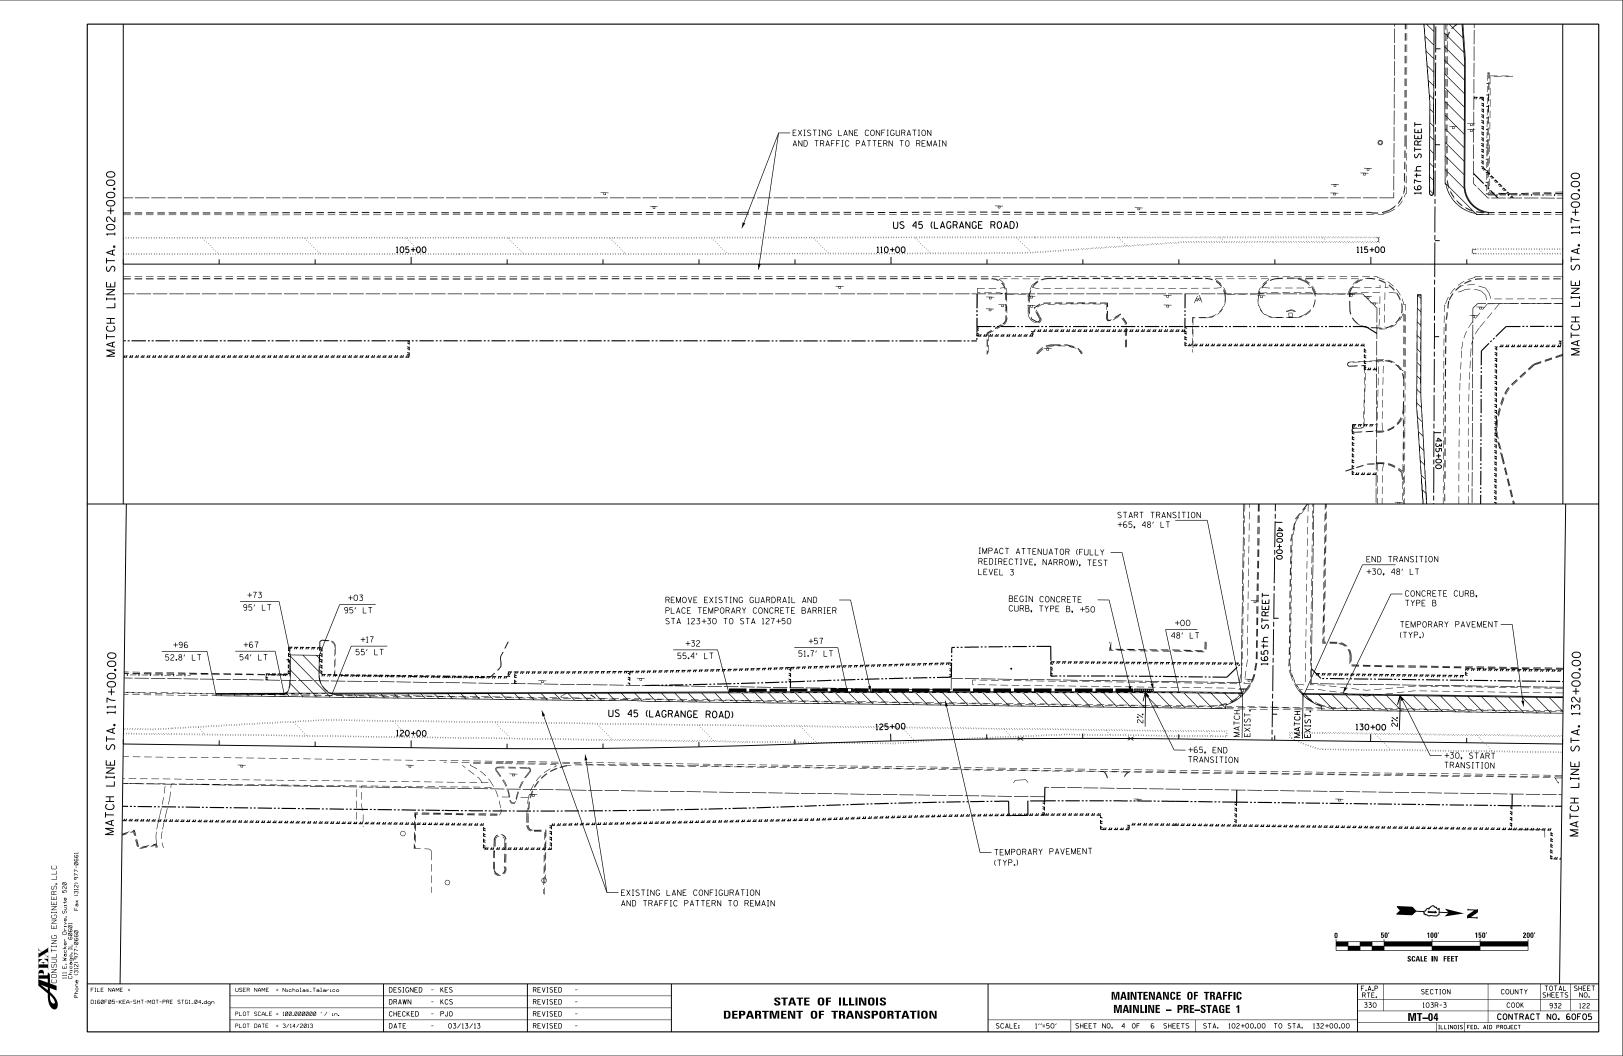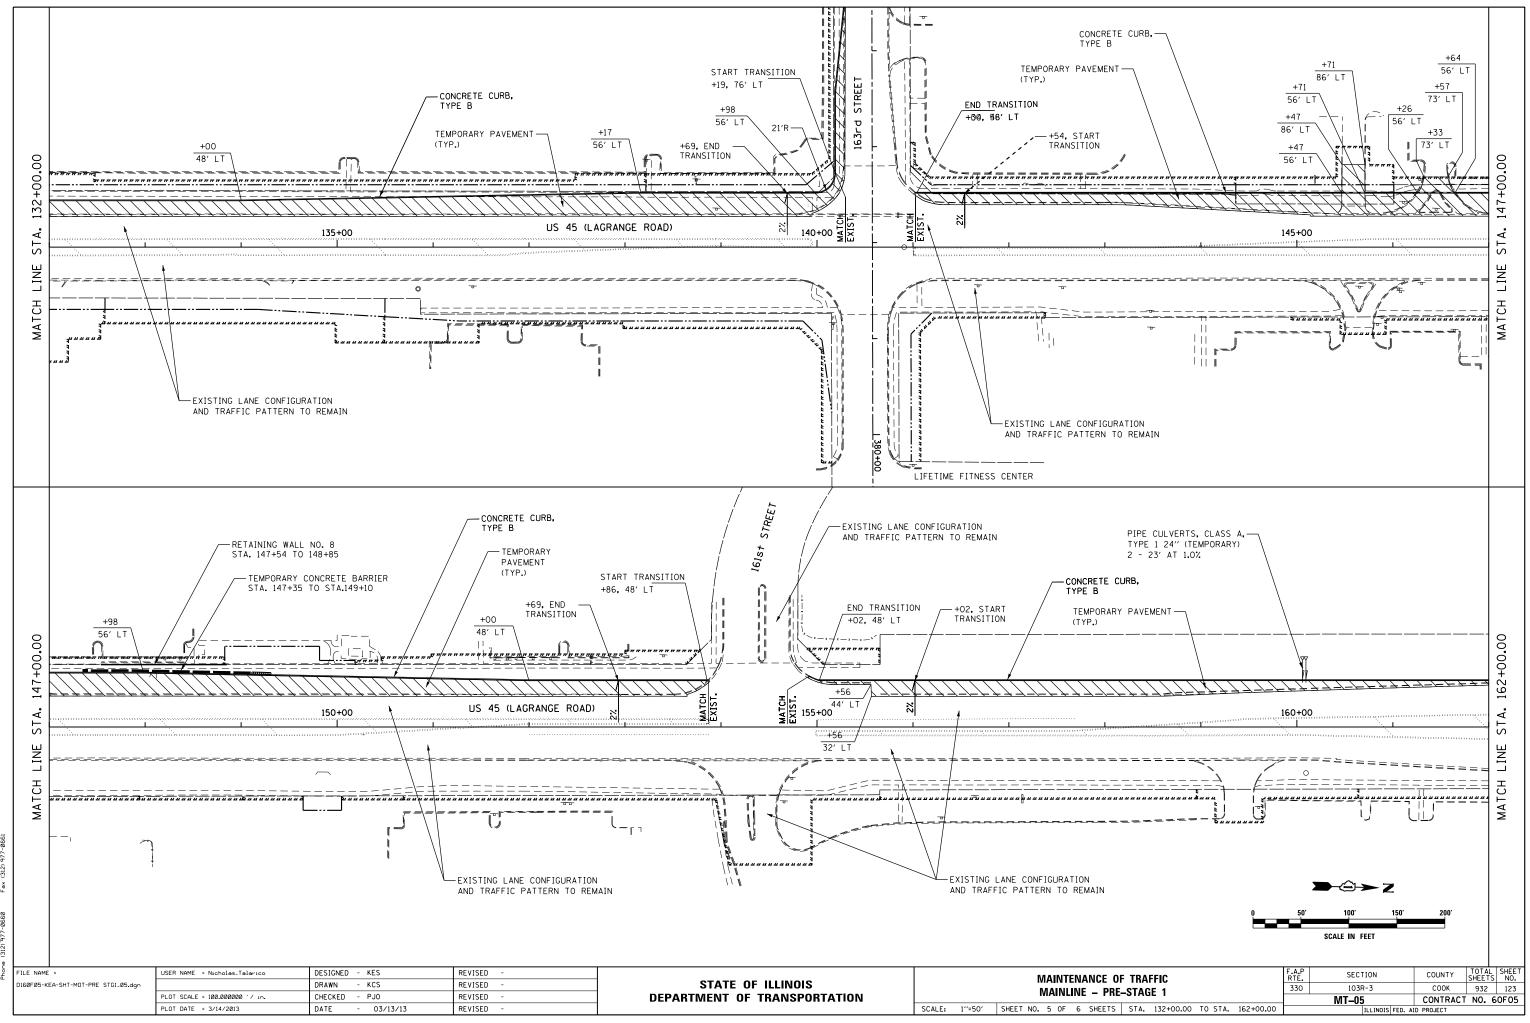CONSULTING ENGINEERS, LLC UII E. Worker Drive, Suite 528 Phone (312) 977-0660 Foxe (312) 977-0661






Phone (312) 977-0600 Fox (312) 977-06

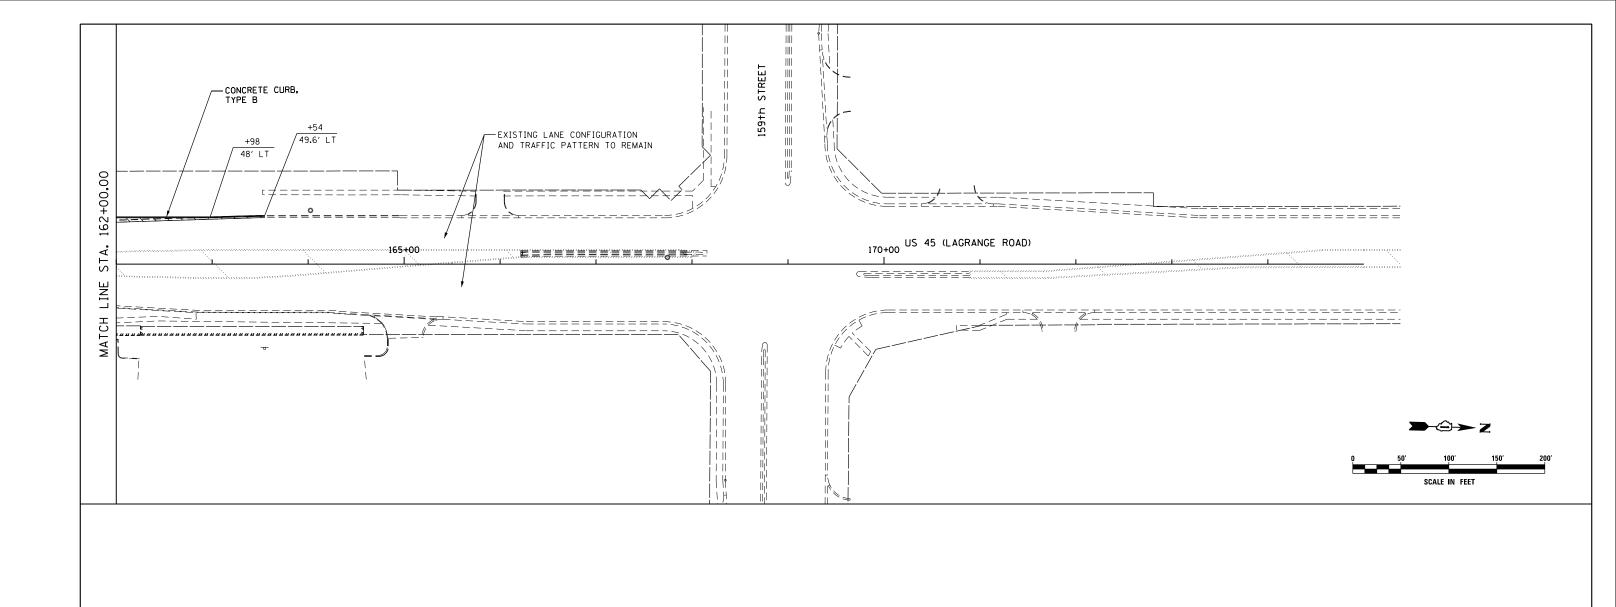


Phone (312) 977-0660 Fax (312) 977-0661


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D160F05-KEA-SHT-MOT-PRE_STG1_06.dgn		DRAWN - KCS	REVISED -	STATE OF ILLINOIS		330	103R-3	COOK 932 124
	PLOT SCALE = 100.0000000 '/ in.	CHECKED - PJO	REVISED -	DEPARTMENT OF TRANSPORTATION	MAINLINE – PRE–STAGE 1		MT-06	CONTRACT NO. 60F05
	PLOT DATE = 3/14/2013	DATE - 03/13/13	REVISED -		SCALE: 1"=50" SHEET NO. 6 OF 6 SHEETS STA. 162+00.00 TO STA. END			ID PROJECT

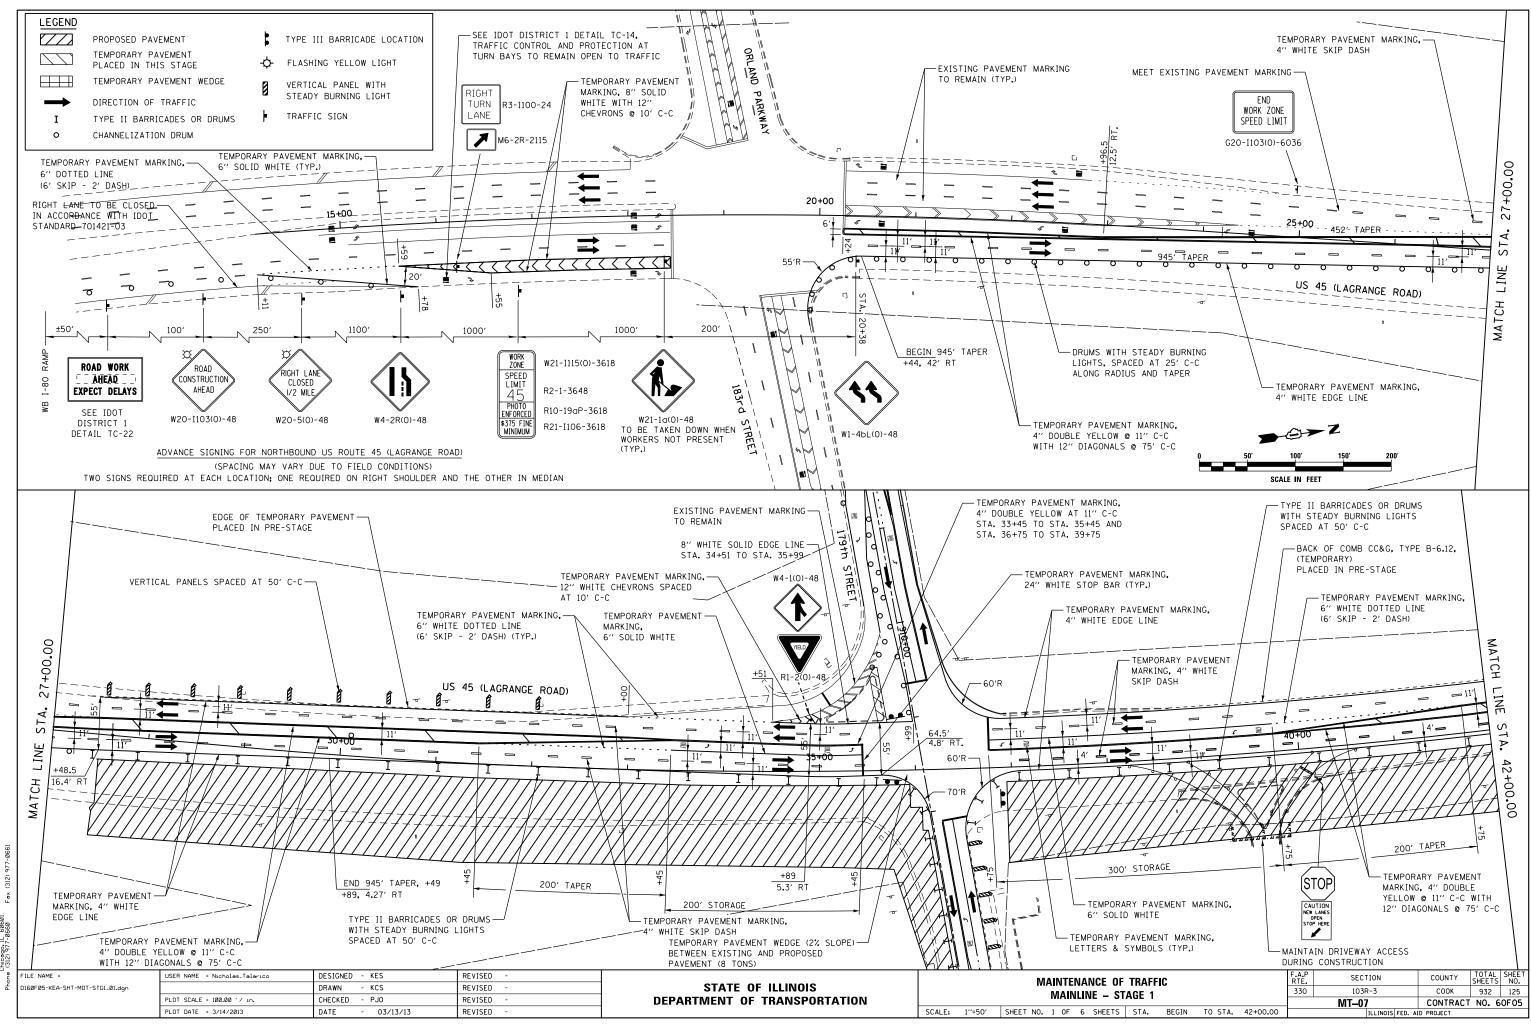


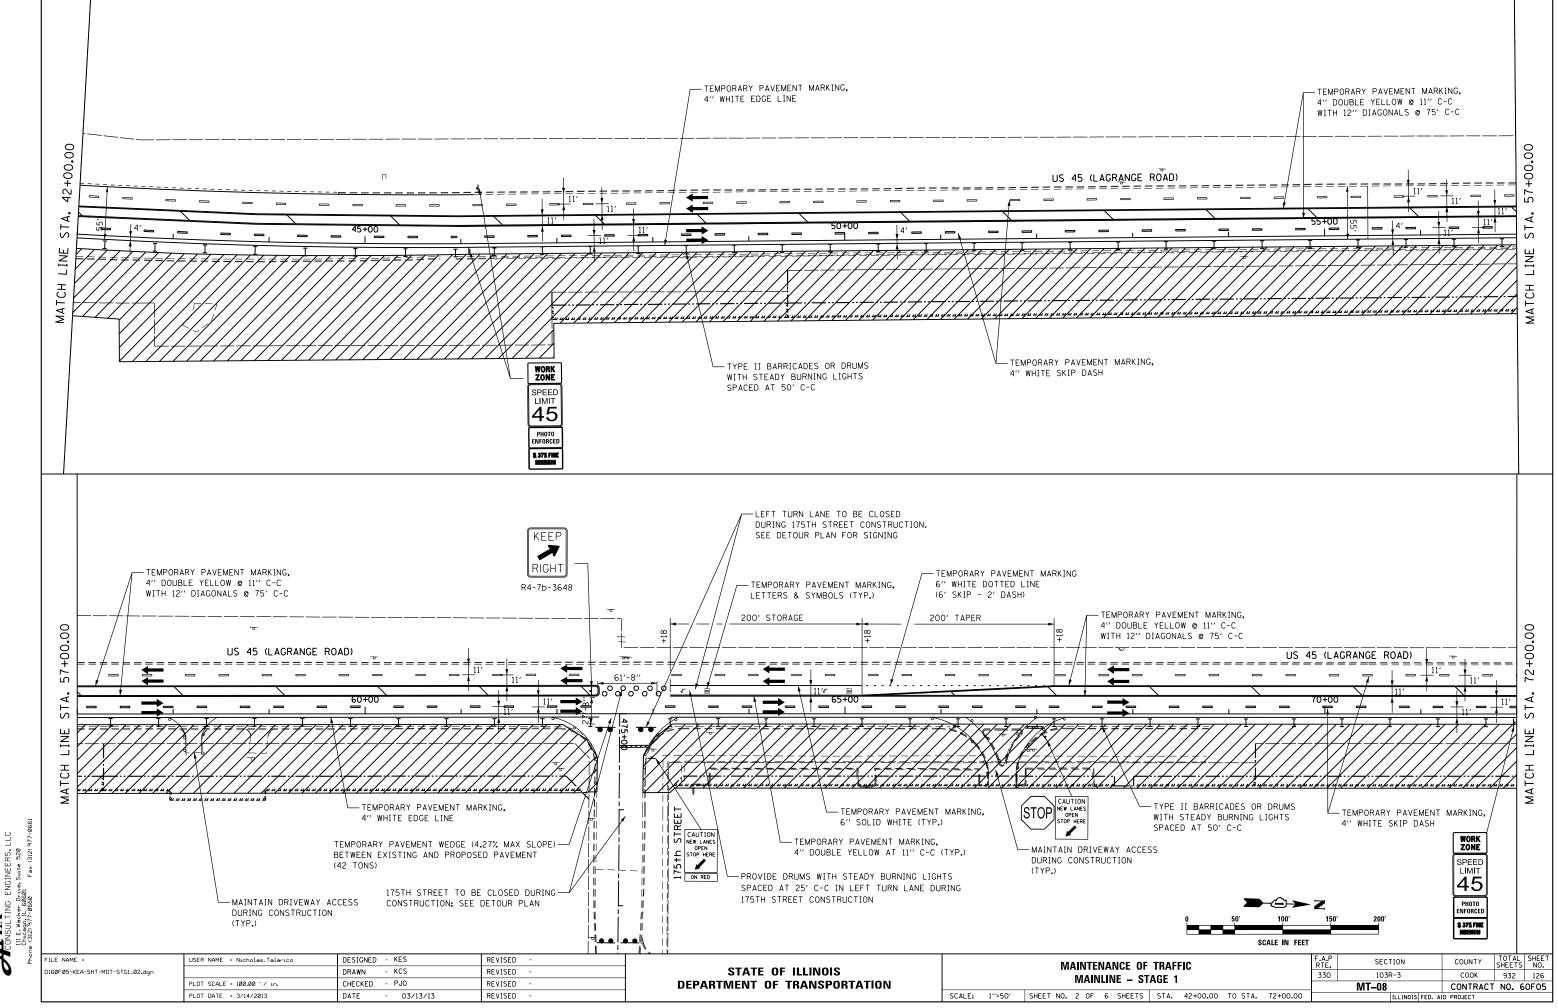520 312) INE Suite Fax ING ENG er Drive, 5 68601 .11 E. Wacke Chicago, 1L (312) 977-1





**TENNER** 1 977

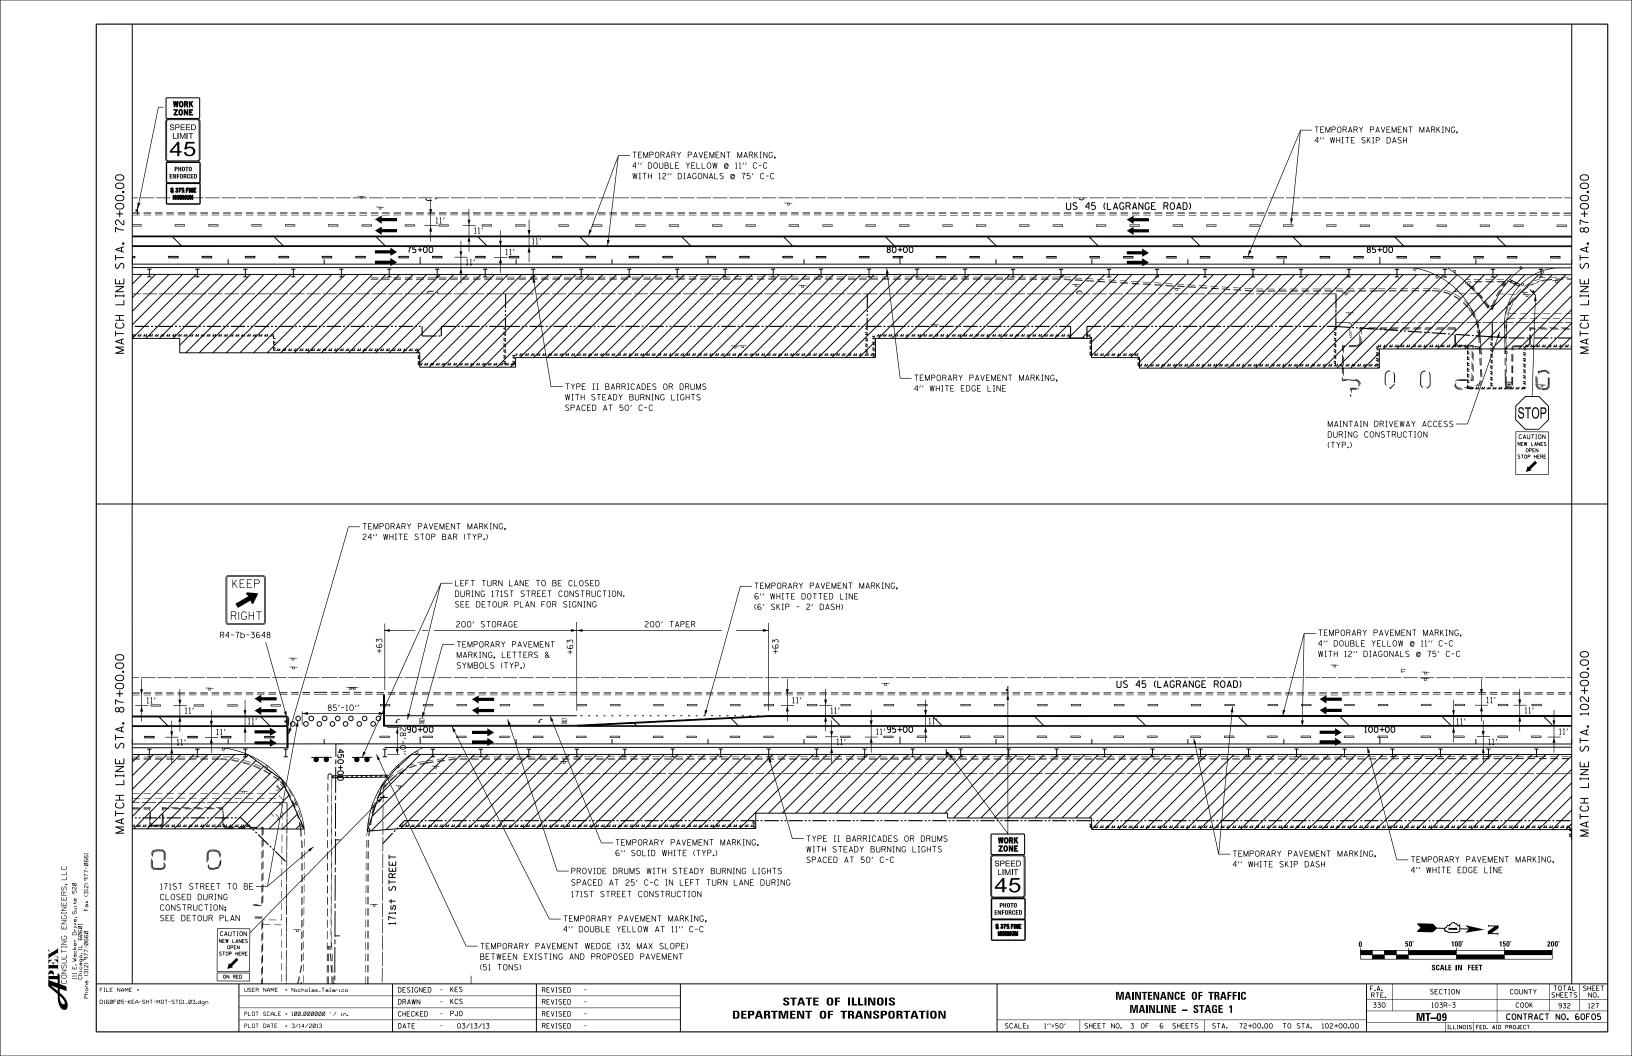

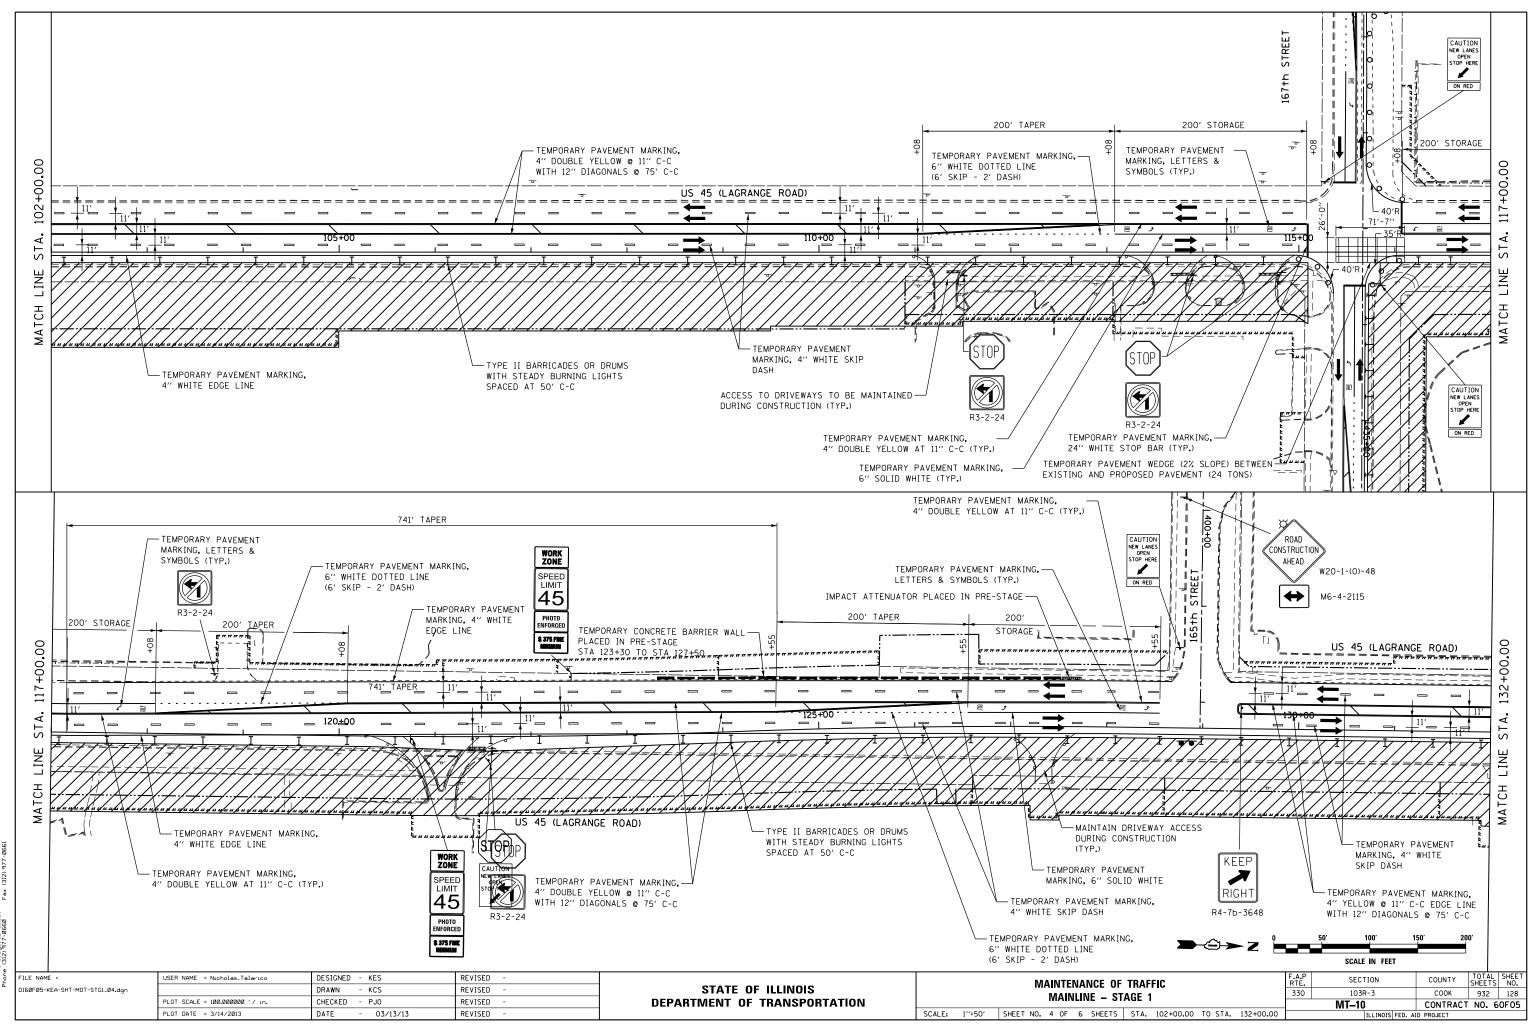

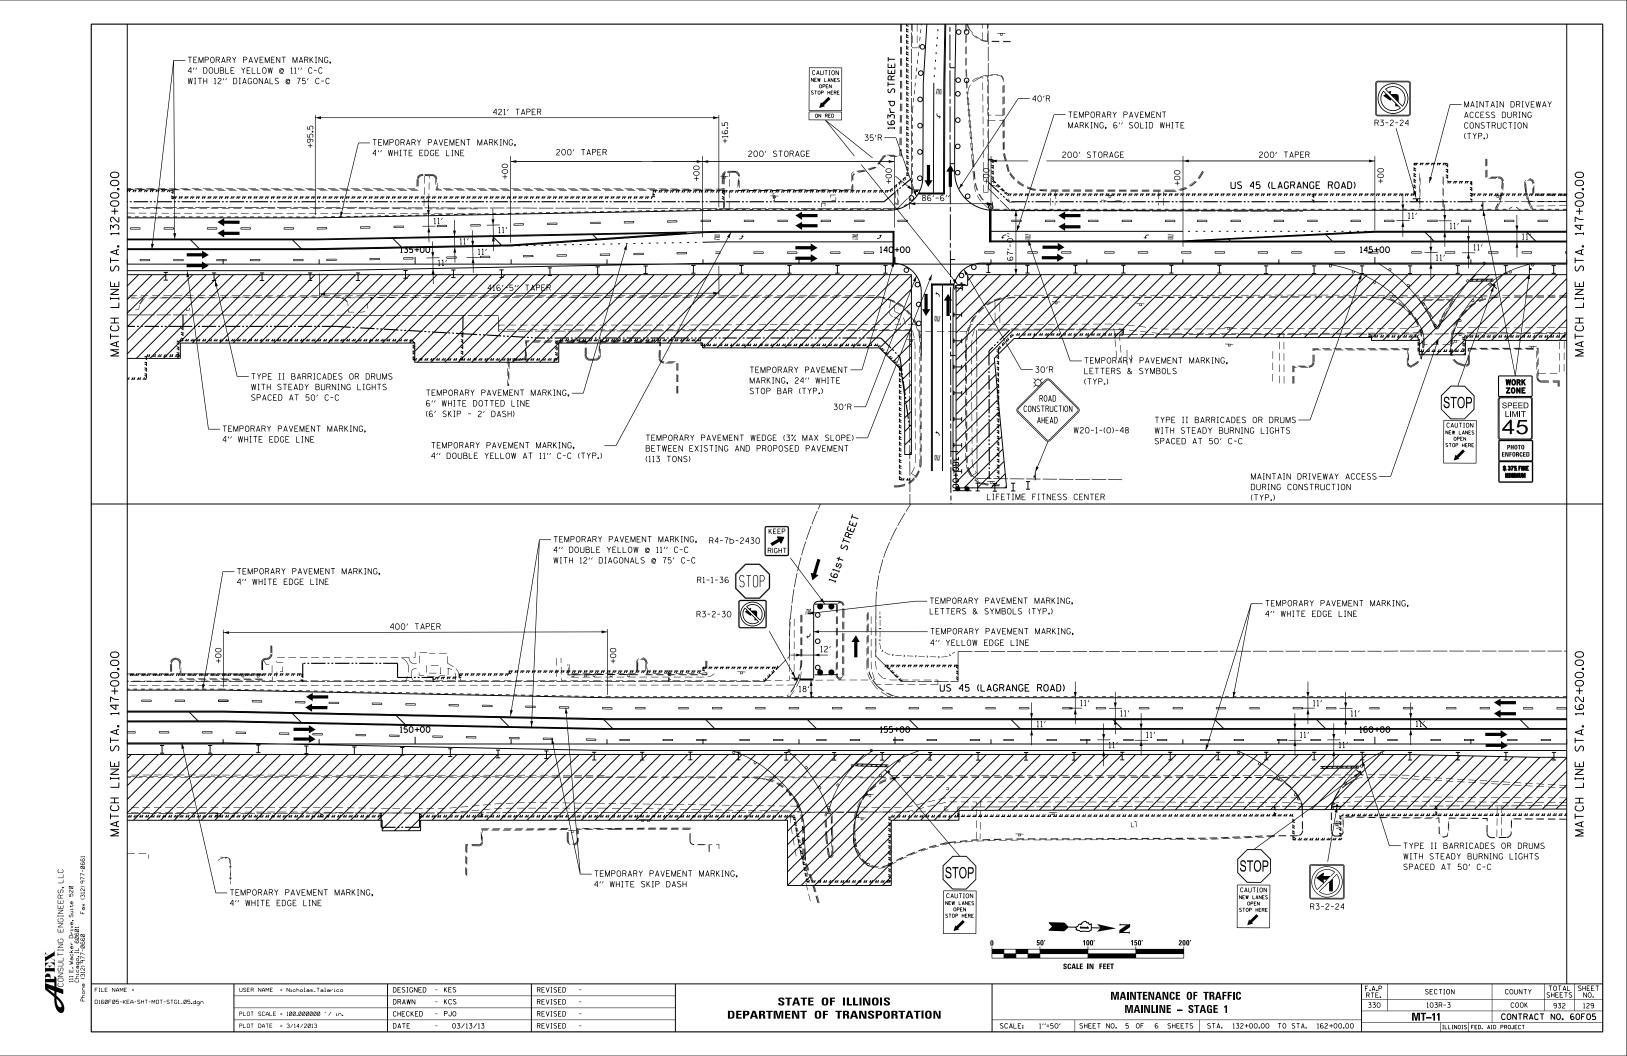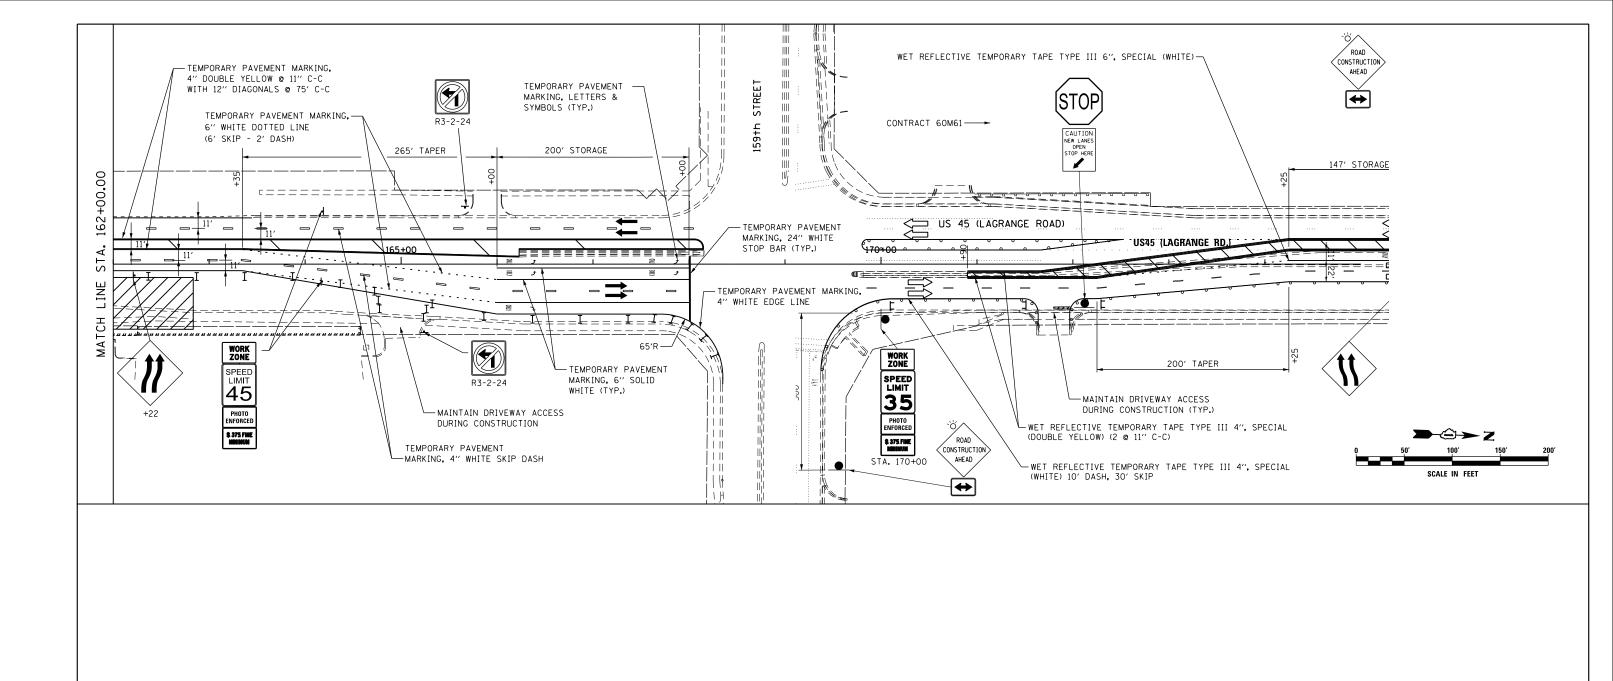
ACONSULTING ENGINEERS, L III E. WORK, Dr.VO. Suite 520 Phone Margonil 26601 Fax (312) 9






CLONSULTING ENGINEERS, LLC UILE. Macher Dave. Suite 528 Phone 0312977-0660 Fax (312) 977-066


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D160F05-KEA-SHT-MOT-STG1_06.dgn		DRAWN - KCS	REVISED -	STATE OF ILLINOIS	MAINTENANCE OF THAT TO MAINLINE – STAGE 1	330 10	103R-3	COOK 932 130
	PLOT SCALE = 100.000000 '/ in.	CHECKED - PJO	REVISED -	DEPARTMENT OF TRANSPORTATION		MT-	-12	CONTRACT NO. 60F05
	PLOT DATE = 3/14/2013	DATE - 03/13/13	REVISED -		SCALE: 1"=50" SHEET NO. 6 OF 6 SHEETS STA. 162+00.00 TO STA. END		ILLINOIS FED. AID F	PROJECT

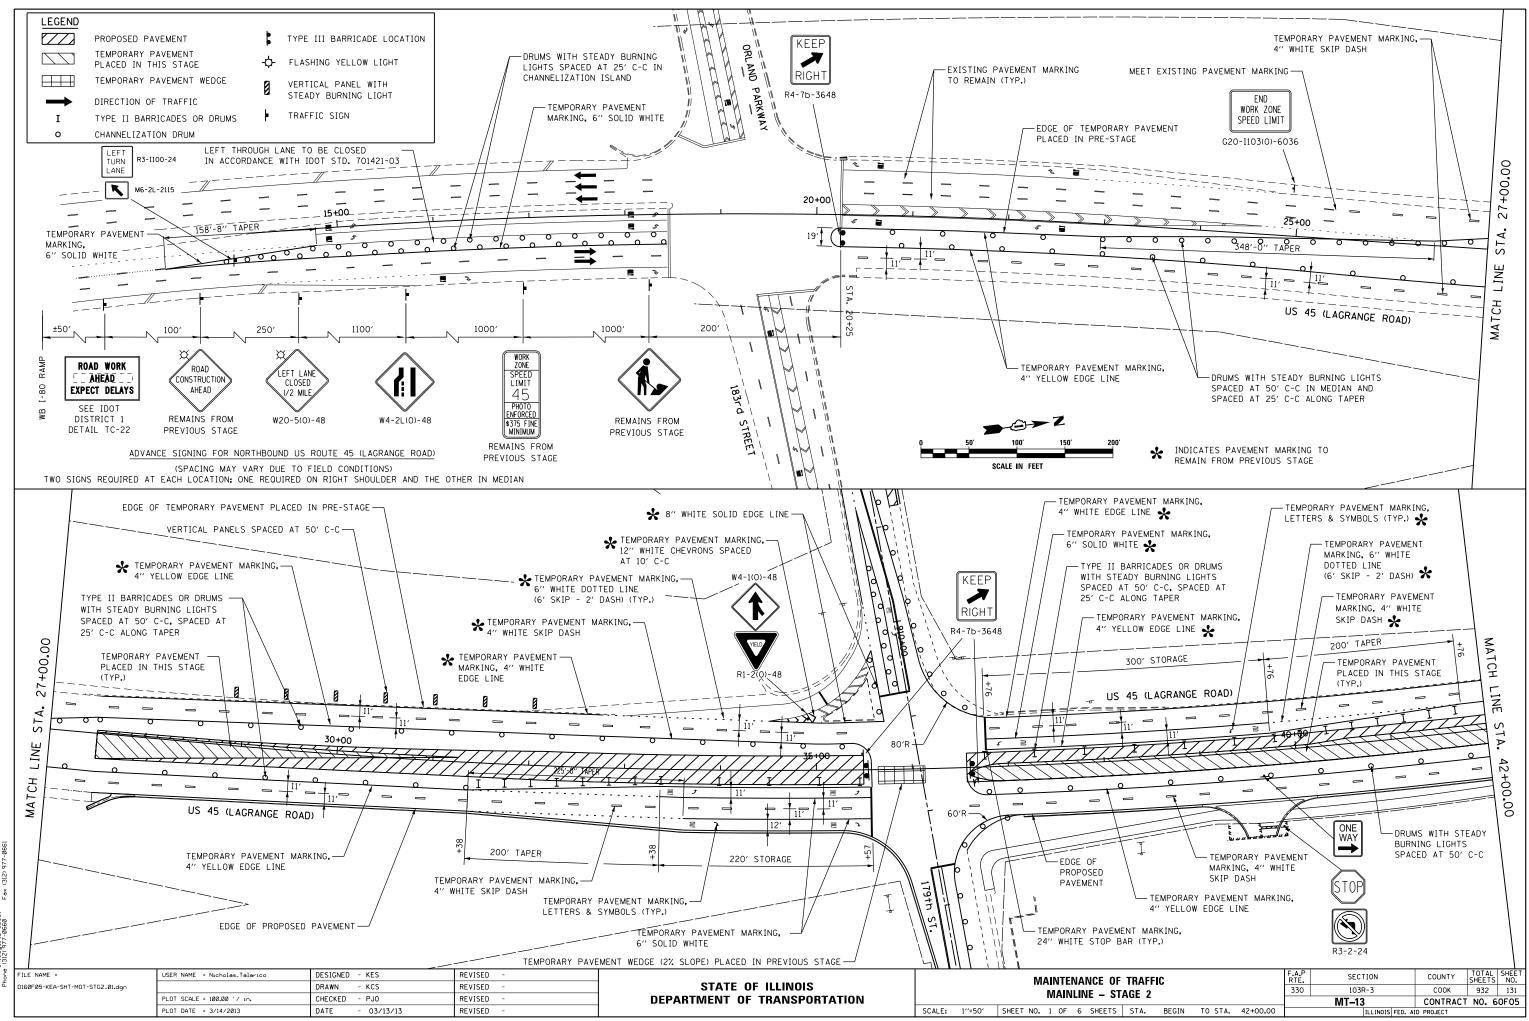


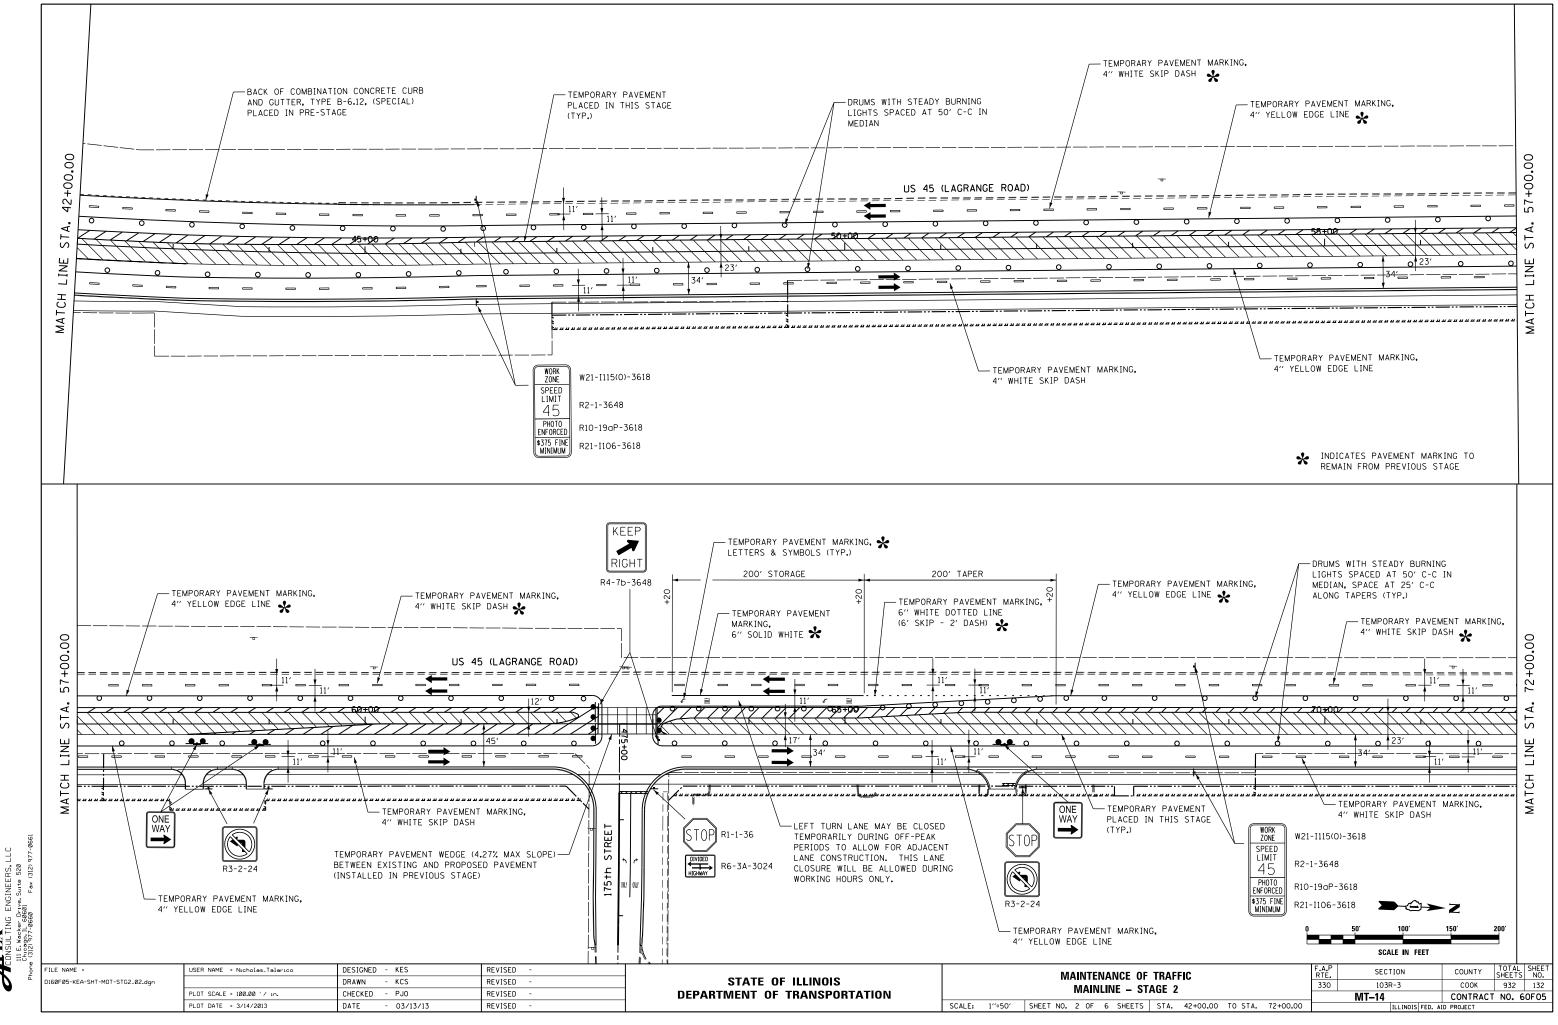
312) INEE Surte er Drive. 60601 0660 11 E. Wacker hicago, IL (312) 977-0 




III E. Wacke Chicago, IL (312) 977-6 

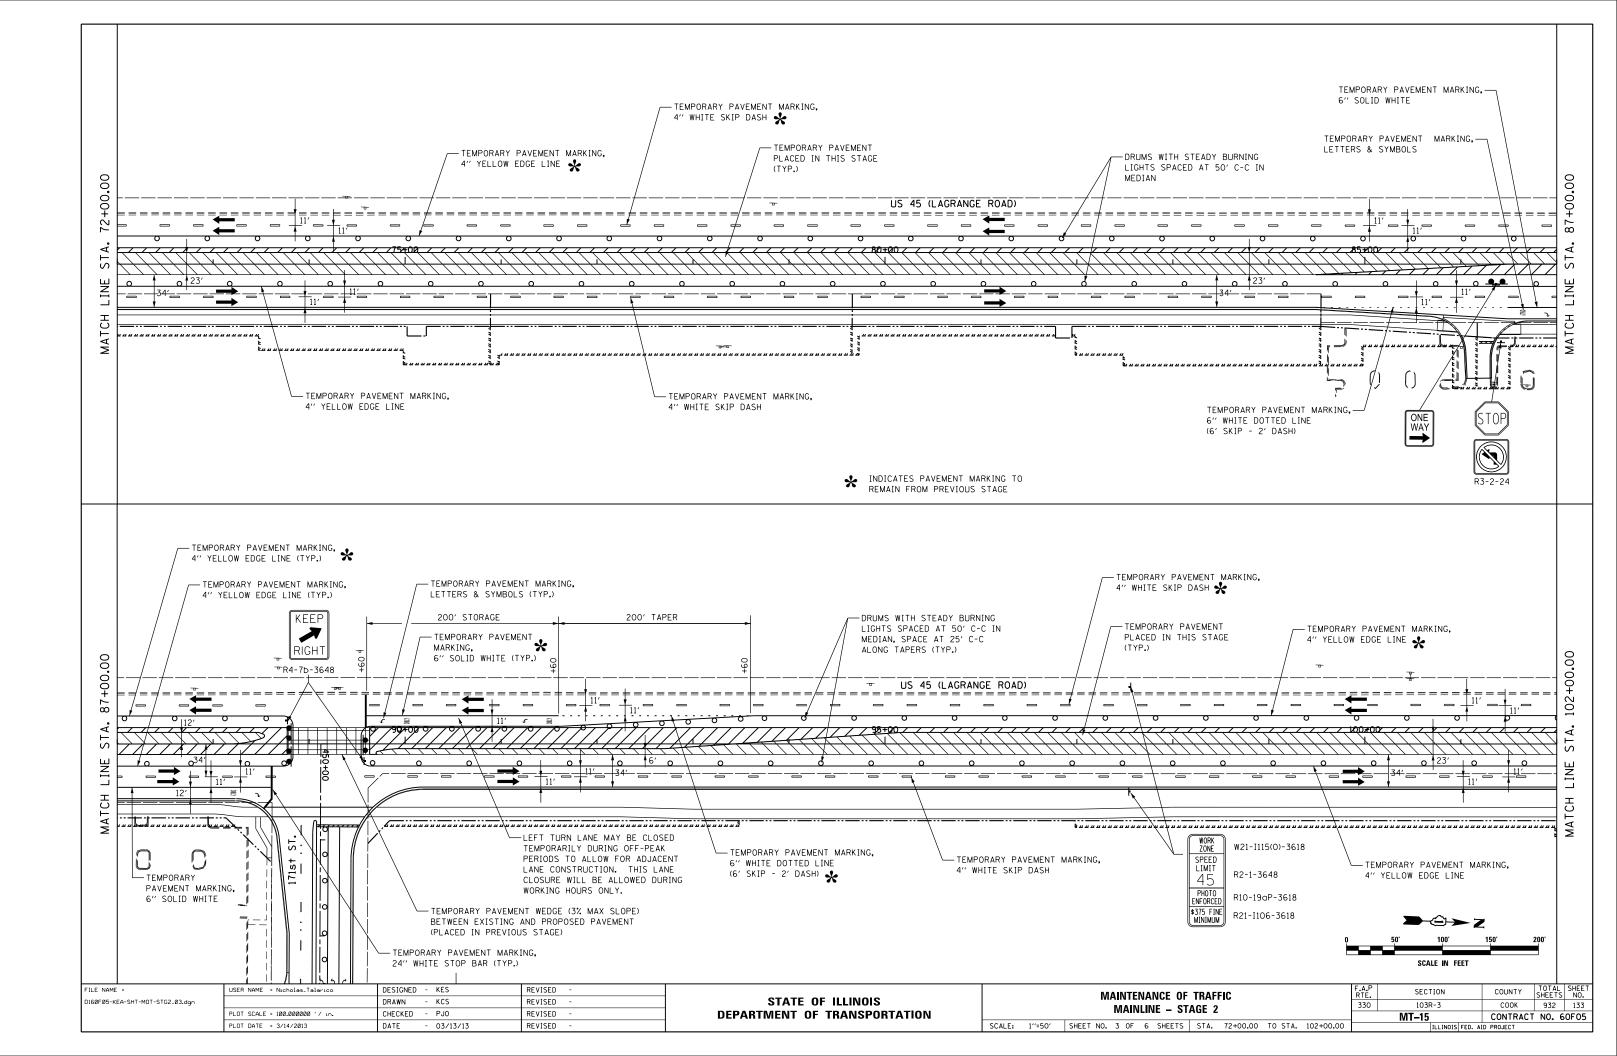


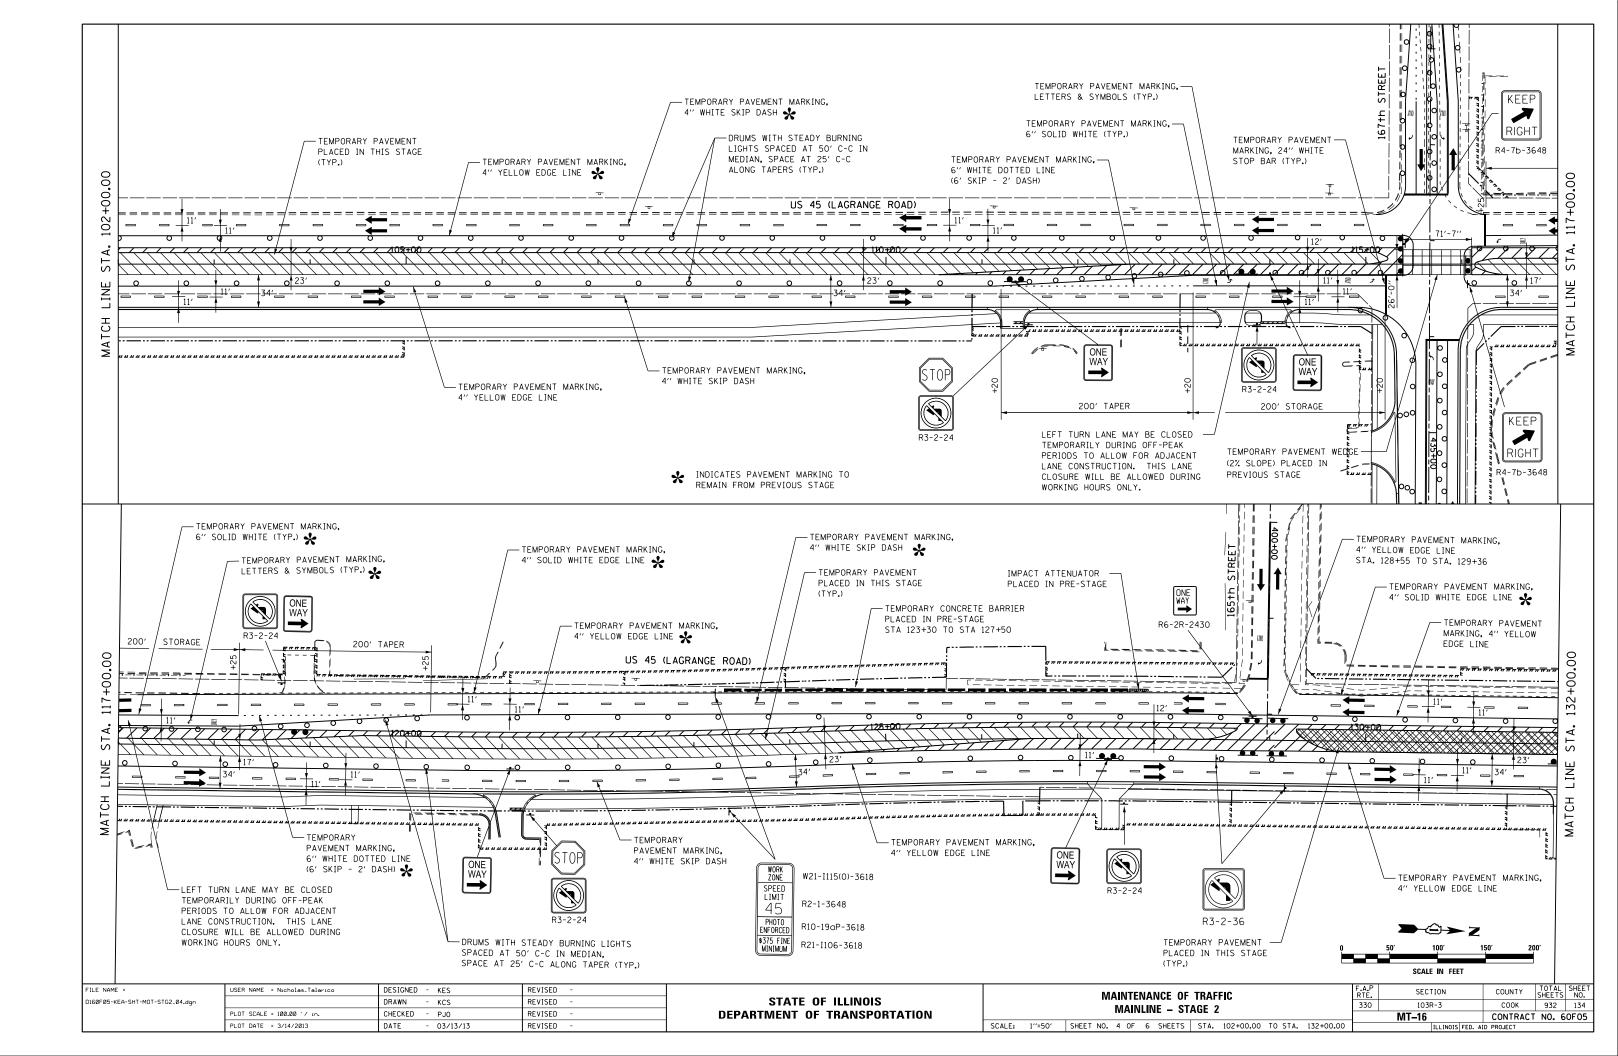


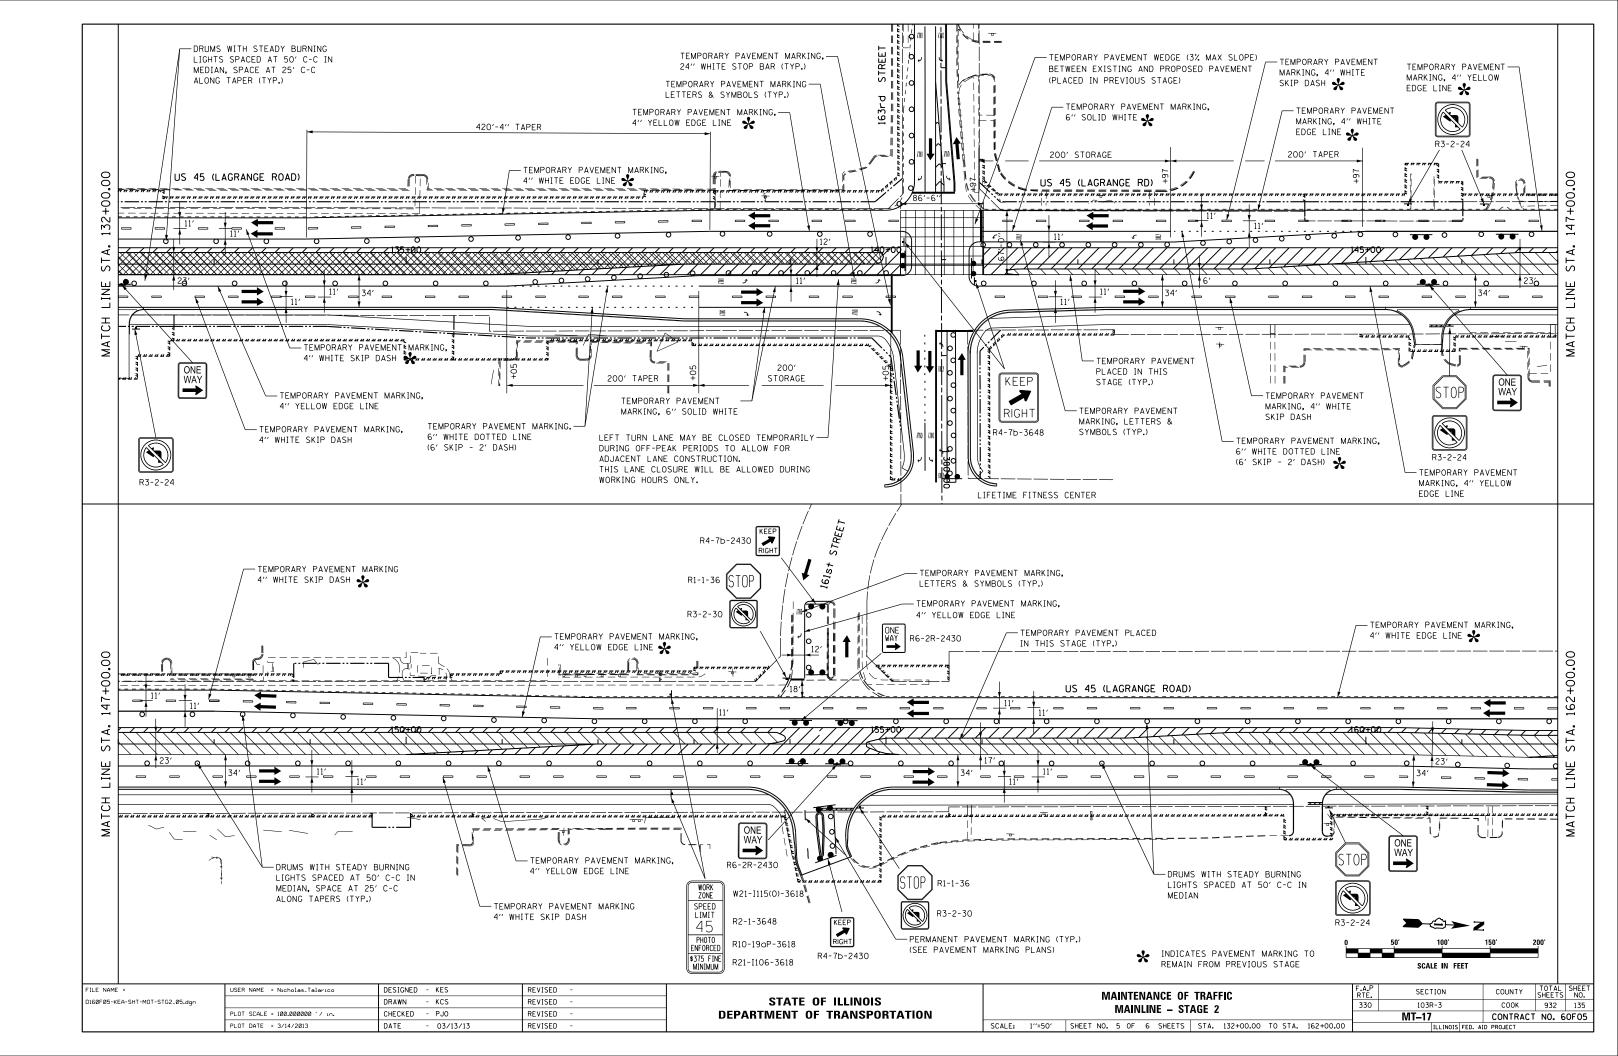


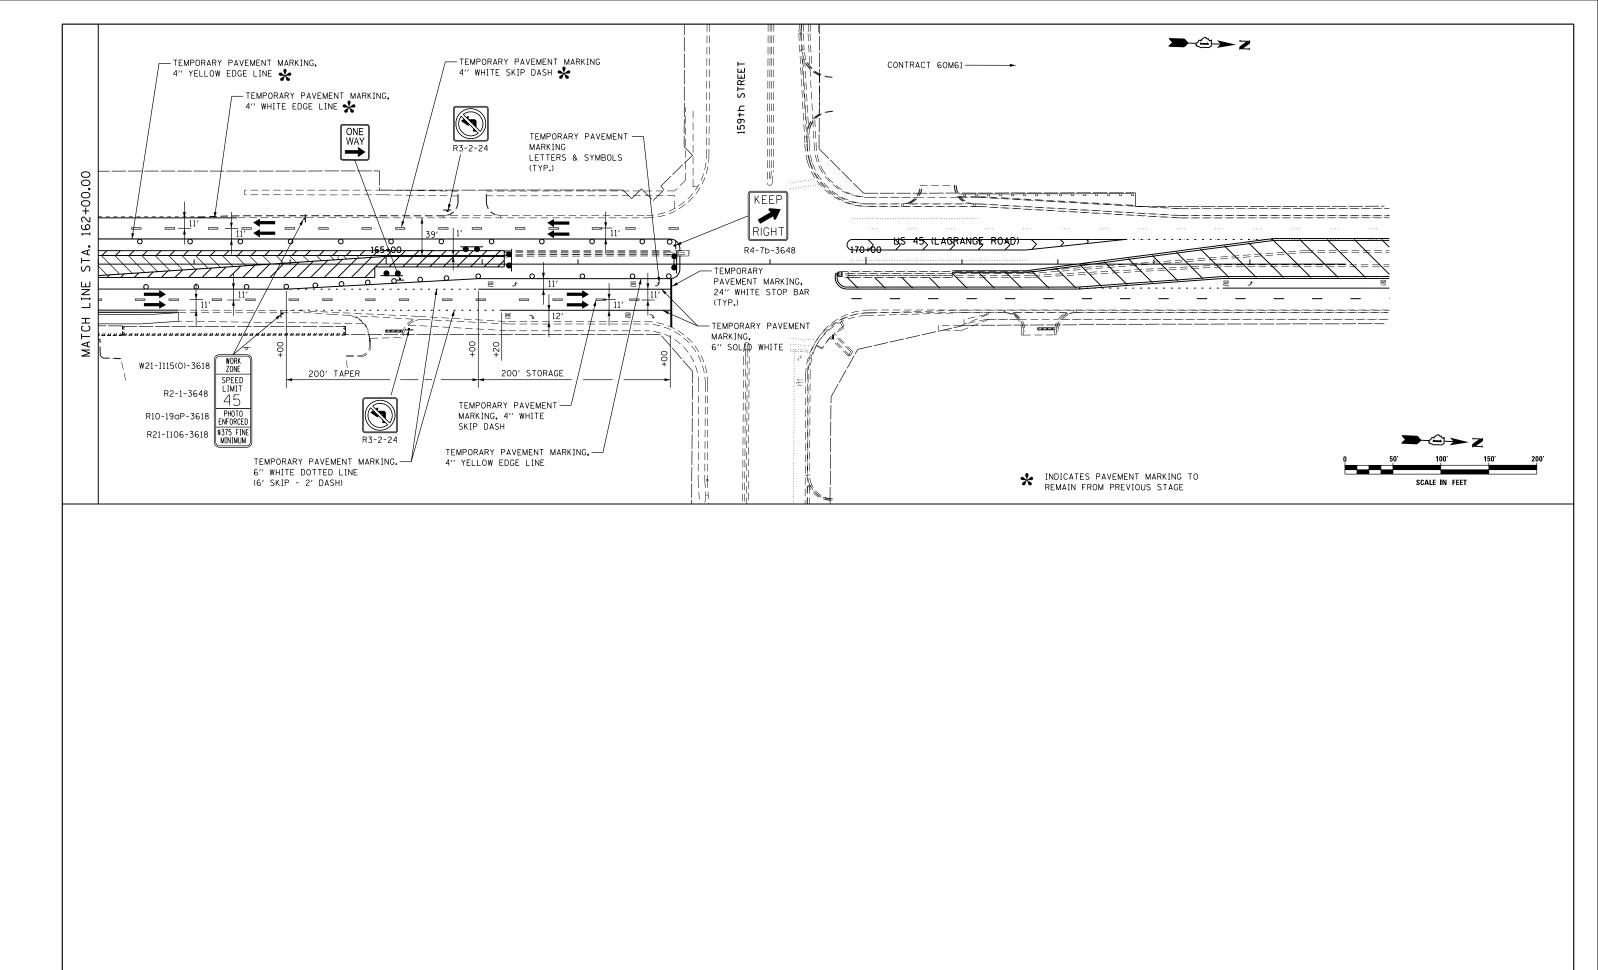



FILE NAME =	USER NAME = Nicholas_Talarico	DESIGNED - KES	REVISED -			MAINTENANCE OF TRAFFIC	F.A.P RTF.	SECTION	COUNTY TOTAL SHEET
D160F05-KEA-SHT-MOT-STG2_06.dgn		DRAWN - KCS	REVISED -	STATE OF ILLINOIS	MAINLINE – STAGE 2			103R-3	COOK 932 136
	PLOT SCALE = 100.000000 '/ in.	CHECKED - PJO	REVISED -	DEPARTMENT OF TRANSPORTATION		MAINLINE - STAGE 2		MT–18	CONTRACT NO. 60F05
	PLOT DATE = 3/14/2013	DATE - 03/13/13	REVISED -		SCALE: 1''=50'	SHEET NO. 6 OF 6 SHEETS STA. 162+00.00 TO STA. END			D PROJECT

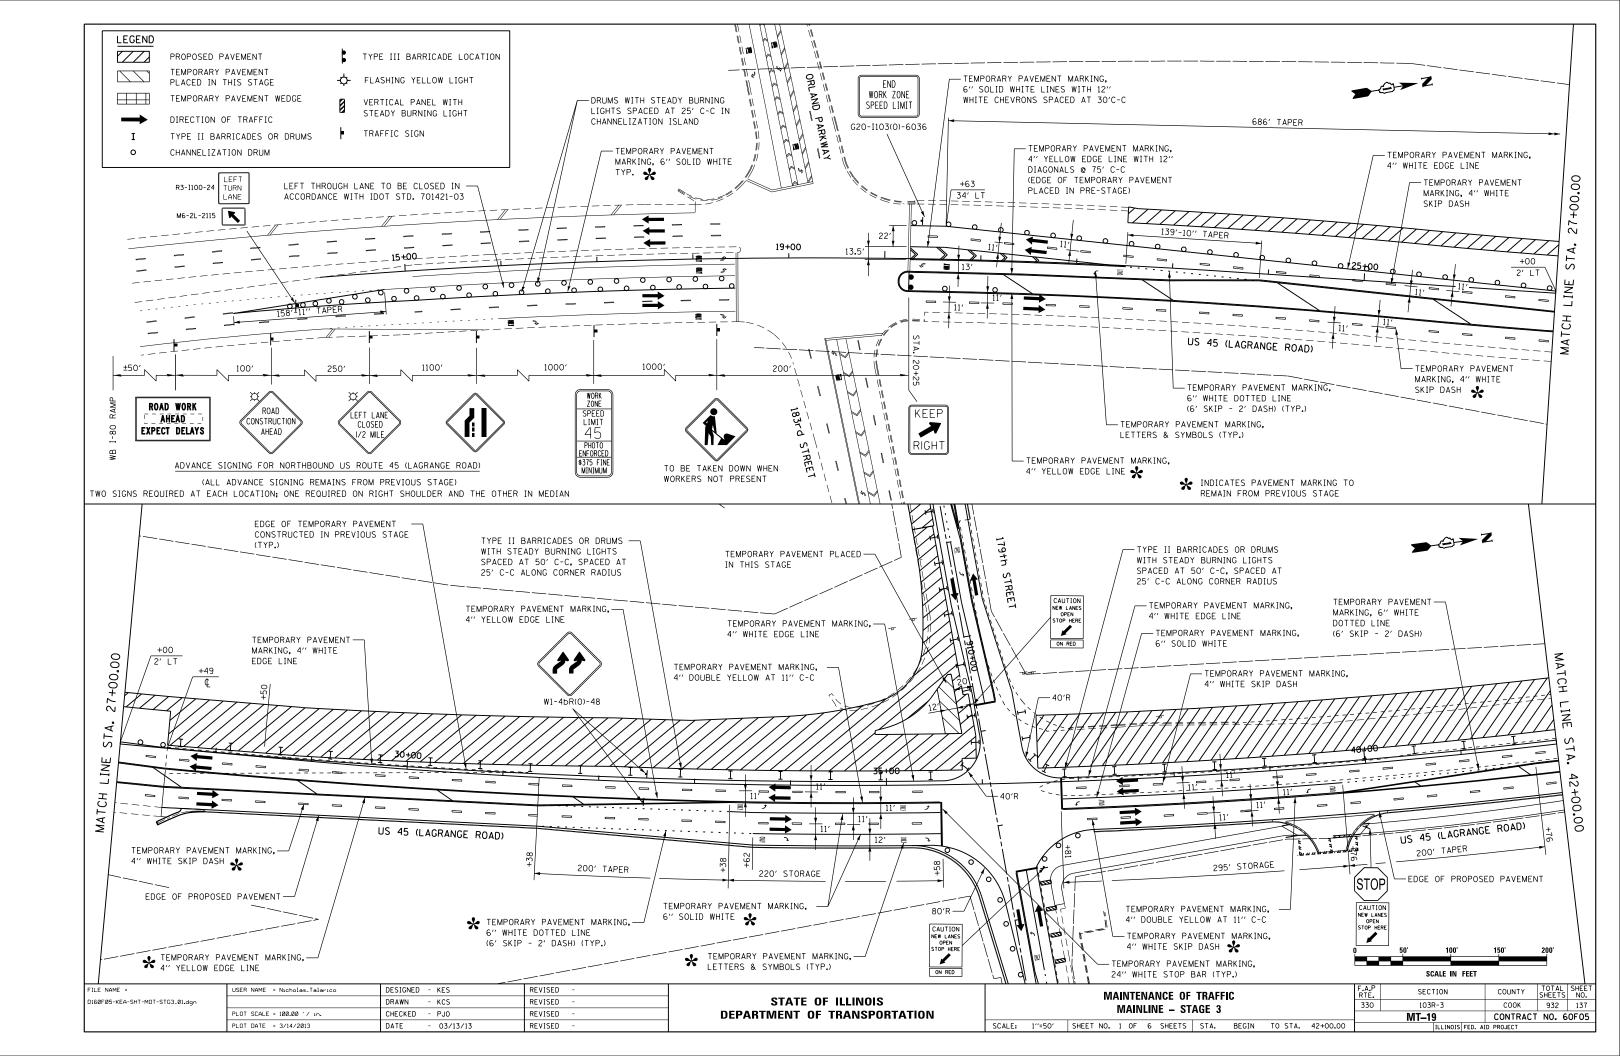


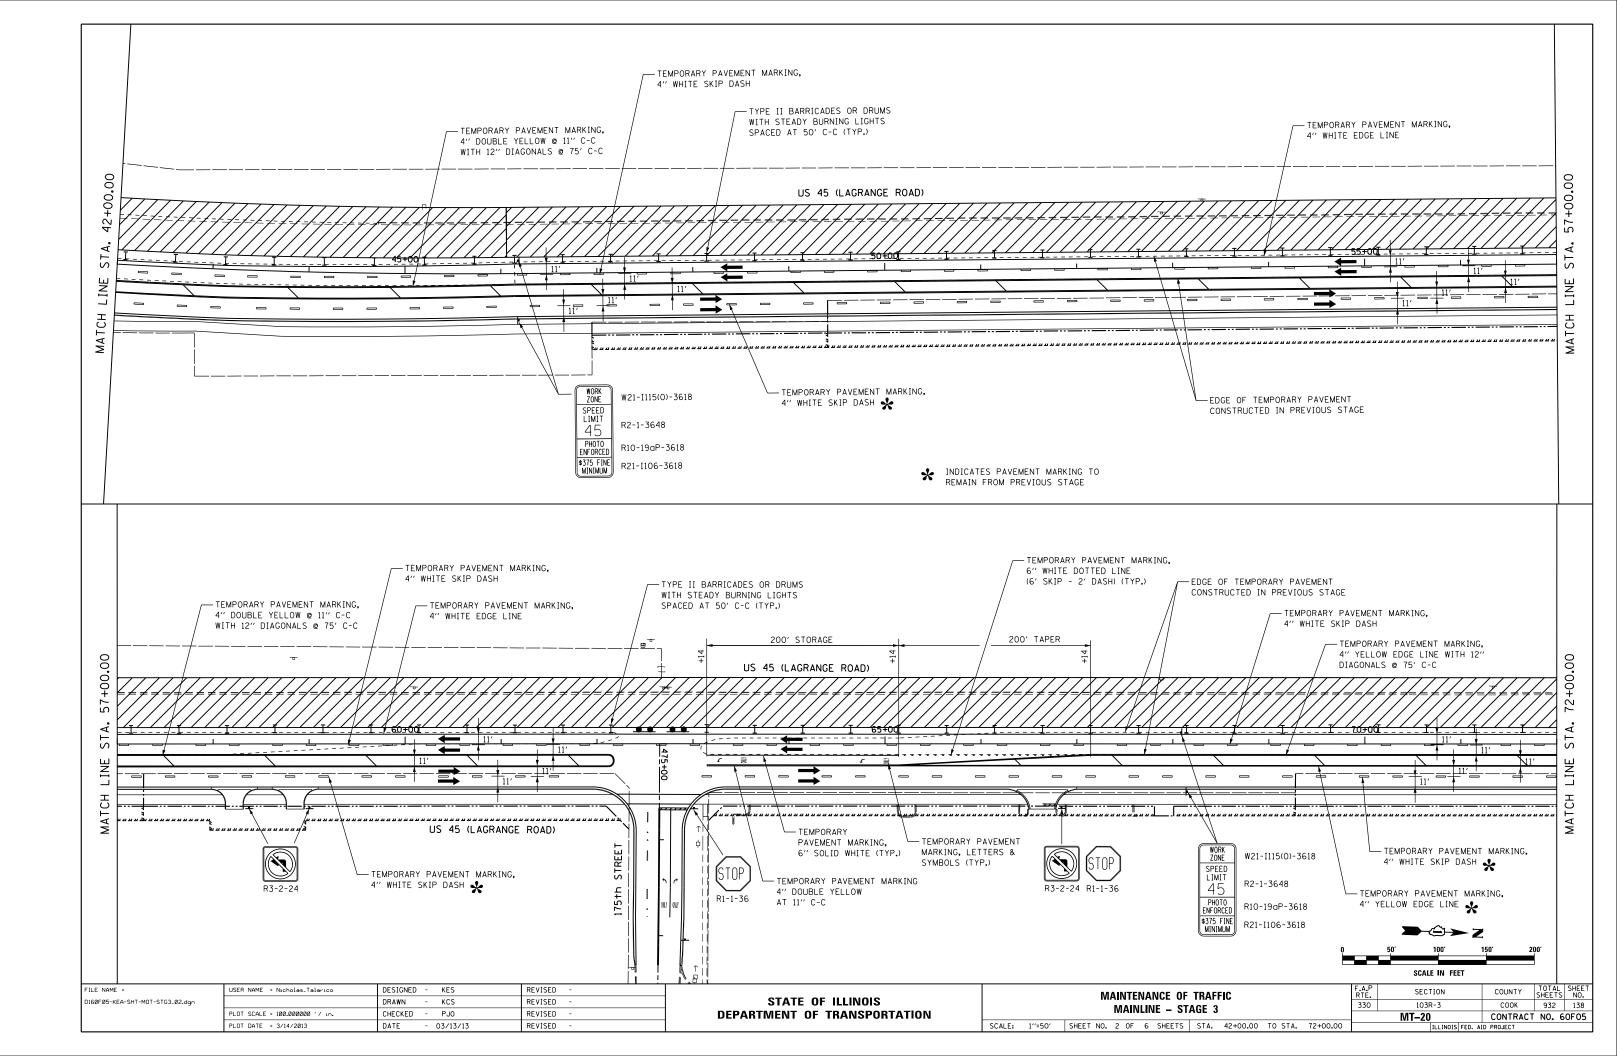

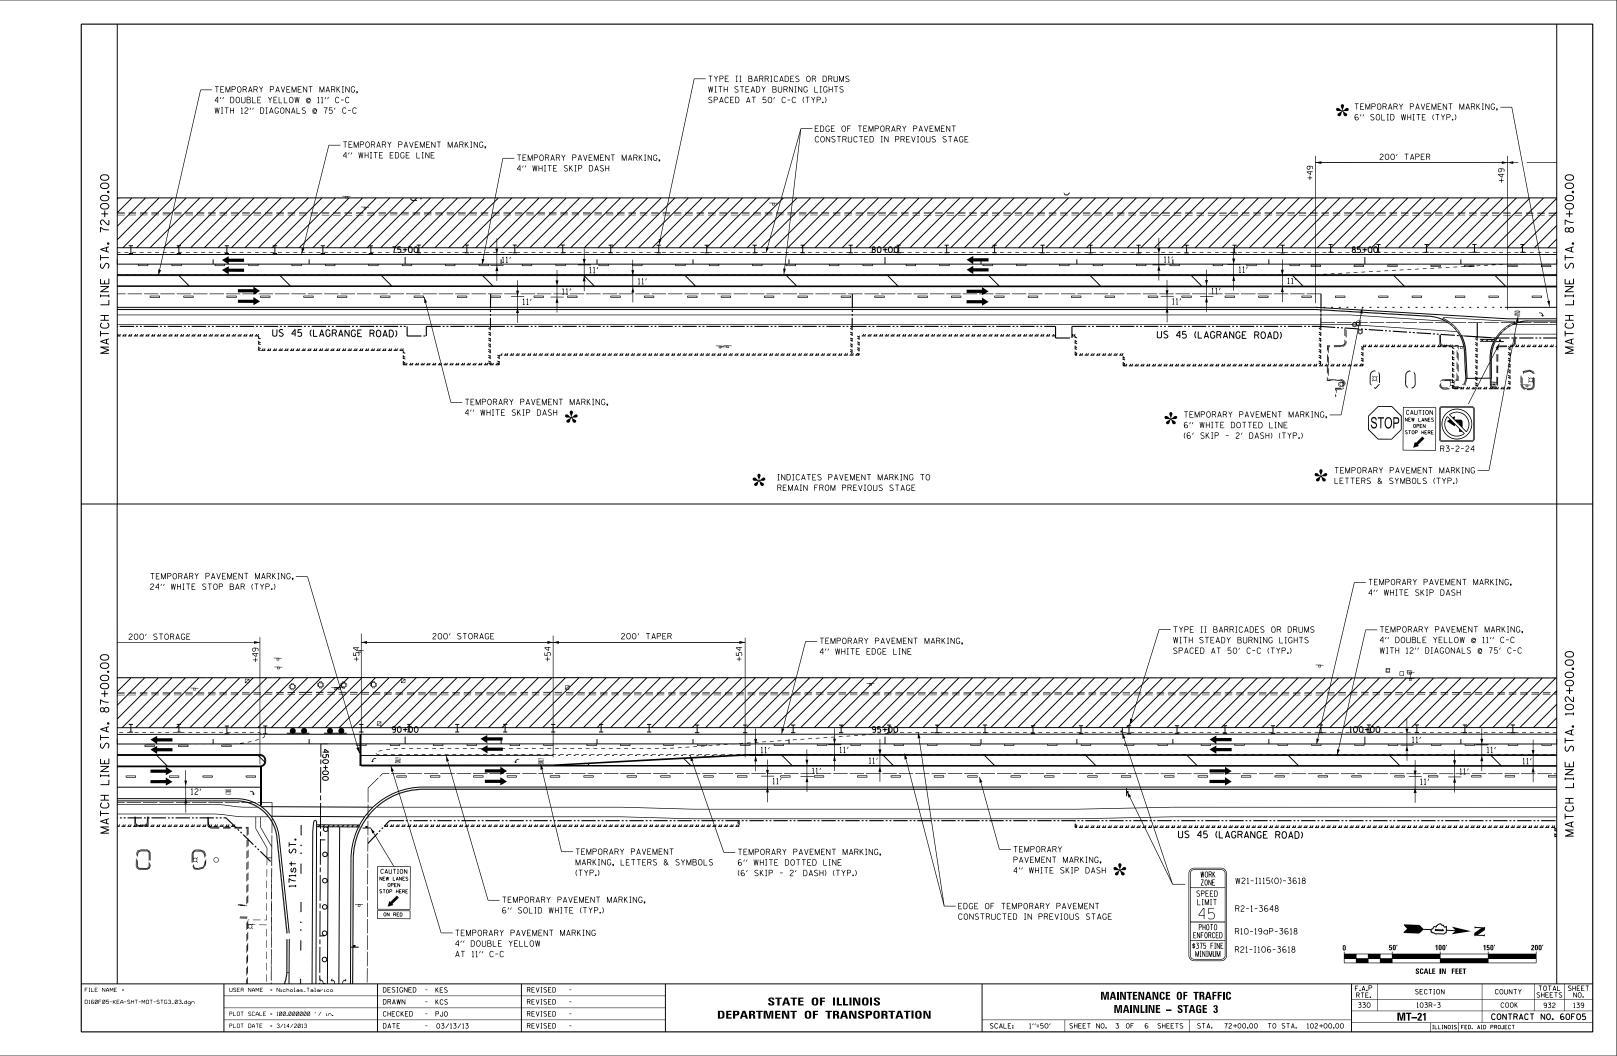

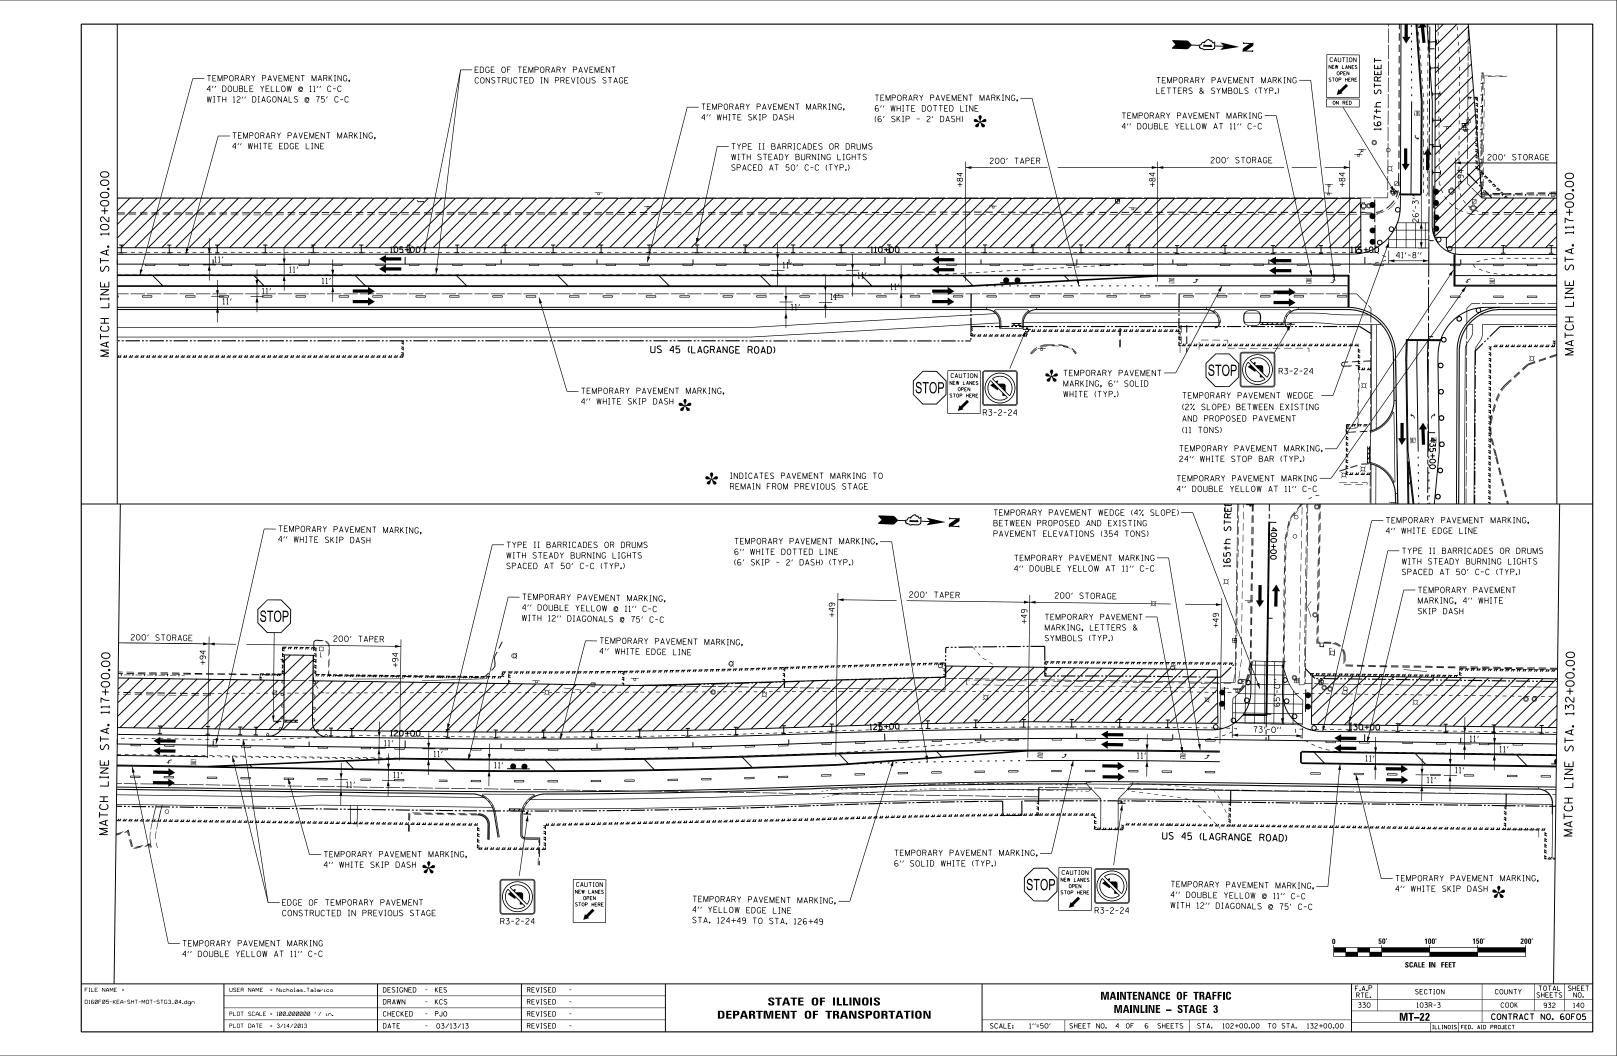

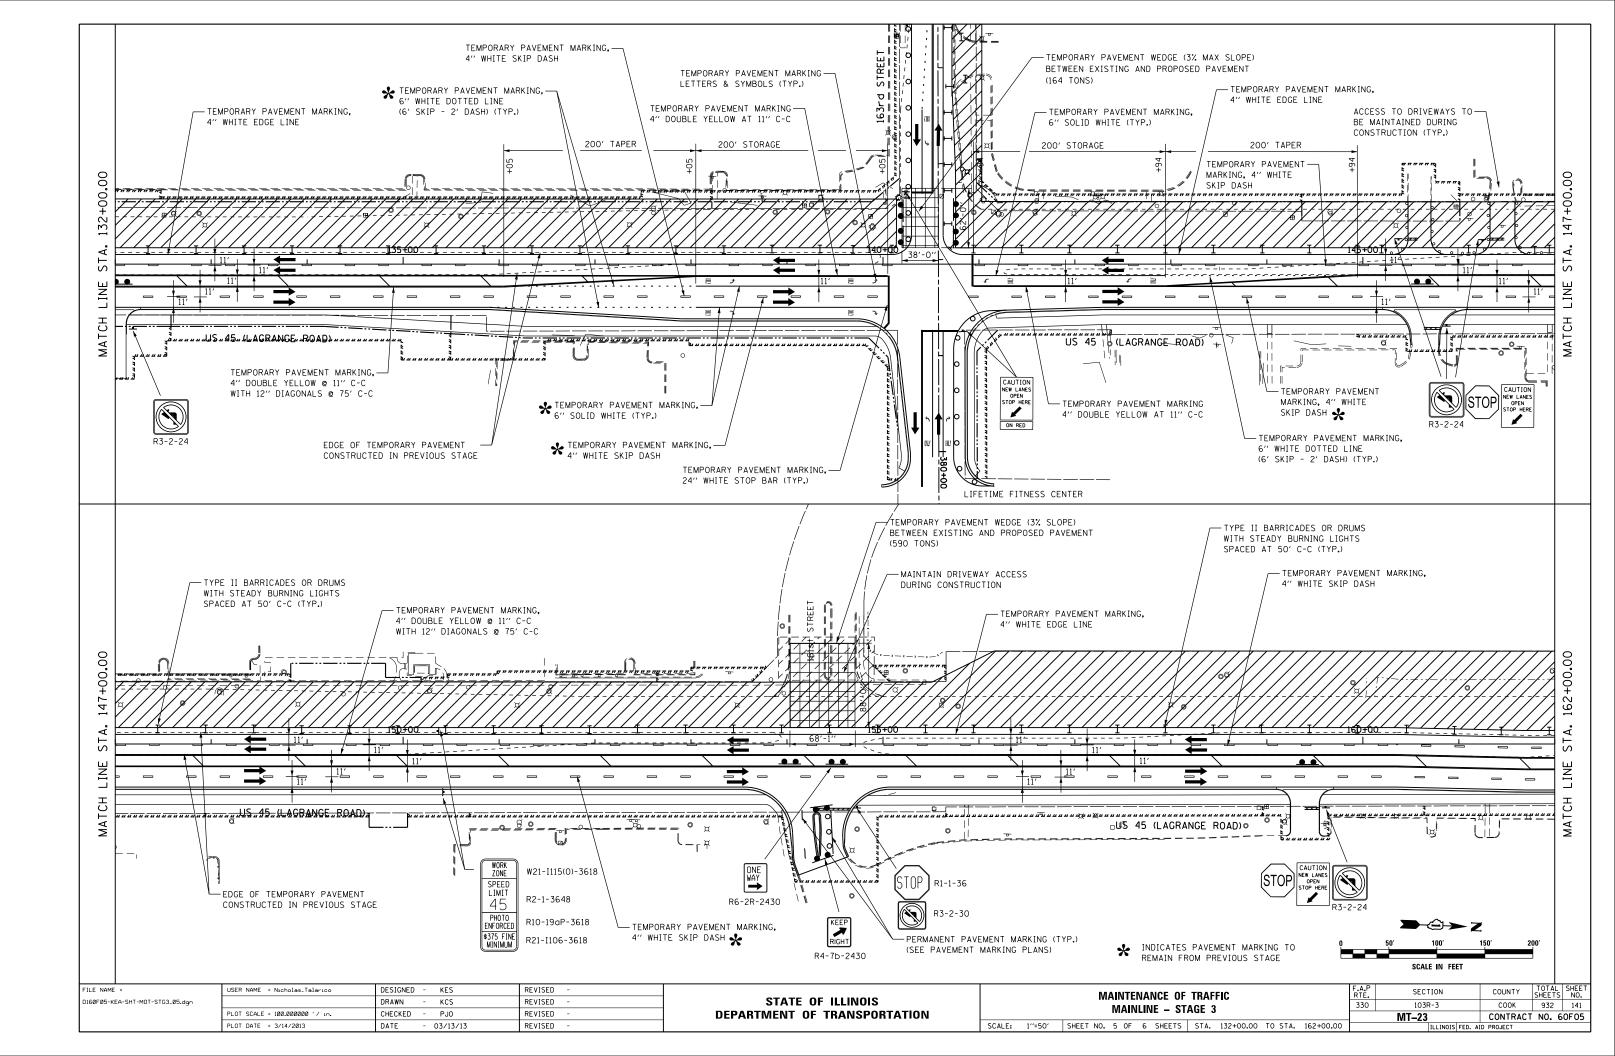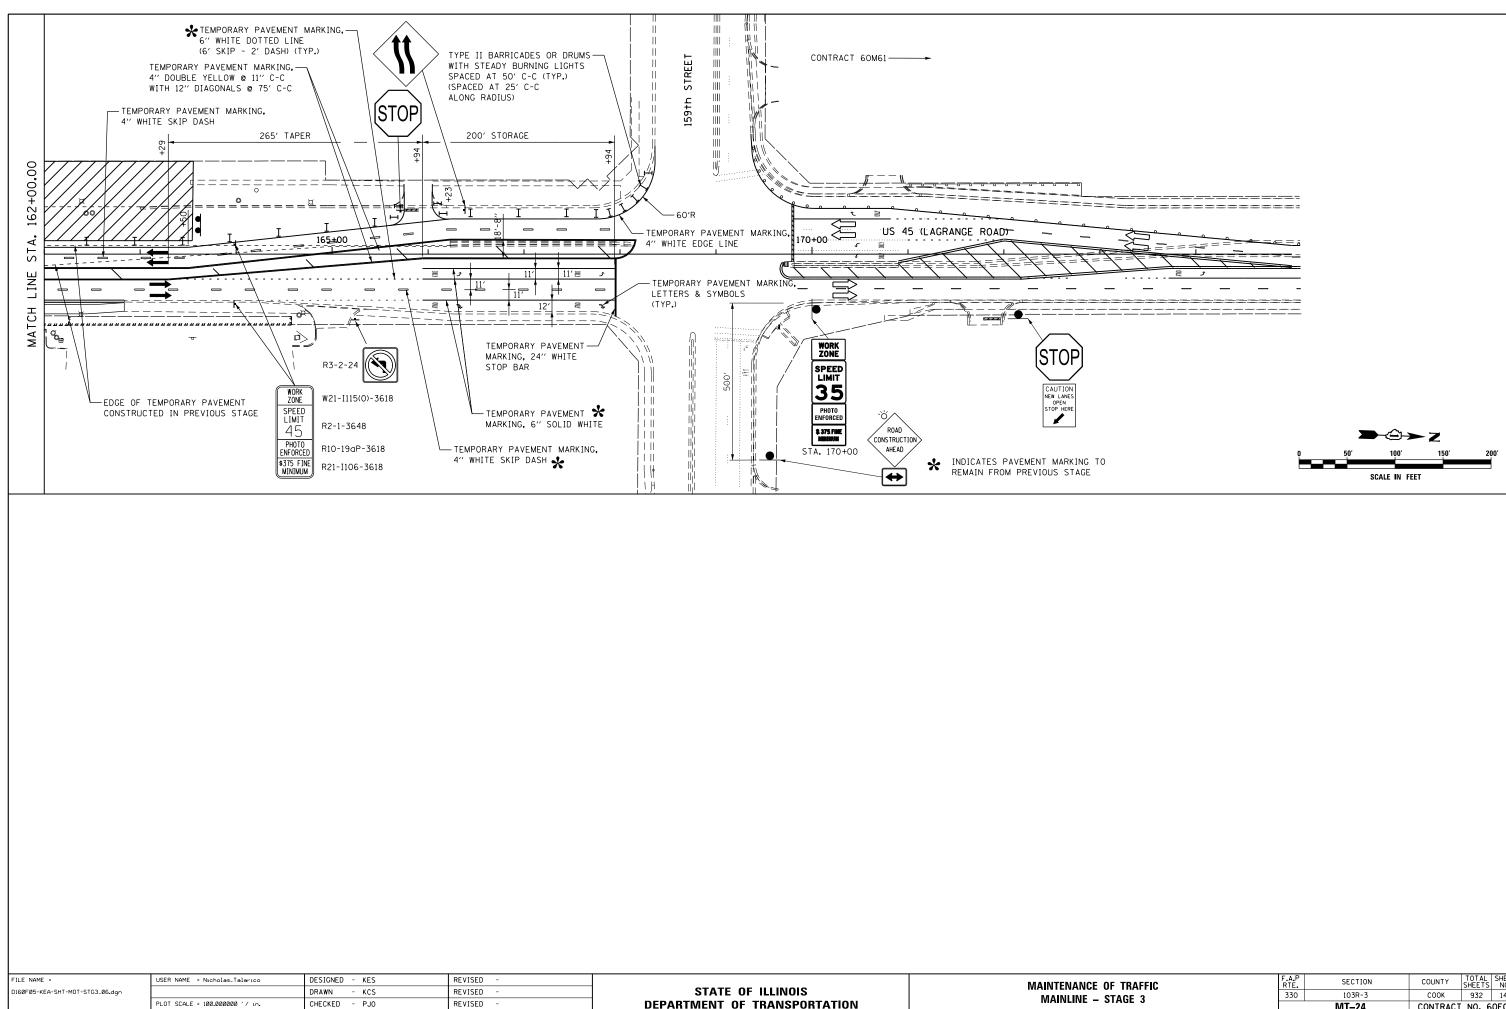



DEPARIMENT OF TRANSPORTATION						
	SCALE:	1''=50'	SHEET NO.	6 OF	6	SHEETS

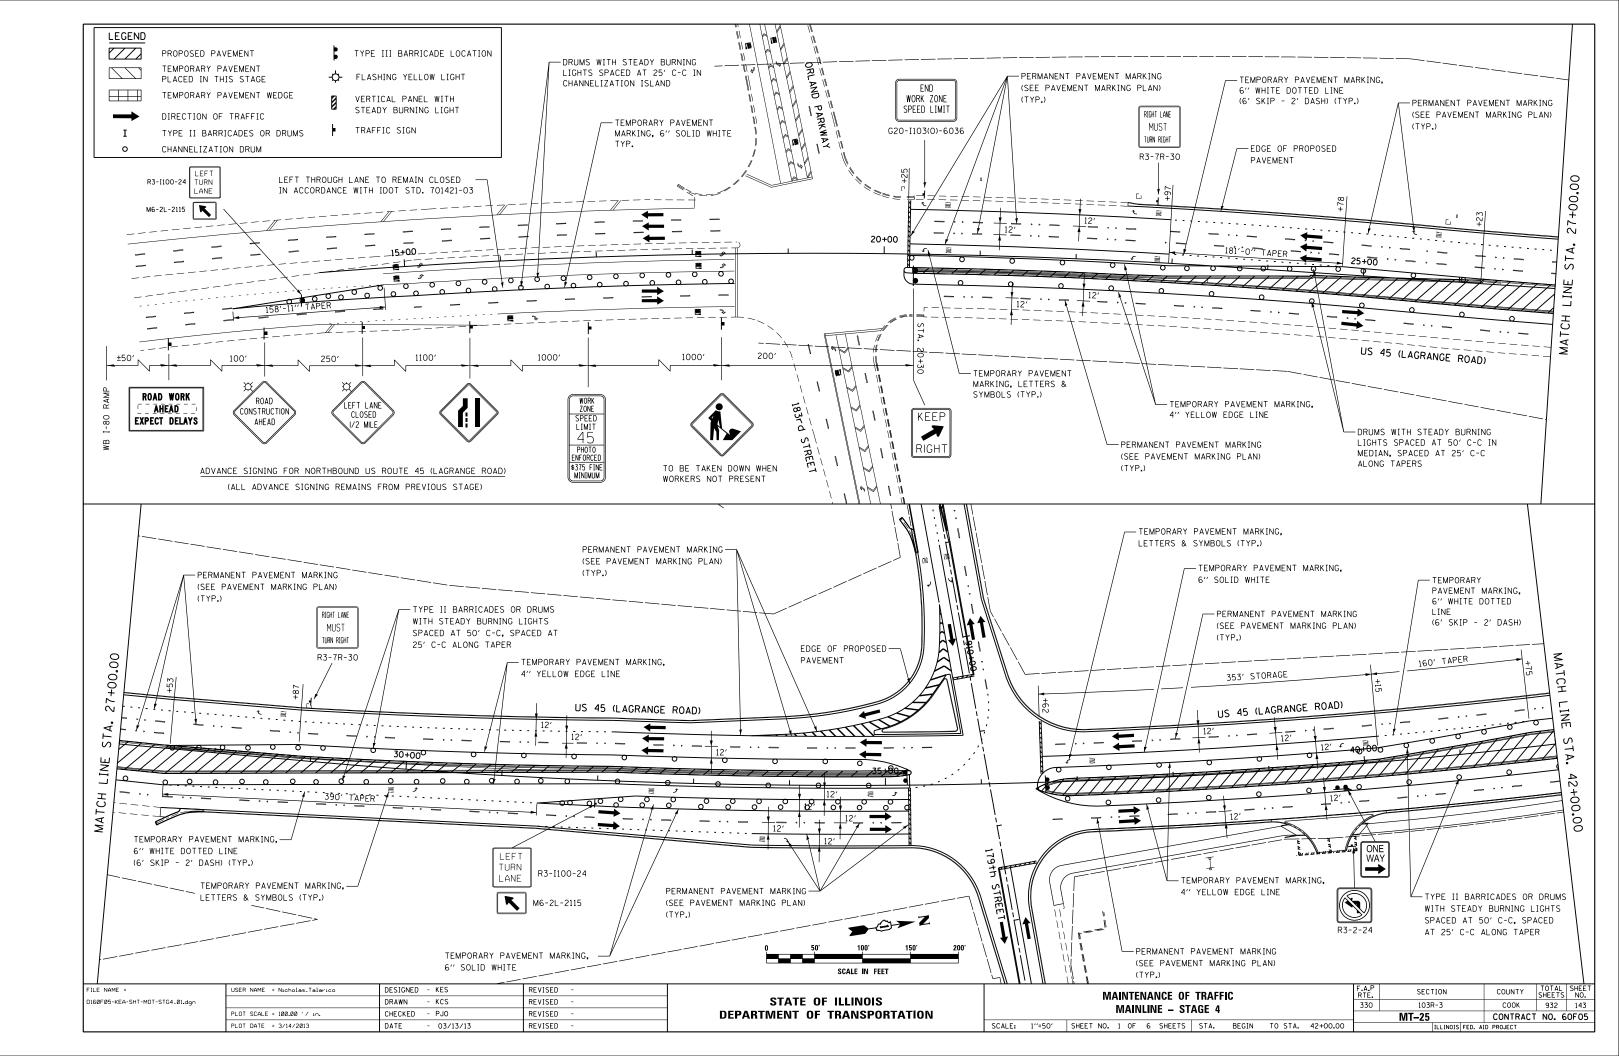
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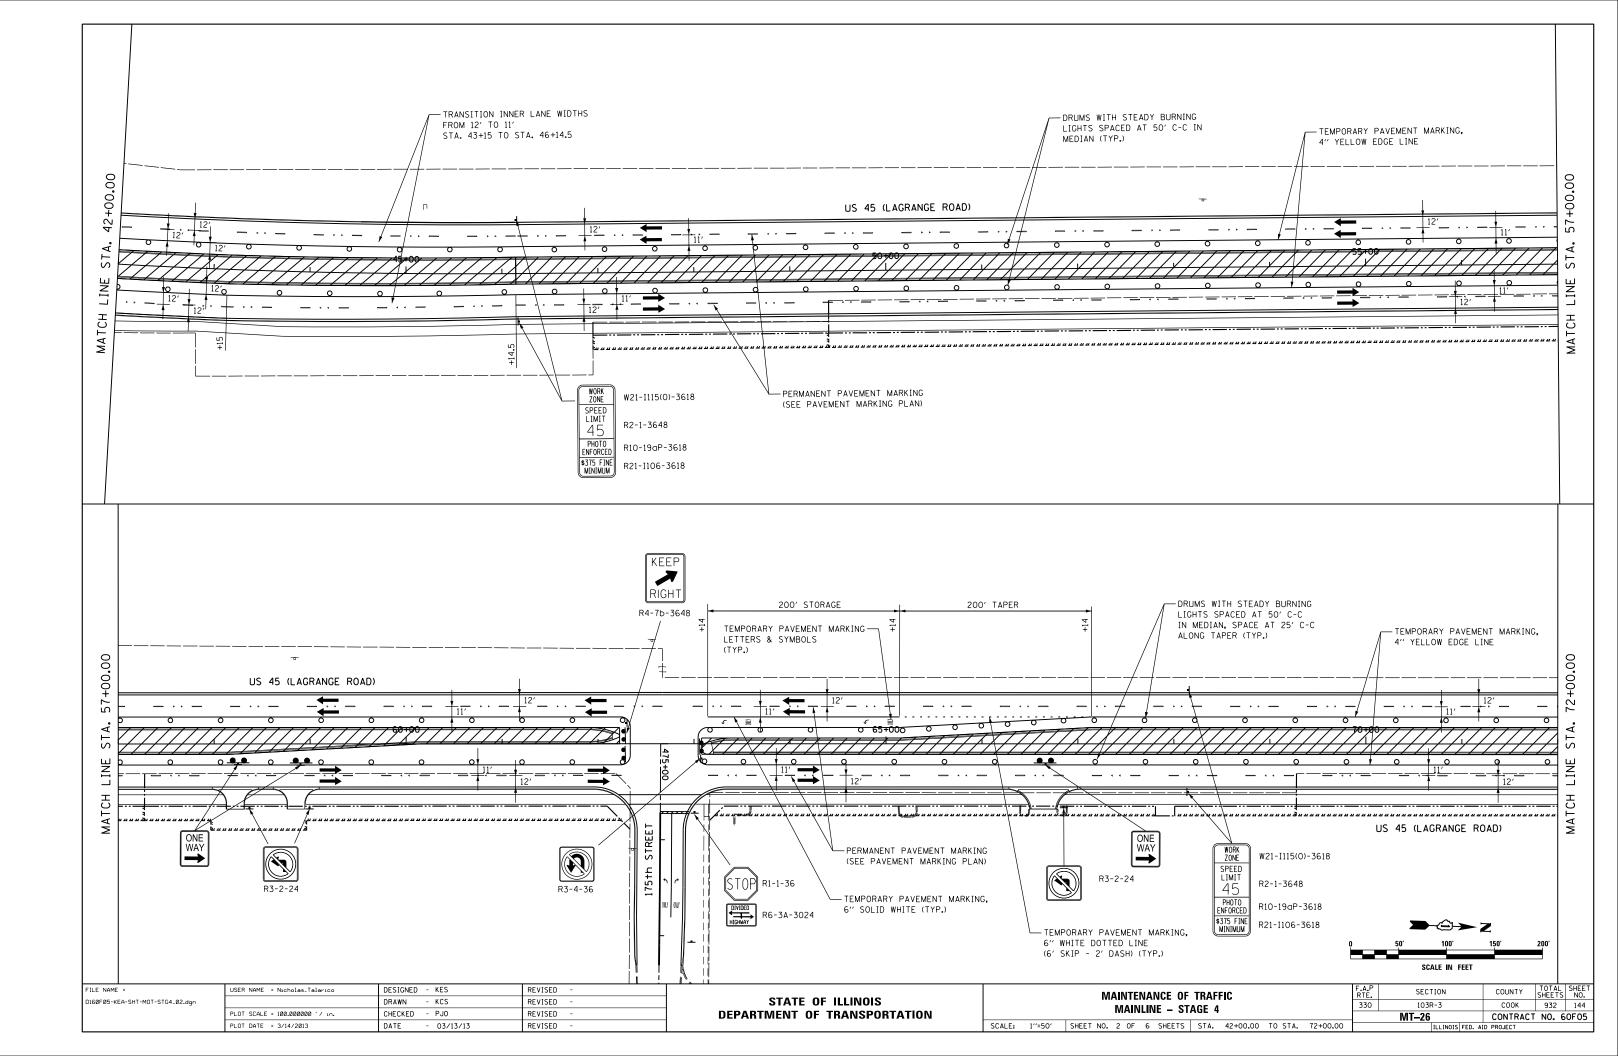
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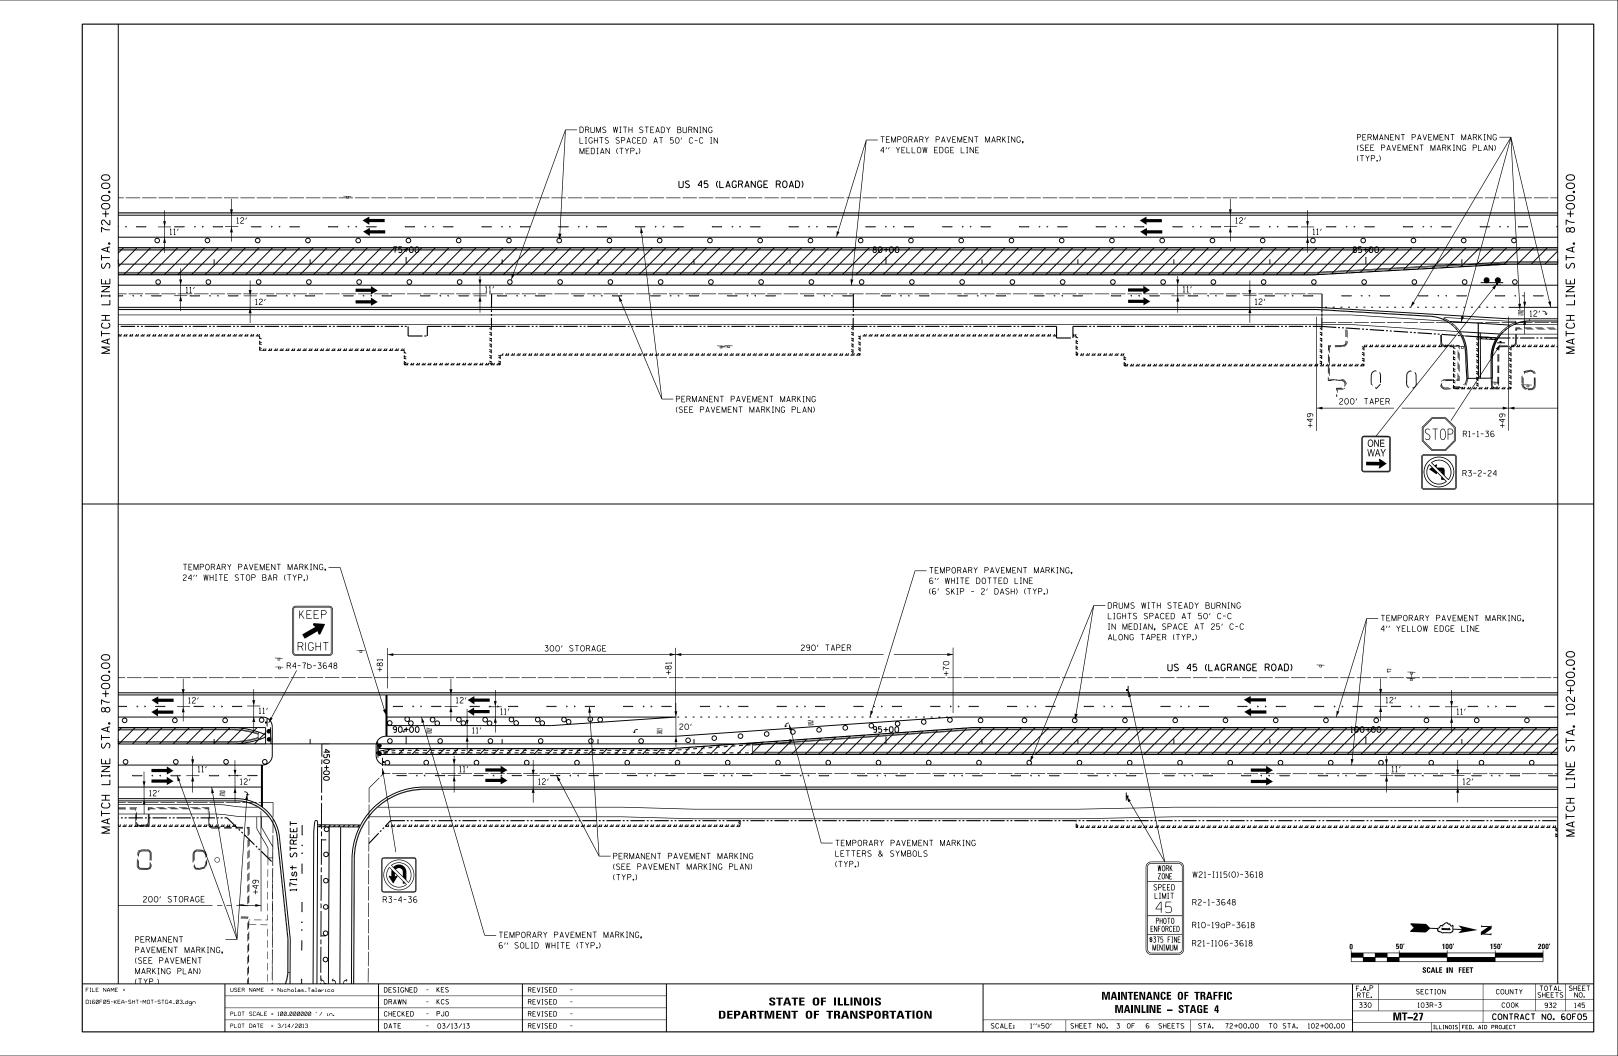
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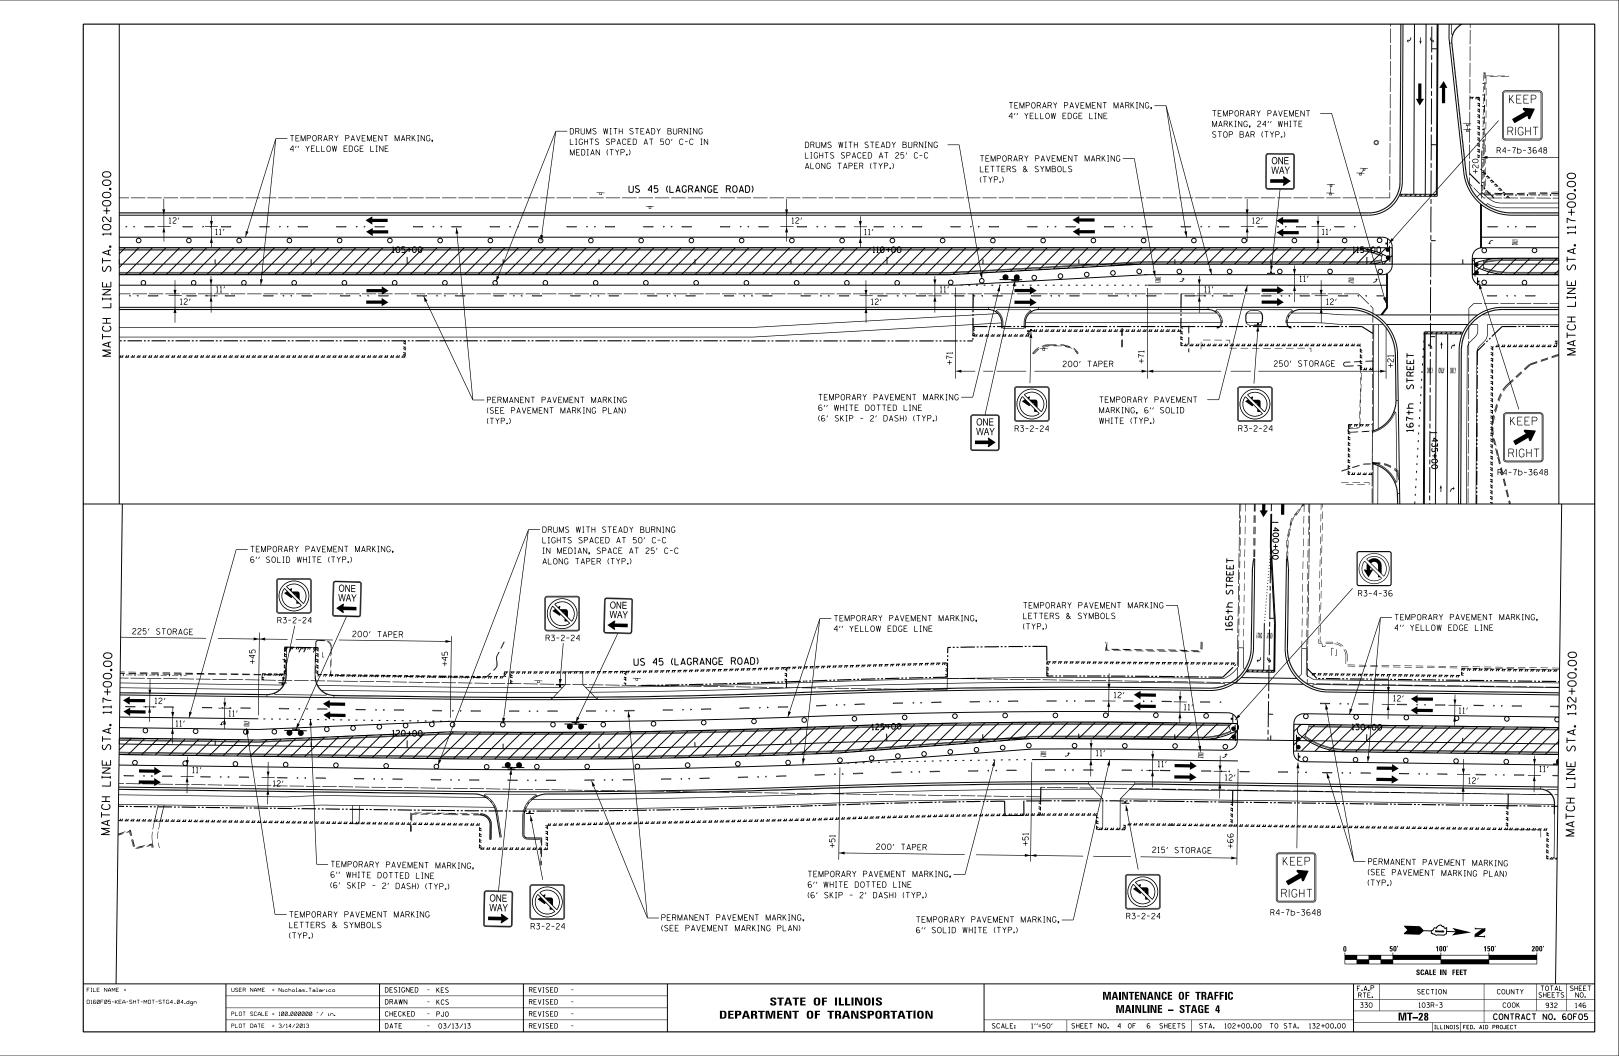
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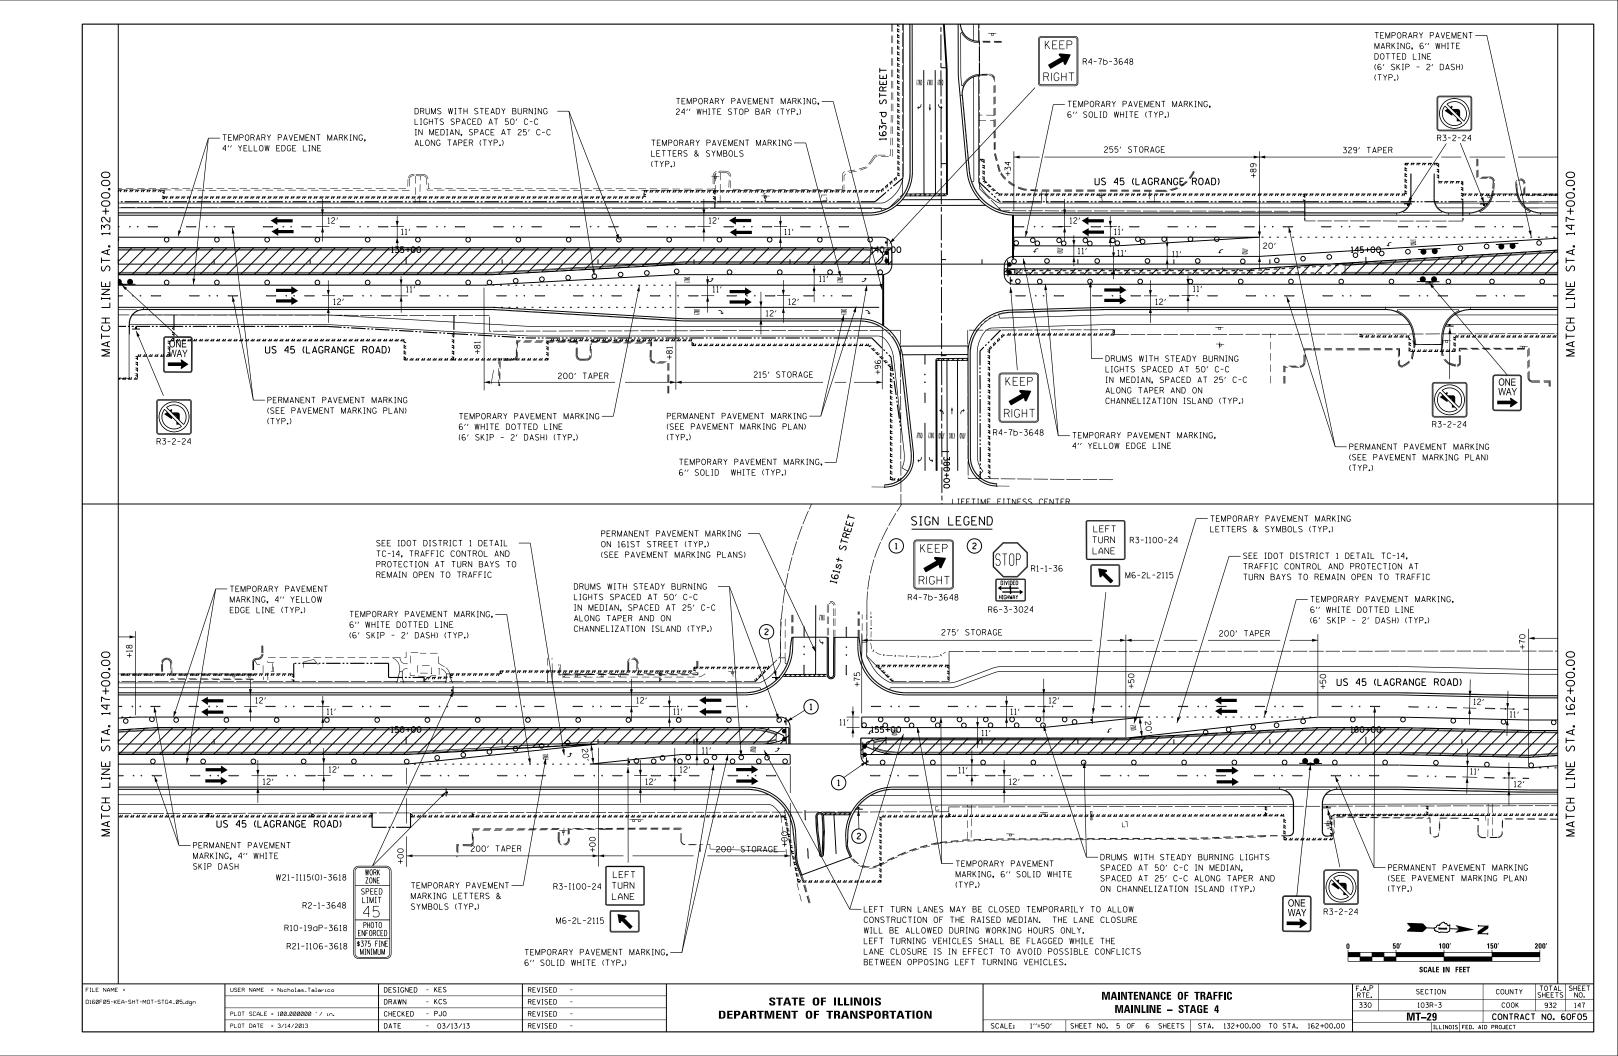
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5	STA. 162+00.00	TO STA.	END		ILLINOIS FED. A	ID PROJECT		

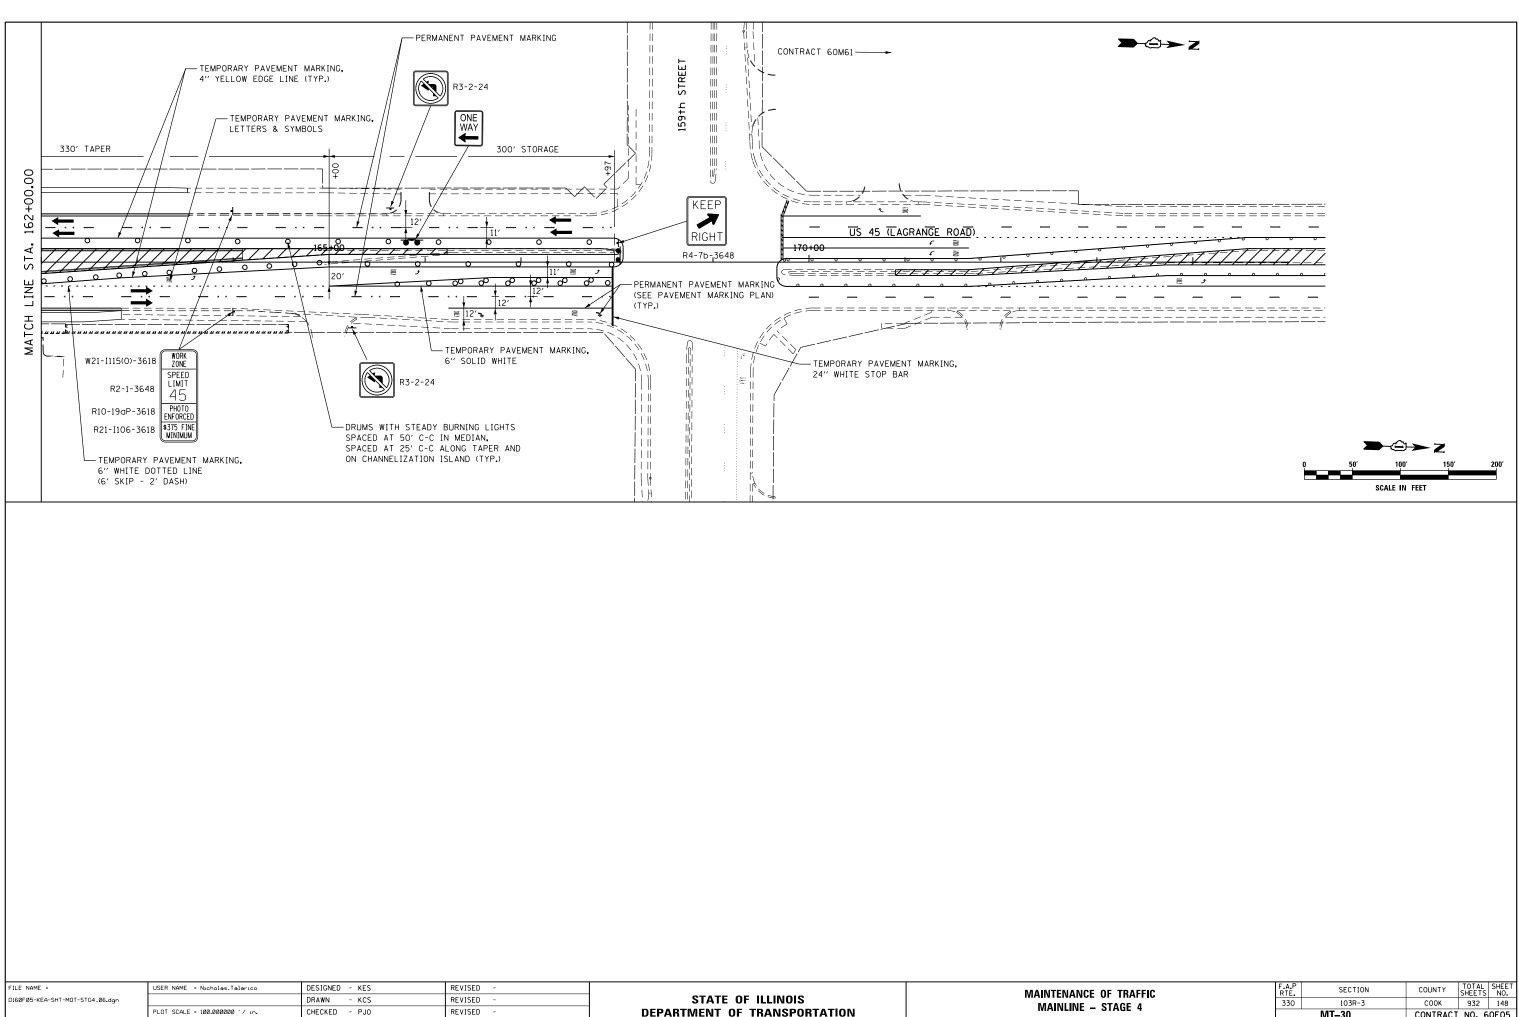












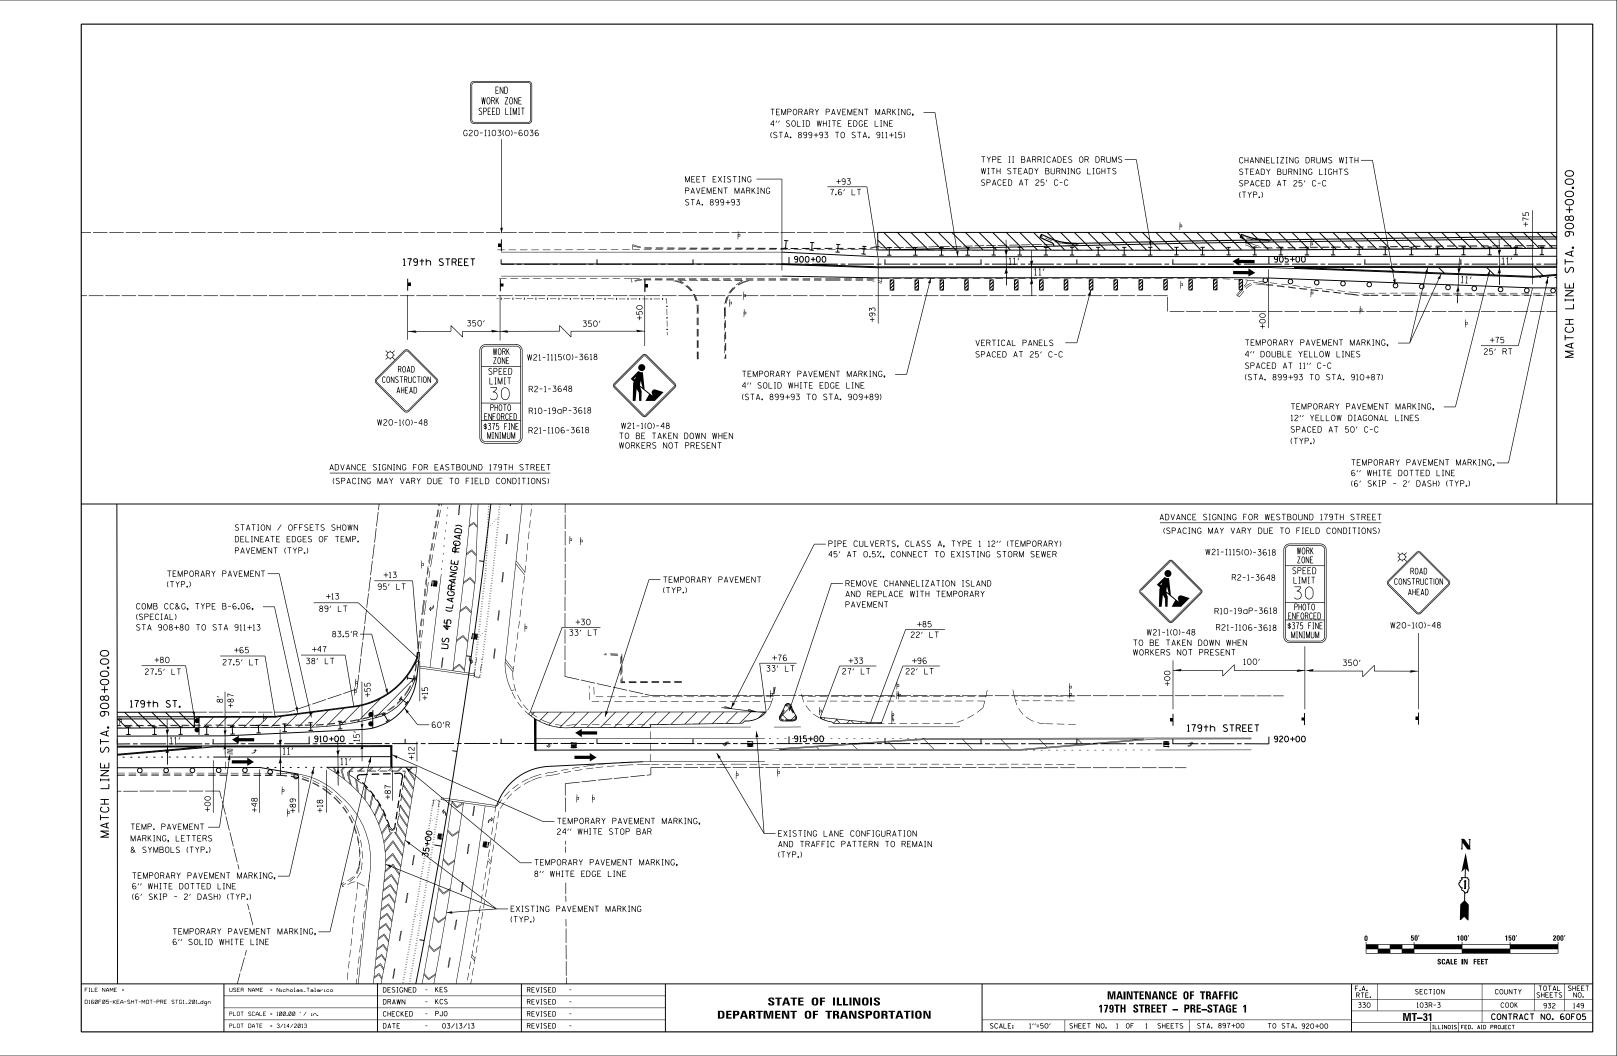
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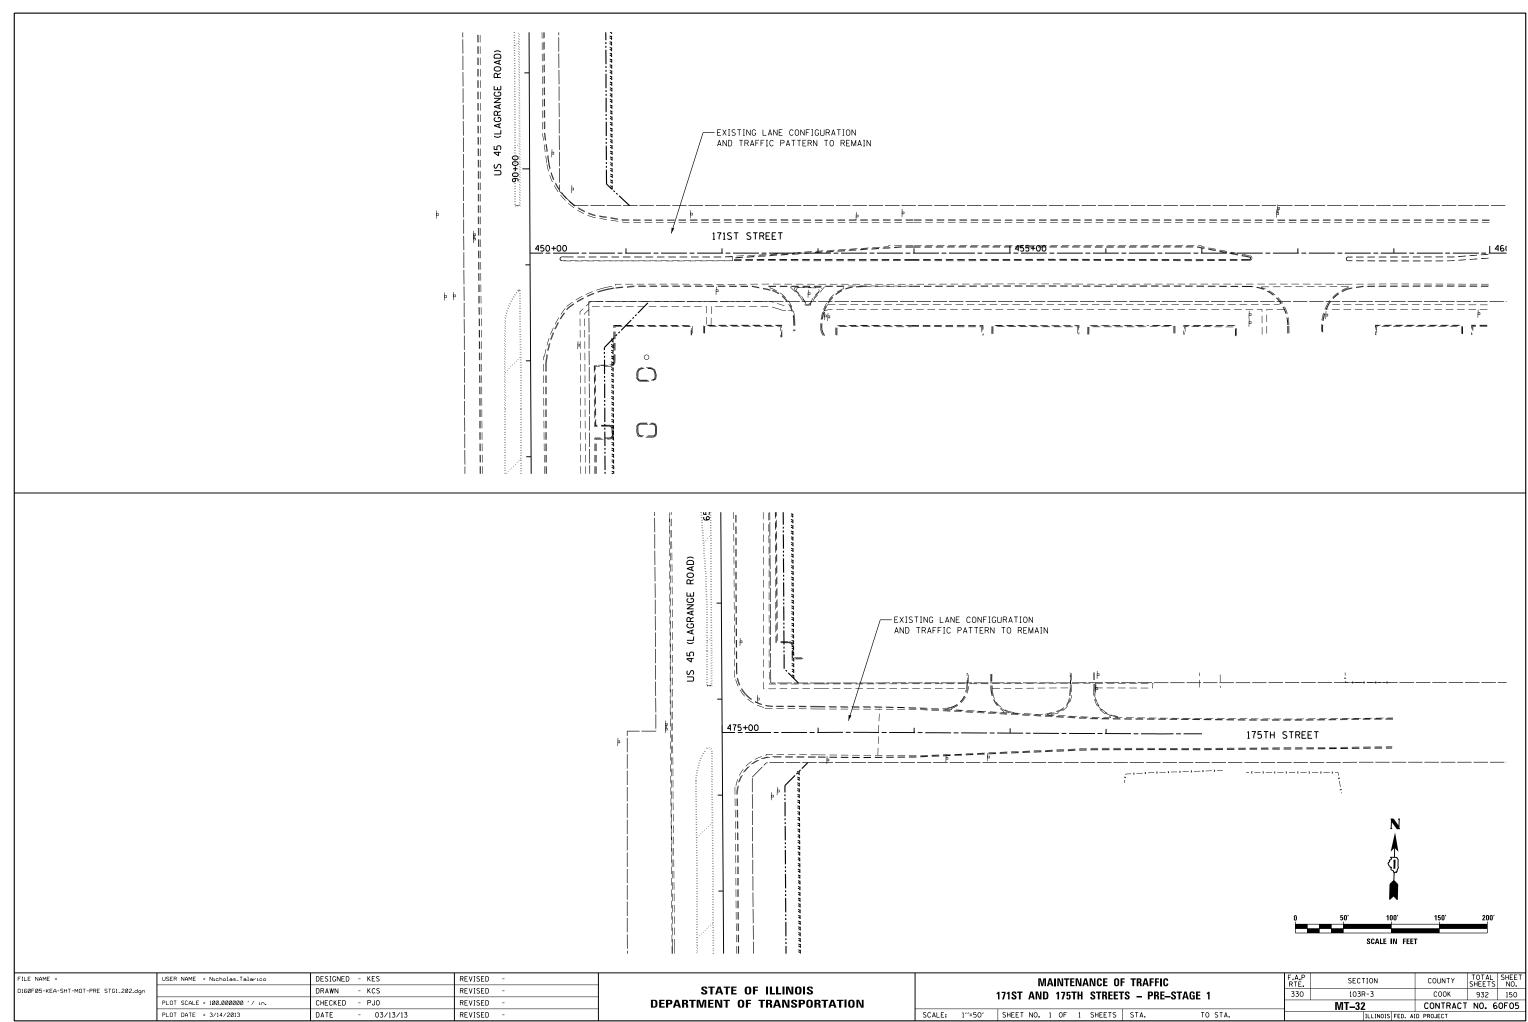
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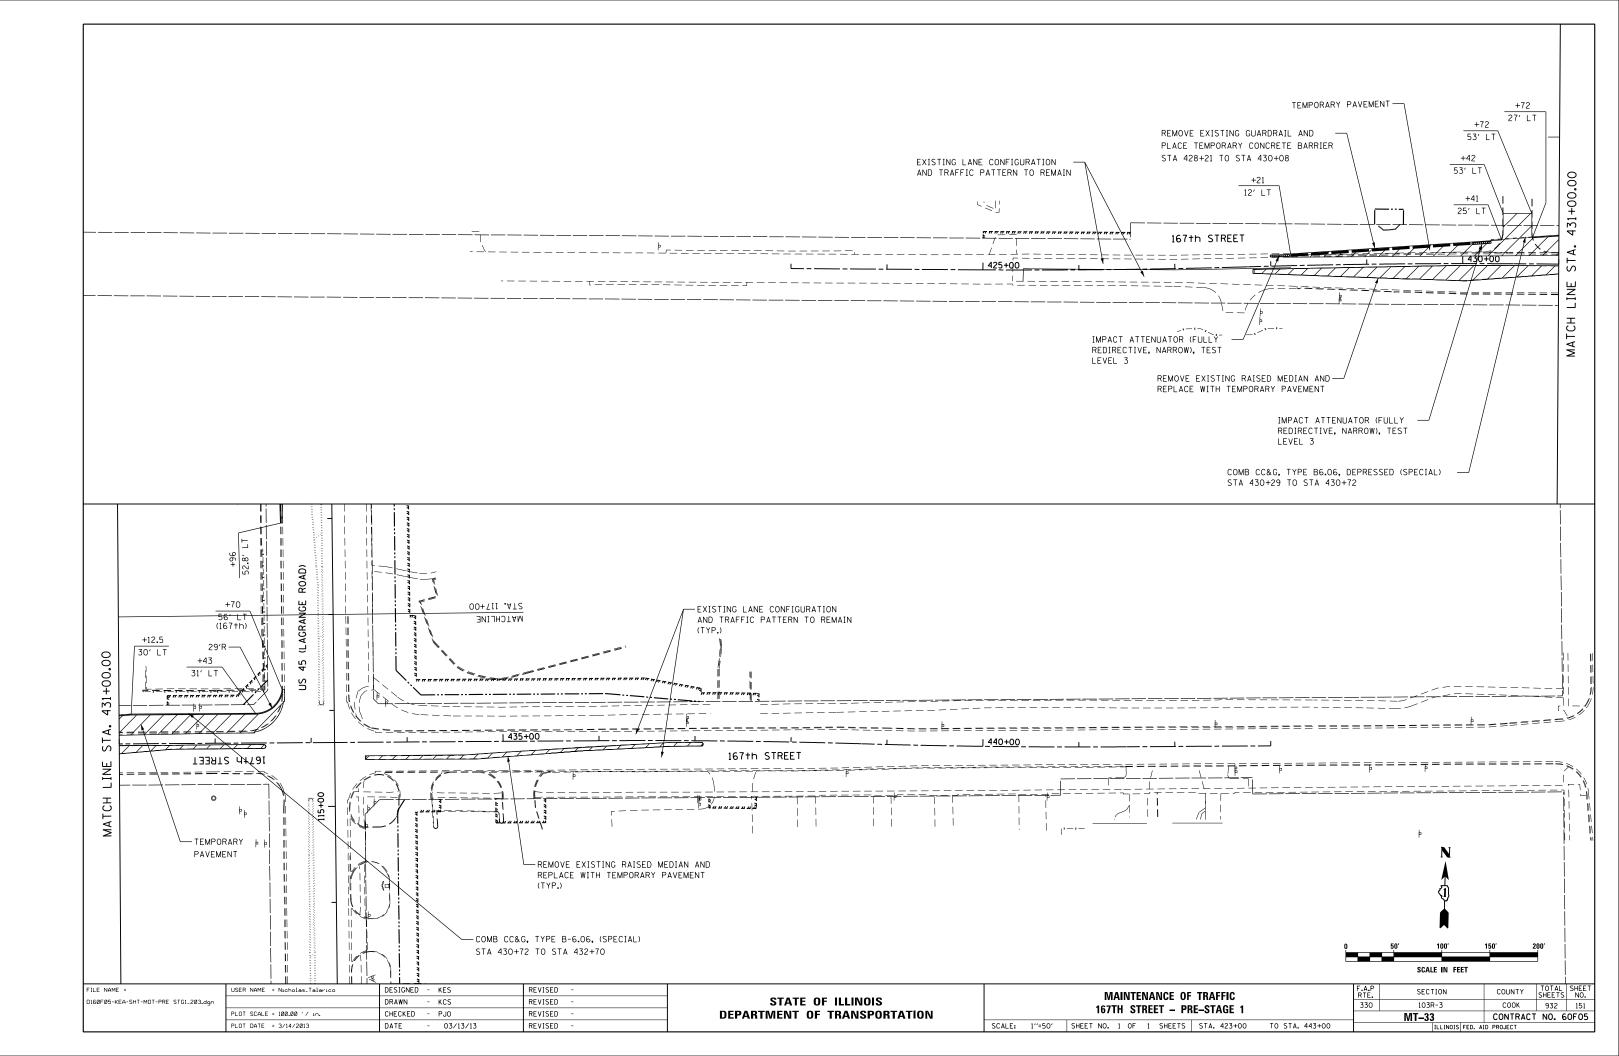
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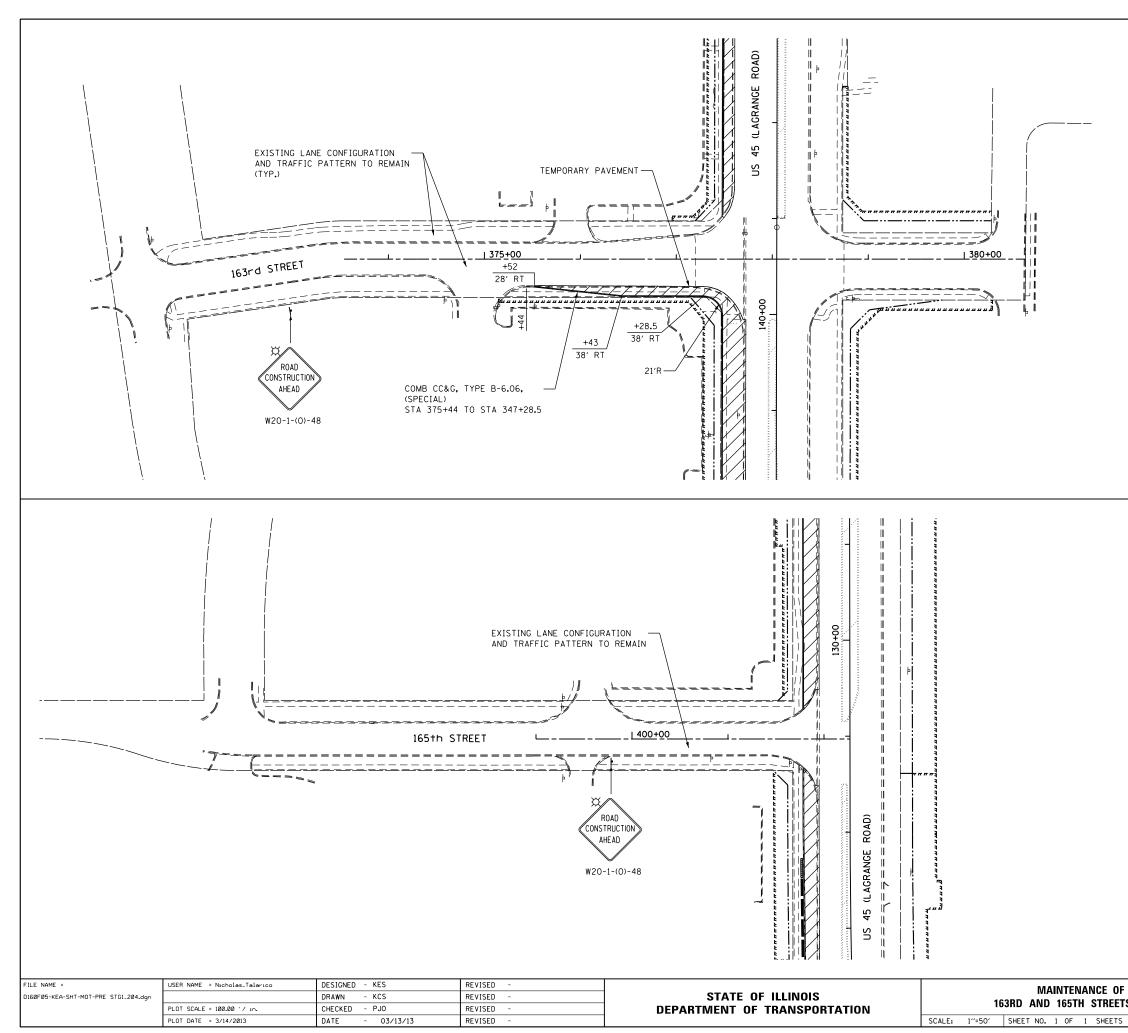
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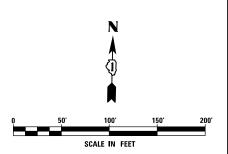
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STAGE 4			770 1070 7 000K 070 140						
STAGE 4						MT-30	CONTRACT	NO. 6	0F05
5 STA. 162+00.00 TO STA. END				ILLINOIS FED. A	D PROJECT				
















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TS – PRE–STAGE 1		330	932 152					
	IS - PRE-STAGE I			MT-34 CONTRACT NO. 60F				
;	STA.	TO STA.		ILLINOIS FED. A	ID PROJECT			

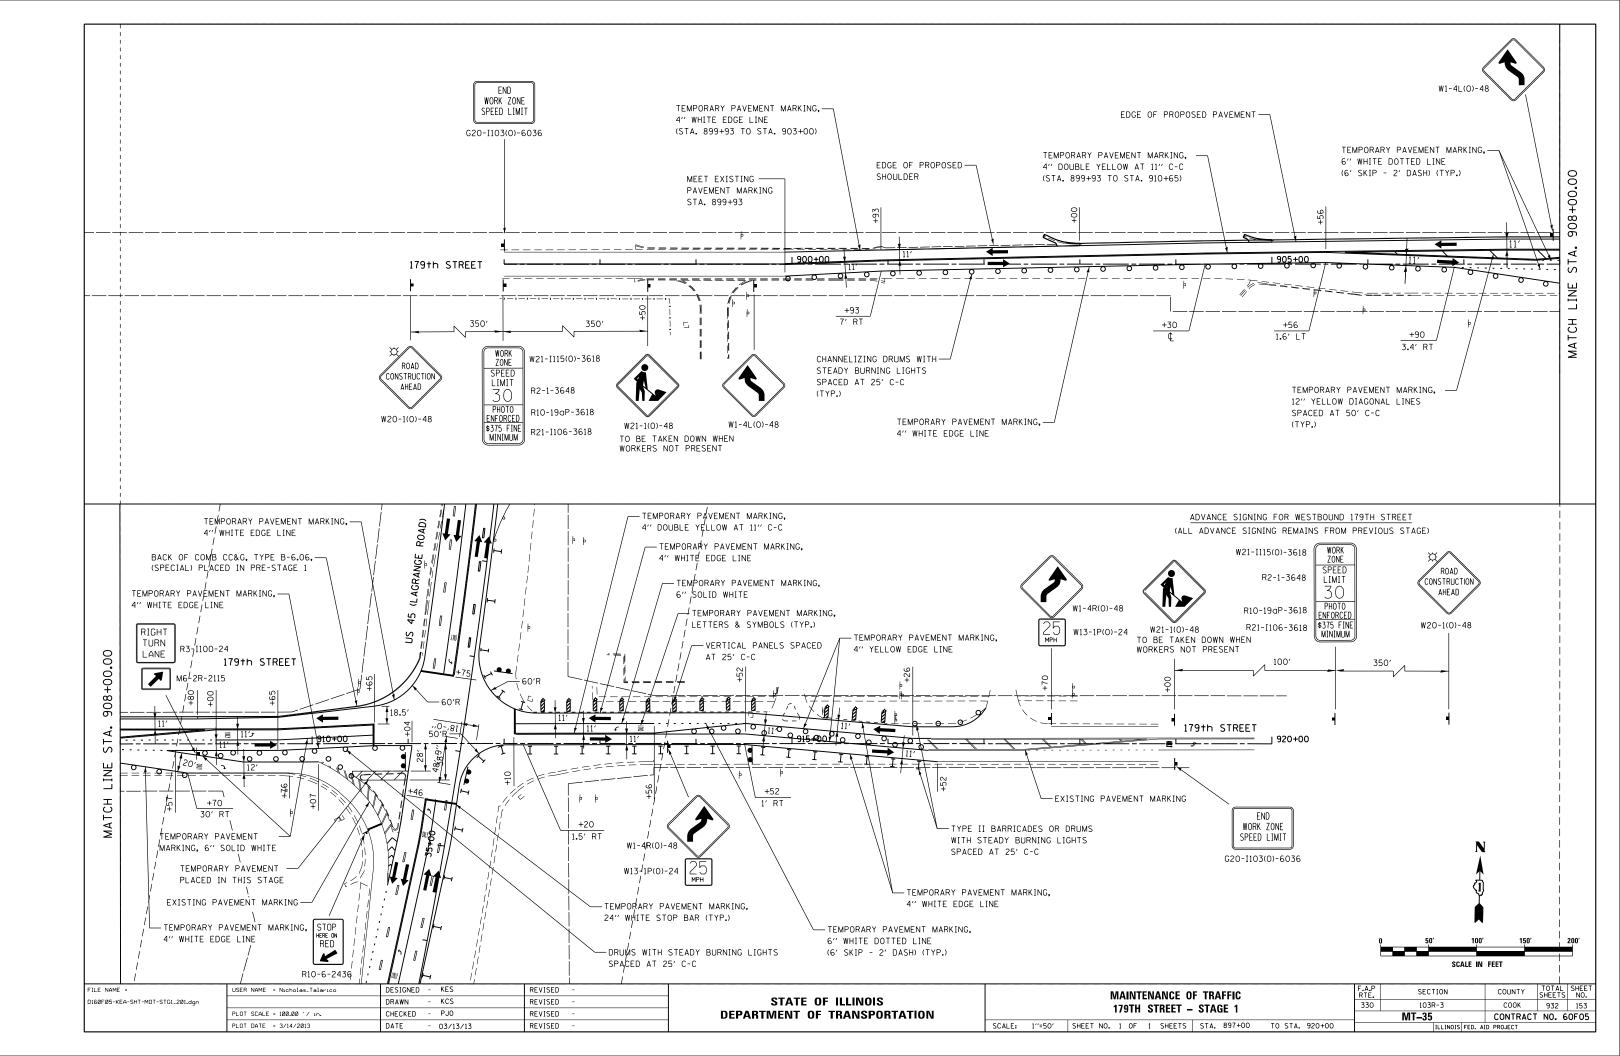

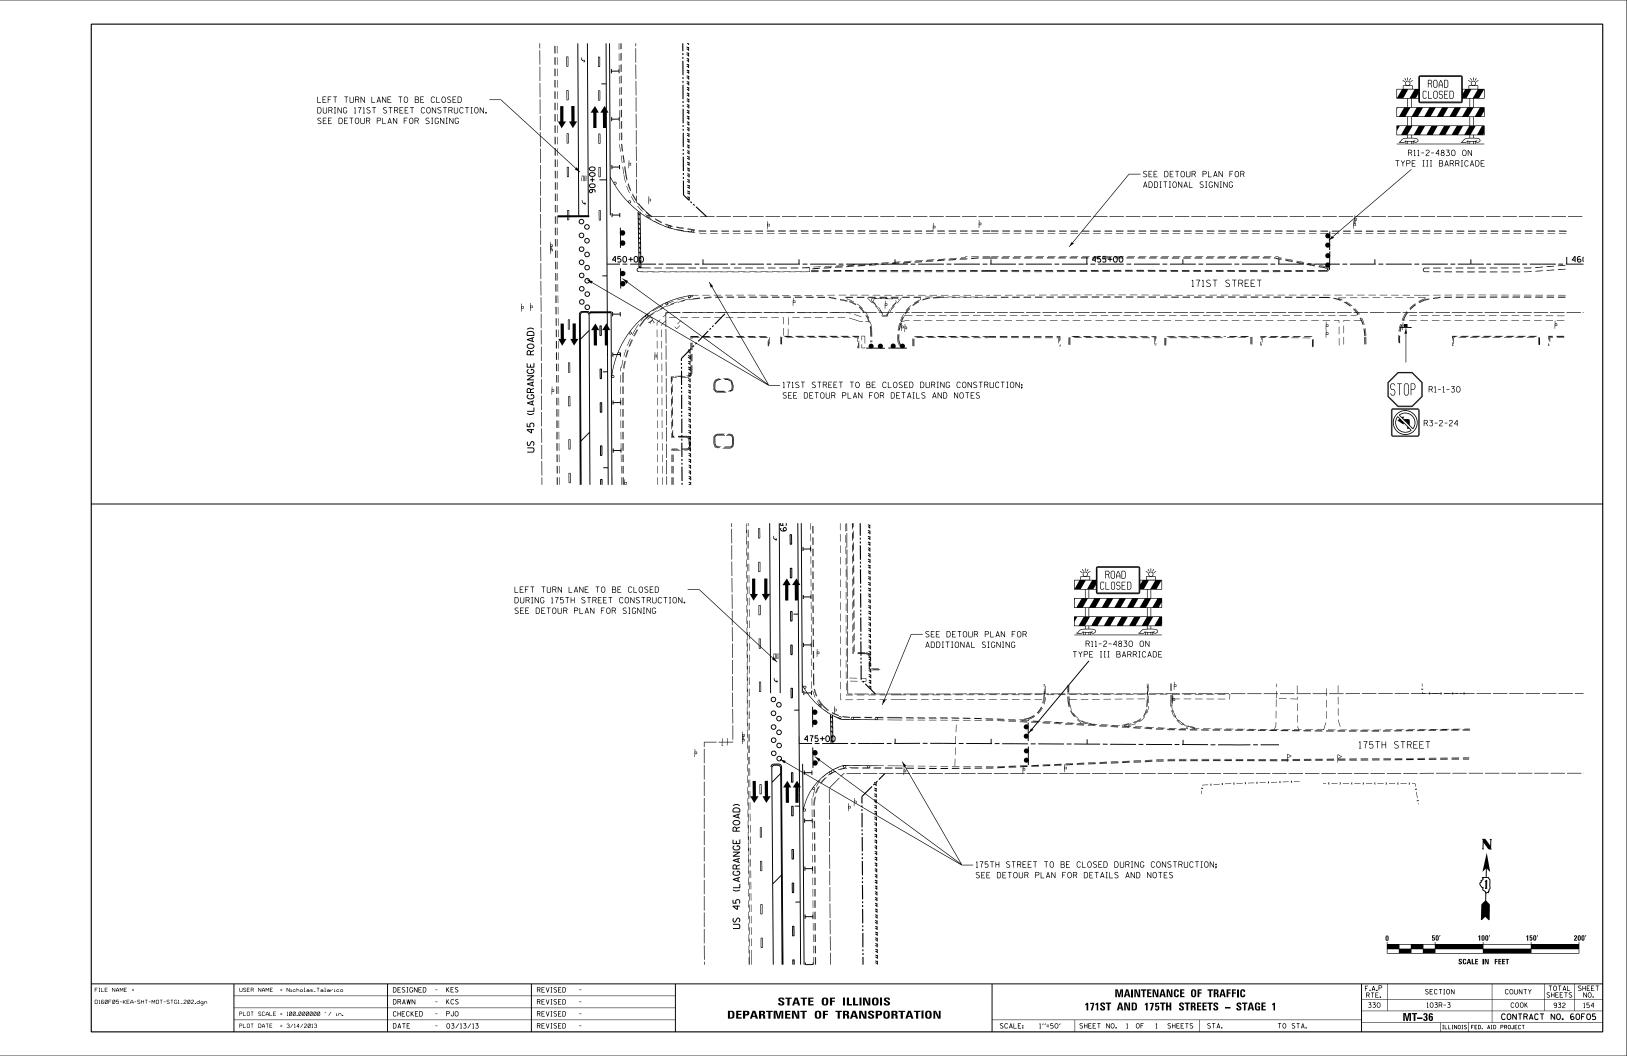


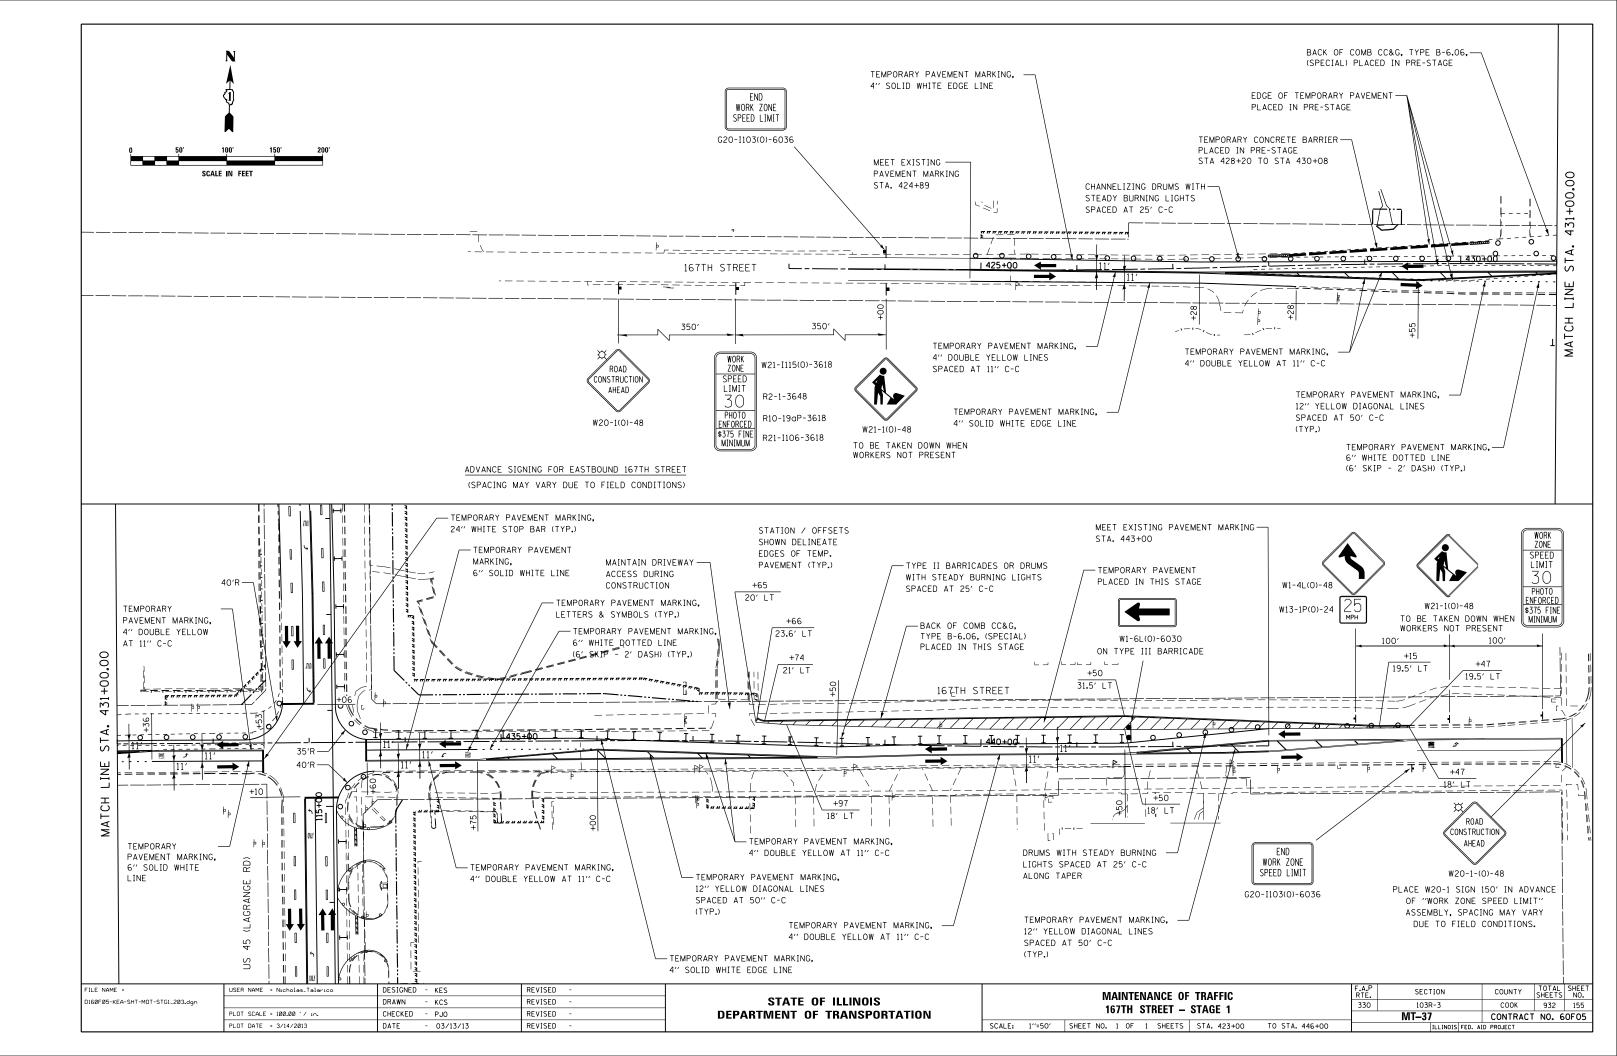


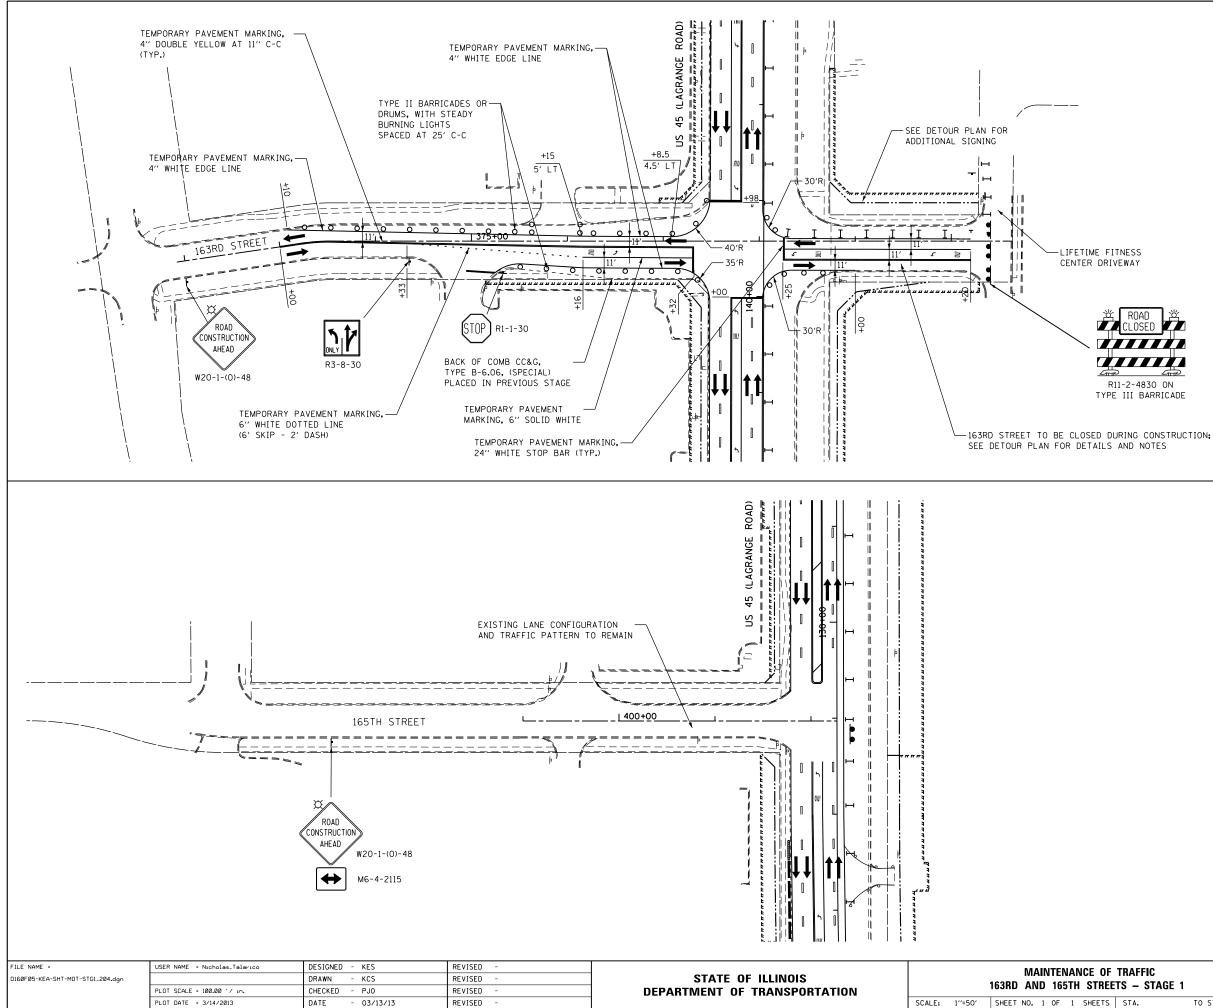


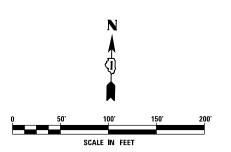


F	TRAFFIC		F.A.P RTE.	SECTION	COUNTY	TOTAL SHEETS	SHEET NO.	
ETS – STAGE 1		330 103R-3 COOK 932 1						
				MT-38 CONTRACT NO. 6				
5 STA. TO STA.				ILLINOIS FED. A	D PROJECT			

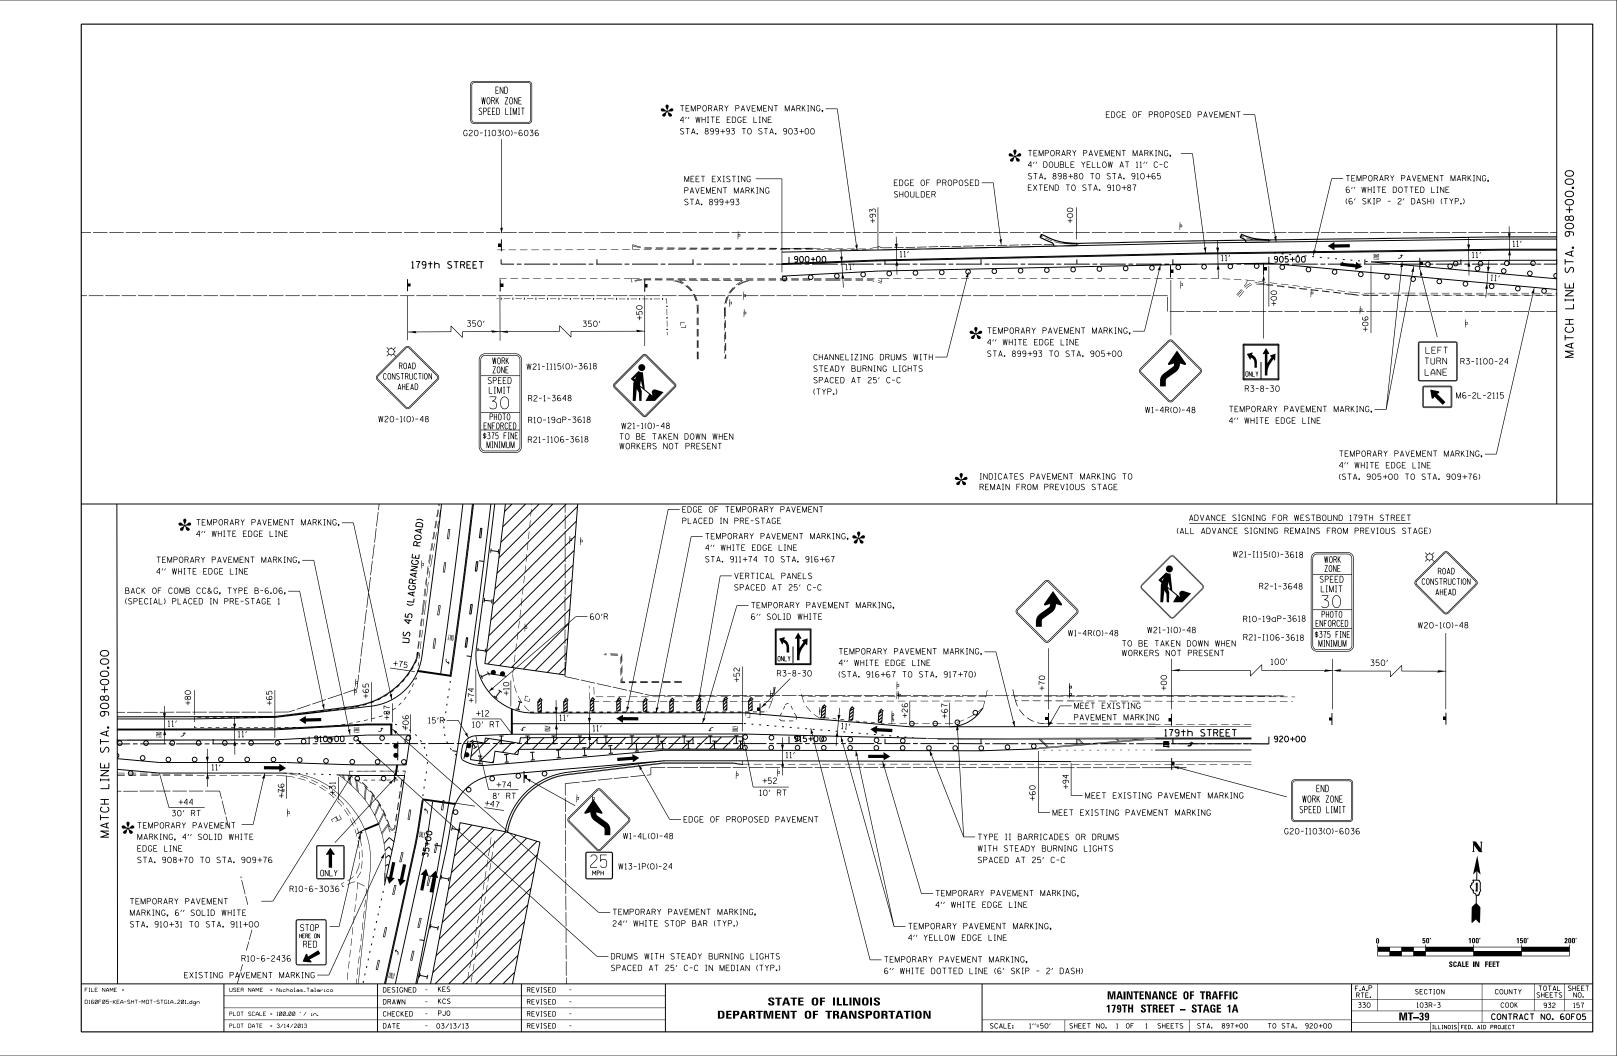


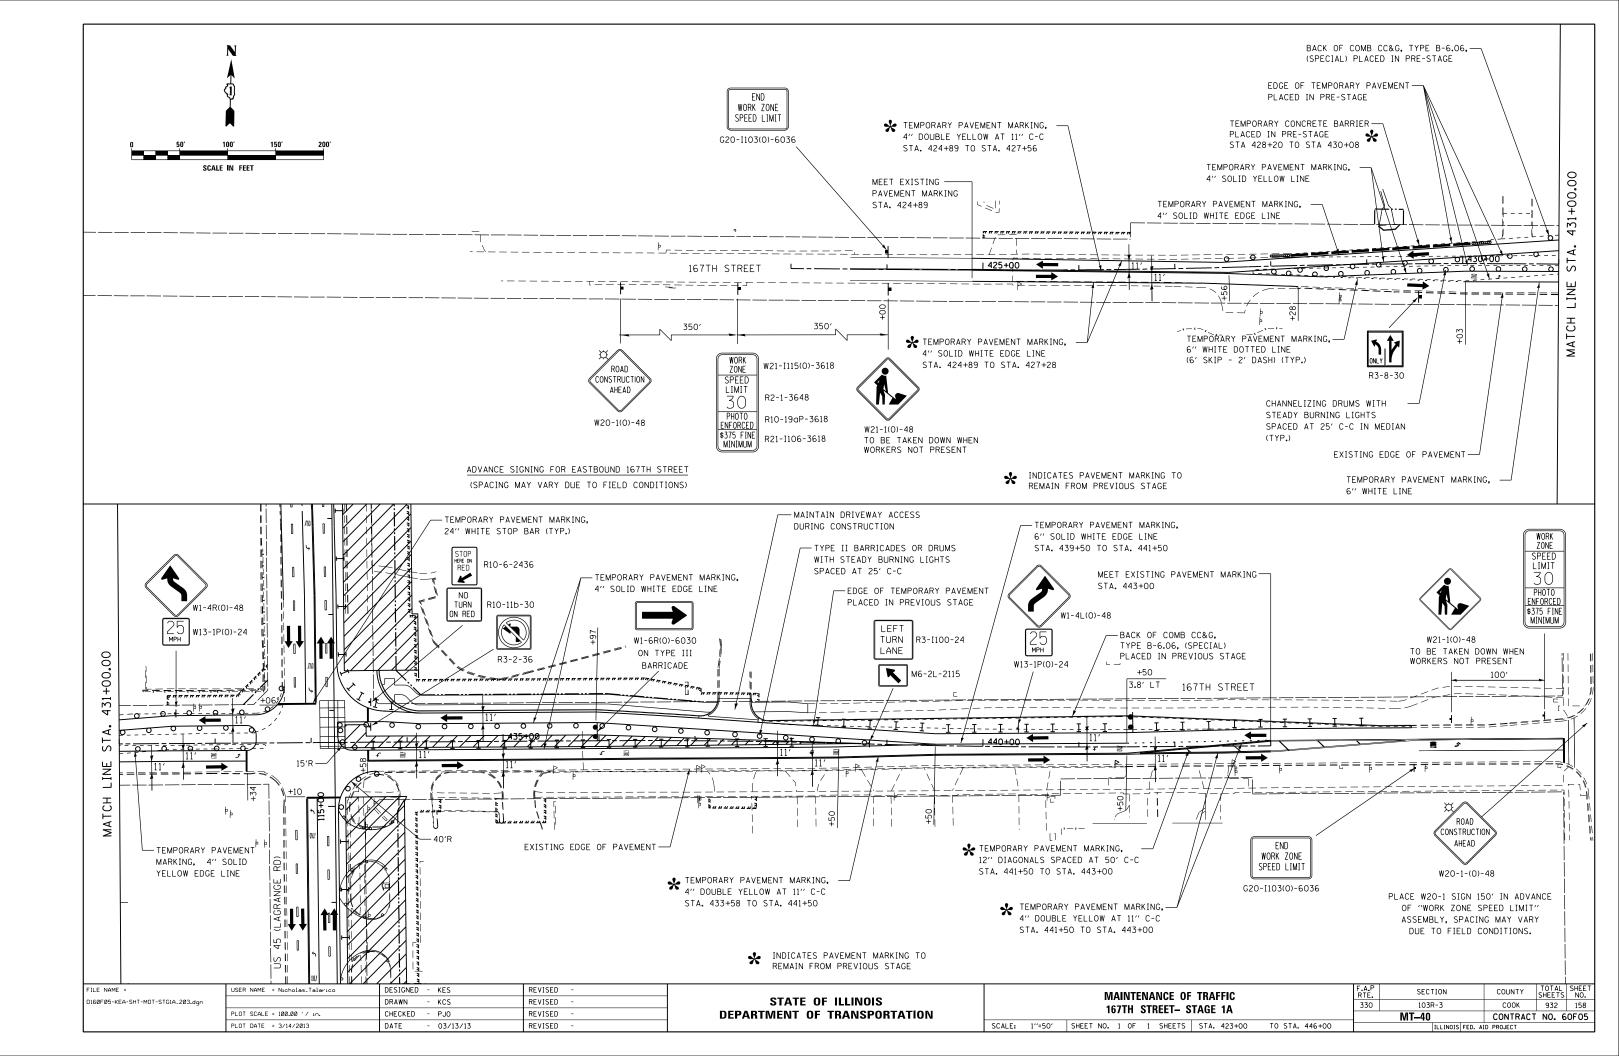


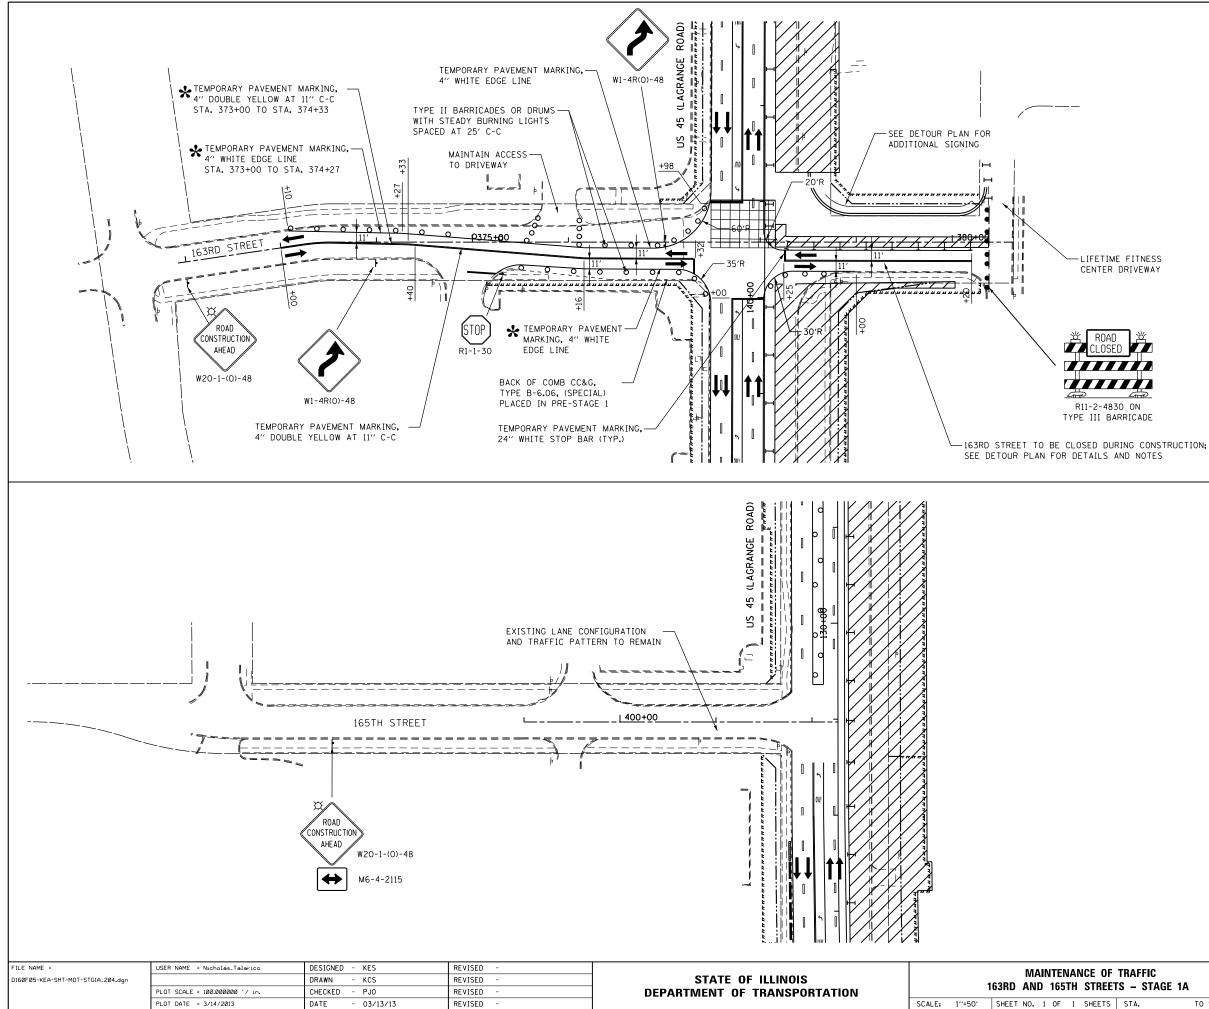


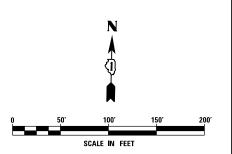


F TRAFFIC			F.A.P RTE.	SECTION	COUNTY	TOTAL SHEETS	SHEET NO.	
ETS – STAGE 1A		330	932	159				
_	13 - STAUL IA			MT-41 CONTRACT NO. 60				
S STA. TO STA.				ILLINOIS FED. AI	D PROJECT			

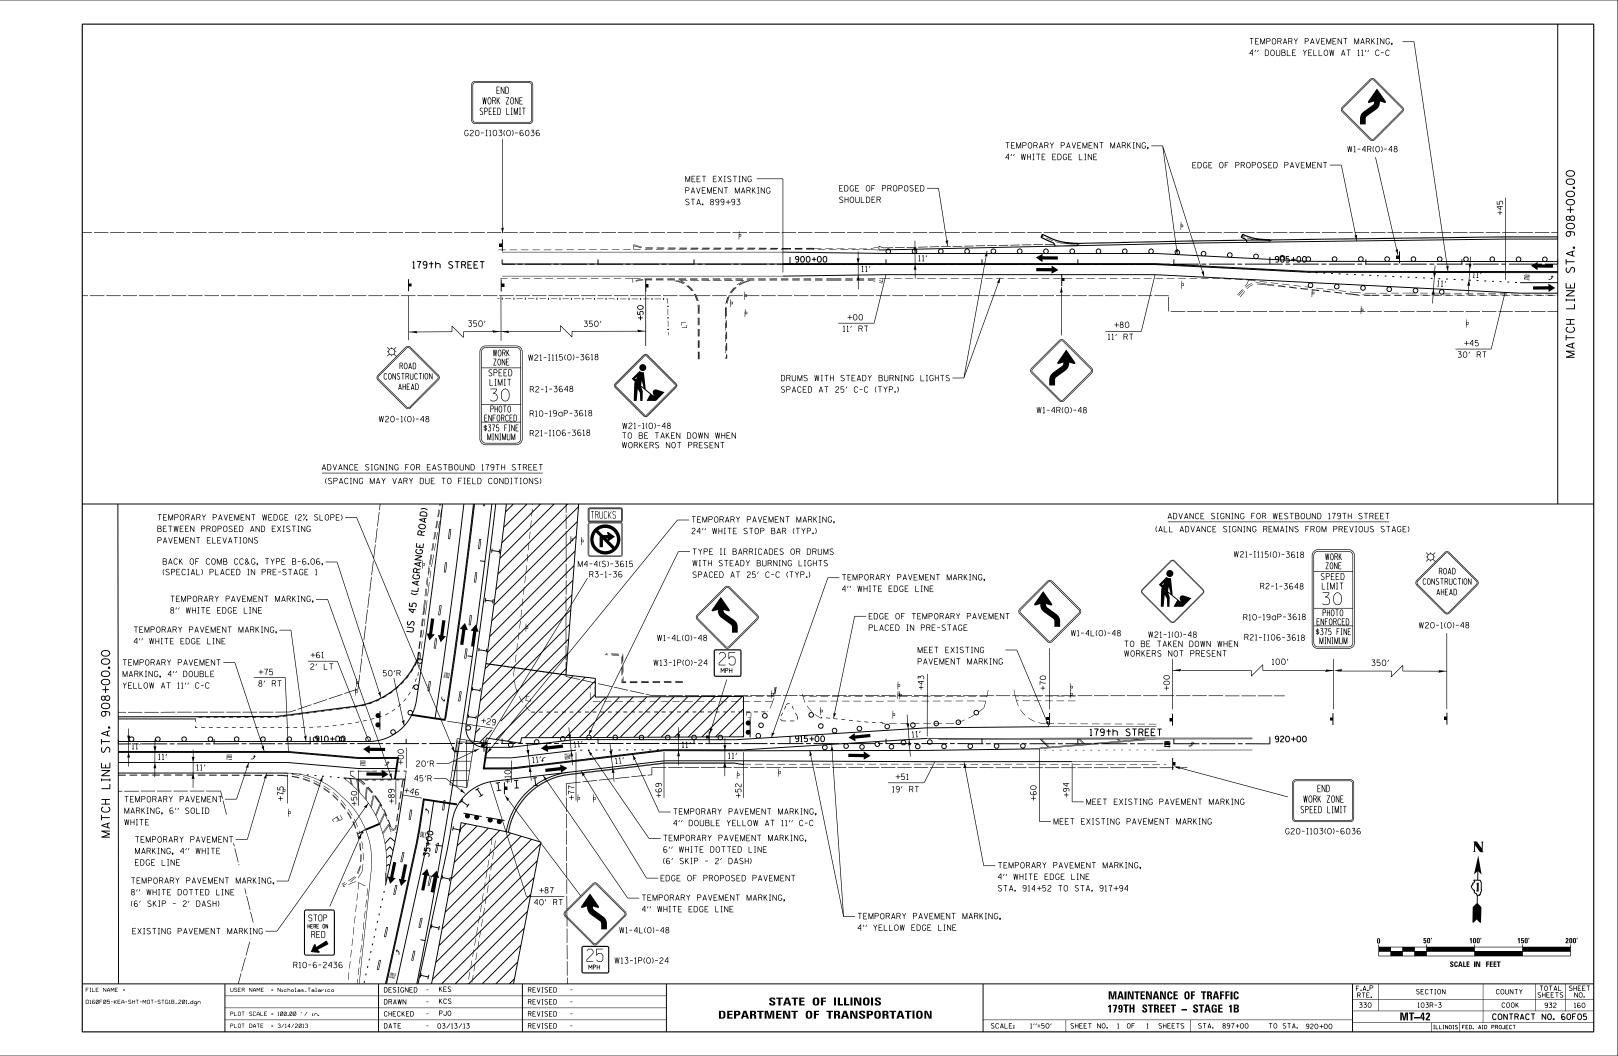


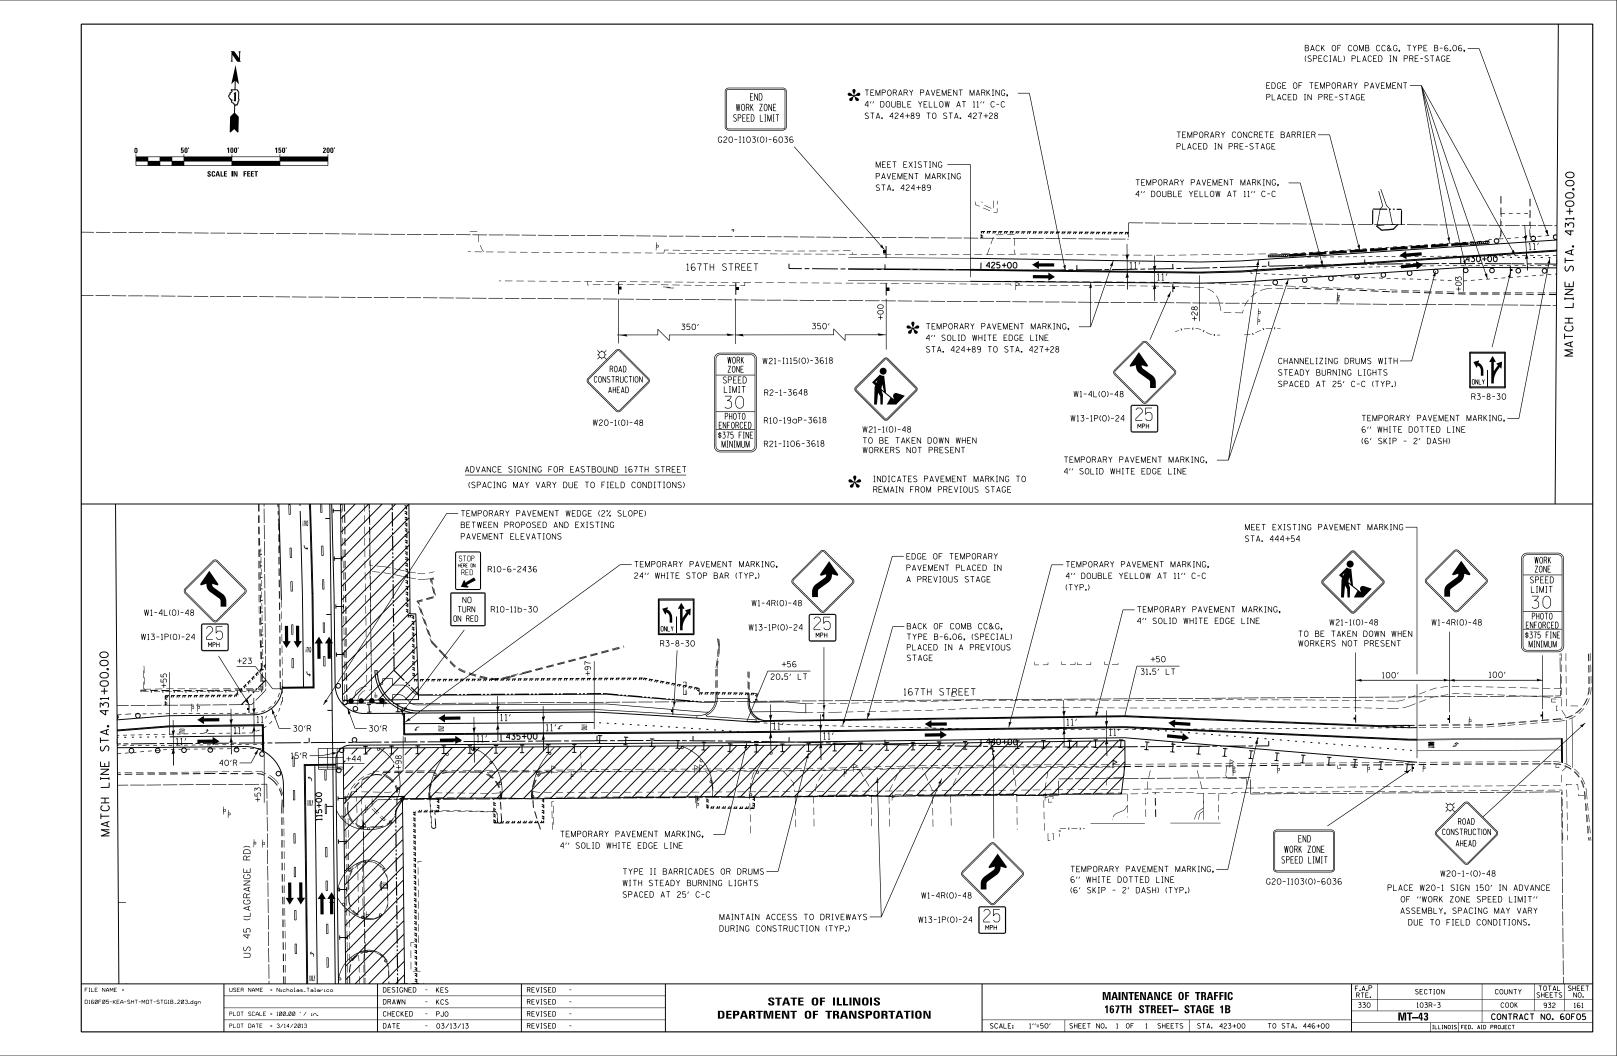


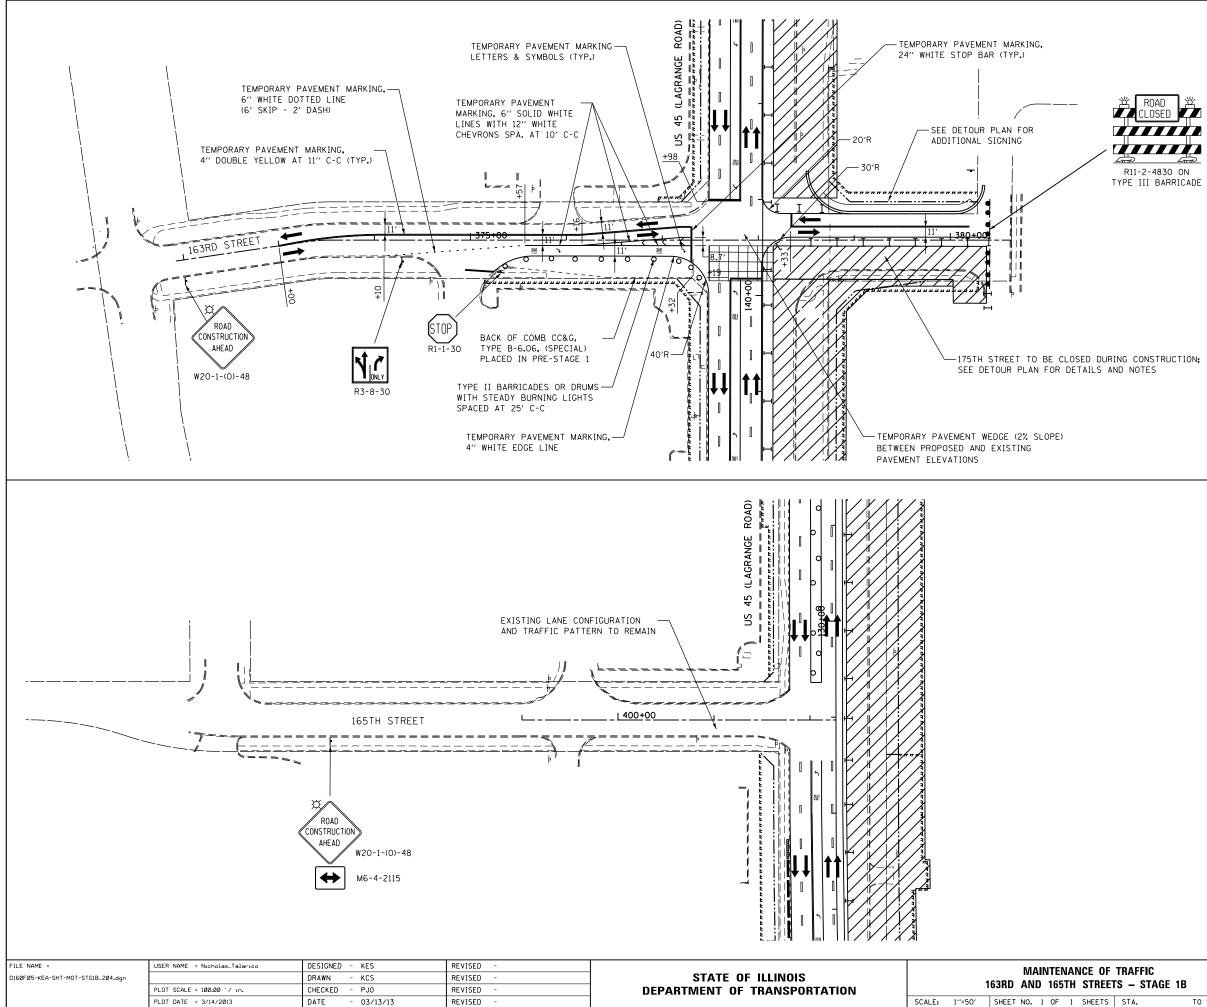

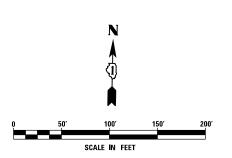



F	TRAFFIC		F.A.P RTE.	SECTION	COUNTY	TOTAL SHEETS	SHEET NO.		
ETS – STAGE 1B		330	103R-3	соок	932	162			
EIS - STAGE IB				MT-44 CONTRACT NO. 60F					
S	STA.	TO STA.		ILLINOIS FED. A	ID PROJECT				

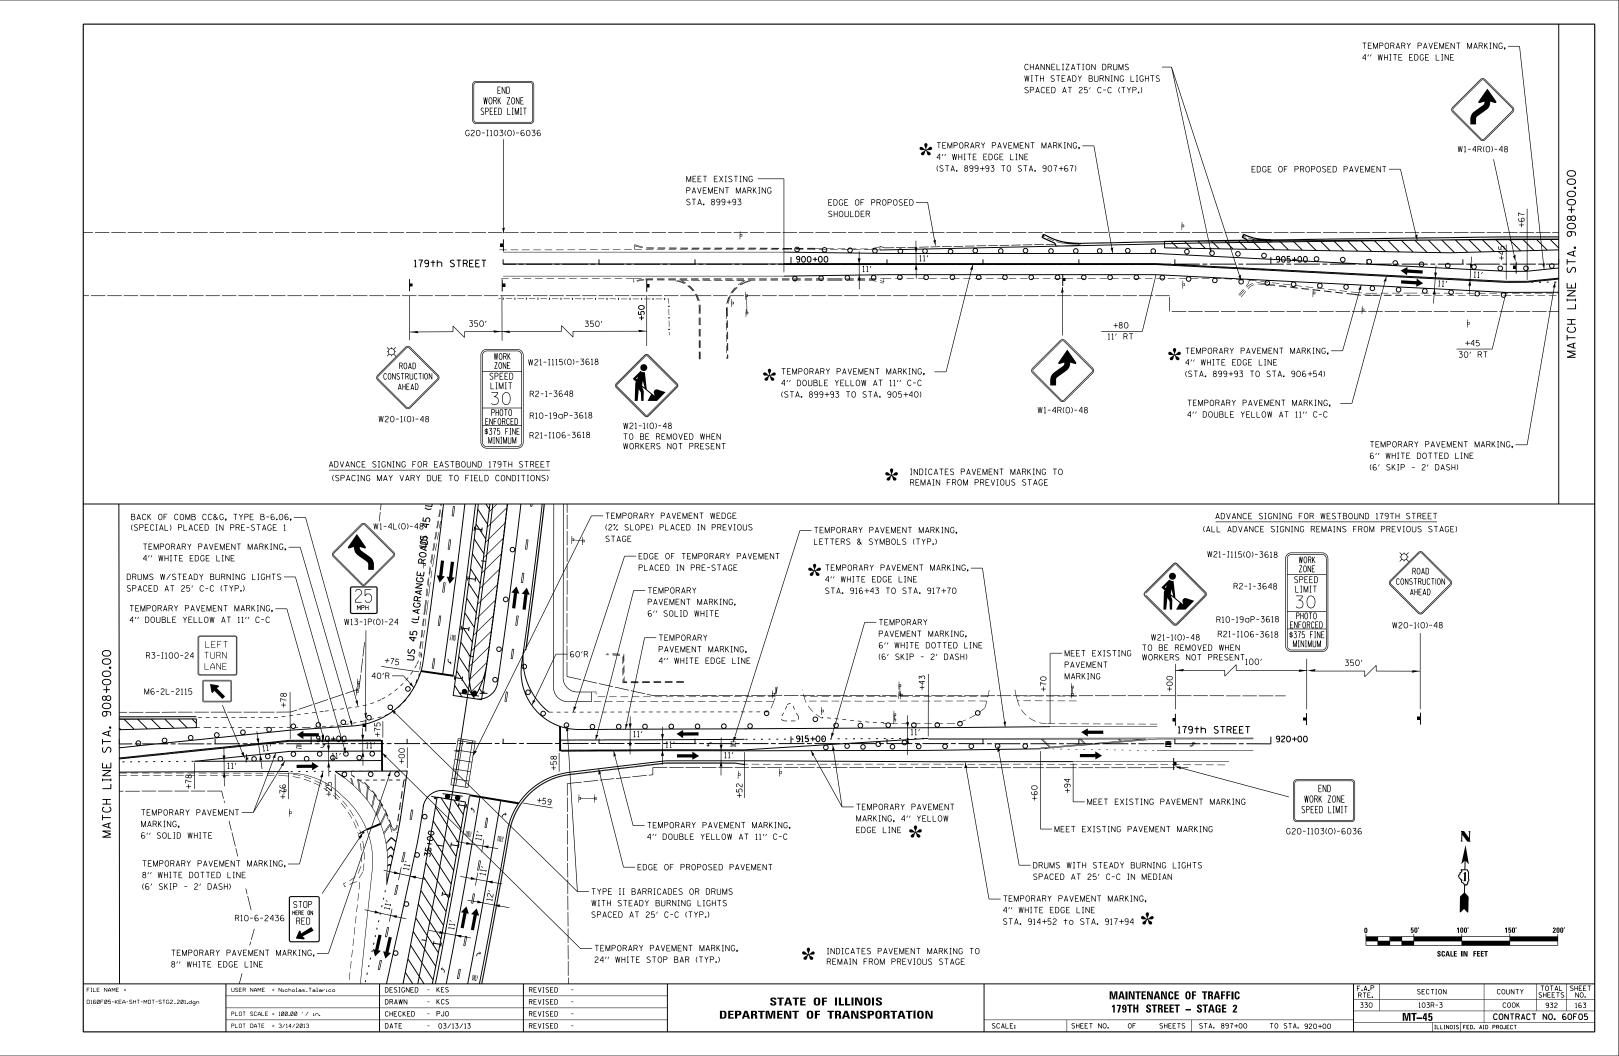


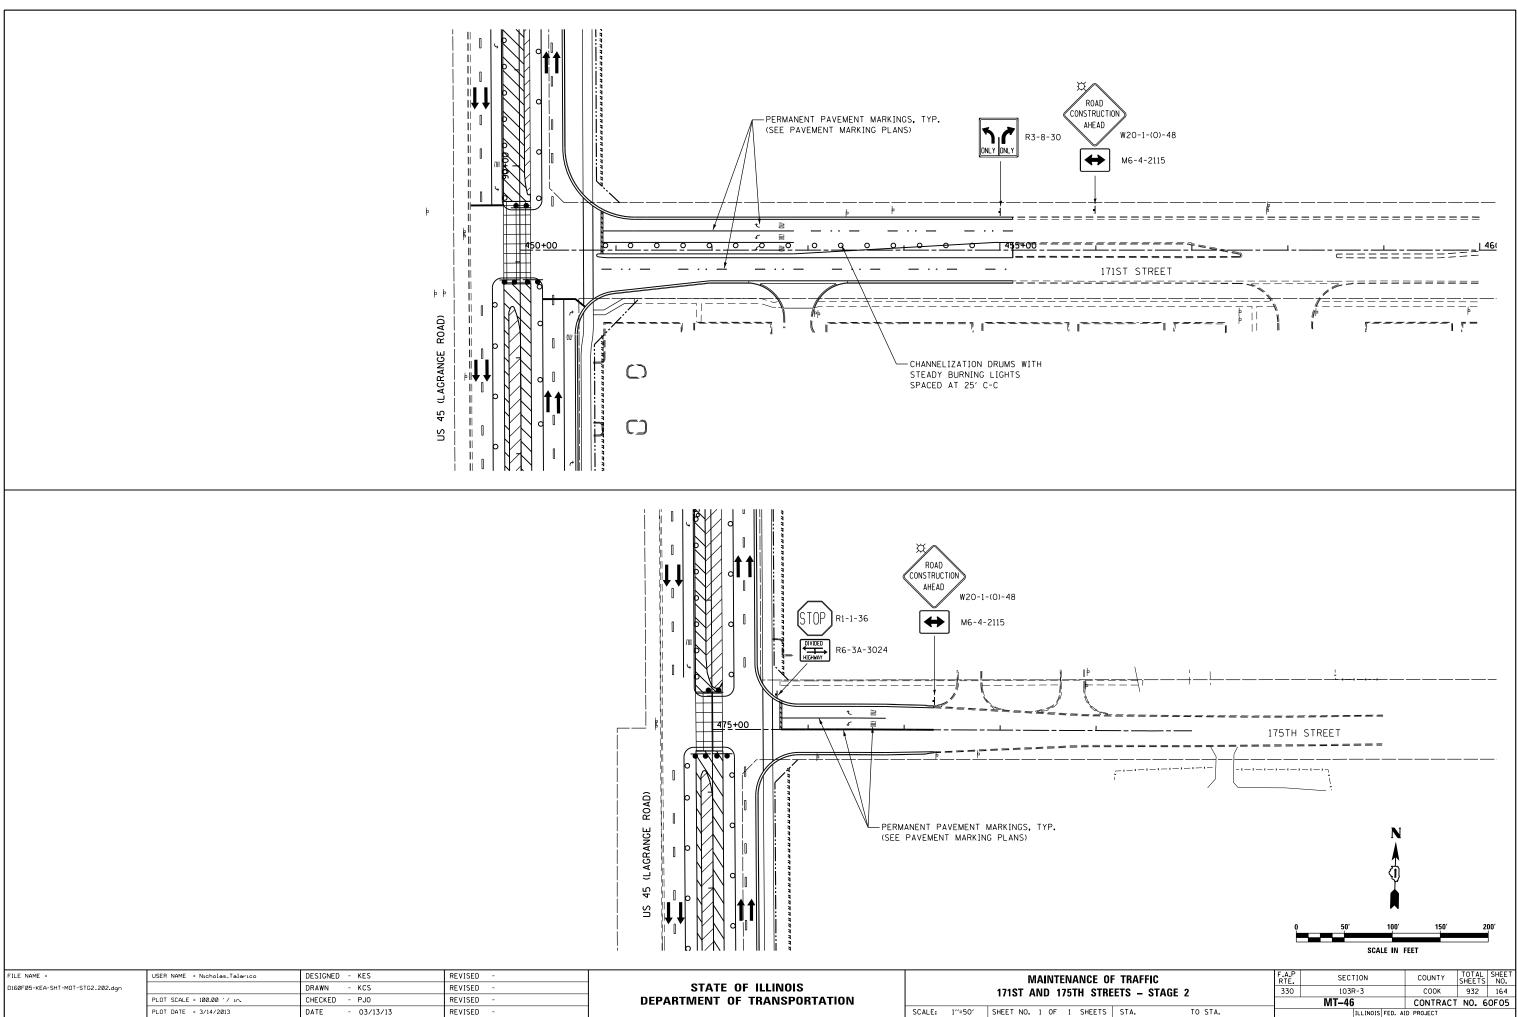



DEPARTMENT OF TRANSPORTATION						•••	
	SCALE:	1''=50'	SHEET NO.	1 (	ЭF	1	SHEET

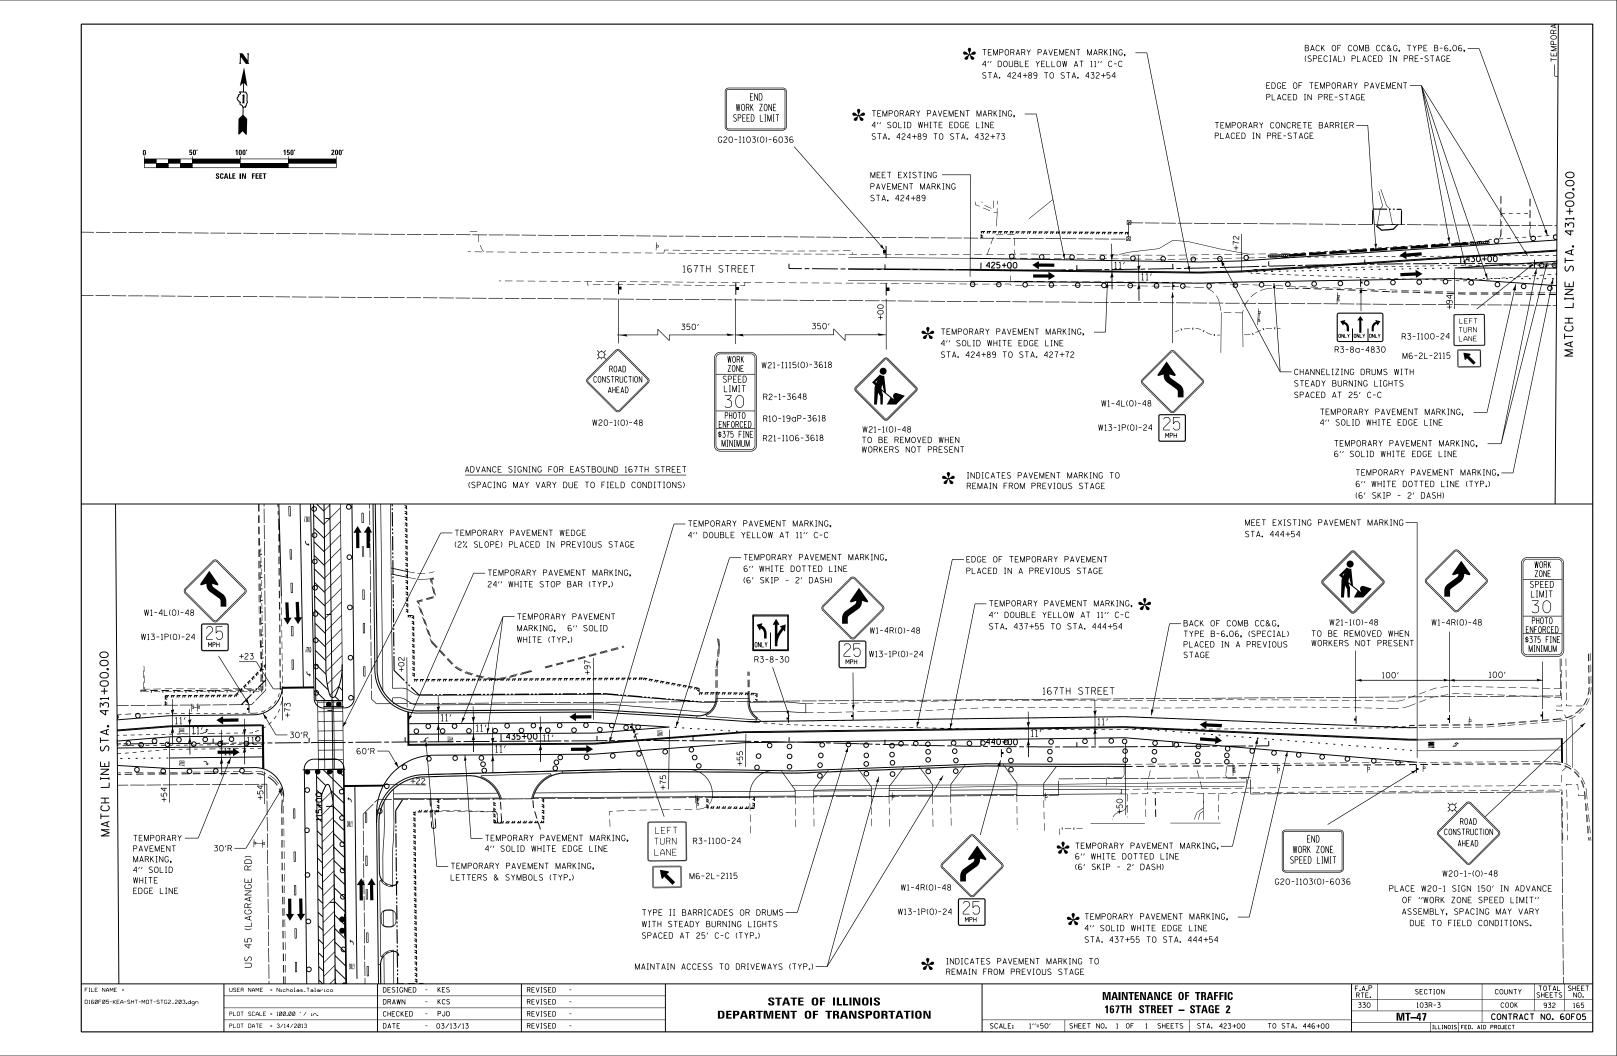


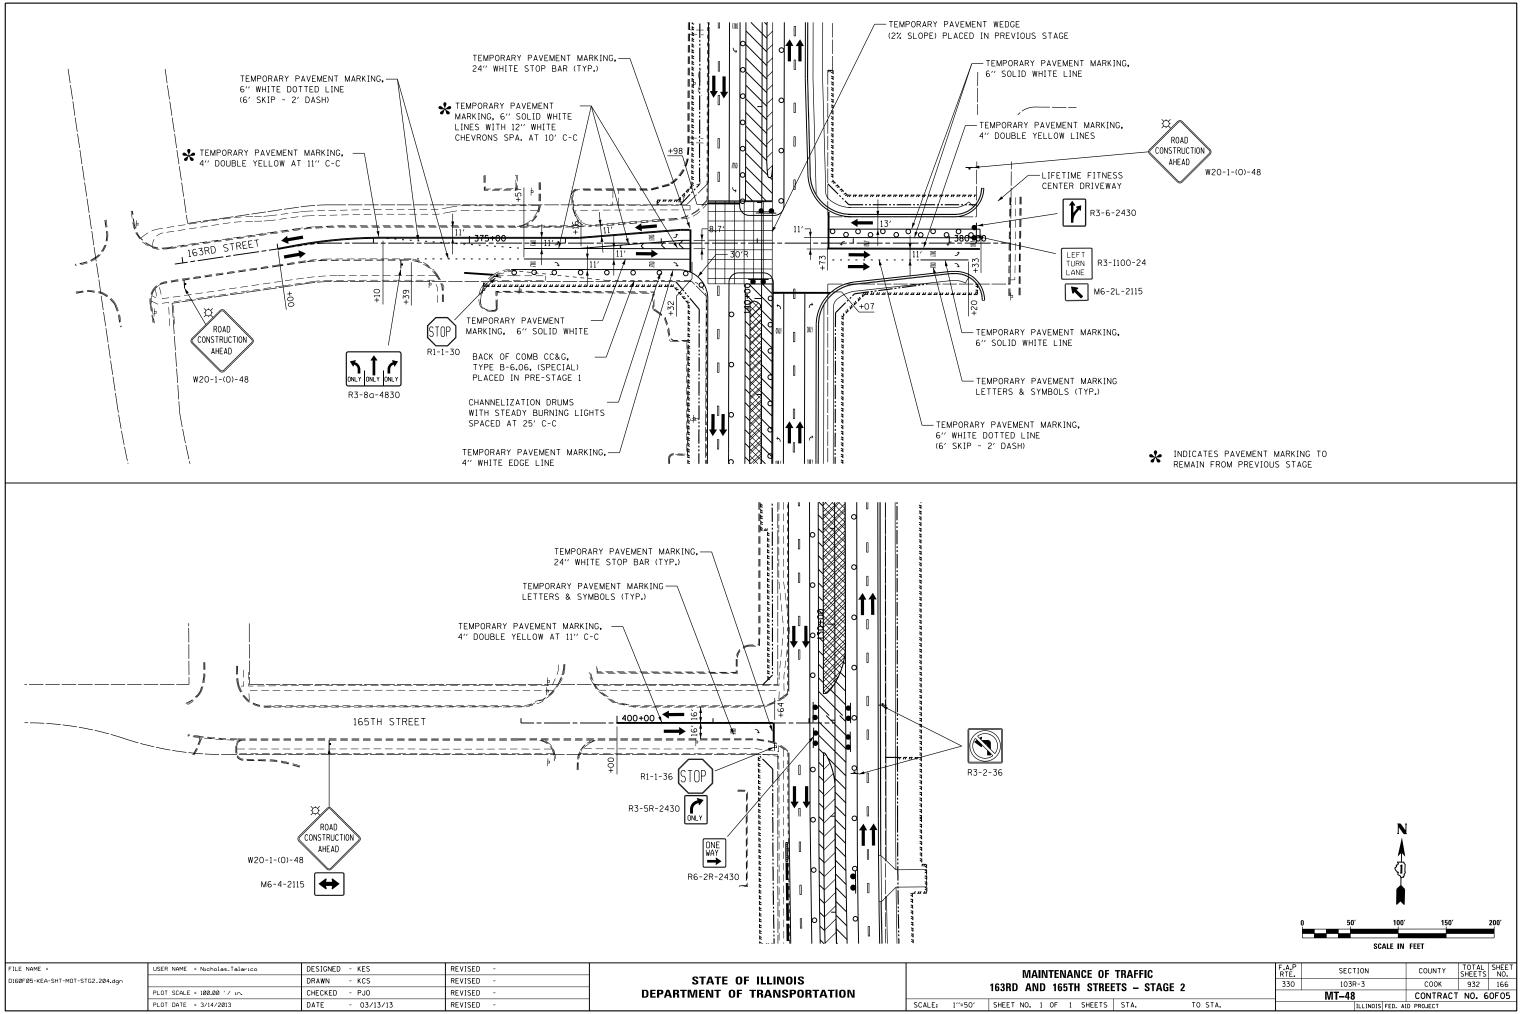

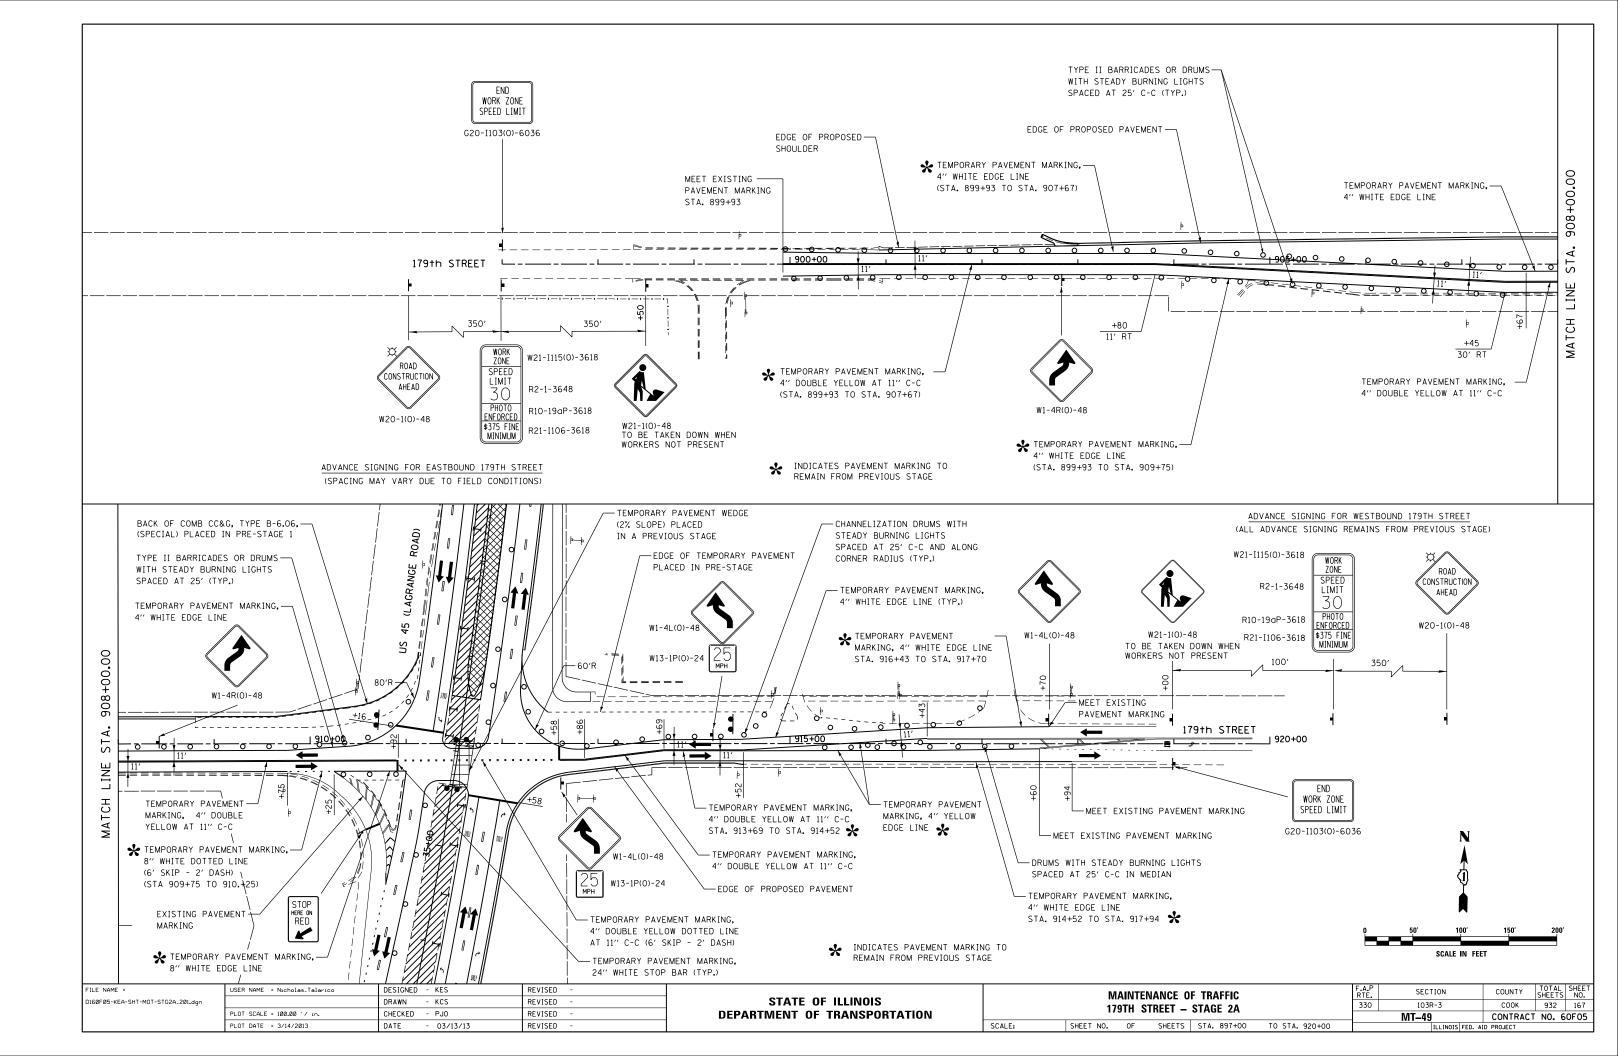

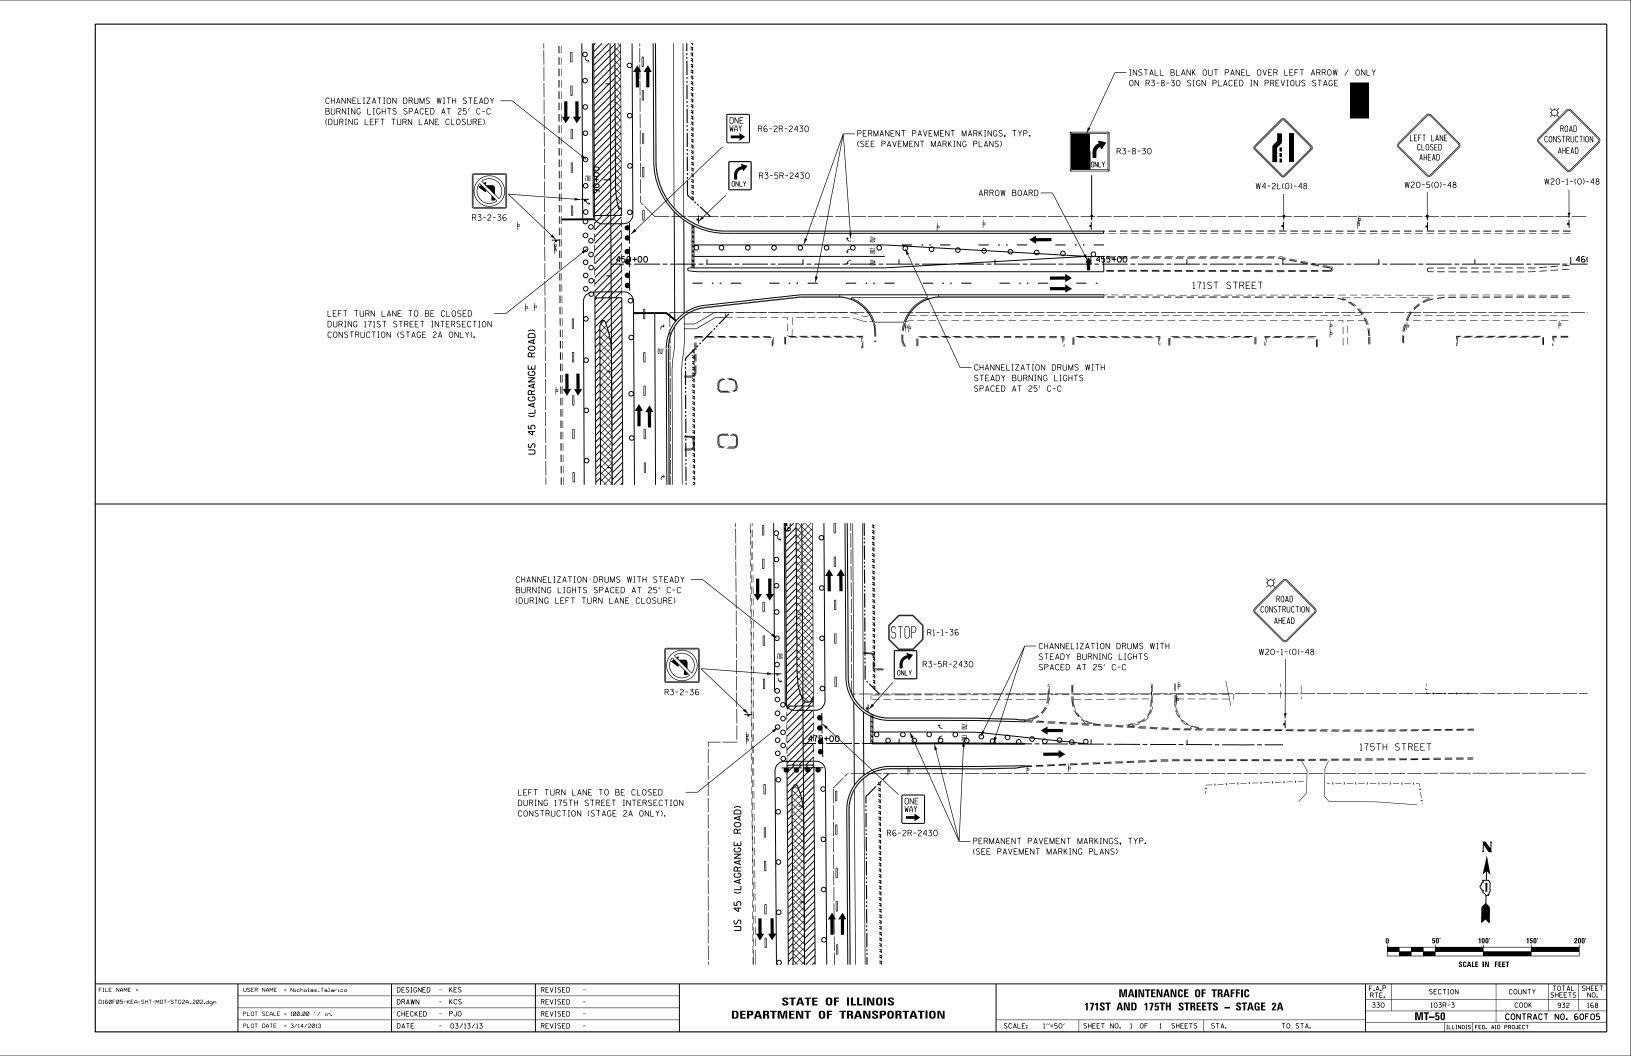

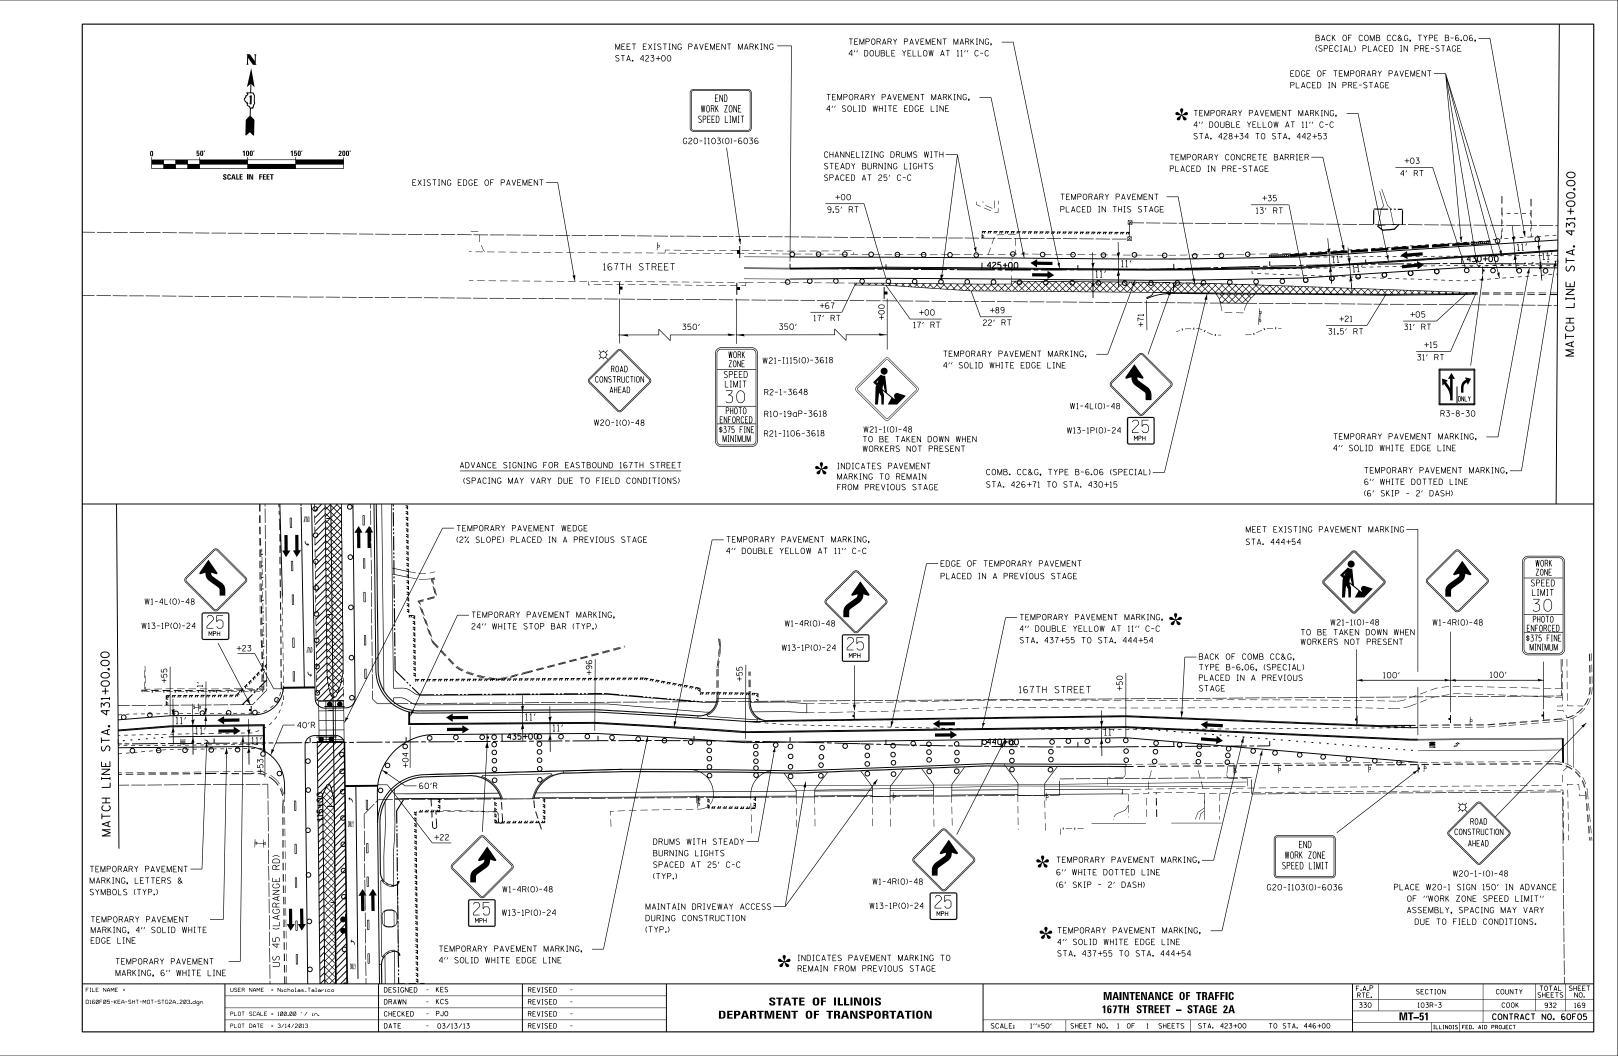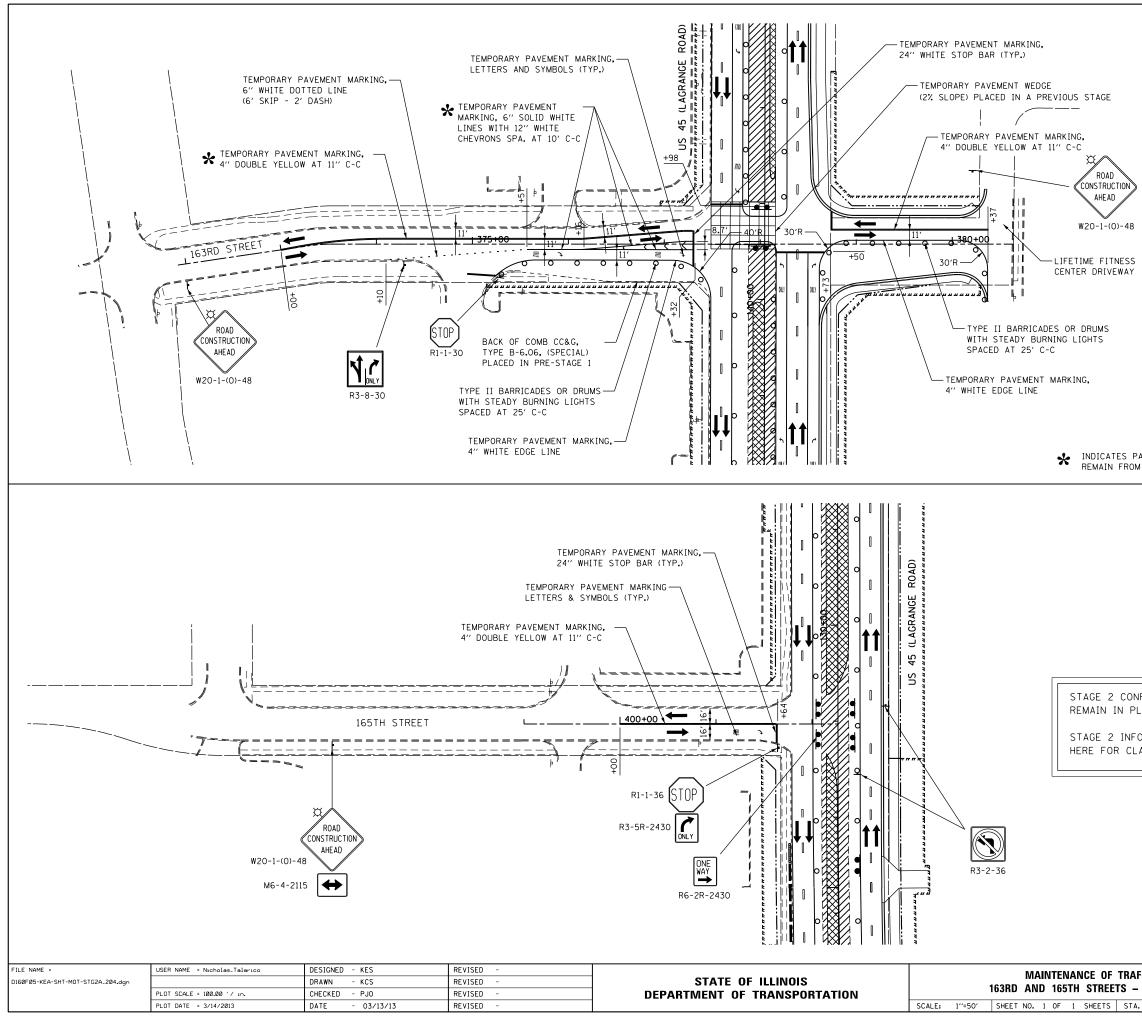





✤ INDICATES PAVEMENT MARKING TO REMAIN FROM PREVIOUS STAGE

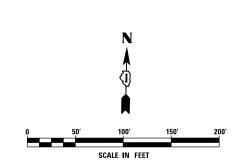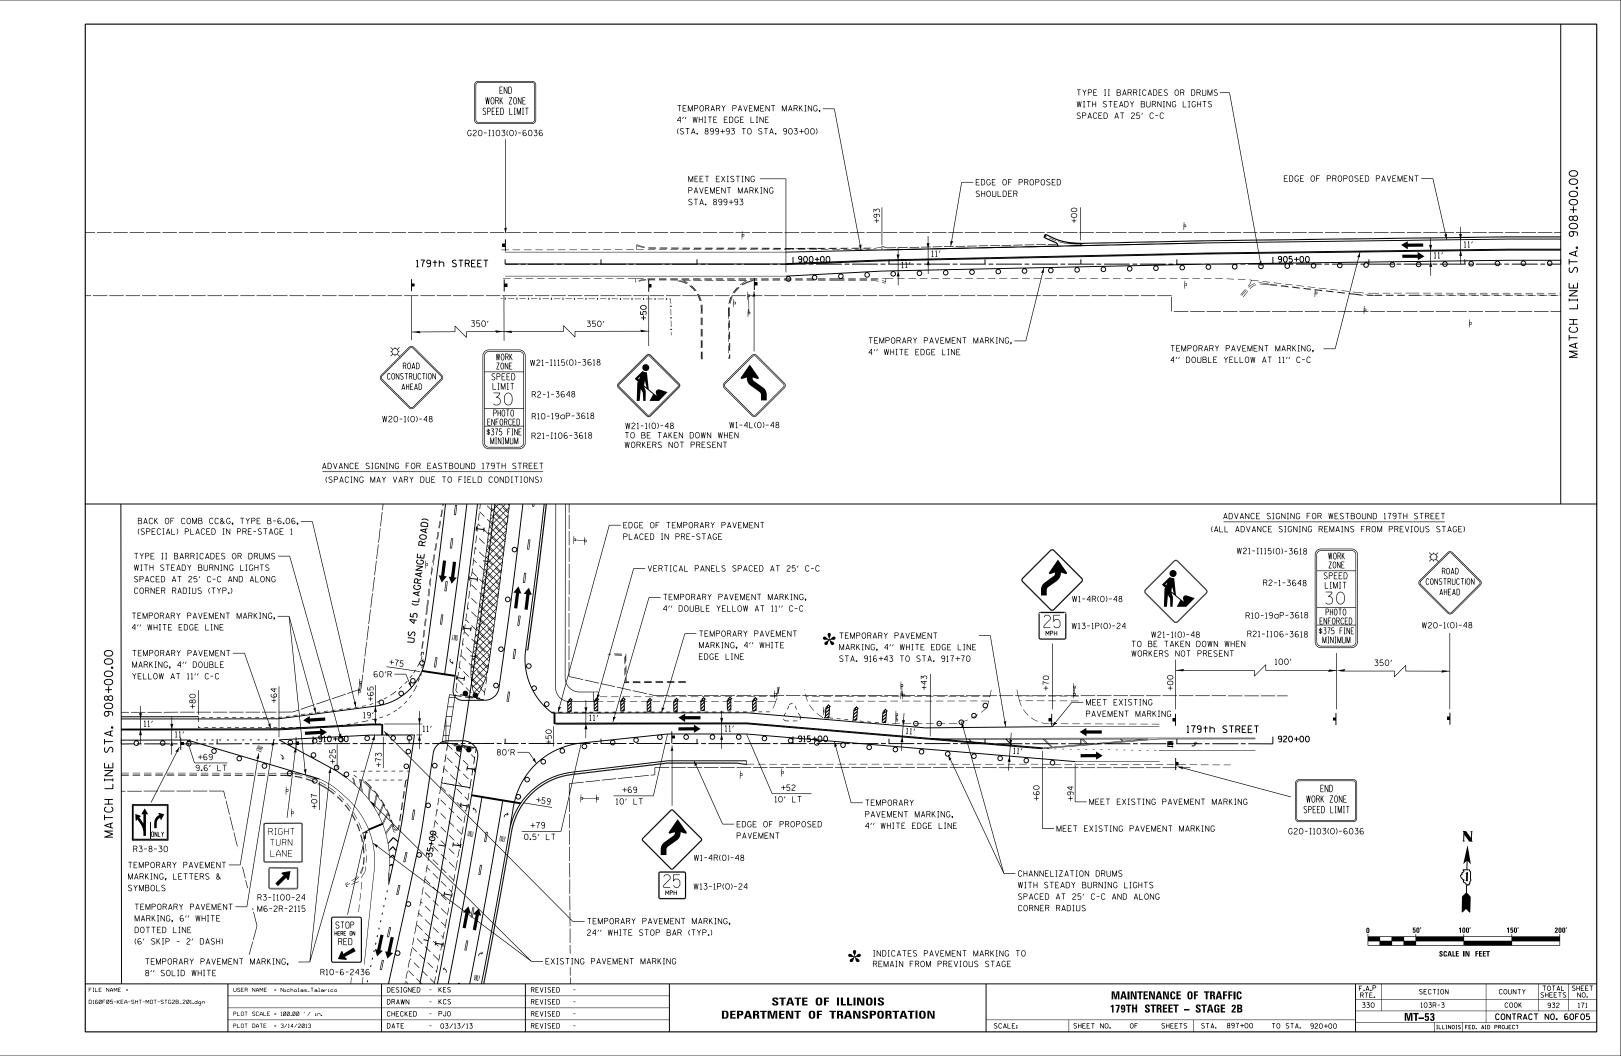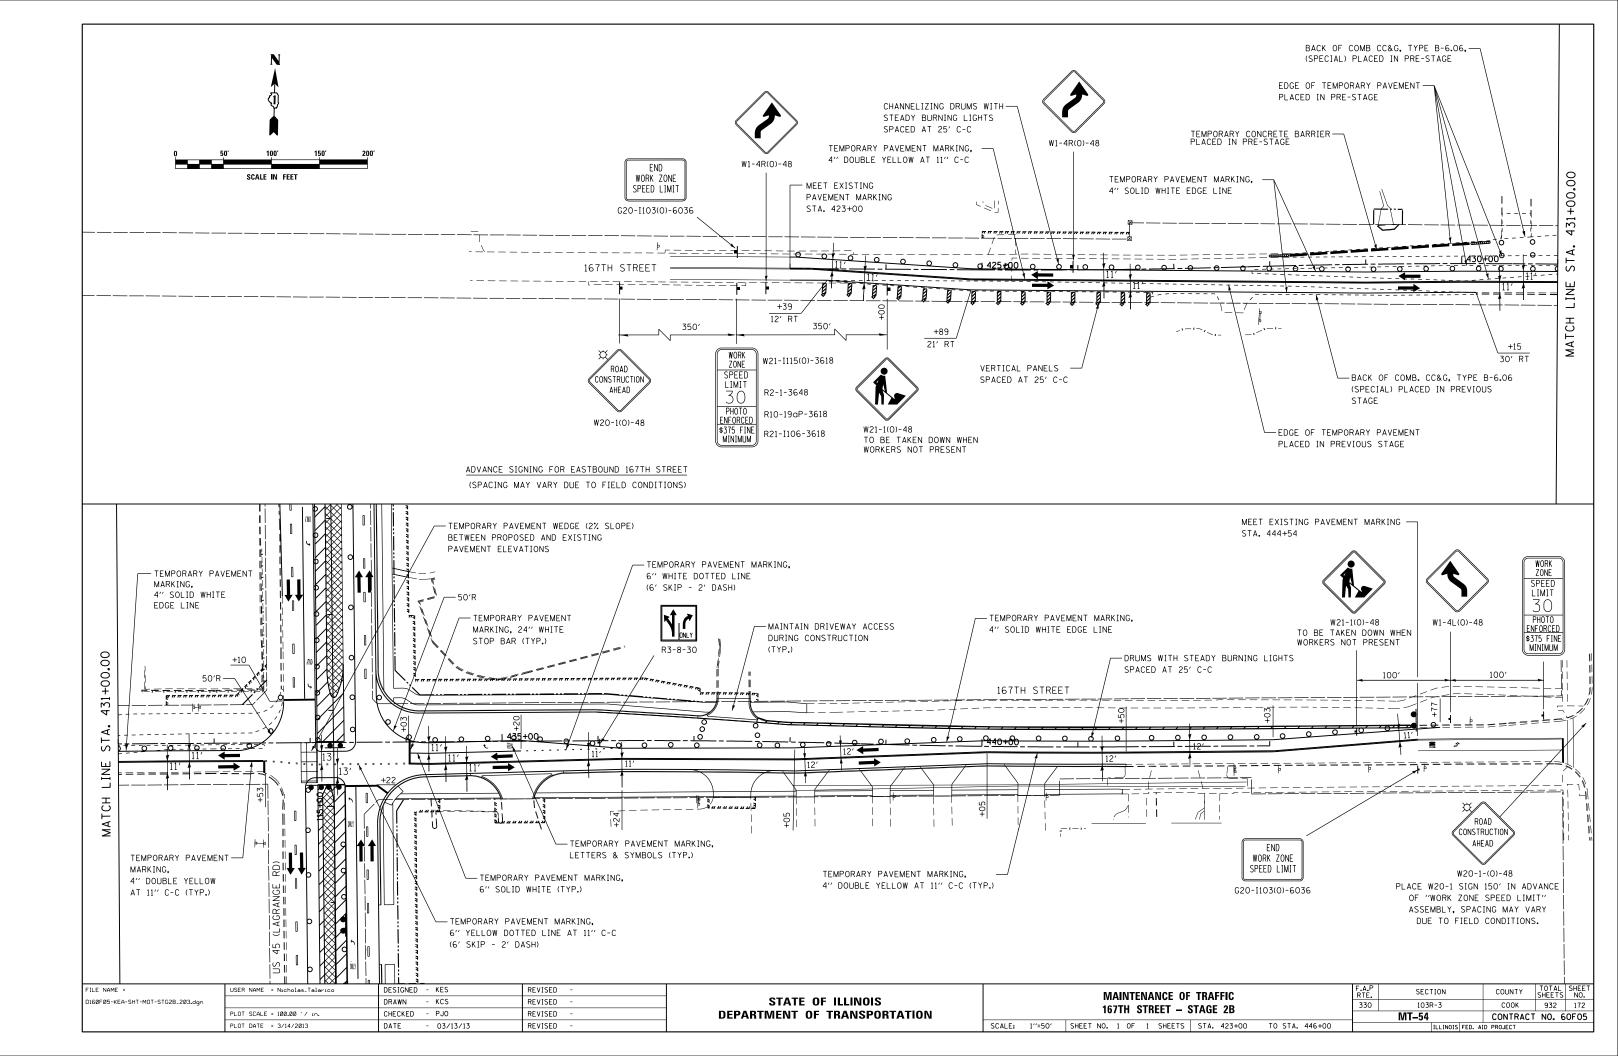
STAGE 2 CONFIGURATION ON 165TH STREET TO REMAIN IN PLACE FOR STAGE 2A.

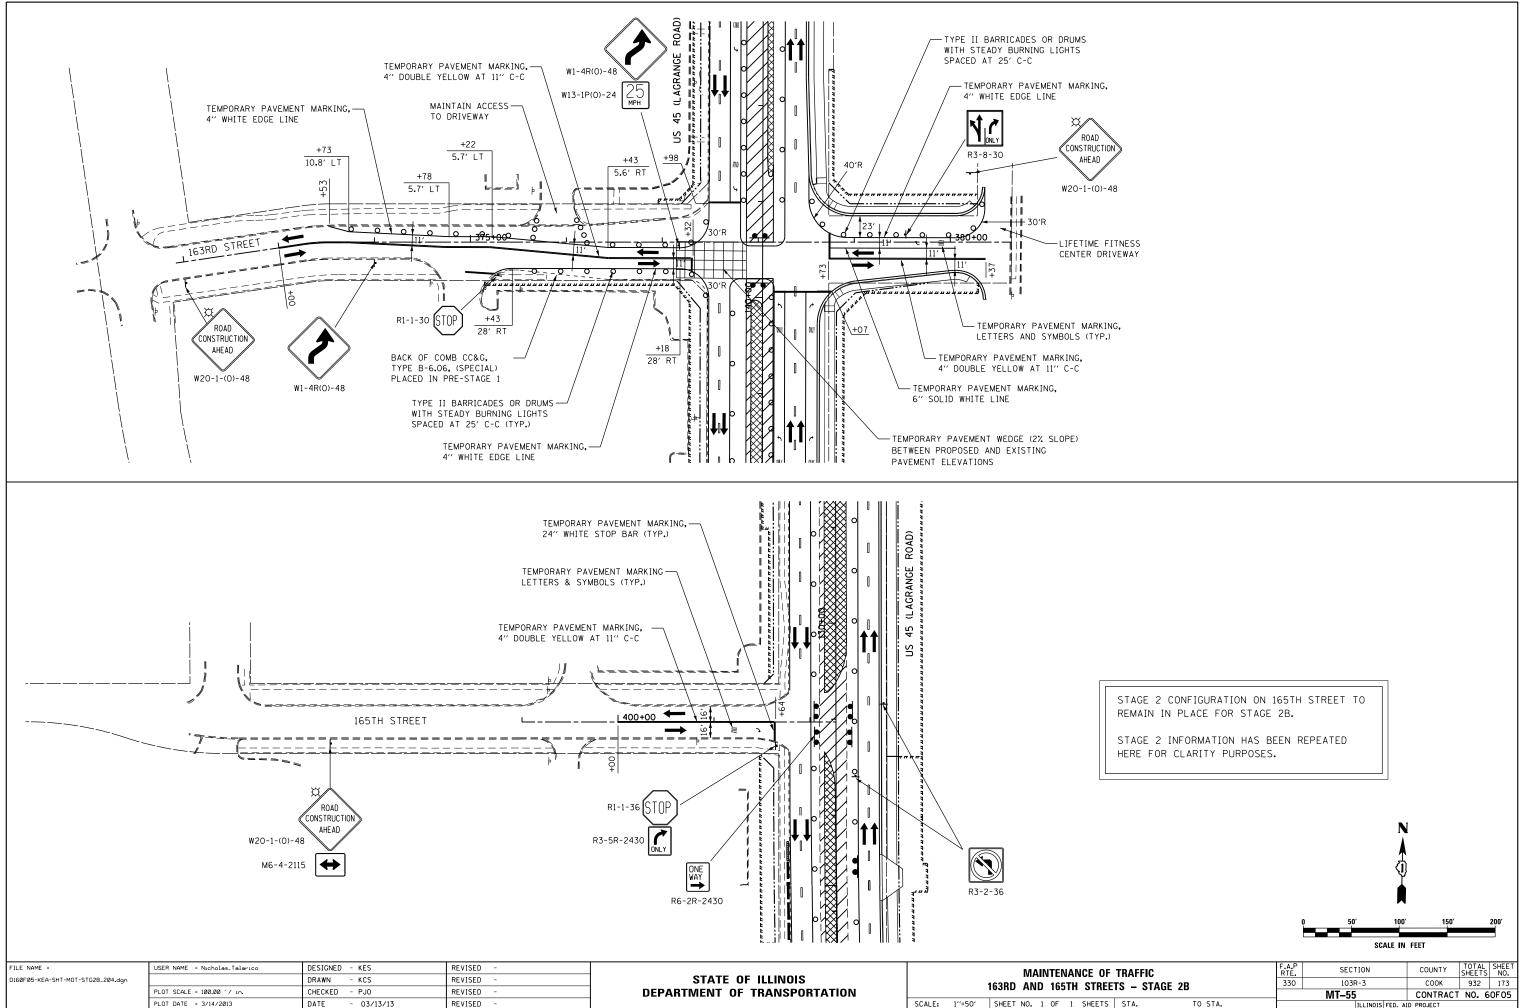
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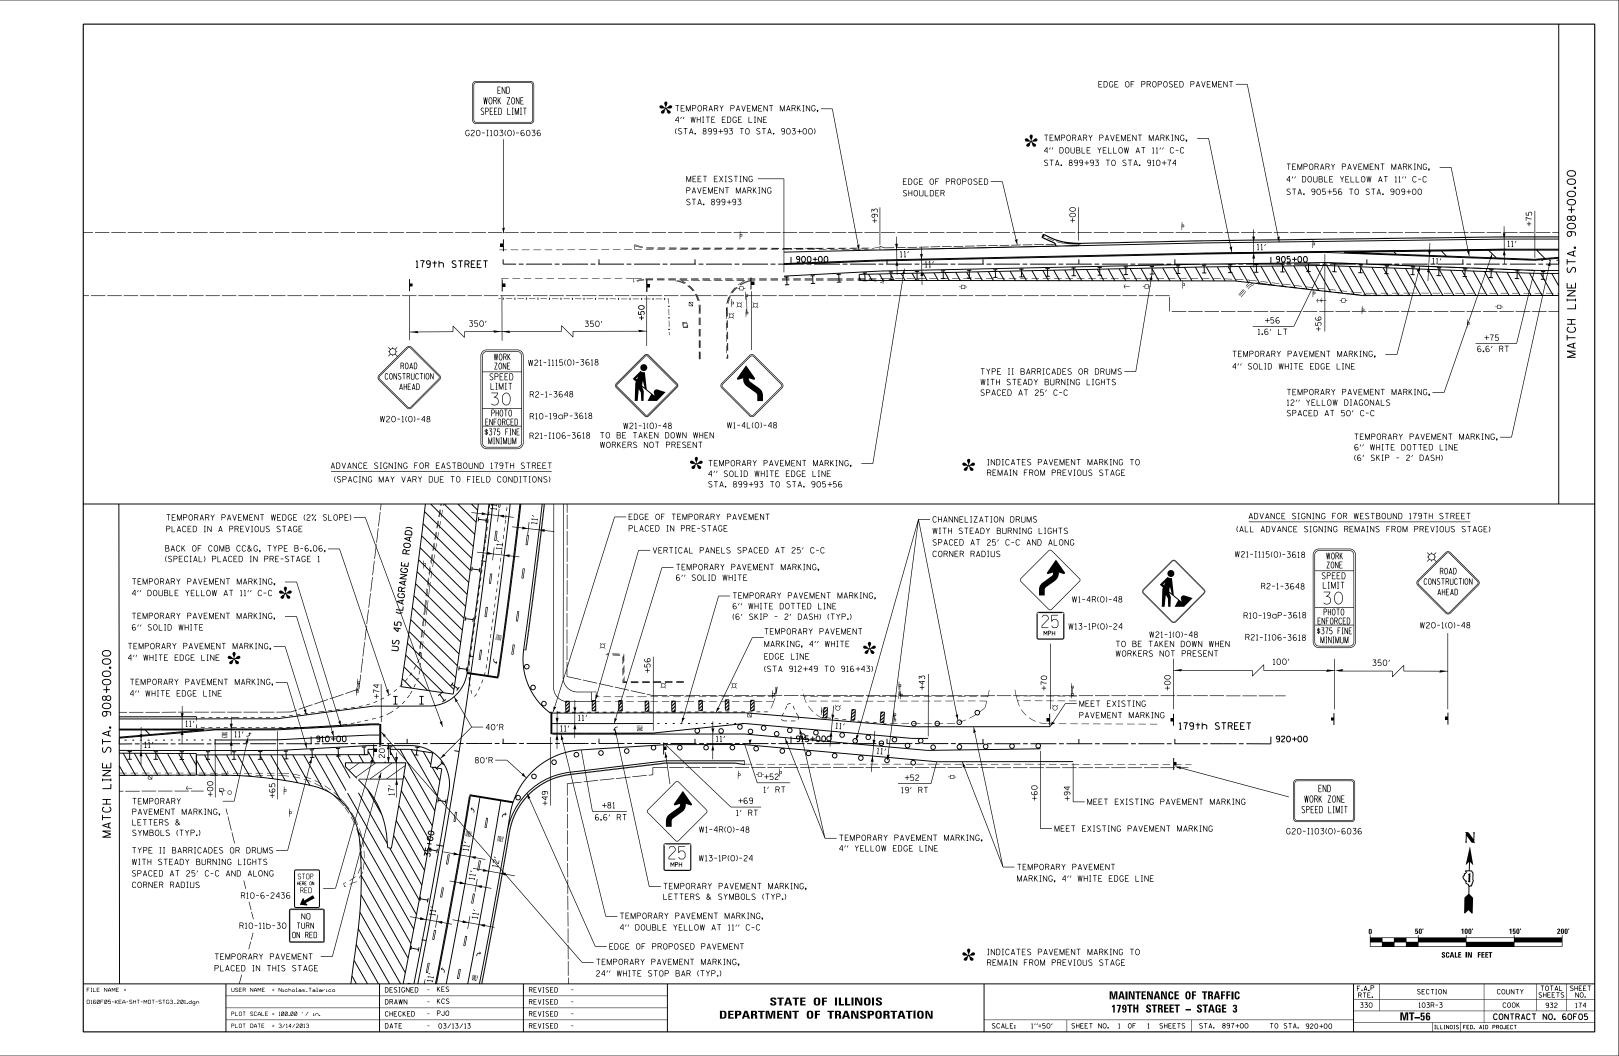



F	TRAFFIC		F.A.P RTE.	SECTION	COUNTY	TOTAL SHEETS	SHEET NO.		
ETS – STAGE 2A		330	330 103R-3 COOK						
_	LIS - STAGE ZA			MT-52 CONTRACT NO. 60FC					
5	STA.	TO STA.		ILLINOIS FED. A	ID PROJECT				












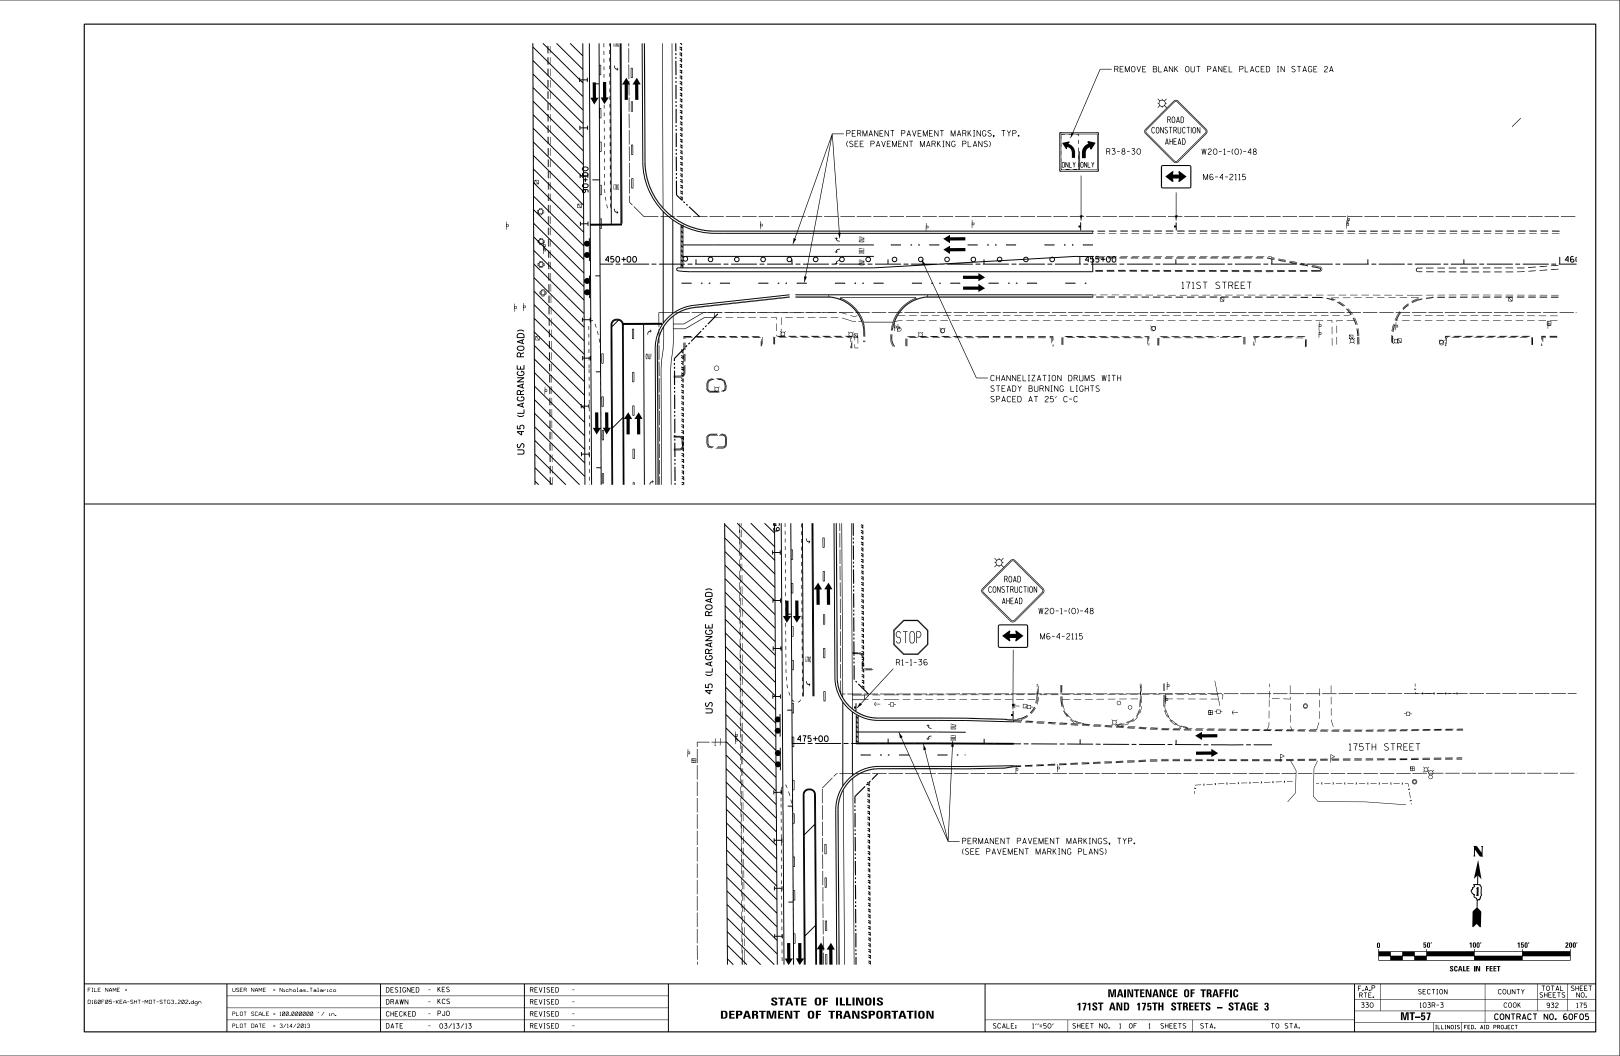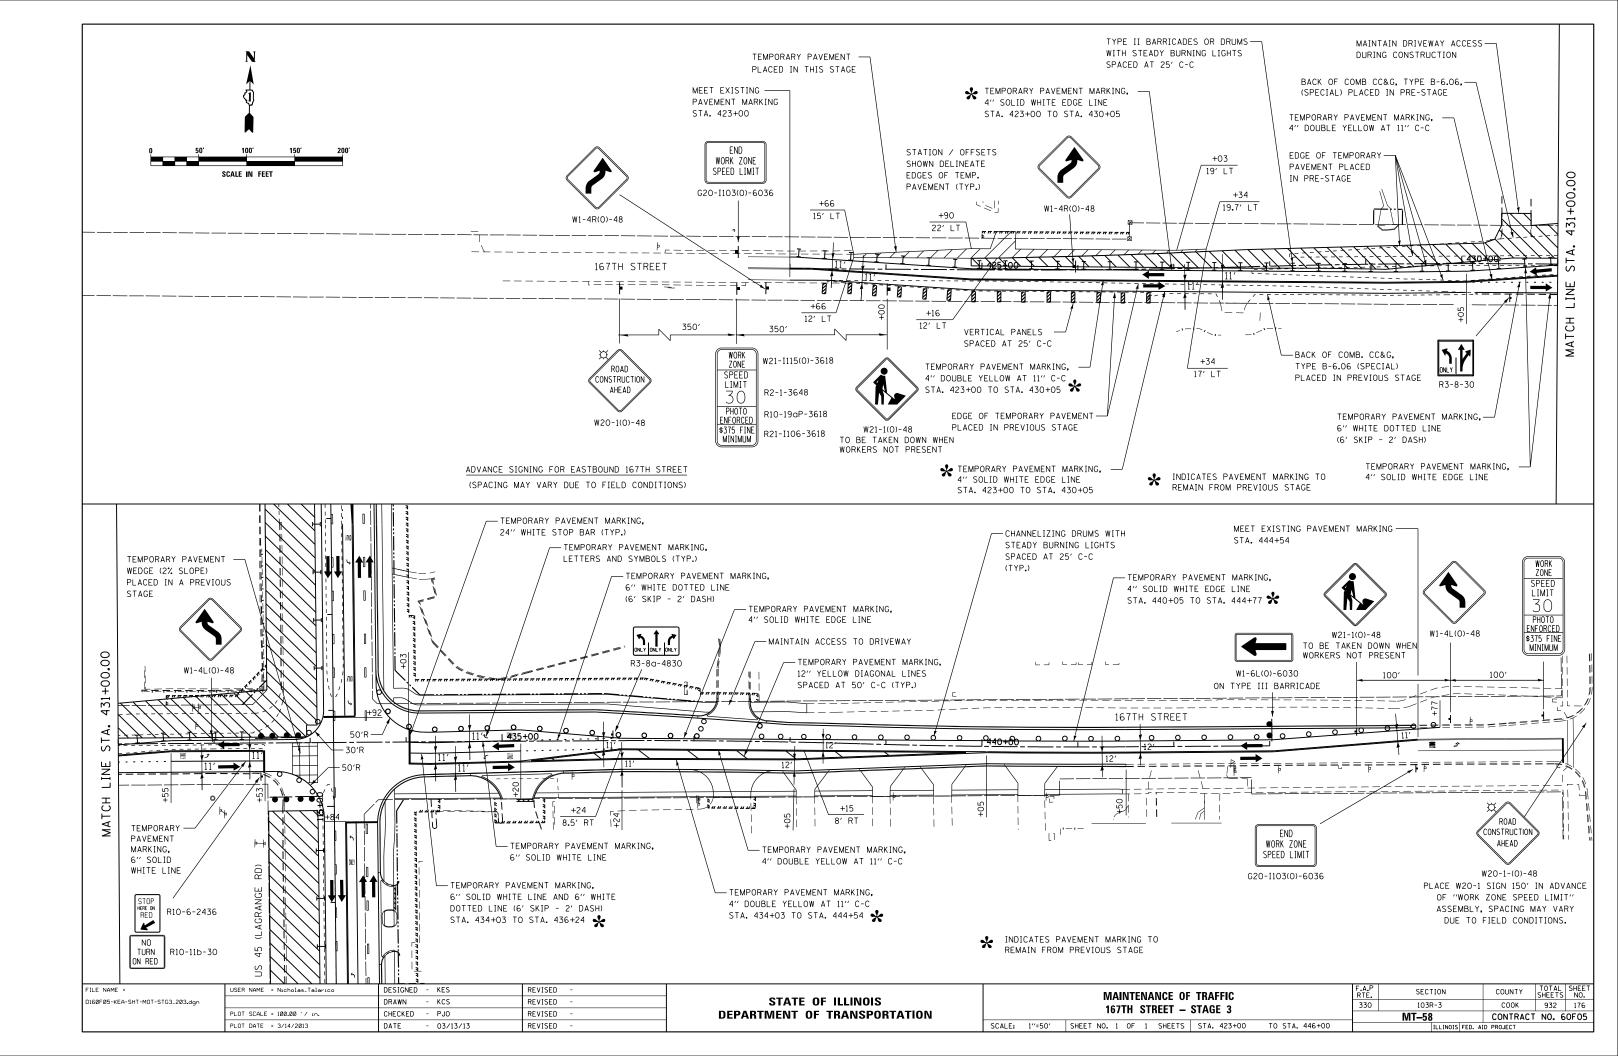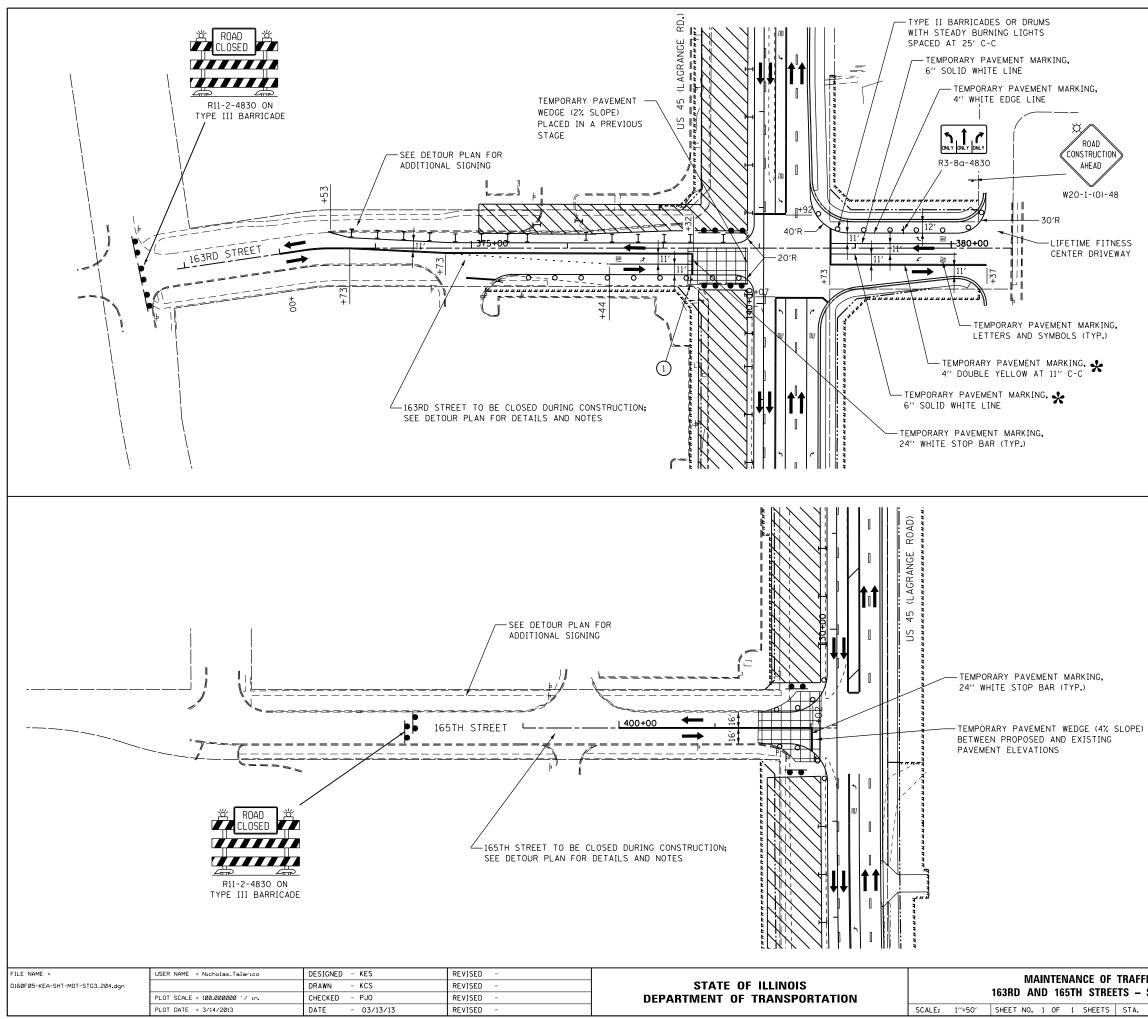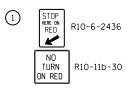

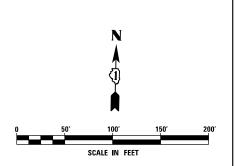




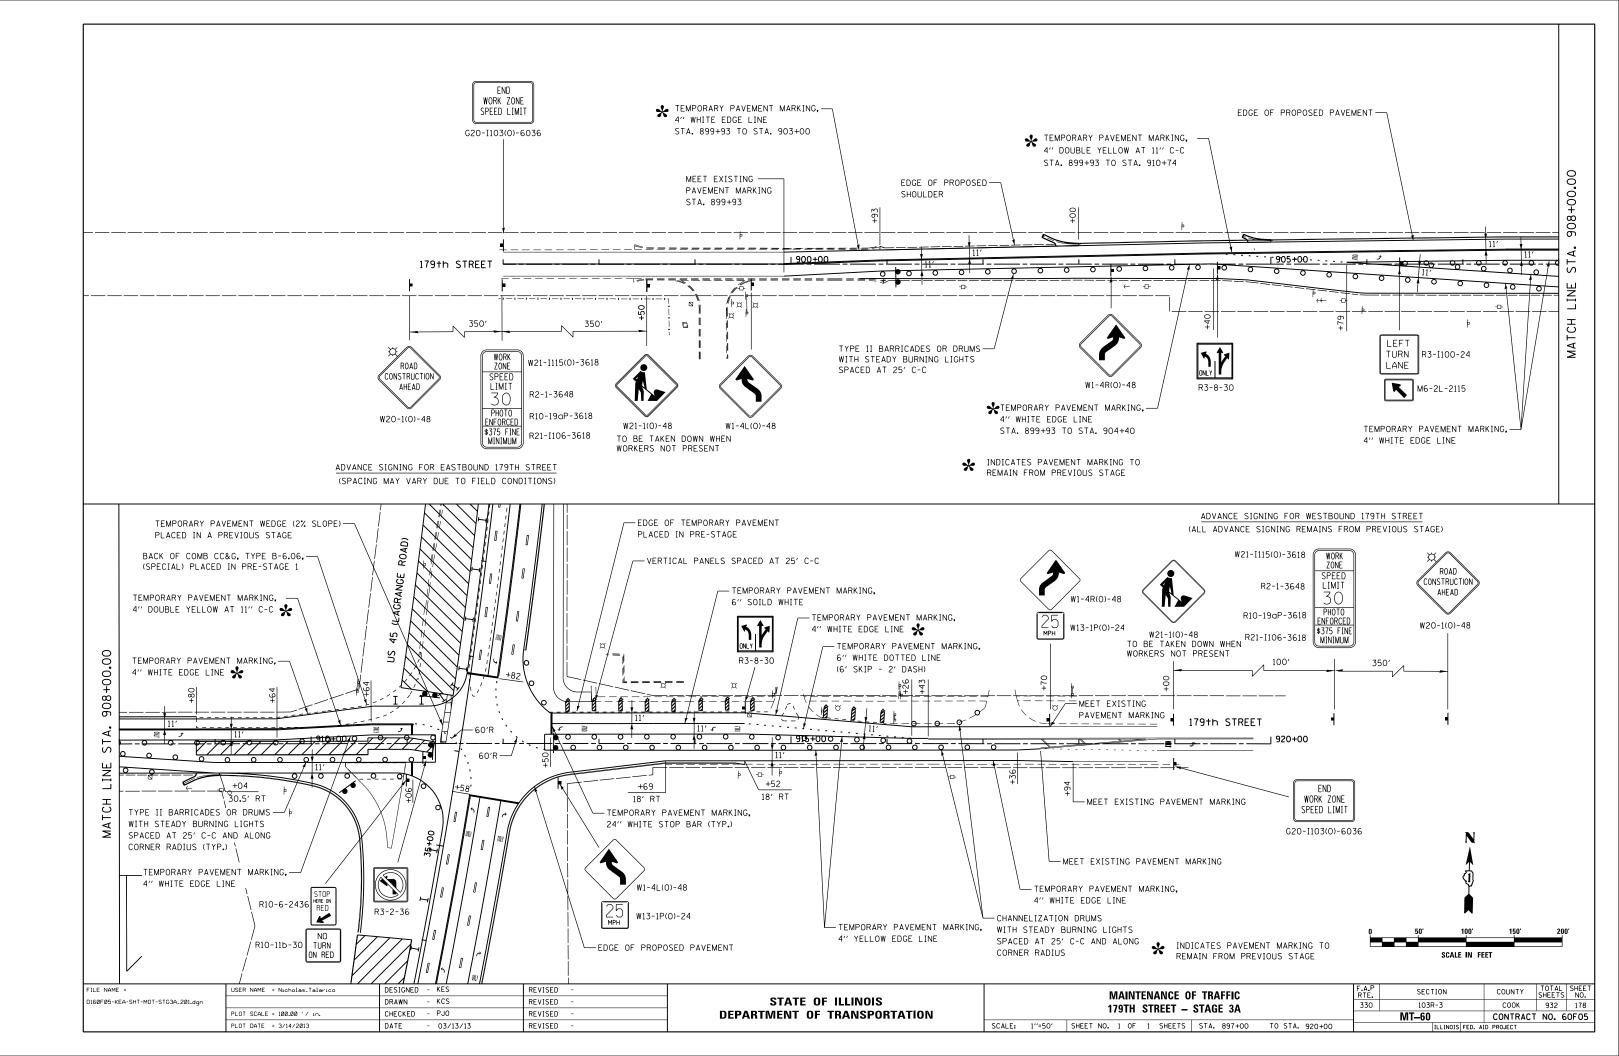


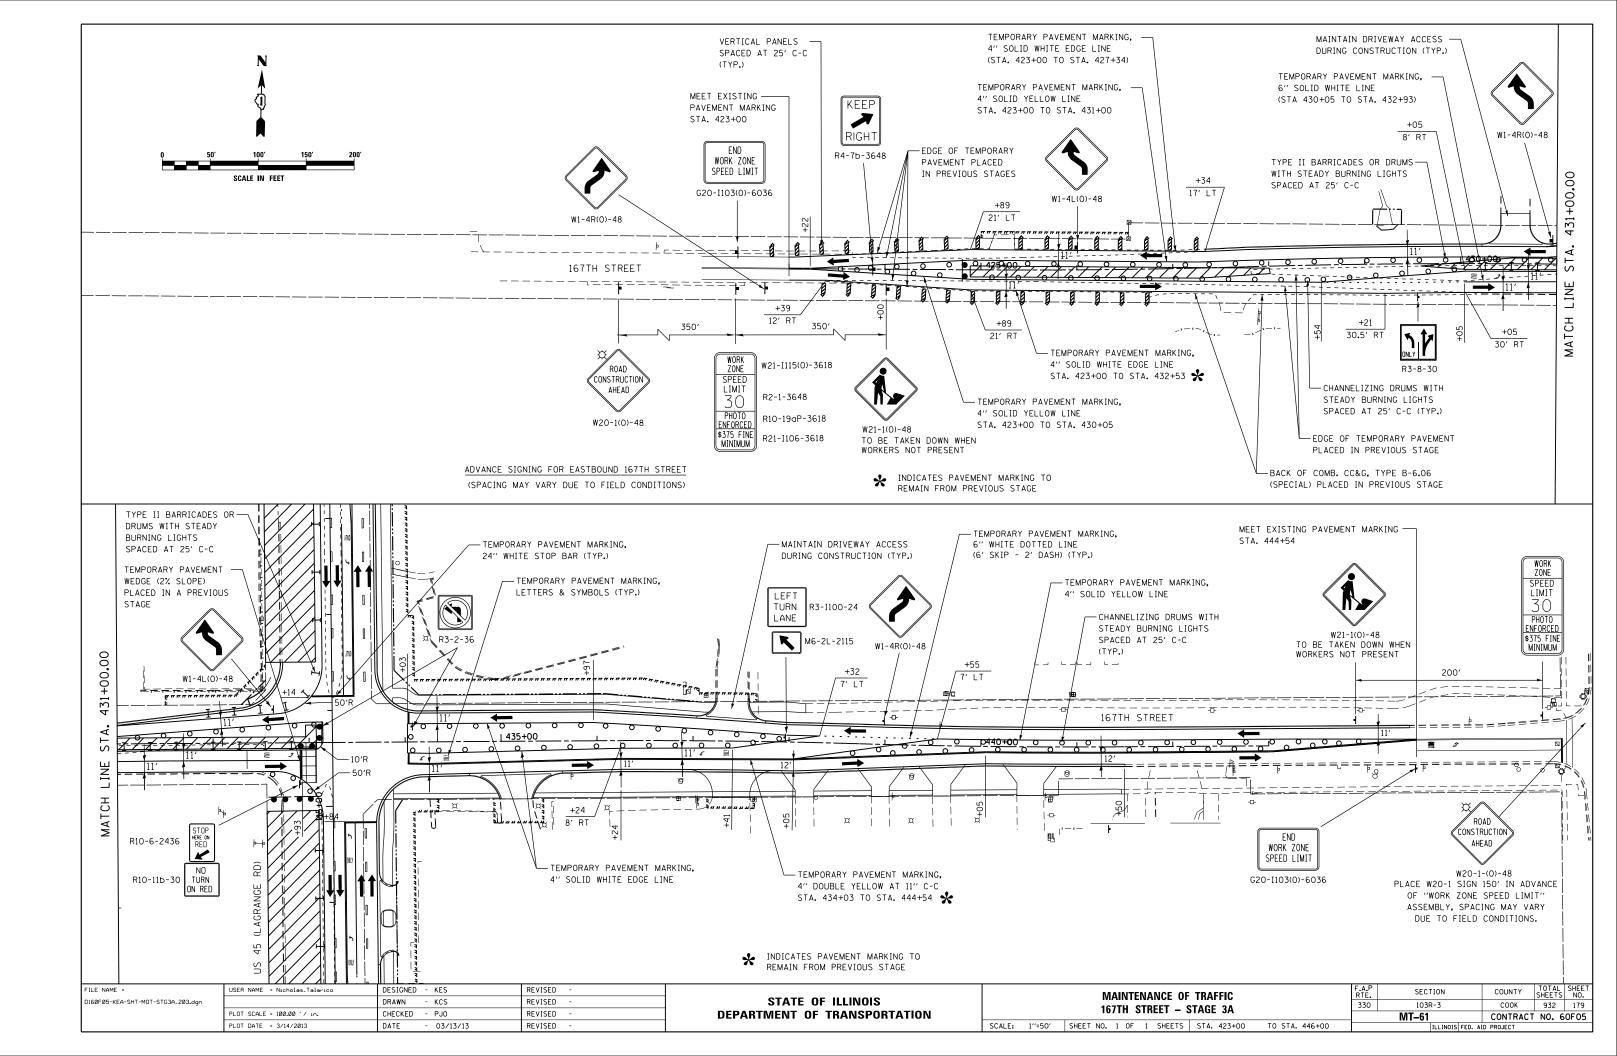
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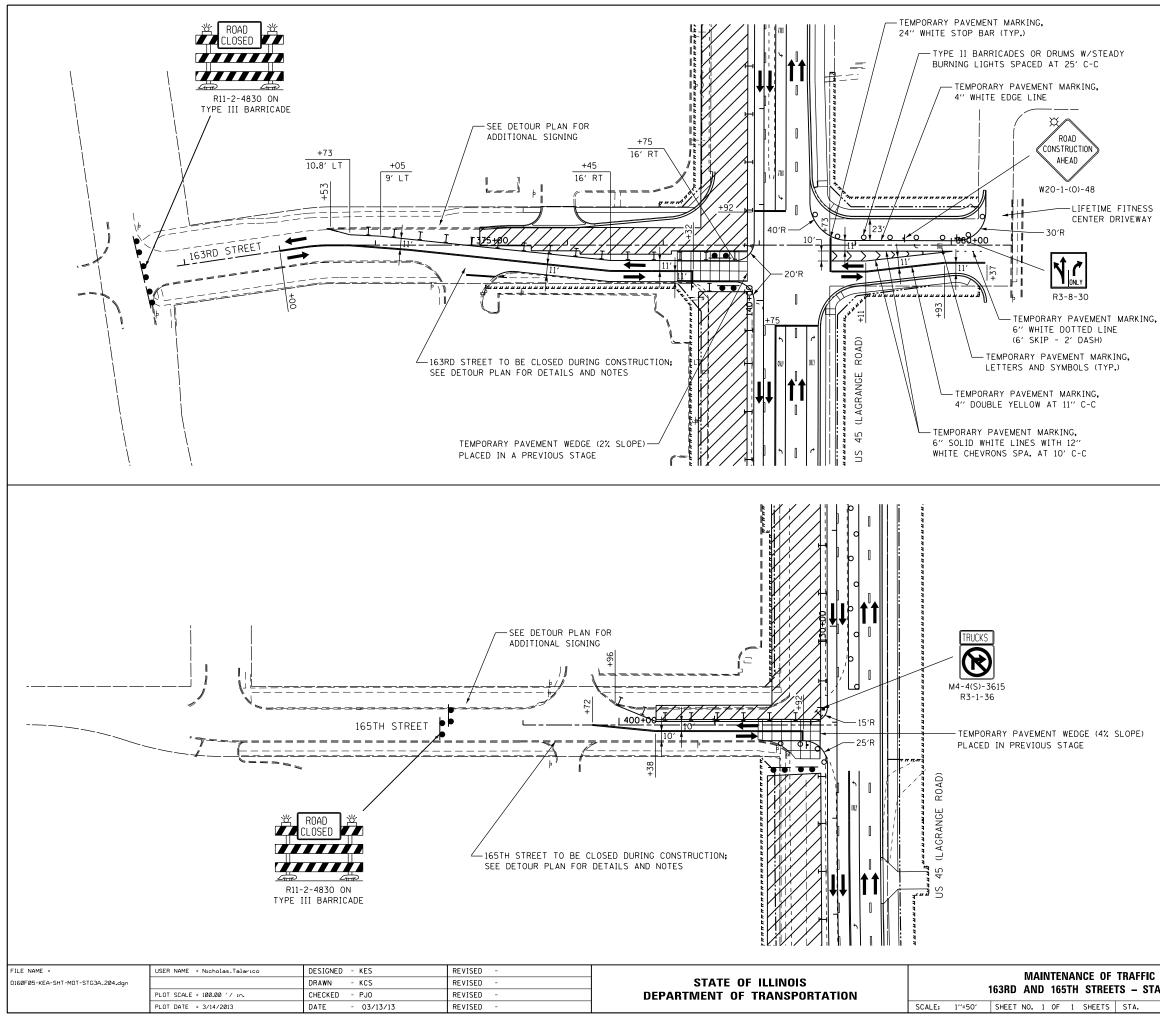
\* INDICATES PAVEMENT MARKING TO REMAIN FROM PREVIOUS STAGE




F TRAFFIC		F.A.P RTE.	SECTION	COUNTY TOTA		SHEET NO.		
FF	EETS – STAGE 3		330	103R-3	СООК	COOK 932		
_				MT-59 CONTRACT NO. 60				
5	STA.	TO STA.		ILLINOIS FED. AID PROJECT				










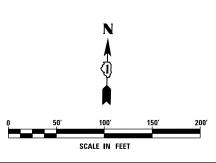


F TRAFFIC		F.A.P RTE.	SECTION	COUNTY	TOTAL SHEETS	SHEET NO.		
F	ETS – STAGE 3A		330	103R-3	COOK 932		180	
_	EIS - STAGE SA			MT-62	CONTRACT NO. 60F05			
;	STA.	TO STA.		ILLINOIS FED. AID PROJECT				

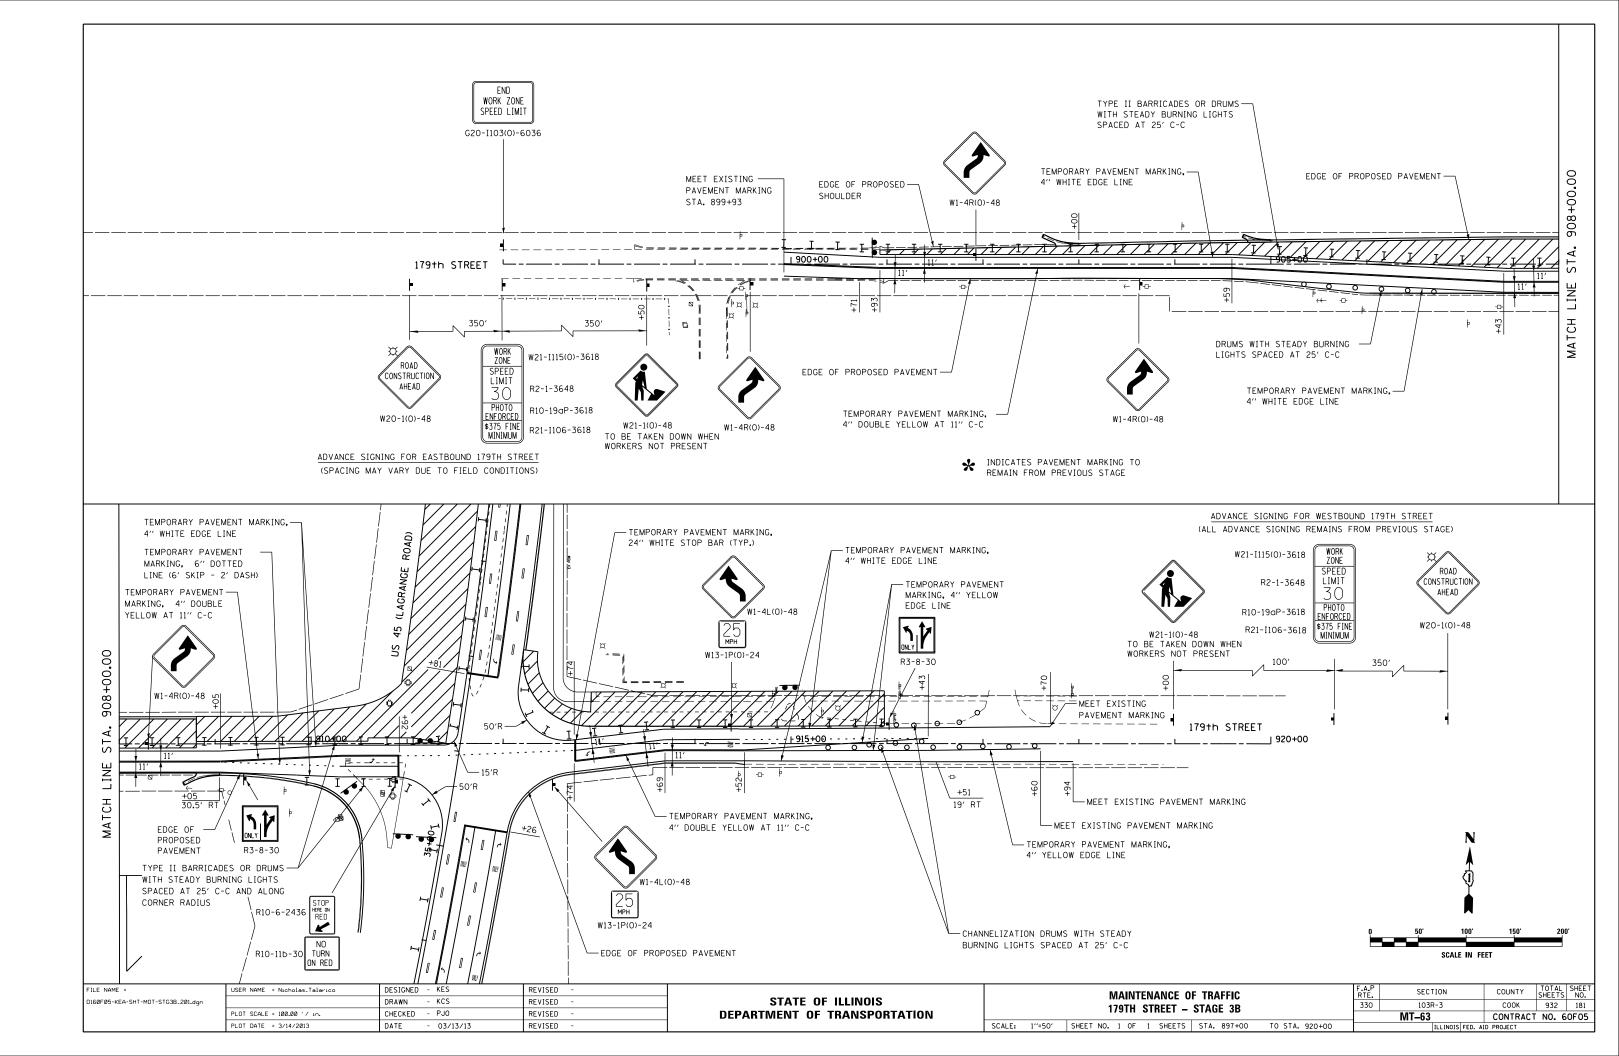


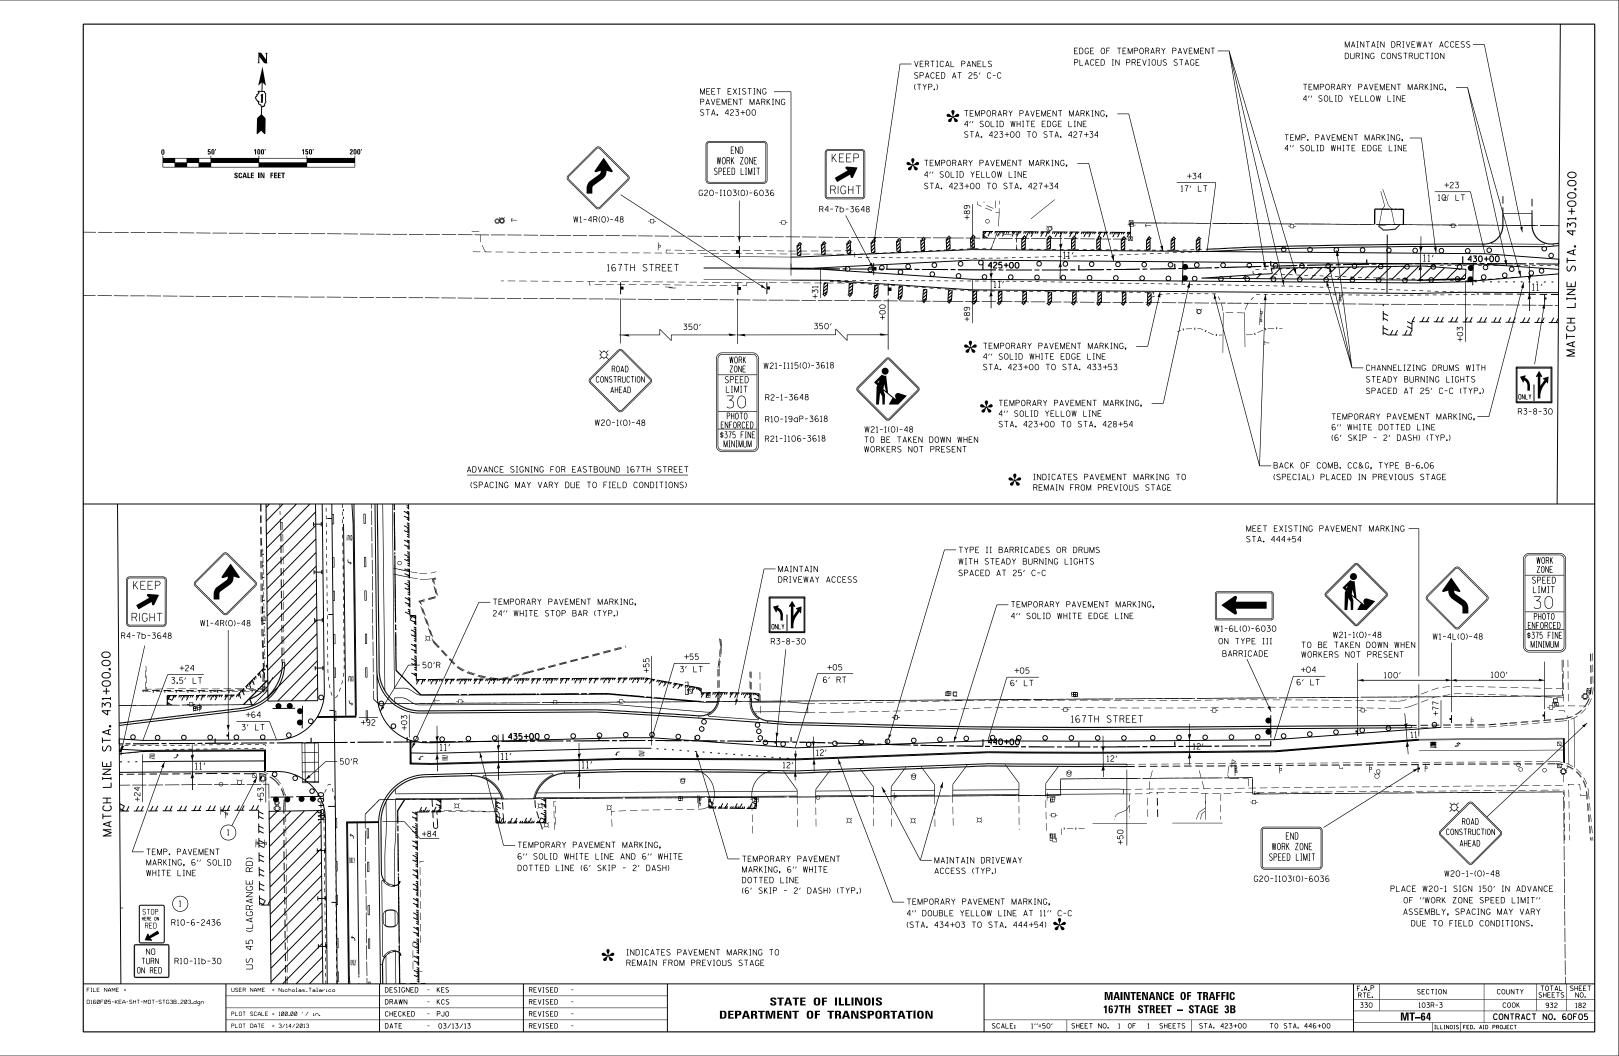


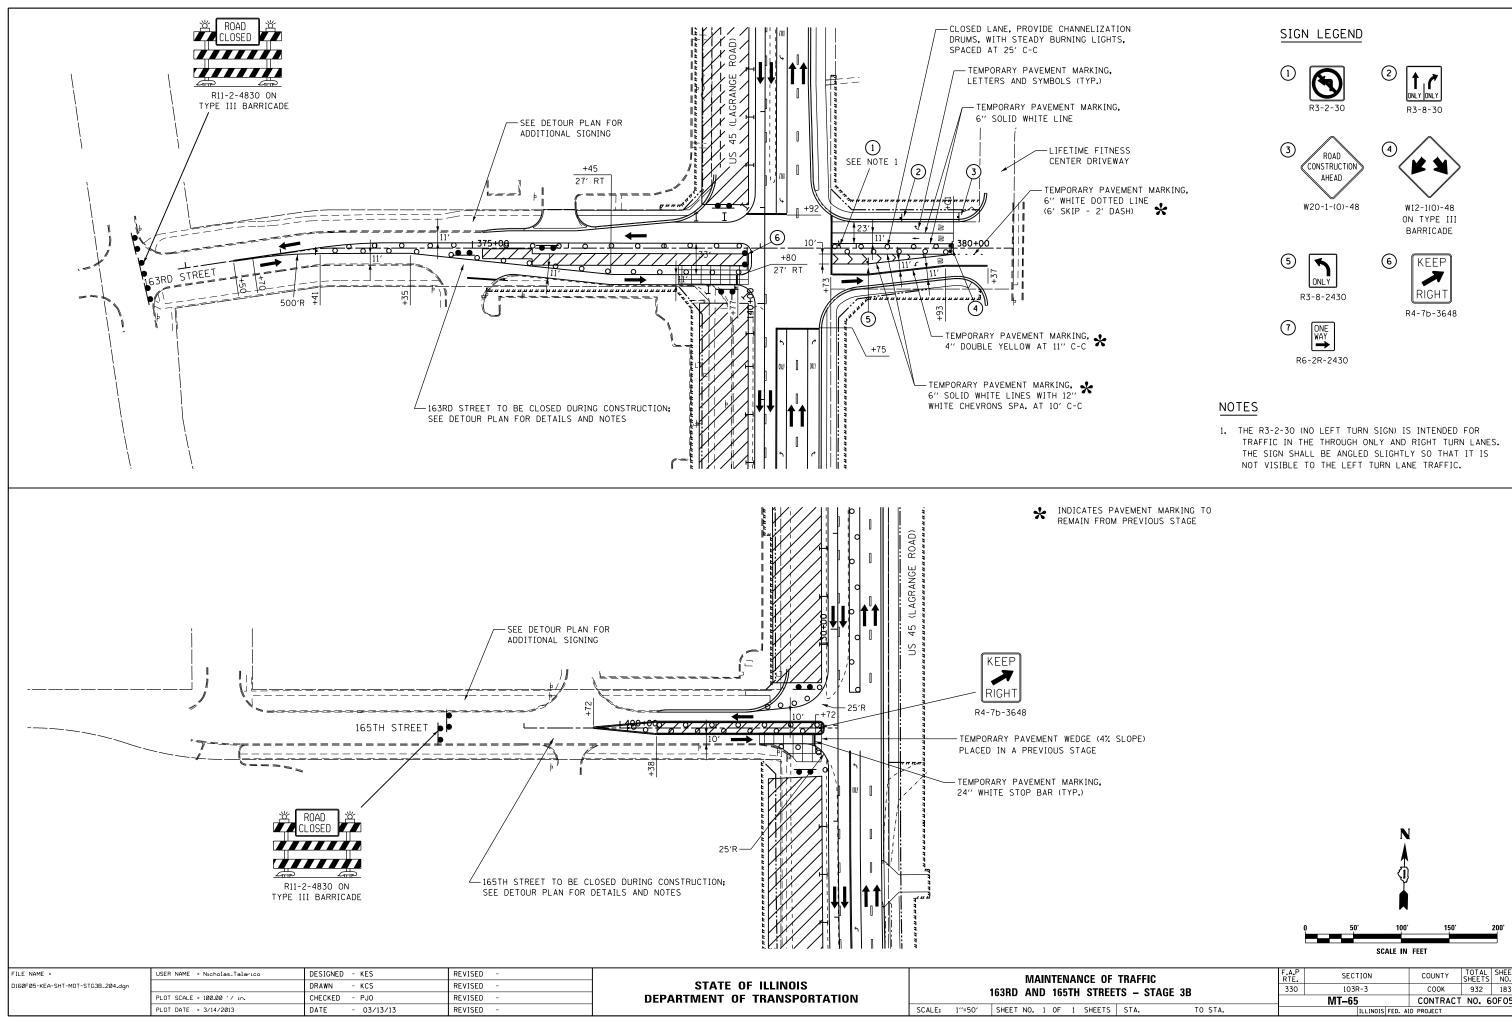

F TRAFFIC ETS – STAGE 3B		SECTION	COUNTY	TOTAL SHEETS	SHEET NO.		
		103R-3	СООК 932		183		
		MT-65	CONTRACT NO. 60F05				
STA. TO STA.		ILLINOIS FED. AID PROJECT					

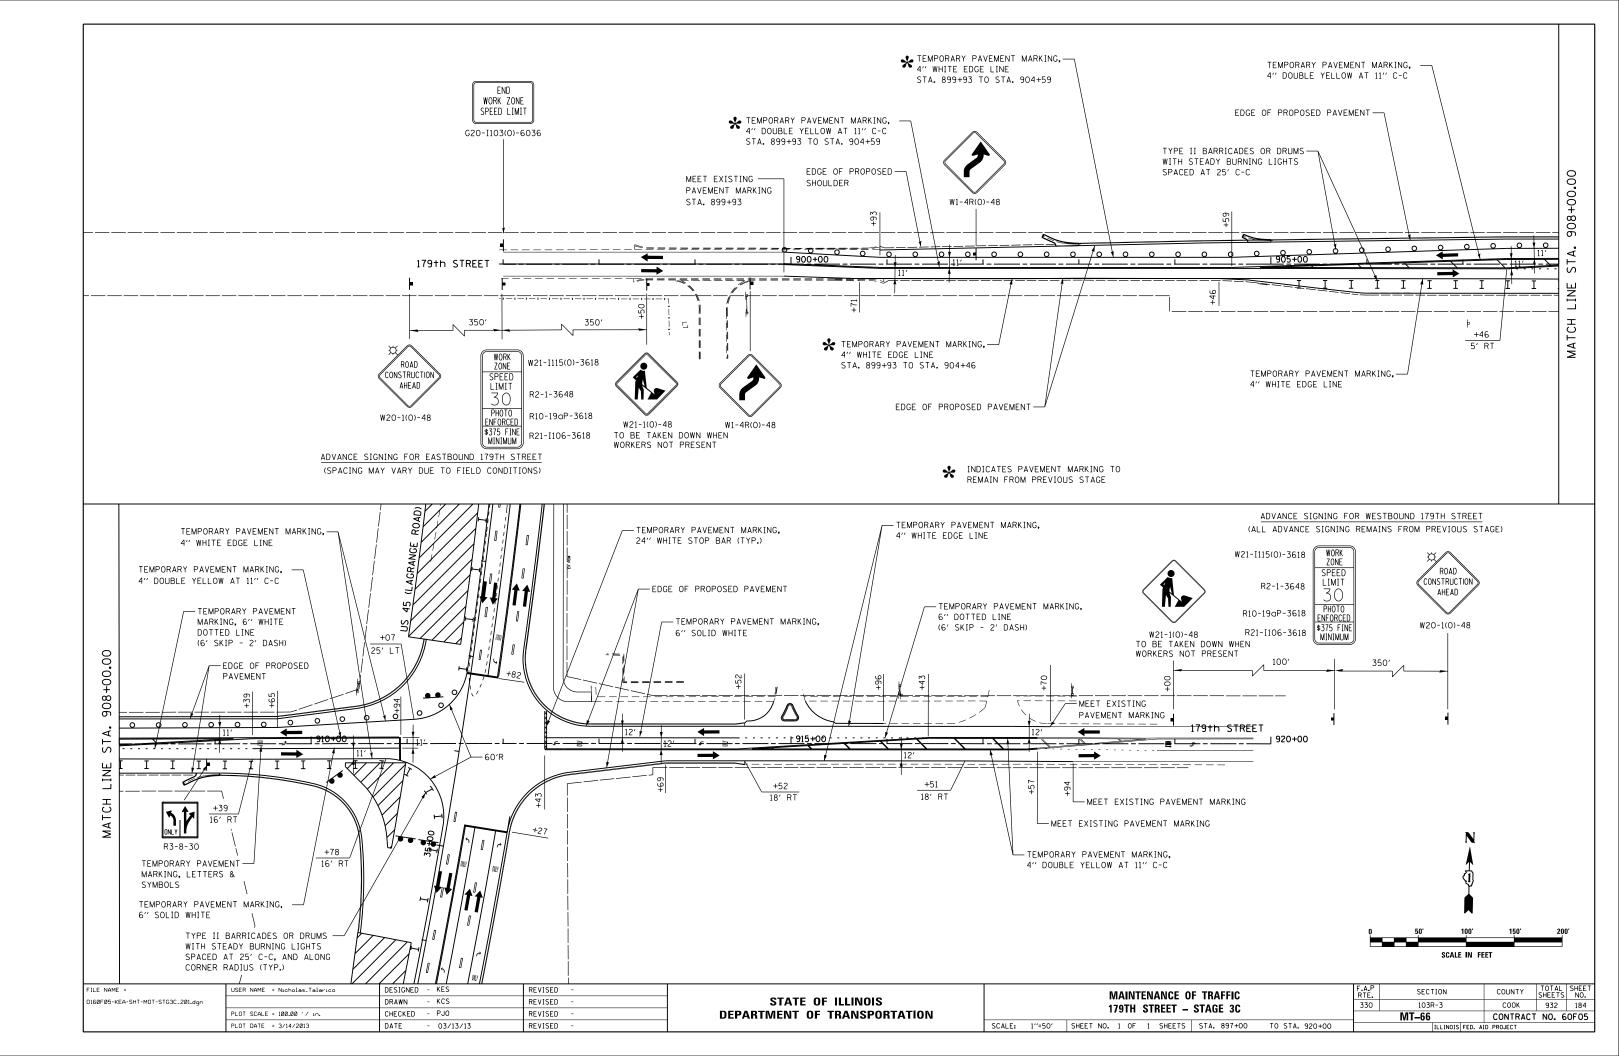


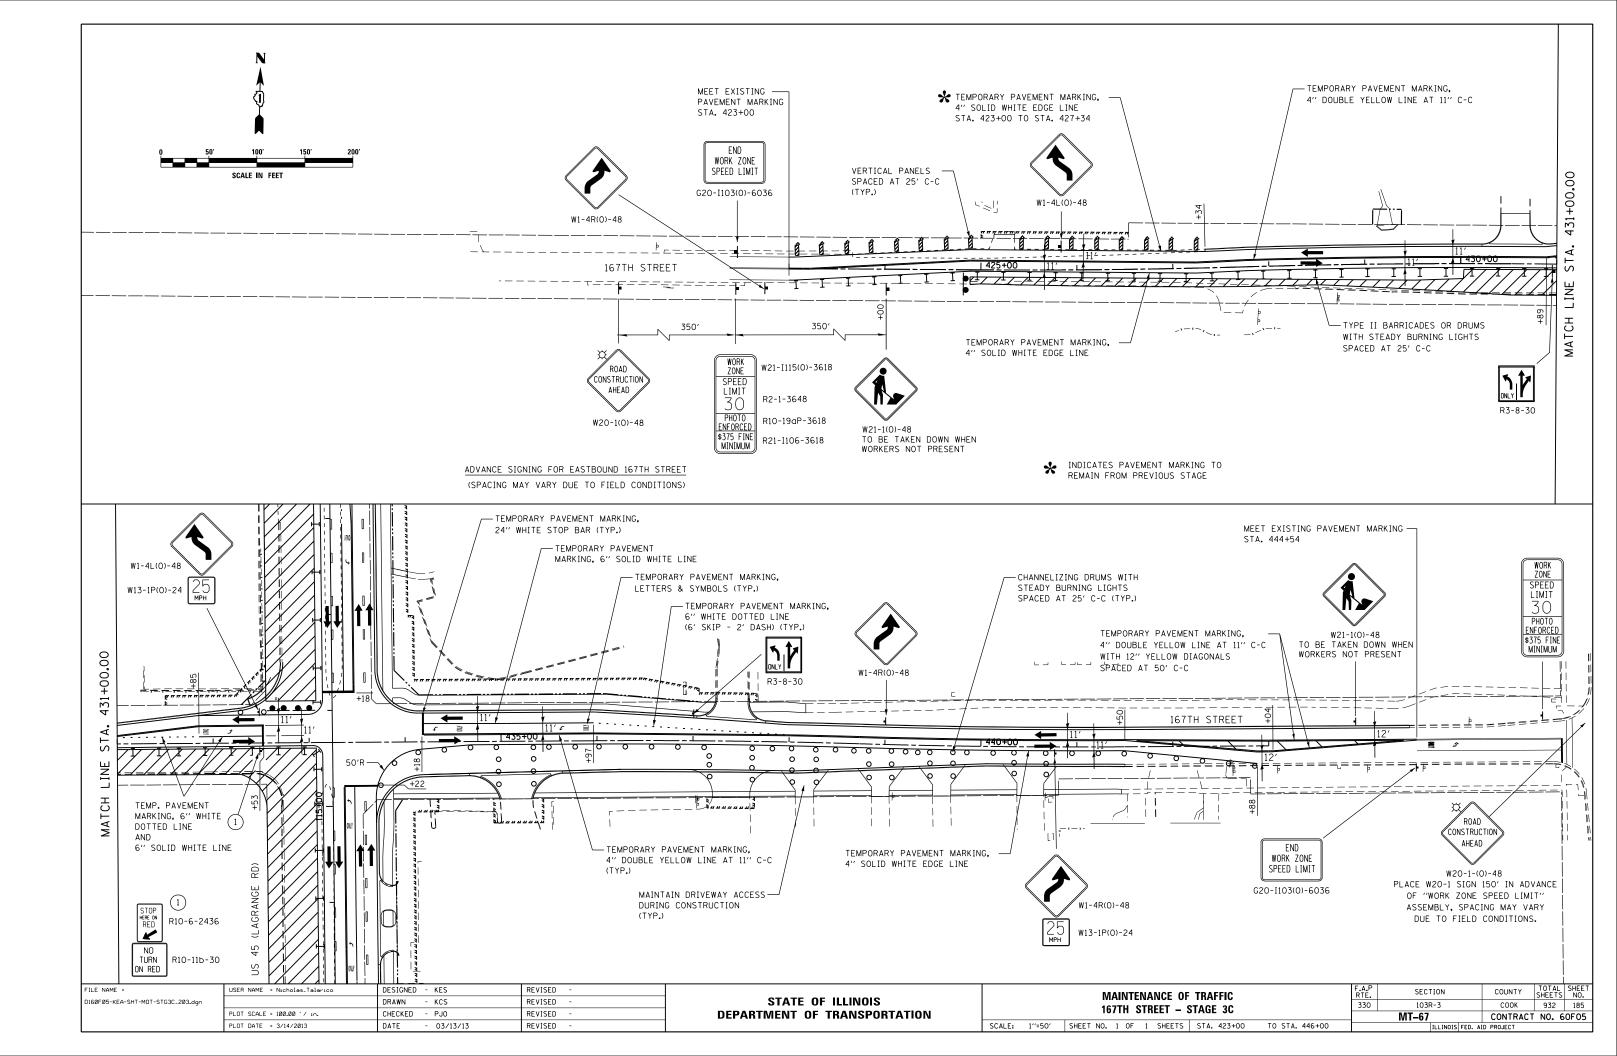

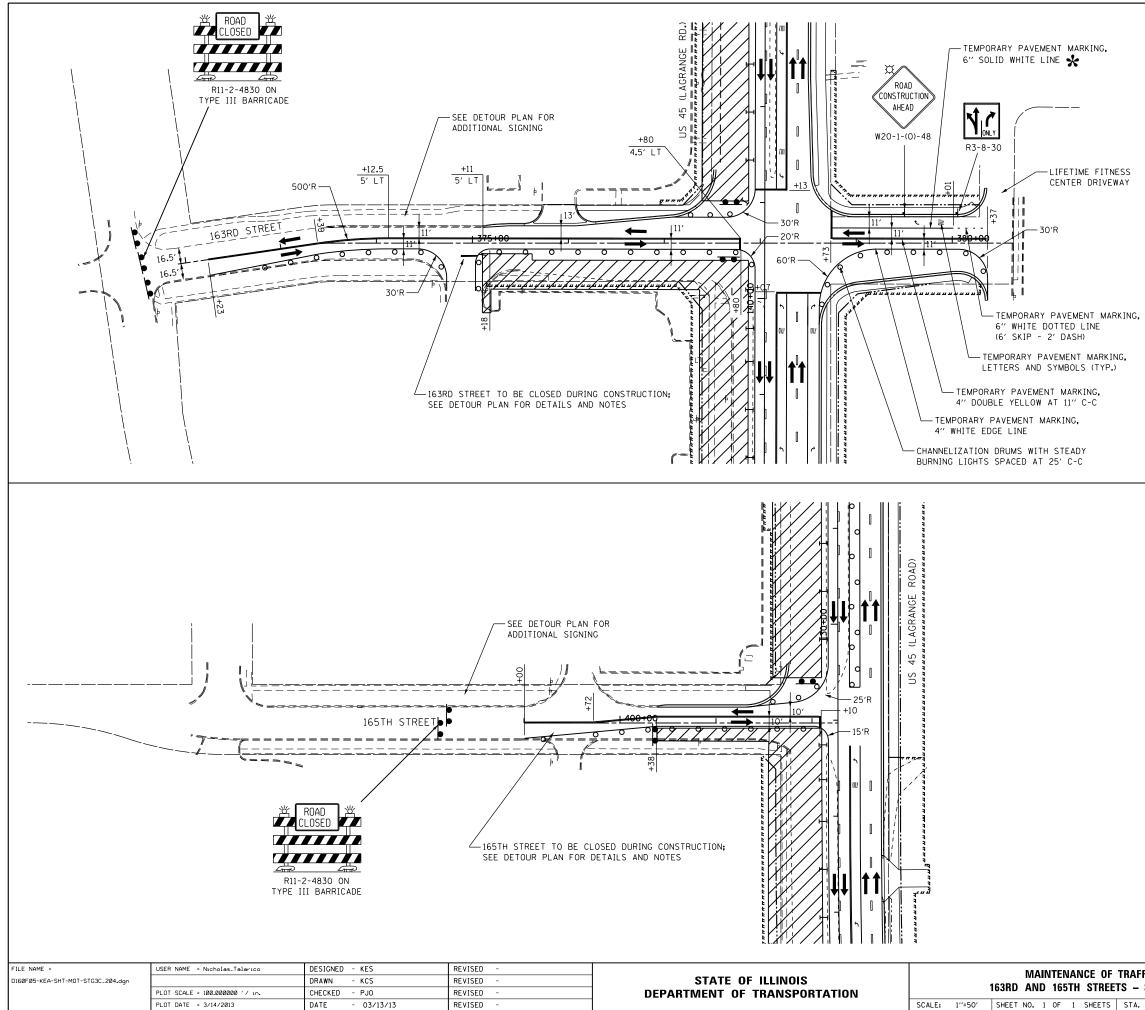





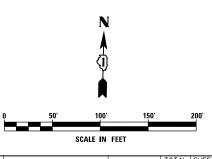
✤ INDICATES PAVEMENT MARKING TO REMAIN FROM PREVIOUS STAGE





F TRAFFIC Eets – stage 3C		SECTION 103R-3			COUNTY TOTAL SHEETS		SHEET NO.		
					COOK	932	186		
		MT-68			CONTRACT NO. 60F05				
STA. TO STA.		ILLINOIS FED. A			D PROJECT				

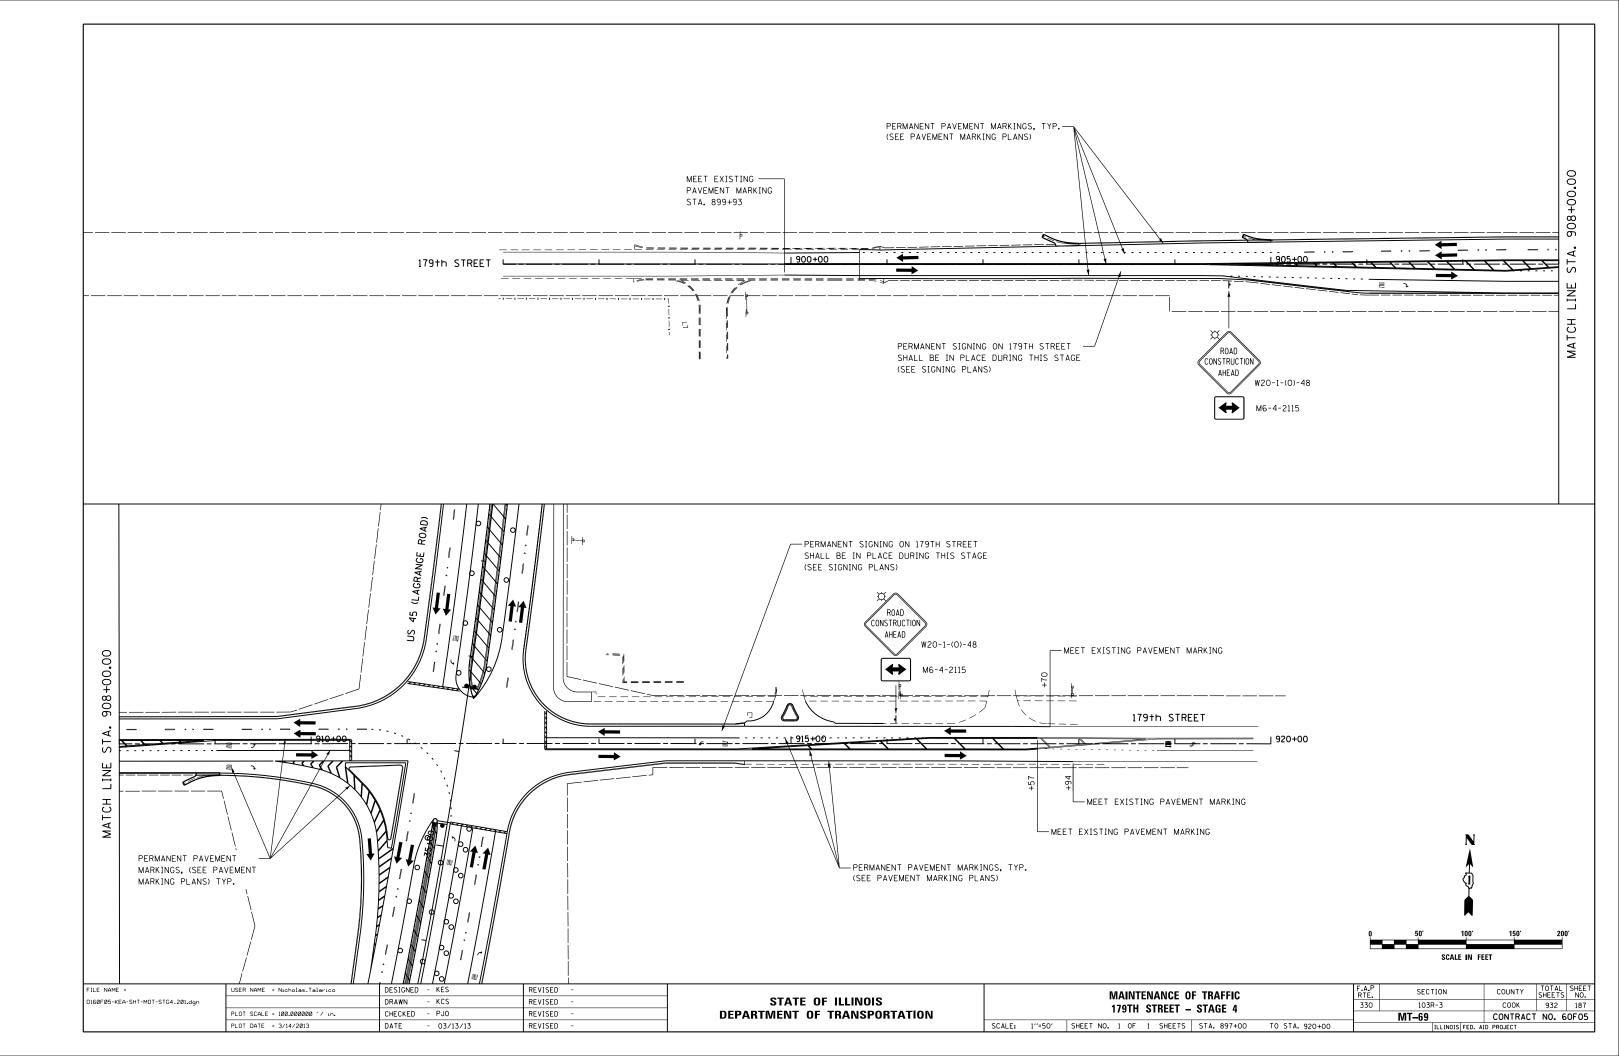

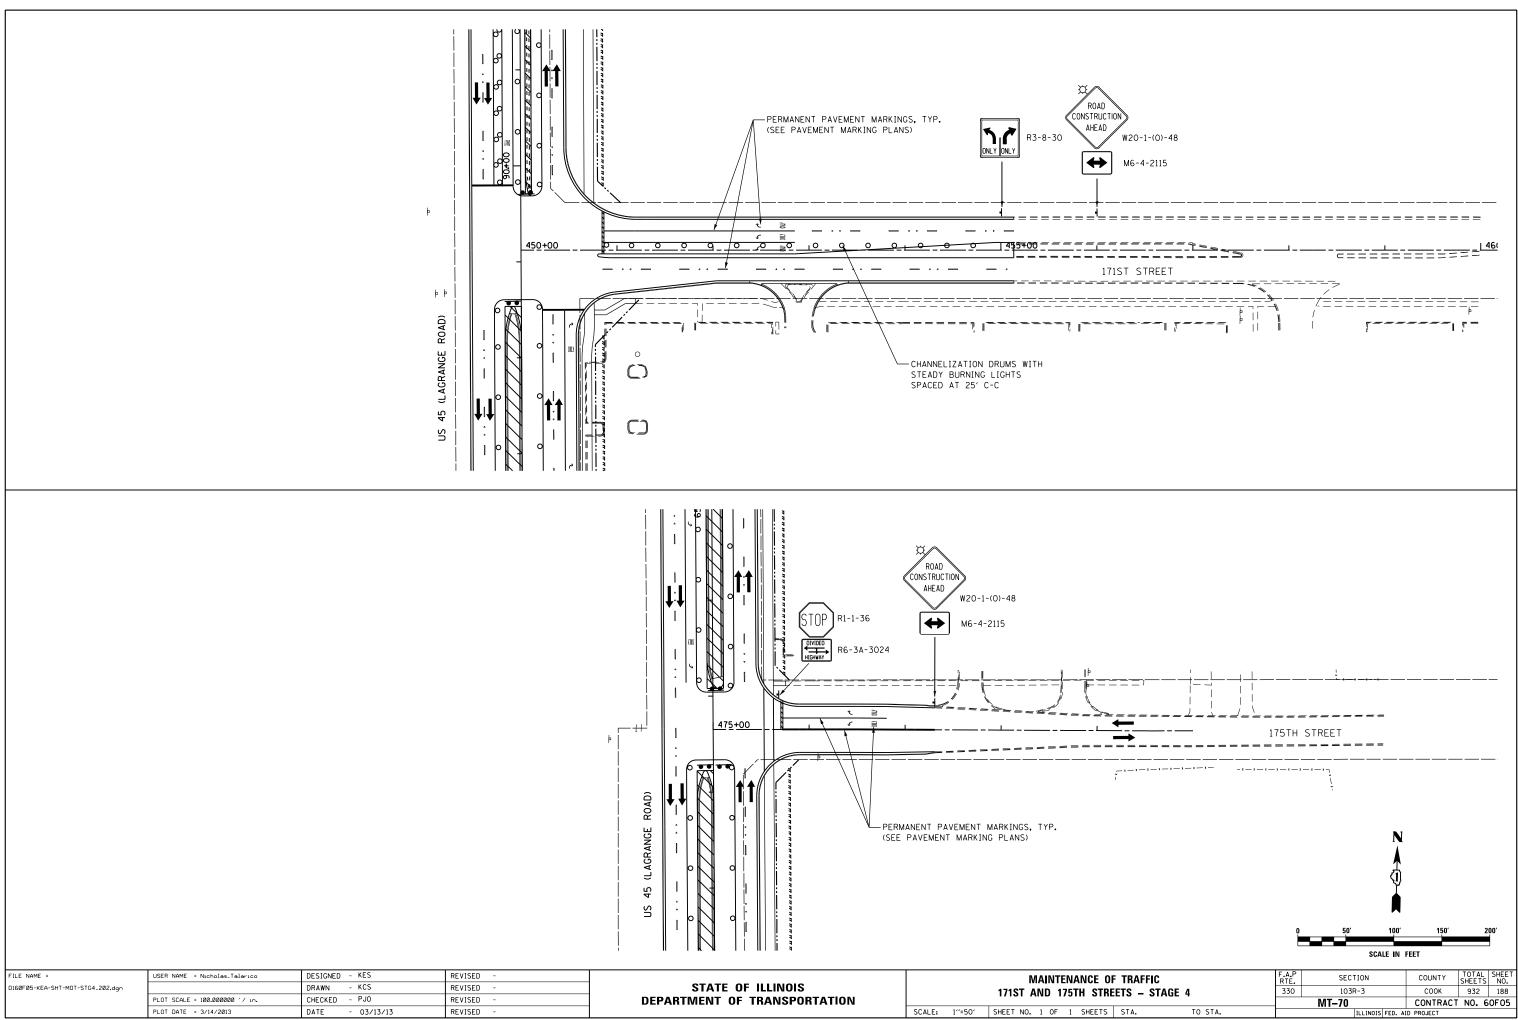

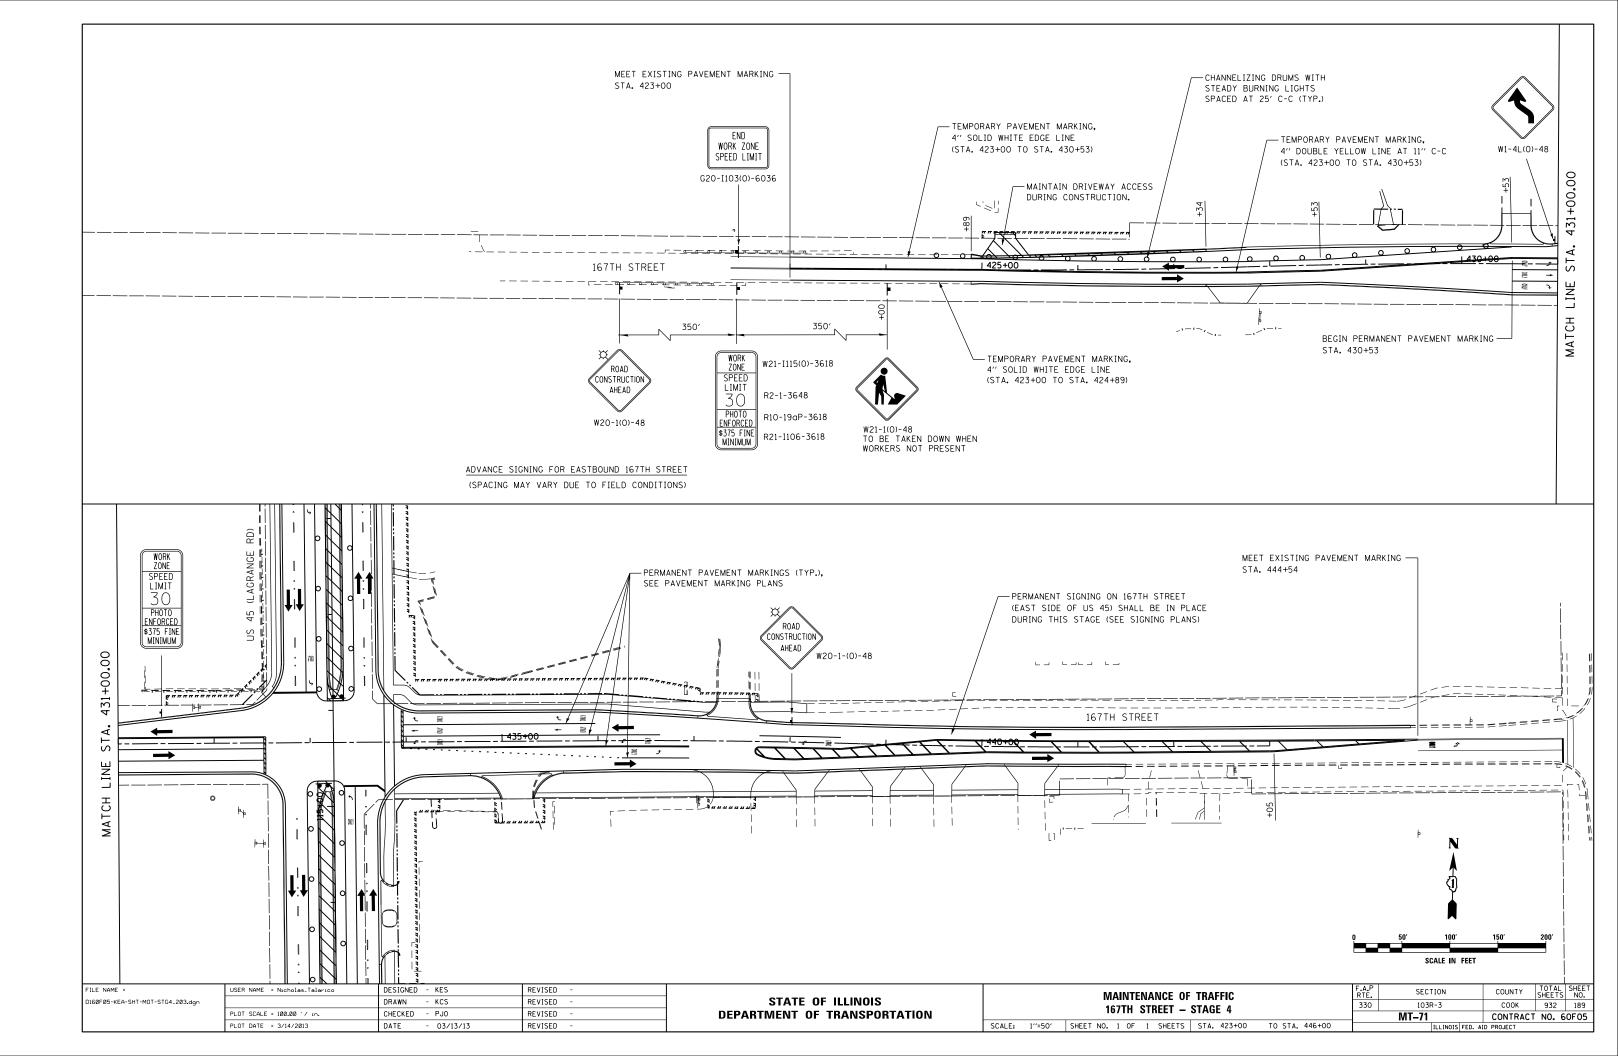

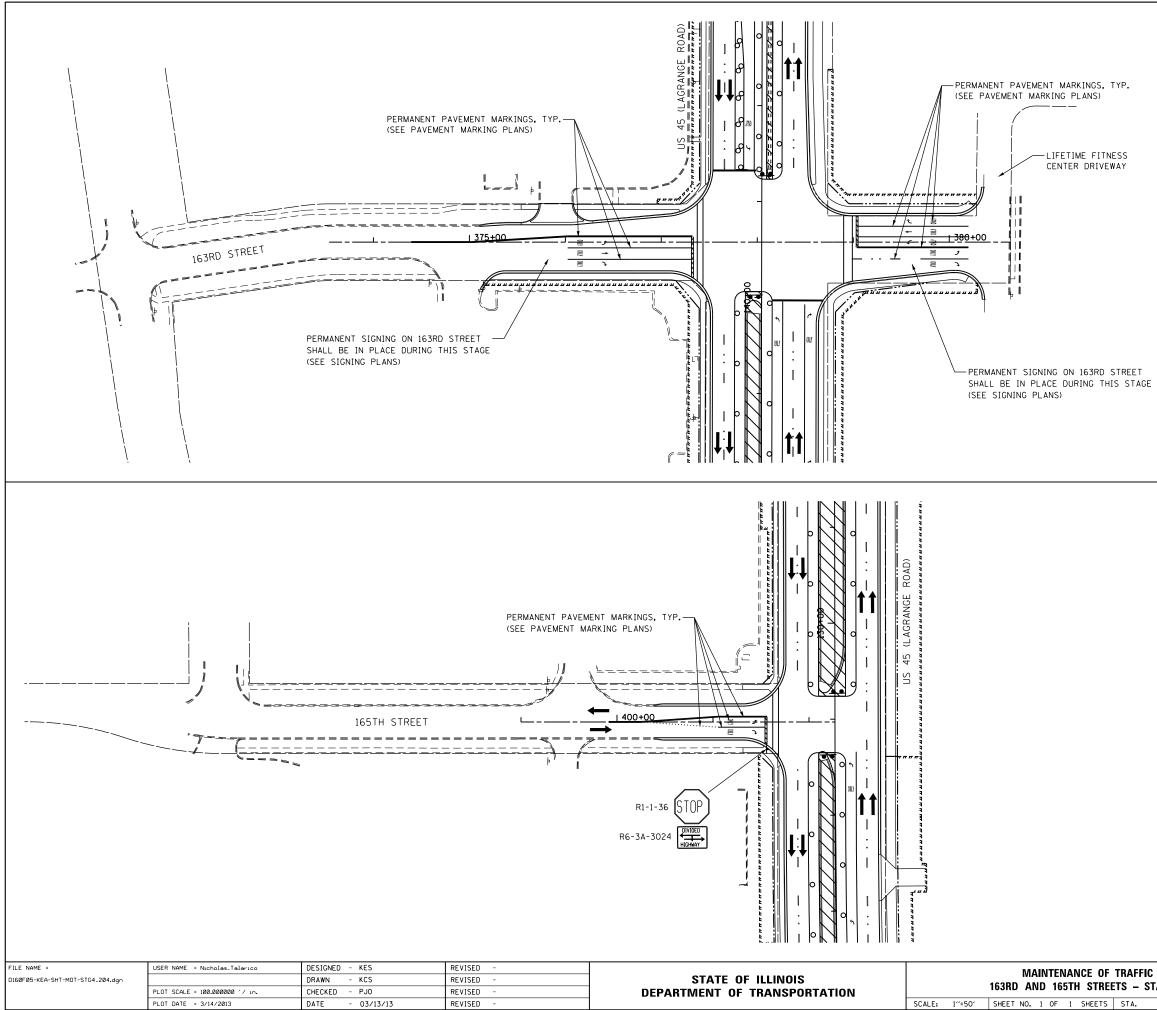

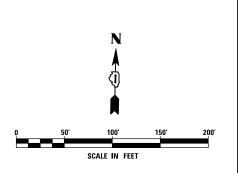

F TRAFFIC		F.A.P RTE.	SECTION	COUNTY TOTAL SHI SHEETS N					
FF	EETS – STAGE 4		330	103R-3	СООК	932	190		
_				MT-72 CONTRACT NO.			0F05		
;	STA.	TO STA.		ILLINOIS FED. AID PROJECT					

## **GENERAL NOTES**

- 1. INSTALL PERIMETER EROSION BARRIER PRIOR TO THE START OF CONSTRUCTION.
- 2. INSTALL EROSION AND SEDIMENT CONTROL MEASURES AS SOON AS CONSTRUCTION ACTIVITIES PERMIT.
- 3. FINISH GRADE AND PLACE FINAL SEEDING AND/OR SODDING IN AREAS THAT WILL NOT BE DISTURBED AGIAN FOR THE DURATION OF THE PROJECT. ANY DAMAGE TO THIS AREA DUE TO CONSTRUCTION WILL BE RESTORED AT THE CONTRACTOR'S EXPENSE.
- 4. ANY AREAS THAT WILL BE UNDISTURBED FOR MORE THAN 14 DAYS SHALL BE SEEDED AND MULCHED WITHIN 7 DAYS.
- 5. TEMPORARY EROSION CONTROL SEEDING WILL BE PLACED ON ALL ERODIBLE EARTH AREAS AS DIRECTED BY THE ENGINEER AS PER THE SPECIFICATIONS.
- 6. TEMPORARY MULCH WILL MEET REQUIREMENTS OF AND BE PAID FOR AS "MULCH, METHOD 3A" OR "HEAVY DUTY EROSION CONTROL BLANKET".
- 7. EROSION AND SEDIMENT CONTROL MEASURES SHALL BE REMOVED AFTER FINAL STABILIZATION IS IN PLACE TO PREVENT EROSION AND SEDIMENTATION OF THE SITE. THE REMOVALS SHALL BE INCIDENTAL TO THE PAY ITEMS.
- 8. PERIMETER EROSION BARRIER SHALL BE PLACED AT CURB CUTS FOLLOWING THE CONSTRUCTION OF THE ROADWAY.
- 9. DISTURBED AREAS SHALL BE MINIMIZED TO PREVENT EROSION AND SEDIMENTATION OF THE SITE.
- 10. ALL EROSION CONTROL ITEMS SHALL BE MAINTAINED UNTIL CONSTRUCTION HAS BEEN COMPLETED UNLESS OTHERWISE DIRECTED BY THE ENGINEER.
- 11. EXISTING DRAINAGE INLETS AND CATCH BASINS SHALL BE PROTECTED WITH ABOVE GRADE INLET FILTERS. MAINTAIN ABOVE GRADE INLET FILTERS UNTIL THE EXISTING STRUCTURES ARE REMOVED.
- 12. EROSION CONTROL MEASURES SHALL BE MAINTAINED. DAMAGED ITEMS SHALL BE REPLACED IMMEDIATELY AT NO ADDITIONAL COST TO THE OWNER.
- 13. CONSTRUCTION SCHEDULE SHALL DETAIL EACH SECTION FINAL STABILIZATION PRIOR TO MOVING ONTO NEXT SECTION IN THE CONSTRUCTION SEQUENCE. FAILURE TO COMPLY WILL RESULT IN AN NPDES DEFICIENCY DEDUCTION.
- 14. CONCRETE WASHOUT REQUIREMENTS ARE A CONTRACTOR-REQUIRED SUBMITTAL.
- 15. ANY DEWATERING OF THE CONSTRUCTION AREA SHALL BE FILTERED THROUGH A DEWARTERING BASIN PRIOR TO ENTERING RECEIVING WATERS.
- 16. ANY DEWATERING SHALL BE ACCORDING TO ILLINOIS URBAN MANUAL, PRACTICE STANDARDS, DEWTATERING CODE 813.
- 17. THE CONTRACTOR SHALL PROVIDE AN EROSION AND SEDIMENT CONTROL PLAN FOR CULVERT CLEANING. THE PLAN SHALL BE REVIEWED AND APPROVED BY THE RESIDENT ENGINEER PRIOR TO STARTING ANY WORK WITHIN THE CULVERT AREA. THE COST OF ALL STORM SEWER CLEANING WORK ITEMS IN THIS AREA WILL NOT BE PAID FOR SEPARATELY, BUT SHALL BE CONSIDERED AS INCLUDED IN THE UNIT BID PRICES OF THE CONTRACT AND NO ADDITIONAL COMPENSATION WILL BE ALLOWED. LACK OF APPROVED PLAN OR FAILURE TO COMPLY WILL RESULT IN AN ESC DEFICIENCY DEDUCTION.

## IN-STREAM WORK AREA NOTES

- CONTRACTOR MUST PREPARE AND IMPLEMENT AN-IN STREAM WORK PLAN (ISWP) FOR ALL WORK CONDUCTED IN THE 1. IN-STREAM WORK AREA (ISW) AS DENOTED ON THE PLANS.
- 2. THE ISWP SHALL COMPLY WITH THE LATEST GUIDELINES FOR IN-STREAM WORK AS UPDATED BY THE CHICAGO DISTRICT OFFICE, ARMY CORPS OF ENGINEERS AND MUST MEET ALL OF THE REQUIREMENTS OF THE STORM WATER POLLUTION PREVENTION PLAN (SWPPP). THE US ARMY CORPS OF ENGINEERS (ACOE) SECTION 404 PERMIT AND ILLINOIS ENVIRONMENTAL PROTECTION AGENCY ILRIO GENERAL NPDES PERMIT FOR STORM WATER DISCHARGES FROM CONSTRUCTION SITES. SEE THE SPECIAL PROVISIONS
- 3. THE ISWP SHOULD BE MADE AVAILABLE AT THE EROSION AND SEDIMENT CONTROL (ESC) PRE-CONSTRUCTION FIELD MEETING.
- 4. THE ISWP MUST BE APPROVED BY THE RESIDENT ENGINEER PRIOR TO THE COMMENCEMENT OF IN-STREAM WORK.
- IF REQUIRED BY THE US ACCE SECTION 404 PERMIT, THE ISWP MUST BE APPROVED IN WRITING BY THE ACCE 5. PRIOR TO THE COMMENCEMENT OF IN-STREAM WORK.
- THE EROSION AND SEDIMENT CONTROLS. STORMWATER MANAGEMENT CONTROLS AND OTHER CONTROLS REQUIRED BY THE 6. ISWP MUST BE AT LEAST AS PROTECTIVE AT THOSE SPECIFIED IN THE STANDARD SPECIFICATIONS FOR ROADWAY AND BRIDGE CONSTRUCTION. OR THE ILLINOIS URBAN MANUAL.
- 7. THE ISWP, INSTALLATION AND MAINTENANCE OF BEST MANAGEMENT PRACTICES (BMPS) SPECIFIED IN THE ISWP ARE NOT MEASURED FOR PAYMENT.
- 8. THE NPDES/ESC DEFICIENCY DEDUCTION APPLIES TO THE ISW AREA.
- IN THE EVENT THE IN-STREAM WORK IS FOUND TO BE NON-COMPLIANT WITH FITHER PERMIT CONDITIONS OR 9. REGULATIONS DURING THE COURSE OF A COMPLIANCE INSPECTION, THE CONTRACTOR WILL WORK WITH THE REGULATORY AGENCIES ON MAKING THE NECESSARY CHANGES TO THE PLANS IN ORDER TO BRING THE PROJECT INTO COMPLIANCE WITH THE IN-STREAM WORK REQUIREMENTS AND PERMIT CONDITIONS.

NOTES \_ PRE-STAGE:

- 1. CONTRACTOR MUST MULCH ALL AREAS DISTURBED AS A RESULT OF TEMPORARY PAVEMENT PLA IN PRE-STAGE.
- 2. PERIMETER EROSION BARRIER WILL BE PLACED ALONG THE PERIMETER OF THE AREA TO BE CI GRADED BEFORE ANY CLEARING OR GRADING TAKES PLACE.

NOTES \_ STAGE 1:

- 1. ANY AREAS THAT WILL BE UNDISTURBED FOR MORE THAN 14 DAYS AND FINAL LANDSCAPING C. IMPLEMENTED SHALL USE TEMPORARY SEEDING AND MULCH WITHIN 7 DAYS.
- 2. PERIMETER EROSION BARRIER WILL BE PLACED ALONG THE PERIMETER OF THE AREA TO BE C BEFORE ANY CLEARING OR GRADING TAKES PLACE.
- 3. FINAL LANDSCAPING RESTORATION AT COMPLETED ROADWAY SECTION SHALL BE IMPLEMENTED THAT STAGE 1 SECTION CONSTRUCTION. SEE LANDSCAPING PLAN FOR FINAL RESTORATION.

NOTES \_ STAGE 2:

1. MAINTAIN PERIMETER EROSION BARRIER WHICH WERE INSTALLED DURING PRE-STAGE AND STAGE I.

NOTES \_ STAGE 3:

- 1. ALL EROSION CONTROL ITEMS INSTALLED IN PREVIOUS STAGES INCLUDING PERIMETER EROSIC MAINTAINED UNTIL CONSTRUCTION IS COMPLETED. EROSION CONTROL ITEMS INSTALLED IN PREVIOUS STAGES NOT SHOWN FOR CLARITY.
- 2. ANY AREAS THAT WILL BE UNDISTURBED FOR MORE THAN 14 DAYS AND FINAL LANDSCAPING CAN NOT BE IMPLEMENTED SHALL USE TEMPORARY SEEDING AND MULCH WITHIN 7 DAYS.
- 3. PERIMETER EROSION BARRIER WILL BE PLACED ALONG THE PERIMETER OF THE AREA TO BE CLEARED AND GRADED BEFORE ANY CLEARING OR GRADING TAKES PLACE.
- 4. PRE-STAGE EROSION CONTROL MEASURES SHALL BE UTILIZED DURING STAGE 3 WHENEVER IS POSSIBLE. MAINTAIN FROSION CONTROL ITEMS UNTIL COMPLETION OF CONSTRUCTION.
- 5. FINAL LANDSCAPING RESTORATION AT COMPLETED ROADWAY SECTION SHALL BE IMPLEMENTED UPON COMPLETION OF STAGE 3 SECTION CONSTRUCTION. SEE LANDSCAPING PLAN FOR FINAL RESTORATION.
- 6. REPLACEMENT OF TEMPORARY EROSION CONTROL SEEDING WITH MULCH METHOD 3A SHALL BE INSTALLED WITHIN 24 HOURS OF INSTALLATION OF PROPOSED DRAINAGE ITEMS AND SHALL BE INCIDENTAL.

NOTES \_ STAGE 4:

- 1. PERIMETER EROSION BARRIER WILL BE PLACED ALONG THE PERIMETER OF THE AREA TO BE CLEARED AND GRADED BEFORE ANY CLEARING OR GRADING TAKES PLACE.
- 2. FINAL LANDSCAPING RESTORATION AT COMPLETED ROADWAY SECTION SHALL BE IMPLEMENTED UPON COMPLETION OF STAGE 1 CONSTRUCTION. SEE LANDSCAPING PLAN FOR FINAL RESTORATION.

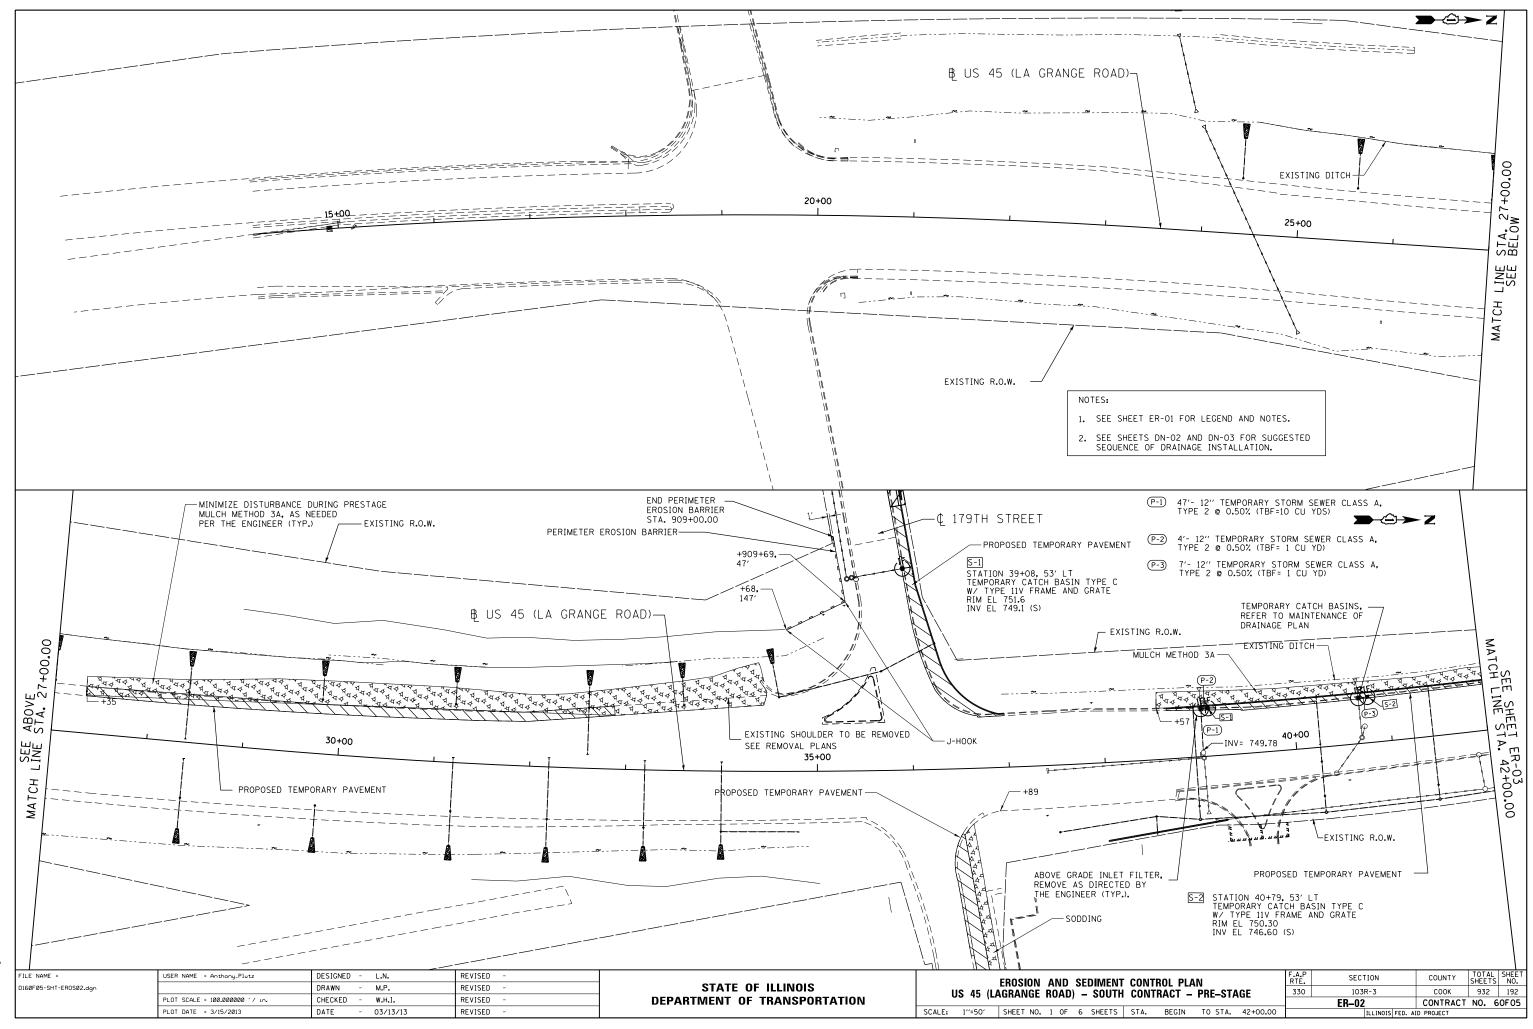
NOTE:

• THE USE OF ABOVE GRADE INLET FILTER CAN BE REPLACED WITH THE DROP INLET FILTER WITH THE APPROVAL OF THE ENGINNER.

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6 24	FILE NAME -	USEN NAME - ANUIONG_F1012		REVISED -			EROSION AND SEDIMENT CONTROL PLAN	RTE.	SECTION	COUNTY	SHEETS NO.
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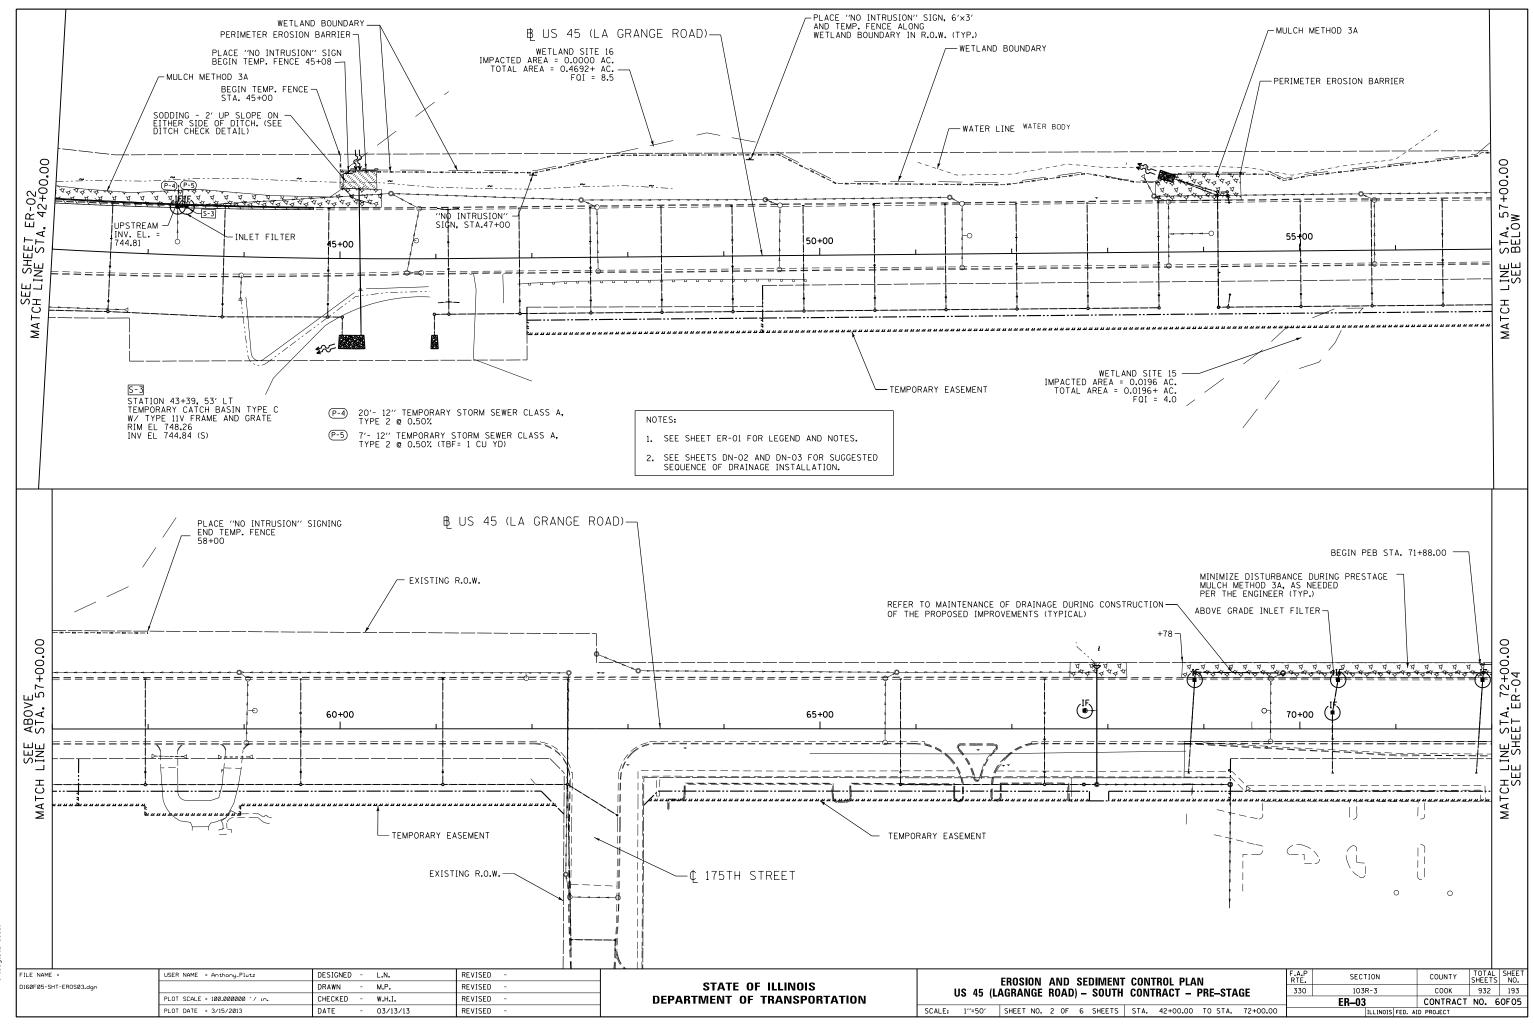
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		TEMPORARY FENCE				
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		HEAVY DUTY EROSION CONTROL BLANKET				
CAN NOT BE CLEARED AND GRADED		SODDING, SALT TOLERANT				
) UPON COMPLETION OF	-\$-	TEMPORARY DITCH CHECK				
		*ABOVE GRADE INLET FILTER				
		TEMPORARY CONSTRUCTION				
		PERMANENT CONSTRUCTION				
		CONSTRUCTION WORK ZONE				
ON BARRIER SHALL BE	<b>}</b> }	FLOW ARROWS				

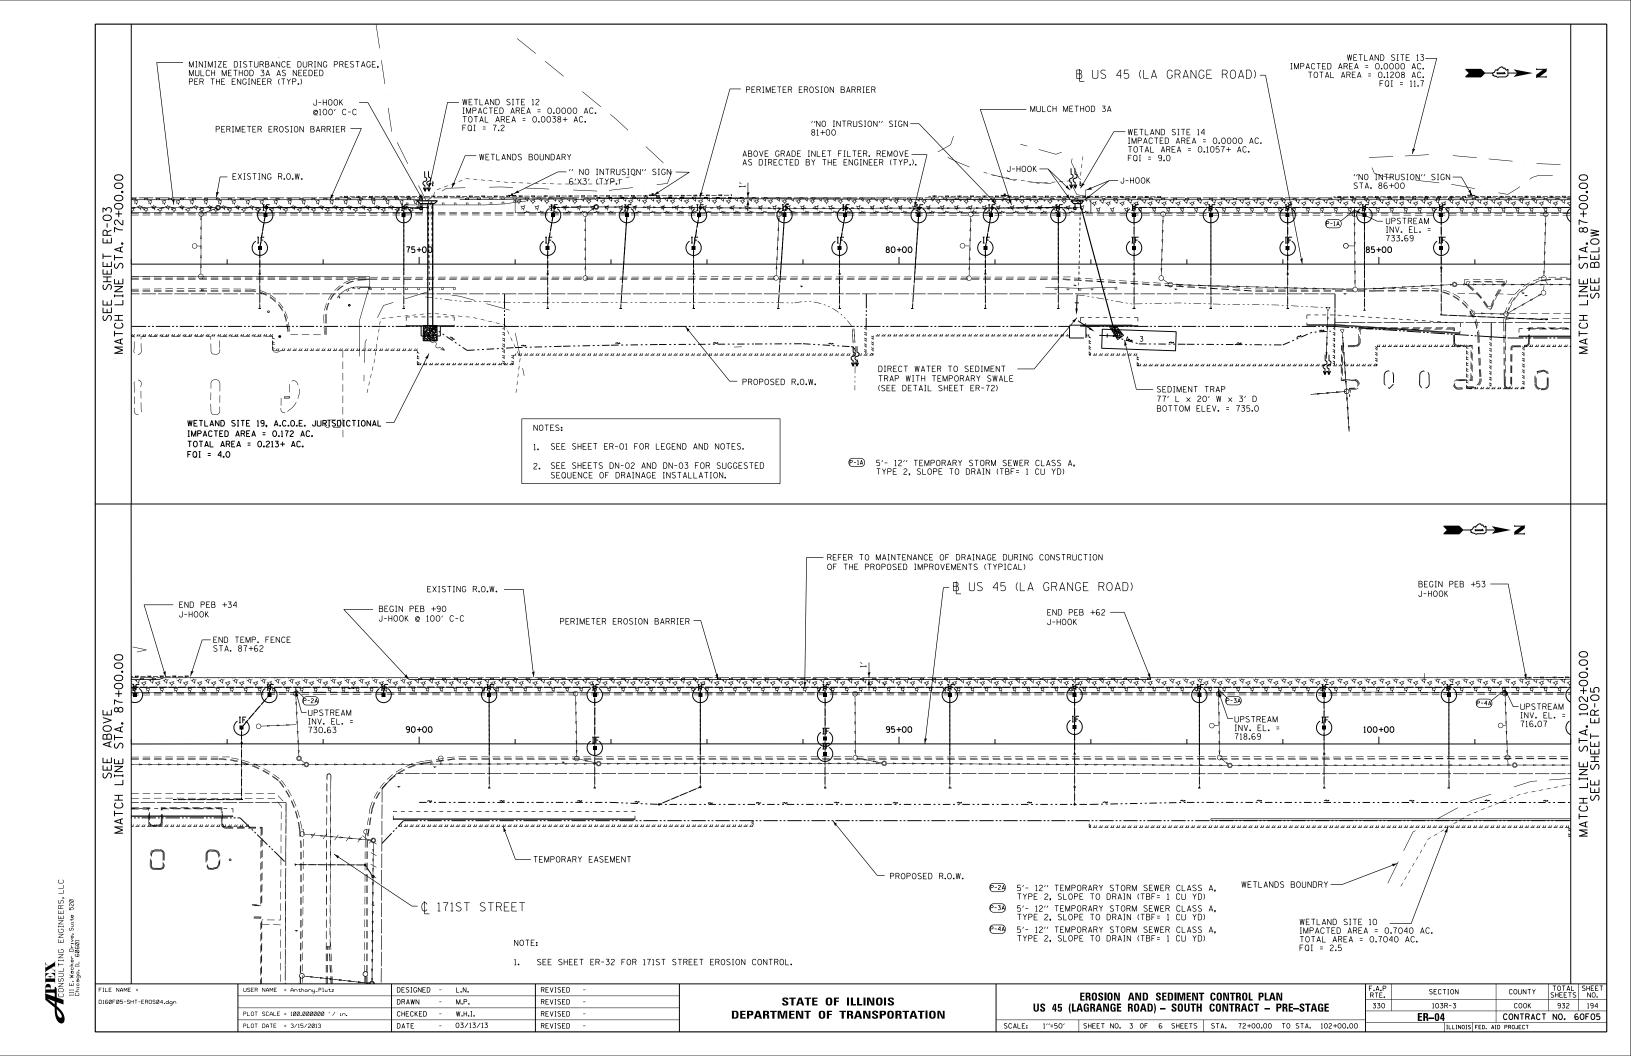


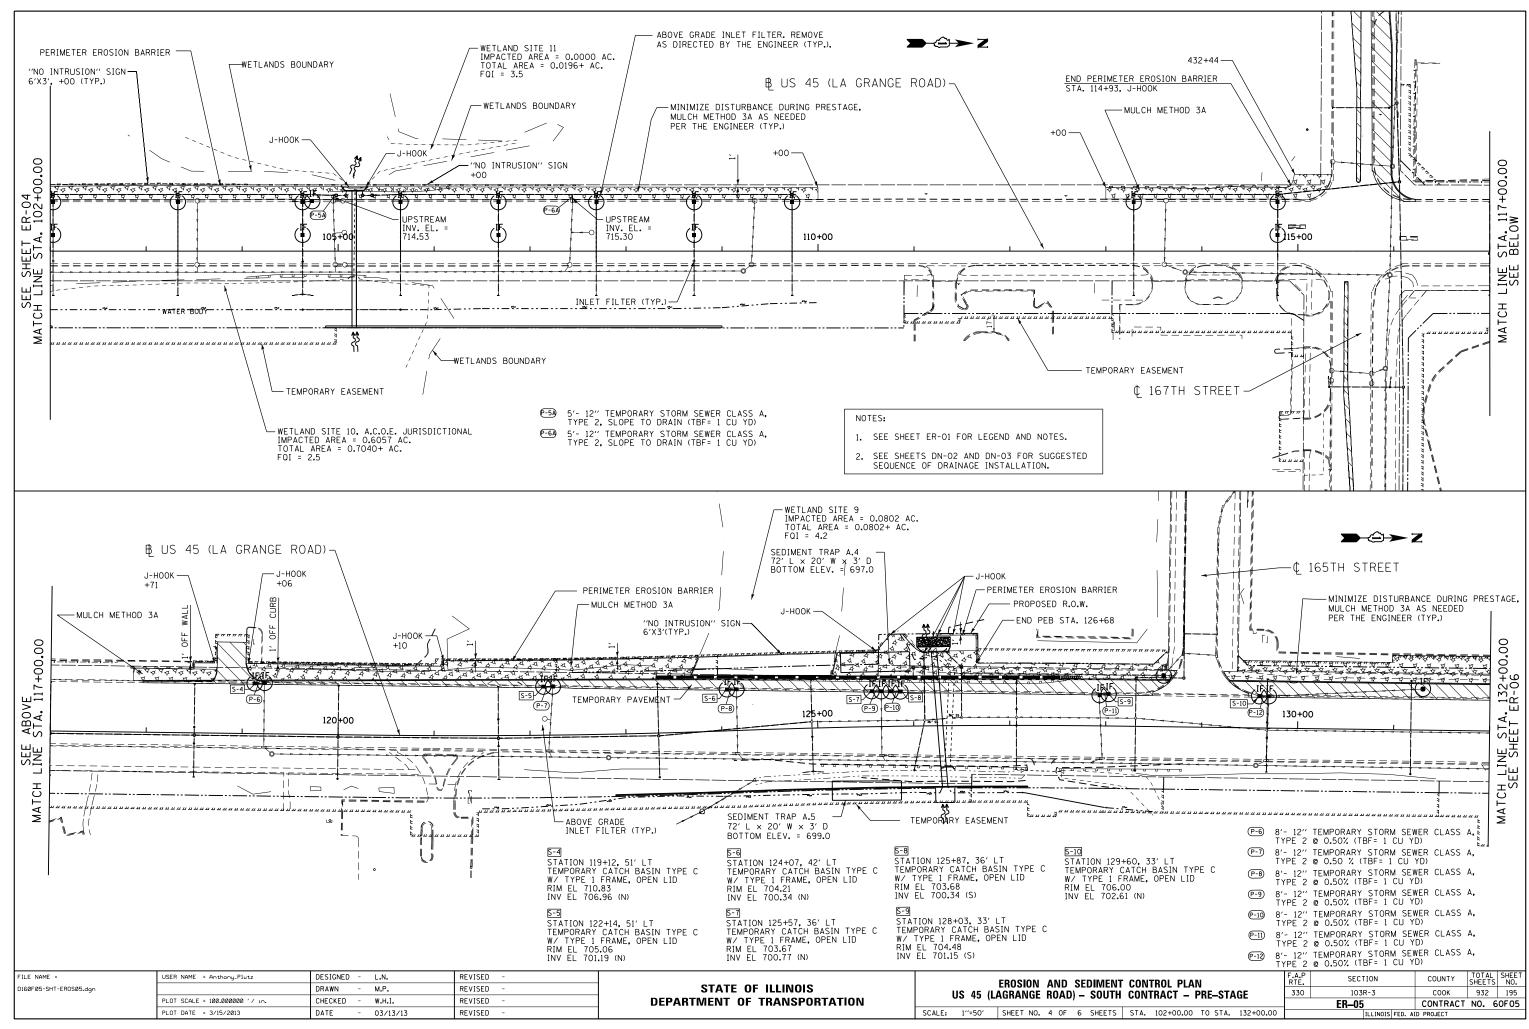
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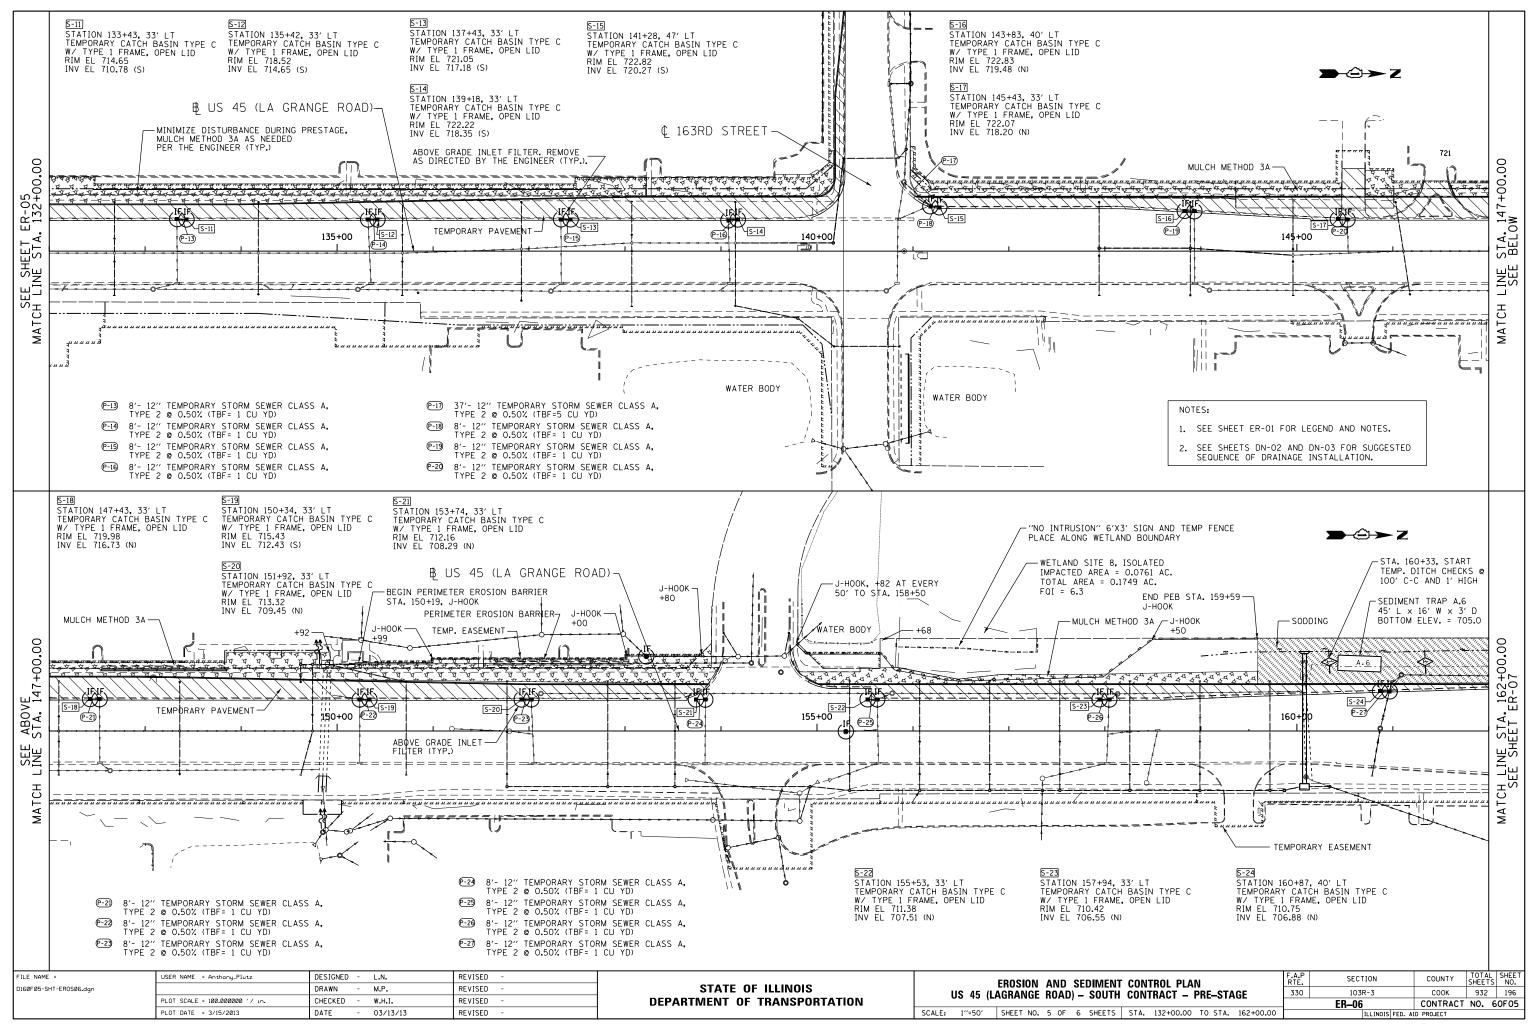
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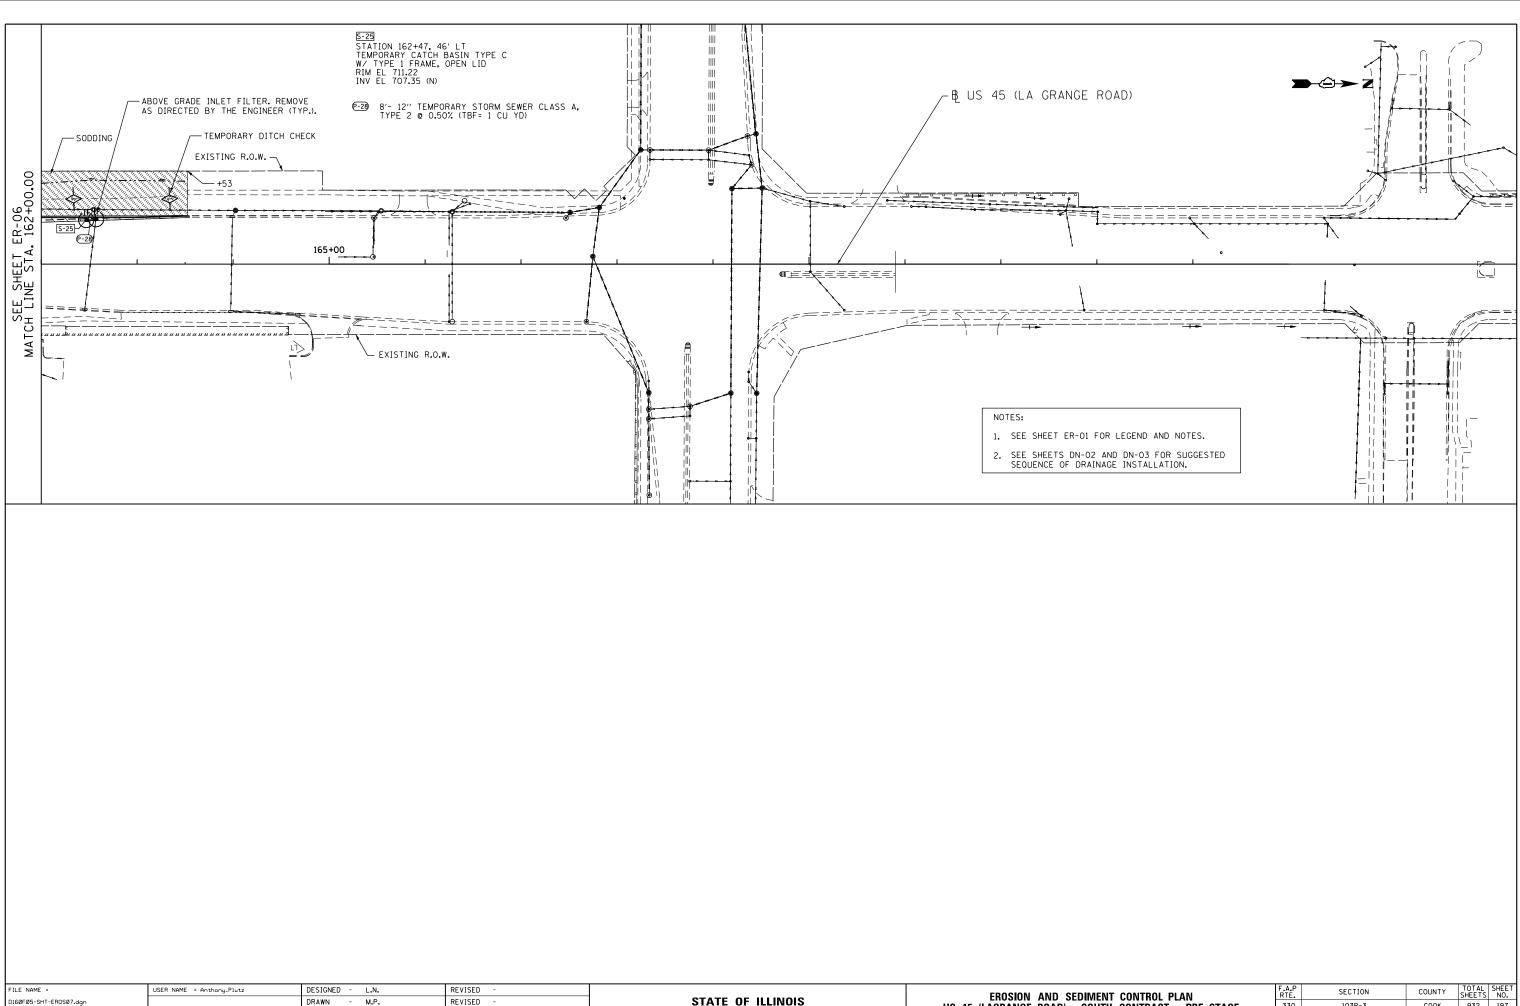




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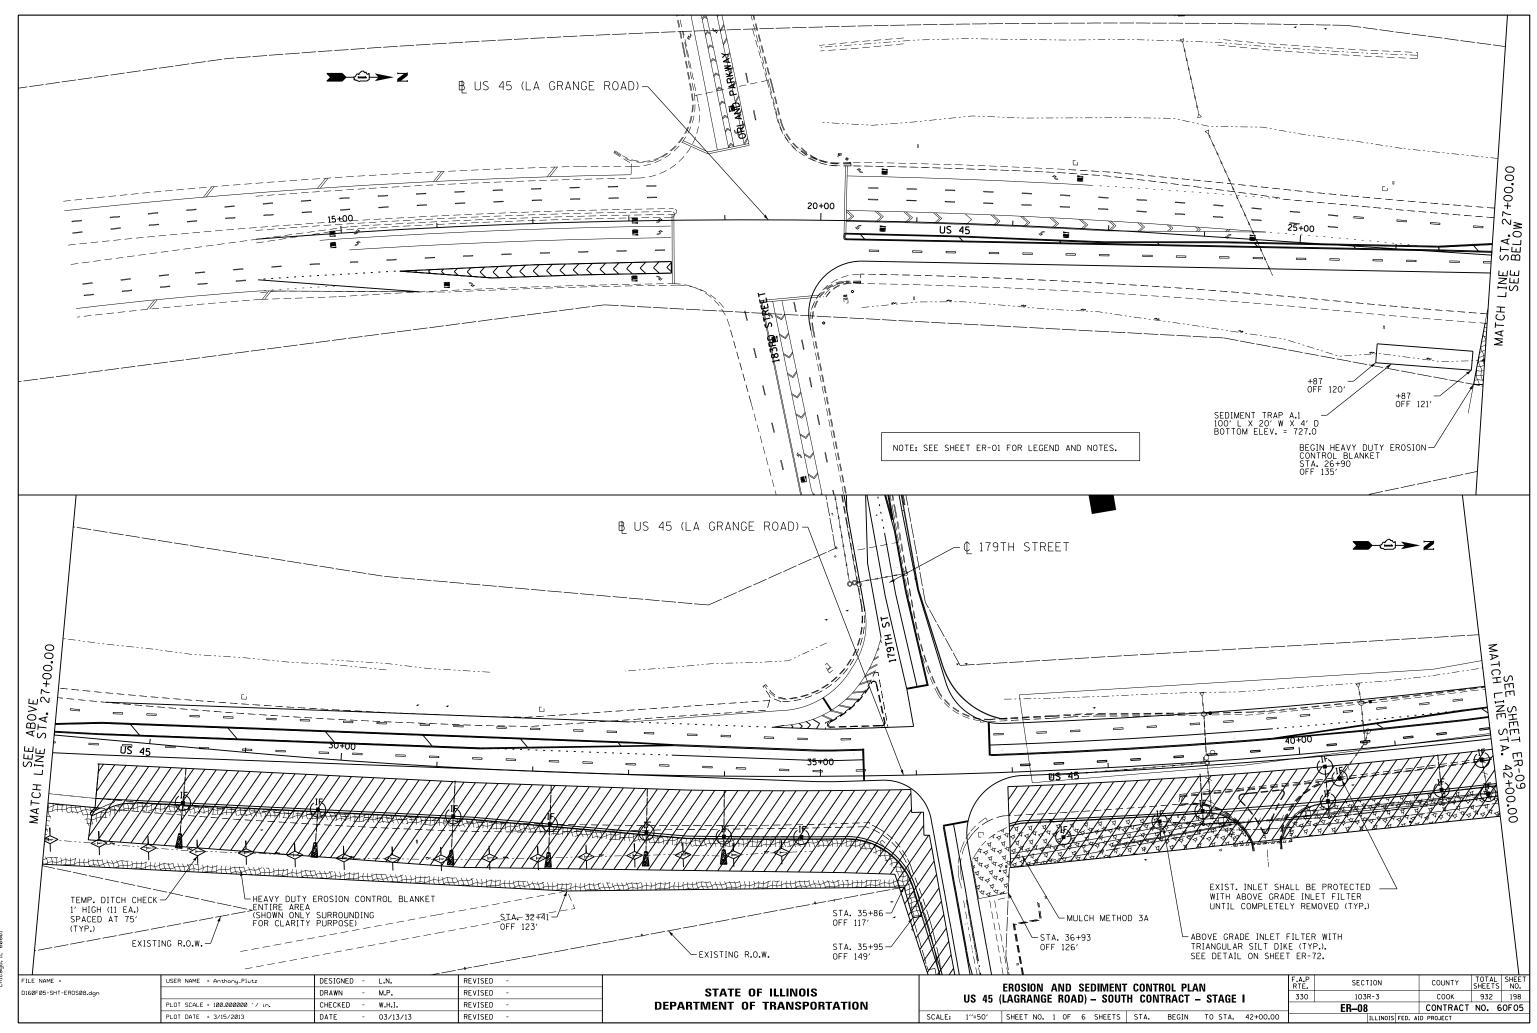


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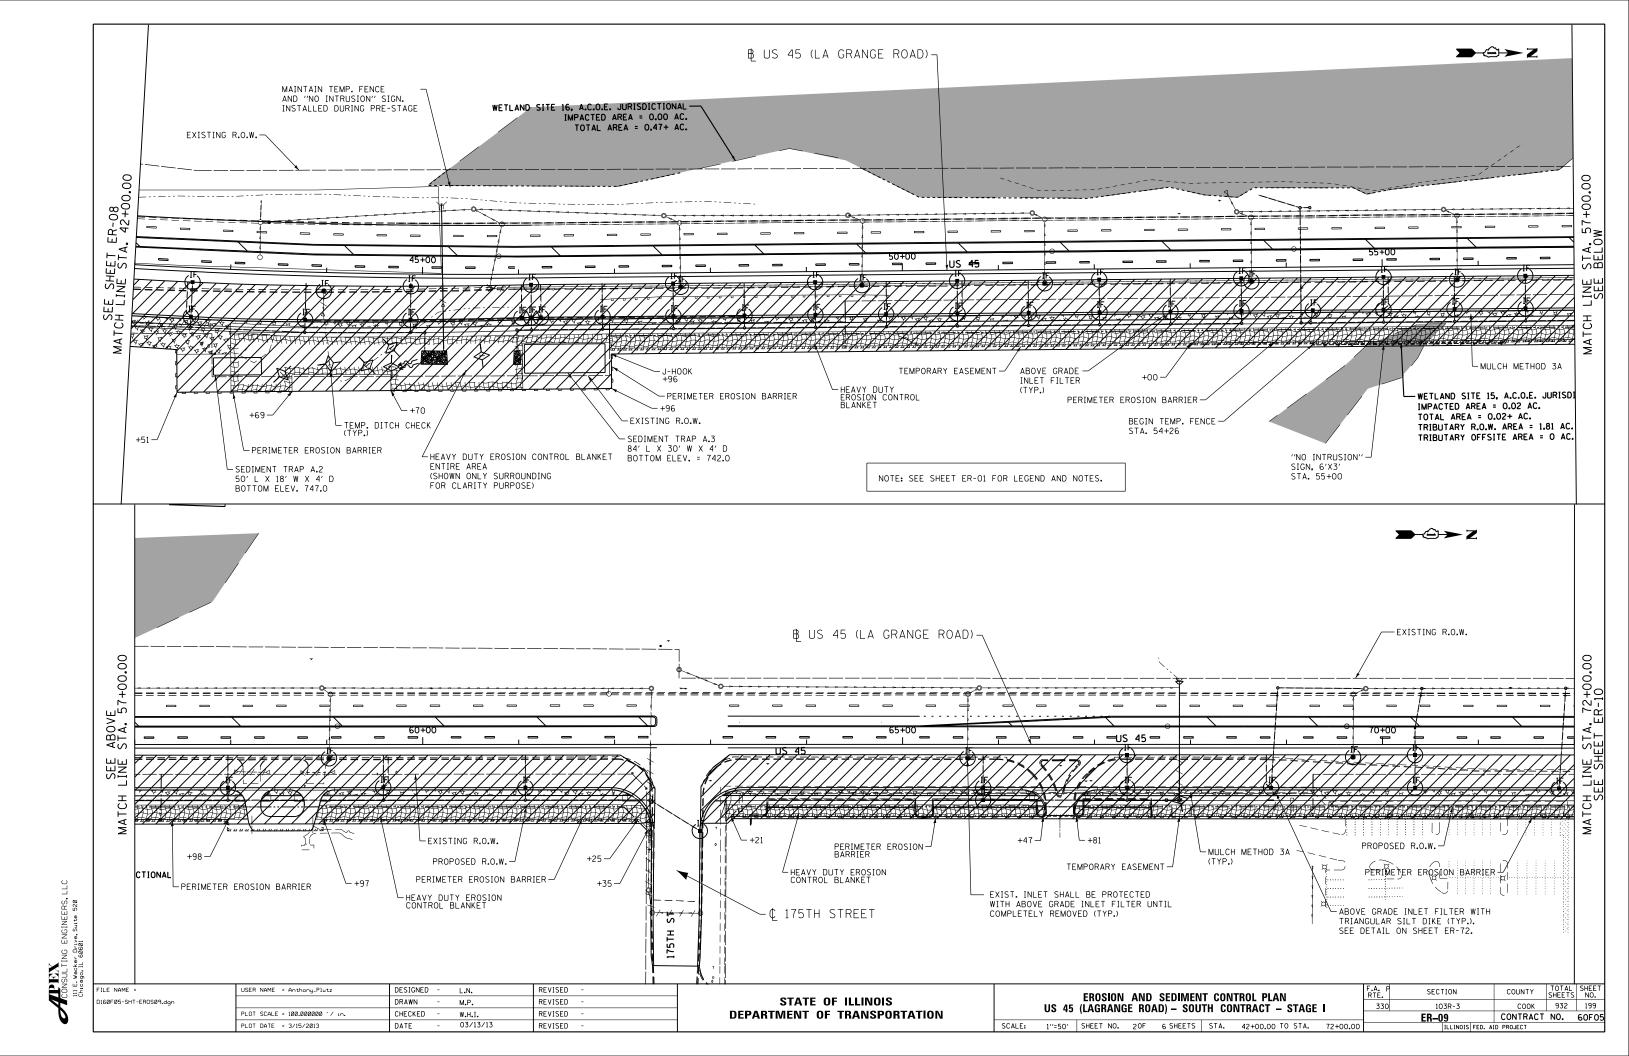


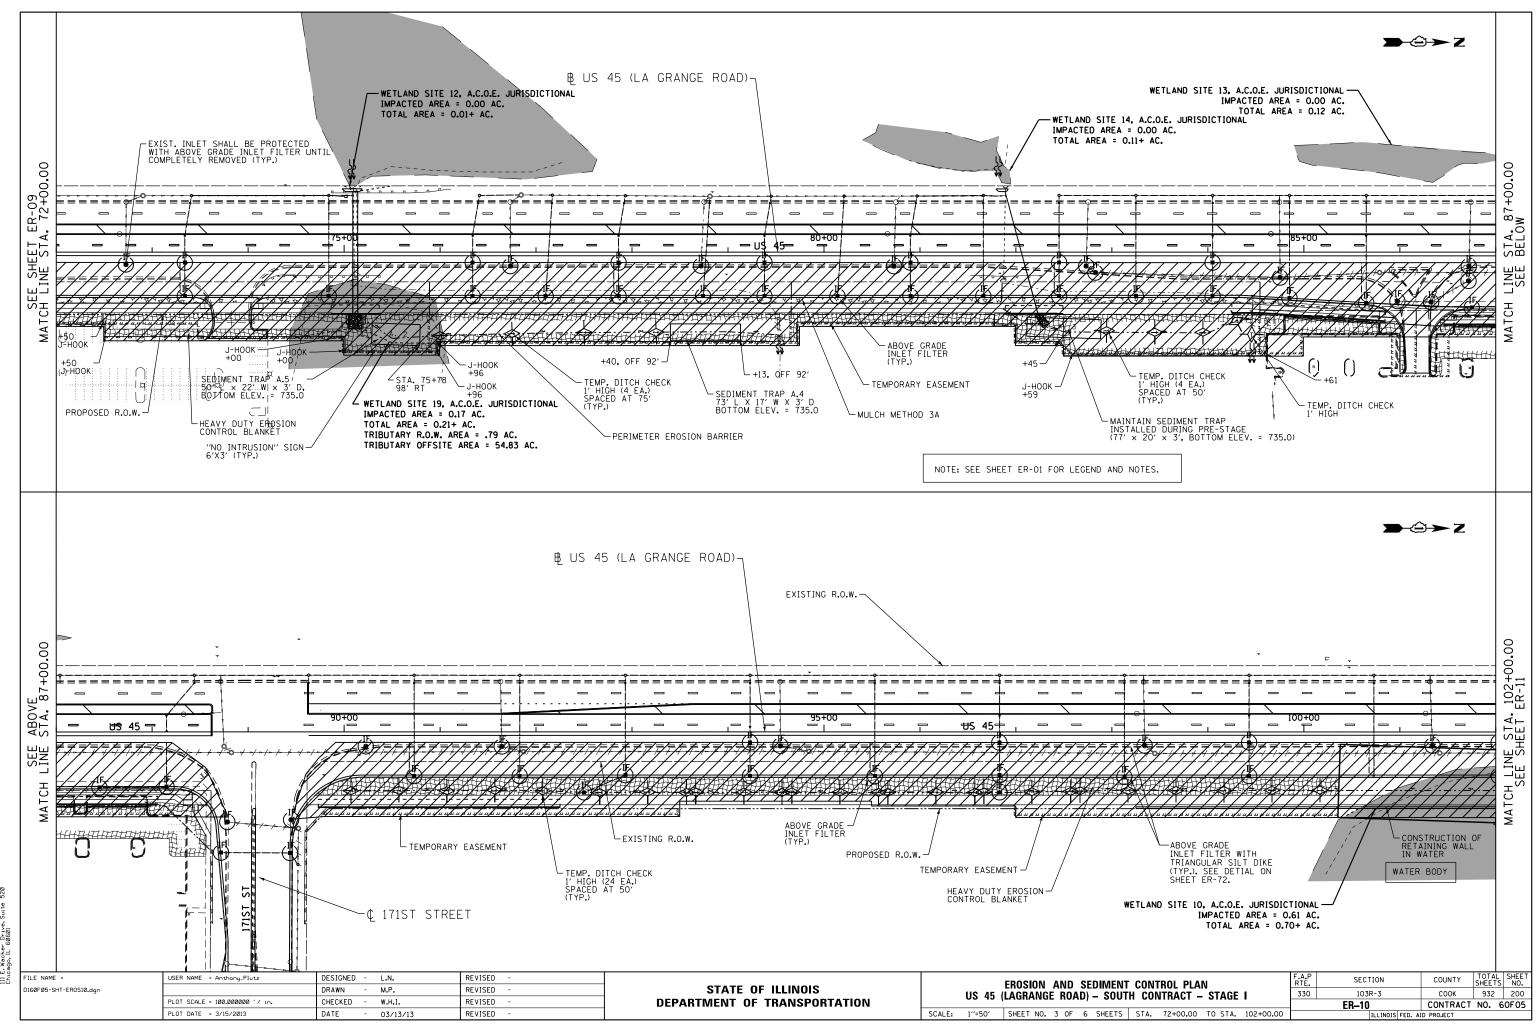


LE NAME =	USER NAME = Anthony_Plutz	DESIGNED - L.N.	REVISED -			EROSION AND SEDIMENT CONTROL PLAN	F.A.P BTE	SECTION	COUNTY TOTAL	L SHEET
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