


F.A.I. RTE.	SECTION	COUNTY	TOTAL SHEETS	SHEET NO.
6998	99-00209-01-PV	VERMILION	296	206
STA. N/A		TO STA. N/A		
FED. ROAD DIST. NO. ILLINOIS		FED. AID PROJECT-		
CONTRACT NO.: 91358				

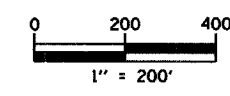

### STAGE 5


**CONSTRUCTION:**

- ① CONSTRUCT THE PROPOSED STRUCTURE FOR THE CSX RAILROAD OVER WINTER AVENUE.
- ② CONSTRUCT THE STORM SEWER BRANCHES TO THE NORTH AND SOUTH ON WINTER AVENUE FROM STA. 107+23.70 TO STA. 114+25.00. CONSTRUCT THE FINAL STORM SEWER ON WINTER AVENUE FROM STA. 101+00.00 TO STA. 105+43.18.
- ③ CONSTRUCT ROADWAY BASE COURSE AND BINDER, CURB AND GUTTER, GUARDRAIL, ENTRANCES, SHARED-USE PATH AND SIDEWALK FROM THE PROPOSED CENTERLINE TO THE NORTH AND SOUTH ALONG WINTER AVENUE FROM STA. 100+10.00 TO STA. 114+50.00.
- ④ COMPLETE ALL FINISHED GRADING ON THE NORTH AND SOUTH SIDES OF WINTER AVENUE FROM STA. 100+10.00 TO STA. 114+50.00.
- ⑤ PLACE FINAL SURFACE COURSE ON WINTER AVENUE FROM STA. 100+10.00 TO STA. 114+50.00.
- ⑥ PLACE FINAL STRIPING ON WINTER AVENUE FROM STA. 100+10.00 TO STA. 114+50.00 AS DETAILED IN THE PLANS.

**EROSION CONTROL:**

1. MAINTAIN EXISTING TEMPORARY EROSION CONTROL MEASURES APPLIED IN STAGE 1, STAGE 2, STAGE 3 AND STAGE 4 CONSTRUCTION IN ACCORDANCE WITH THE STANDARD SPECIFICATIONS FOR ROAD AND BRIDGE CONSTRUCTION, SPECIAL PROVISIONS AND AS DIRECTED BY THE ENGINEER.
2. PROVIDE, APPLY AND MAINTAIN TEMPORARY EROSION CONTROL MEASURES AT LOCATIONS INDICATED ON THE PLANS AND AS DIRECTED BY THE ENGINEER DURING CONSTRUCTION IN ACCORDANCE WITH THE STANDARD SPECIFICATIONS FOR ROAD AND BRIDGE CONSTRUCTION AND SPECIAL PROVISIONS.
3. CONSTRUCT FINAL GRADING AND APPLY FINAL SEEDING AS INDICATED ON THE PLANS, CROSS SECTIONS AND AS DIRECTED BY THE ENGINEER.

PLAN	SURVEYED	DATE
NOTE BOOK	BY	
No.		
	PLANNED	
	DESIGNED	
	CHECKED	
	BY	
	DATE	

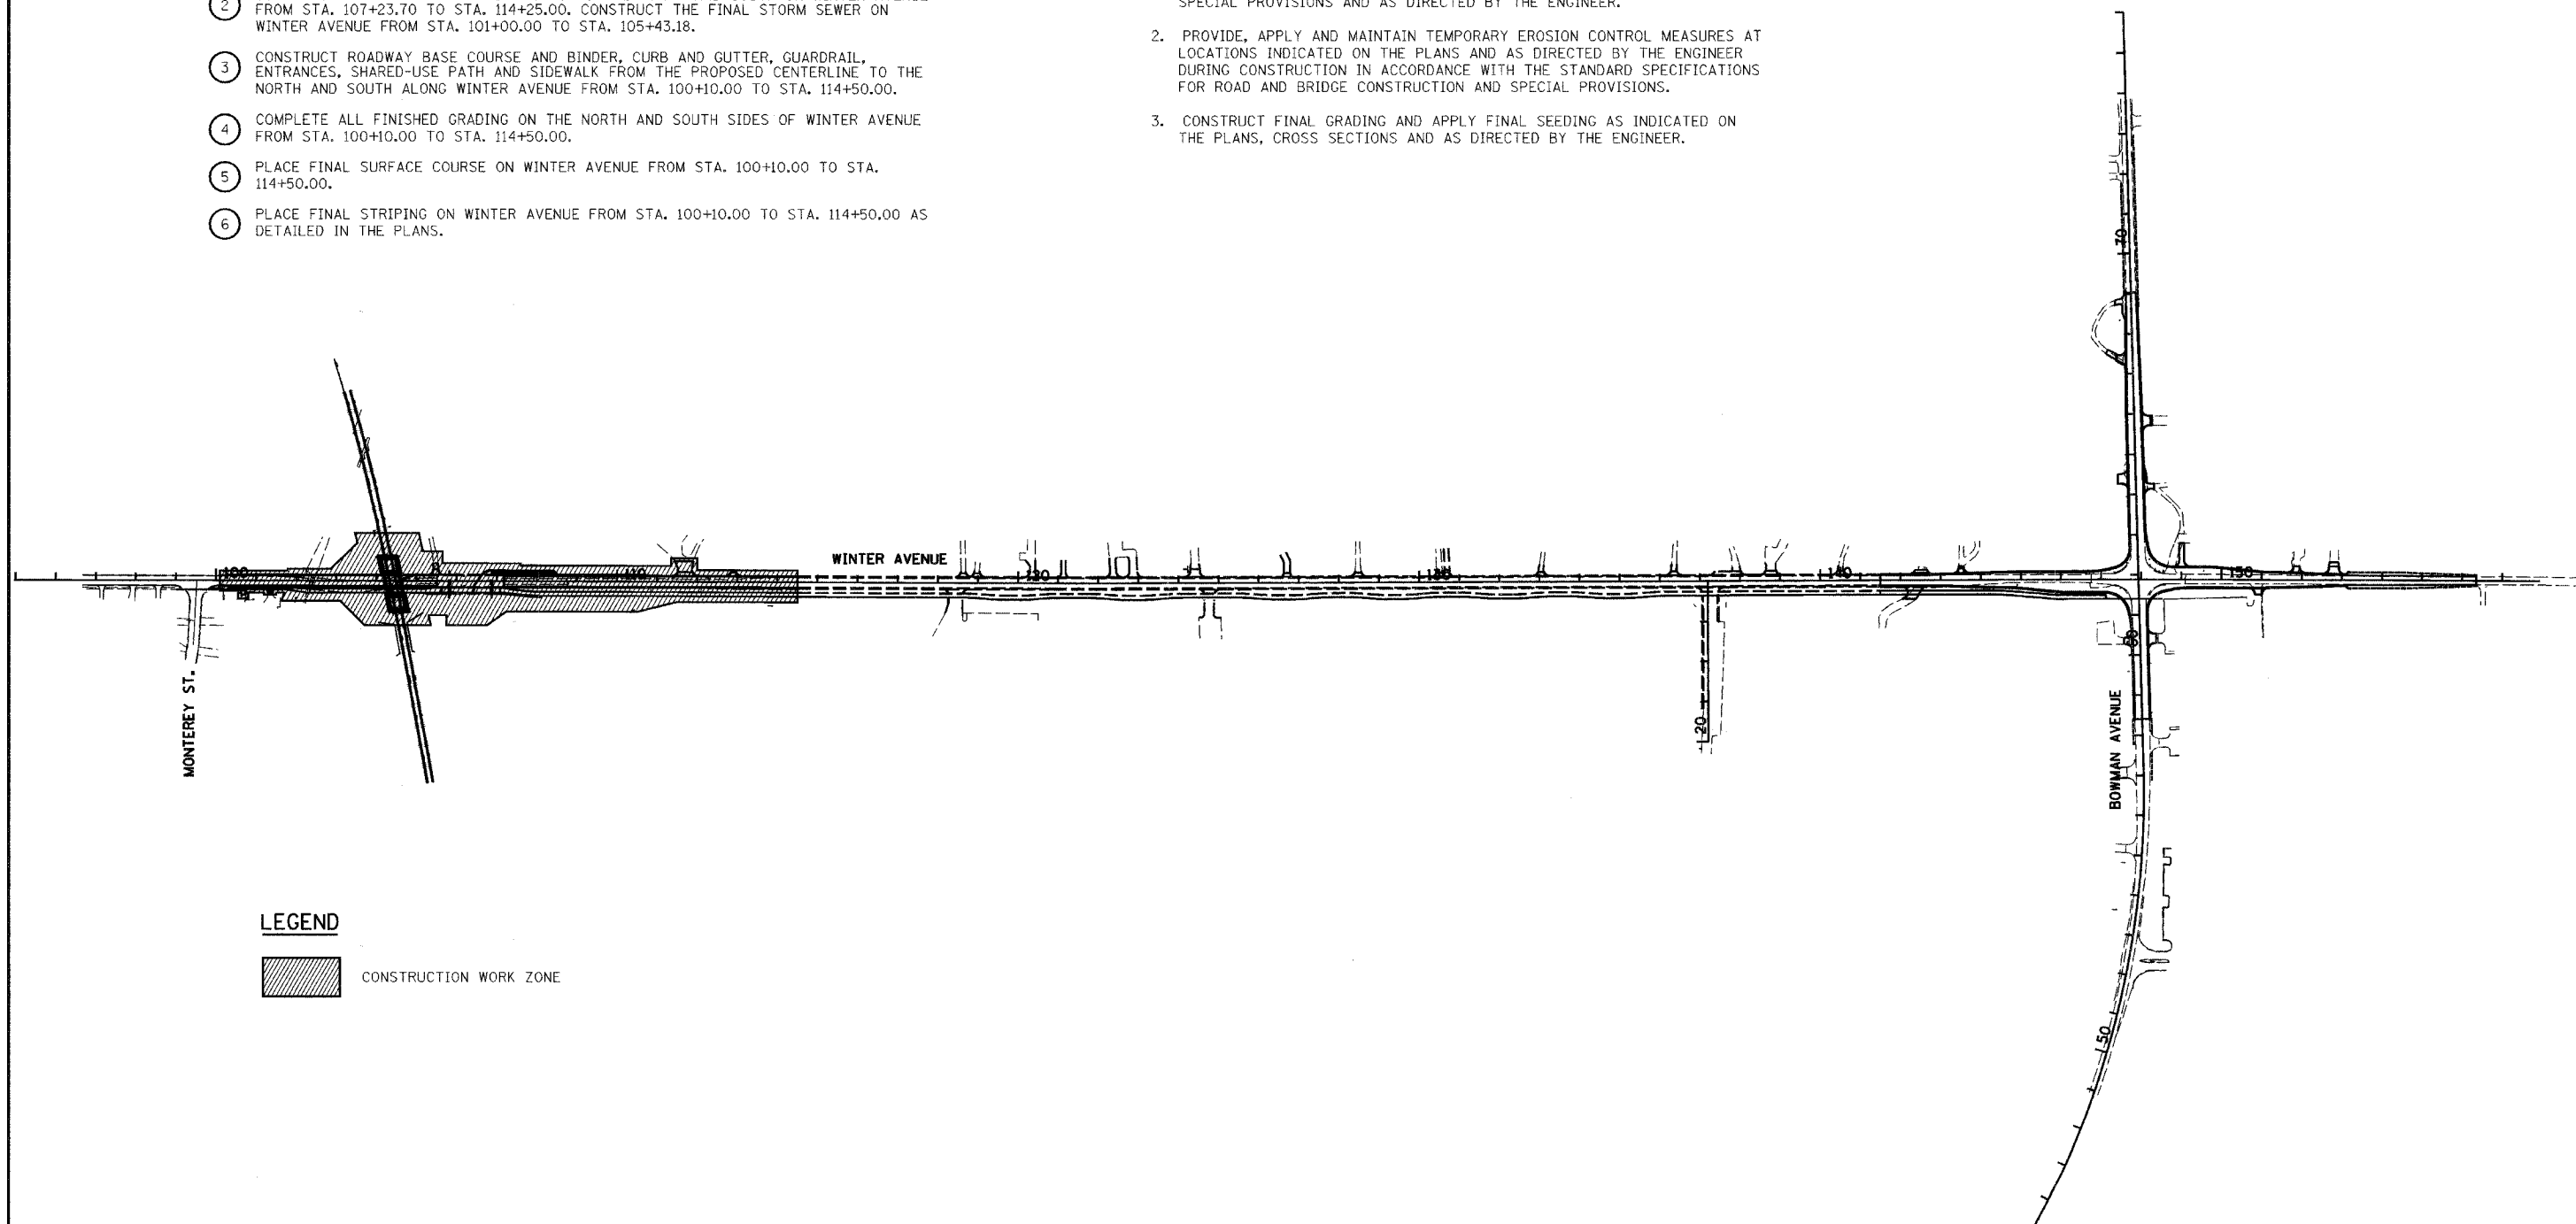

**LEGEND**

CONSTRUCTION WORK ZONE

REVISIONS	
NAME	DATE

CITY OF DANVILLE, ILLINOIS  
**WINTER AVENUE RECONSTRUCTION**  
 TEMPORARY EROSION CONTROL PLAN  
 OVERALL STAGE 5

SCALE: 1" = 200'      DATE: 12/21/06  
 DRAWN BY: MLS      CHECKED BY: SRS