
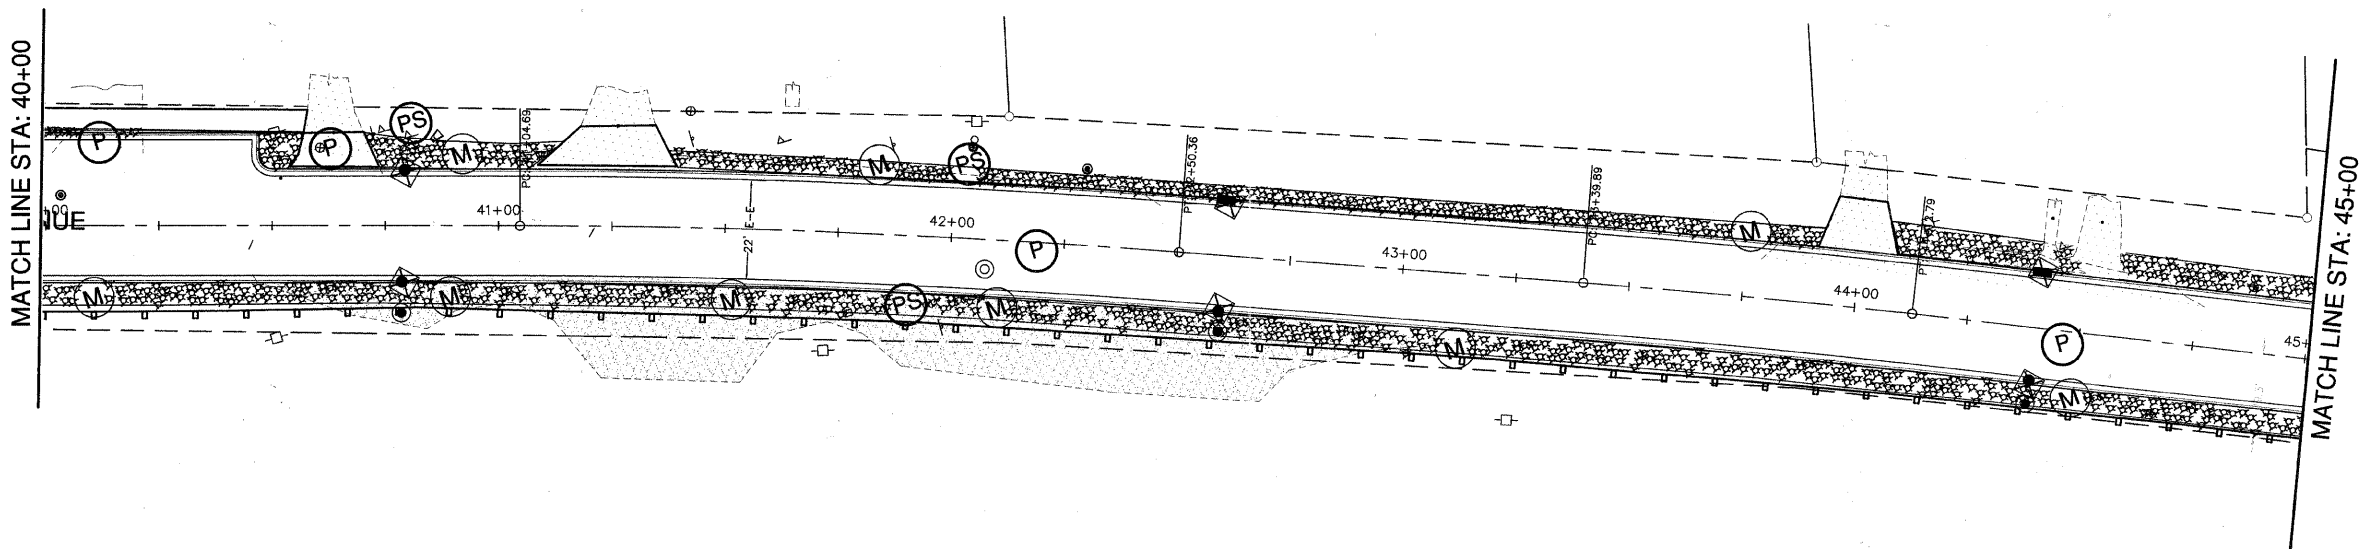


**LEGEND**

- PROPOSED OVERLAND FLOW DIRECTION
- PROPOSED MAJOR OVERFLOW DIRECTION
- PERIMETER EROSION BARRIER
- TEMPORARY FENCE
- INLET FILTERS
- PAVING (TYP.)
- SEEDING CLASS 1A & TOPSOIL FURNISH & PLACE, 4"
- MULCH, METHOD 3
- EROSION CONTROL BLANKET
- EROSION CONTROL BLANKET
- STONE RIPRAP, CLASS A4
- MULCH, METHOD 3
- EX. WETLAND

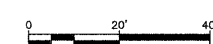

FILE NAME: xxx	GERALD L. HEINZ & ASSOCIATES, INC. CONSULTING ENGINEERS & LAND SURVEYORS 206 NORTH RIVER STREET EAST DUNDEE, ILLINOIS 60118	USER NAME:	DESIGNED: EBW	REVISED: MARCH 23, 2011	STATE OF ILLINOIS DEPARTMENT OF TRANSPORTATION	EROSION AND SEDIMENT CONTROL	FAH ROUTE	SECTION	COUNTY	TOTAL SHEETS	SHEET NO.
		PLOT SCALE: 1" = 20'	DRAWN: PC	REVISED: MAY 16, 2011			2528	04-00043-00-PV	KANE	85	32
		PLOT DATE:	CHECKED: JDH	REVISED:			SCALE: 1" = 20'		SHEET NO. 5 OF 6 SHEETS	STA: 35+00 TO STA: 45+00	CONTRACT NO. 63507
			DATE: AUGUST 25, 2010	REVISED:			FED. ROAD DIST. NO.	ILLINOIS	FED. AID. PROJECT		