




LEGEND

-  TOPSOIL FURNISH AND PLACE, 4" SODDING, SALT TOLERANT
-  PERIMETER EROSION BARRIER




NOTE:

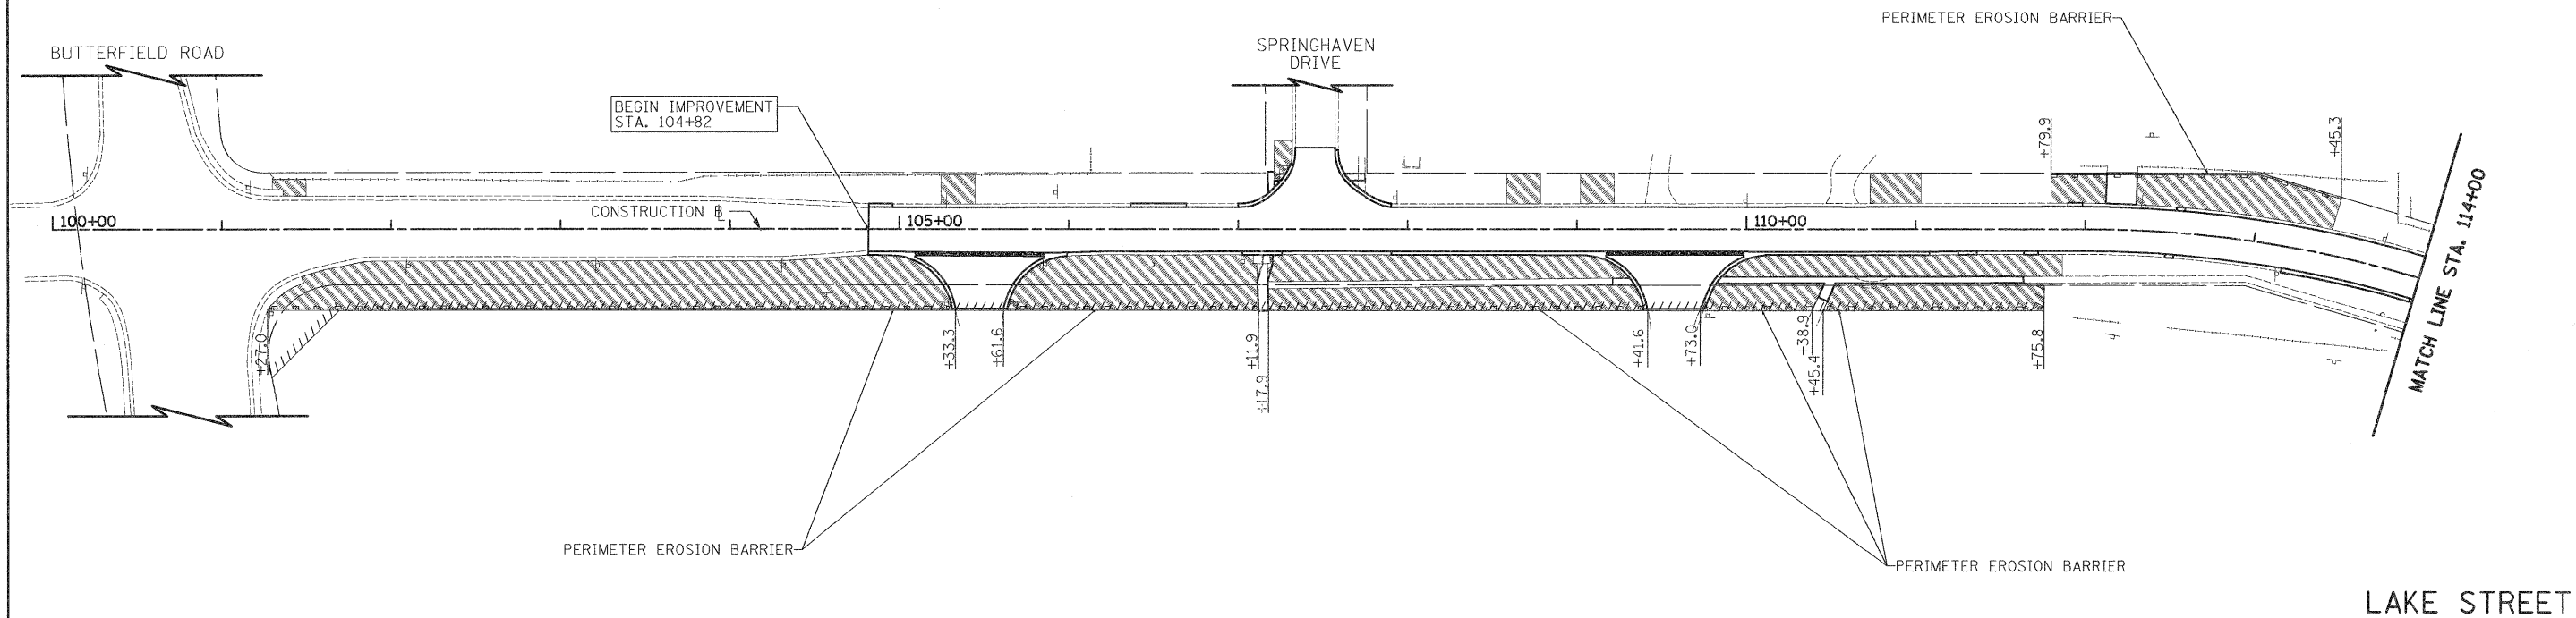INLET FILTERS SHALL BE INSTALLED ON ANY OPEN LID STRUCTURES IN THE PAVEMENT OR IN THE PARKWAY WHERE WATER MAIN EXCAVATION WILL TAKE PLACE, AS DIRECTED BY AND TO THE SATISFACTION OF THE ENGINEER, BEFORE ANY WORK SHALL BEGIN.

CONTRACTOR SHALL PLACE PERIMETER EROSION BARRIER AS SHOWN ON THE PLAN BELOW OR AS DIRECTED BY THE ENGINEER.

CONTRACTOR SHALL MAKE EVERY EFFORT TO MINIMIZE THE AMOUNT OF RESTORATION NEEDED. PARKWAY REPAIRS DETERMINED BY THE ENGINEER TO BE NOT RELATED TO THE INSTALLATION OF THE WATER MAIN WILL BE REPAIRED AT THE CONTRACTOR'S EXPENSE.

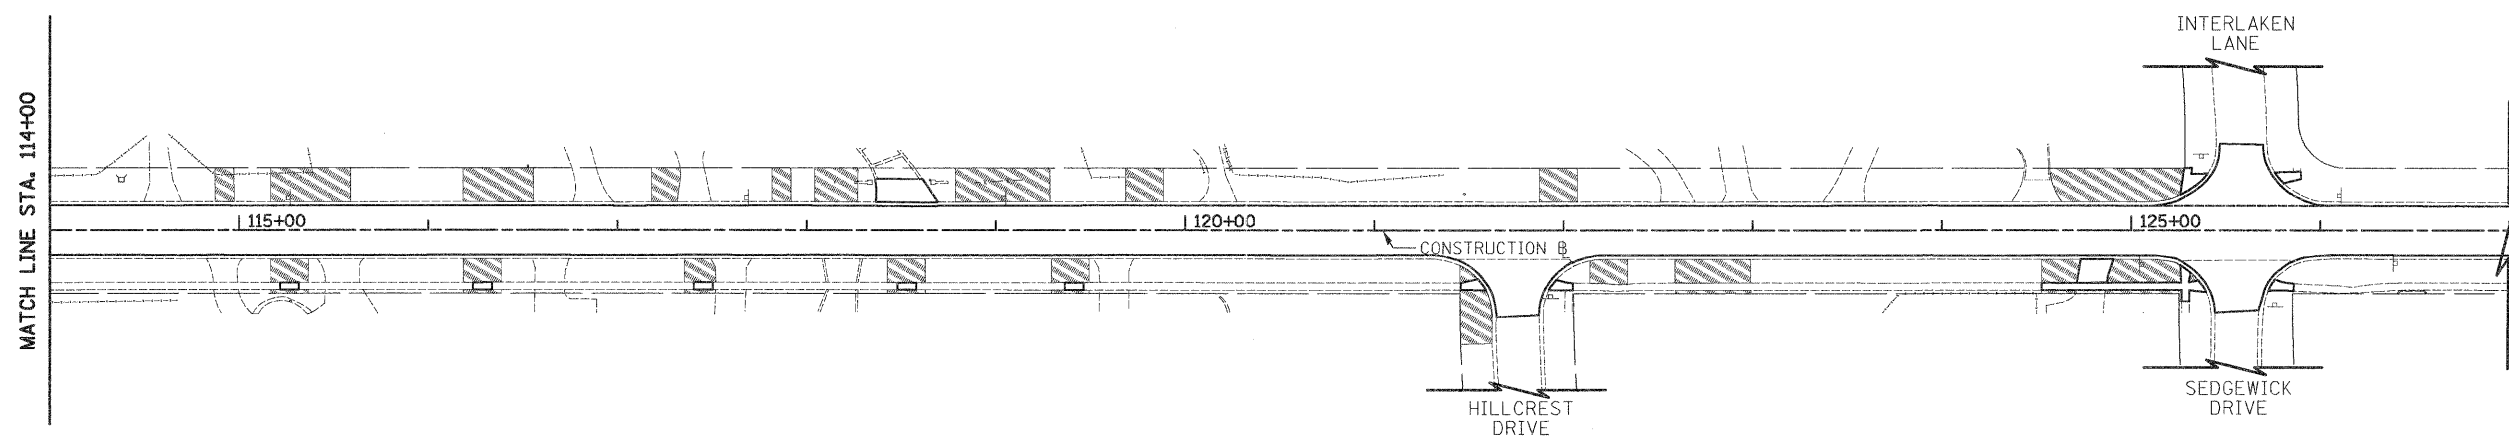

LAKE STREET

FILE NAME = ...\\Cad\sheet\2253_sht... 	USER NAME = eds	DESIGNED - JSM	REVISED -	<b>STATE OF ILLINOIS</b> <b>DEPARTMENT OF TRANSPORTATION</b>	<b>EROSION CONTROL &amp;</b> <b>LANDSCAPING PLAN</b>	F.A.U. RTE. 1236	SECTION 08-00100-00-PV	COUNTY LAKE	TOTAL SHEETS 35	SHEET NO. 19
	PLOT SCALE = 50.0000' / in.	CHECKED - DNM	REVISED -			SCALE: 1" = 50'	SHEET NO. 1 OF 1 SHEETS	STA. 100+00 TO STA. 127+00	CONTRACT NO. 63697	
PLOT DATE = 2/2/2012	DATE = 02/06/12	REVISED -	REVISED -	FED. ROAD DIST. NO. 7 ILLINOIS FED. AID PROJECT						