

FOR INDEX OF SHEETS, SEE SHEET NO. 2
 FOR INDEX OF HIGHWAY STANDARDS, SEE SHEET NO. 2

04-28-2023 LETTING ITEM 086

STATE OF ILLINOIS

DEPARTMENT OF TRANSPORTATION

PLANS FOR PROPOSED FEDERAL AID HIGHWAY

FAU ROUTE 0085 (WALKUP ROAD /CRYSTAL LAKE ROAD)
 BULL VALLEY ROAD TO HILLSIDE ROAD
 SECTION 19-00511-00-SP
 PROJECT YNA2(285)
 TRAFFIC SIGNAL MODERNIZATION
 MCHENRY COUNTY
 JOB NO.: C-91-079-20

F.A.U. RTE.	SECTION	COUNTY	TOTAL SHEETS	SHEET NO.
0085	19-00511-00-SP	MCHENRY	45	1
		ILLINOIS	CONTRACT NO. 61J51	

PROJECT LOCATED IN:
 UNINCORPORATED MCHENRY COUNTY
 VILLAGE OF BULL VALLEY
 CITY OF MCHENRY

TRAFFIC DATA

ROAD NAME: WALKUP ROAD/CRYSTAL LAKE ROAD
 FUNCTIONAL CLASSIFICATION: OTHER PRINCIPAL ARTERIAL
 POSTED SPEED LIMIT: 40 MPH TO 50 MPH
 DESIGN SPEED: 50 MPH
 ADT: 9150-14700




Todd Artz

TODD ARTZ, P.E., DATE 11/17/2023
 HANSON PROFESSIONAL SERVICES INC.
 LICENSE EXPIRES: 11/30/2023
 SHEET RANGE: 1 - 6; 15 - 47




Kurt Bialobreski

KURT BIALOBRESKI, P.E., DATE 11/17/2023
 HANSON PROFESSIONAL SERVICES INC.
 LICENSE EXPIRES: 11/30/2023
 SHEET RANGE: 7 - 14

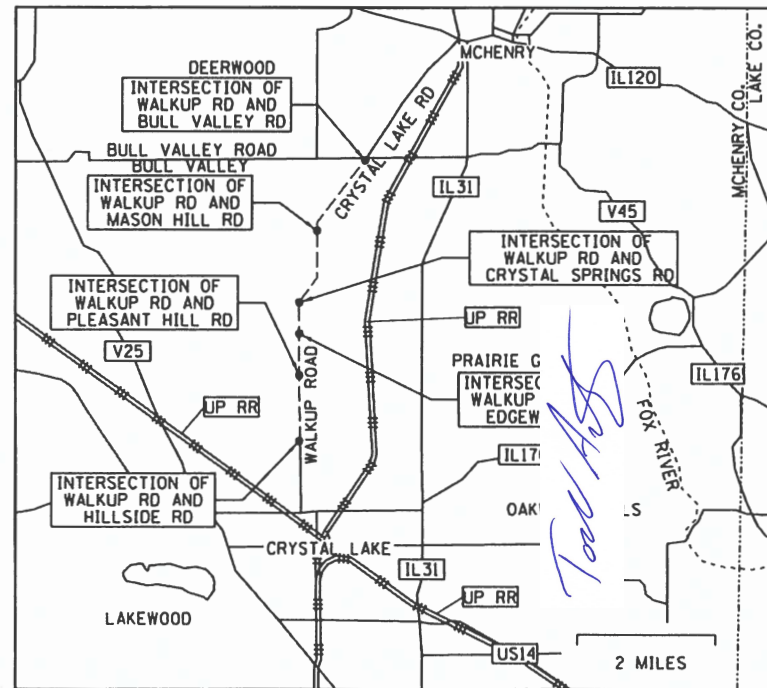

LOCATION MAP

GROSS LENGTH = N / A
 NET LENGTH = N / A
 WORK IN INTERSECTIONS ONLY

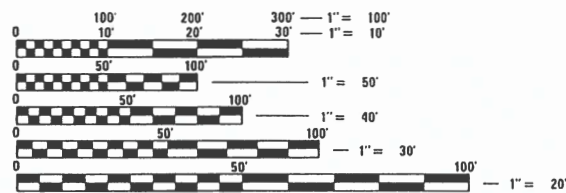

FULL SIZE PLANS HAVE BEEN PREPARED USING STANDARD ENGINEERING SCALES. REDUCED SIZED PLANS WILL NOT CONFORM TO STANDARD SCALES. IN MAKING MEASUREMENTS ON REDUCED PLANS, THE ABOVE SCALES MAY BE USED.

J.U.L.I.E.
 JOINT UTILITY LOCATION INFORMATION FOR EXCAVATION
 1-800-892-0123
 OR 811

PROJECT ENGINEER: TODD ARTZ
 PROJECT MANAGER: KURT BIALOBRESKI
 CONTRACT NO. 61J51

PROGRAM AND OFFICE ENGINEER: CARMEN E. RAMOS, P.E., SCHAUMBURG, IL

DATE: -



STATE OF ILLINOIS
 DEPARTMENT OF TRANSPORTATION

APPROVED FEBRUARY 21 2023
Kurt Bialobreski
 COUNTY ENGINEER
 MCHENRY COUNTY DIVISION OF TRANSPORTATION

PASSED FEB 21 2023
[Signature]
 DISTRICT 1 ENGINEER OF LOCAL ROADS AND STREETS

RELEASED FOR BID
 BASED ON LIMITED REVIEW FEBRUARY 21 2023
[Signature]
 REGIONAL ENGINEER

PRINTED BY THE AUTHORITY
 OF THE STATE OF ILLINOIS

INDEX OF SHEETS

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35-45	IDOT DISTRICT ONE STANDARD DRAWINGS

LIST OF STANDARDS

000001-08	STANDARD SYMBOLS, ABBREVIATIONS AND PATTERNS
424001-11	PERPENDICULAR CURB RAMPS FOR SIDEWALKS
424006-05	DIAGONAL CURB RAMPS FOR SIDEWALKS
424021-06	DEPRESSED CORNER FOR SIDEWALKS
606001-08	CONCRETE CURB TYPE B AND COMBINATION CONCRETE CURB AND GUTTER
701001-02	OFF-RD OPERATIONS, 2L, 2W, MORE THAN 15' AWAY
701006-05	OFF-RD OPERATIONS, 2L, 2W, 15' TO 24" FROM PAVEMENT EDGE
701101-05	OFF-RD OPERATIONS, MULTILANE, 15' TO 24" FROM PAVEMENT EDGE
701106-02	OFF-RD OPERATIONS, MULTILANE, MORE THAN 15' AWAY
701426-09	LANE CLOSURE, MULTILANE, INTERMITTENT OR MOVING OPER., FOR SPEEDS >= 45 MPH
701427-05	LANE CLOSURE, MULTILANE, INTERMITTENT OR MOVING OPER., FOR SPEEDS <= 40 MPH
701701-10	URBAN LANE CLOSURE, MULTI LANE INTERSECTION
701801-06	SIDEWALK, CORNER OR CROSSWALK CLOSURE
701901-08	TRAFFIC CONTROL DEVICES
720001-01	SIGN PANEL MOUNTING DETAILS
720006-04	SIGN PANEL ERECTION DETAILS
720016-04	MAST ARM MOUNTED STREET NAME SIGN
780001-05	TYPICAL PAVEMENT MARKINGS
814001-03	HANDHOLES
821101-02	LUMINAIRE WIRING IN POLE
838001-01	BREAKAWAY DEVICES
857001-01	STANDARD PHASE DESIGNATION DIAGRAMS AND PHASE SEQUENCES
873001-02	TRAFFIC SIGNAL GROUNDING & BONDING
876001-04	PEDESTRIAN PUSH BUTTON POST
877011-10	STEEL COMB. MAST ARM ASSEMBLY AND POLE 16' THROUGH 55'
877012-07	STEEL COMB. MAST ARM ASSEMBLY AND POLE 56' THROUGH 75'
878001-11	CONCRETE FOUNDATION DETAILS
880006-01	TRAFFIC SIGNAL MOUNTING DETAILS

LIST OF D1 STANDARDS

BD24	CURB OR CURB AND GUTTER REMOVAL AND REPLACEMENT
BE205	LIGHTING CONTROLLER, BASE MOUNTED, 480 VOLT, 200 AMP, (DUAL) RADIO SCADA (4 SHEETS)
BE215	LIGHTING CONTROLLER SINGLE DOOR
BE240	COMBINATION LIGHTING, TRAFFIC SIGNAL SCHEMATIC
BE702	MISCELLANEOUS ELECTRICAL DETAILS, SHEET A - (CABLE SPLICE, POLE WIRING, TRENCH DETAIL)
BE1050	FIBER OPTIC INTERCONNECT CABINET
TC13	DISTRICT ONE TYPICAL PAVEMENT MARKINGS
TS02	MAST ARM MOUNTED STREET NAME SIGNS
TS05	DISTRICT ONE STANDARD TRAFFIC SIGNAL DESIGN DETAILS

UTILITY NOTE

THE LOCATIONS OF THOSE BURIED AND ABOVEGROUND UTILITIES SHOWN ARE APPROXIMATE, ARE SHOWN FOR CONTRACTOR INFORMATIONAL USE ONLY, AND ARE NOT TO BE REFERENCED FOR CONSTRUCTION PURPOSES. THE IMPLIED PRESENCE OR ABSENCE OF UTILITIES IS NOT TO BE CONSTRUED BY THE OWNER, ENGINEER, CONTRACTOR, OR SUBCONTRACTORS TO BE AN ACCURATE AND COMPLETE REPRESENTATION OF UTILITIES THAT MAY OR MAY NOT EXIST ON THE CONSTRUCTION SITE. BURIED AND ABOVEGROUND UTILITY LOCATION, IDENTIFICATION, AND MARKING ARE THE SOLE RESPONSIBILITY OF THE CONTRACTOR. REROUTING, DISCONNECTION, PROTECTION, ETC. OF ANY UTILITIES MUST BE COORDINATED AMONG THE CONTRACTOR, UTILITY COMPANY, AND OWNER. SITE SAFETY, INCLUDING THE AVOIDANCE OF HAZARDS, ASSOCIATED WITH BURIED AND ABOVEGROUND UTILITIES REMAIN THE SOLE RESPONSIBILITY OF THE CONTRACTOR.

LEGEND

⊙	EXISTING MANHOLE	—G—	GAS
▲	CONTROL POINT	—T—	TELEPHONE
⊞	EXISTING TELEPHONE PEDESTAL	—CTV—	CABLE TELEVISION
→	EXISTING GUY	—FO—	FIBER OPTIC
⊞	EXISTING POWER POLE	—W—	WATER
◁	EXISTING CULVERT	-----	PIPE CULVERT
⊞	EXISTING SIGN	—	PROPOSED STORM SEWER
⊙	EXISTING TREE	—	EXISTING STORM SEWER
⊞	EXISTING R.O.W. MARKER	—A—	OVERHEAD ELECTRIC
⊞	EXISTING MAILBOX	-----	FENCE
▶	PROPOSED MAILBOX	— -- —	PROPOSED R.O.W.
—	PROPOSED INLET	—	EXISTING R.O.W.
⊙	PROPOSED MANHOLE		TEMPORARY EASEMENT
⊞	PROPOSED SIGN	—	

GENERAL NOTES

1. THE CONSTRUCTION SHALL BE GOVERNED BY THE "STANDARD SPECIFICATIONS FOR ROAD AND BRIDGE CONSTRUCTION IN ILLINOIS", 2022 EDITION AND "SUPPLEMENTAL SPECIFICATIONS AND RECURRING SPECIAL PROVISIONS", 2023 EDITION
2. WHERE SECTION, SUB-SECTION, SUBDIVISION, OR PROPERTY MONUMENTS ARE ENCOUNTERED, THE ENGINEER SHALL BE NOTIFIED BEFORE SUCH MONUMENTS ARE REMOVED. THE CONTRACTOR SHALL PROTECT AND PRESERVE ALL PROPERTY MARKERS UNTIL AN OWNER OR AUTHORIZED SURVEYOR HAS WITNESSED OR REFERENCED THEIR LOCATION.
3. THE CONTRACTOR SHALL FIELD VERIFY ALL DIMENSIONS AND EXISTING CONDITIONS PRIOR TO CONSTRUCTION AND NOTIFY THE ENGINEER OF ANY DISCREPANCY IMMEDIATELY.
4. THE CONTRACTOR SHALL BE RESPONSIBLE FOR REPAIRS TO ANY UTILITY LINES AND EXISTING FACILITIES TO REMAIN THAT ARE DAMAGED AS A RESULT OF THE WORK.
5. ALL SECTIONS, DETAILS AND NOTES SHOWN ON THE DRAWINGS ARE INTENDED TO BE TYPICAL AND SHALL APPLY TO SIMILAR SITUATIONS ELSEWHERE, UNLESS OTHERWISE SHOWN.
6. ALL THE ELEVATIONS, STATIONS, AND OFFSETS SHOWN ON THE PLANS SHALL BE FIELD VERIFIED BY THE CONTRACTOR PRIOR TO CONSTRUCTION.
7. THE CONTRACTOR IS RESPONSIBLE FOR OBTAINING ALL NECESSARY PERMITS.
8. EXCESS MATERIAL, IF NOT USED FOR OTHER ON-SITE PURPOSES, SHALL BE HAULED OFF-SITE AT CONTRACTOR'S EXPENSE.
9. THE WORK AREA SHALL BE POSITIVELY DRAINED DURING CONSTRUCTION. FINAL GRADES SHALL BE PROTECTED AGAINST DAMAGE FROM EROSION, SEDIMENTATION, AND TRAFFIC.
10. THE CONTRACTOR SHALL USE ANY ON SITE MATERIAL DEEMED SUITABLE BY THE ENGINEER BEFORE ANY NEW FILL IS HAULED TO THE SITE.
11. CONTRACTOR SHALL BE RESPONSIBLE FOR LOCATING ALL EXISTING UNDERGROUND UTILITIES PRIOR TO EXCAVATION.
12. CONTRACTORS BIDDING THIS PROJECT SHALL VISIT THE SITE BEFORE BIDDING.
13. TRAFFIC SIGNS LOCATED ON EXISTING SIGNAL MAST ARMS AND POSTS SHOULD BE REMOVED SAFELY STORED AND REINSTALLED TO THE PROPOSED TRAFFIC SIGNAL POSTS OR MAST ARMS. ALL RELOCATED SIGNS AND PROPOSED SIGNS SHALL BE INSTALLED WITH SUPPORTING CHANNELS UNLESS DIRECTED OTHERWISE BY THE ENGINEER.
14. PROPOSED SIDEWALKS SHALL BE 5" PCC ON A 4" CA-6(SUB-BASE GRANULAR MATERIAL, TYPE B)
15. THE LOCATIONS AND ELEVATIONS SHOWN ON THE PLANS MAY BE MODIFIED IN THE FIELD AS NECESSARY AND SHALL IN NO WAY BE A CAUSE FOR FURTHER COMPENSATION TO THE CONTRACTOR.
16. THE CONTRACTOR SHALL BE RESPONSIBLE FOR THE PROTECTION OF ANY FENCE LOCATIONS WITHIN ROW IN THE PROJECT LIMITS.
17. ALL COORDINATE INFORMATION SHOWN IS EXPRESSED IN ILLINOIS STATE PLANE WEST ZONE (1983) COORDINATE SYSTEM.

PROJECT CONTACTS			
SCHOOLS	DISTRICT 155 (CRYSTAL LAKE)	SHANNON PODZIMEK	(815) 455-8500
	DISTRICT 47 (CRYSTAL LAKE)	DENISE BARR	(815) 788-5014
	DISTRICT 156 (MCHENRY)	SUSAN BAUMGARTNER	(815) 385-7900
	DISTRICT 15 (MCHENRY)	BECCA LATHAM	(847) 963-3204
EMS	CRYSTAL LAKE FIRE/RESCUE DEPARTMENT	PAUL DERAEDT	(815) 356-3640
	MCHENRY TOWNSHIP FIRE PROTECTION DISTRICT	STEVE SPRAKER	(815) 385-0075
	NUNDA RURAL FIRE PROTECTION DISTRICT	MICHAEL KEENAN	(815) 455-1559
STATE	ILLINOIS DEPARTMENT OF TRANSPORTATION - DISTRICT ONE	CARMEN RAMOS	(847) 705-4021
COUNTY	MCHENRY COUNTY DIVISION OF TRANSPORTATION	REBECCA BRAZAS	(815) 482-1051
	MCDOT CONSTRUCTION CONTACT	JEREMY STULL	(815) 334-4967
VILLAGES	CITY OF MCHENRY	TROY STRANGE	(815) 363-2186
	VILLAGE OF BULL VALLEY	MIKE KOCH	(815) 459-4833
	NUNDA TOWNSHIP	MIKE LESPERANCE	(815) 459-4410
UTILITIES	AT&T (DISTRIBUTION)	STEVE LARSON	(630) 573-5450
	AT&T (TRANSMISSION LONG DISTANCE)	KEN COLWELL	(630) 383-9249
	COMED ELECTRONIC PLAN SUBMITTAL	LISA ARGAST	(630) 576-7094
	NICOR GAS	PAUL EGGEN	(630) 388-2903
	CRYSTAL LAKE WATER	ABIGAIL WILGREEN	(815) 356-3605
	MCHENRY COUNTY WATER	TROY STRANGE	(815) 363-2186

HMA MIXTURE REQUIREMENTS		
LOCATION:	WALKUP ROAD	WALKUP ROAD
MIXTURE USE(S):	HMA PATCHING - 2"	BINDER COURSE - 11"
PG:	PG 64-28	PG 64-22
DESIGN AIR VOIDS:	4% @ N-70	4% @ N-70
MIXTURE COMPOSITION (GRADIENT MIXTURE)	IL 9.5	IL 19.0
FRICTION AGGREGATE:	MIXTURE D	N/A
MIXTURE WEIGHT:	112 LB/SO YD/IN	112 LB/SO YD/IN
QUALITY MANAGEMENT PROGRAM:	OC/OA	OC/OA
SUBLOT SIZE:	N/A	N/A

DESIGNED	
DRAWN	
REVIEWED	

USER NAME =	Pearc00397
DESIGNED -	NN
DRAWN -	JAP
PLOT SCALE =	2.0000' / in.
CHECKED -	
REVISOR -	
DATE =	2/17/2023
DATE -	
REVISOR -	

**STATE OF ILLINOIS
DEPARTMENT OF TRANSPORTATION**

**INDEX OF SHEETS, GENERAL NOTES,
LEGEND AND LIST OF STANDARDS**

SCALE: SHEET OF SHEETS STA. TO STA.

F.A.U. RTE.	SECTION	COUNTY	TOTAL SHEETS	SHEET NO.
0085	19-00511-00-SP	MCHENRY	45	2
	19L0111		CONTRACT NO.	61J51
		ILLINOIS	FED. AID PROJECT	

SPEC PROV.	CODE NO.	ITEM	UNIT	TOTAL QUANTITY	HILLSIDE	PLEASANT HILL	EDGEWOOD	CRYSTAL SPRINGS	MASON HILL	BULL VALLEY
					CONSTRUCTION CODE 0021					
					90% STATE (HSIP FUNDS)			10% CITY		
#	20101200	TREE ROOT PRUNING	EACH	1	1					
#	20101300	TREE PRUNING (1 TO 10 INCH DIAMETER)	EACH	1	1					
	21101615	TOPSOIL FURNISH AND PLACE, 4"	SQ YD	244	120	124				
	25200110	SODDING, SALT TOLERANT	SQ YD	244	120	124				
	28000250	TEMPORARY EROSION CONTROL SEEDING	POUND	5	3	3				
	31101000	SUBBASE GRANULAR MATERIAL, TYPE B	TON	33	18	15				
	42400200	PORTLAND CEMENT CONCRETE SIDEWALK 5 INCH	SQ FT	2,559	1,408	1,151				
	42400800	DETECTABLE WARNINGS	SQ FT	309	128	181				
	44000500	COMBINATION CURB AND GUTTER REMOVAL	FOOT	347	167	180				
	44000600	SIDEWALK REMOVAL	SQ FT	1,282	727	555				
	44201798	CLASS D PATCHES, TYPE I, 13 INCH	SQ YD	121	59	62				
	60260100	INLETS TO BE ADJUSTED	EACH	1	SPEC	SPEC	SPEC	SPEC	SPEC	SPEC
	60605000	COMBINATION CONCRETE CURB AND GUTTER, TYPE B-6.24	FOOT	347	167	180				
	67100100	MOBILIZATION	L SUM	1	0.17	0.17	0.17	0.17	0.17	0.17
	70102635	TRAFFIC CONTROL AND PROTECTION, STANDARD 701701	L SUM	1	0.17	0.17	0.17	0.17	0.17	0.17
	70102640	TRAFFIC CONTROL AND PROTECTION, STANDARD 701801	L SUM	1	0.17	0.17	0.17	0.17	0.17	0.17
	70107025	CHANGEABLE MESSAGE SIGN	CAL DA	50	SPEC	SPEC	SPEC	SPEC	SPEC	SPEC
#	72000100	SIGN PANEL - TYPE 1	SQ FT	120	38	23	15	8	8	30

#SPECIALTY ITEMS

DESIGNED	
DRAWN	
REVIEWED	

MODEL SHEET 1
FILE NAME: p:\hubs\cpc\dw\hansony.com\hansony-01\Documents\19\05\19\0111\CAD - Use MicroStation V8i or PowerGeopak 5510\RoadSheet\kquantities.dgn

USER NAME = Pearc00397	DESIGNED - NN	REVISED -
PLOT SCALE = 2,000' / in	DRAWN - NN	REVISED -
PLOT DATE = 3/16/2023	CHECKED -	REVISED -
	DATE - -	REVISED -

**STATE OF ILLINOIS
DEPARTMENT OF TRANSPORTATION**

SUMMARY OF QUANTITIES

SCALE: SHEET OF SHEETS STA. TO STA.

F.A.U. RTE.	SECTION	COUNTY	TOTAL SHEETS	SHEET NO.
0085	19-00511-00-SP	McHENRY	45	3
19L0111		CONTRACT NO.	61J51	
ILLINOIS FED. AID PROJECT				

HPSI

SPEC PROV.	CODE NO.	ITEM	UNIT	TOTAL QUANTITY	HILLSIDE	PLEASANT HILL	EDGEWOOD	CRYSTAL SPRINGS	MASON HILL	BULL VALLEY	
					CONSTRUCTION CODE 0021						
					90% STATE (HSIP FUNDS)				10% CITY		
#	78009006	MODIFIED URETHANE PAVEMENT MARKING - LINE 6"	FOOT	944	400	544					
#	78009012	MODIFIED URETHANE PAVEMENT MARKING - LINE 12"	FOOT	1,405	491	914					
#	78009024	MODIFIED URETHANE PAVEMENT MARKING - LINE 24"	FOOT	104	22	82					
	78300202	PAVEMENT MARKING REMOVAL - WATER BLASTING	SQ FT	1,119	229	890					
	81028200	UNDERGROUND CONDUIT, GALVANIZED STEEL, 2" DIA.	FOOT	212	110	56				46	
	81028220	UNDERGROUND CONDUIT, GALVANIZED STEEL, 3" DIA.	FOOT	1,025	87	201	44	87	114	492	
	81028240	UNDERGROUND CONDUIT, GALVANIZED STEEL, 4" DIA.	FOOT	691		281				410	
	81400100	HANDHOLE	EACH	3		2				1	
	81400300	DOUBLE HANDHOLE	EACH	3						3	
	81702110	ELECTRIC CABLE IN CONDUIT, 600V (XLP-TYPE USE) 1/C NO. 10	FOOT	5,796		954	922	617	581	2,722	
*	85000200	MAINTENANCE OF EXISTING TRAFFIC SIGNAL INSTALLATION	EACH	6	1	1	1	1	1	1	
	87301225	ELECTRIC CABLE IN CONDUIT, SIGNAL NO. 14 3C	FOOT	963		220	196			547	
	87301245	ELECTRIC CABLE IN CONDUIT, SIGNAL NO. 14 5C	FOOT	13,386	3,338	3,783	806	823	927	3,709	
	87301255	ELECTRIC CABLE IN CONDUIT, SIGNAL NO. 14 7C	FOOT	4,417	421	749	439	304	286	2,218	
	87301900	ELECTRIC CABLE IN CONDUIT, EQUIPMENT GROUNDING CONDUCTOR, NO. 6 1C	FOOT	2,354	243	654	70	97	103	1,187	
	87502440	TRAFFIC SIGNAL POST, GALVANIZED STEEL 10 FT.	EACH	9	5	4					
	87502500	TRAFFIC SIGNAL POST, GALVANIZED STEEL 16 FT.	EACH	12	2	3			1	6	
	87702920	STEEL COMBINATION MAST ARM ASSEMBLY AND POLE 38 FT.	EACH	1			1				
	87702930	STEEL COMBINATION MAST ARM ASSEMBLY AND POLE 40 FT.	EACH	4		2		1		1	

#SPECIALTY ITEMS

DESIGNED	
DRAWN	
REVIEWED	

MODEL SHEET 2
FILE NAME: p:\hanson\c-w\hanson\c-w\hanson\c-w\190319\0111\CAD - Use MicroStation V8i or PowerGeopak 5510\BosonSheet\kquantitytbl.dgn

USER NAME = Pearc00397	DESIGNED - NN	REVISED -
PLOT SCALE = 2,0000' / in	DRAWN - NN	REVISED -
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	DATE - -	REVISED -

**STATE OF ILLINOIS
DEPARTMENT OF TRANSPORTATION**

SUMMARY OF QUANTITIES

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F.A.U. RTE.	SECTION	COUNTY	TOTAL SHEETS	SHEET NO.
0085	19-00511-00-SP	McHENRY	45	4
	19L0111			CONTRACT NO. 61J51
		ILLINOIS	FED. AID PROJECT	

HPSI

SPEC PROV.	CODE NO.	ITEM	UNIT	TOTAL QUANTITY	HILLSIDE	PLEASANT HILL	EDGEWOOD	CRYSTAL SPRINGS	MASON HILL	BULL VALLEY
					CONSTRUCTION CODE 0021					
					90% STATE (HSIP FUNDS)			10% CITY		
	87702955	STEEL COMBINATION MAST ARM ASSEMBLY AND POLE 45 FT.	EACH	1			1			
	87702960	STEEL COMBINATION MAST ARM ASSEMBLY AND POLE 46 FT.	EACH	2					1	1
	87702970	STEEL COMBINATION MAST ARM ASSEMBLY AND POLE 48 FT.	EACH	1						1
	87702980	STEEL COMBINATION MAST ARM ASSEMBLY AND POLE 50 FT.	EACH	1						1
	87702990	STEEL COMBINATION MAST ARM ASSEMBLY AND POLE 54 FT.	EACH	1						1
	87800100	CONCRETE FOUNDATION, TYPE A	FOOT	84	28	28			4	24
	87800415	CONCRETE FOUNDATION, TYPE E 36-INCH DIAMETER	FOOT	134		26	26	13	13	56
	87900200	DRILL EXISTING HANDHOLE	EACH	21	8	8	2	1	2	
	88040070	SIGNAL HEAD, POLYCARBONATE, LED, 1-FACE, 3-SECTION, BRACKET MOUNTED	EACH	36	6	6	4	7	6	7
	88040090	SIGNAL HEAD, POLYCARBONATE, LED, 1-FACE, 3-SECTION, MAST ARM MOUNTED	EACH	35	4	8	8	4	4	7
	88040110	SIGNAL HEAD, POLYCARBONATE, LED, 1-FACE, 4-SECTION, BRACKET MOUNTED	EACH	14	4	2	2	1	1	4
	88040120	SIGNAL HEAD, POLYCARBONATE, LED, 1-FACE, 4-SECTION, MAST ARM MOUNTED	EACH	14	4	2	2	1	1	4
	88102717	PEDESTRIAN SIGNAL HEAD, LED, 1-FACE, BRACKET MOUNTED WITH COUNTDOWN TIMER	EACH	16	8	8				
	88200510	TRAFFIC SIGNAL BACKPLATE, RETROREFLECTIVE	EACH	99	18	18	16	13	12	22
	88700200	LIGHT DETECTOR	EACH	4						4
*	89501400	RELOCATE EXISTING EMERGENCY VEHICLE PRIORITY SYSTEM, DETECTOR UNIT	EACH	4		2	2			
*	89502210	MODIFY EXISTING CONTROLLER CABINET	EACH	5	1	1	1	1	1	
*	89502375	REMOVE EXISTING TRAFFIC SIGNAL EQUIPMENT	EACH	6	1	1	1	1	1	1

#SPECIALTY ITEMS

DESIGNED	
DRAWN	
REVIEWED	

MODEL SHEET 3
FILE NAME: p:\hanson\c-w\hantley\com\hanson\p-01\Documents\19\0011\CAD - Use MicroStation V8i or PowerGeopak 5510\RoadSheet\kquantities.dgn

USER NAME = Pearc00397	DESIGNED - NN	REVISED -
PLOT SCALE = 2,0000' / in	DRAWN - NN	REVISED -
PLOT DATE = 3/16/2023	CHECKED -	REVISED -
	DATE - -	REVISED -

**STATE OF ILLINOIS
DEPARTMENT OF TRANSPORTATION**

SUMMARY OF QUANTITIES

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F.A.U. RTE.	SECTION	COUNTY	TOTAL SHEETS	SHEET NO.
0085	19-00511-00-SP	McHENRY	45	5
	19L0111			
ILLINOIS FED. AID PROJECT			CONTRACT NO. 61J51	

HPSI

SPEC PROV.	CODE NO.	ITEM	UNIT	TOTAL QUANTITY	HILLSIDE	PLEASANT HILL	EDGEWOOD	CRYSTAL SPRINGS	MASON HILL	BULL VALLEY
					CONSTRUCTION CODE 0021					
					90% STATE (HSIP FUNDS)			10% CITY		
*	X0321973	MODIFY EXISTING SERVICE INSTALLATION	EACH	6	1	1	1	1	1	1
*	X0322281	WIDE AREA VIDEO DETECTION SYSTEM COMPLETE	EACH	1						1
*	X0323986	RELOCATE EXISTING VIDEO VEHICLE DETECTOR	EACH	8		2	2	2	2	
*	X0324085	EMERGENCY VEHICLE PRIORITY SYSTEM LINE SENSOR CABLE, NO. 20 3/C	FOOT	963		220	196			547
*	X0324599	ROD AND CLEAN EXISTING CONDUIT	FOOT	826	243	240	120	121	102	
	X0338320	CONCRETE COLOR ADDITIVE	CU YD	0.6	0.2	0.3				
*	X1400107	FULL-ACTUATED CONTROLLER AND TYPE SUPER P CABINET	EACH	1						1
*	X1400150	SERVICE INSTALLATION, GROUND MOUNTED, METERED	EACH	6	1	1	1	1	1	1
*	X1400238	LUMINAIRE, LED, SPECIAL	EACH	10		2	2	1	1	4
*	X2130010	EXPLORATION TRENCH, SPECIAL	FOOT	300	50	50	50	50	50	50
*	X8570215	FULL-ACTUATED CONTROLLER IN EXISTING CABINET	EACH	5	1	1	1	1	1	
*	X8760200	ACCESSIBLE PEDESTRIAN SIGNALS	EACH	16	8	8				
*	X8809005	LED SIGNAL FACE, LENS COVER	EACH	99	18	18	16	13	12	22
*	X8870300	EMERGENCY VEHICLE PRIORITY SYSTEM	EACH	1						1
*	XX005937	LED INTERNALLY ILLUMINATED STREET NAME SIGN	EACH	22	4	4	4	3	3	4
*	Z0013798	CONSTRUCTION LAYOUT	L SUM	1	0.17	0.17	0.17	0.17	0.17	0.17
*	Z0007430	TEMPORARY SIDEWALK	SQ FT	2,559	1,408	1,151				
Δ	*	Z0076600	TRAINEES	HOUR	500	SPEC	SPEC	SPEC	SPEC	SPEC
Δ	*	Z0076604	TRAINEES TRAINING PROGRAM GRADUATE	HOUR	500	SPEC	SPEC	SPEC	SPEC	SPEC

#SPECIALTY ITEMS

Δ 0042

DESIGNED	
DRAWN	
REVIEWED	

MODEL SHEET 4
FILE NAME: p:\hanson\c-w\hantley.com\hanson\p-01\Documents\19\05\19\0111\CAD - Use MicroStation V8i or PowerGeopak 5510\RoadSheet\kquantities.dgn

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PLOT DRIVER NAME = ... \HANSON.pdf_300dpi.plt:fg

USER NAME = Pearc00397	DESIGNED - NN	REVISED -
	DRAWN - NN	REVISED -
PLOT SCALE = 2,000' / in	CHECKED -	REVISED -
PLOT DATE = 3/16/2023	DATE - -	REVISED -

**STATE OF ILLINOIS
DEPARTMENT OF TRANSPORTATION**



SUMMARY OF QUANTITIES

SCALE: SHEET OF SHEETS STA. TO STA.

F.A.U. RTE.	SECTION	COUNTY	TOTAL SHEETS	SHEET NO.
0085	19-00511-00-SP	McHENRY	45	6
19L0111		CONTRACT NO.	61J51	
ILLINOIS FED. AID PROJECT				

HPSI

HILLSIDE ROAD INTERSECTION REMOVAL QUANTITIES			
44000500	COMBINATION CURB AND GUTTER REMOVAL	FOOT	167
44000600	SIDEWALK REMOVAL	SQ. FT	727
78300202	PAVEMENT MARKING REMOVAL - WATER BLASTING	SQ. FT	229

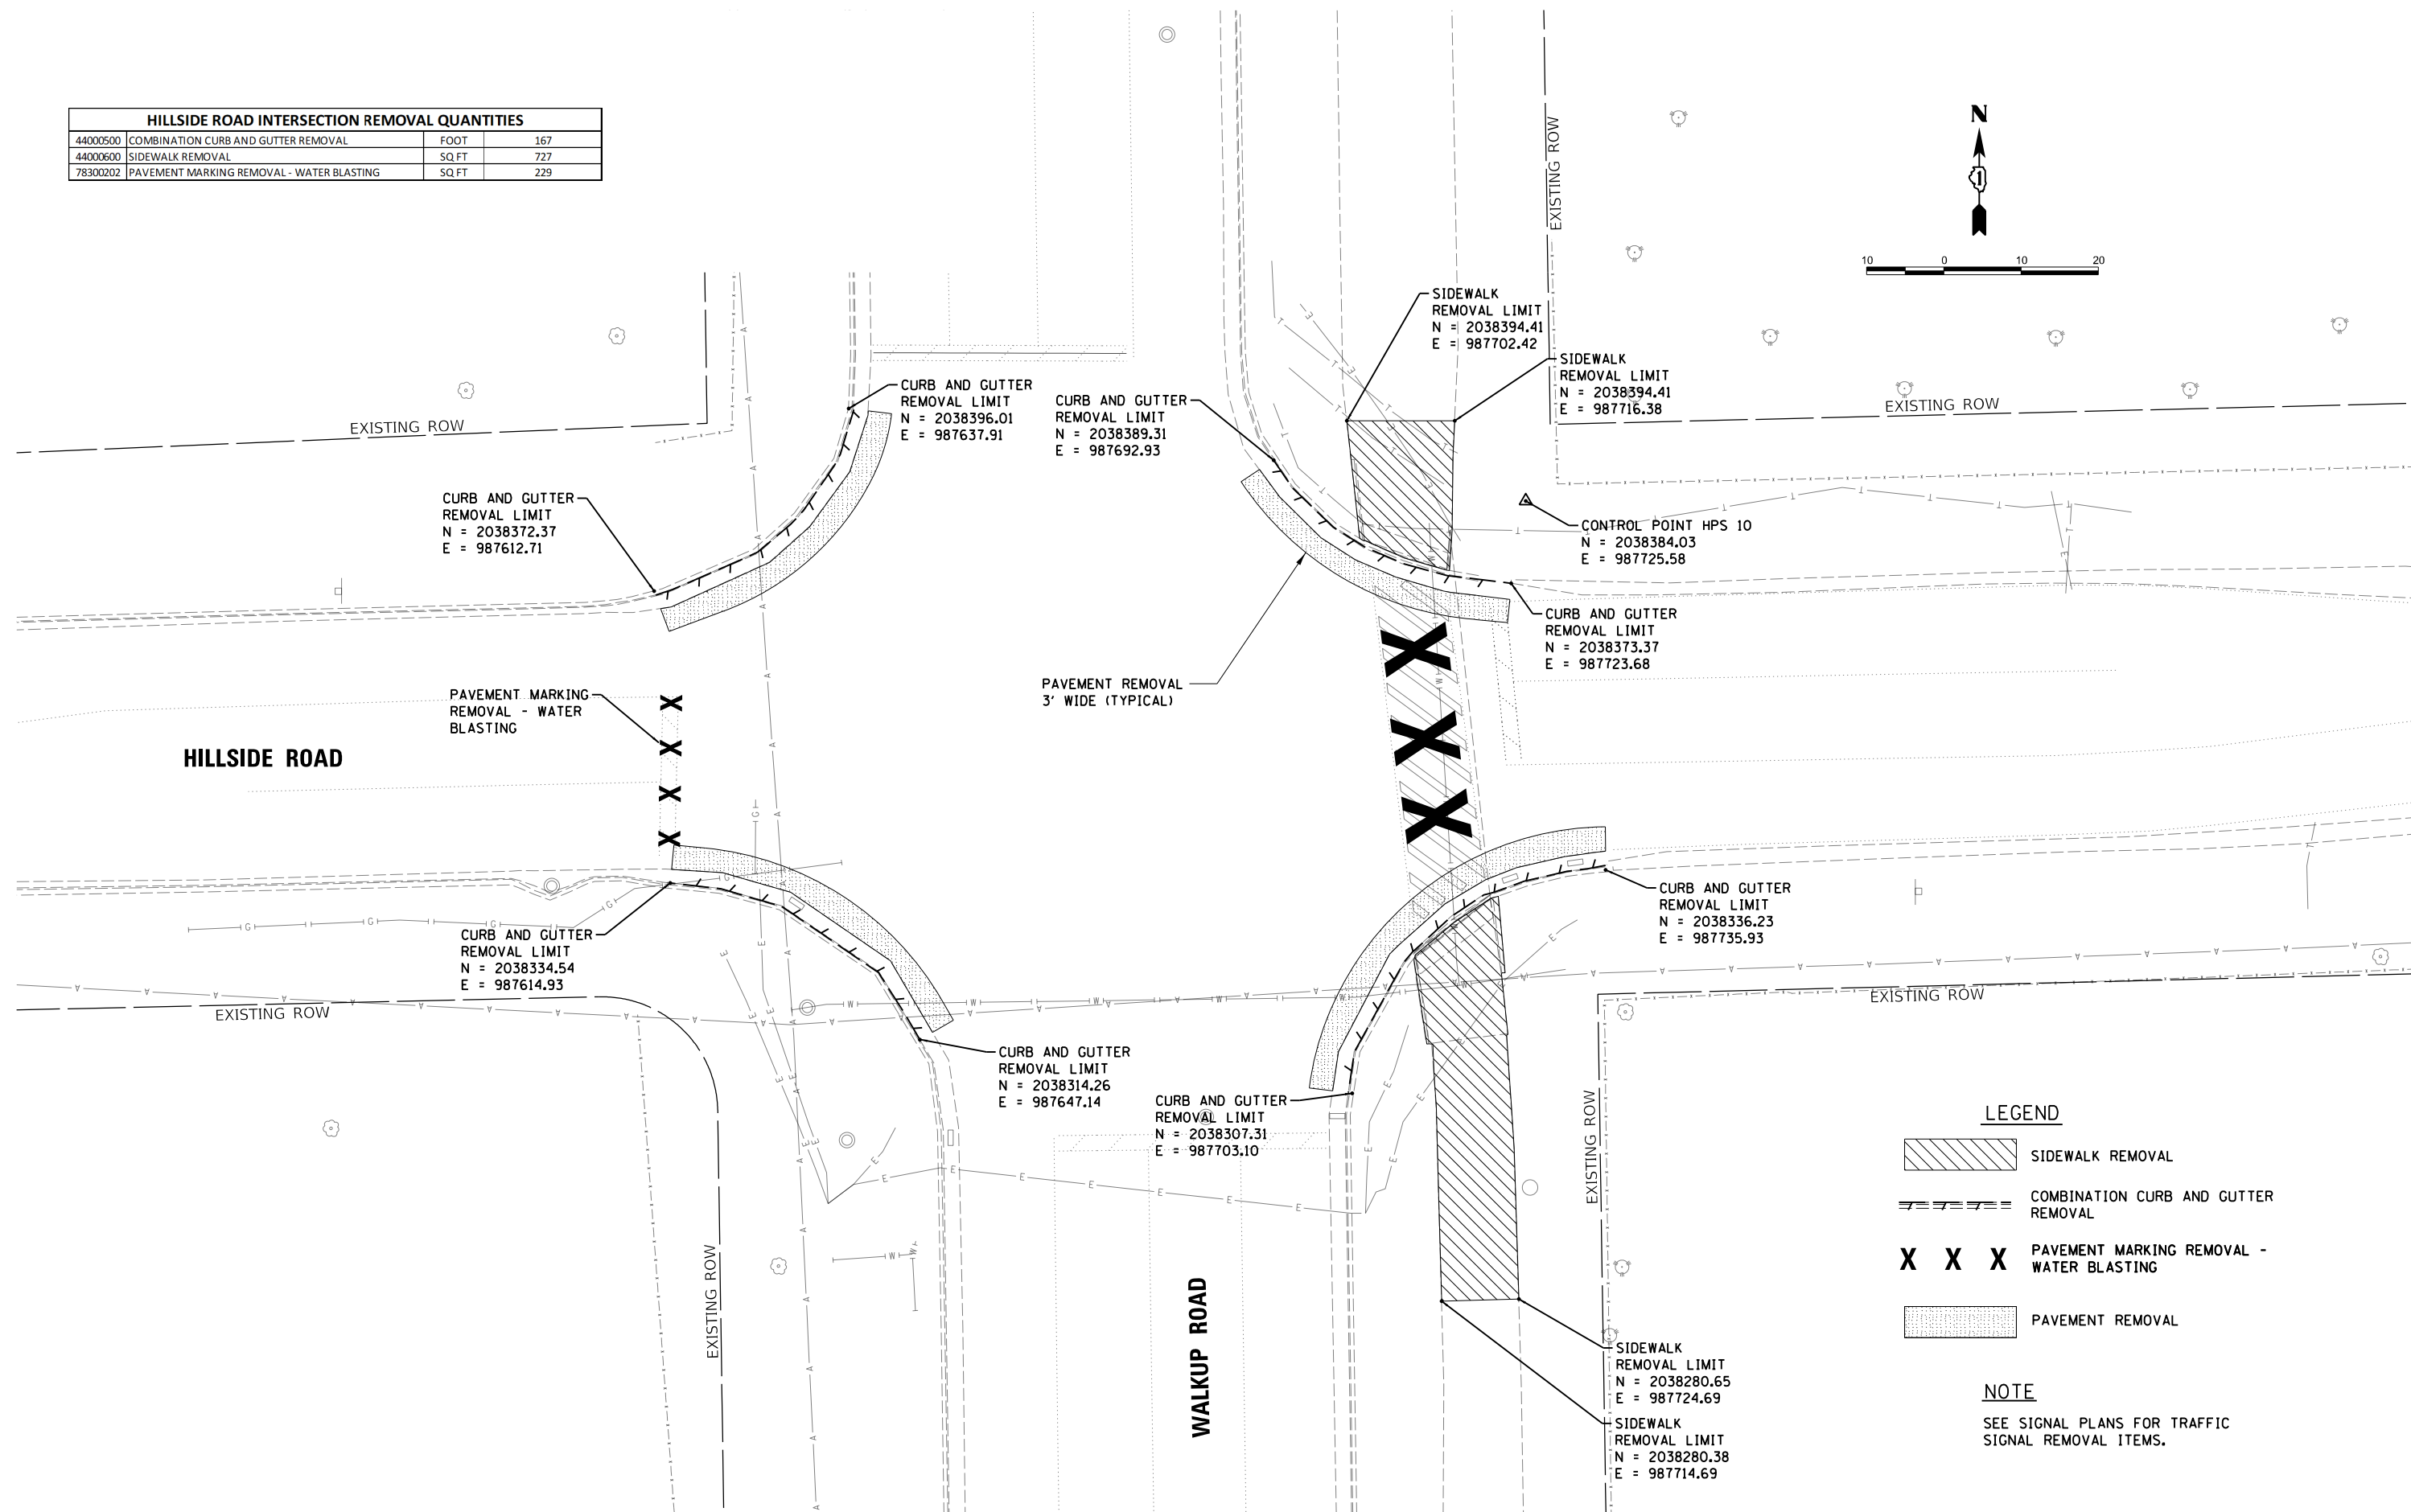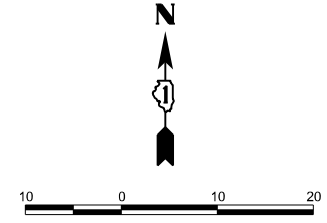

MODEL: Hillside Road
 FILE: h:\a\c\p\19\0511\190511\190511\CAD - Use MicroStation V8i or PowerGeopak 5510\RoadSheet1.dwg
 User: Michael J. Hendry, m.hendry@hanson.com
 Date: 3/16/2023

LEGEND

- SIDEWALK REMOVAL
- COMBINATION CURB AND GUTTER REMOVAL
- X X X** PAVEMENT MARKING REMOVAL - WATER BLASTING
- PAVEMENT REMOVAL

NOTE

SEE SIGNAL PLANS FOR TRAFFIC SIGNAL REMOVAL ITEMS.

DESIGNED	
DRAWN	
REVIEWED	

USER NAME = Pearc00397	DESIGNED -	REVISED -
	DRAWN - JAP	REVISED -
PLOT SCALE = 20.0000' / in.	CHECKED -	REVISED -
PLOT DATE = 3/16/2023	DATE -	REVISED -

**STATE OF ILLINOIS
DEPARTMENT OF TRANSPORTATION**

**HILLSIDE ROAD / WALKUP ROAD
REMOVAL SHEET**



SCALE: 1"=10' SHEET OF SHEETS STA. TO STA.

F.A.U. RTE.	SECTION	COUNTY	TOTAL SHEETS	SHEET NO.
0085	19-00511-00-SP	McHENRY	45	7
	19L0111			CONTRACT NO. 61J51

HPS1



MODEL: Pleasant Hill Road
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 PENTABLE NAME = ...\\pen\LargeFormat_Plotter.tbl
 PLOT DRIVER NAME = ...\\HANSON.pdf_300dpi.pltcfgr

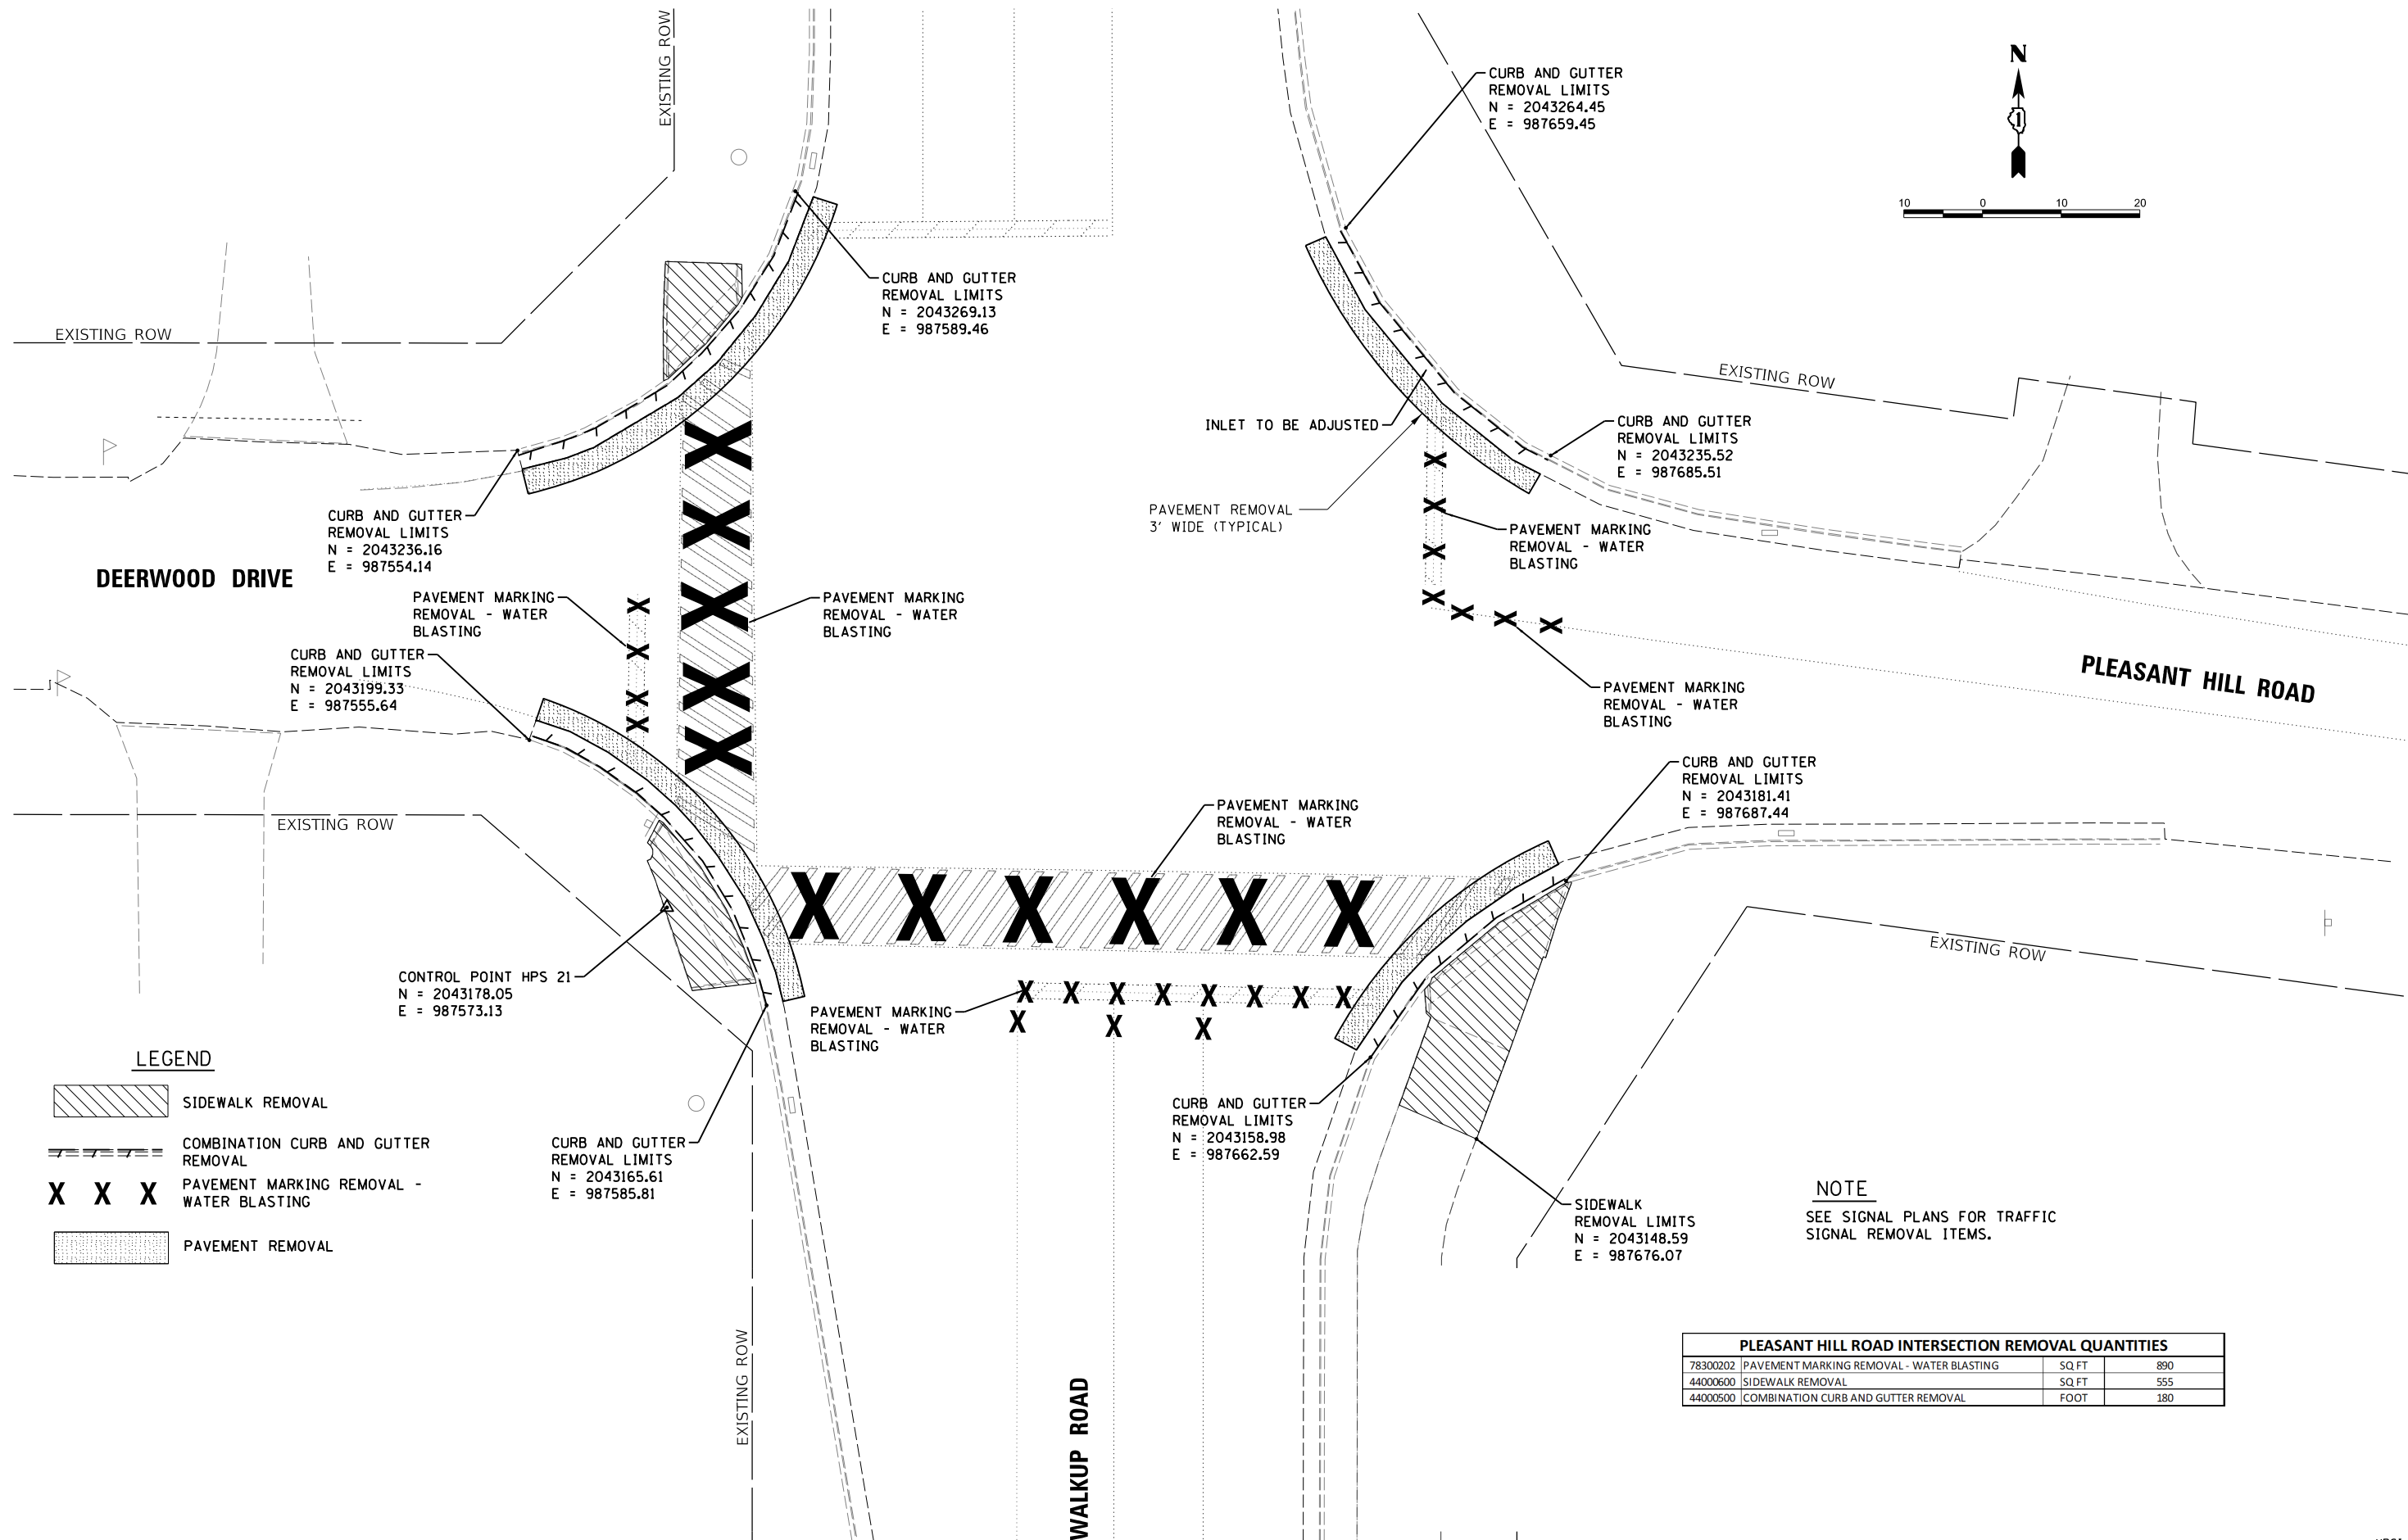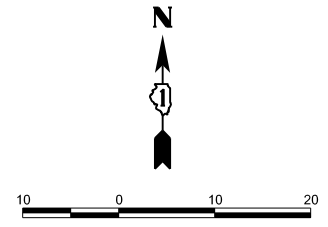

PLEASANT HILL ROAD INTERSECTION REMOVAL QUANTITIES			
78300202	PAVEMENT MARKING REMOVAL - WATER BLASTING	SQ FT	890
44000600	SIDEWALK REMOVAL	SQ FT	555
44000500	COMBINATION CURB AND GUTTER REMOVAL	FOOT	180

DESIGNED	
DRAWN	
REVIEWED	

USER NAME = Pearc00397	DESIGNED -	REVISED -
	DRAWN - JAP	REVISED -
PLOT SCALE = 20.0000' / in.	CHECKED -	REVISED -
PLOT DATE = 3/16/2023	DATE -	REVISED -

**STATE OF ILLINOIS
DEPARTMENT OF TRANSPORTATION**



**PLEASANT HILL ROAD / WALKUP ROAD
REMOVAL SHEET**

SCALE: 1"=10' SHEET OF SHEETS STA. TO STA.

F.A.U. RTE.	SECTION	COUNTY	TOTAL SHEETS	SHEET NO.
0085	19-00511-00-SP	McHENRY	45	8
	19L0111		CONTRACT NO.	61J51
		ILLINOIS	FED. AID PROJECT	

HPS1

HILLSIDE ROAD INTERSECTION QUANTITIES			
21101615	TOPSOIL FURNISH AND PLACE, 4"	SQ YD	120
25200110	SODDING, SALT TOLERANT	SQ YD	120
28000250	TEMPORARY EROSION CONTROL SEEDING	POUND	3
31101000	SUBBASE GRANULAR MATERIAL, TYPE B	TON	18
42400200	PORTLAND CEMENT CONCRETE SIDEWALK 5 INCH	SQ FT	1408
42400800	DETECTABLE WARNINGS	SQ FT	128
44201798	CLASS D PATCHES, TYPE I, 13 INCH	SQ YD	59
60605000	COMBINATION CONCRETE CURB AND GUTTER, TYPE B-6.24	FOOT	167
78009006	MODIFIED URETHANE PAVEMENT MARKING - LINE 6"	FOOT	400
78009012	MODIFIED URETHANE PAVEMENT MARKING - LINE 12"	FOOT	491
78009024	MODIFIED URETHANE PAVEMENT MARKING - LINE 24"	FOOT	22
X0338320	CONCRETE COLOR ADDITIVE	CU YD	0.2
Z0007430	TEMPORARY SIDEWALK	SQ FT	1408

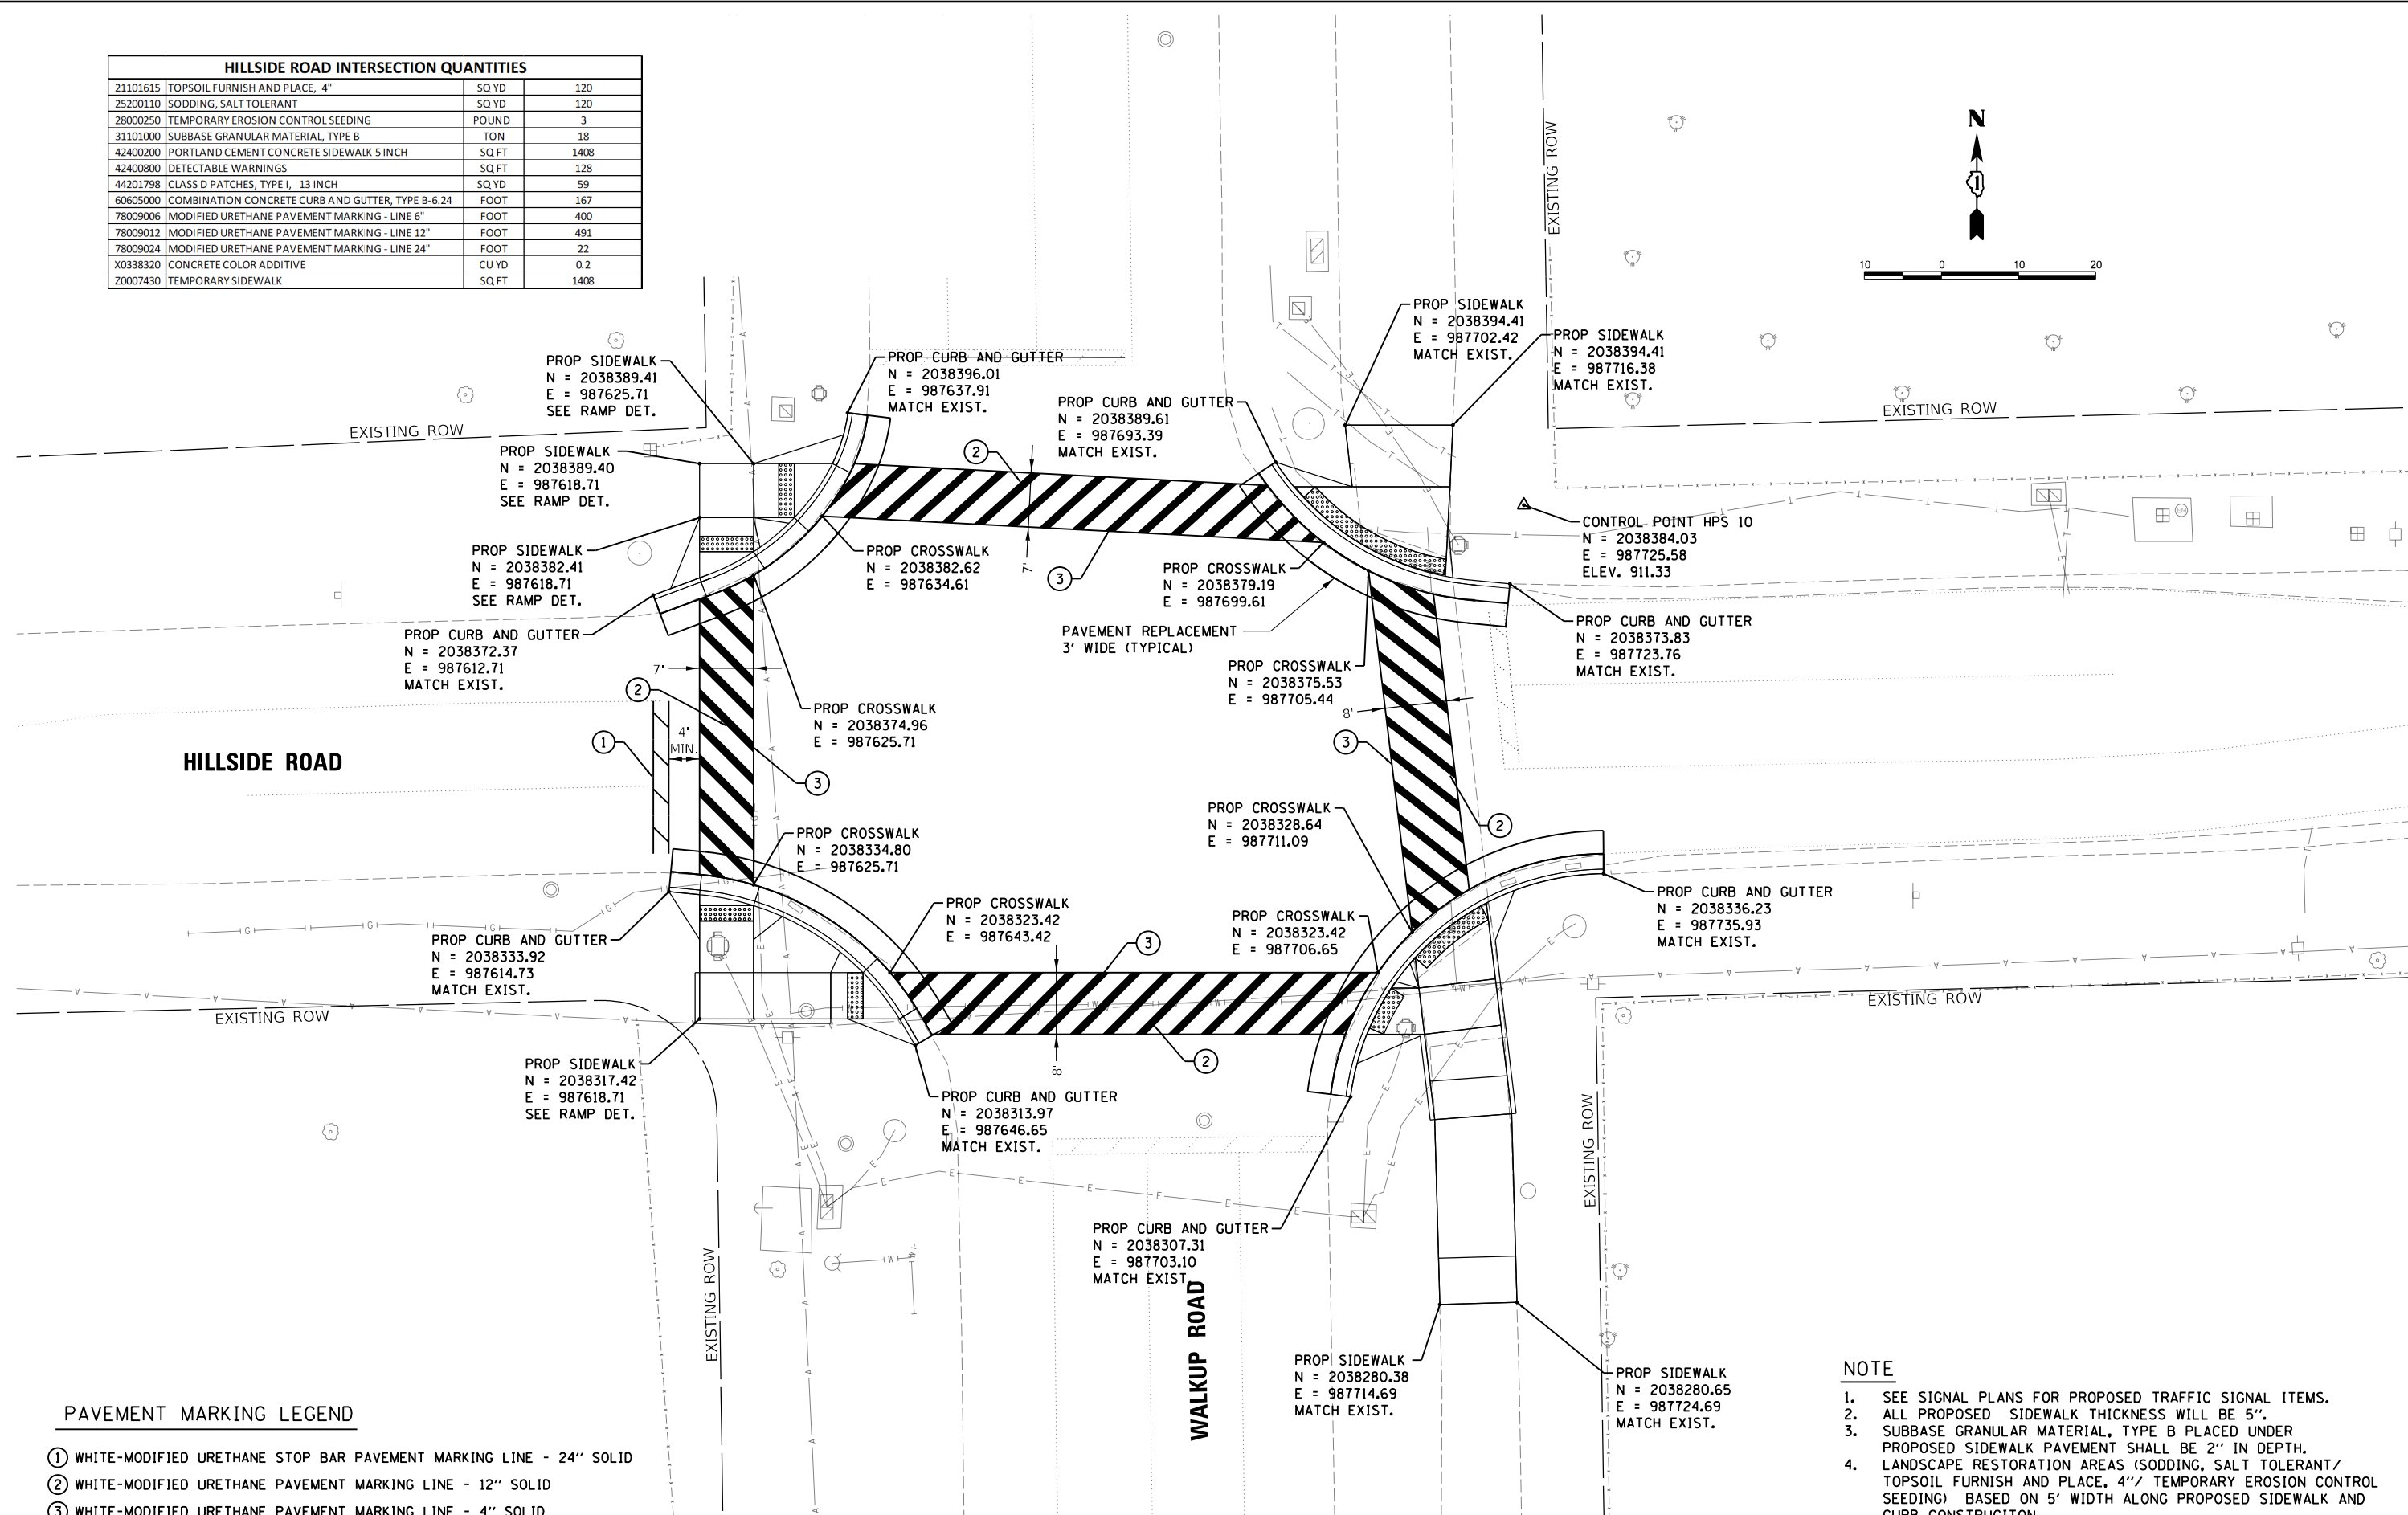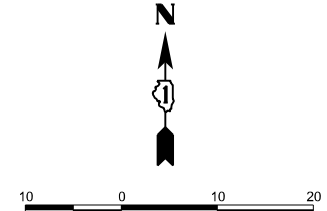

MODEL: Hillside Road
 FILE: h:\a\c\p\19\0111\CAD - Use MicroStation V8i or PowerGeopak 5510\Road\Sheet\01\Drawings\Hanson Professional Services Inc. 2023

HILLSIDE ROAD

WALKUP ROAD

PAVEMENT MARKING LEGEND

- ① WHITE-MODIFIED URETHANE STOP BAR PAVEMENT MARKING LINE - 24" SOLID
- ② WHITE-MODIFIED URETHANE PAVEMENT MARKING LINE - 12" SOLID
- ③ WHITE-MODIFIED URETHANE PAVEMENT MARKING LINE - 4" SOLID

NOTE

1. SEE SIGNAL PLANS FOR PROPOSED TRAFFIC SIGNAL ITEMS.
2. ALL PROPOSED SIDEWALK THICKNESS WILL BE 5".
3. SUBBASE GRANULAR MATERIAL, TYPE B PLACED UNDER PROPOSED SIDEWALK PAVEMENT SHALL BE 2" IN DEPTH.
4. LANDSCAPE RESTORATION AREAS (SODDING, SALT TOLERANT/TOPSOIL FURNISH AND PLACE, 4"/ TEMPORARY EROSION CONTROL SEEDING) BASED ON 5' WIDTH ALONG PROPOSED SIDEWALK AND CURB CONSTRUCTION.

DESIGNED	
DRAWN	
REVIEWED	

USER NAME =	Pearc00397
PLOT SCALE =	20.0000' / in.
PLOT DATE =	3/16/2023

DESIGNED -	REVISD -
DRAWN - JAP	REVISD -
CHECKED -	REVISD -
DATE -	REVISD -

**STATE OF ILLINOIS
DEPARTMENT OF TRANSPORTATION**

**HILLSIDE ROAD / WALKUP ROAD
PLAN SHEET**



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F.A.U. RTE.	SECTION	COUNTY	TOTAL SHEETS	SHEET NO.
0085	19-00511-00-SP	McHENRY	45	9
			CONTRACT NO.	61J51
			ILLINOIS	FED. AID PROJECT

HPS1



MODEL: Pleasant Hill Road
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 PLOT DATE: 3/16/2023
 PLOT DRIVER NAME: ...\\han\LargeFormat_Plotter.tbl

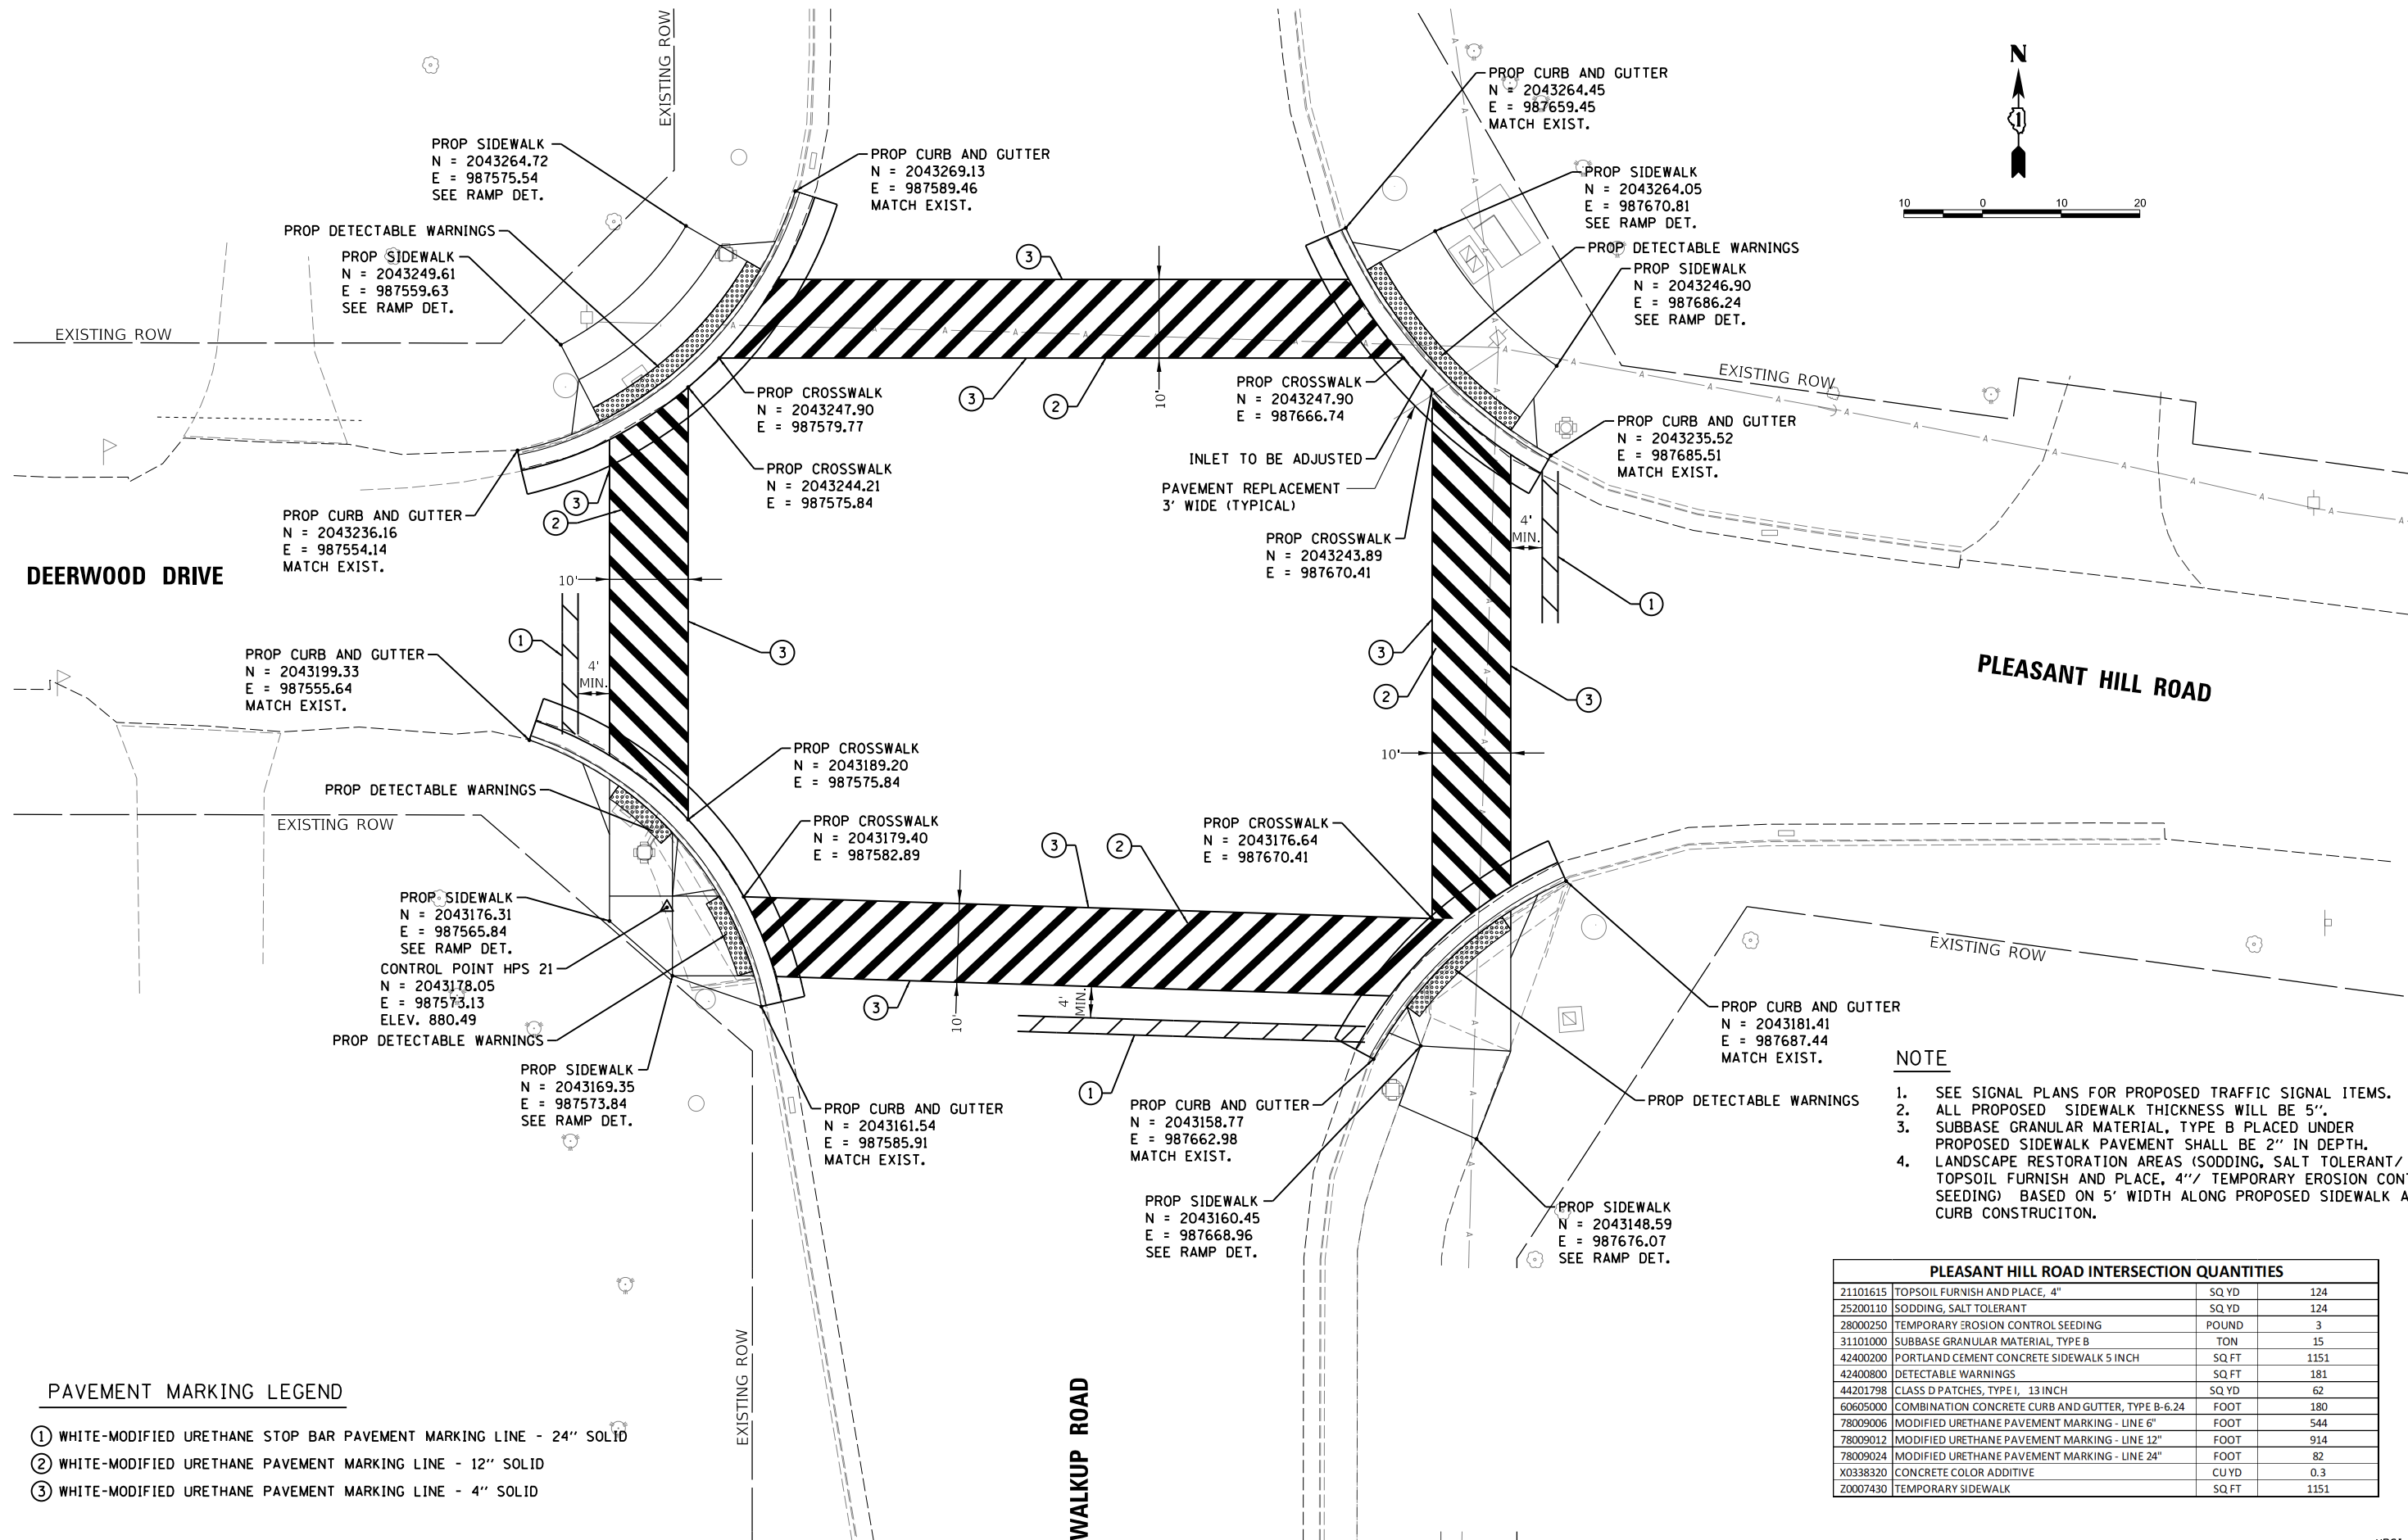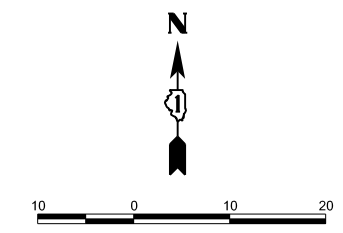

DEERWOOD DRIVE

PLEASANT HILL ROAD

WALKUP ROAD

PAVEMENT MARKING LEGEND

- ① WHITE-MODIFIED URETHANE STOP BAR PAVEMENT MARKING LINE - 24" SOLID
- ② WHITE-MODIFIED URETHANE PAVEMENT MARKING LINE - 12" SOLID
- ③ WHITE-MODIFIED URETHANE PAVEMENT MARKING LINE - 4" SOLID

NOTE

1. SEE SIGNAL PLANS FOR PROPOSED TRAFFIC SIGNAL ITEMS.
2. ALL PROPOSED SIDEWALK THICKNESS WILL BE 5".
3. SUBBASE GRANULAR MATERIAL, TYPE B PLACED UNDER PROPOSED SIDEWALK PAVEMENT SHALL BE 2" IN DEPTH.
4. LANDSCAPE RESTORATION AREAS (SODDING, SALT TOLERANT/TOPSOIL FURNISH AND PLACE, 4" TEMPORARY EROSION CONTROL SEEDING) BASED ON 5' WIDTH ALONG PROPOSED SIDEWALK AND CURB CONSTRUCTION.

PLEASANT HILL ROAD INTERSECTION QUANTITIES			
21101615	TOPSOIL FURNISH AND PLACE, 4"	SQ.YD	124
25200110	SODDING, SALT TOLERANT	SQ.YD	124
28000250	TEMPORARY EROSION CONTROL SEEDING	POUND	3
31101000	SUBBASE GRANULAR MATERIAL, TYPE B	TON	15
42400200	PORTLAND CEMENT CONCRETE SIDEWALK 5 INCH	SQ.FT	1151
42400800	DETECTABLE WARNINGS	SQ.FT	181
44201798	CLASS D PATCHES, TYPE I, 13 INCH	SQ.YD	62
60605000	COMBINATION CONCRETE CURB AND GUTTER, TYPE B-6.24	FOOT	180
78009006	MODIFIED URETHANE PAVEMENT MARKING - LINE 6"	FOOT	544
78009012	MODIFIED URETHANE PAVEMENT MARKING - LINE 12"	FOOT	914
78009024	MODIFIED URETHANE PAVEMENT MARKING - LINE 24"	FOOT	82
X0338320	CONCRETE COLOR ADDITIVE	CU.YD	0.3
Z0007430	TEMPORARY SIDEWALK	SQ.FT	1151

DESIGNED	
DRAWN	
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USER NAME = Pearc00397	DESIGNED -	REVISED -
	DRAWN - JAP	REVISED -
PLOT SCALE = 20.0000' / in.	CHECKED -	REVISED -
PLOT DATE = 3/16/2023	DATE -	REVISED -

**STATE OF ILLINOIS
DEPARTMENT OF TRANSPORTATION**

**PLEASANT HILL ROAD / WALKUP ROAD
PLAN SHEET**


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F.A.U. RTE.	SECTION	COUNTY	TOTAL SHEETS	SHEET NO.
0085	19-00511-00-SP	McHENRY	45	10
			CONTRACT NO.	61J51
			ILLINOIS	FED. AID PROJECT


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PLOT DRIVER NAME: ...\\pen\LargeFormat_Plotter.tbl



NOTE
SEE SIGNAL PLANS FOR PROPOSED TRAFFIC SIGNAL ITEMS.

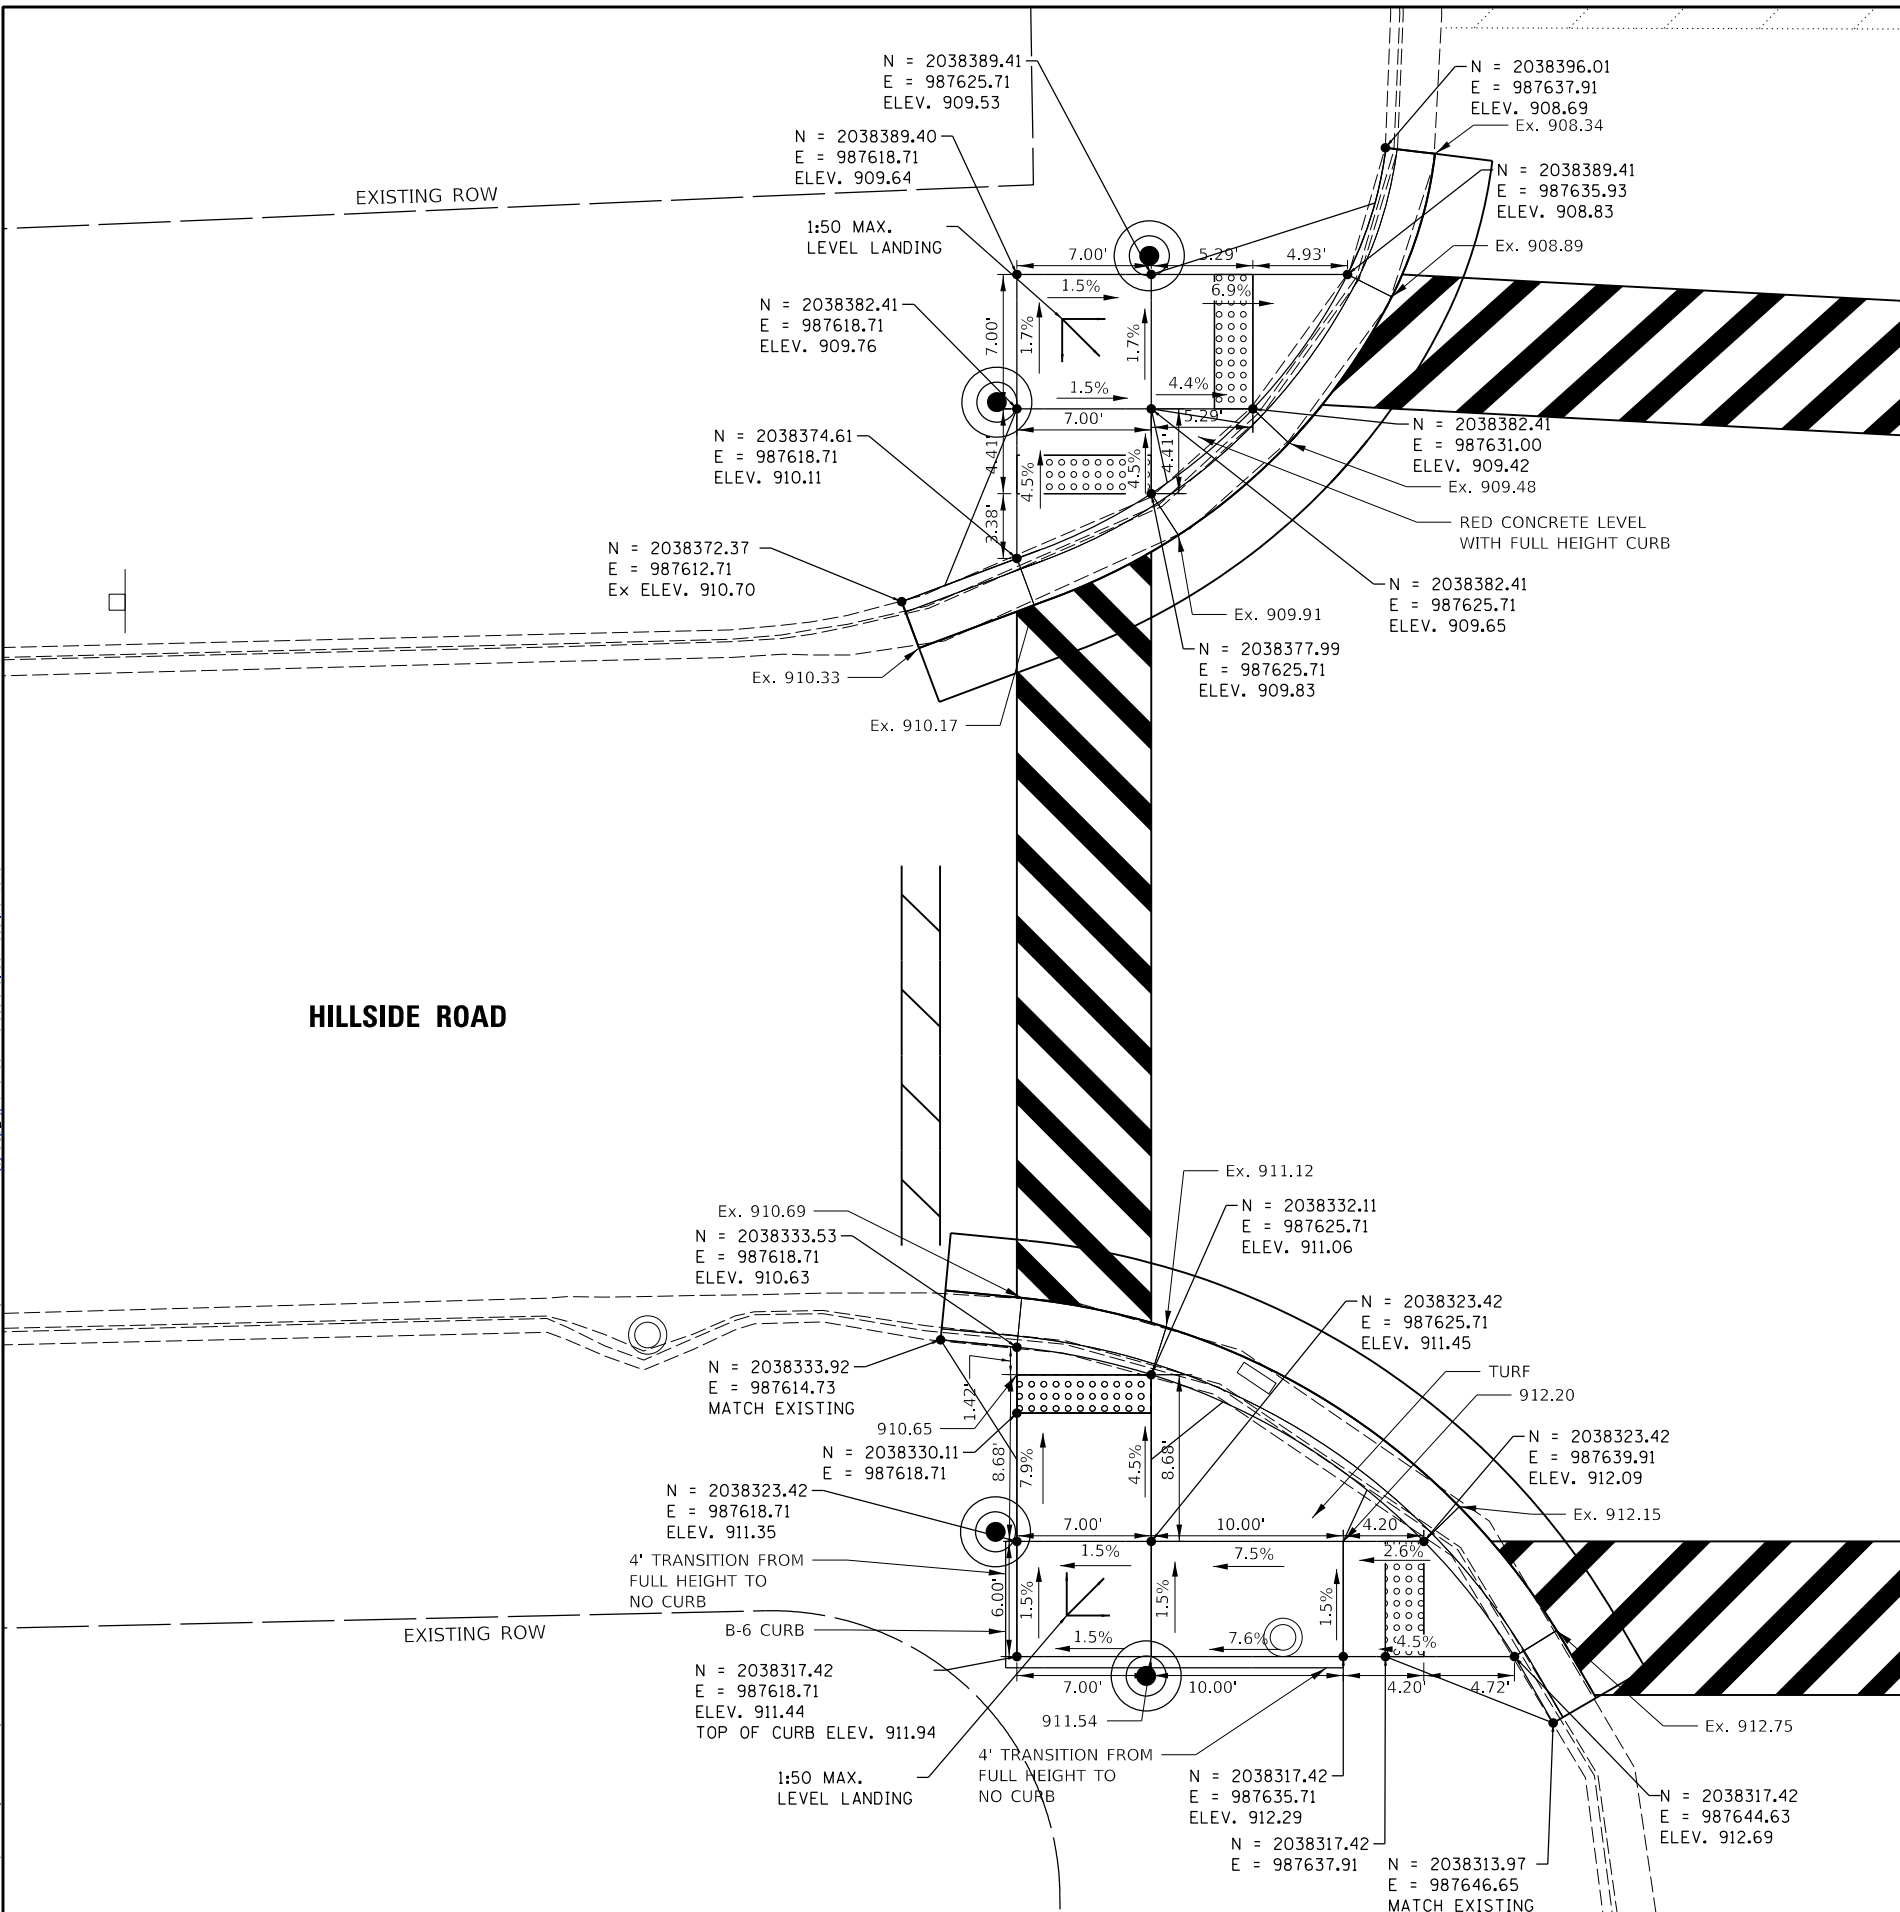

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USER NAME =	Pearc00397
DESIGNED -	NN
DRAWN -	NN
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REVIS	-
REVIS	-

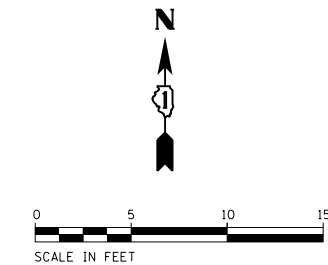**STATE OF ILLINOIS
DEPARTMENT OF TRANSPORTATION**

**HILLSIDE ROAD / WALKUP ROAD WEST RAMPS
RAMP GRADING SHEET**

SCALE: 1"=5' SHEET OF SHEETS STA. TO STA.


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0085	19-00511-00-SP	McHENRY	45	11
19L0111		CONTRACT NO. 61J51		
ILLINOIS		FED. AID PROJECT		

HPS1



MODEL: Hillside_Road_Est
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WALKUP ROAD

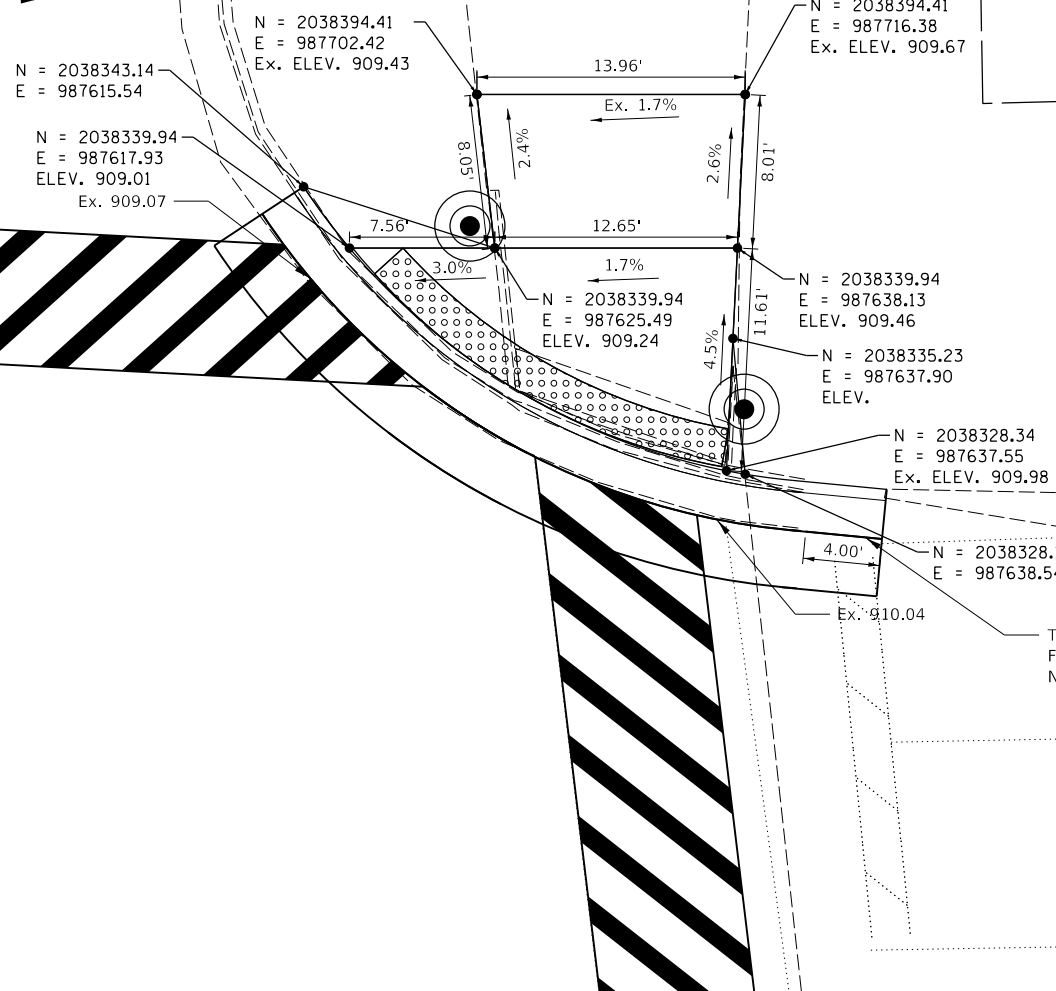


NOTE
 SEE SIGNAL PLANS FOR PROPOSED
 TRAFFIC SIGNAL ITEMS.




HILLSIDE ROAD

WALKUP ROAD

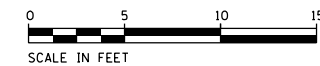

HILLSIDE ROAD

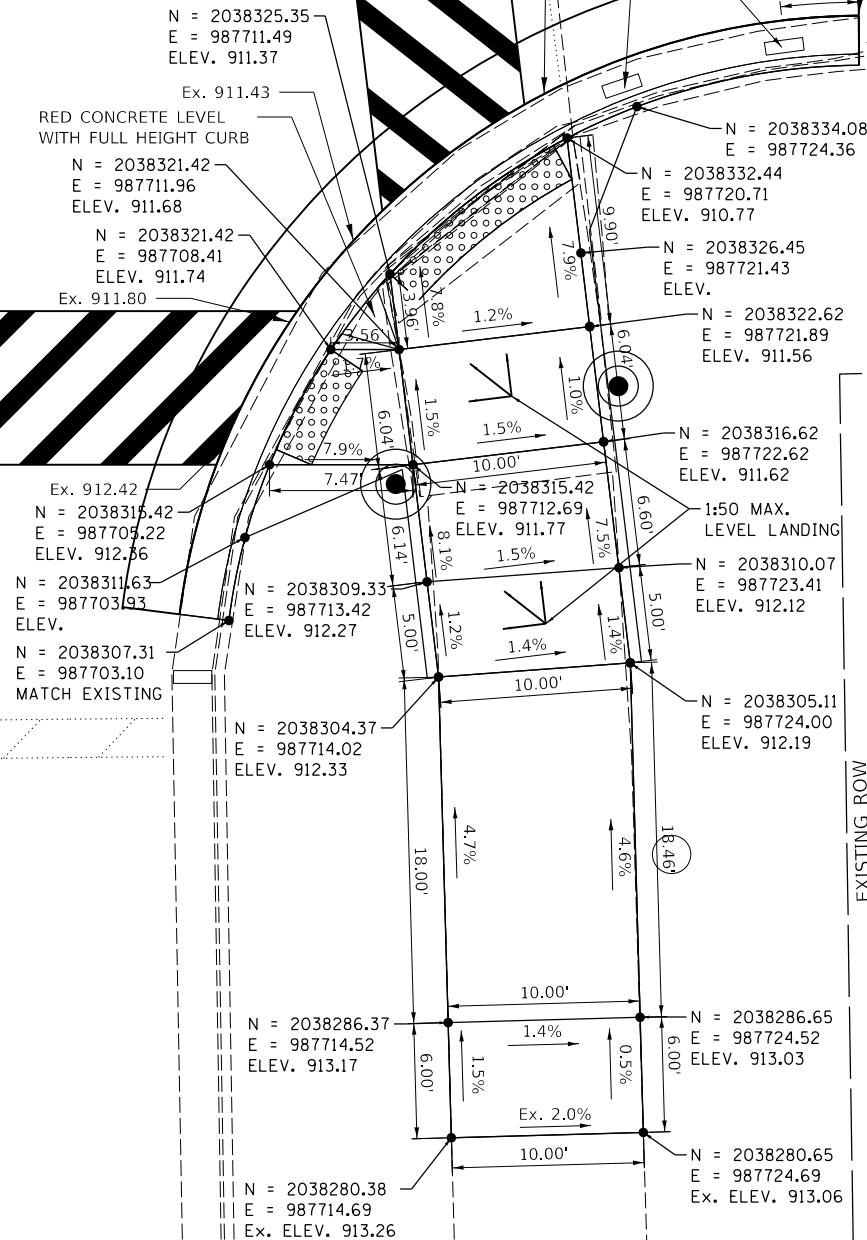

STATE OF ILLINOIS
 DEPARTMENT OF TRANSPORTATION

HILLSIDE ROAD / WALKUP ROAD EAST RAMP
 RAMP GRADING SHEET

SCALE: 1"=5' SHEET OF SHEETS STA. TO STA.

F.A.U. RTE.	SECTION	COUNTY	TOTAL SHEETS	SHEET NO.
0085	19-00511-00-SP	McHENRY	45	12
19L0111		CONTRACT NO.		61J51
ILLINOIS FED. AID PROJECT				

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REVIEWED	

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PLOT DRIVER NAME = ...\\hanson.pdf_300dpi.pltcf



NOTE
SEE SIGNAL PLANS FOR PROPOSED TRAFFIC SIGNAL ITEMS.

DEERWOOD DRIVE

PLEASANT HILL ROAD

TRANSITION FROM FULL HEIGHT TO NO CURB

Ex. 880.18

N = 2043199.33
E = 987555.64
ELEV. 880.98

N = 2043165.39
E = 987667.23
ELEV. 880.12

N = 2043194.31
E = 987565.84
ELEV. 880.61

N = 2043162.11
E = 987664.94

Ex. 880.71
N = 2043142.56
E = 987583.84
ELEV. 880.65

N = 2043181.41
E = 987687.44
MATCH EXISTING
N = 2043179.65
E = 987683.85

N = 2043177.62
E = 987680.41
ELEV. 880.41

N = 2043171.62
E = 987680.41

1:50 MAX. LEVEL LANDING

1:50 MAX. LEVEL LANDING

N = 2043179.49
E = 987565.84
ELEV. 880.71

N = 2043158.77
E = 987662.98
MATCH EXISTING

N = 2043159.78
E = 987680.1
ELEV. 880.29

N = 2043160.45
E = 987668.96
ELEV. 880.17

N = 2043176.31
E = 987565.84
ELEV. 880.72

N = 2043152.92
E = 987666.26
Ex. ELEV. 880.12

N = 2043148.59
E = 987676.07
Ex. ELEV. 879.91

1:50 MAX. LEVEL LANDING

N = 2043169.35
E = 987573.84
ELEV. 880.59

N = 2043134.49
E = 987583.84
ELEV. 880.69

N = 2043134.49
E = 987589.87
ELEV. 880.59
Ex. 880.65

Ex. 880.49
N = 2043169.35
E = 987584.23
ELEV. 880.43

N = 2043120.46
E = 987595.15
MATCH EXISTING

Ex. 880.71
N = 2043142.56
E = 987583.84
ELEV. 880.65

RED CONCRETE LEVEL WITH FULL HEIGHT CURB

DESIGNED	
DRAWN	
REVIEWED	

USER NAME	= Pearc00397
PLOT SCALE	= 10.0000 ' / in.
PLOT DATE	= 2/17/2023

DESIGNED	- NN	REVISION	-
DRAWN	- NN	REVISION	-
CHECKED	- KNB	REVISION	-
DATE	-	REVISION	-

STATE OF ILLINOIS
DEPARTMENT OF TRANSPORTATION

PLEASANT HILL ROAD / WALKUP ROAD SOUTH RAMPS
RAMP GRADING SHEET

SCALE: 1"=5' SHEET OF SHEETS STA. TO STA.

F.A.U. RTE.	SECTION	COUNTY	TOTAL SHEETS	SHEET NO.
0085	19-00511-00-SP	McHENRY	45	13
19L0111		CONTRACT NO. 61J51		



MODEL: Pleasant Hill Road
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PENTABLE NAME = ...pen\LargeFormat_Plotter.tbl

PLOT DRIVER NAME = ...\HANSON.pdf_300dpi.pltcf

HPS1

ILLINOIS FED. AID PROJECT

TRAFFIC SIGNAL LEGEND

(NOT TO SCALE)

ITEM	EXISTING	PROPOSED	ITEM	EXISTING	PROPOSED	ITEM	EXISTING	PROPOSED
CONTROLLER CABINET			HANDHOLE -SQUARE -ROUND			SIGNAL HEAD -(P) PROGRAMMABLE SIGNAL HEAD		
COMMUNICATION CABINET			HEAVY DUTY HANDHOLE -SQUARE -ROUND			SIGNAL HEAD WITH BACKPLATE -(P) PROGRAMMABLE SIGNAL HEAD -(RB) RETROREFLECTIVE BACKPLATE		
MASTER CONTROLLER			DOUBLE HANDHOLE			PEDESTRIAN SIGNAL HEAD AT RAILROAD INTERSECTIONS		
MASTER MASTER CONTROLLER			JUNCTION BOX			PEDESTRIAN SIGNAL HEAD WITH COUNTDOWN TIMER		
UNINTERRUPTABLE POWER SUPPLY			RAILROAD CANTILEVER MAST ARM			ILLUMINATED SIGN "NO LEFT TURN"/"NO RIGHT TURN"		
SERVICE INSTALLATION -(P) POLE MOUNTED			RAILROAD FLASHING SIGNAL			NUMBER OF CONDUCTORS, ELECTRIC CABLE NO. 14, UNLESS NOTED OTHERWISE. ALL DETECTOR LOOP CABLE TO BE SHIELDED		
SERVICE INSTALLATION -(G) GROUND MOUNTED -(GM) GROUND MOUNTED METERED			RAILROAD CROSSING GATE			GROUND CABLE IN CONDUIT, NO. 6 SOLID COPPER (GREEN)		
TELEPHONE CONNECTION			RAILROAD CROSSBUCK			ELECTRIC CABLE IN CONDUIT, TRACER NO. 14 1/C		
STEEL MAST ARM ASSEMBLY AND POLE			RAILROAD CONTROLLER CABINET			COAXIAL CABLE		
ALUMINUM MAST ARM ASSEMBLY AND POLE			UNDERGROUND CONDUIT (UC), GALVANIZED STEEL			VENDOR CABLE		
STEEL COMBINATION MAST ARM ASSEMBLY AND POLE WITH LUMINAIRE			TEMPORARY SPAN WIRE, TETHER WIRE, AND CABLE			COPPER INTERCONNECT CABLE, NO. 18, 3 PAIR TWISTED, SHIELDED		
SIGNAL POST -(BM) BARREL MOUNTED - TEMPORARY			SYSTEM ITEM			FIBER OPTIC CABLE -NO. 62.5/125, MM12F -NO. 62.5/125, MM12F SM12F -NO. 62.5/125, MM12F SM24F		
WOOD POLE			INTERSECTION ITEM			GROUND ROD -(C) CONTROLLER -(M) MAST ARM -(P) POST -(S) SERVICE		
GUY WIRE			REMOVE ITEM					
SIGNAL HEAD			RELOCATE ITEM					
SIGNAL HEAD WITH BACKPLATE			ABANDON ITEM					
SIGNAL HEAD OPTICALLY PROGRAMMED			CONTROLLER CABINET AND FOUNDATION TO BE REMOVED					
FLASHER INSTALLATION -(FS) SOLAR POWERED			MAST ARM POLE AND FOUNDATION TO BE REMOVED					
PEDESTRIAN SIGNAL HEAD			SIGNAL POST AND FOUNDATION TO BE REMOVED					
PEDESTRIAN PUSH BUTTON -(APS) ACCESSIBLE PEDESTRIAN PUSH BUTTON			DETECTOR LOOP, TYPE I					
RADAR DETECTION SENSOR			PREFORMED DETECTOR LOOP					
VIDEO DETECTION CAMERA			SAMPLING (SYSTEM) DETECTOR					
RADAR/VIDEO DETECTION ZONE			INTERSECTION AND SAMPLING (SYSTEM) DETECTOR					
PAN, TILT, ZOOM (PTZ) CAMERA			QUEUE AND SAMPLING (SYSTEM) DETECTOR					
EMERGENCY VEHICLE LIGHT DETECTOR			WIRELESS DETECTOR SENSOR					
CONFIRMATION BEACON			WIRELESS ACCESS POINT					
WIRELESS INTERCONNECT			LEFT TURN YIELD ON FLASHING YELLOW ARROW (R10-1109)					
WIRELESS INTERCONNECT RADIO REPEATER			STREET NAME SIGN LED					

MODEL: Default
FILE NAME: P:\110848\BID\NTEG\Illinois.gov\PIV\DOT\Documents\DOT_Offices\District_1\Projects\DH\S423-24\CADD\ha\CAD\sheet\ts05.dgn

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	DRAWN - IP	REVISED -
PLOT SCALE = 50.0000' / in.	CHECKED - LP	REVISED -
PLOT DATE = 3/4/2019	DATE - 9/29/2016	REVISED -

**STATE OF ILLINOIS
DEPARTMENT OF TRANSPORTATION**


**DISTRICT ONE
STANDARD TRAFFIC SIGNAL DESIGN DETAILS**

SCALE: NONE SHEET 1 OF 7 SHEETS STA. TO STA.

F.A. RTE.	SECTION	COUNTY	TOTAL SHEETS	SHEET NO.
0085	19-00511-00-SP	McHENRY	45	15
TS-05		CONTRACT NO. 61J51		
ILLINOIS FED. AID PROJECT				

TRAFFIC SIGNAL MAST ARM AND SIGNAL POST


MAST ARM MOUNTED SIGNALS IN EXISTING, PROPOSED OR FUTURE SIDEWALK/BICYCLE PATH AREA. INTERSECTION SHOWN WITH PEDESTRIAN SIGNALS AND PEDESTRIAN PUSHBUTTON DETECTORS.

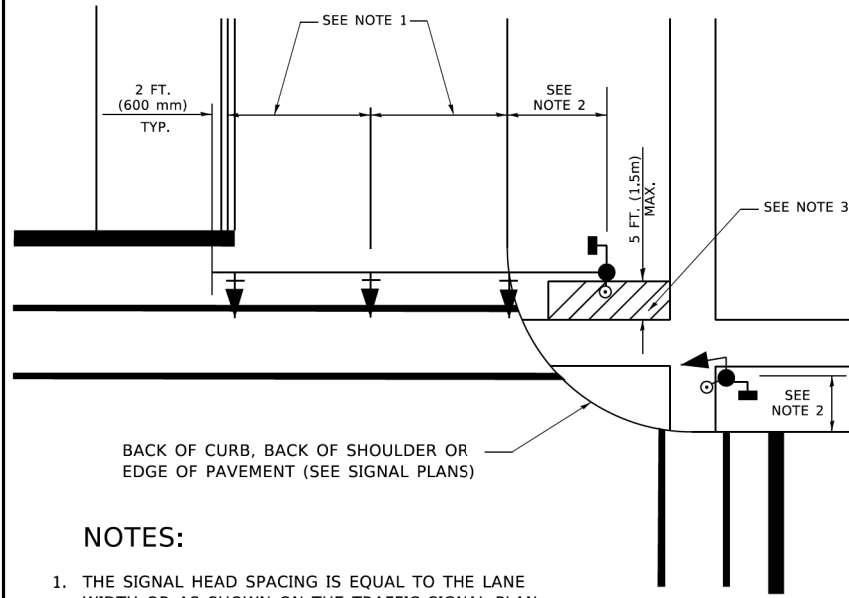

NOTES:

1. THE SIGNAL HEAD SPACING IS EQUAL TO THE LANE WIDTH OR AS SHOWN ON THE TRAFFIC SIGNAL PLAN.
2. REFER TO THE TRAFFIC SIGNAL EQUIPMENT OFFSET TABLE.
3. PROVIDE A LEVEL ALL-WEATHER SURFACE (CONCRETE SIDEWALK, ASPHALT BICYCLE PATH SURFACE OR MATCHING MATERIAL TO THE ADJACENT SURFACE) UP TO THE MAST ARM SHAFT OR THE SIGNAL POST.
4. THE FACE OF THE PEDESTRIAN PUSHBUTTON SHALL BE PARALLEL TO THE CROSSWALK TO BE USED.
5. THE LOCATIONS AND INSTALLATION OF PEDESTRIAN SIGNAL HEADS AND PEDESTRIAN PUSHBUTTONS SHALL MEET THE REQUIREMENTS OF THE MUTCD AND INFORMATION FOUND IN THE "AMERICANS WITH DISABILITIES ACT ACCESSIBILITY GUIDELINES FOR BUILDINGS AND FACILITIES."


PEDESTRIAN SIGNAL POST AND PEDESTRIAN PUSH BUTTON POST

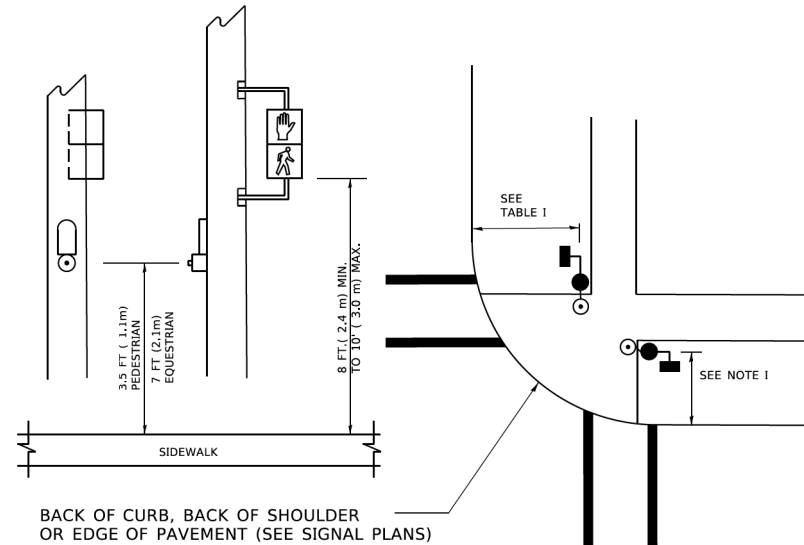

NOTES:

1. REFER TO THE TRAFFIC SIGNAL EQUIPMENT OFFSET TABLE.
2. PROVIDE A LEVEL ALL-WEATHER SURFACE (CONCRETE SIDEWALK, ASPHALT BICYCLE PATH SURFACE OR MATCHING MATERIAL TO THE ADJACENT SURFACE) UP TO THE PEDESTRIAN SIGNAL POST OR THE PEDESTRIAN PUSH BUTTON POST.
3. THE FACE OF THE PEDESTRIAN PUSHBUTTON SHALL BE PARALLEL TO THE CROSSWALK TO BE USED.
4. THE LOCATIONS AND INSTALLATION OF PEDESTRIAN SIGNAL HEADS AND PEDESTRIAN PUSHBUTTONS SHALL MEET THE REQUIREMENTS OF THE MUTCD AND INFORMATION FOUND IN THE "AMERICANS WITH DISABILITIES ACT ACCESSIBILITY GUIDELINES FOR BUILDINGS AND FACILITIES."

RECOMMENDED PUSHBUTTON LOCATIONS

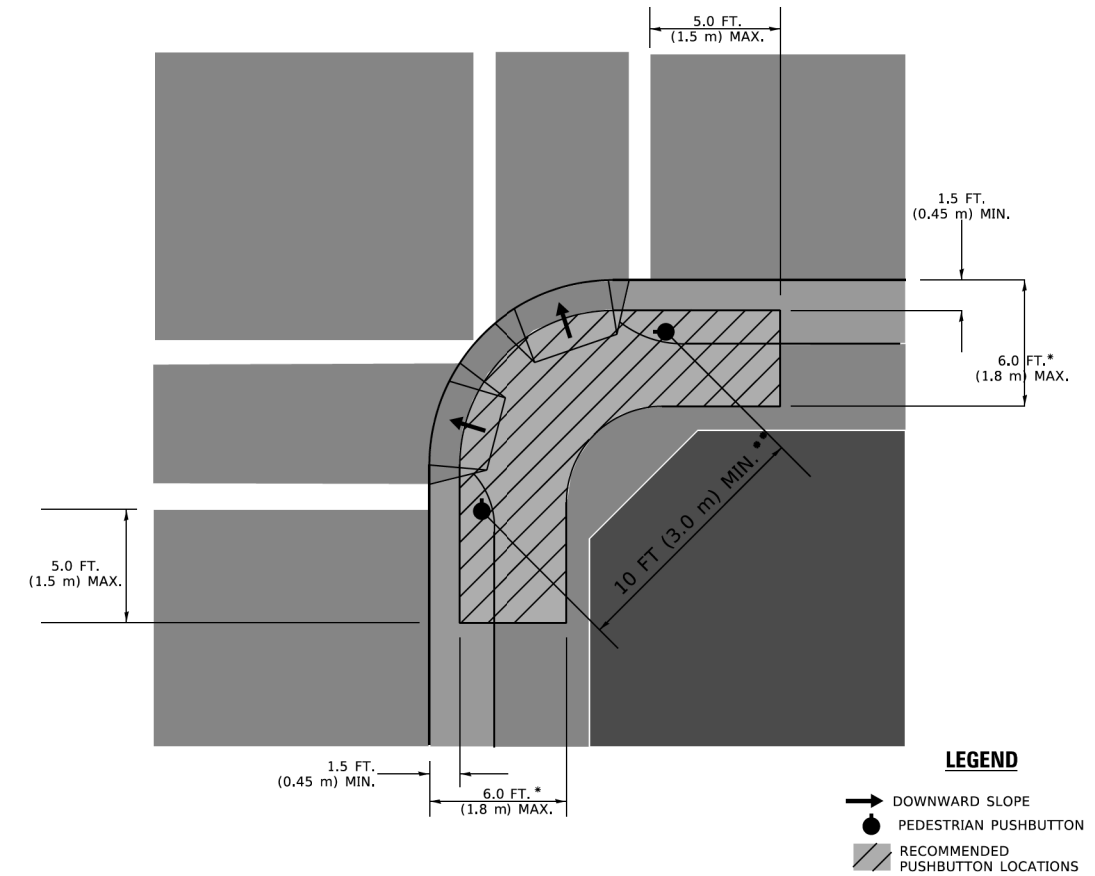

LEGEND

- DOWNWARD SLOPE
- PEDESTRIAN PUSHBUTTON
- ▨ RECOMMENDED PUSHBUTTON LOCATIONS

- * WHERE THERE ARE CONSTRAINTS THAT MAKE IT IMPRACTICAL TO PLACE THE PEDESTRIAN PUSHBUTTON BETWEEN 1.5 FT (0.45 m) AND 6 FT (1.8 m) FROM THE EDGE OF THE CURB, SHOULDER, OR PAVEMENT, IT SHOULD NOT BE FURTHER THAN 10 FT (3 m) FROM THE EDGE OF CURB, SHOULDER, OR PAVEMENT.
- ** WHERE THERE ARE CONSTRAINTS ON A PARTICULAR CORNER THAT MAKE IT IMPRACTICAL TO PROVIDE THE 10 FT (3 m) SEPERATION BETWEEN THE TWO PEDESTRIAN PUSHBUTTONS, THE PUSHBUTTONS MAY BE PLACED CLOSER TOGETHER OR ON THE SAME POLE.

NOTES:

1. PEDESTRIAN SIGNAL HEADS SHALL BE MOUNTED WITH THE BOTTOM OF THE SIGNAL HOUSING INCLUDING BRACKETS NOT LESS THAN 8 FT (2.4 m) OR MORE THAN 10 FT (3 m) ABOVE SIDEWALK LEVEL, AND SHALL BE POSITIONED AND ADJUSTED TO PROVIDE MAXIMUM VISIBILITY AT THE BEGINNING OF THE CONTROLLED CROSSWALK.
2. THE BOTTOM OF THE SIGNAL HOUSING (INCLUDING BRACKETS) OF A VEHICULAR SIGNAL FACE THAT IS NOT LOCATED OVER A HIGHWAY SHALL BE AT LEAST 8 FT (2.4 m) BUT NOT MORE THAN 19 FT (5.8 m) ABOVE THE SIDEWALK OR, IF THERE IS NO SIDEWALK, ABOVE THE PAVEMENT GRADE AT THE CENTER OF THE ROADWAY.
3. THE BOTTOM OF THE SIGNAL HOUSING AND ANY RELATED ATTACHMENTS TO A SIGNAL FACE LOCATED OVER ANY PORTION OF A HIGHWAY SHALL BE ACCORDING TO CURRENT STATE STANDARDS 877001, 877002, 877006, 877011 AND 877012 WITH A MINIMUM OF 16 FT (5.0 m) AND A MAXIMUM OF 18 FT. (5.5 m) FROM THE HIGHEST POINT OF PAVEMENT.
4. THE BOTTOM OF THE TEMPORARY SPAN WIRE MOUNTED SIGNAL HOUSING AND ANY RELATED ATTACHMENTS TO A SIGNAL FACE LOCATED OVER ANY PORTION OF A HIGHWAY SHALL BE ACCORDING TO CURRENT STATE STANDARD 880001 WITH A MINIMUM OF 17 FT (5.18 m) FROM THE HIGHEST POINT OF PAVEMENT.
5. THE TOP OF THE SIGNAL HOUSING OF A SIGNAL FACE LOCATED OVER ANY PORTION OF A HIGHWAY SHALL NOT BE MORE THAN 25.6 FT (7.8 m) ABOVE THE PAVEMENT.

TRAFFIC SIGNAL EQUIPMENT OFFSET

TRAFFIC SIGNAL EQUIPMENT	COMBINATION CONCRETE CURB AND GUTTER (MINIMUM DISTANCE FROM BACK OF CURB TO CENTERLINE OF FOUNDATION)	SHOULDER/NON-CURBED AREA (MINIMUM DISTANCE FROM EDGE OF PAVEMENT TO CENTERLINE OF FOUNDATION)
TRAFFIC SIGNAL MAST ARM POLE	6 FT (1.8m)	SHOULDER WIDTH + 2 FT (0.6m), MINIMUM 10 FT (3.0m)
TRAFFIC SIGNAL POST	4 FT (1.2m)	SHOULDER WIDTH + 2 FT (0.6m), MINIMUM 10 FT (3.0m)
PEDESTRIAN SIGNAL POST	4 FT (1.2m)	SHOULDER WIDTH + 2 FT (0.6m), MINIMUM 10 FT (3.0m)
PEDESTRIAN PUSHBUTTON POST	4 FT (1.2m)	SHOULDER WIDTH + 2 FT (0.6m), MINIMUM 10 FT (3.0m)
TEMPORARY WOOD POLE	6 FT (1.8m)	SHOULDER WIDTH + 2 FT (0.6m), MINIMUM 10 FT (3.0m)
CONTROLLER CABINET	6 FT (1.8m) MINIMUM DISTANCE SEE NOTE 2	SHOULDER WIDTH + 6 FT (1.8m), MINIMUM 16 FT (4.9m) SEE NOTE 3.
SERVICE INSTALLATION, GROUND MOUNT	6 FT (1.8m) MINIMUM DISTANCE SEE NOTE 2	SHOULDER WIDTH + 6 FT (1.8m), MINIMUM 16 FT (4.9m) SEE NOTE 3.

NOTES:

1. CONTACT THE "AREA TRAFFIC SIGNAL MAINTENANCE AND OPERATIONS ENGINEER" FOR ASSISTANCE IN LOCATING THE TRAFFIC SIGNAL EQUIPMENT WHEN THERE ARE CONFLICTS WITH DITCHES OR THE MINIMUM OFFSET DISTANCES CANNOT BE MET.
2. MINIMUM DISTANCE FROM THE BACK OF CURB TO THE ROADWAY SIDE OF THE FOUNDATION.
3. MINIMUM DISTANCE FROM THE EDGE OF PAVEMENT TO THE ROADWAY SIDE OF THE FOUNDATION.
4. ANY CHANGES TO THE OFFSETS OF THE FOUNDATIONS, FROM THE MINIMUM DISTANCES LISTED IN THE "TRAFFIC SIGNAL EQUIPMENT OFFSET" CHART AND THE TRAFFIC SIGNAL INSTALLATION PLAN, COULD EFFECT THE PLACEMENT OF THE SIGNAL HEADS, PEDESTRIAN SIGNAL HEADS AND THE PEDESTRIAN PUSHBUTTONS. THE SIGNAL HEAD PLACEMENT ON THE MAST ARMS SHALL REMAIN AS PER THE TRAFFIC SIGNAL INSTALLATION PLAN AND THE "TRAFFIC SIGNAL MAST ARM AND SIGNAL POST" DETAIL ABOVE. THE PROPOSED MAST ARM LENGTHS MAY NEED TO BE REVISED TO MEET THE ABOVE REQUIREMENTS. THE PEDESTRIAN SIGNAL HEADS AND PEDESTRIAN PUSHBUTTONS MUST MEET THE REQUIREMENTS UNDER THE DETAILS ON THIS SHEET.

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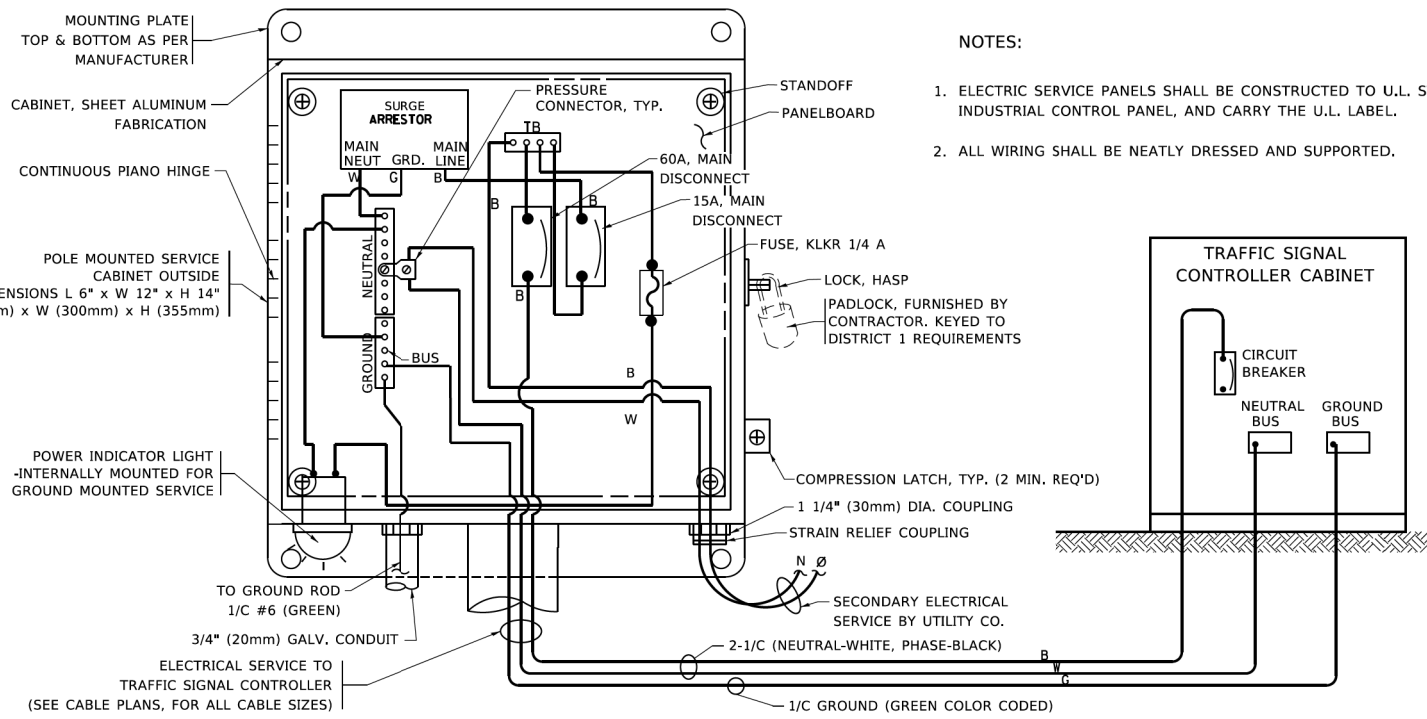
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**STATE OF ILLINOIS
DEPARTMENT OF TRANSPORTATION**


**DISTRICT ONE
STANDARD TRAFFIC SIGNAL DESIGN DETAILS**

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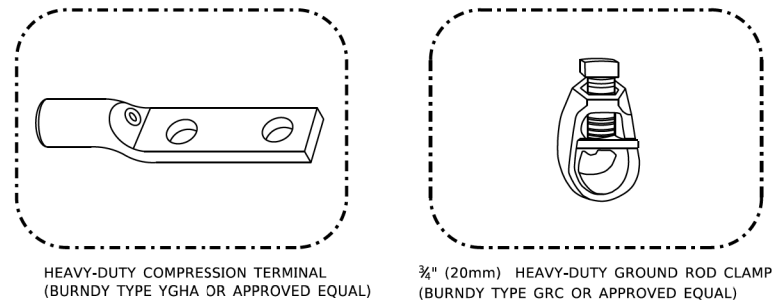
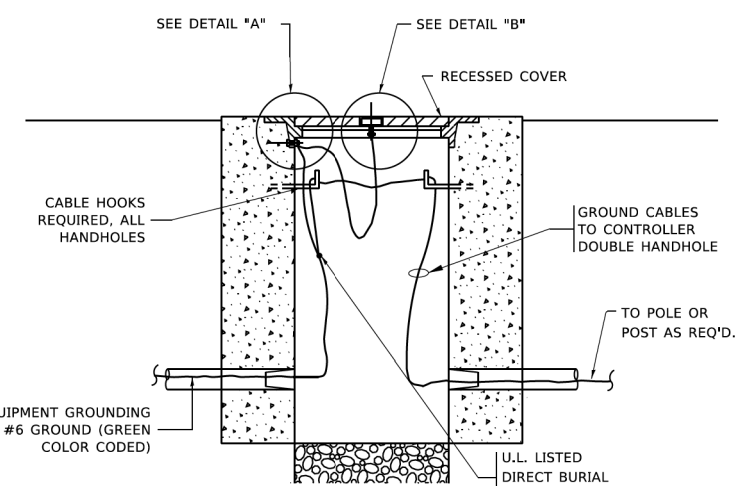
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0085	19-00511-00-SP	McHENRY	45	16
TS-05		CONTRACT NO. 61J51		
ILLINOIS FED. AID PROJECT				







ELECTRICAL SERVICE – PANEL DIAGRAM (TYPICAL FOR POLE AND GROUND MOUNTED SERVICE)
SERVICE INSTALLATION POLE MOUNT (SHOWN)
 (NOT TO SCALE)

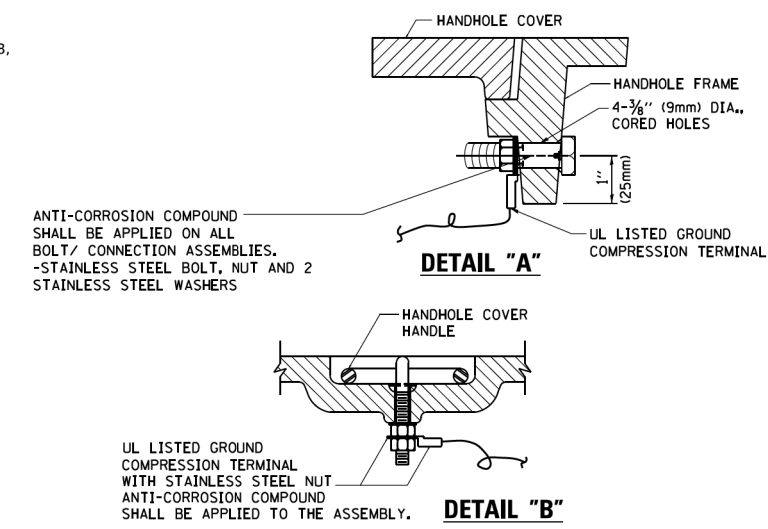

- NOTES:**
- GROUNDING SYSTEM**
1. THE GROUNDING SYSTEM SHALL CONSIST OF AN INSULATED CONDUCTOR TYPE XLP, NO. 6 A.W.G., STRANDED COPPER TO BE INSTALLED IN RACEWAYS. THE GROUNDING CABLE SHALL BE INSTALLED IN A CONTINUOUS MANNER AS SHOWN ON THE CABLE PLAN PROVIDED. ALL GROUNDING CONDUCTORS SHALL BE BONDED TO METAL ENCLOSURE (HANDHOLE, POST, MAST ARM, CONTROLLER, ETC.). GROUND ROD SHALL BE 3/4" DIA. x 10'-0" (20mm x 3.0m) LONG, COPPER CLAD, ONE GROUND ROD SHALL BE INSTALLED AT ALL POST FOUNDATIONS, POLE FOUNDATIONS, CONTROLLER CABINET FOUNDATION AND ELECTRICAL SERVICE INSTALLATION AS INDICATED ON THE CABLE PLAN. IF THERE ARE ANY SPECIAL CONDITIONS SUCH AS SUB-SURFACE CONDITIONS OR INSTALLATION PROBLEMS, THE RESIDENT ENGINEER SHALL BE NOTIFIED OR CONTACT THE BUREAU OF TRAFFIC, ILLINOIS DEPARTMENT OF TRANSPORTATION DISTRICT ONE AT (847) 705-4139.
 2. THE NEUTRAL CONDUCTOR AND THE GROUND CONDUCTOR SHALL BE CONNECTED IN THE SERVICE INSTALLATION. AT NO OTHER POINT IN THE TRAFFIC SIGNAL SYSTEM SHALL THE NEUTRAL AND GROUND CONDUCTORS BE CONNECTED.
 3. ALL EQUIPMENT GROUNDING CONDUCTORS SHALL TERMINATE AT THE GROUND BUS IN THE CONTROLLER CABINET.
 4. THE CONTRACTOR SHALL PROVIDE A GROUND CABLE WITH CONNECTORS BETWEEN THE HANDHOLE COVER AND HANDHOLE FRAME.



- NOTES:**
- ALL CLAMPS SHALL BE BRONZE OR COPPER, UL APPROVED.
 - GROUND CABLE SHALL BE LOOPED OVER HOOKS IN THE HANDHOLES
 - 6.5' (2.0m) SLACK SHALL BE PROVIDED IN SINGLE HANDHOLES
 - 13' (4.0m) OF SLACK SHALL BE PROVIDED IN DOUBLE HANDHOLES.
 - 5' (1.4m) OF SLACK SHALL BE PROVIDED BETWEEN FRAME AND COVER.

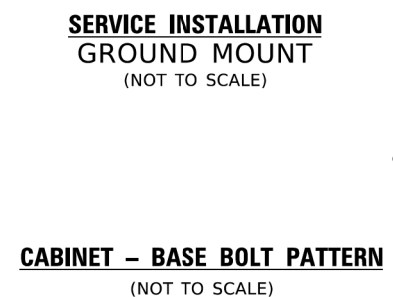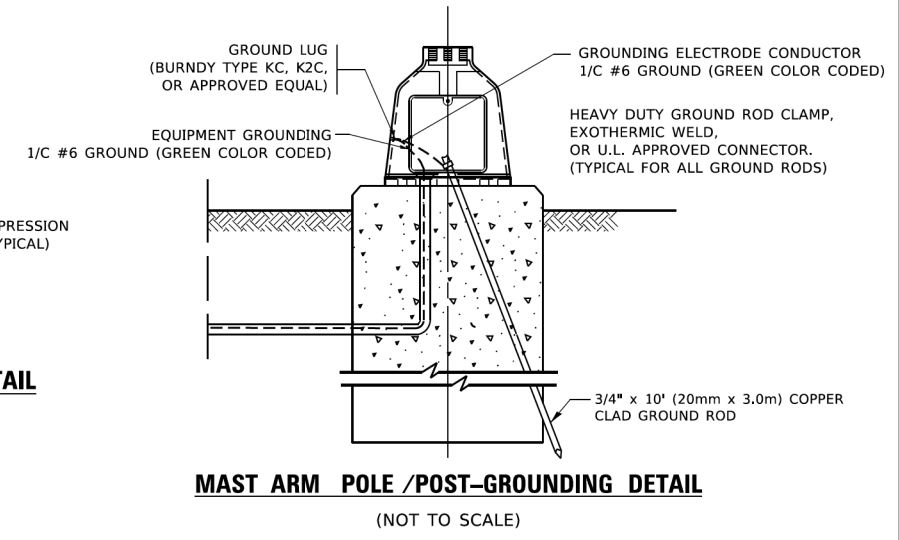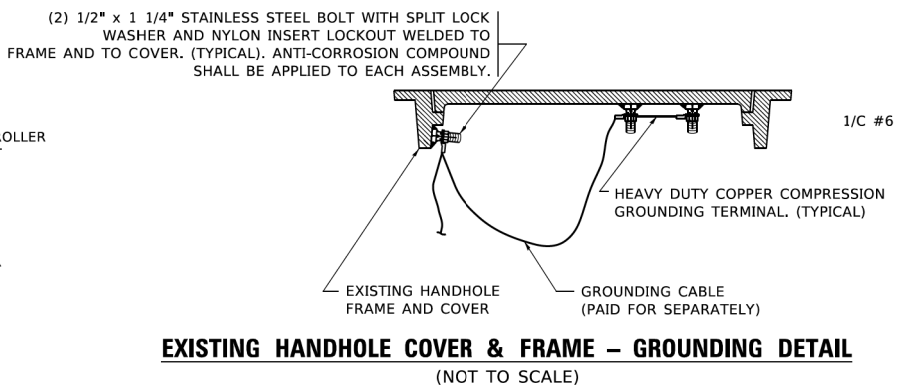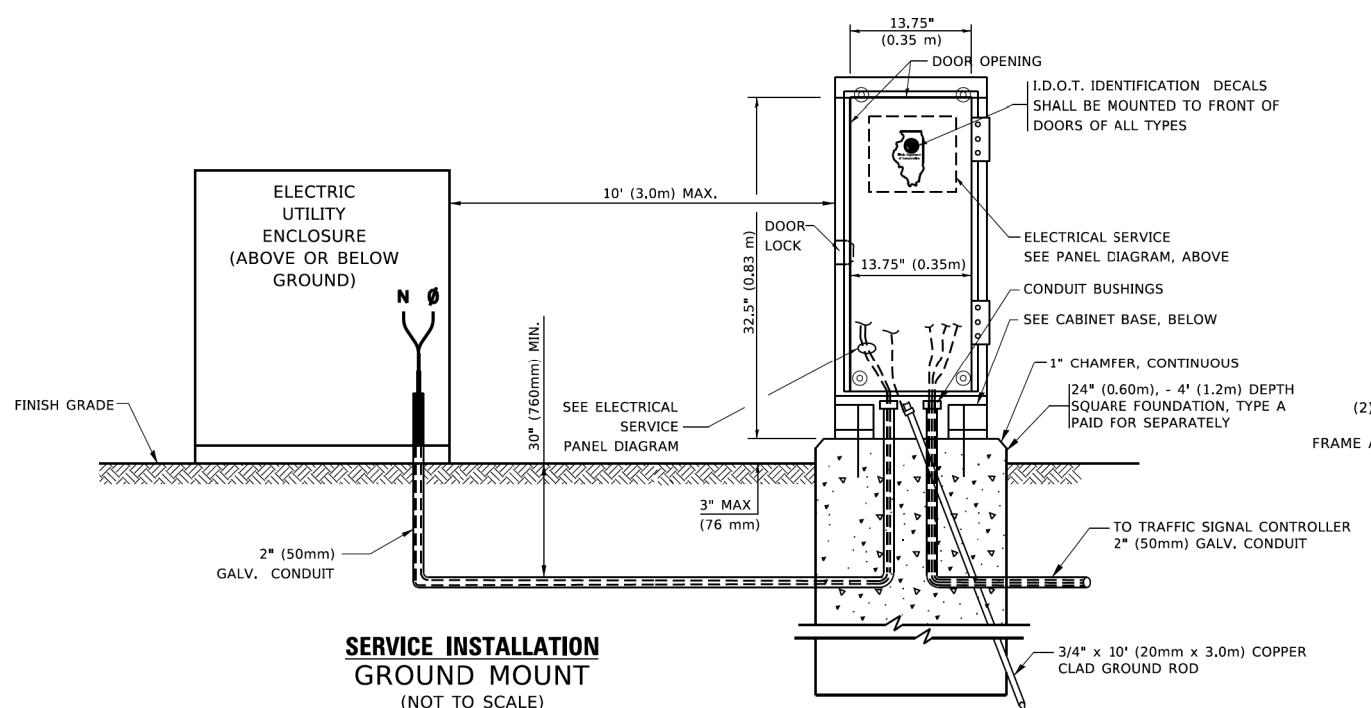

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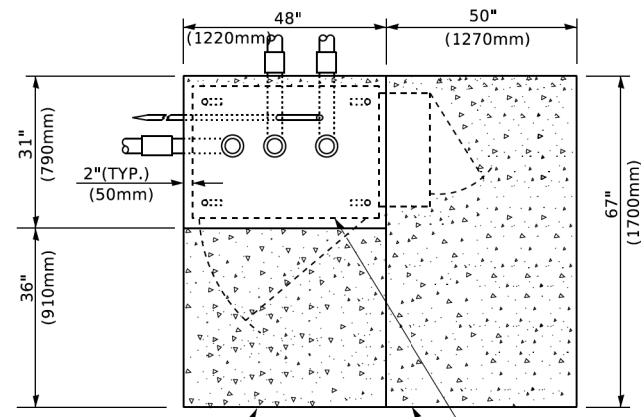
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**STATE OF ILLINOIS
 DEPARTMENT OF TRANSPORTATION**


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 STANDARD TRAFFIC SIGNAL DESIGN DETAILS**

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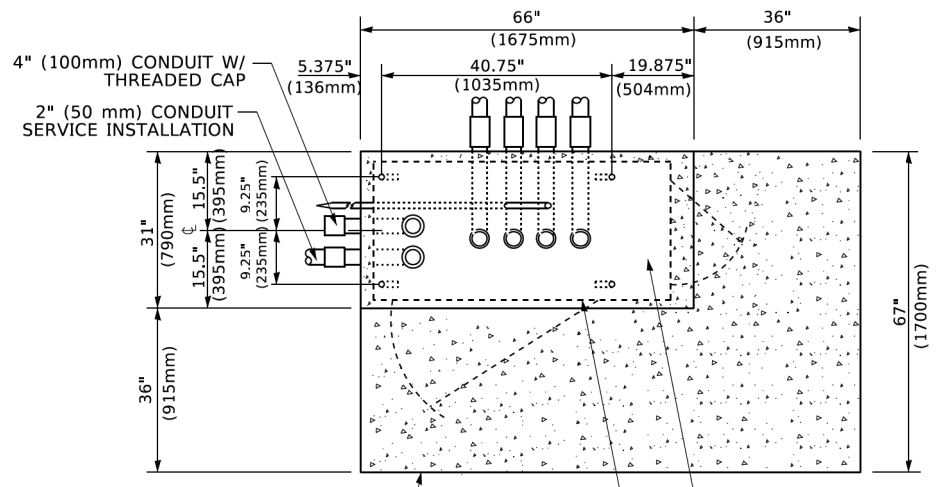
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TS-05		CONTRACT NO. 61J51		
ILLINOIS		FED. AID PROJECT		




TOP VIEW

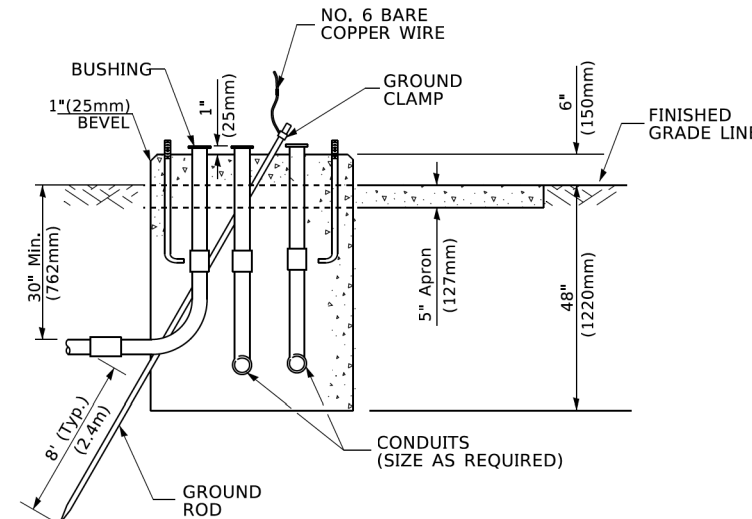


**TYPE D
FOR GROUND MOUNTED
CONTROLLER CABINET
AND UPS BATTERY CABINET**



TOP VIEW

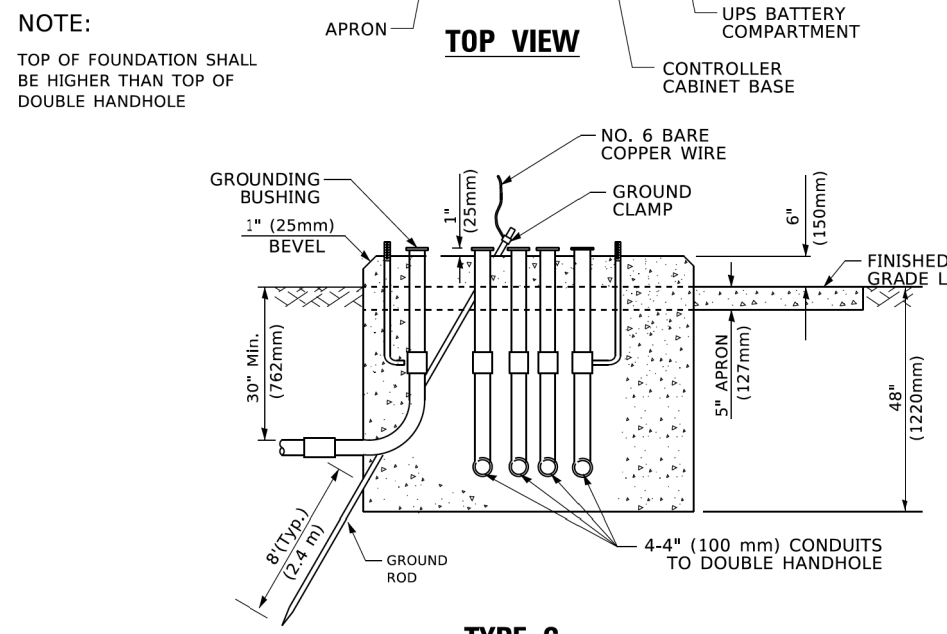

**TYPE C
FOR GROUND MOUNTED
SUPER P (TYPE IV) AND SUPER R (TYPE V)
CONTROLLER CABINETS**

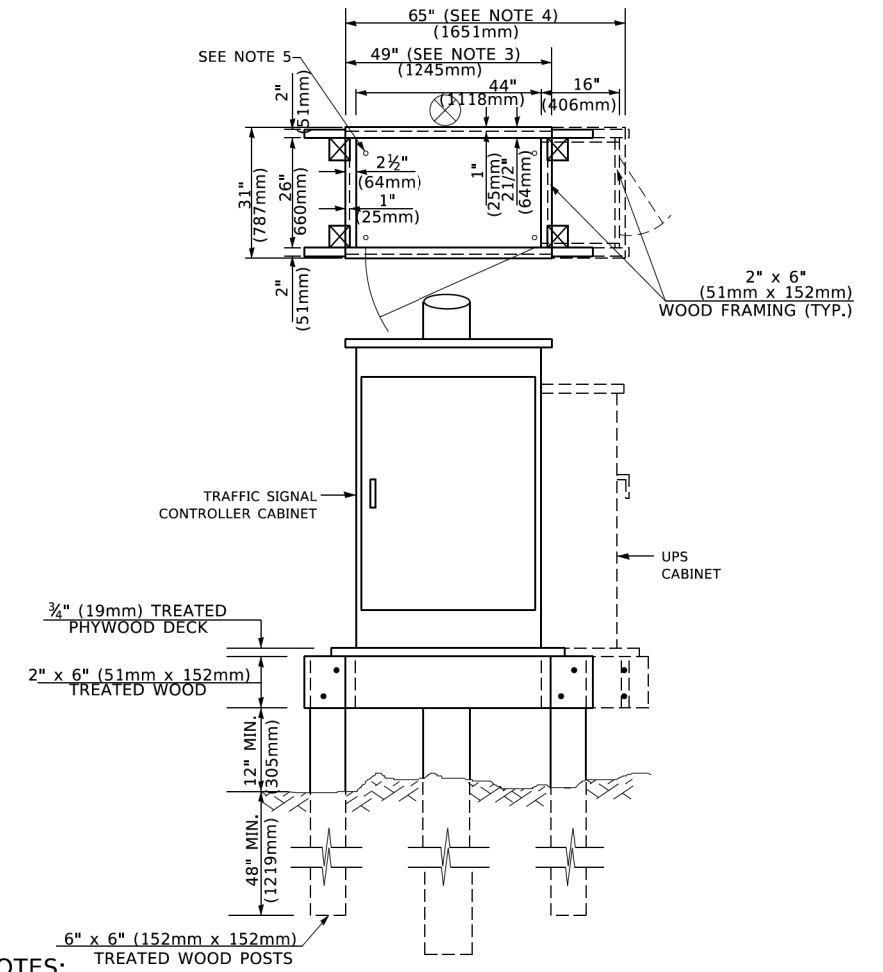

NOTES:

1. BASED ON CONTROLLER CABINET TYPE IV WITH BASE DIMENSIONS OF 26" x 44" (660mm x 1118mm). ADJUST PLATFORM SIZE TO FIT CABINET BASE DIMENSIONS BEING SUPPLIED.
2. BASED ON UNINTERRUPTIBLE POWER SUPPLY CABINET WITH BASE DIMENSIONS OF 16" x 25" (406mm x 635mm). ADJUST PLATFORM SIZE TO FIT CABINET BASE DIMENSIONS BEING SUPPLIED.
3. PLATFORM SIZE FOR CONTROLLER CABINET TYPE IV.
4. PLATFORM SIZE FOR CONTROLLER CABINET TYPE IV AND UNINTERRUPTIBLE POWER SUPPLY CABINET.
5. DRILLED HOLES THROUGH THE PLATFORM BASE TO MATCH THE CONTROLLER CABINET BOLT TEMPLATE. FASTEN THE CONTROLLER CABINET TO THE PLATFORM WITH CARRIAGE BOLTS, WASHERS AND NUTS.
6. FASTEN ALL SUPPORT WOOD FRAMING TO THE WOOD POSTS WITH 2 LAG SCREWS FOR EACH CONNECTION..

**TEMPORARY SIGNAL CONTROLLER
WOOD SUPPORT PLATFORM**

CABLE SLACK LENGTH	FEET	METER
HANDHOLE	6.5	2.0
DOUBLE HANDHOLE	13.0	4.0
SIGNAL POST	2.0	0.6
MAST ARM	2.0	0.6
CONTROLLER CABINET	1.5	0.5
FIBER OPTIC AT CABINET	13.0	4.0
ELECTRIC SERVICE AT (CABINET OR SERVICE LOCATION)	1.5	0.5
GROUND CABLE (SIGNAL POST, MAST ARM, CABINET)	1.5	0.5
GROUND CABLE (BETWEEN FRAME AND COVER)	5.0	1.6

CABLE SLACK

VERTICAL CABLE LENGTH	FEET	METER
MAST ARM POLE (MAST ARM MOUNTED SIGNAL HEAD) (L = MAST ARM LENGTH - DISTANCE TO SIGNAL HEAD FROM END OF ARM)	20.0+L	6.0+L
BRACKET MOUNTED (MAST ARM POLE OR SIGNAL POLE)	13.0	4.0
PEDESTRIAN PUSH BUTTON	6.0	2.0
SERVICE INSTALLATION POLE MOUNT TO SERVICE DROP	13.5	4.1
SERVICE INSTALLATION POLE MOUNT TO GROUND	13.5	4.1
SERVICE INSTALLATION GROUND MOUNT	6.0	2.0
FOUNDATION (SIGNAL POST, MAST ARM POLE, CONTROLLER CABINET, SERVICE-GROUND MOUNT)	3.0	1.0

VERTICAL CABLE LENGTH

FOUNDATION	DEPTH
TYPE A - Signal Post	4'-0" (1.2m)
TYPE C - CONTROLLER W/ UPS	4'-0" (1.2m)
TYPE D - CONTROLLER	4'-0" (1.2m)
SERVICE INSTALLATION, GROUND MOUNT, TYPE A - SQUARE	4'-0" (1.2m)

DEPTH OF FOUNDATION

MAST ARM LENGTH	① FOUNDATION DEPTH	FOUNDATION DIAMETER	SPIRAL DIAMETER	QUANTITY OF REBARS	SIZE OF REBARS
Less than 30' (9.1 m)	10'-0" (3.0 m)	30" (750mm)	24" (600mm)	8	6(19)
Greater than or equal to 30' (9.1 m) and less than 40' (12.2 m)	13'-6" (4.1 m)	30" (750mm)	24" (600mm)	8	6(19)
Greater than or equal to 40' (12.2 m) and less than 50' (15.2 m)	11'-0" (3.4 m)	36" (900mm)	30" (750mm)	12	7(22)
Greater than or equal to 50' (15.2 m) and up to 55' (16.8 m)	13'-0" (4.0 m)	36" (900mm)	30" (750mm)	12	7(22)
Greater than or equal to 55' (16.8 m) and up to 65' (19.8 m)	15'-0" (4.6 m)	36" (900mm)	30" (750mm)	12	7(22)
Greater than or equal to 65' (19.8 m) and less than 75' (22.9 m)	21'-0" (6.4 m)	42" (1060mm)	36" (900mm)	16	8(25)
Greater than or equal to 75' (22.9 m)	25'-0" (7.6 m)	42" (1060mm)	36" (900mm)	16	8(25)

NOTES:

1. These foundation depths are for sites which have cohesive soils (clayey silt, sandy clay, etc.) along the length of the shaft, with an average Unconfined Compressive Strength (Qu) > 1.0 tsf (100 kpa). This strength shall be verified by boring data prior to construction or with testing by the Engineer during foundation drilling. The Bureau of Bridges & Structures should be contacted for a revised design if other conditions are encountered.
2. Combination mast arm assemblies under 55 feet (16.8 m) shall use 36" (900 mm) diameter foundations.
3. Combination mast arm assemblies under 56 feet (16.8 m) through 75 feet (22.9 m) shall use 42" (1060 mm) diameter foundations.
4. For mast arm assemblies with dual arms refer to state standard 878001..

DEPTH OF MAST ARM FOUNDATIONS, TYPE E


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**STATE OF ILLINOIS
DEPARTMENT OF TRANSPORTATION**

DISTRICT ONE	
STANDARD TRAFFIC SIGNAL DESIGN DETAILS	
SCALE: NONE	SHEET 5 OF 7 SHEETS STA. TO STA.


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TS-05		CONTRACT NO. 61J51		
ILLINOIS FED. AID PROJECT				



NOTES:

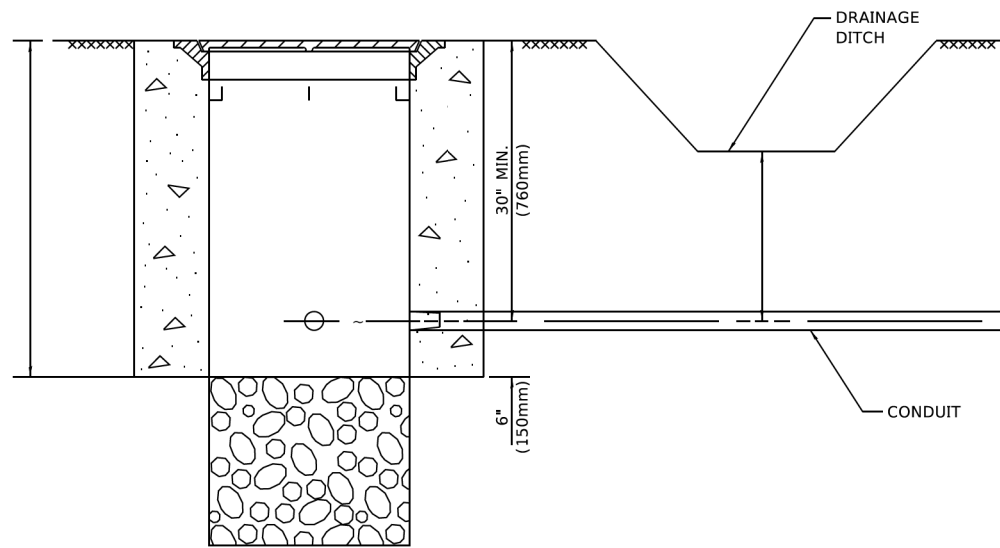1. CONDUIT DEPTH SHALL BE A MINIMUM OF 30" (760mm) BELOW THE BOTTOM OF THE DRAINAGE DITCH OR ANY SLOPING GROUND
2. THE MINIMUM CONDUIT DEPTH APPLIES TO ALL CONDUIT PLACED UNDER ROADWAY PAVEMENT, MULTI-USE PATHS, SIDEWALKS AND SOIL SURFACES.
3. THE MINIMUM CONDUIT DEPTH APPLIES TO ALL HANDHOLES, HEAVY DUTY HANDHOLES AND DOUBLE HANDHOLES.

HANDHOLE WITH MINIMUM CONDUIT DEPTH
(NOT TO SCALE)

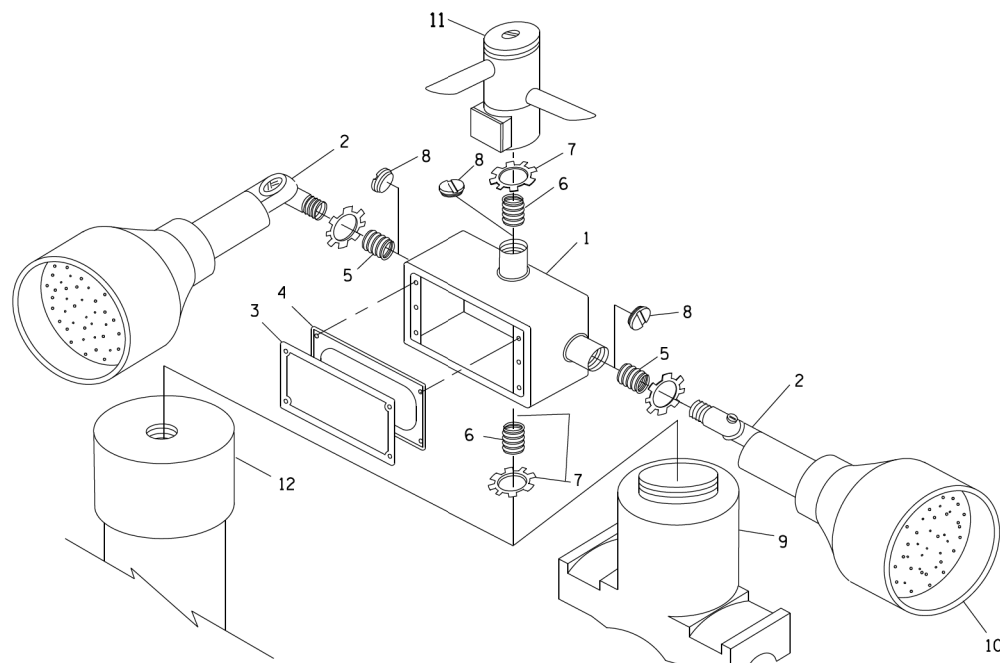


POST CAP MOUNT **MAST ARM MOUNT**
EMERGENCY VEHICLE DETECTOR WITH CONFIRMATION BEACON MOUNTING DETAIL


ITEM NO.	IDENTIFICATION
1	OUTLET BOX- GALV. 21 CU.IN. (0.000344 CU-M)
2	LAMP HOLDER AND COVER
3	OUTLET BOX COVER
4	RUBBER COVER GASKET
5	REDUCING BUSHING
6	3/4" (19 mm) CLOSE NIPPLE
7	3/4" (19 mm) LOCKNUT
8	3/4" (19 mm) HOLE PLUG
9	SADDLE BRACKET - GALV.
10	6 WATT PAR 38 LED FLOOD LAMP
11	DETECTOR UNIT
12	POST CAP [18 FT. (5.4 m) POST MIN.]

NOTES:


1. ALL ELECTRICAL ITEMS, EXCEPT ITEMS #2 AND #11 SHALL BE ALUMINUM OR GALVANIZED
2. ITEM #1- OZ/GEDNEY FSX-1-50 OR EQUIVALENT
ITEM #2- MULBERRY CON-O-SHADE LAMP SHIELD OR EQUIVALENT
ITEM #9- "BAND-IT" SADDLE BRACKET OR EQUIVALENT
3. WHEN POST MOUNTING IS SPECIFIED, ITEM #9 SHALL NOT BE REQUIRED. THE DETECTION UNIT SHALL BE MOUNTED DIRECTLY ON TOP OF THE CAP BY DRILLING AND TAPPING A 3/4" (19 mm) HOLE WITH PIPE THREADS. THE POST CAP SHALL EITHER BE SCREWED TO THE TOP OF THE POST OR A MINIMUM OF 3 TIGHTENING SCREWS SHALL BE REQUIRED ON EACH CAP.

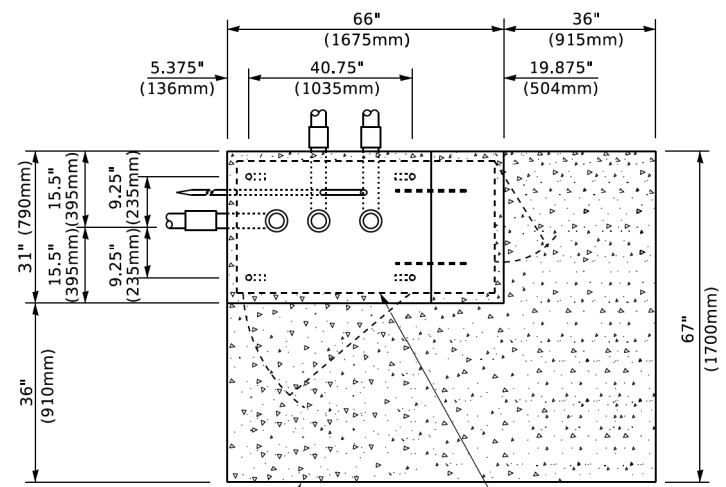

TOP VIEW
(NOT TO SCALE)

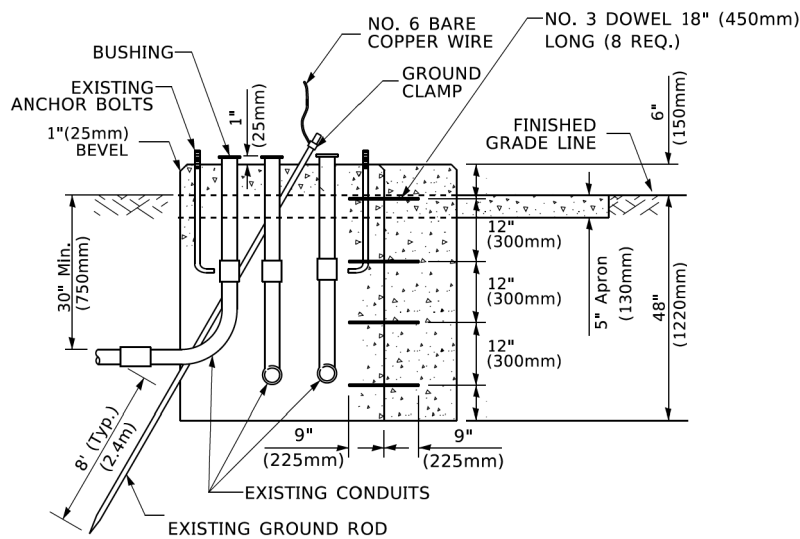

MODIFY EXISTING TYPE "D" FOUNDATION TO TYPE "C" FOUNDATION
(NOT TO SCALE)

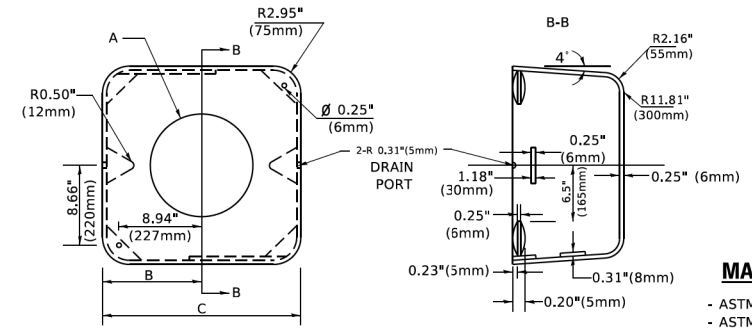

MATERIAL
- ASTM A36 STEEL
- ASTM A-123 HOT DIPPED GALVANIZED

A	B	C	HEIGHT	WEIGHT
VARIABLES	9.5" (241mm)	19" (483mm)	7" (178mm) - 12" (300mm)	53 lbs (24kg)
VARIABLES	10.75" (273mm)	21.5" (546mm)	7" (178mm) - 12" (300mm)	68 lbs (31 kg)
VARIABLES	13.0" (330mm)	26" (660mm)	7" (178mm) - 12" (300mm)	81 lbs (37 kg)
VARIABLES	18.5" (470mm)	37" (940mm)	7" (178mm) - 12" (300mm)	126 lbs (57 kg)


SHROUD

NOTES:


1. DIMENSION "A" IS EQUAL TO THE DIAMETER OF THE MAST ARM POLE AT THE TOP OF THE SHROUD. THE SHROUD SHALL BE TIGHT TO THE MAST ARM POLE.
2. THE SUPPLIER SHALL VERIFY THE ABOVE DIMENSIONS BASED ON MAST ARM REQUIREMENTS.
3. THE HEIGHT OF THE SHROUD SHALL COVER THE ANCHOR BOLTS, NUTS AND MAST ARM POLE BASE.

NOTE:

SUPPORT EXISTING CABINET AND CONTROL EQUIPMENT ABOVE FOUNDATION TO KEEP TRAFFIC SIGNAL FUNCTIONING WHILE FOUNDATION MODIFICATION WORK IS PROCEEDING.

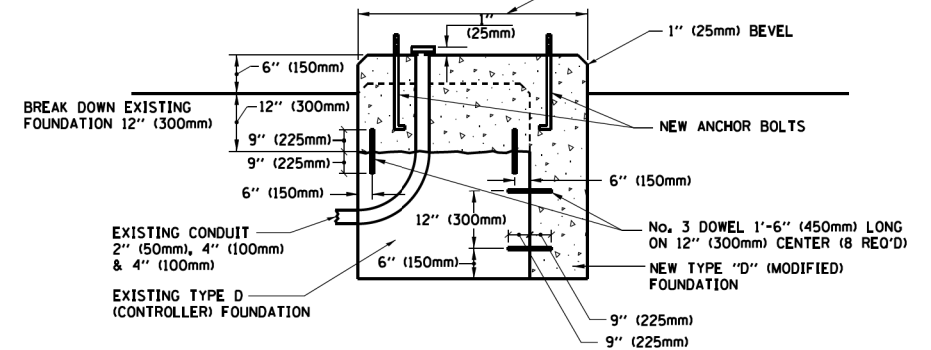

MODIFY EXISTING TYPE "D" FOUNDATION

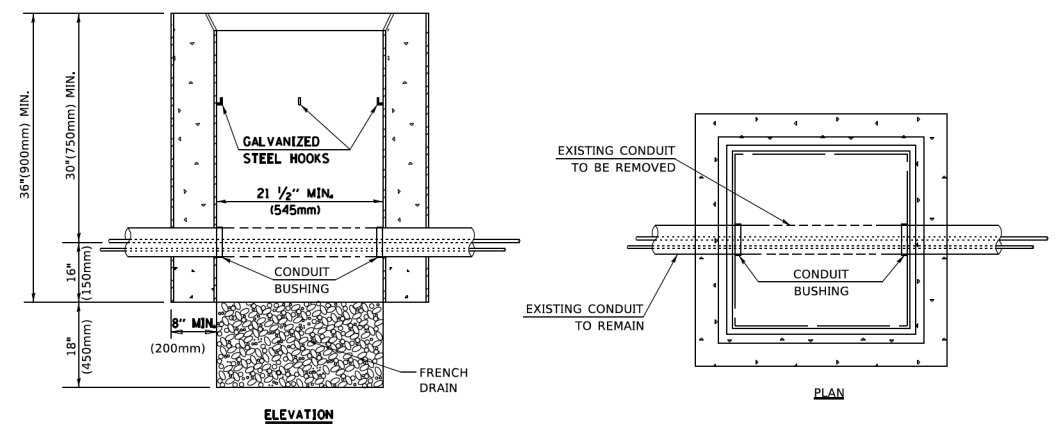

NOTES:

1. HANDHOLE CONSTRUCTED PER STATE STANDARD 814001.
2. REMOVAL OF THE EXISTING CONDUIT FROM THE HANDHOLE AND THE INSTALLATION OF THE CONDUIT BUSHINGS SHALL BE INCLUDED WITH THE COST OF THE HANDHOLE.

HANDHOLE TO INTERCEPT EXISTING CONDUIT

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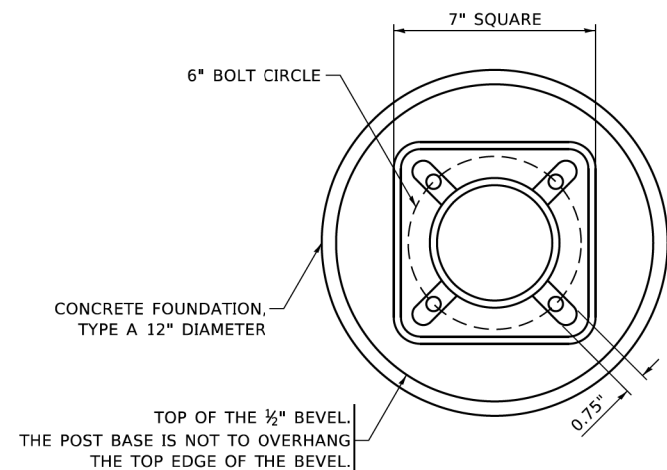
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STATE OF ILLINOIS
DEPARTMENT OF TRANSPORTATION

DISTRICT ONE
STANDARD TRAFFIC SIGNAL DESIGN DETAILS


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F.A. RTE. 0085	SECTION 19-00511-00-SP	COUNTY McHENRY	TOTAL SHEETS 45	SHEET NO. 19
TS-05		CONTRACT NO. 61J51		
ILLINOIS / FED. AID PROJECT				




BOLT PATTERN


NOTE:
1. IF THE PEDESTRIAN SIGNAL POST FOUNDATION IS INSTALLED WITHIN OR BEHIND A BARRIER CURB, THE TOP OF THE FOUNDATION SHALL BE INSTALLED FLUSH WITH THE TOP OF THE BARRIER CURB.

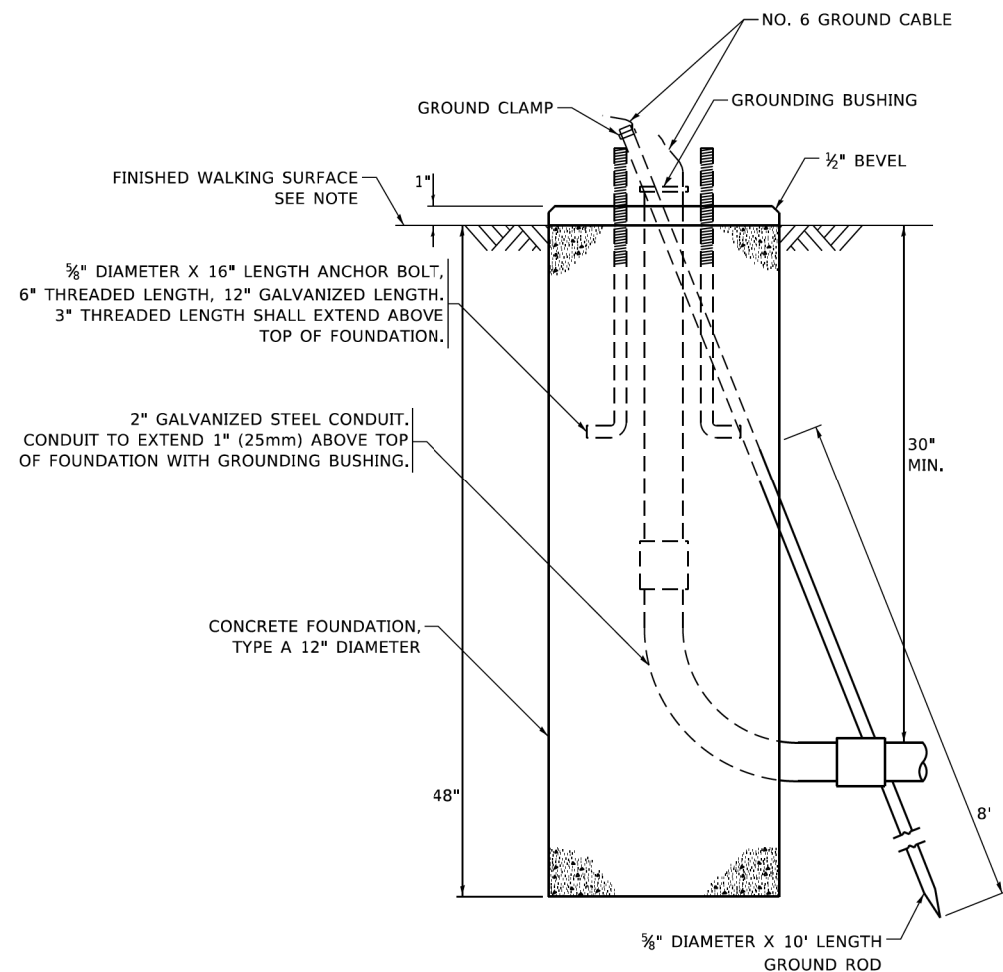


**CONCRETE FOUNDATION,
TYPE A 12-INCH DIAMETER**

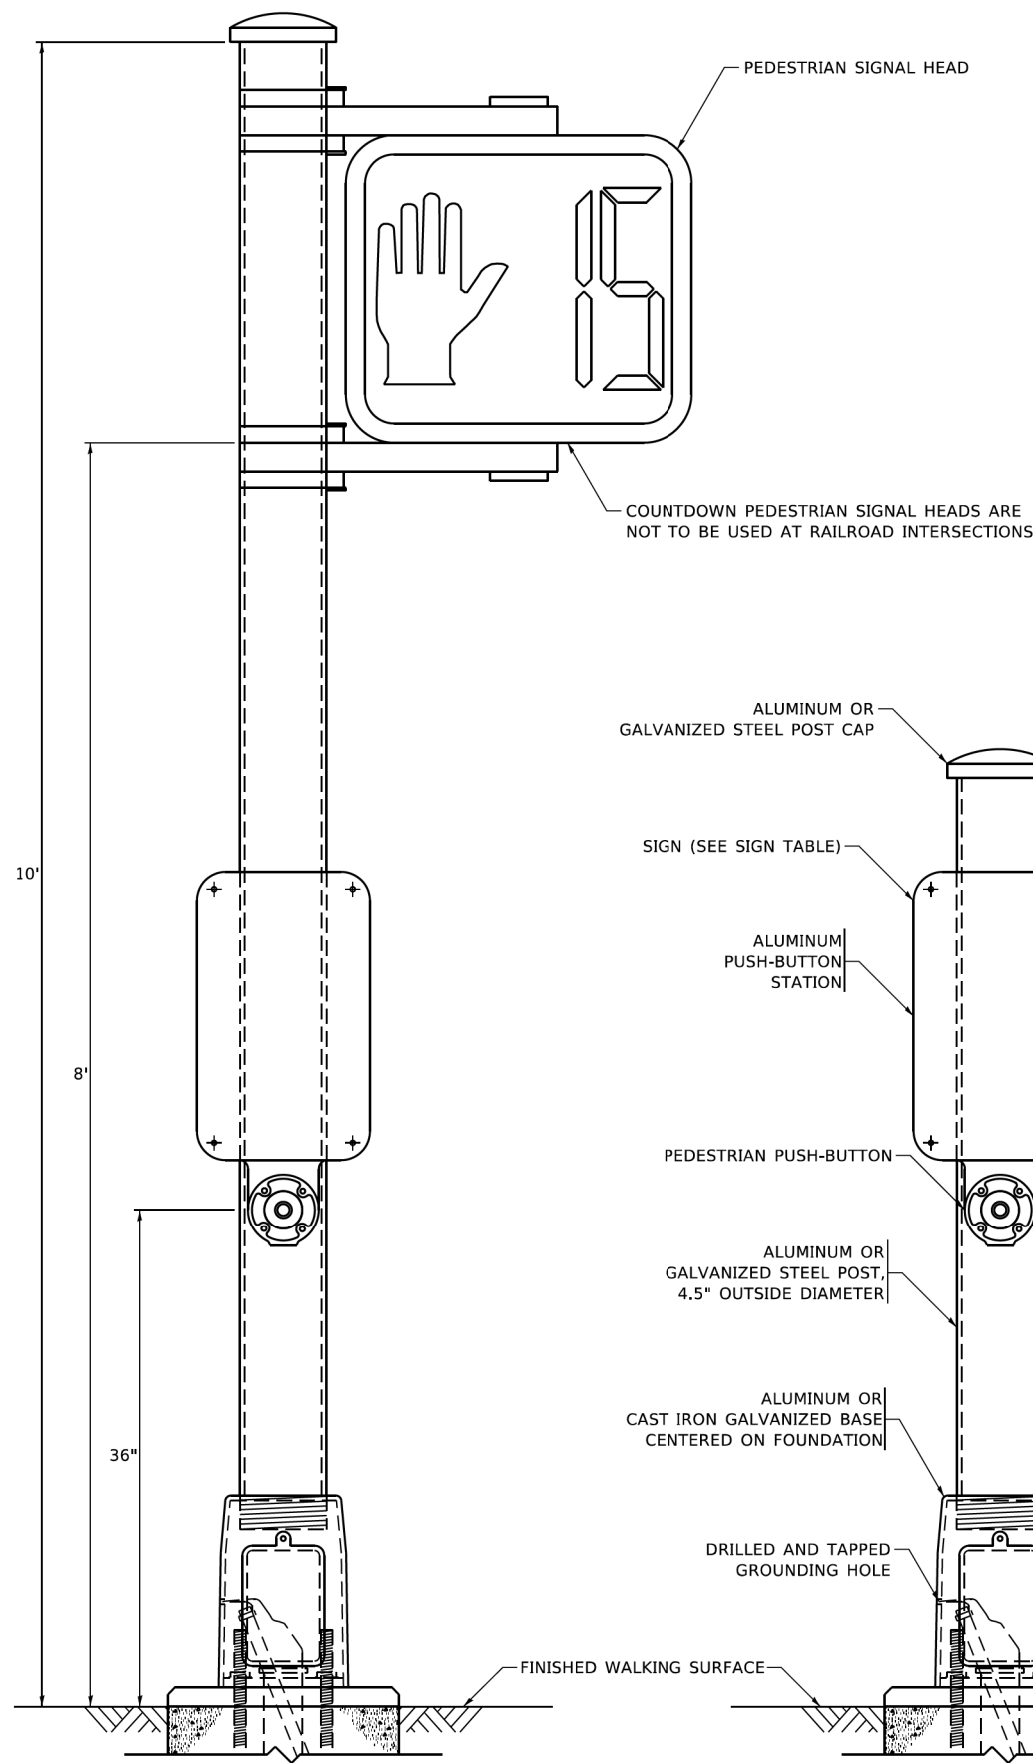


PEDESTRIAN SIGNAL POST, 10 FT.

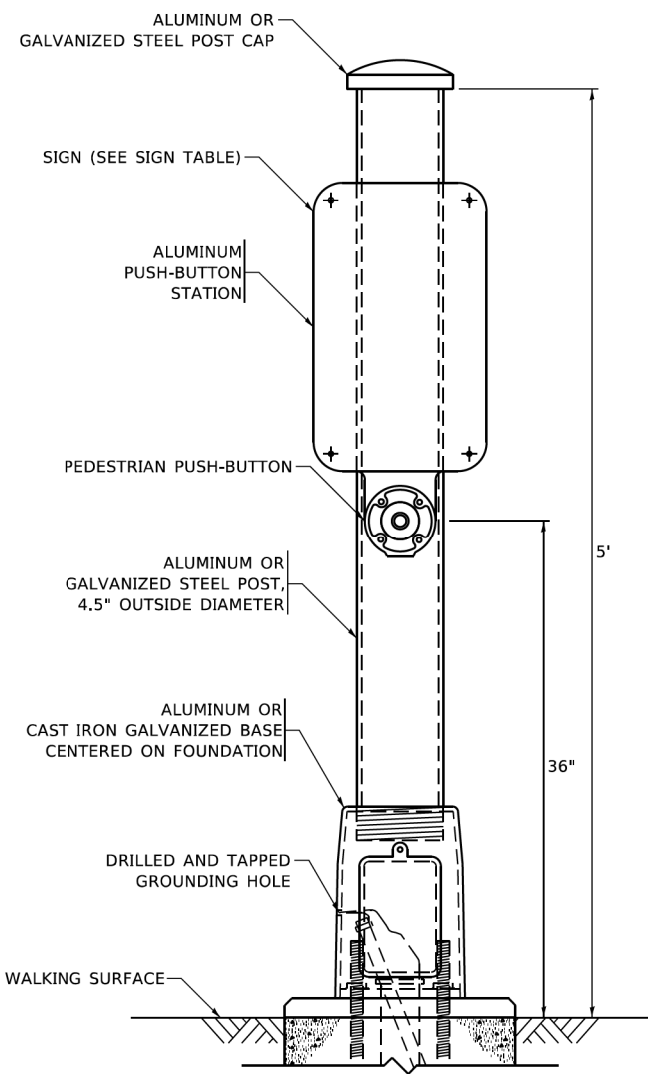


PEDESTRIAN SIGNAL POST, 5 FT.

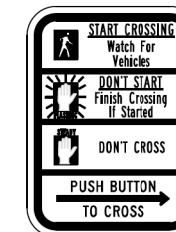

R10-3b

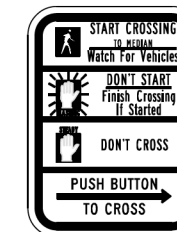

R10-3d

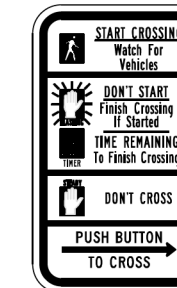

R10-3e

COUNTDOWN PEDESTRIAN SIGNAL HEADS ARE NOT TO BE USED AT RAILROAD INTERSECTIONS

SIGN TABLE

SIGN	DIMENSIONS
R10-3b (RAILROAD ONLY)	9" X 12"
R10-3d (RAILROAD ONLY)	9" X 12"
R10-3e	9" X 12"

NOTES:
1. THE SIGN PANELS SHALL BE TYPE AP SHEETING.
2. THE ARROW ON SIGNS FOR PUSH-BUTTONS SERVING TWO DIRECTIONS ON THE SAME PHASE SHALL BE BI-DIRECTIONAL.
3. THE SIGN FOR DUAL-CALL PUSH-BUTTONS SHALL HAVE NO ARROW.

MODEL: Default
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USER NAME = gaglianob	DESIGNED - IP	REVISED - 10-15-2020
PLOT SCALE = 100,0000' / in.	DRAWN - IP	REVISED -
PLOT DATE = 11/23/2020	CHECKED - LP	REVISED -
	DATE - 10-15-2018	REVISED -

**STATE OF ILLINOIS
DEPARTMENT OF TRANSPORTATION**

**DISTRICT ONE
STANDARD TRAFFIC SIGNAL DESIGN DETAILS**

SCALE: NONE SHEET 7 OF 7 SHEETS STA. TO STA.

F.A. RTE.	SECTION	COUNTY	TOTAL SHEETS	SHEET NO.
0085	19-00511-00-SP	McHENRY	45	20
TS-05			CONTRACT NO. 61J51	
ILLINOIS FED. AID PROJECT				


TRAFFIC SIGNAL NOTES:

1. THE REMOVAL OF EXISTING ELECTRIC CABLE IN CONDUIT SHALL NOT BE PAID FOR SEPARATELY, BUT SHALL BE INCLUDED IN THE COST OF "REMOVE EXISTING TRAFFIC SIGNAL EQUIPMENT". REMOVAL OF EXISTING ELECTRICAL CONDUIT SHALL BE IN ACCORDANCE WITH ARTICLE 895.
2. THE CONTRACTOR SHALL FIELD VERIFY THE PRECISE LOCATIONS AND LAYOUT OF PROPOSED SIGNAL MAST ARMS, POLES, CONTROLLERS, HANDHOLES, AND FOUNDATIONS AND VERIFY ALL EXISTING UTILITIES, OVERHEAD AND UNDERGROUND, PRIOR TO ORDERING MATERIALS, OR PROCEEDING WITH CONSTRUCTION.
3. ALL TRAFFIC SIGNAL SECTIONS SHALL HAVE 12" SINGLE LED LENSES.
4. ALL PEDESTRIAN SECTIONS SHALL HAVE 16" LENSES WITH A MAN/HAND OVERLAY AND COUNTDOWN TIMER.
5. THE RED SECTIONS OF THE SIGNAL HEADS SHARING THE SAME MAST ARM SHALL BE LEVEL WITH ONE ANOTHER AND MAINTAIN A 17' MINIMUM CLEARANCE FROM THE HIGHEST POINT OF THE ROADWAY.
6. THE PROPOSED MAST ARM MOUNTED TRAFFIC SIGNAL HEADS SHALL BE MOUNTED DIRECTLY OVER THE CENTER OF THEIR RESPECTIVE LANES, UNLESS OTHERWISE DIRECTED.
7. ALL TRAFFIC SIGNAL POSTS ARE TO BE GALVANIZED STEEL.
8. PROPOSED HANDHOLES SHALL BE CAST IN PLACE CONCRETE HANDHOLES.
9. THE HANDHOLES SHALL BE CONSTRUCTED SO THAT THE TOP OF THE FRAME WILL BE FLUSH WITH THE SURFACE OF THE MEDIAN, SIDEWALK, CURB, OR GROUND LINE.
10. THE LOCATIONS FOR HANDHOLES, TRAFFIC SIGNAL POST FOUNDATIONS, AND MAST ARM FOUNDATIONS ARE PROVIDED FOR REFERENCE ONLY. THE RESIDENT ENGINEER SHALL BE NOTIFIED FOR LOCATION VERIFICATION BEFORE INSTALLATION.
11. ALL SURPLUS MATERIALS SHALL BE DISPOSED OF IN ACCORDANCE WITH ARTICLE 202.03 OF THE STANDARD SPECIFICATIONS.
12. NO ADDITIONAL COMPENSATION SHALL BE ALLOWED FOR PLACING CONDUIT AT GREATER THAN 3 FT. OR 36" MINIMUM DEPTH TO AVOID OBSTACLES SUCH AS UNDERGROUND UTILITIES. CONDUIT SHALL NEVER BE INSTALLED AT DEPTH LESS THAN 36" UNLESS APPROVED BY THE ENGINEER IN WRITING.
13. THE CONTRACTOR IS RESPONSIBLE FOR THE COST OF UNCOVERING OR HAND DIGGING AROUND UTILITIES AS NECESSARY. THIS COST OF THIS WORK SHALL BE INCLUDED IN THE UNIT PRICES FOR THE CONDUITS OR THE APPROPRIATE PAY ITEM BEING INSTALLED. EXPLORATORY WORK SUCH AS "POT-HOLING" TO EXPOSE EXACT UTILITY LOCATIONS SHALL ALSO BE CONSIDERED INCLUDED IN THE PAY ITEM BEING INSTALLED.
14. ALL TRAFFIC SIGNAL MAST ARMS, POSTS, HANDHOLE LIDS AND RINGS, HANDHOLE FRAMES, CONTROLLER CABINETS, SERVICE RISERS, EXPOSED METALLIC CONDUITS, AND PHOTOCCELL RELAYS SHALL BE GROUNDED IN ACCORDANCE WITH NEC REQUIREMENTS.
15. A 1/4" DIAMETER CONTINUOUS NYLON ROPE SHALL BE FURNISHED AND LEFT IN PLACE IN ALL CONDUITS BETWEEN HANDHOLES AND FOUNDATIONS OR CONTROLLER. SHALL BE PAID FOR WITH UNIT PRICE FOR CONDUIT
16. ALL EXISTING TIMING, PHASING, AND PREEMPTION ARE TO FUNCTION AS THE EXISTING SIGNALS UNLESS OTHERWISE NOTED.
17. ALL EXISTING CONDUIT IS TO REMAIN AND USED IN PLACE UNLESS OTHERWISE NOTED.
18. ALL PEDESTRIAN PUSH BUTTONS AND ASSOCIATED SIGN ASSEMBLIES SHALL BE PARALLEL TO THE CROSSWALK AND BE A MAXIMUM OF 10 INCHES FROM THE EDGE OF SIDEWALK PATH.
19. EVERY MAST ARM MOUNTED FLASHING YELLOW ARROW SIGNAL HEAD SHALL BE INSTALLED ALONG WITH A "FLASHING YELLOW ARROW" SIGN AS DETAILED ON SIGN PANEL DETAIL THIS SHEET. ALL FLASHING YELLOW ARROW SIGNS SHALL BE INSTALLED WITH SUPPORTING/REINFORCING CHANNELS.
20. ALL LUMINAIRE ARMS ON SIGNAL COMBINATION MAST ASSEMBLIES SHALL BE 25' IN LENGTH UNLESS OTHERWISE APPROVED BY THE ENGINEER.
21. ALL HANDHOLES SPECIFIED TO BE REMOVED SHALL ALSO INCLUDE REQUIRED WORK, AS APPROVED BY THE ENGINEER, ASSOCIATED WITH SEALING THE ABANDONED CONDUITS FROM BOTH ENDS OF THE CONDUIT PATHWAY WITH MORTAR OR OTHER MATERIAL AS APPROVED BY THE ENGINEER. THIS ADDITIONAL WORK SHALL BE INCLUDED IN THE COST OF THE HANDHOLE BEING REMOVED. IF PROPOSED CONDUITS INTERCEPT EXISTING CONDUITS, THE COST ASSOCIATED WITH LABOR AND MATERIALS TO MAKE AN ENGINEER APPROVED CONNECTION SHALL BE COMPENSATED FOR AS PART OF THE PROPOSED CONDUIT BEING INSTALLED.
22. ALL SIGNS ASSOCIATED WITH TRAFFIC SIGNAL HEADS TO BE REMOVED SHALL ALSO BE REMOVED.
23. A DAMPENING PLATE SHALL BE INSTALLED NEAR THE ENDS OF ALL MAST ARMS OVER 41 FEET IN LENGTH. THE COST OF THE DAMPENING PLATE SHALL BE INCLUDED IN THE COST OF THE RESPECTIVE MAST ARM PAY ITEM. SEE DETAIL.
24. THE EXISTING TRAFFIC SIGNALS SHALL REMAIN IN OPERATION UNTIL THE PROPOSED SIGNAL EQUIPMENT AND CABLING IS INSTALLED. THE SIGNAL SHALL BE TAKEN OFFLINE AND REPLACED WITH AN ALL WAY STOP, AT A TIME AND DATE APPROVED BY THE COUNTY, WHILE THE NEW SERVICE CONNECTOIN, CONTROLLER, AND CABINET EQUIPMENT IS INSTALLED AND MADE OPERATIONAL.




CABLE PLAN NOTES

1. THE CONTRACTOR SHALL INFORM THE COUNTY PRIOR TO THE START OF ANY WORK ON THE CONTRACT. A MINIMUM OF FIVE (5) WORKING DAYS ADVANCED NOTICE IS REQUIRED.
2. THE EXACT LOCATIONS OF ALL UTILITIES SHALL BE FIELD VERIFIED BY THE CONTRACTOR BEFORE THE INSTALLATION OF ANY COMPONENTS OF THE TRAFFIC SIGNAL SYSTEM. FOR THE LOCATIONS OF THE UTILITIES, CALL JULIE TOLL FREE 1-800-892-0123.8. IT IS CONTRACTOR'S RESPONSIBILITY TO LOCATE EXISTING TRAFFIC SIGNAL CABLES AND CONDUITS AND ROADWAY LIGHTING SYSTEM CABLES REGARDLESS OF MAINTENANCE RESPONSIBILITY OF SYSTEM NEEDING TO BE LOCATED.
3. ALL WORK ASSOCIATED WITH INSTALLING NEW CONDUIT INTO EXISTING HANDHOLES, SUCH AS GROUTING, CORING, PATCHING, ETC. SHALL BE INCLUDED IN THE PRICE OF THE CONDUIT BEING INSTALLED.

FLASHING YELLOW ARROW SIGN

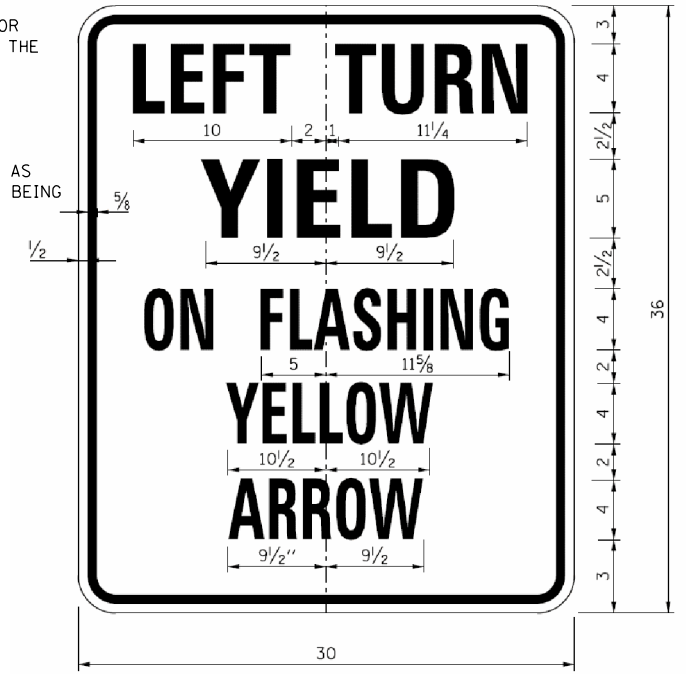

COLOR: BACKGROUND - WHITE
MESSAGE: - BLACK
LINE 1 IS SERIES - C
LINE 2, 4, AND 5 ARE SERIES - D
LINE 3 IS SERIES - B
ALL DIMENSIONS SHOWN ARE IN INCHES
SHEETING: TYPE ZZ

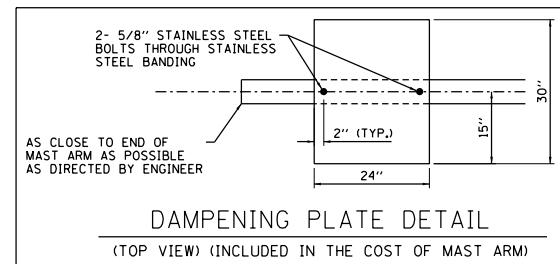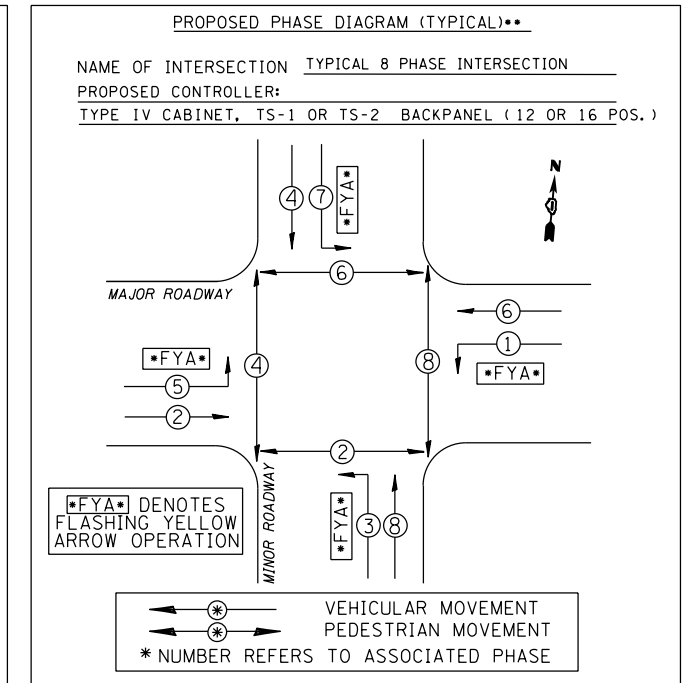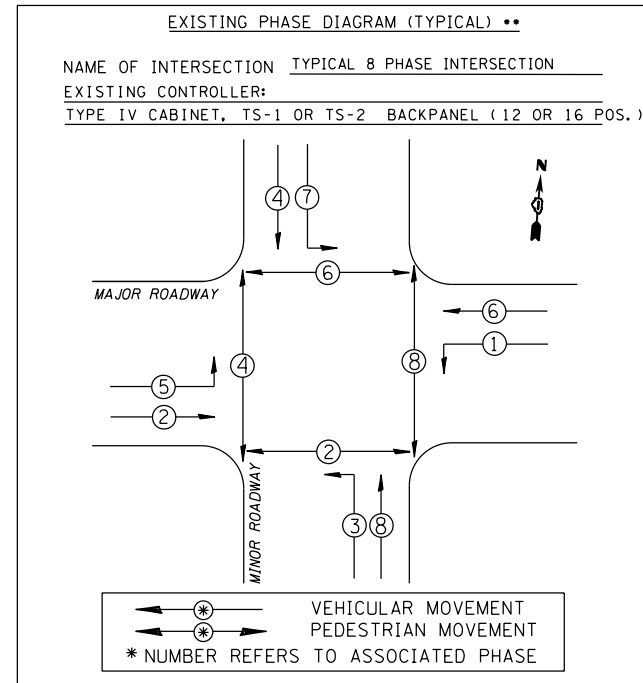

(TYPICAL) ** : SEE INTERSECTION SPECIFIC TRAFFIC SIGNAL AND CABLE PLANS FOR LOCATION SPECIFIC DETAILS AS THERE ARE VARIATIONS FROM THE TYPICAL SHOWN. PHASE DESIGNATIONS SHALL FOLLOW STANDARD 857001 (EXAMPLE PHASE 2 MAY BE EITHER NORTHBOUND THROUGH OR EASTBOUND THROUGH BASED UPON WHICH ROADWAY IS DESIGNATED AS "MAJOR ROADWAY").



DESIGNED	
DRAWN	
REVIEWED	

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PLOT DATE = 2/17/2023	DATE -	REVISED -

**STATE OF ILLINOIS
DEPARTMENT OF TRANSPORTATION**

SIGNAL DETAIL

SCALE: SHEET OF SHEETS STA. TO STA.

F.A.U. RTE.	SECTION	COUNTY	TOTAL SHEETS	SHEET NO.
0085	19-00511-00-SP	McHENRY	45	21
19L0111			CONTRACT NO. 61J51	
ILLINOIS FED. AID PROJECT				





REMOVAL NOTES:

THE FOLLOWING ITEMS SHALL BE REMOVED BY THE CONTRACTOR AND SHALL BE DISPOSED OF BY THEM OUTSIDE THE RIGHT-OF-WAY AT THEIR EXPENSE. THE SALVAGE VALUE OF THE REMOVED EQUIPMENT SHALL BE REFLECTED IN THE CONTRACT BID PRICE.

- 6 EACH 5-SECTION SIGNAL HEAD
- 8 EACH 3-SECTION SIGNAL HEAD

GENERAL NOTES:

ALL FENCING WITHIN ROW SHALL BE PROTECTED.
 ALL EXISTING SIGNAL HEADS SHALL BE REPLACED.
 ALL PUSH BUTTONS TO BE APS.
 ALL PUSH BUTTONS TO BE INSTALLED WITH R10-3e SIGN.
 WESTBOUND SIGNAL PHASES SHALL BE UPDATED TO MATCH EASTBOUND TIMINGS.

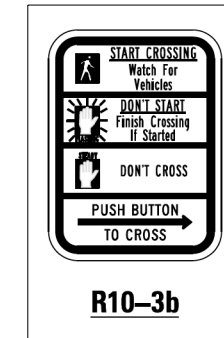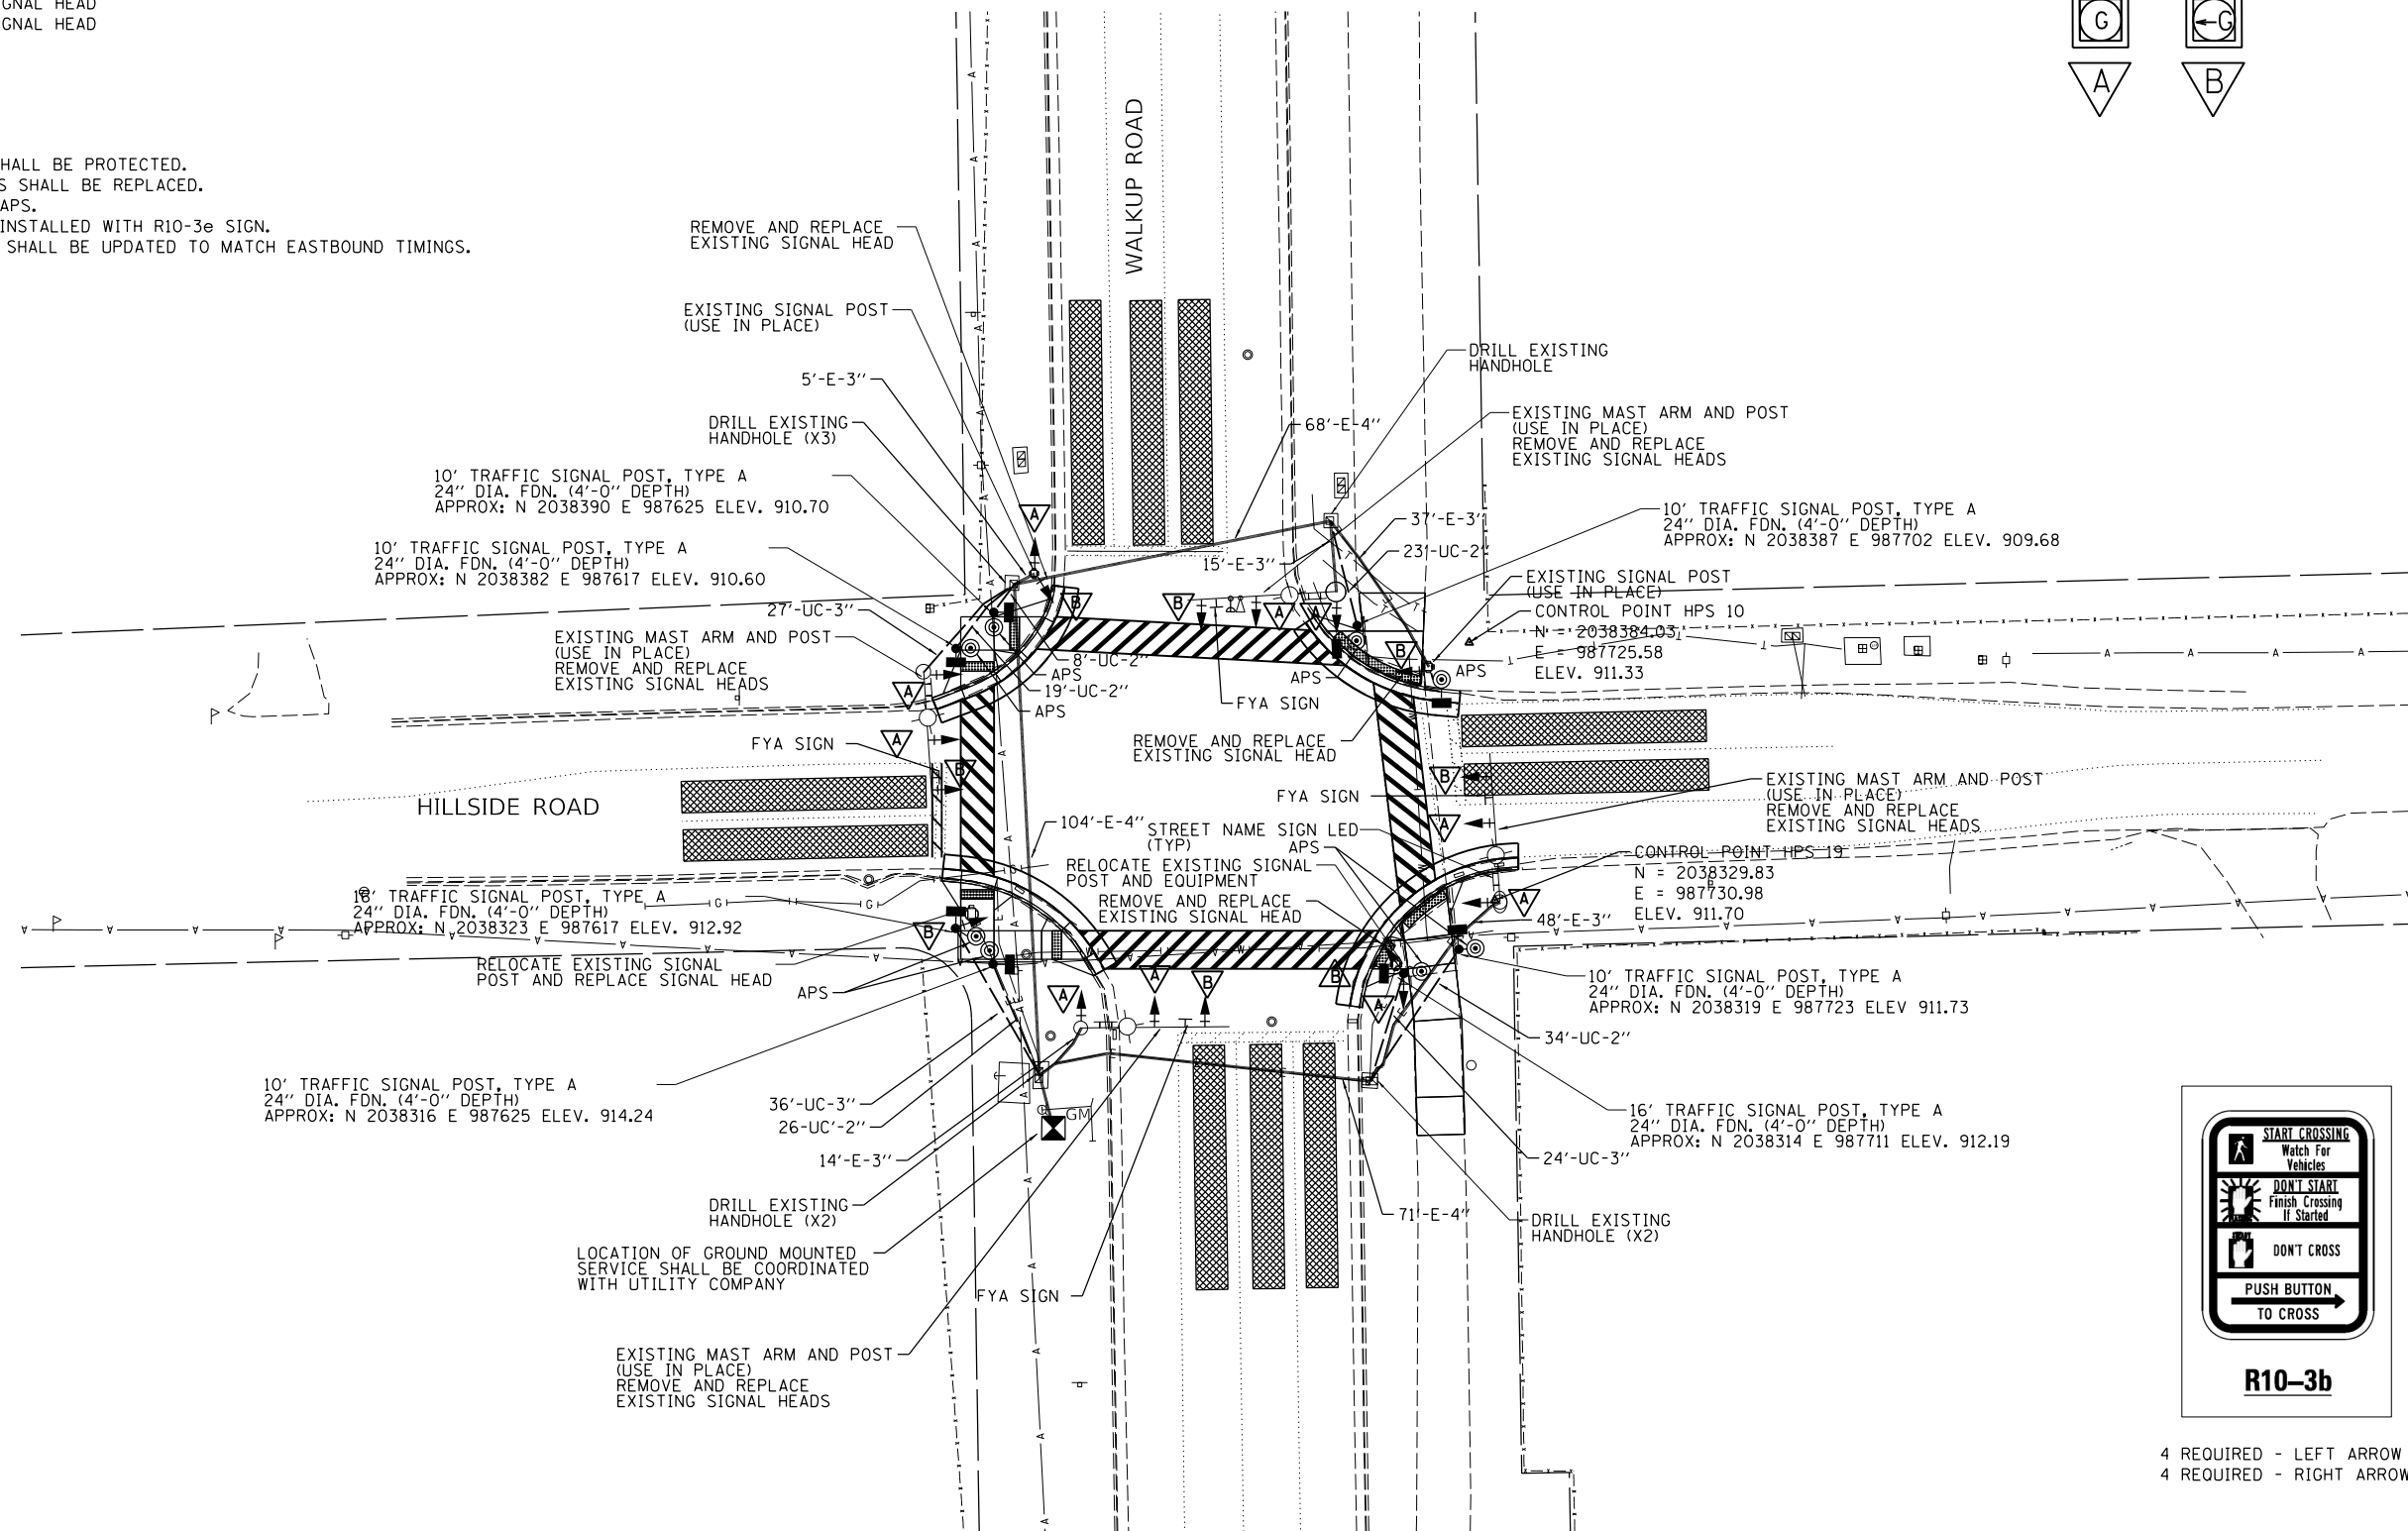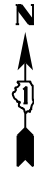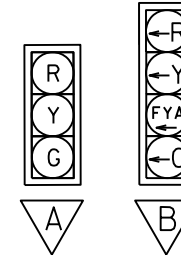

FYA SIGN
 4 REQUIRED

4 REQUIRED - LEFT ARROW
 4 REQUIRED - RIGHT ARROW



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	DATE -	REVISED -

STATE OF ILLINOIS
DEPARTMENT OF TRANSPORTATION

HILLSIDE ROAD / WALKUP ROAD
SIGNAL PLAN


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19L0111			CONTRACT NO.	61J51
ILLINOIS		FED. AID PROJECT		




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PROPOSED PHASE DIAGRAM



**PROPOSED EMERGENCY VEHICLE
PREEMPTION SEQUENCE**

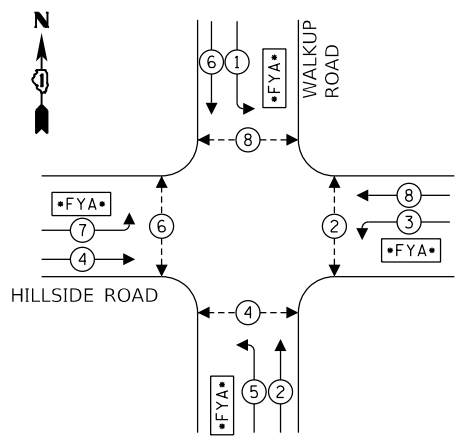

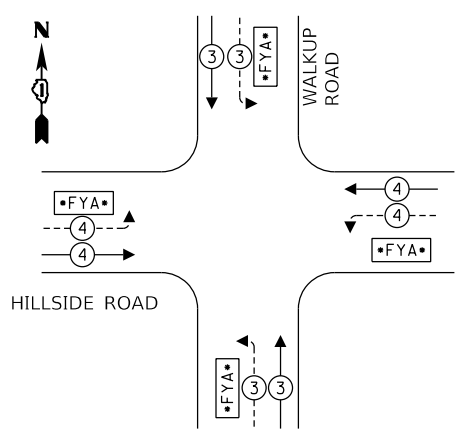
**TRAFFIC SIGNAL INSTALLATION
ELECTRICAL SERVICE REQUIREMENTS**

TYPE	NO. LAMPS	LED WATTAGE	% OPERATION	TOTAL WATTAGE
SIGNAL (RED)	19	11	50	104.5
(YELLOW)	19	20	5	19.0
(GREEN)	19	12	45	102.6
FYA	8	10	45	36.0
PED. SIGNAL				8
CONTROLLER				1
UPS				1
VIDEO DETECTION				1
LUMINAIRE				4
PTZ/SURVEILLANCE				1
TOTAL =			1137.1	

ENERGY COST - BILLED TO: McHENRY COUNTY
 2200 N. SEMINARY AVE.
 WOODSTOCK, IL 60098

ENERGY SUPPLY - CONTACT: LISA ARGAST
 PHONE: (630) 576-7094
 COMPANY: COMED

PAY ITEM	DESCRIPTION	UNIT	Quantity
72000100	SIGN PANEL - TYPE 1	SQ FT	38
81028200	UNDERGROUND CONDUIT, GALVANIZED STEEL, 2" DIA.	FOOT	110
81028220	UNDERGROUND CONDUIT, GALVANIZED STEEL, 3" DIA.	FOOT	87
87301245	ELECTRIC CABLE IN CONDUIT, SIGNAL NO 14 5C	FOOT	3338
87301255	ELECTRIC CABLE IN CONDUIT, SIGNAL NO 14 7C	FOOT	421
87301900	ELECTRIC CABLE IN CONDUIT, EQUIPMENT GROUNDING CONDUCTOR, NO. 6 1C	FOOT	243
87502440	TRAFFIC SIGNAL POST, GALVANIZED STEEL 10 FT.	EACH	5
87502500	TRAFFIC SIGNAL POST, GALVANIZED STEEL 16 FT.	EACH	2
87800100	CONCRETE FOUNDATION, TYPE A	FOOT	28
87900200	DRILL EXISTING HANDHOLE	EACH	8
88040070	SIGNAL HEAD, POLYCARBONATE, LED, 1-FACE, 3-SECTION, BRACKET MOUNTED	EACH	6
88040090	SIGNAL HEAD, POLYCARBONATE, LED, 1-FACE, 3-SECTION, MAST ARM MOUNTED	EACH	4
88040110	SIGNAL HEAD, POLYCARBONATE, LED, 1-FACE, 4-SECTION, BRACKET MOUNTED	EACH	4
88040120	SIGNAL HEAD, POLYCARBONATE, LED, 1-FACE, 4-SECTION, MAST ARM MOUNTED	EACH	4
88102717	PEDESTRIAN SIGNAL HEAD, LED, 1-FACE, BRACKET MOUNTED WITH COUNTDOWN TIMER	EACH	8
88200510	TRAFFIC SIGNAL BACKPLATE, RETROREFLECTIVE	EACH	18
89502210	MODIFY EXISTING CONTROLLER CABINET	EACH	1
89502375	REMOVE EXISTING TRAFFIC SIGNAL EQUIPMENT	EACH	1
X0321973	MODIFY EXISTING SERVICE INSTALLATION	EACH	1
X0324599	ROD AND CLEAN EXISTING CONDUIT	FOOT	243
X1400150	SERVICE INSTALLATION, GROUND MOUNTED, METERED	EACH	1
X8570215	FULL-ACTUATED CONTROLLER IN EXISTING CABINET	EACH	1
X8760200	ACCESSIBLE PEDESTRIAN SIGNALS	EACH	8
X8809005	LED SIGNAL FACE, LENS COVER	EACH	18
XX005937	LED INTERNALLY ILLUMINATED STREET NAME SIGN	EACH	4

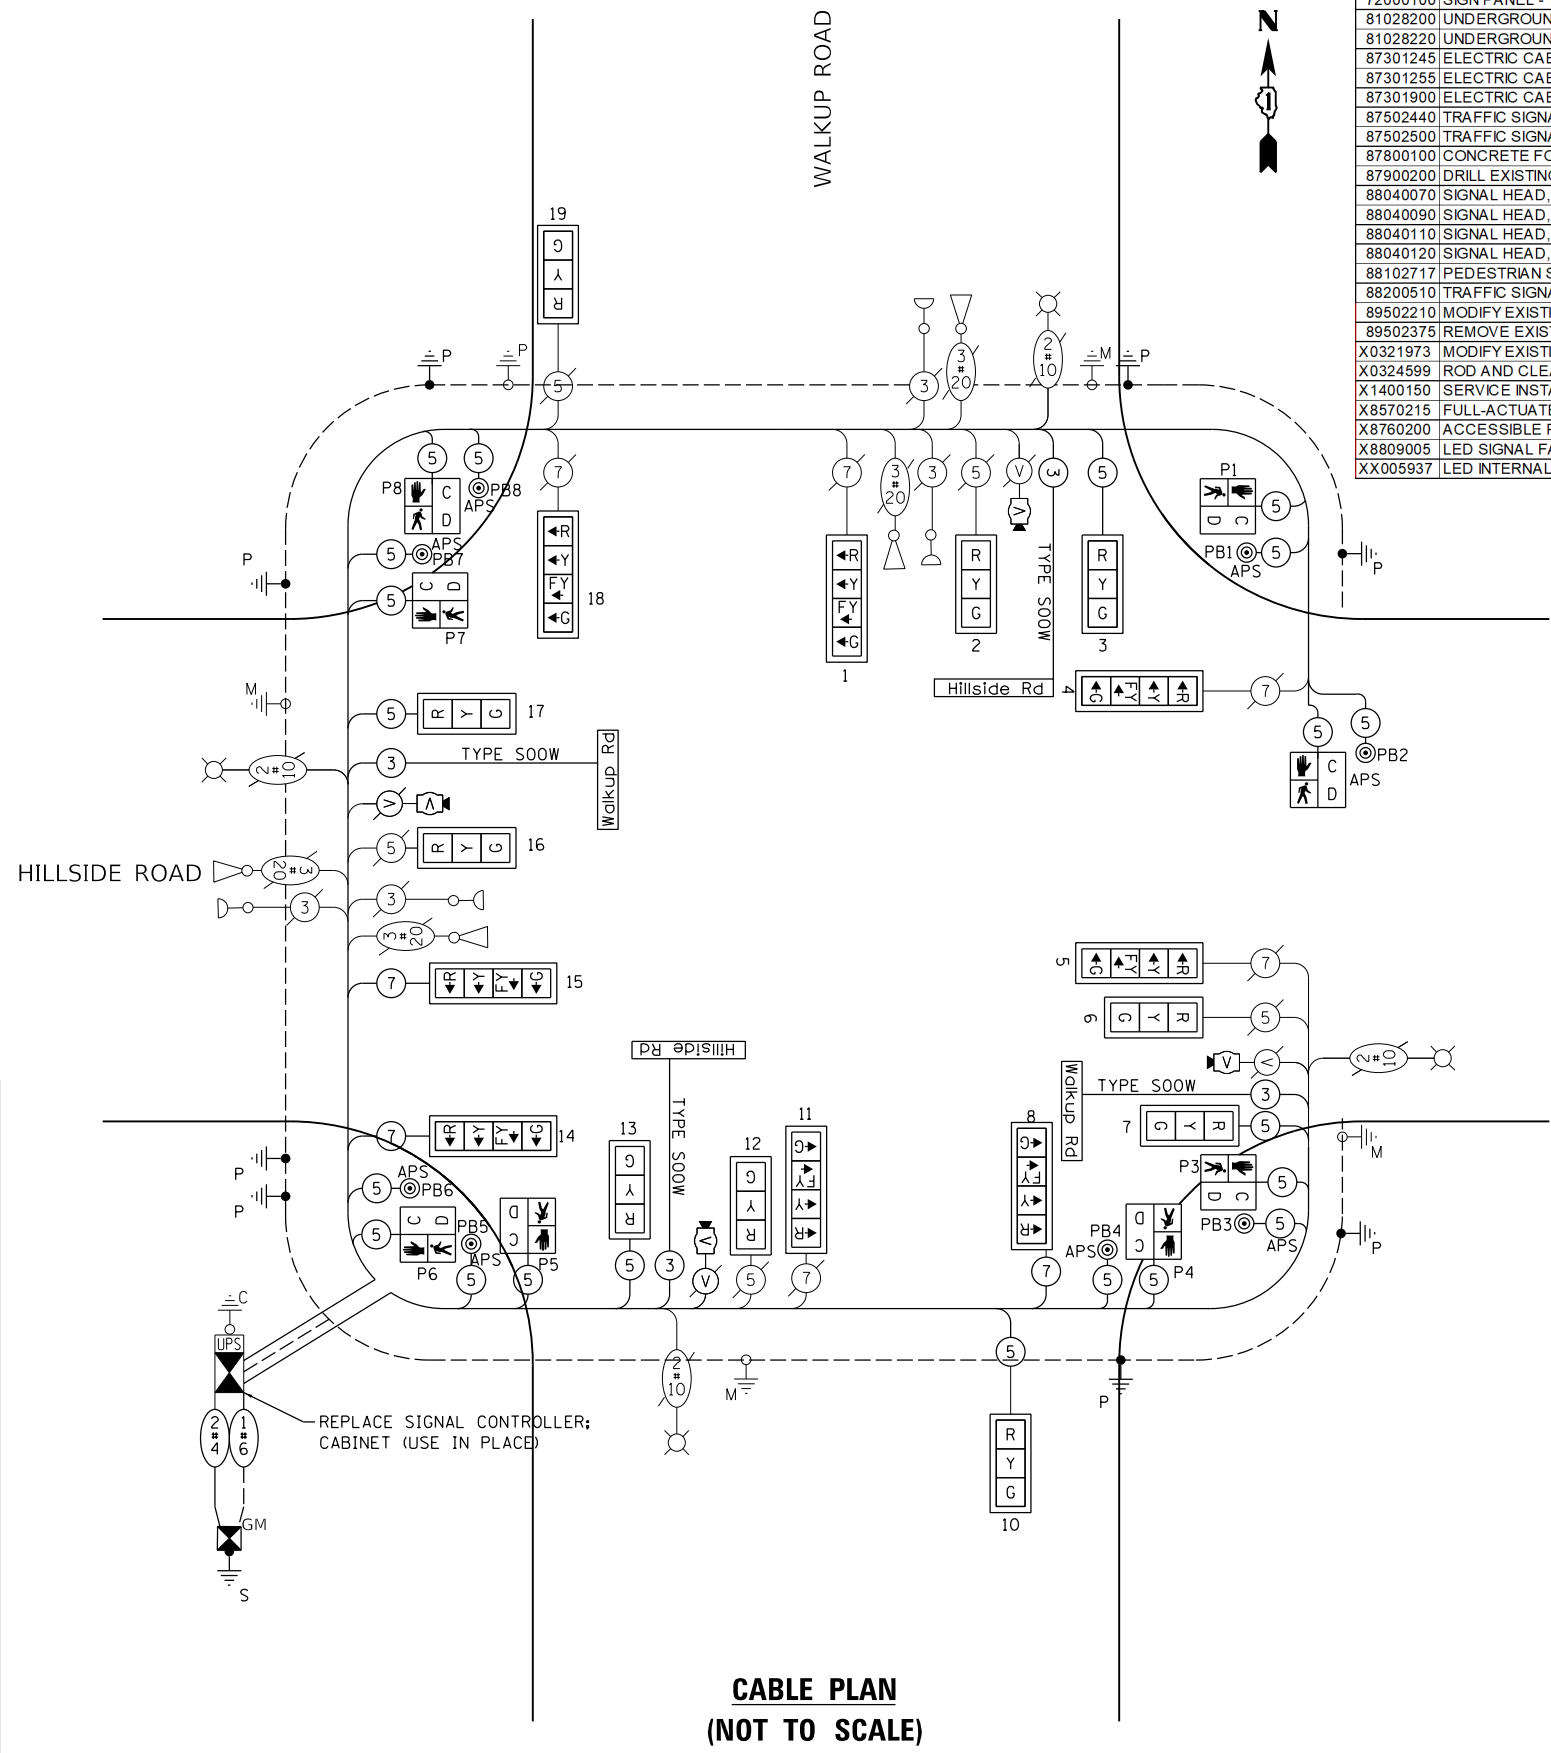

**CABLE PLAN
(NOT TO SCALE)**

DESIGNED	
DRAWN	
REVIEWED	

USER NAME = Pearc00397	DESIGNED -	REVISED -
PLOT SCALE = 40.0000 ' / in.	DRAWN -	REVISED -
PLOT DATE = 2/17/2023	CHECKED -	REVISED -
	DATE -	REVISED -

**STATE OF ILLINOIS
DEPARTMENT OF TRANSPORTATION**

**HILLSIDE ROAD / WALKUP ROAD
WIRING DIAGRAM**

F.A.U. RTE.	SECTION	COUNTY	TOTAL SHEETS	SHEET NO.
0085	19-00511-00-SP	McHENRY	45	23
19L0111			CONTRACT NO.	61J51

SCALE: SHEET OF SHEETS STA. TO STA.

HPS1

ILLINOIS FED. AID PROJECT



REMOVAL NOTES:

THE FOLLOWING ITEMS SHALL BE REMOVED BY THE CONTRACTOR AND SHALL BE DISPOSED OF BY THEM OUTSIDE THE RIGHT-OF-WAY AT THEIR EXPENSE. THE SALVAGE VALUE OF THE REMOVED EQUIPMENT SHALL BE REFLECTED IN THE CONTRACT BID PRICE.


- 2 EACH STEEL MAST ARM ASSEMBLY AND POLE
- 2 EACH 3-SECTION SIGNAL HEAD
- 4 EACH 5-SECTION SIGNAL HEAD

GENERAL NOTES:

ALL EXISTING SIGNAL HEADS SHALL BE REMOVED AND REPLACED.
 ALL PUSH BUTTONS TO BE APS.
 ALL PUSH BUTTONS TO BE INSTALLED WITH R10-3e SIGN.
 EVP AND VIDEO DETECTION EQUIPMENT TO BE RELOCATED TO NEW MAST ARMS.

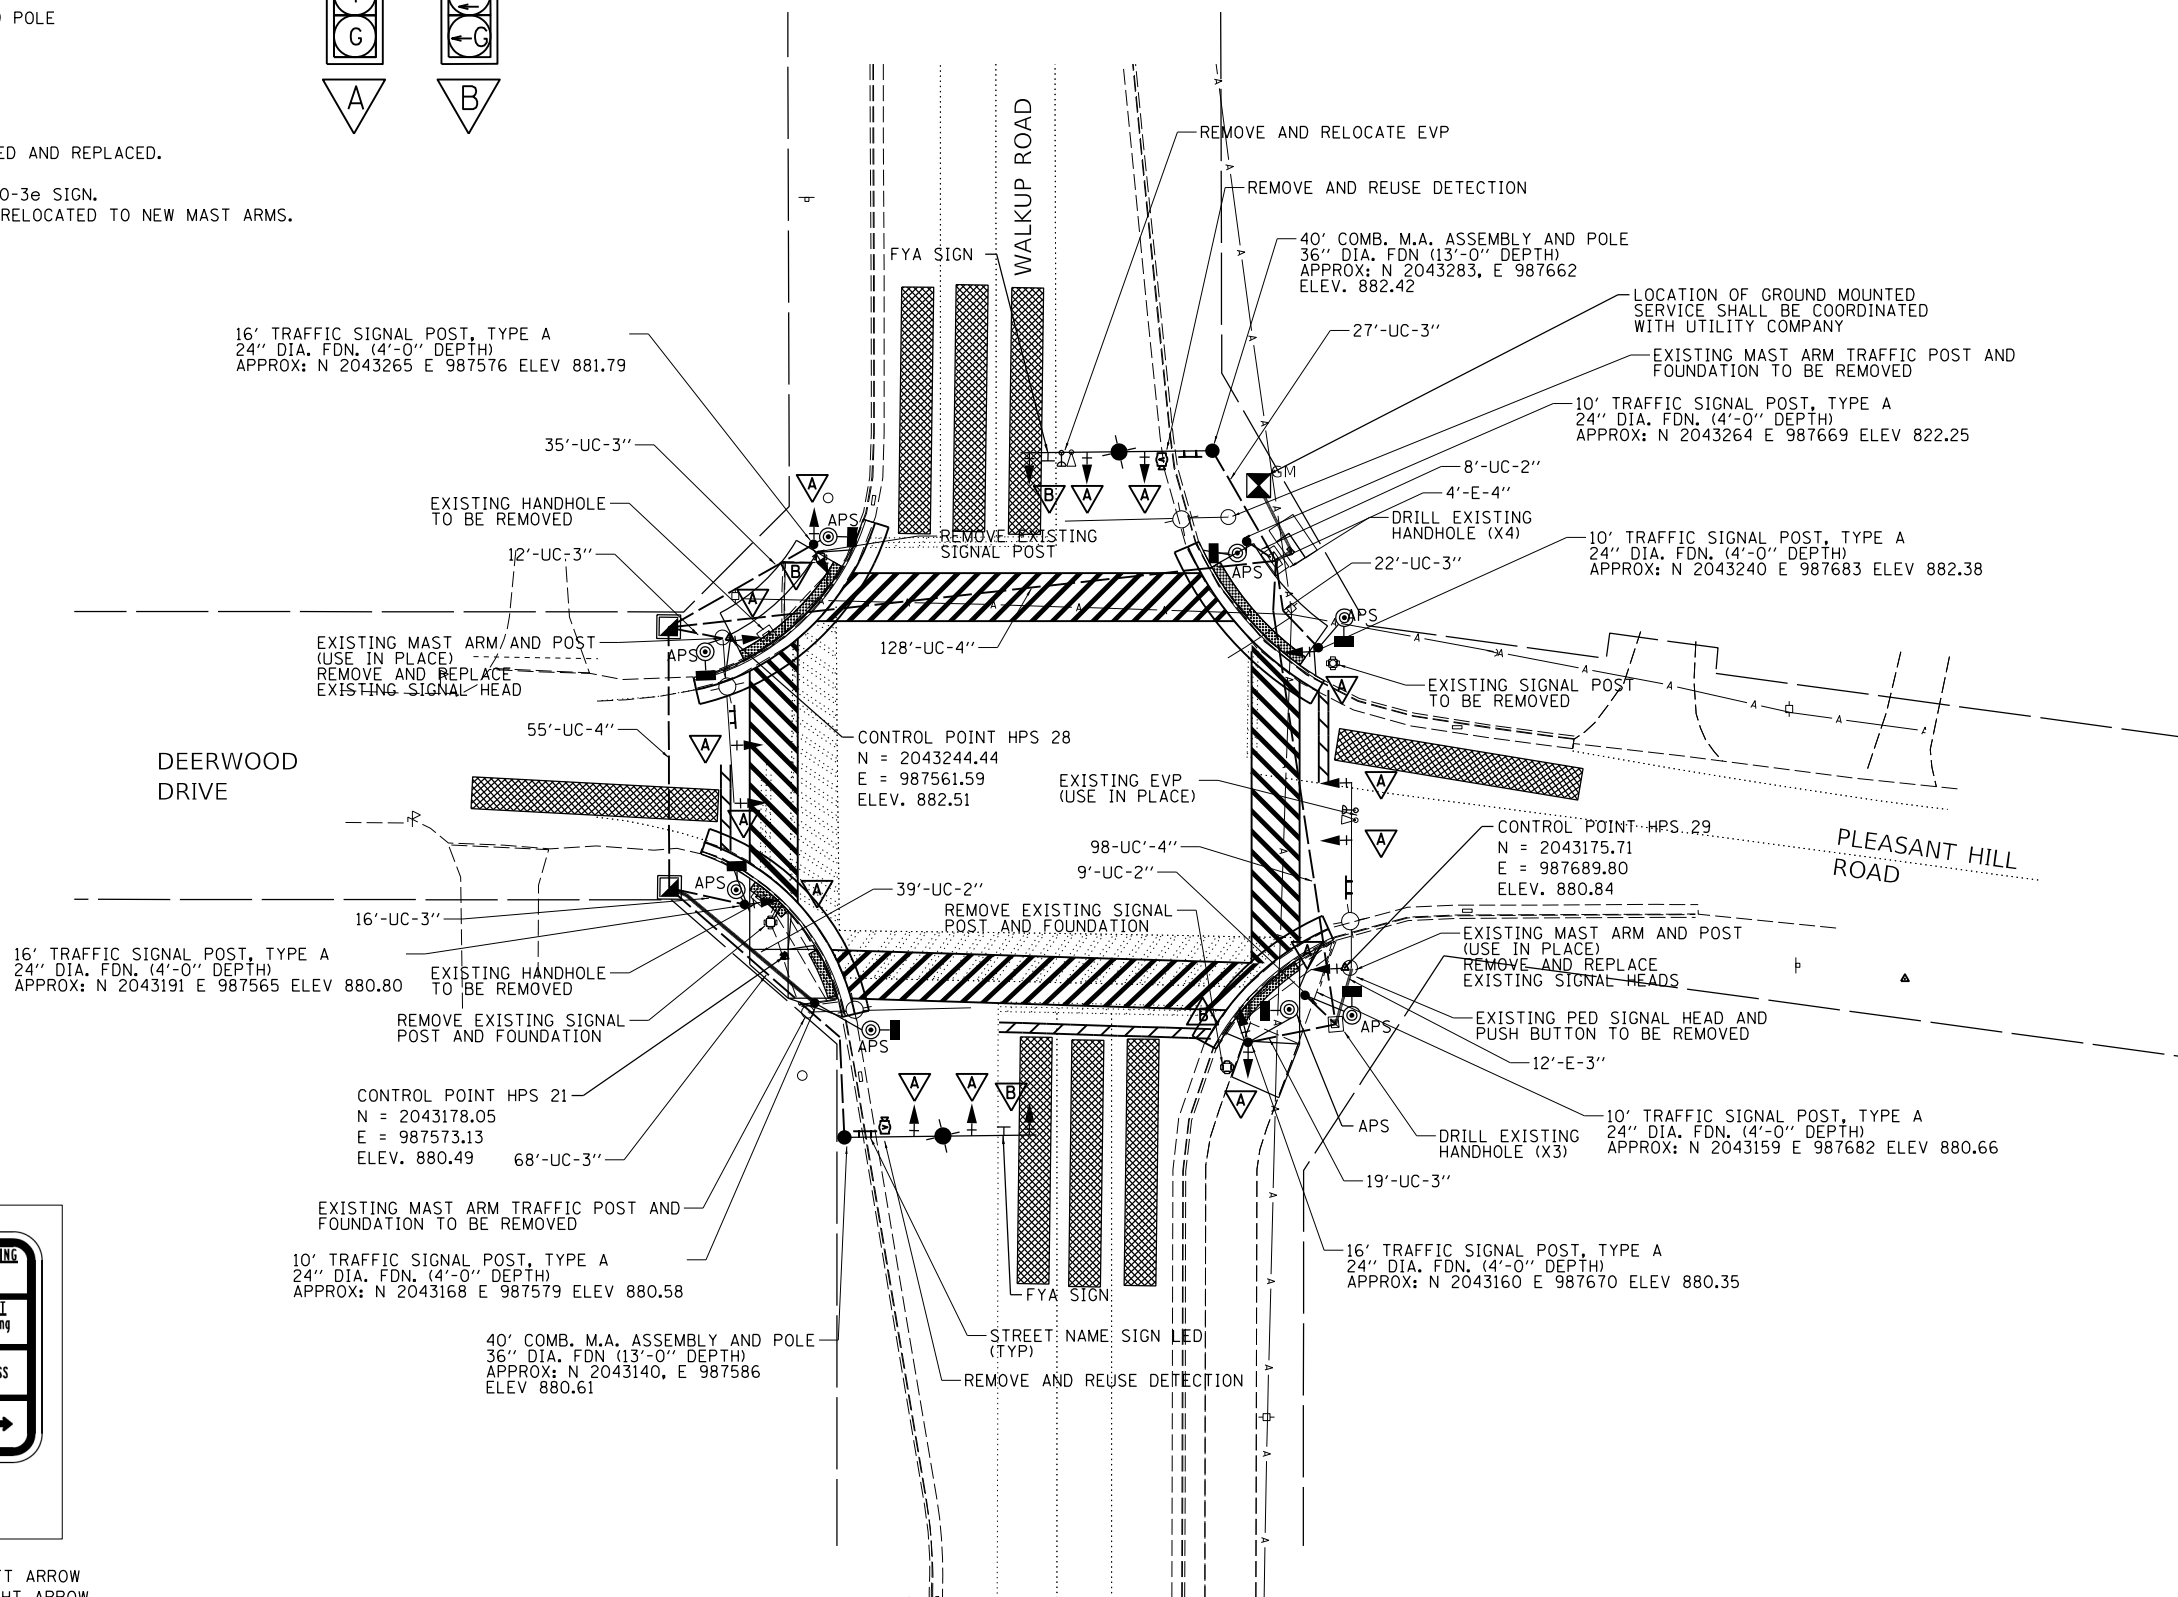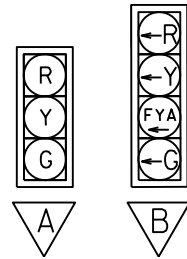

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FYA SIGN
2 REQUIRED

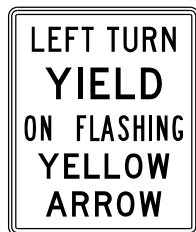

4 REQUIRED - LEFT ARROW
4 REQUIRED - RIGHT ARROW



DESIGNED	
DRAWN	
REVIEWED	

USER NAME = Pearc00397	DESIGNED - TMA	REVISED -
PLOT SCALE = 40.0000' / in.	DRAWN - MOC/TMA	REVISED -
PLOT DATE = 2/17/2023	CHECKED - KNB	REVISED -
	DATE -	REVISED -

**STATE OF ILLINOIS
DEPARTMENT OF TRANSPORTATION**

**PLEASANT HILL ROAD / WALKUP ROAD
SIGNAL PLAN**

SCALE: 1"=20' SHEET OF SHEETS STA. TO STA.


F.A.U. RTE.	SECTION	COUNTY	TOTAL SHEETS	SHEET NO.
0085	19-00511-00-SP	McHENRY	45	24
	19L0111		CONTRACT NO.	61J51

ILLINOIS FED. AID PROJECT




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 PLOT DATE = 2/17/2023

PROPOSED PHASE DIAGRAM

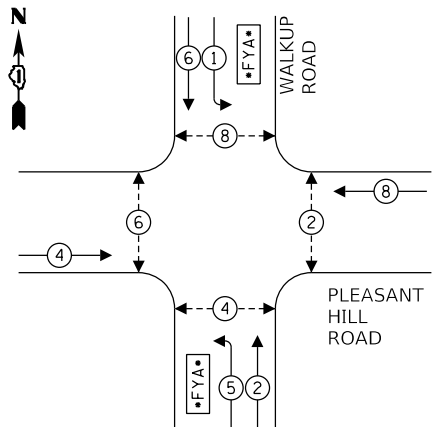

PROPOSED EMERGENCY VEHICLE PREEMPTION SEQUENCE

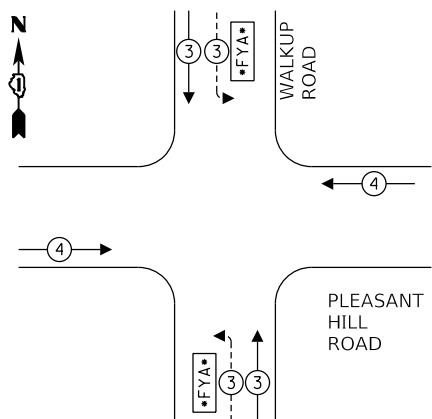


TRAFFIC SIGNAL INSTALLATION ELECTRICAL SERVICE REQUIREMENTS

TYPE	NO. LAMPS	LED WATTAGE	% OPERATION	TOTAL WATTAGE
SIGNAL	(RED)	18	11	99.0
	(YELLOW)	18	20	18.0
	(GREEN)	18	12	97.2
	FYA	4	10	18.0
PED. SIGNAL	8	20	100	160.0
CONTROLLER	1	100	100	100.0
UPS	1	25	100	25.0
VIDEO DETECTION	1	150	100	150.0
LUMINAIRE	4	190	50	380.0
TOTAL =				1047.2

ENERGY COST - BILLED TO: MCHENRY COUNTY
 2200 N. SEMINARY AVE.
 WOODSTOCK, IL 60098

ENERGY SUPPLY - CONTACT: LISA ARGAST
 PHONE: (630) 576-7094
 COMPANY: COMED

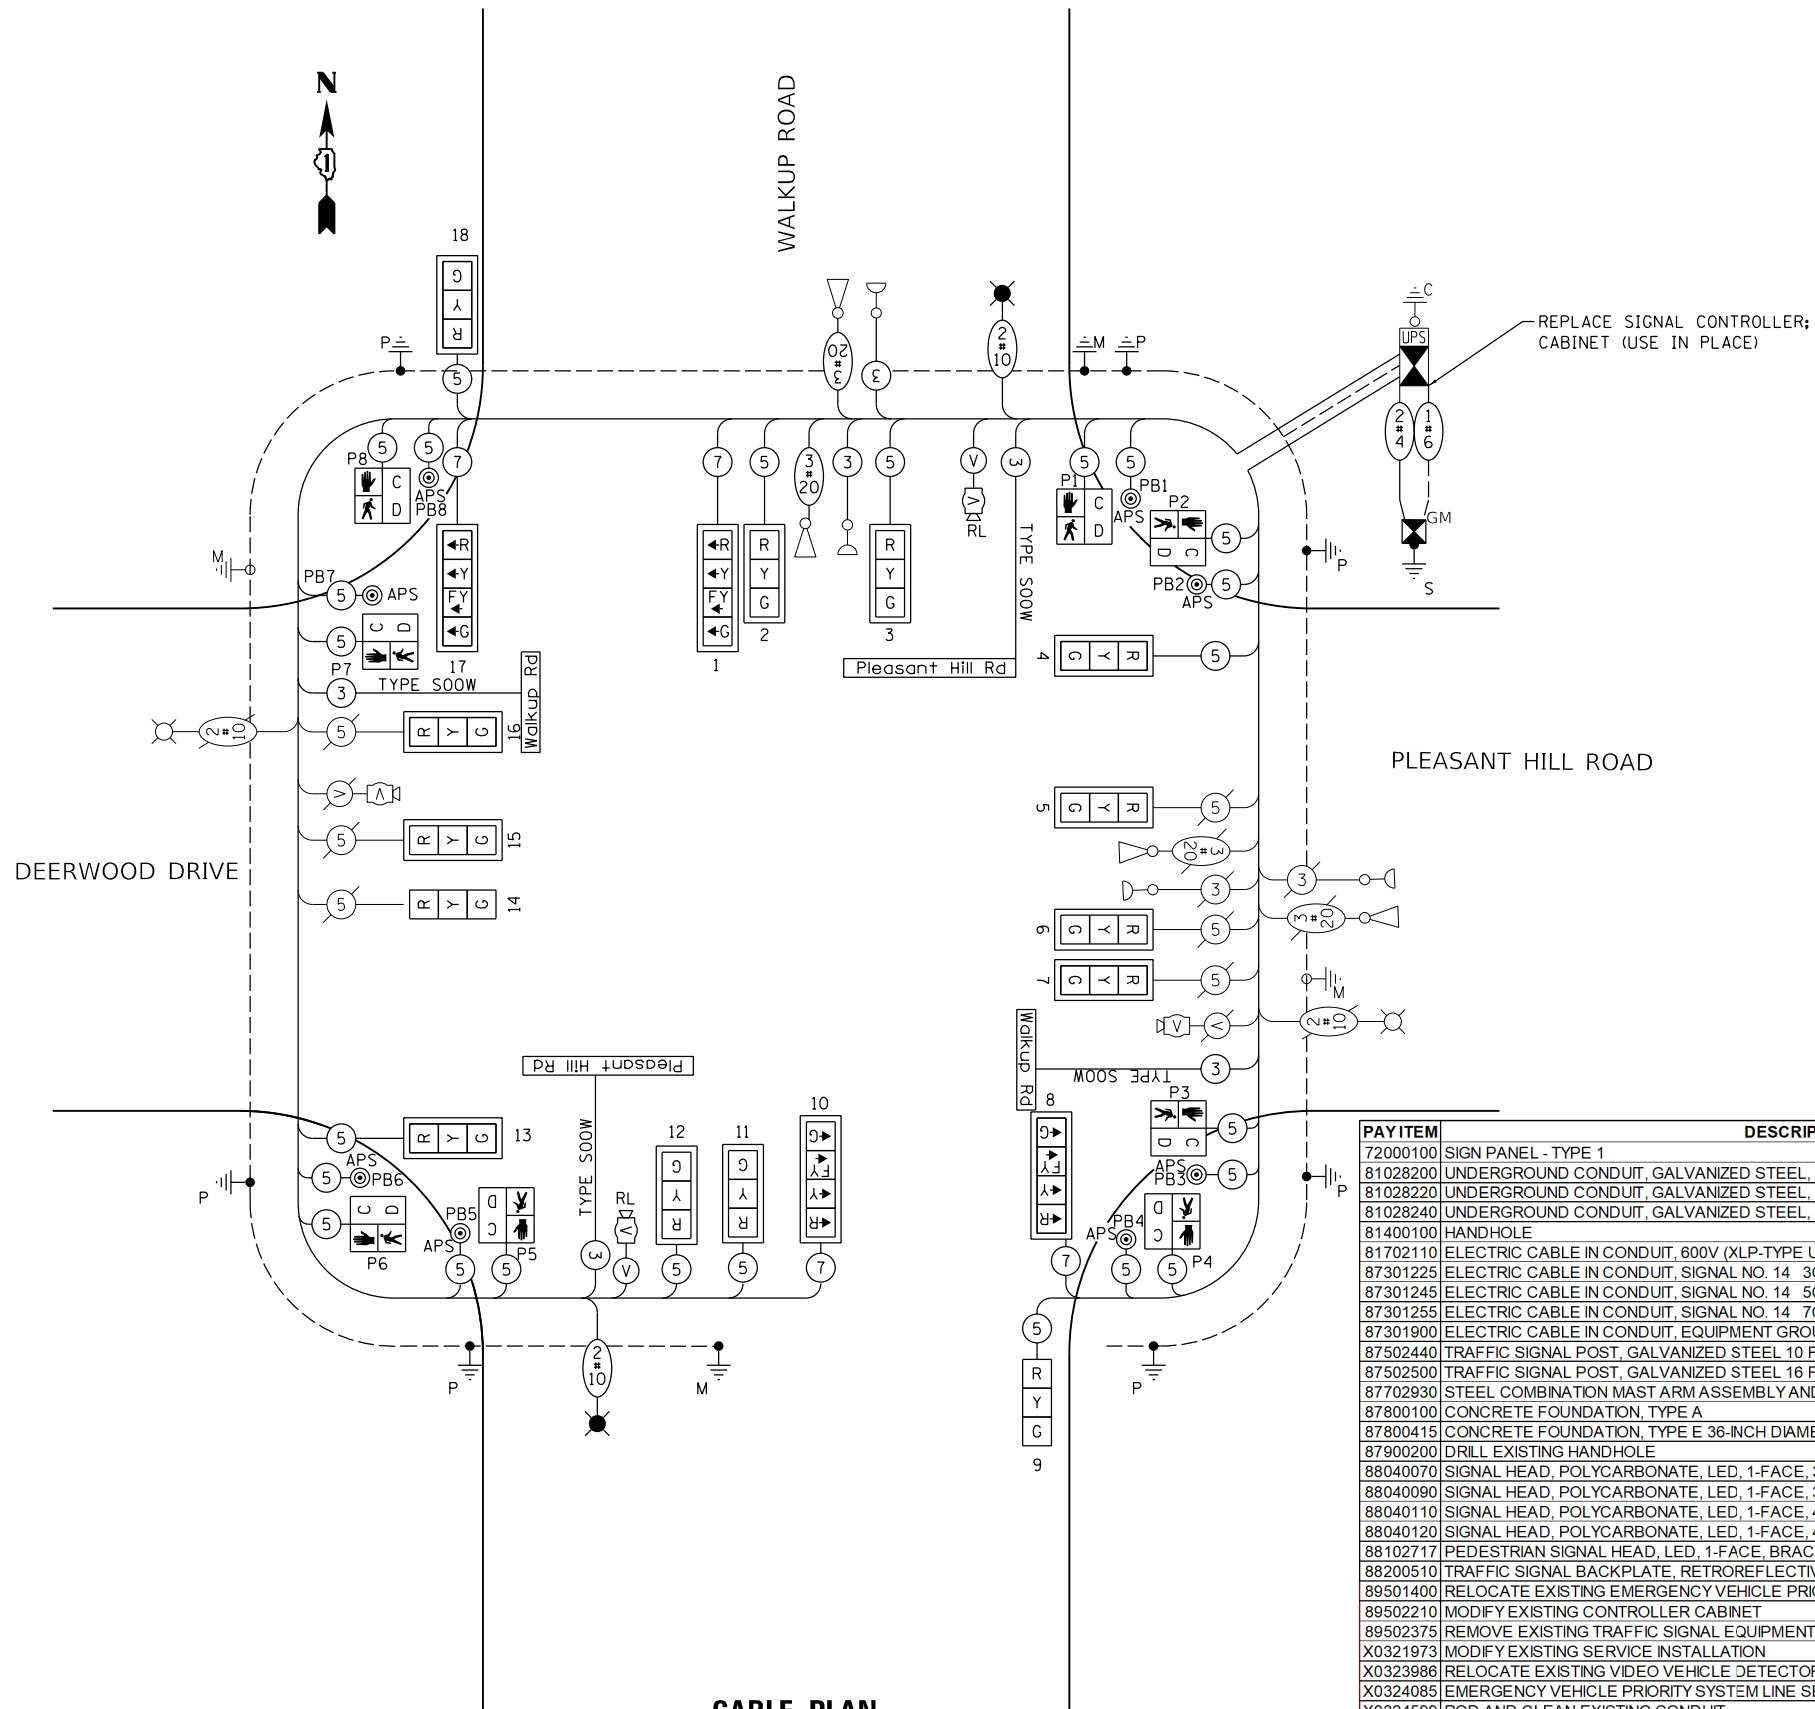

CABLE PLAN (NOT TO SCALE)

PAY ITEM	DESCRIPTION	UNIT	Quantity
72000100	SIGN PANEL - TYPE 1	SQ FT	23
81028200	UNDERGROUND CONDUIT, GALVANIZED STEEL, 2" DIA.	FOOT	56
81028220	UNDERGROUND CONDUIT, GALVANIZED STEEL, 3" DIA.	FOOT	201
81028240	UNDERGROUND CONDUIT, GALVANIZED STEEL, 4" DIA.	FOOT	281
81400100	HANDHOLE	EACH	2
81702110	ELECTRIC CABLE IN CONDUIT, 600V (XLP-TYPE USE) 1/2 NO. 10	FOOT	954
87301225	ELECTRIC CABLE IN CONDUIT, SIGNAL NO. 14 3C	FOOT	220
87301245	ELECTRIC CABLE IN CONDUIT, SIGNAL NO. 14 5C	FOOT	3783
87301255	ELECTRIC CABLE IN CONDUIT, SIGNAL NO. 14 7C	FOOT	749
87301900	ELECTRIC CABLE IN CONDUIT, EQUIPMENT GROUNDING CONDUCTOR, NO. 6 1C	FOOT	654
87502440	TRAFFIC SIGNAL POST, GALVANIZED STEEL 10 FT.	EACH	4
87502500	TRAFFIC SIGNAL POST, GALVANIZED STEEL 16 FT.	EACH	3
87702930	STEEL COMBINATION MAST ARM ASSEMBLY AND POLE 40 FT.	EACH	2
87800100	CONCRETE FOUNDATION, TYPE A	FOOT	28
87800415	CONCRETE FOUNDATION, TYPE E 36-INCH DIAMETER	FOOT	26
87900200	DRILL EXISTING HANDHOLE	EACH	8
88040070	SIGNAL HEAD, POLYCARBONATE, LED, 1-FACE, 3-SECTION, BRACKET MOUNTED	EACH	6
88040090	SIGNAL HEAD, POLYCARBONATE, LED, 1-FACE, 3-SECTION, MAST ARM MOUNTED	EACH	8
88040110	SIGNAL HEAD, POLYCARBONATE, LED, 1-FACE, 4-SECTION, BRACKET MOUNTED	EACH	2
88040120	SIGNAL HEAD, POLYCARBONATE, LED, 1-FACE, 4-SECTION, MAST ARM MOUNTED	EACH	2
88102717	PEDESTRIAN SIGNAL HEAD, LED, 1-FACE, BRACKET MOUNTED WITH COUNTDOWN TIMER	EACH	8
88200510	TRAFFIC SIGNAL BACKPLATE, RETROREFLECTIVE	EACH	18
89501400	RELOCATE EXISTING EMERGENCY VEHICLE PRIORITY SYSTEM, DETECTOR UNIT	EACH	2
89502210	MODIFY EXISTING CONTROLLER CABINET	EACH	1
89502375	REMOVE EXISTING TRAFFIC SIGNAL EQUIPMENT	EACH	1
X0321973	MODIFY EXISTING SERVICE INSTALLATION	EACH	1
X0323986	RELOCATE EXISTING VIDEO VEHICLE DETECTOR	EACH	2
X0324085	EMERGENCY VEHICLE PRIORITY SYSTEM LINE SENSOR CABLE, NO. 20 3/C	FOOT	220
X0324599	ROD AND CLEAN EXISTING CONDUIT	FOOT	240
X1400150	SERVICE INSTALLATION, GROUND MOUNTED, METERED	EACH	1
X1400238	LUMINAIRE, LED, SPECIAL	EACH	2
X8570215	FULL-ACTUATED CONTROLLER IN EXISTING CABINET	EACH	1
X8760200	ACCESSIBLE PEDESTRIAN SIGNALS	EACH	8
X8809005	LED SIGNAL FACE, LENS COVER	EACH	18
XX005937	LED INTERNALLY ILLUMINATED STREET NAME SIGN	EACH	4

DESIGNED	
DRAWN	
REVIEWED	

USER NAME = Pearc00397	DESIGNED -	REVISED -
PLOT SCALE = 40.0000 "/>		

**STATE OF ILLINOIS
 DEPARTMENT OF TRANSPORTATION**

**PLEASANT HILL ROAD / WALKUP ROAD
 WIRING DIAGRAM**

SCALE: SHEET OF SHEETS STA. TO STA.

F.A.U. RTE.	SECTION	COUNTY	TOTAL SHEETS	SHEET NO.
0085	19-00511-00-SP	MCHENRY	45	25
19L0111			CONTRACT NO.	61J51

ILLINOIS FED. AID PROJECT



GENERAL NOTES:

ALL EXISTING SIGNAL HEADS TO BE REMOVED AND REPLACED.
EVP AND VIDEO DETECTION EQUIPMENT TO BE RELOCATED TO NEW MAST ARMS.

REMOVAL NOTES:

THE FOLLOWING ITEMS SHALL BE REMOVED BY THE CONTRACTOR AND SHALL BE DISPOSED OF BY THEM OUTSIDE THE RIGHT-OF-WAY AT THEIR EXPENSE. THE SALVAGE VALUE OF THE REMOVED EQUIPMENT SHALL BE REFLECTED IN THE CONTRACT BID PRICE.

- 2 EACH STEEL MAST ARM ASSEMBLY AND POLE
- 12 EACH 3-SECTION SIGNAL HEAD
- 4 EACH 5-SECTION SIGNAL HEAD

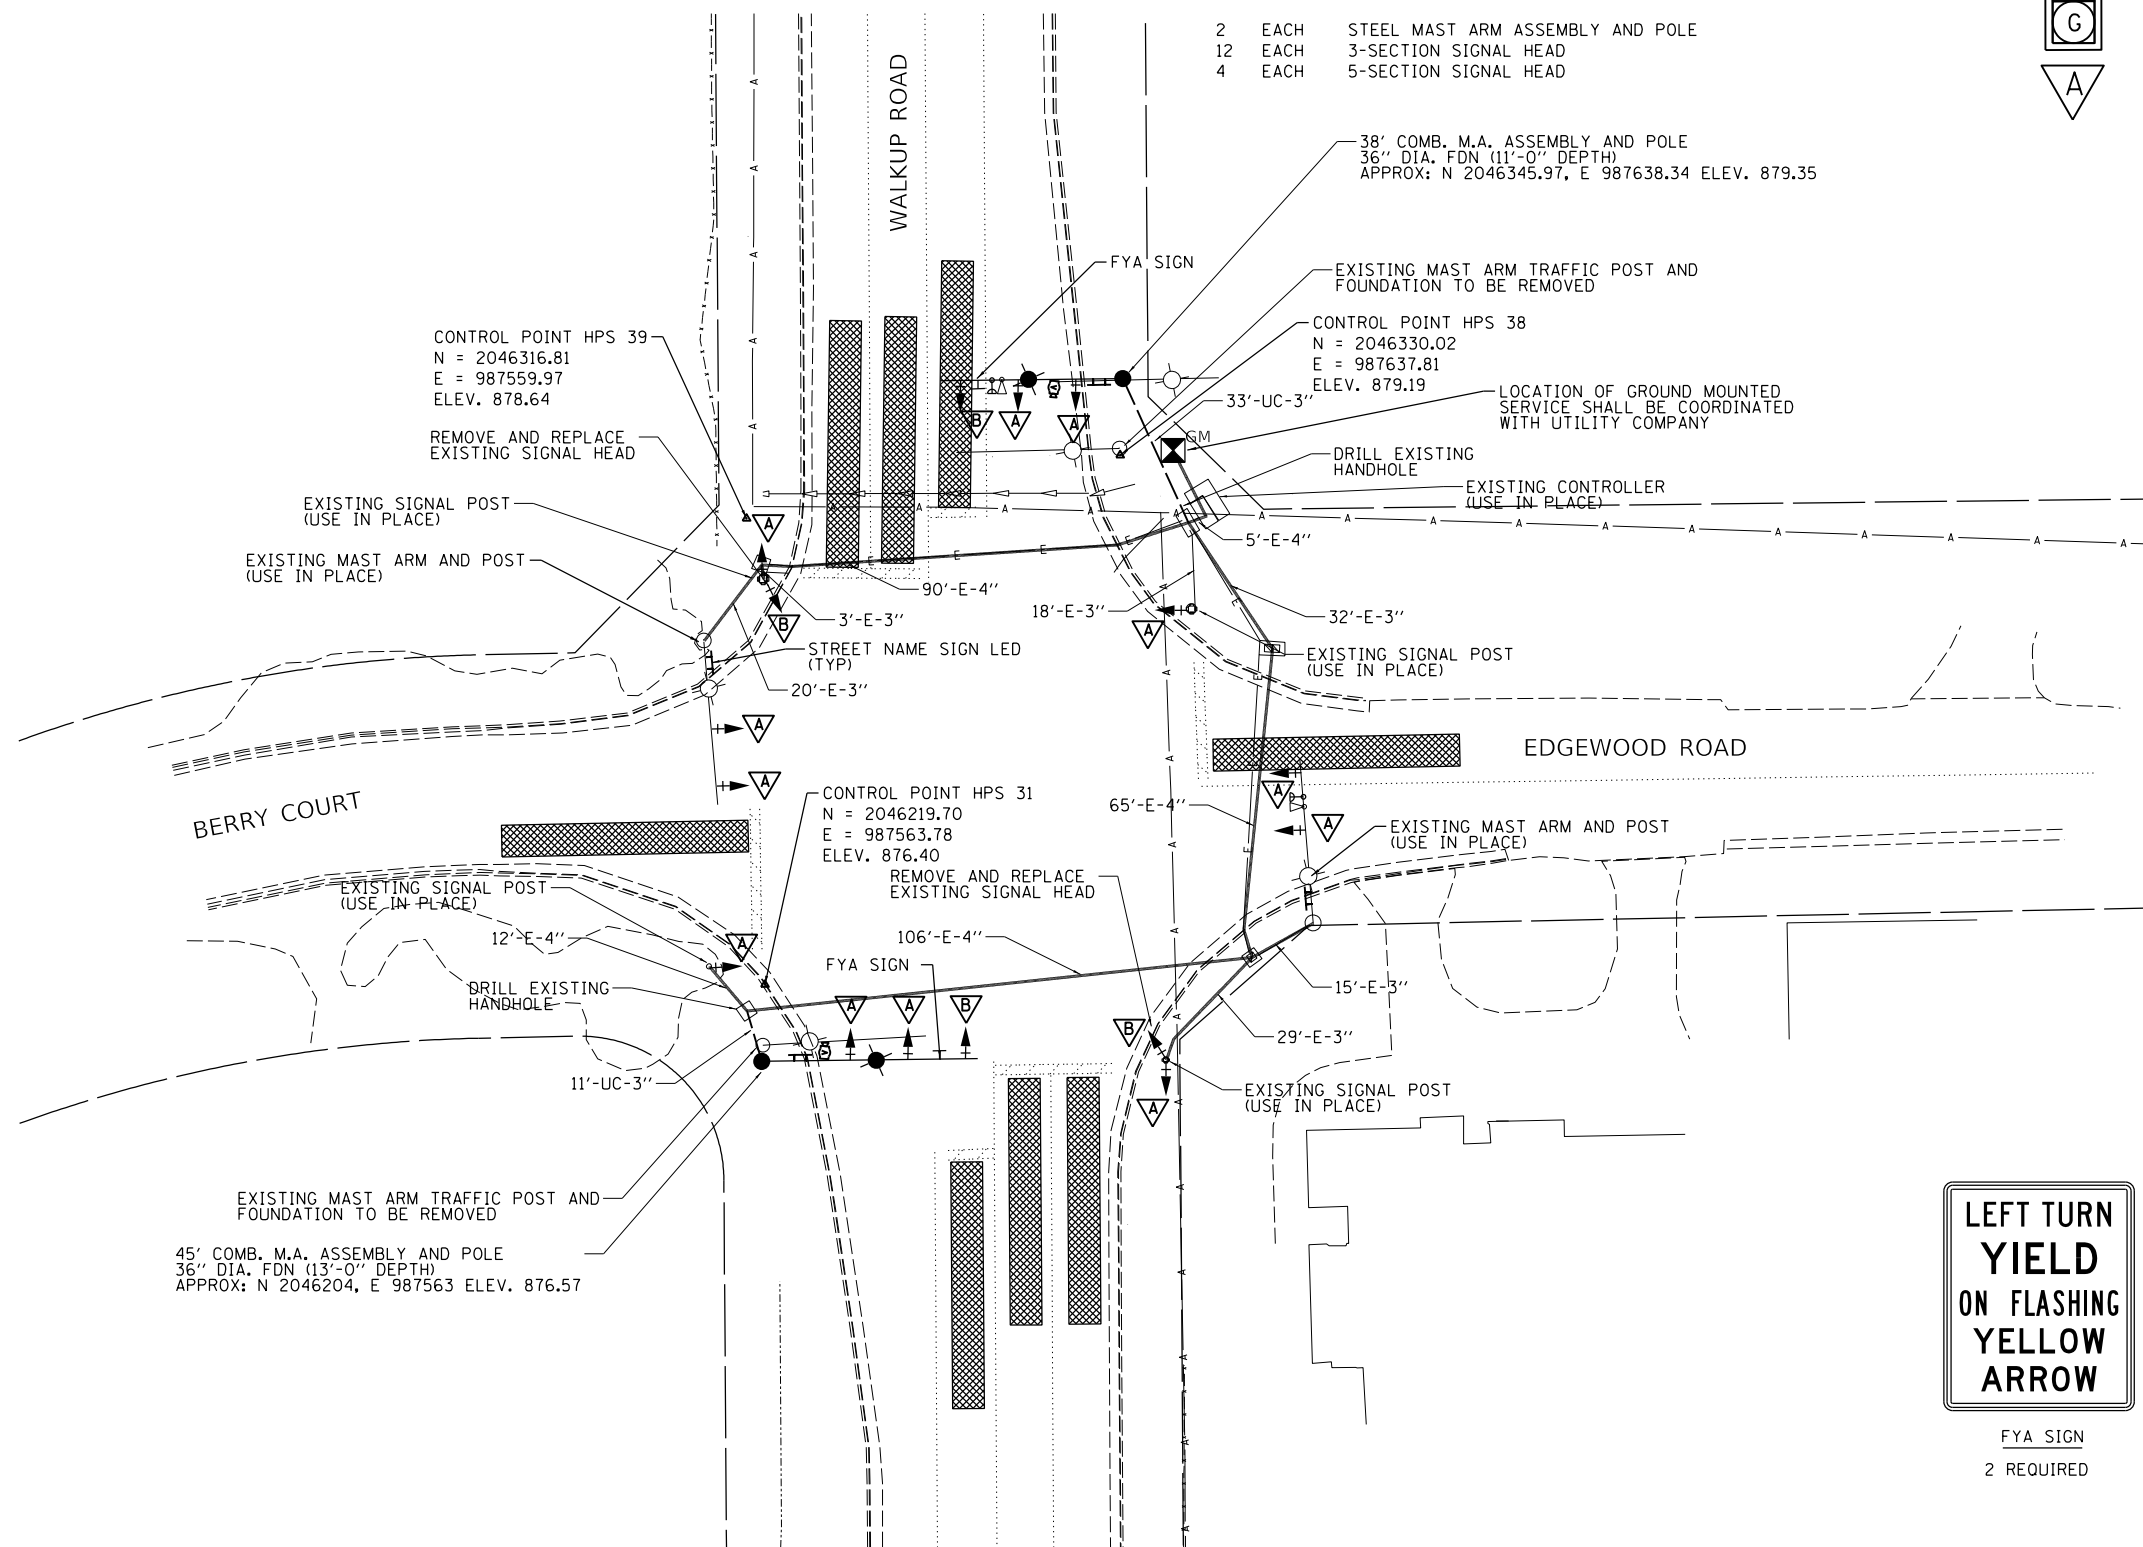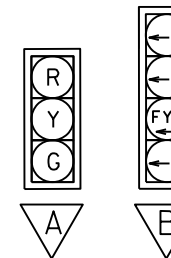

DESIGNED	
DRAWN	
REVIEWED	

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USER NAME = Pearc00397	DESIGNED - TMA	REVISED -
PLOT SCALE = 40.0000 ' / in.	DRAWN - MOC/TMA	REVISED -
PLOT DATE = 2/17/2023	CHECKED - KNB	REVISED -
	DATE -	REVISED -

**STATE OF ILLINOIS
DEPARTMENT OF TRANSPORTATION**

**EDGEWOOD ROAD / WALKUP ROAD
SIGNAL PLAN**


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F.A.U. RTE.	SECTION	COUNTY	TOTAL SHEETS	SHEET NO.
0085	19-00511-00-SP	McHENRY	45	26
19L0111		CONTRACT NO.	61J51	
ILLINOIS FED. AID PROJECT				





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PROPOSED PHASE DIAGRAM



PROPOSED EMERGENCY VEHICLE PREEMPTION SEQUENCE

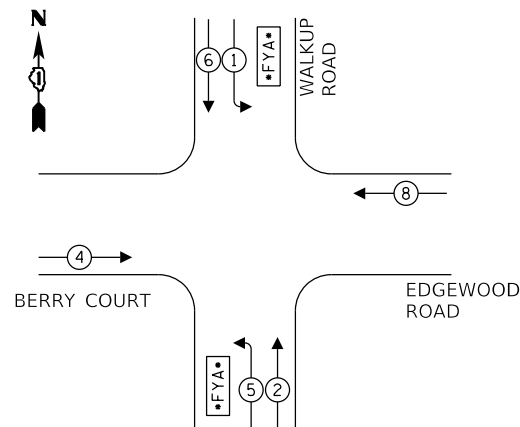

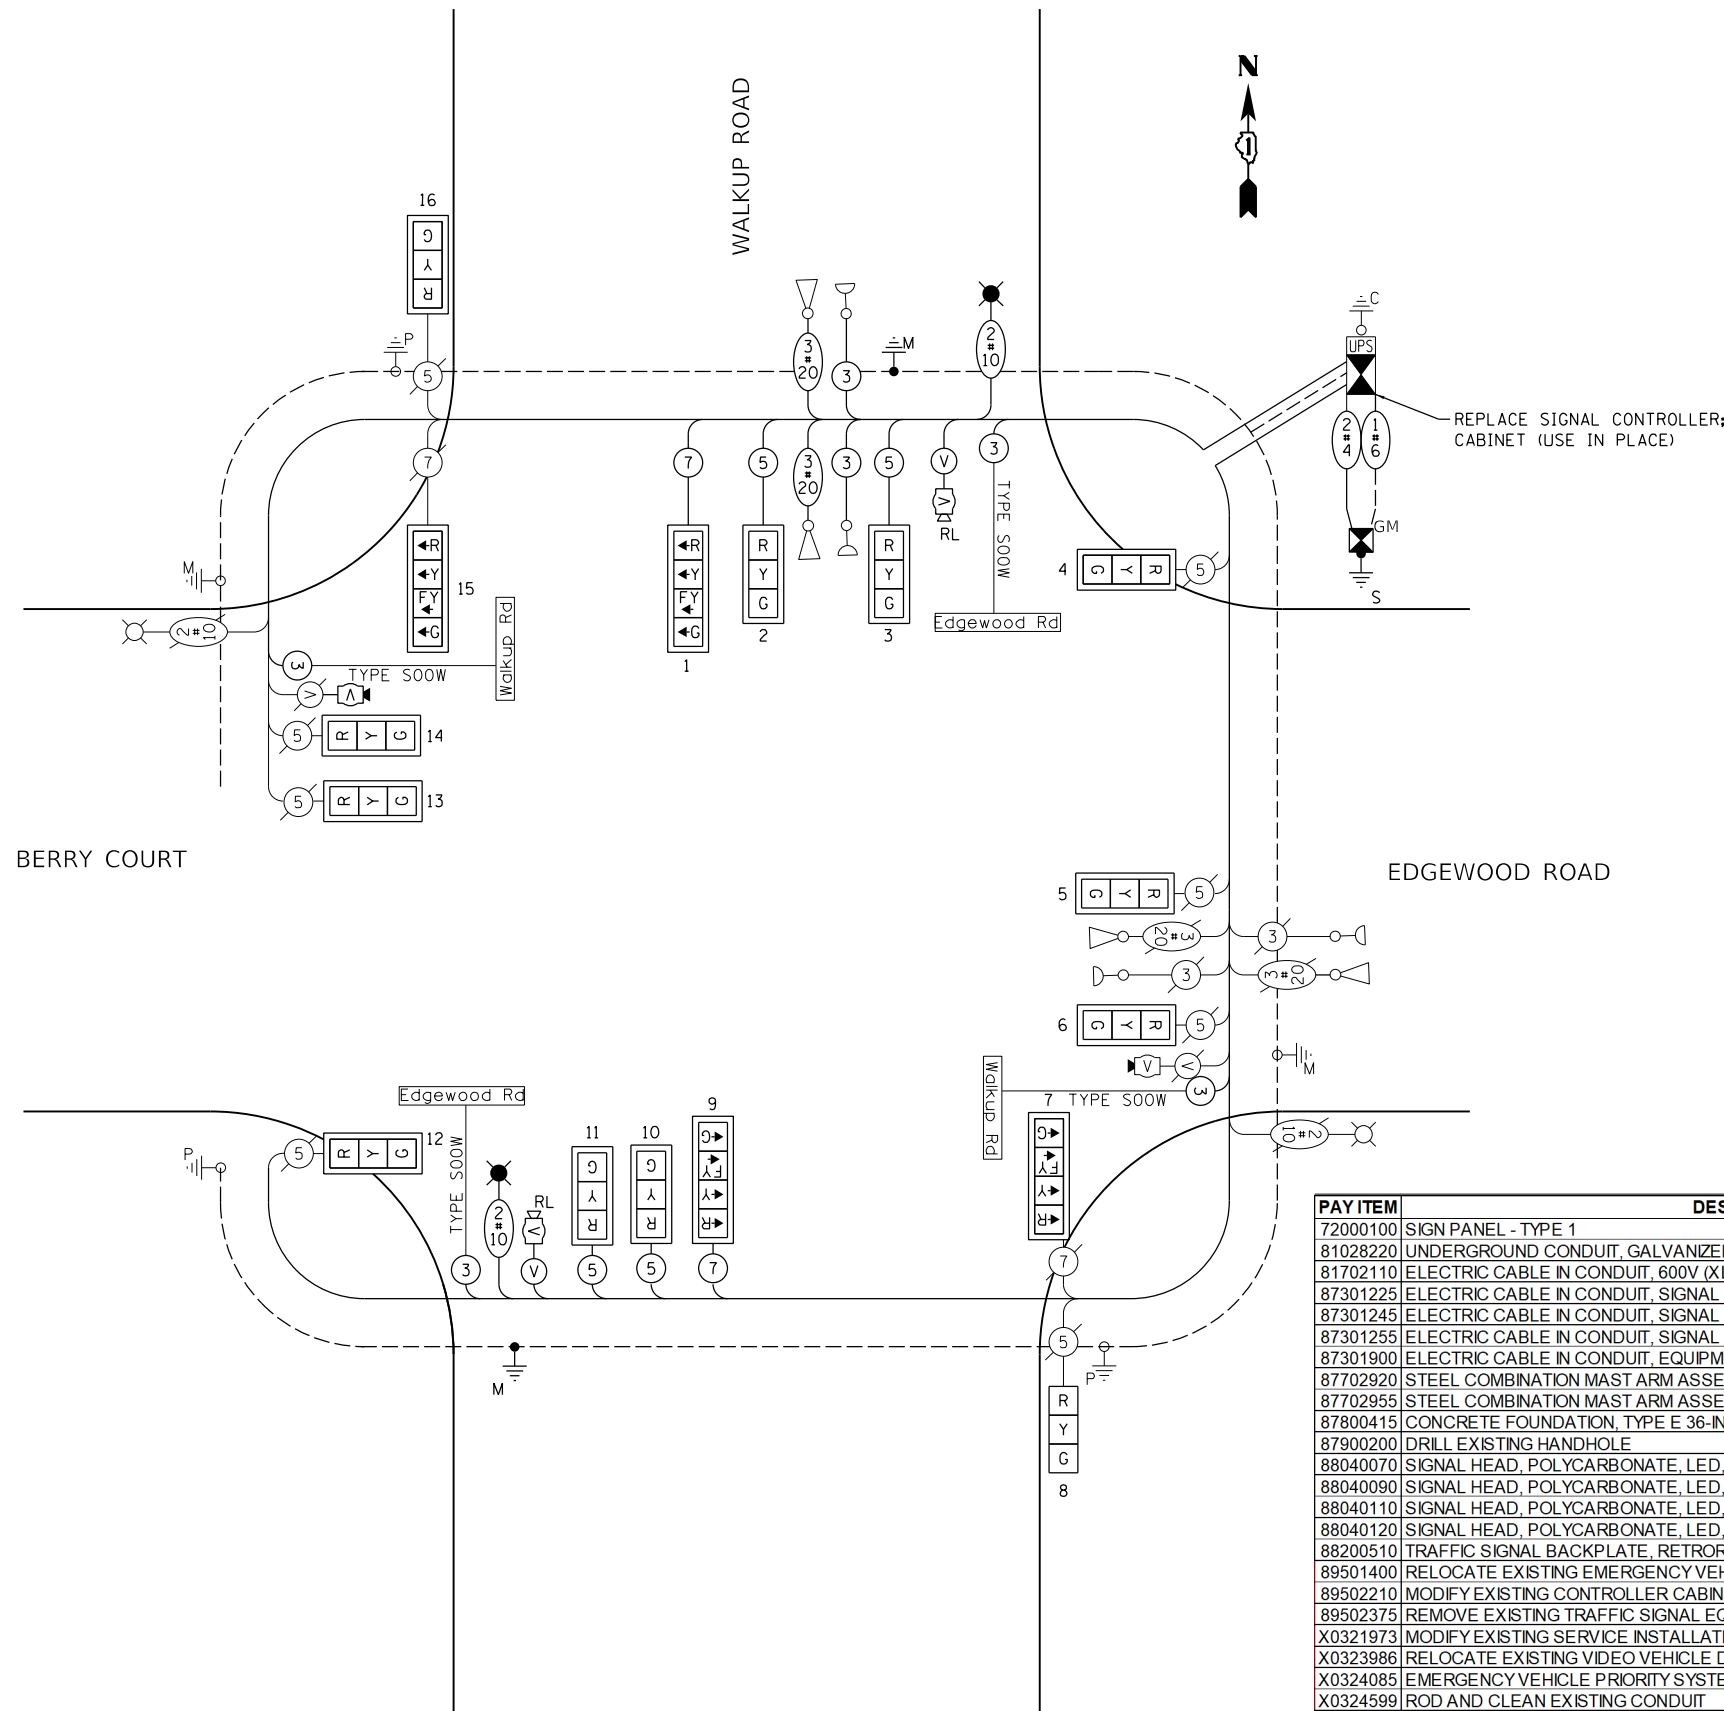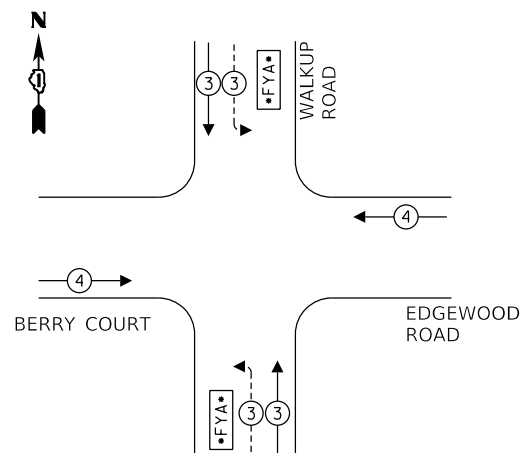**CABLE PLAN
(NOT TO SCALE)**

**TRAFFIC SIGNAL INSTALLATION
ELECTRICAL SERVICE REQUIREMENTS**

TYPE	NO. LAMPS	LED WATTAGE	% OPERATION	TOTAL WATTAGE
SIGNAL (RED)	16	11	50	88.0
(YELLOW)	16	20	5	16.0
(GREEN)	16	12	45	86.4
FYA	4	10	45	18.0
TOTAL =				863.4

ENERGY COST - BILLED TO: McHENRY COUNTY
 2200 N. SEMINARY AVE.
 WOODSTOCK, IL 60098

ENERGY SUPPLY - CONTACT: LISA ARGAST
 PHONE: (630) 576-7094
 COMPANY: COMED

PAY ITEM	DESCRIPTION	UNIT	Quantity
72000100	SIGNAL PANEL - TYPE 1	SQ FT	15
81028220	UNDERGROUND CONDUIT, GALVANIZED STEEL, 3" DIA.	FOOT	44
81702110	ELECTRIC CABLE IN CONDUIT, 600V (XLP-TYPE USE) 1/C NO. 10	FOOT	922
87301225	ELECTRIC CABLE IN CONDUIT, SIGNAL NO. 14 3C	FOOT	196
87301245	ELECTRIC CABLE IN CONDUIT, SIGNAL NO. 14 5C	FOOT	806
87301255	ELECTRIC CABLE IN CONDUIT, SIGNAL NO. 14 7C	FOOT	439
87301900	ELECTRIC CABLE IN CONDUIT, EQUIPMENT GROUNDING CONDUCTOR, NO. 6 1C	FOOT	70
87702920	STEEL COMBINATION MAST ARM ASSEMBLY AND POLE 38 FT.	EACH	1
87702955	STEEL COMBINATION MAST ARM ASSEMBLY AND POLE 45 FT.	EACH	1
87800415	CONCRETE FOUNDATION, TYPE E 36-INCH DIAMETER	FOOT	26
87900200	DRILL EXISTING HANDHOLE	EACH	2
88040070	SIGNAL HEAD, POLYCARBONATE, LED, 1-FACE, 3-SECTION, BRACKET MOUNTED	EACH	4
88040090	SIGNAL HEAD, POLYCARBONATE, LED, 1-FACE, 3-SECTION, MAST ARM MOUNTED	EACH	8
88040110	SIGNAL HEAD, POLYCARBONATE, LED, 1-FACE, 4-SECTION, BRACKET MOUNTED	EACH	2
88040120	SIGNAL HEAD, POLYCARBONATE, LED, 1-FACE, 4-SECTION, MAST ARM MOUNTED	EACH	2
88200510	TRAFFIC SIGNAL BACKPLATE, RETROREFLECTIVE	EACH	16
89501400	RELOCATE EXISTING EMERGENCY VEHICLE PRIORITY SYSTEM, DETECTOR UNIT	EACH	2
89502210	MODIFY EXISTING CONTROLLER CABINET	EACH	1
89502375	REMOVE EXISTING TRAFFIC SIGNAL EQUIPMENT	EACH	1
X0321973	MODIFY EXISTING SERVICE INSTALLATION	EACH	1
X0323986	RELOCATE EXISTING VIDEO VEHICLE DETECTOR	EACH	2
X0324085	EMERGENCY VEHICLE PRIORITY SYSTEM LINE SENSOR CABLE, NO. 20 3/C	FOOT	196
X0324599	ROD AND CLEAN EXISTING CONDUIT	FOOT	120
X1400150	SERVICE INSTALLATION, GROUND MOUNTED, METERED	EACH	1
X1400238	LUMINAIRE, LED, SPECIAL	EACH	2
X8570215	FULL-ACTUATED CONTROLLER IN EXISTING CABINET	EACH	1
X8809005	LED SIGNAL FACE, LENS COVER	EACH	16
XX005937	LED INTERNALLY ILLUMINATED STREET NAME SIGN	EACH	4

DESIGNED	
DRAWN	
REVIEWED	

USER NAME = Pearn00397	DESIGNED -	REVISED -
PLOT SCALE = 40.0000 ' / in.	DRAWN -	REVISED -
PLOT DATE = 2/17/2023	CHECKED -	REVISED -
	DATE -	REVISED -

**STATE OF ILLINOIS
DEPARTMENT OF TRANSPORTATION**

**EDGEWOOD ROAD / WALKUP ROAD
WIRING DIAGRAM**

SCALE: SHEET OF SHEETS STA. TO STA.

F.A.U. RTE.	SECTION	COUNTY	TOTAL SHEETS	SHEET NO.
0085	19-00511-00-SP	McHENRY	45	27
19L0111			CONTRACT NO.	61J51
ILLINOIS FED. AID PROJECT				

HPS1

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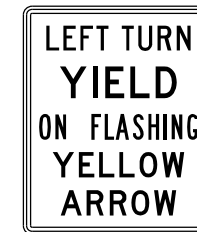
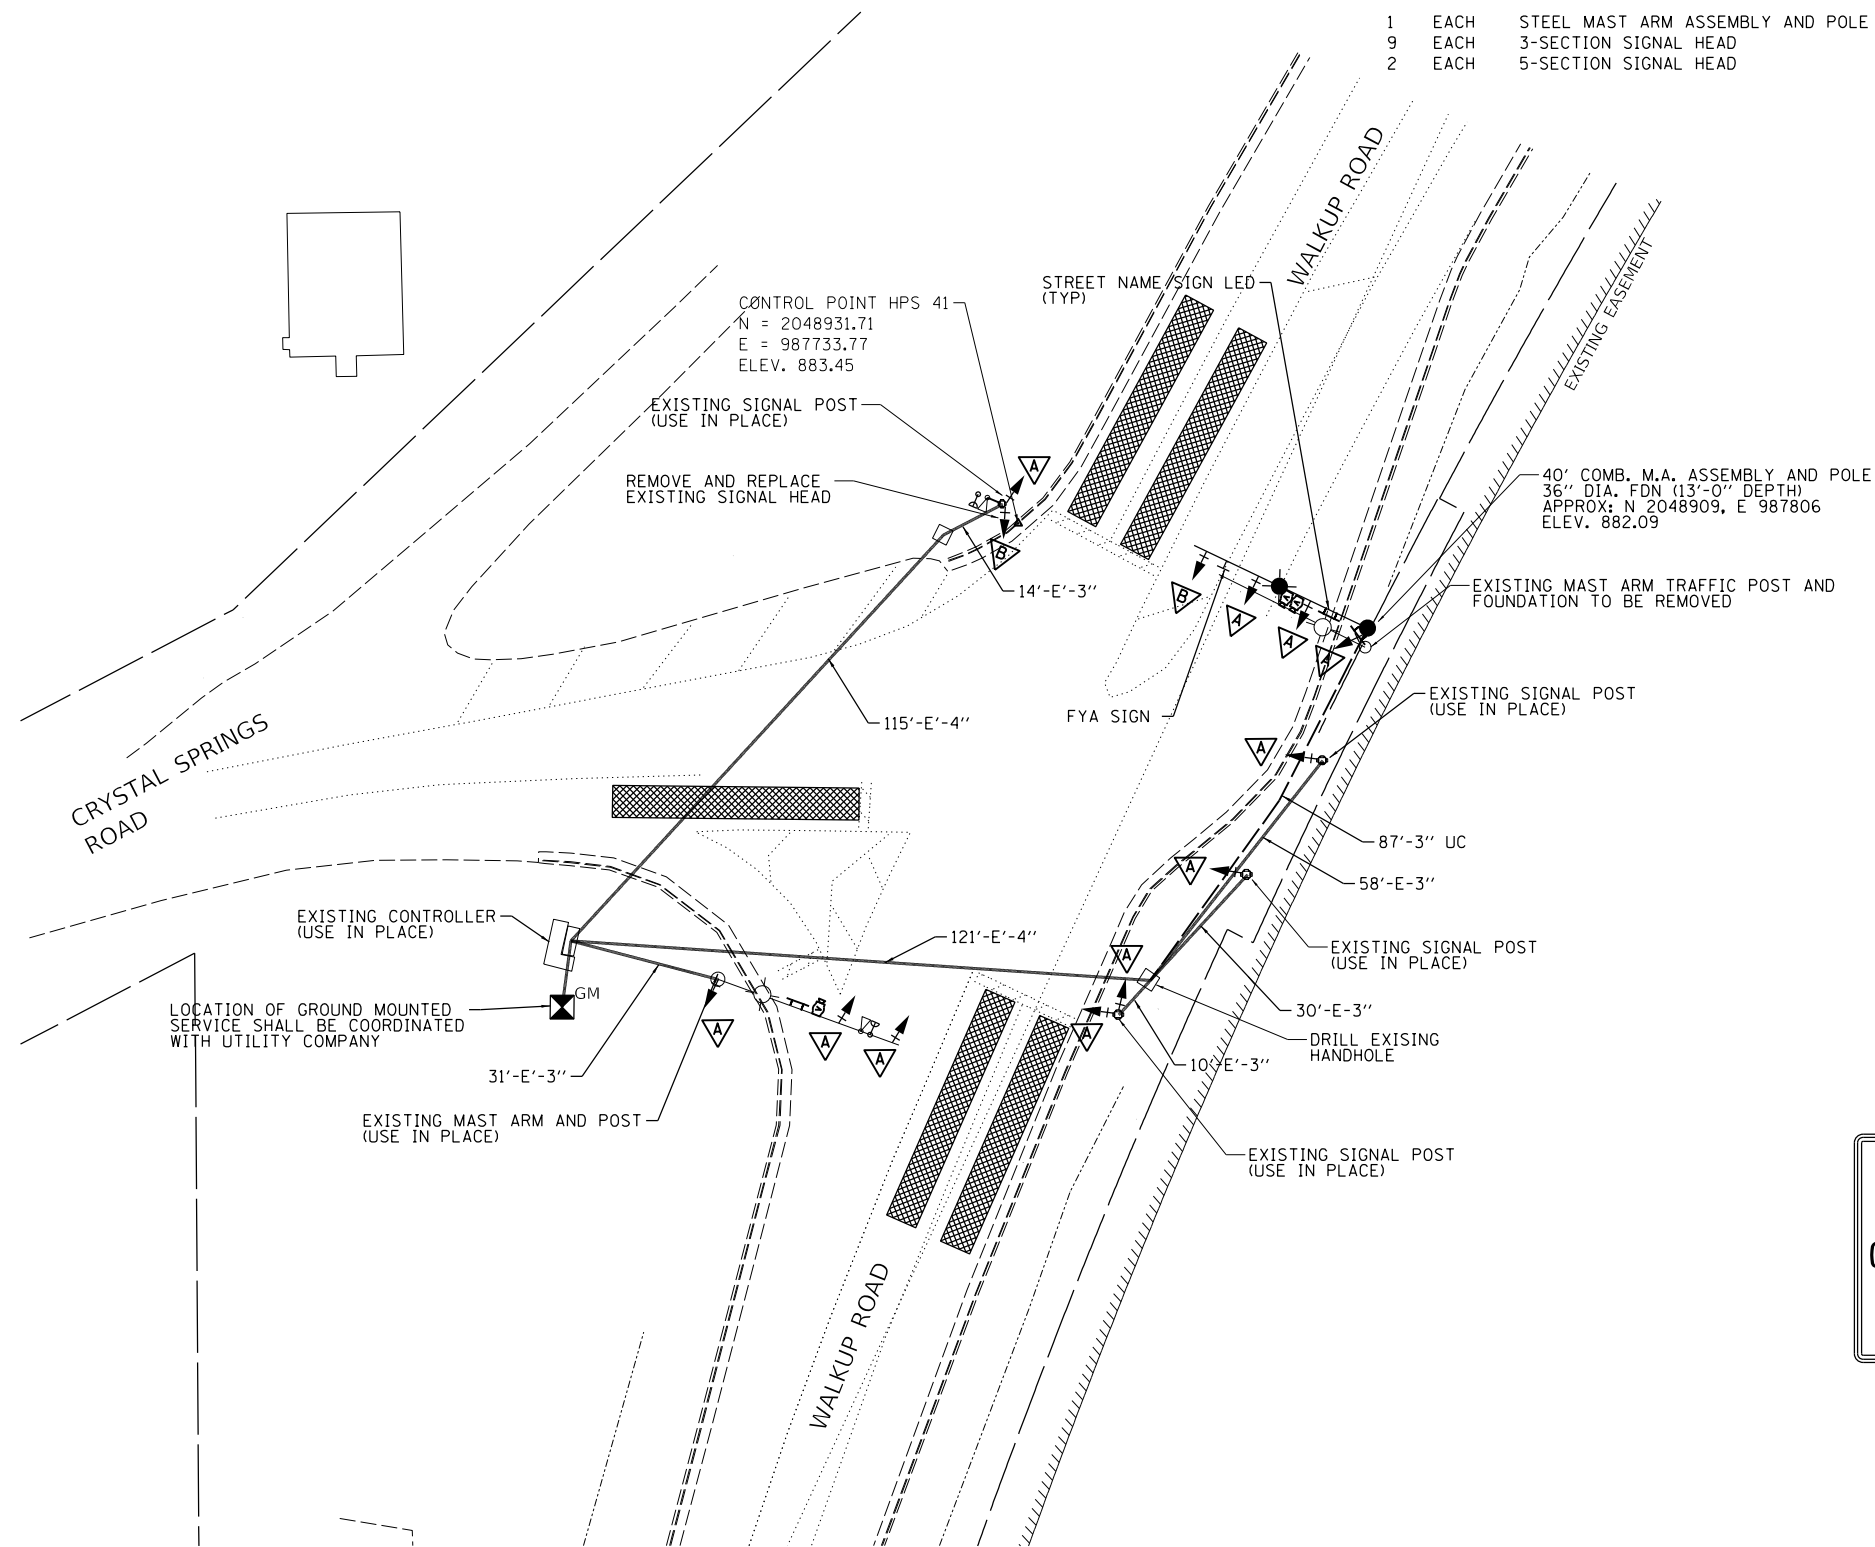
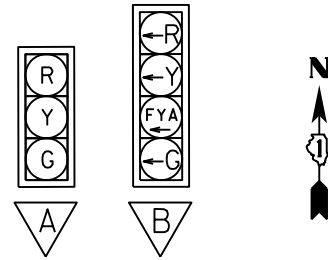
GENERAL NOTES:

ALL EXISTING SIGNAL HEADS SHALL BE REPLACED.
EVP AND VIDEO DETECTION EQUIPMENT TO BE RELOCATED TO NEW MAST ARM.

REMOVAL NOTES:

THE FOLLOWING ITEMS SHALL BE REMOVED BY THE CONTRACTOR AND SHALL BE DISPOSED OF BY THEM OUTSIDE THE RIGHT-OF-WAY AT THEIR EXPENSE. THE SALVAGE VALUE OF THE REMOVED EQUIPMENT SHALL BE REFLECTED IN THE CONTRACT BID PRICE.

- 1 EACH STEEL MAST ARM ASSEMBLY AND POLE
- 9 EACH 3-SECTION SIGNAL HEAD
- 2 EACH 5-SECTION SIGNAL HEAD



FYA SIGN
1 REQUIRED



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 PLOT DATE: 2/17/2023
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DESIGNED	
DRAWN	
REVIEWED	

USER NAME = Pearc00397	DESIGNED - TMA	REVISED -
PLOT SCALE = 40.0000 ' / in.	DRAWN - MOC/TMA	REVISED -
PLOT DATE = 2/17/2023	CHECKED - KNB	REVISED -
	DATE -	REVISED -

**STATE OF ILLINOIS
DEPARTMENT OF TRANSPORTATION**

**CRYSTAL SPRINGS ROAD / CRYSTAL LAKE ROAD
SIGNAL PLAN**

SCALE: 1"=20' SHEET OF SHEETS STA. TO STA.


F.A.U. RTE.	SECTION	COUNTY	TOTAL SHEETS	SHEET NO.
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19L0111		CONTRACT NO. 61J51		

ILLINOIS FED. AID PROJECT




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PLOT DATE = 2/17/2023


PROPOSED PHASE DIAGRAM

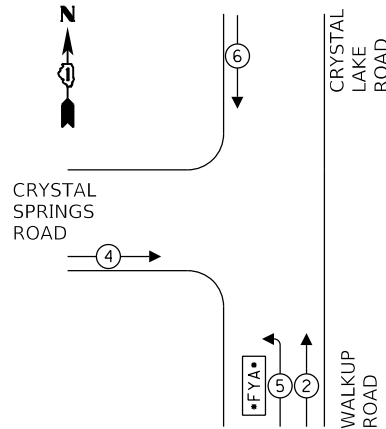

PROPOSED EMERGENCY VEHICLE PREEMPTION SEQUENCE

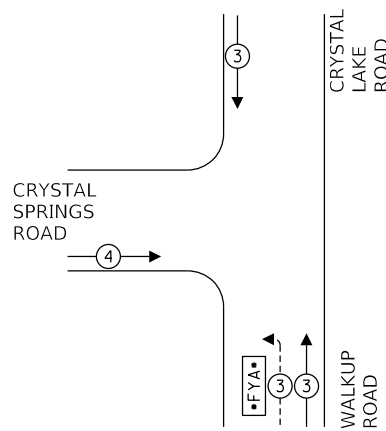

TRAFFIC SIGNAL INSTALLATION ELECTRICAL SERVICE REQUIREMENTS					
TYPE	NO. LAMPS	LED WATTAGE	% OPERATION	TOTAL WATTAGE	
SIGNAL	(RED)	13	11	50	71.5
	(YELLOW)	13	20	5	13.0
	(GREEN)	13	12	45	70.2
	FYA	2	10	45	9.0
CONTROLLER	1	100	100	100.0	
UPS	1	25	100	25.0	
VIDEO DETECTION	1	150	100	150.0	
LUMINAIRE	2	190	50	190.0	
TOTAL =				628.7	
ENERGY COST - BILLED TO: McHENRY COUNTY 2200 N. SEMINARY AVE. WOODSTOCK, IL 60098					
ENERGY SUPPLY - CONTACT: LISA ARGAST PHONE: (630) 576-7094 COMPANY: COMED					

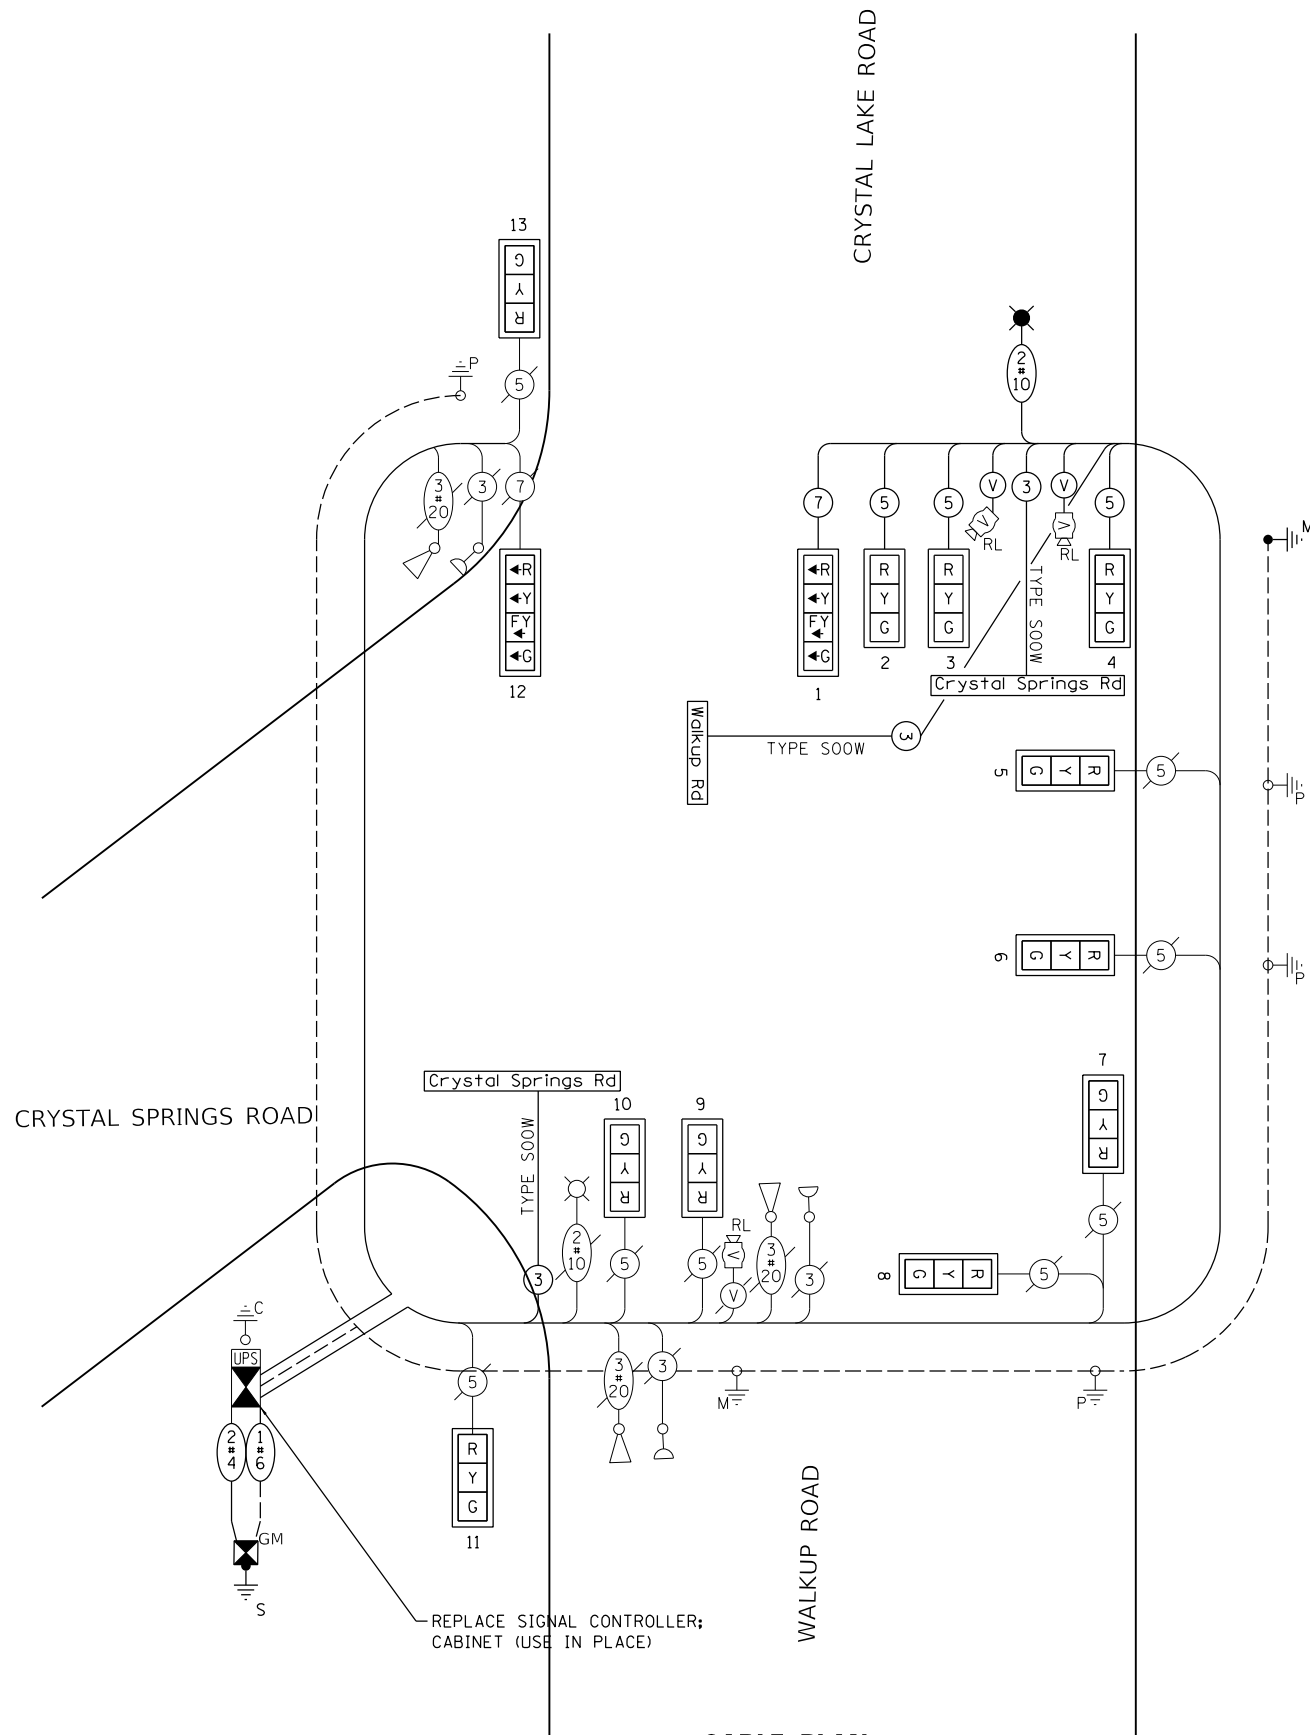

REPLACE SIGNAL CONTROLLER; CABINET (USE IN PLACE)

CABLE PLAN (NOT TO SCALE)

PAY ITEM	DESCRIPTION	UNIT	Quantity
72000100	SIGN PANEL - TYPE 1	SQ FT	8
81028220	UNDERGROUND CONDUIT, GALVANIZED STEEL, 3" DIA.	FOOT	87
81702110	ELECTRIC CABLE IN CONDUIT, 600V (XLP-TYPE USE) 1/C NO. 10	FOOT	617
87301245	ELECTRIC CABLE IN CONDUIT, SIGNAL NO. 14 5C	FOOT	823
87301255	ELECTRIC CABLE IN CONDUIT, SIGNAL NO. 14 7C	FOOT	304
87301900	ELECTRIC CABLE IN CONDUIT, EQUIPMENT GROUNDING CONDUCTOR, NO. 6 1C	FOOT	97
87702930	STEEL COMBINATION MAST ARM ASSEMBLY AND POLE 40 FT.	EACH	1
87800415	CONCRETE FOUNDATION, TYPE E 36-INCH DIAMETER	FOOT	13
87900200	DRILL EXISTING HANDHOLE	EACH	1
88040070	SIGNAL HEAD, POLYCARBONATE, LED, 1-FACE, 3-SECTION, BRACKET MOUNTED	EACH	7
88040090	SIGNAL HEAD, POLYCARBONATE, LED, 1-FACE, 3-SECTION, MAST ARM MOUNTED	EACH	4
88040110	SIGNAL HEAD, POLYCARBONATE, LED, 1-FACE, 4-SECTION, BRACKET MOUNTED	EACH	1
88040120	SIGNAL HEAD, POLYCARBONATE, LED, 1-FACE, 4-SECTION, MAST ARM MOUNTED	EACH	1
88200510	TRAFFIC SIGNAL BACKPLATE, RETROREFLECTIVE	EACH	13
89502210	MODIFY EXISTING CONTROLLER CABINET	EACH	1
89502375	REMOVE EXISTING TRAFFIC SIGNAL EQUIPMENT	EACH	1
X0321973	MODIFY EXISTING SERVICE INSTALLATION	EACH	1
X0323986	RELOCATE EXISTING VIDEO VEHICLE DETECTOR	EACH	2
X0324599	ROD AND CLEAN EXISTING CONDUIT	FOOT	121
X1400150	SERVICE INSTALLATION, GROUND MOUNTED, METERED	EACH	1
X1400238	LUMINAIRE, LED, SPECIAL	EACH	1
X8570215	FULL-ACTUATED CONTROLLER IN EXISTING CABINET	EACH	1
X8809005	LED SIGNAL FACE, LENS COVER	EACH	13
XX005937	LED INTERNALLY ILLUMINATED STREET NAME SIGN	EACH	3

DESIGNED	
DRAWN	
REVIEWED	

USER NAME = Pearc00397	DESIGNED -	REVISD -
PLOT SCALE = 40.0000 ' / in.	DRAWN -	REVISD -
PLOT DATE = 2/17/2023	CHECKED -	REVISD -
	DATE -	REVISD -

STATE OF ILLINOIS DEPARTMENT OF TRANSPORTATION


CRYSTAL SPRINGS ROAD / CRYSTAL LAKE ROAD WIRING DIAGRAM

F.A.U. RTE.	SECTION	COUNTY	TOTAL SHEETS	SHEET NO.
0085	19-00511-00-SP	McHENRY	45	29
	19L0111		CONTRACT NO.	61J51
		ILLINOIS	FED. AID PROJECT	


SCALE: SHEET OF SHEETS STA. TO STA.



PROPOSED PHASE DIAGRAM

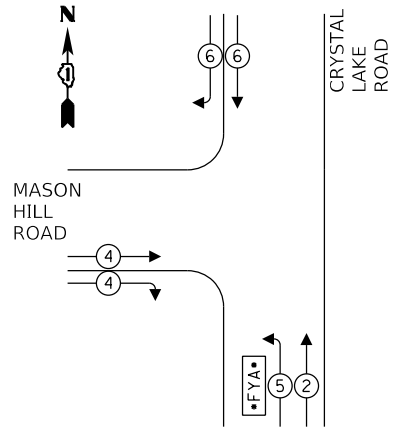

PROPOSED EMERGENCY VEHICLE PREEMPTION SEQUENCE

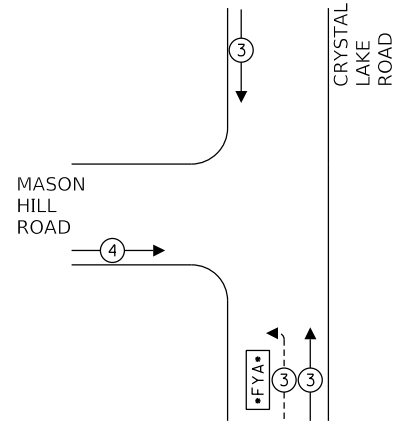

TRAFFIC SIGNAL INSTALLATION ELECTRICAL SERVICE REQUIREMENTS

TYPE	NO. LAMPS	LED WATTAGE	% OPERATION	TOTAL WATTAGE	
SIGNAL (RED)	12	11	50	66.0	
	(YELLOW)	12	20	5	12.0
	(GREEN)	12	12	45	64.8
	FYA	2	10	45	9.0
CONTROLLER	1	100	100	100.0	
UPS	1	25	100	25.0	
VIDEO DETECTION	1	150	100	150.0	
LUMINAIRE	2	190	50	190.0	
TOTAL =				616.8	

ENERGY COST - BILLED TO: McHENRY COUNTY
2200 N. SEMINARY AVE.
WOODSTOCK, IL 60098

ENERGY SUPPLY - CONTACT: LISA ARGAST
PHONE: (630) 576-7094
COMPANY: COMED

DESIGNED	
DRAWN	
REVIEWED	

USER NAME = Pearc00397	DESIGNED -
PLOT SCALE = 40.0000 ' / in.	DRAWN -
PLOT DATE = 2/17/2023	CHECKED -
	REVISER -

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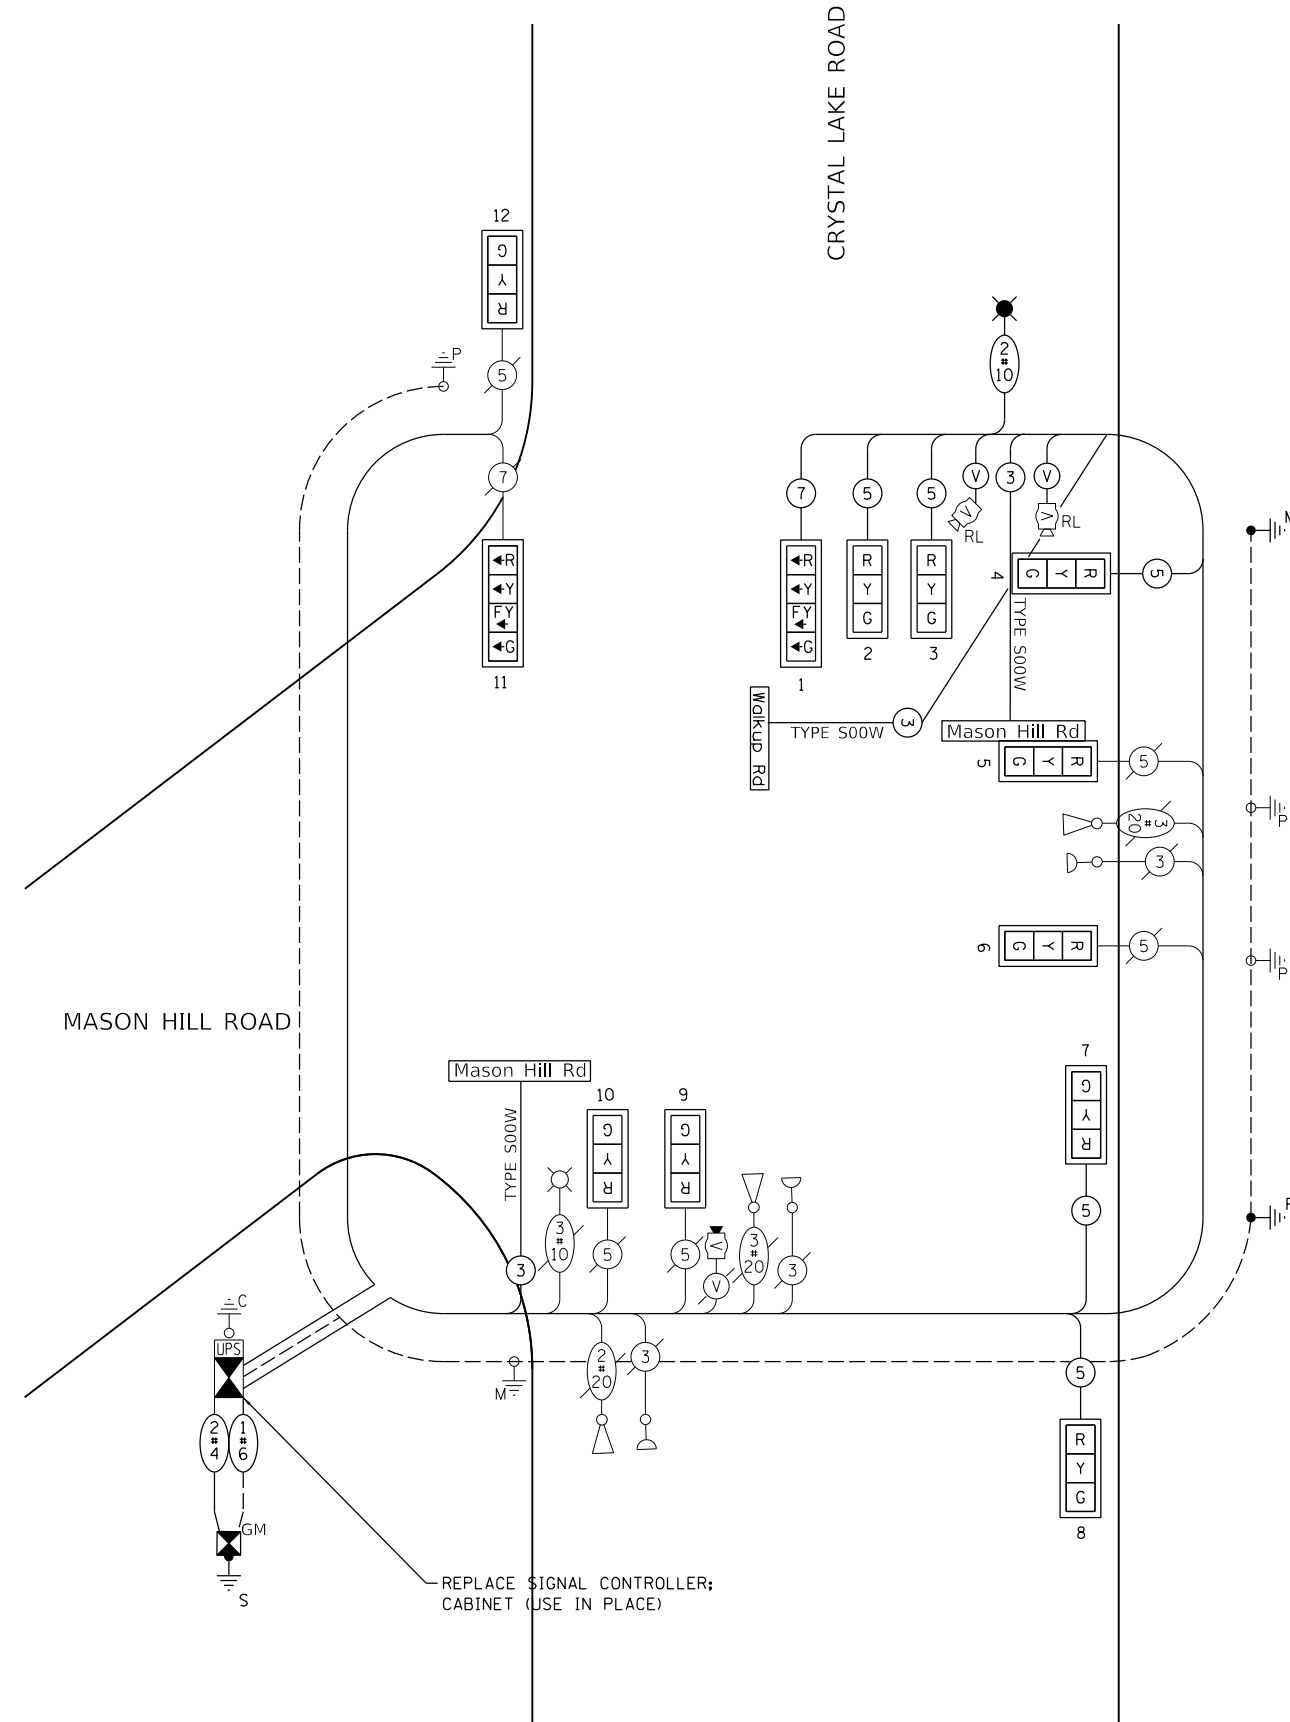
**STATE OF ILLINOIS
DEPARTMENT OF TRANSPORTATION**

**MASON HILL ROAD / CRYSTAL LAKE ROAD
WIRING DIAGRAM**

SCALE: SHEET OF SHEETS STA. TO STA.

PAY ITEM	DESCRIPTION	UNIT	Quantity
72000100	SIGN PANEL - TYPE 1	SQ FT	8
81028220	UNDERGROUND CONDUIT, GALVANIZED STEEL, 3" DIA.	FOOT	114
81702110	ELECTRIC CABLE IN CONDUIT, 600V (XLP-TYPE USE) 1/2 NO. 10	FOOT	581
87301245	ELECTRIC CABLE IN CONDUIT, SIGNAL NO. 14 5C	FOOT	927
87301255	ELECTRIC CABLE IN CONDUIT, SIGNAL NO. 14 7C	FOOT	286
87301900	ELECTRIC CABLE IN CONDUIT, EQUIPMENT GROUNDING CONDUCTOR, NO. 6 1C	FOOT	103
87502500	TRAFFIC SIGNAL POST, GALVANIZED STEEL 16 FT.	EACH	1
87702960	STEEL COMBINATION MAST ARM ASSEMBLY AND POLE 46 FT.	EACH	1
87800100	CONCRETE FOUNDATION, TYPE A	FOOT	4
87800415	CONCRETE FOUNDATION, TYPE E 36-NCH DIAMETER	FOOT	13
87900200	DRILL EXISTING HANDHOLE	EACH	2
88040070	SIGNAL HEAD, POLYCARBONATE, LED, 1-FACE, 3-SECTION, BRACKET MOUNTED	EACH	6
88040090	SIGNAL HEAD, POLYCARBONATE, LED, 1-FACE, 3-SECTION, MAST ARM MOUNTED	EACH	4
88040110	SIGNAL HEAD, POLYCARBONATE, LED, 1-FACE, 4-SECTION, BRACKET MOUNTED	EACH	1
88040120	SIGNAL HEAD, POLYCARBONATE, LED, 1-FACE, 4-SECTION, MAST ARM MOUNTED	EACH	1
88200510	TRAFFIC SIGNAL BACKPLATE, RETROREFLECTIVE	EACH	12
89502210	MODIFY EXISTING CONTROLLER CABINET	EACH	1
89502375	REMOVE EXISTING TRAFFIC SIGNAL EQUIPMENT	EACH	1
X0321973	MODIFY EXISTING SERVICE INSTALLATION	EACH	1
X0323986	RELOCATE EXISTING VIDEO VEHICLE DETECTOR	EACH	2
X0324599	ROD AND CLEAN EXISTING CONDUIT	FOOT	102
X1400150	SERVICE INSTALLATION, GROUND MOUNTED, METERED	EACH	1
X1400238	LUMINAIRE, LED, SPECIAL	EACH	1
X8570215	FULL-ACTUATED CONTROLLER IN EXISTING CABINET	EACH	1
X8809005	LED SIGNAL FACE, LENS COVER	EACH	12
XX005937	LED INTERNALLY ILLUMINATED STREET NAME SIGN	EACH	3

**CABLE PLAN
(NOT TO SCALE)**



HPS1

F.A.U. RTE.	SECTION	COUNTY	TOTAL SHEETS	SHEET NO.
0085	19-00511-00-SP	McHENRY	45	31
19L0111		CONTRACT NO.		61J51
ILLINOIS FED. AID PROJECT				






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PLOT DATE = 2/17/2023
PLOT DRIVER NAME = ...HANSON.pdf_300dpi.ctbfg

DESIGNED	
DRAWN	
REVIEWED	

REMOVAL NOTES:

THE FOLLOWING ITEMS SHALL BE REMOVED BY THE CONTRACTOR AND SHALL BE DISPOSED OF BY THEM OUTSIDE THE RIGHT AT THEIR EXPENSE. THE SALVAGE VALUE OF THE REMOVED EQUIPMENT SHALL BE REFLECTED IN THE CONTRACT BID PRICE.

- 1 EACH CONTROLLER AND CABINET
- 4 EACH STEEL MAST ARM ASSEMBLY AND POLE
- 6 EACH 3-SECTION SIGNAL HEAD
- 8 EACH 5-SECTION SIGNAL HEAD

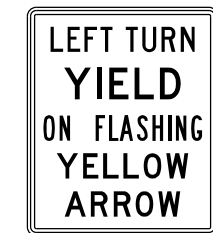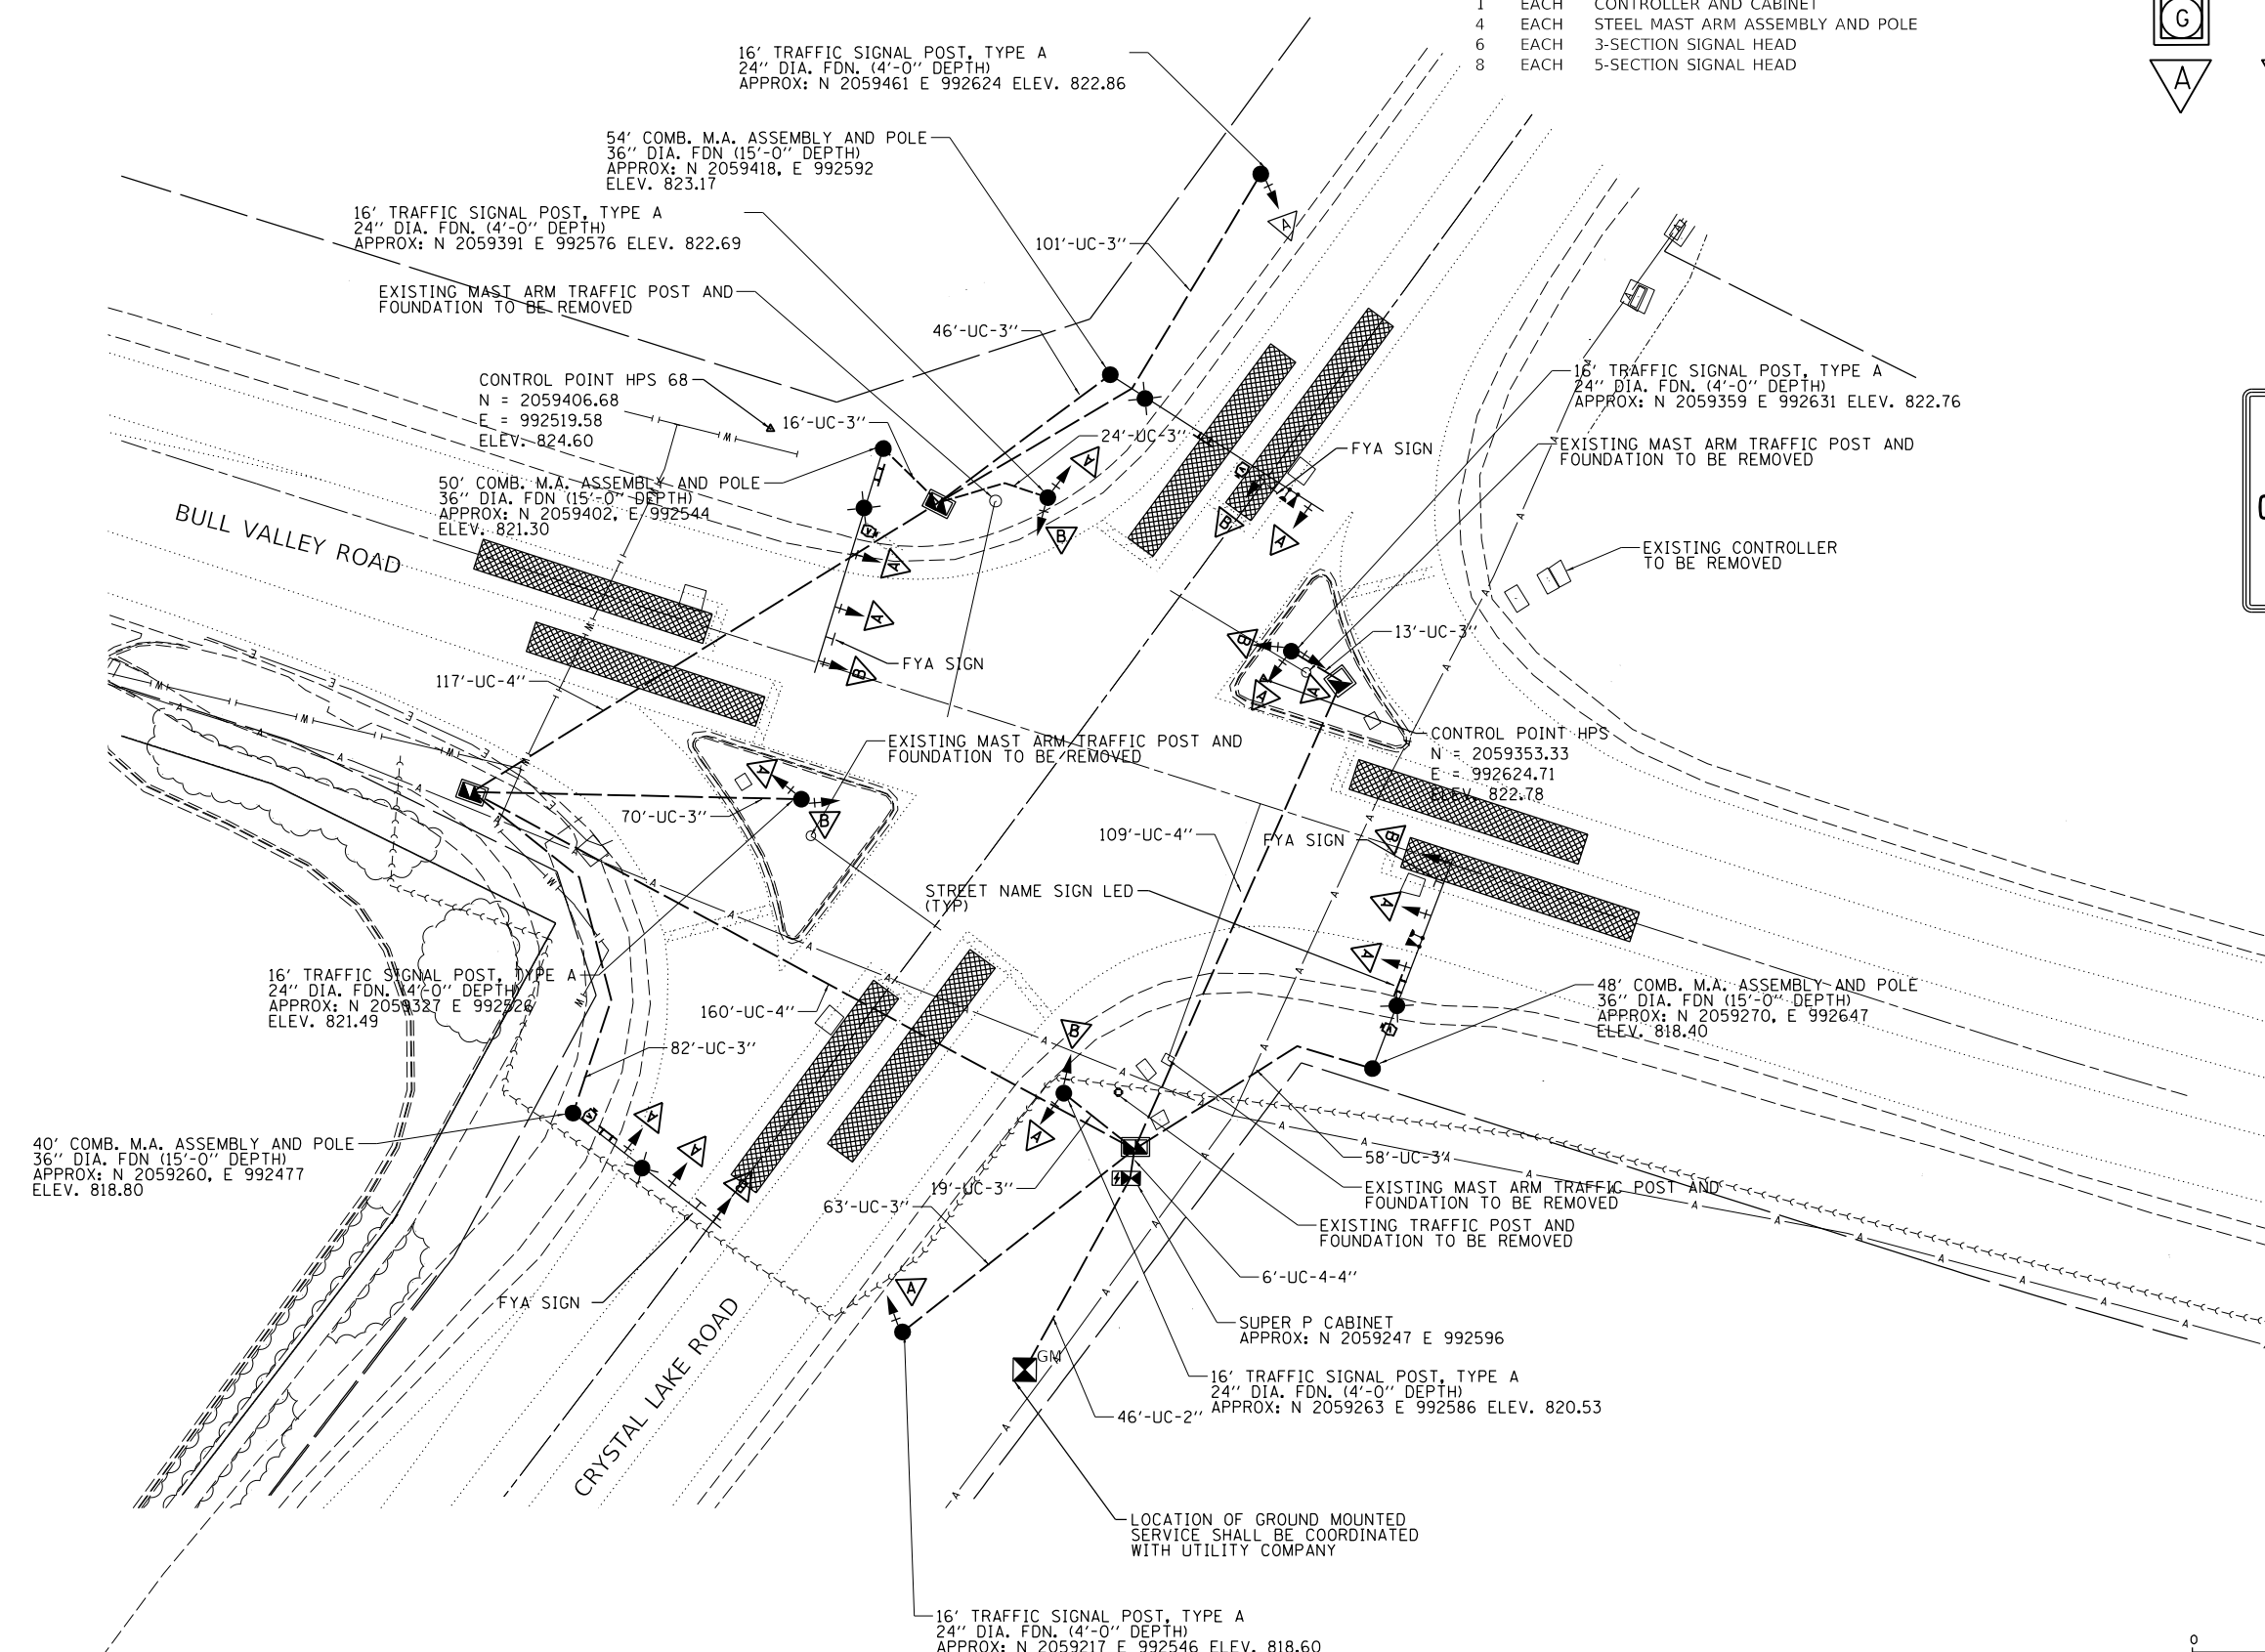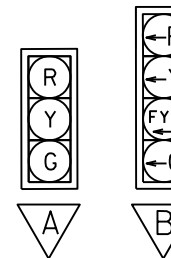

FYA SIGN
4 REQUIRED



SCALE IN FEET HPS1

STATE OF ILLINOIS
DEPARTMENT OF TRANSPORTATION

BULL VALLEY ROAD / CRYSTAL LAKE ROAD
SIGNAL PLAN

SCALE: 1"=20' SHEET OF SHEETS STA. TO STA.


F.A.U. RTE.	SECTION	COUNTY	TOTAL SHEETS	SHEET NO.
0085	19-00511-00-SP	McHENRY	45	32
19L0111			CONTRACT NO.	61J51
ILLINOIS FED. AID PROJECT				

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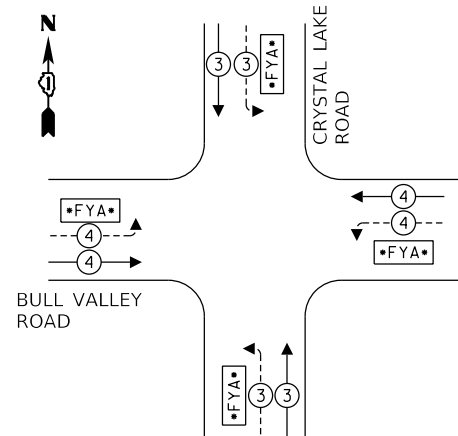


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PROPOSED PHASE DIAGRAM



PROPOSED EMERGENCY VEHICLE PREEMPTION SEQUENCE

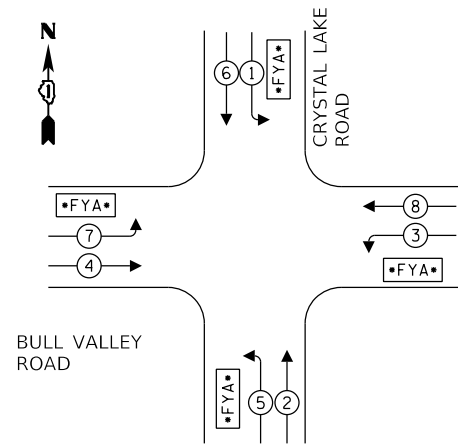


TRAFFIC SIGNAL INSTALLATION ELECTRICAL SERVICE REQUIREMENTS

TYPE	NO. LAMPS	LED WATTAGE	% OPERATION	TOTAL WATTAGE
SIGNAL (RED)	21	11	50	115.5
(YELLOW)	21	20	5	21.0
(GREEN)	21	12	45	113.4
FYA	8	10	45	36.0
TOTAL =				940.9

ENERGY COST - BILLED TO: McHENRY COUNTY
 2200 N. SEMINARY AVE.
 WOODSTOCK, IL 60098

ENERGY SUPPLY - CONTACT: LISA ARGAST
 PHONE: (630) 576-7094
 COMPANY: COMED

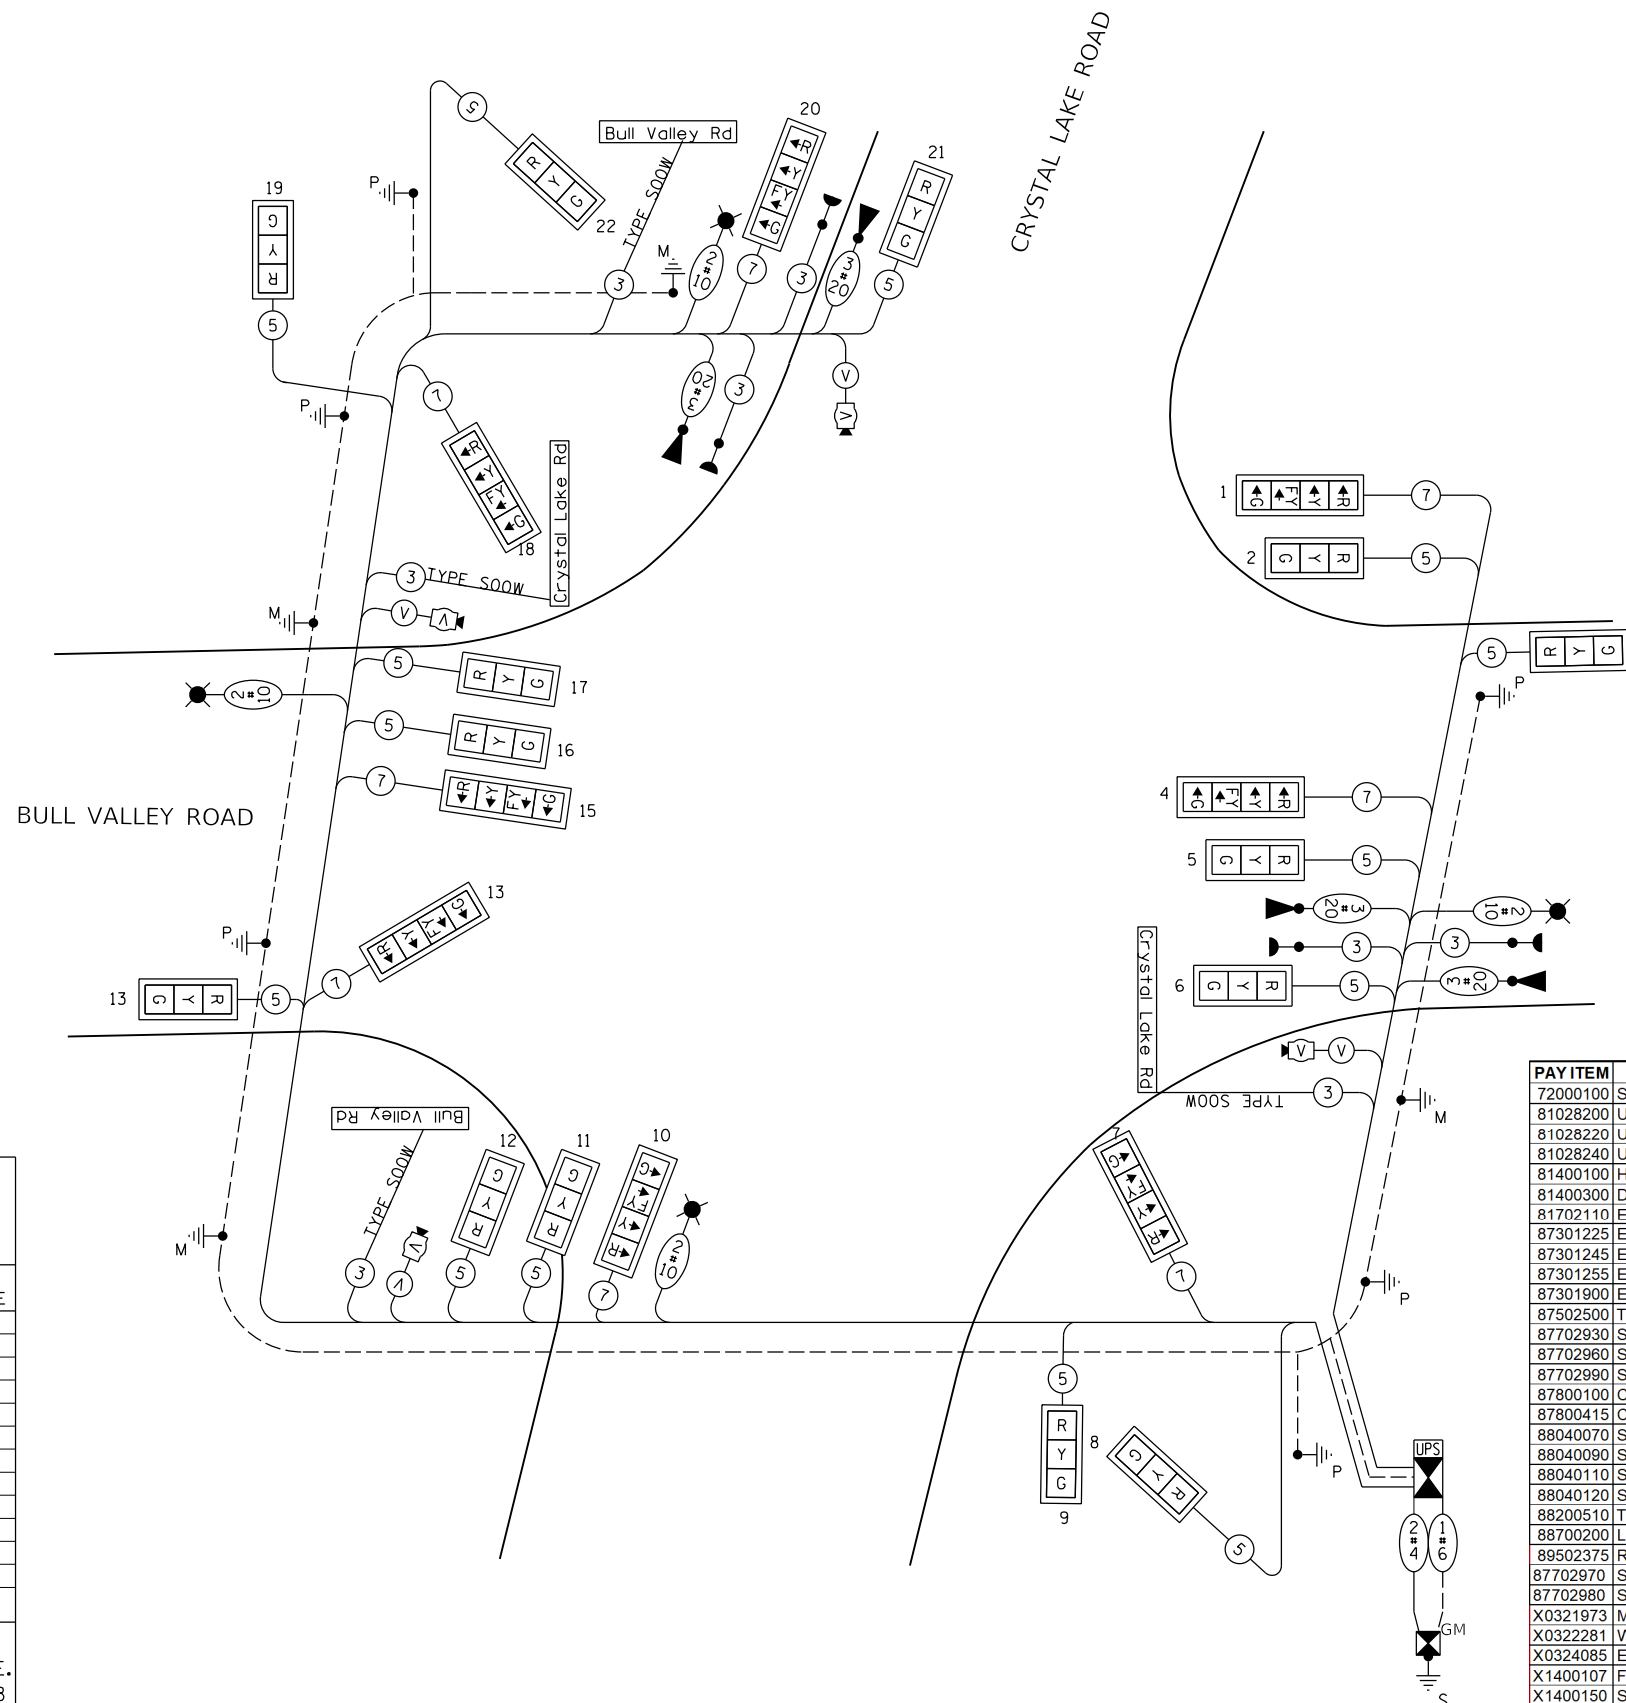

CABLE PLAN (NOT TO SCALE)

PAY ITEM	DESCRIPTION	UNIT	Quantity
72000100	SIGN PANEL - TYPE 1	SQ.FT	30
81028200	UNDERGROUND CONDUIT, GALVANIZED STEEL, 2" DIA.	FOOT	46
81028220	UNDERGROUND CONDUIT, GALVANIZED STEEL, 3" DIA.	FOOT	492
81028240	UNDERGROUND CONDUIT, GALVANIZED STEEL, 4" DIA.	FOOT	410
81400100	HANDHOLE	EACH	1
81400300	DOUBLE HANDHOLE	EACH	3
81702110	ELECTRIC CABLE IN CONDUIT, 600V (XLP-TYPE USE) 1/C NO. 10	FOOT	2722
87301225	ELECTRIC CABLE IN CONDUIT, SIGNAL NO. 14 3C	FOOT	547
87301245	ELECTRIC CABLE IN CONDUIT, SIGNAL NO. 14 5C	FOOT	3709
87301255	ELECTRIC CABLE IN CONDUIT, SIGNAL NO. 14 7C	FOOT	2218
87301900	ELECTRIC CABLE IN CONDUIT, EQUIPMENT GROUNDING CONDUCTOR, NO. 6 1C	FOOT	1187
87502500	TRAFFIC SIGNAL POST, GALVANIZED STEEL 16 FT.	EACH	6
87702930	STEEL COMBINATION MAST ARM ASSEMBLY AND POLE 40 FT.	EACH	1
87702960	STEEL COMBINATION MAST ARM ASSEMBLY AND POLE 46 FT.	EACH	1
87702990	STEEL COMBINATION MAST ARM ASSEMBLY AND POLE 54 FT.	EACH	1
87800100	CONCRETE FOUNDATION, TYPE A	FOOT	24
87800415	CONCRETE FOUNDATION, TYPE E 36-INCH DIAMETER	FOOT	56
88040070	SIGNAL HEAD, POLYCARBONATE, LED, 1-FACE, 3-SECTION, BRACKET MOUNTED	EACH	7
88040090	SIGNAL HEAD, POLYCARBONATE, LED, 1-FACE, 3-SECTION, MAST ARM MOUNTED	EACH	7
88040110	SIGNAL HEAD, POLYCARBONATE, LED, 1-FACE, 4-SECTION, BRACKET MOUNTED	EACH	4
88040120	SIGNAL HEAD, POLYCARBONATE, LED, 1-FACE, 4-SECTION, MAST ARM MOUNTED	EACH	4
88200510	TRAFFIC SIGNAL BACKPLATE, RETROREFLECTIVE	EACH	22
88700200	LIGHT DETECTOR	EACH	4
89502375	REMOVE EXISTING TRAFFIC SIGNAL EQUIPMENT	EACH	1
87702970	STEEL COMBINATION MAST ARM ASSEMBLY AND POLE 48 FT.	EACH	1
87702980	STEEL COMBINATION MAST ARM ASSEMBLY AND POLE 50 FT.	EACH	1
X0321973	MODIFY EXISTING SERVICE INSTALLATION	EACH	1
X0322281	WIDE AREA VIDEO DETECTION SYSTEM COMPLETE	EACH	1
X0324085	EMERGENCY VEHICLE PRIORITY SYSTEM LINE SENSOR CABLE, NO. 20 3/C	FOOT	547
X1400107	FULL-ACTUATED CONTROLLER AND TYPE SUPER P CABINET	EACH	1
X1400150	SERVICE INSTALLATION, GROUND MOUNTED, METERED	EACH	1
X1400238	LUMINAIRE, LED, SPECIAL	EACH	4
X8809005	LED SIGNAL FACE, LENS COVER	EACH	22
X8870300	EMERGENCY VEHICLE PRIORITY SYSTEM	EACH	1
XX005937	LED INTERNALLY ILLUMINATED STREET NAME SIGN	EACH	4

DESIGNED	
DRAWN	
REVIEWED	

USER NAME = Pearc00397	DESIGNED -	REVISED -
PLOT SCALE = 40.0000 ' / in.	DRAWN -	REVISED -
PLOT DATE = 2/17/2023	CHECKED -	REVISED -
	DATE -	REVISED -


**STATE OF ILLINOIS
 DEPARTMENT OF TRANSPORTATION**

**BULL VALLEY ROAD / CRYSTAL LAKE ROAD
 WIRING DIAGRAM**

SCALE: SHEET OF SHEETS STA. TO STA.


F.A.U. RTE.	SECTION	COUNTY	TOTAL SHEETS	SHEET NO.
0085	19-00511-00-SP	McHENRY	45	33
	19L0111		CONTRACT NO.	61J51

HPS1

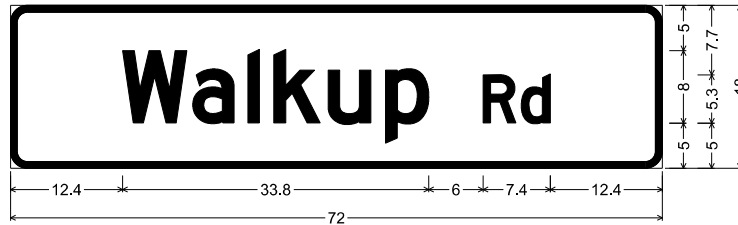


D3-1(3)_VARx18;
1.9" Radius, 0.8" Border, White on, Green;
"Walkup", D 2K; "Rd", D 2K;

DESIGN SERIES	AREA (SQ FT)	SHEETING TYPE	QTY. REQUIRED
D	9	ILLUM. SIGN (ZZ)	7

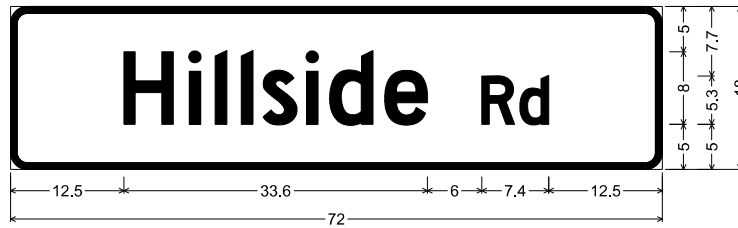


D3-1(3)_VARx18;
1.9" Radius, 0.8" Border, White on, Green;
"Hillside", D 2K; "Rd", D 2K;

DESIGN SERIES	AREA (SQ FT)	SHEETING TYPE	QTY. REQUIRED
D	9	ILLUM. SIGN (ZZ)	2

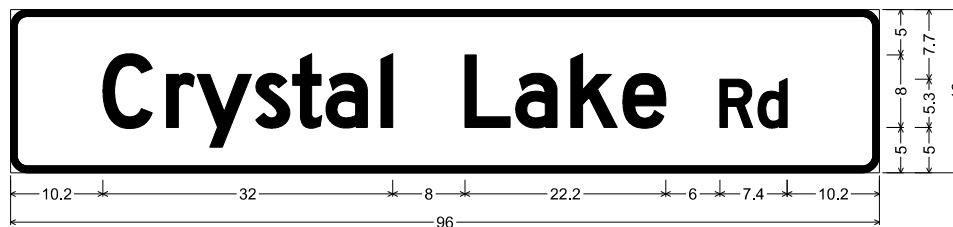


D3-1(3)_VARx18;
1.9" Radius, 0.8" Border, White on, Green;
"Crystal Lake", D 2K; "Rd", D 2K;

DESIGN SERIES	AREA (SQ FT)	SHEETING TYPE	QTY. REQUIRED
D	12	ILLUM. SIGN (ZZ)	3

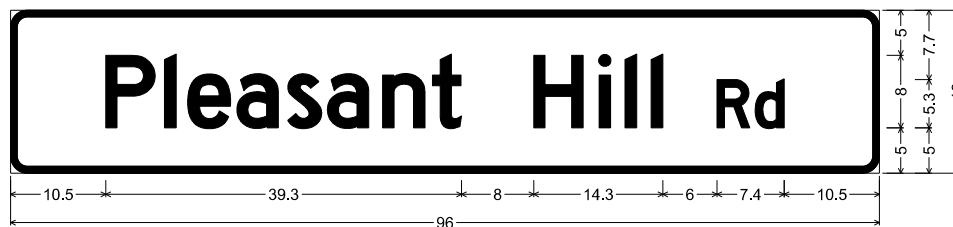


D3-1(3)_VARx18;
1.9" Radius, 0.8" Border, White on, Green;
"Pleasant Hill", D 2K; "Rd", D 2K;

DESIGN SERIES	AREA (SQ FT)	SHEETING TYPE	QTY. REQUIRED
D	12	ILLUM. SIGN (ZZ)	1

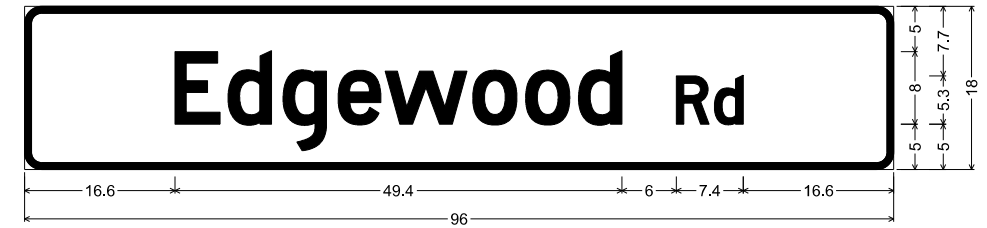


D3-1(3)_VARx18;
1.9" Radius, 0.8" Border, White on, Green;
"Edgewood", D 2K; "Rd", D 2K;

DESIGN SERIES	AREA (SQ FT)	SHEETING TYPE	QTY. REQUIRED
D	12	ILLUM. SIGN (ZZ)	1

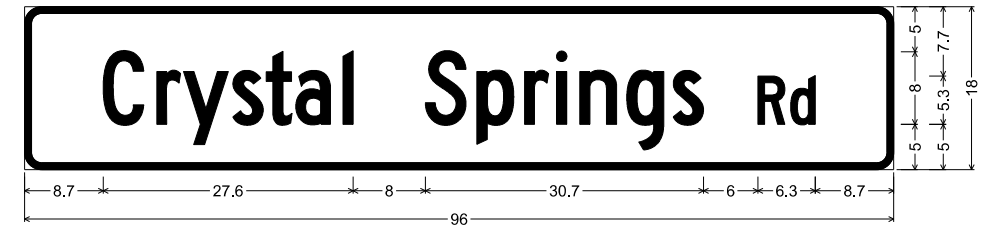


D3-1(3)_VARx18;
1.9" Radius, 0.8" Border, White on, Green;
"Crystal Springs", C 2K; "Rd", C 2K;

DESIGN SERIES	AREA (SQ FT)	SHEETING TYPE	QTY. REQUIRED
D	12	ILLUM. SIGN (ZZ)	2

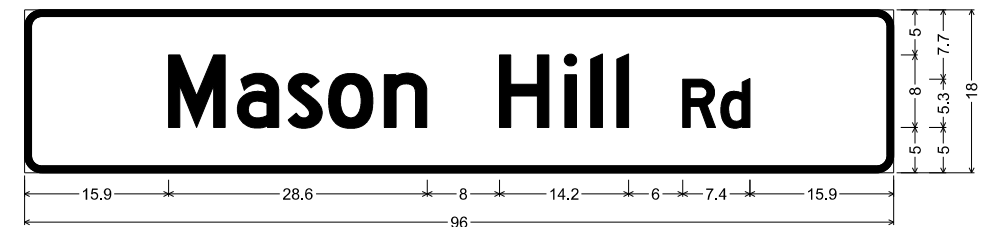

D3-1(3)_VARx18;
1.9" Radius, 0.8" Border, White on, Green;
"Mason Hill", D 2K; "Rd", D 2K;

DESIGN SERIES	AREA (SQ FT)	SHEETING TYPE	QTY. REQUIRED
D	12	ILLUM. SIGN (ZZ)	2

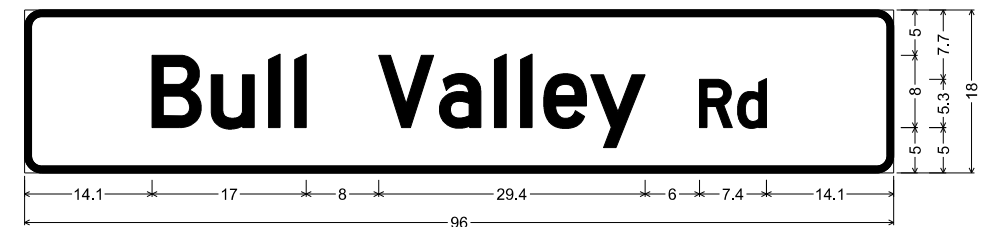

D3-1(3)_VARx18;
1.9" Radius, 0.8" Border, White on, Green;
"Bull Valley", D 2K; "Rd", D 2K;

DESIGN SERIES	AREA (SQ FT)	SHEETING TYPE	QTY. REQUIRED
D	12	ILLUM. SIGN (ZZ)	2

DESIGNED	
DRAWN	
REVIEWED	

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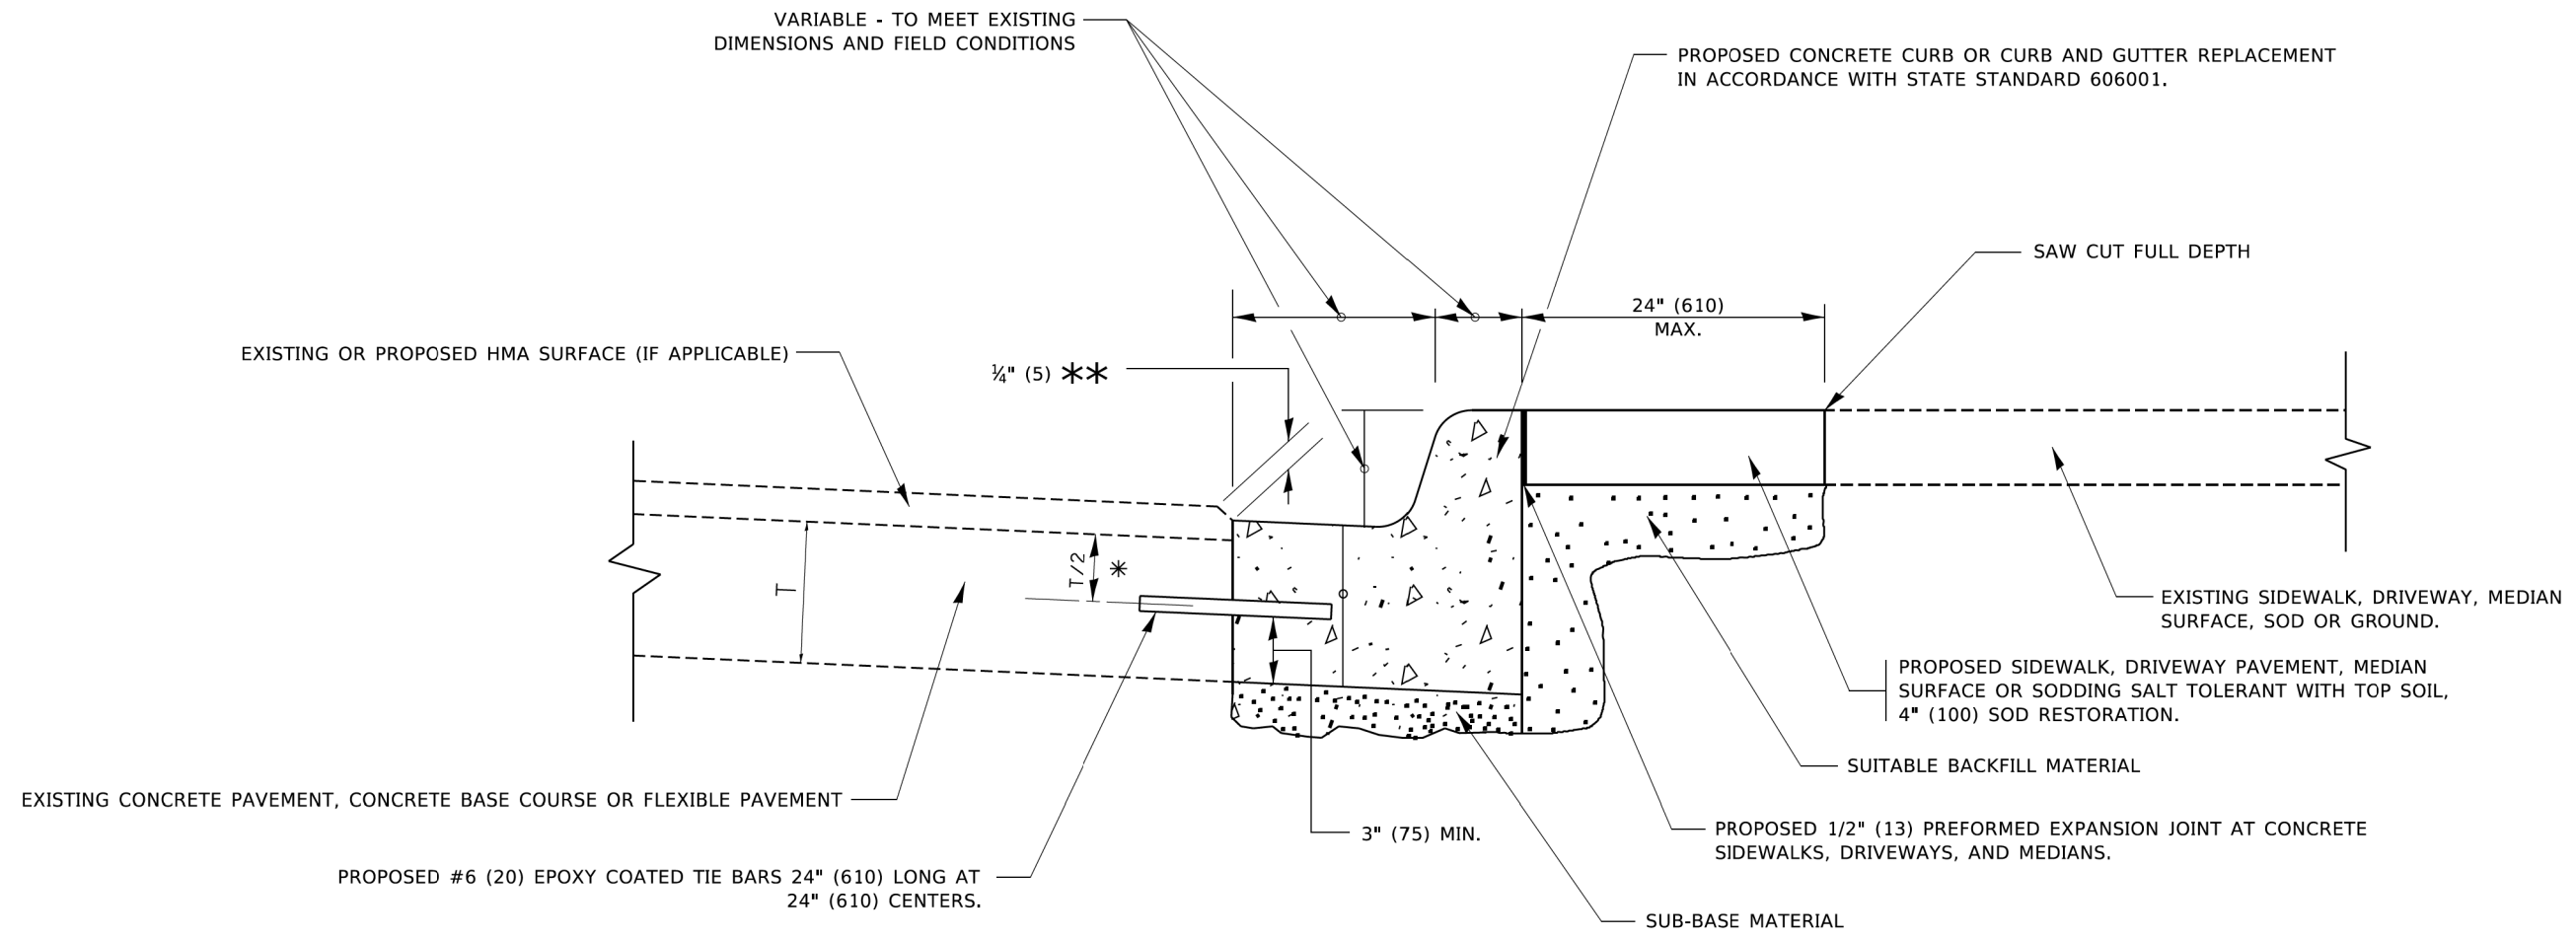
STATE OF ILLINOIS
DEPARTMENT OF TRANSPORTATION

LED ILLUMINATED
STREET NAME SIGNS

SCALE: SHEET OF SHEETS STA. TO STA.

F.A.U. RTE.	SECTION	COUNTY	TOTAL SHEETS	SHEET NO.
0085	19-00511-00-SP	McHENRY	45	34
19L0111		CONTRACT NO.	61J51	
ILLINOIS FED. AID PROJECT				

HPS1



- * 3" (75) MINIMUM FROM TOP AND BOTTOM OF THE CONCRETE PAVEMENT OR BASE COURSE.
- ** IF THE FINAL SURFACE OF THE PAVEMENT IS CONCRETE, THE GUTTER IS TO BE FLUSH WITH THE PAVEMENT.

CURB OR CURB AND GUTTER REMOVAL AND REPLACEMENT

ALL DIMENSIONS ARE IN INCHES (MILLIMETERS) UNLESS OTHERWISE SHOWN.

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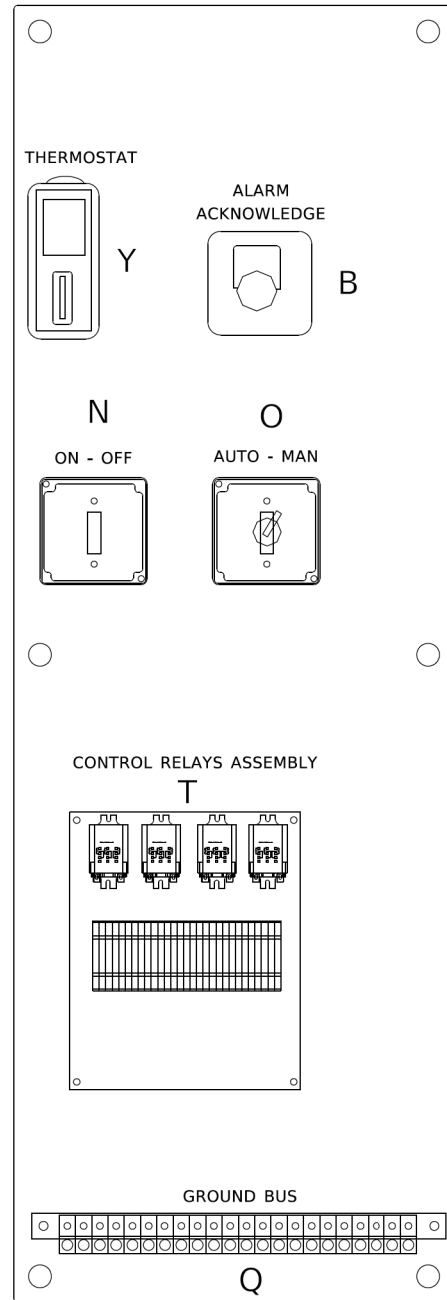
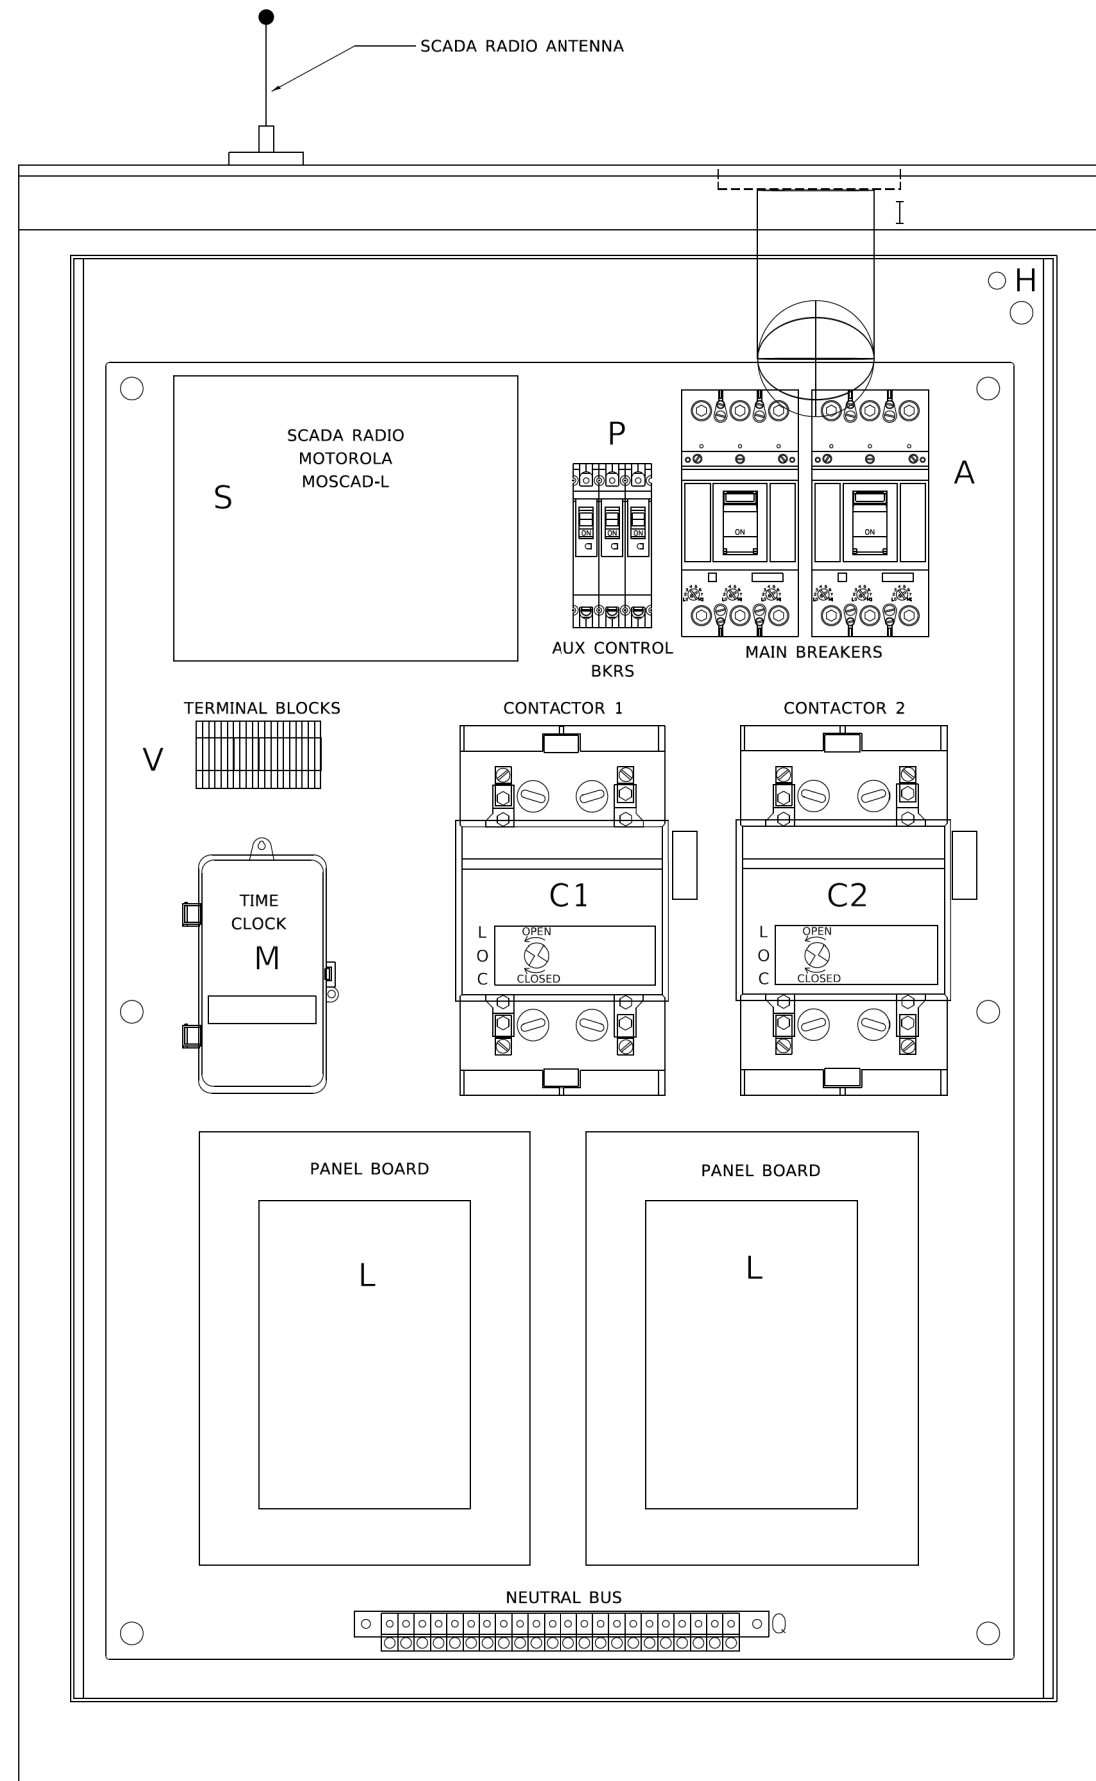
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	DRAWN -	REVISED - M. GOMEZ 01-22-01
PLOT SCALE = 50.0000' / in.	CHECKED -	REVISED - R. BORO 12-15-09
PLOT DATE = 7/11/2019	DATE - 03-11-94	REVISED - K. SMITH 07-11-19

**STATE OF ILLINOIS
DEPARTMENT OF TRANSPORTATION**


**CURB OR CURB AND GUTTER
REMOVAL AND REPLACEMENT**

SCALE: NONE SHEET 1 OF 1 SHEETS STA. TO STA.

F.A. RTE.	SECTION	COUNTY	TOTAL SHEETS	SHEET NO.
0085	19-00511-00-SP	McHENRY	45	35
BD600-06 (BD-24)			CONTRACT NO. 61J51	
ILLINOIS FED. AID PROJECT				



LEFT SIDE PANEL

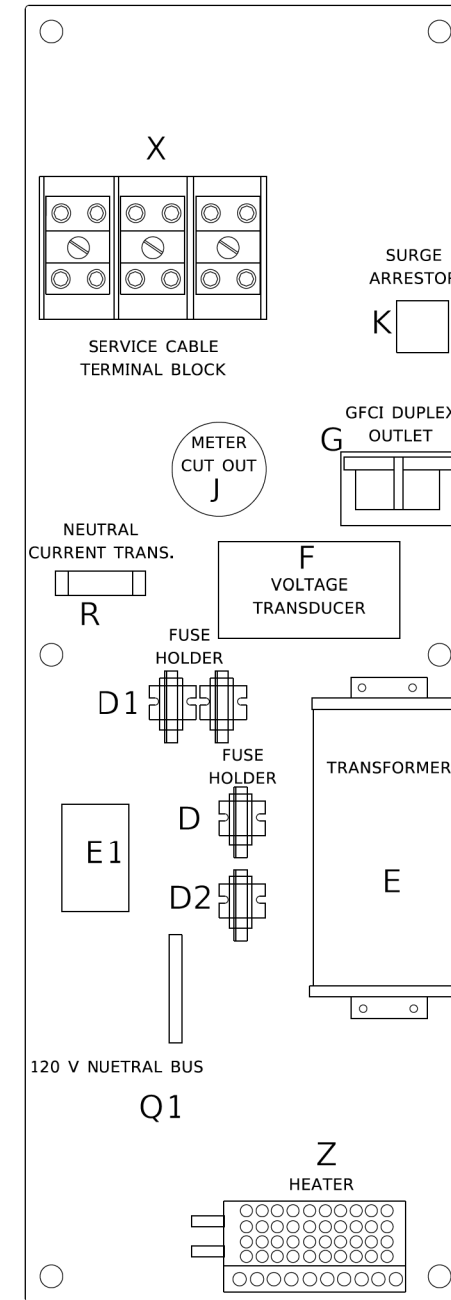

RIGHT SIDE PANEL

BILL OF MATERIALS		
ITEM	QTY	DESCRIPTION
A	2	MAIN CIRCUIT BREAKERS 2 POLE 200 AMP WITH AUX CONTACT
B	1	ACKNOWLEDGE SWITCH, PUSH BUTTON WITH YELLOW INSERT
C1, C2 *	2	CONTACTOR 2 POLE 200 AMP 240V COIL WITH AUX CONTACTS
D	1	FINGERSAFE FUSE HOLDER WITH KTK - 20A FUSE
D1	2	FINGERSAFE FUSE HOLDER WITH KTK - 1/2 A FUSE
D2	1	FINGERSAFE FUSE HOLDER WITH KTK - 2A FUSE
E	1	2.0 KVA 277V-240/120 TRANSFORMER
E1	1	0.25 KVA240/ 120 - 24 VAC TRANSFORMER
F	1	VOLTAGE TRANSDUCER WITH COVER TERMINALS
G	1	20 AMP GFCI DUPLEX OUTLET W/COVER
H	2	DOOR SWITCH
I	1	LIGHT FIXTURE
J	1	METER FITTING 1 PHASE 3 WIRE 200 AMP
K	1	SURGE ARRESTER
L	2	PANEL BOARD 480/ 240V 1 PHASE, 250 AMP COPPER BUS
M	1	2 CHANNEL DIGITAL TIME CLOCK
N	1	MOMENTARY SWITCH ON - OFF
O	1	SQUARE D, 9001KS11BH13, 2 POSITION SWITCH IN 9001KY1 ENCLOSURE OR APPROVED EQUAL
P	2	BREAKER 1P 15A
Q	2	COPPER GROUND AND NEUTRAL BUS 1 X 16 X 1/4
Q1	1	COPPER NEUTRAL BUS WITH 1 #6 AND 8 #12 CONDUCTOR POINTS
R	1	CURRENT TRANSDUCER
S	1	MOTOROLA MOSCAD-L RADIO, 240 V
T *	1	CONTROL RELAY ASSEMBLY 240V COILS WITH 4 - 3PDT 25A RELAYS (W389ACX-15) (R1, R2, R3, R4). QTY 32 TERMINAL BLOCKS
V	20	TERMINAL BLOCKS
X *	1	620 AMP SPLICE BLOCK
Y	1	40-80 DEGREE THERMOSTAT
Z	1	375 WATT HEATER

* TERMINALS SHALL BE COVERED WITH CLEAR PLEXIGLASS SHEET

MODEL: Default
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PROJECT: D:\Projects\1100111\1100111.dwg
DATE: 4/19/2019


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	DRAWN -	REVISED - R. TOMSONS 05-11-09
PLOT SCALE = 50.0000' / in.	CHECKED -	REVISED - R. TOMSONS 03-10-10
PLOT DATE = 4/19/2019	DATE -	REVISED - R. TOMSONS 03-29-12

STATE OF ILLINOIS
DEPARTMENT OF TRANSPORTATION

LIGHTING CONTROLLER, BASE MOUNTED,
480VOLT, 200AMP (DUAL) RADIO SCADA

SCALE: NONE SHEET 1 OF 4 SHEETS STA. TO STA.

F.A. RTE. 0085	SECTION 19-00511-00-SP	COUNTY McHENRY	TOTAL SHEETS 45	SHEET NO. 36
BE-205		CONTRACT NO. 61J51		
ILLINOIS FED. AID PROJECT				

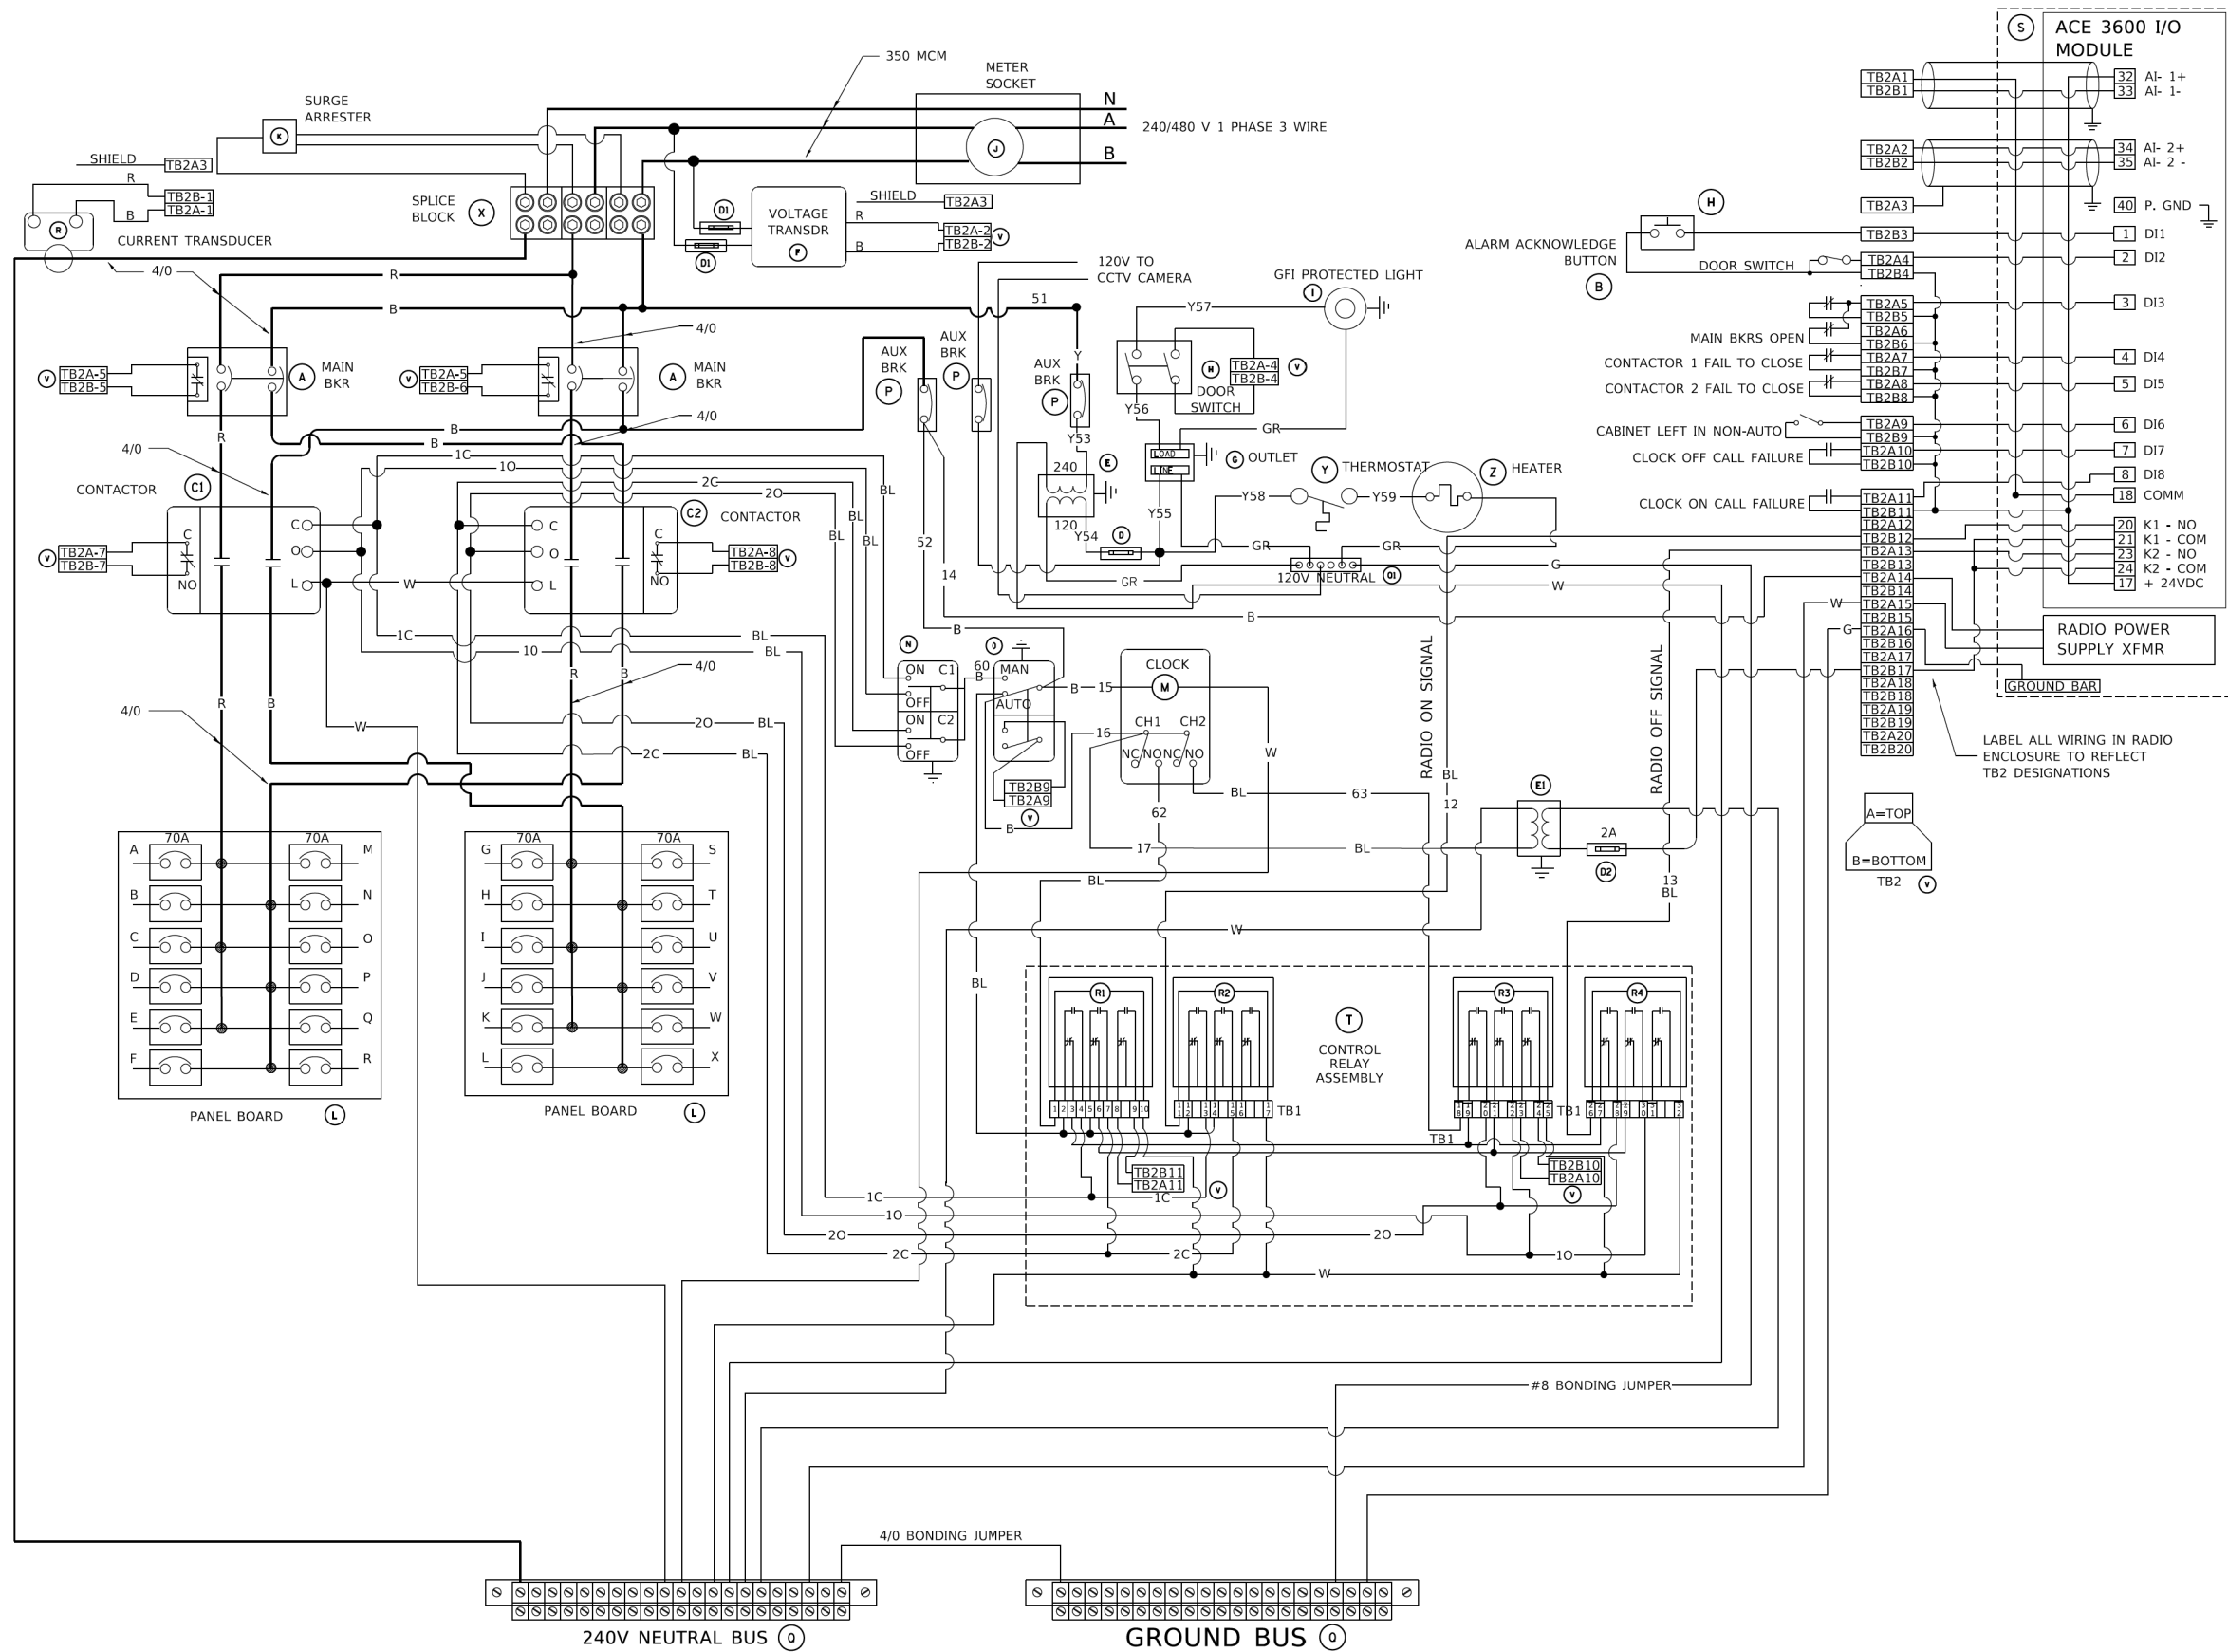

BILL OF MATERIALS		
ITEM	QTY	DESCRIPTION
A	2	MAIN CIRCUIT BREAKERS 2 POLE 200 AMP WITH AUX CONTACT
B	1	ACKNOWLEDGE SWITCH, PUSH BUTTON WITH YELLOW INSERT
C1, C2*	2	CONTACTOR 2 POLE 200 AMP 240V COIL WITH AUX CONTACTS
D	1	FINGERSAFE FUSE HOLDER WITH KTK - 20A FUSE
D1	2	FINGERSAFE FUSE HOLDER WITH KTK - 1/2 A FUSE
D2	1	FINGERSAFE FUSE HOLDER WITH KTK - 2A FUSE
E	1	2.0 KVA 277V-240/120 TRANSFORMER
E1	1	0.25 KVA240/ 120 - 24 VAC TRANSFORMER
F	1	VOLTAGE TRANSDUCER WITH COVER TERMINALS
G	1	20 AMP GFCI DUPLEX OUTLET W/COVER
H	2	DOOR SWITCH
I	1	LIGHT FIXTURE
J	1	METER FITTING 1 PHASE 3 WIRE 200 AMP
K	1	SURGE ARRESTER
L	2	PANEL BOARD 480/ 240V 1 PHASE, 250 AMP COPPER BUS
M	1	2 CHANNEL DIGITAL TIME CLOCK
N	1	MOMENTARY SWITCH ON - OFF
O	1	SQUARE D, 9001K511BH13, 2 POSITION SWITCH IN 9001KY1 ENCLOSURE OR APPROVED EQUAL
P	2	BREAKER 1P 15A
Q	2	COPPER GROUND AND NEUTRAL BUS 1 X 16 X 1/4
Q1	1	COPPER NEUTRAL BUS WITH 1 #6 AND 8 #12 CONDUCTOR POINTS
R	1	CURRENT TRANSDUCER
S	1	MOTOROLA MOSCAD-L RADIO, 240 V
T*	1	CONTROL RELAY ASSEMBLY 240V COILS WITH 4 - 3PDT 25A RELAYS (W389ACX-15) (R1, R2, R3, R4). QTY 32 TERMINAL BLOCKS
V	20	TERMINAL BLOCKS
X*	1	620 AMP SPLICE BLOCK
Y	1	40-80 DEGREE THERMOSTAT
Z	1	375 WATT HEATER

* TERMINALS SHALL BE COVERED WITH CLEAR PLEXIGLASS SHEET

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 OFFICE: DISTRICT 1
 DATE: 4/19/2019


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	DRAWN -	REVISED - R. TOMSONS 05-11-09
PLOT SCALE = 50.0000' / in.	CHECKED -	REVISED - R. TOMSONS 03-10-10
PLOT DATE = 4/19/2019	DATE -	REVISED - R. TOMSONS 03-29-12

**STATE OF ILLINOIS
DEPARTMENT OF TRANSPORTATION**

**LIGHTING CONTROLLER, BASE MOUNTED,
480VOLT, 200AMP (DUAL) RADIO SCADA**

SCALE: NONE SHEET 2 OF 4 SHEETS STA. TO STA.

F.A. RTE. 0085	SECTION 19-00511-00-SP	COUNTY McHENRY	TOTAL SHEETS 45	SHEET NO. 37
BE-205			CONTRACT NO. 61J51	
ILLINOIS FED. AID PROJECT				

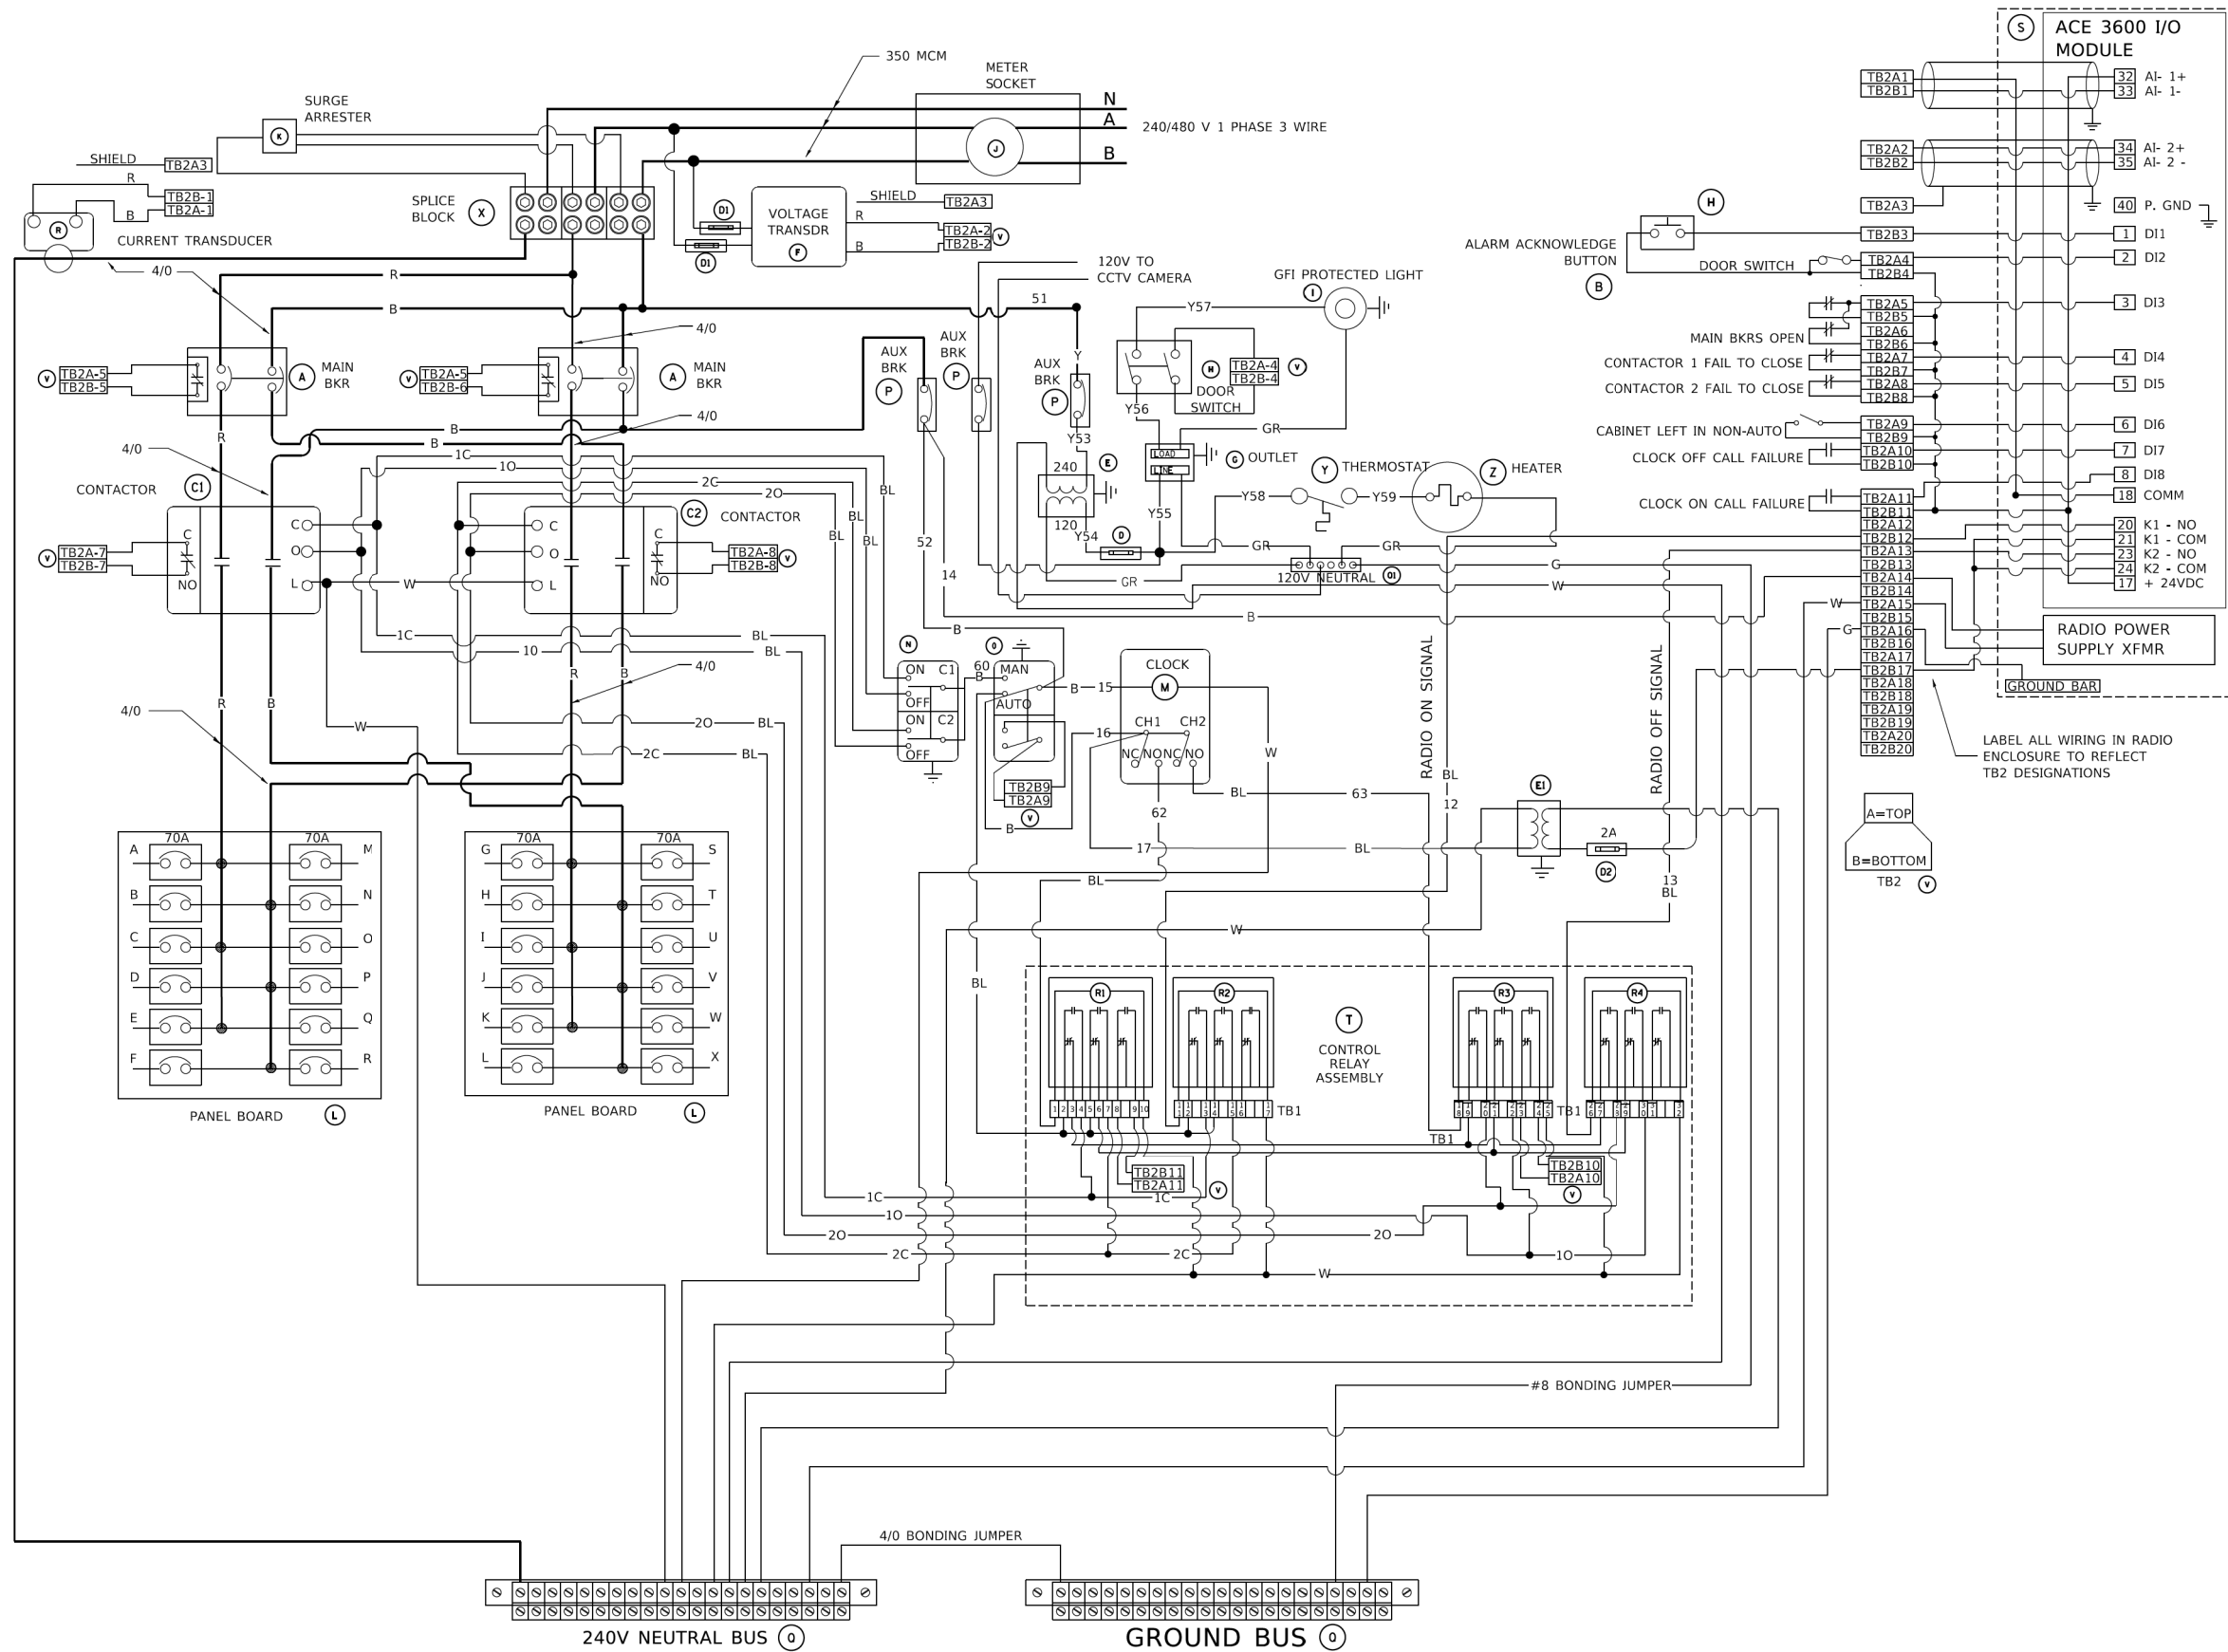

BILL OF MATERIALS		
ITEM	QTY	DESCRIPTION
A	2	MAIN CIRCUIT BREAKERS 2 POLE 200 AMP WITH AUX CONTACT
B	1	ACKNOWLEDGE SWITCH, PUSH BUTTON WITH YELLOW INSERT
C1, C2*	2	CONTACTOR 2 POLE 200 AMP 240V COIL WITH AUX CONTACTS
D	1	FINGERSAFE FUSE HOLDER WITH KTK - 20A FUSE
D1	2	FINGERSAFE FUSE HOLDER WITH KTK - 1/2 A FUSE
D2	1	FINGERSAFE FUSE HOLDER WITH KTK - 2A FUSE
E	1	2.0 KVA 277V-240/120 TRANSFORMER
E1	1	0.25 KVA240/ 120 - 24 VAC TRANSFORMER
F	1	VOLTAGE TRANSDUCER WITH COVER TERMINALS
G	1	20 AMP GFCI DUPLEX OUTLET W/COVER
H	2	DOOR SWITCH
I	1	LIGHT FIXTURE
J	1	METER FITTING 1 PHASE 3 WIRE 200 AMP
K	1	SURGE ARRESTER
L	2	PANEL BOARD 480/ 240V 1 PHASE, 250 AMP COPPER BUS
M	1	2 CHANNEL DIGITAL TIME CLOCK
N	1	MOMENTARY SWITCH ON - OFF
O	1	SQUARE D, 9001K511BH13, 2 POSITION SWITCH IN 9001KY1 ENCLOSURE OR APPROVED EQUAL
P	2	BREAKER 1P 15A
Q	2	COPPER GROUND AND NEUTRAL BUS 1 X 16 X 1/4
Q1	1	COPPER NEUTRAL BUS WITH 1 #6 AND 8 #12 CONDUCTOR POINTS
R	1	CURRENT TRANSDUCER
S	1	MOTOROLA MOSCAD-L RADIO, 240 V
T*	1	CONTROL RELAY ASSEMBLY 240V COILS WITH 4 - 3PDT 25A RELAYS (W389ACX-15) (R1, R2, R3, R4). QTY 32 TERMINAL BLOCKS
V	20	TERMINAL BLOCKS
X*	1	620 AMP SPLICE BLOCK
Y	1	40-80 DEGREE THERMOSTAT
Z	1	375 WATT HEATER

* TERMINALS SHALL BE COVERED WITH CLEAR PLEXIGLASS SHEET

MODEL: Default
 FILE NAME: Proj\plancom.dwg
 PROJECT: 19-00511-00-SP
 OFFICE: DISTRICT 1
 DATE: 4/19/2019

USER NAME = footemj	DESIGNED -	REVISED - R. TOMSONS 08-19-04
	DRAWN -	REVISED - R. TOMSONS 05-11-09
PLOT SCALE = 50.0000' / in.	CHECKED -	REVISED - R. TOMSONS 03-10-10
PLOT DATE = 4/19/2019	DATE -	REVISED - R. TOMSONS 03-29-12

STATE OF ILLINOIS
DEPARTMENT OF TRANSPORTATION

LIGHTING CONTROLLER, BASE MOUNTED,
480VOLT, 200AMP (DUAL) RADIO SCADA


SCALE: NONE SHEET 2 OF 4 SHEETS STA. TO STA.

F.A. RTE. 0085	SECTION 19-00511-00-SP	COUNTY McHENRY	TOTAL SHEETS 45	SHEET NO. 38
BE-205			CONTRACT NO. 61J51	
ILLINOIS FED. AID PROJECT				

NOTES

- CABINET SHALL BE FABRICATED FROM 0.125-INCH (3.175) SHEET ALUMINUM #3003H14, FORMED AND ARC WELDED.
- ALL SCREWS AND HARDWARE SHALL BE PLATED, GALVANIZED, OR MADE OF BRASS, ALUMINUM OR STAINLESS STEEL, UNLESS OTHERWISE NOTED.
- NAME PLATE SHALL HAVE ENGRAVED 0.75-INCH (19.05) HIGH LETTERS FILLED IN BLACK: "STATE OF ILLINOIS LIGHTING CONTROLS" UNLESS OTHERWISE SPECIFIED.
- ONE INCH THICK POLYISOCYANURATE INSULATION SHALL BE INSTALL AND PERMANENTLY CEMENTED ON ALL SIDES OF THE CABINET AND DOORS.
- CABINET SHALL BE PRIMED AND PAINTED AS SPECIFIED.
- ELECTRIC UTILITY METER BOX SHALL BE MOUNTED ON THE SIDE OF CONTROL CABINET AS SHOWN ON THE PANEL LAYOUT DIAGRAM.
- THE COMPLETED CONTROLLER SHALL BE U.L. LISTED AS AN INDUSTRIAL CONTROL PANEL UNDER UL508.
- METAL MOUNTING PANEL SHALL BE FABRICATED FROM THE SAME MATERIAL AS THE CABINET AND SHALL BE FLANGED BACK 0.75-INCHES I.D. ON 4 SIDES.
- CIRCUIT BREAKERS AND CONTACTORS AND OTHER COMPONENTS SHALL BE MOUNTED ON 0.125-INCH (3.175) THICK GLASTIC INSULATION BACK PANEL.
- ALL DEVICES SHALL BE FRONT REMOVABLE.
- TIME CLOCK CHANNEL 1 N.O. CONTACT IS CLOSED NIGHT AND OPEN DAY (LIGHTS ON).
- SET LATITUDE TO 42 DEGREES. SET CH.1 TO 23 MINUTES AFTER ASTRONOMICAL SUNSET, 50 MINUTES BEFORE ASTRONOMICAL SUNRISE. SET CH.2 TO 60 MINUTES AFTER ASTRONOMICAL SUNSET (WITH A SIGNAL LENGTH OF 1 SECOND), +28 MINUTES AFTER ASTRONOMICAL SUNRISE (WITH A SIGNAL LENGTH OF 7 SECONDS.)
- BUS BAR SHALL HAVE 22 LUG TERMINALS SIZED TO ACCOMMODATE REQUIRED WIRE SIZES. 240V NEUTRAL BUS SHALL BE PAINTED WHITE, GROUND BUS SHALL BE PAINTED GREEN, AND THE 120V NEUTRAL BUS SHALL BE PAINTED GREY.
- ALL LUGS SHALL BE OF COPPER SCREWS AND CONNECTORS, SPRING HELD.
- ALL WIRING TERMINATIONS SHALL BE RATED NOT LESS THAN 75 DEGREE CENTIGRADE.
- ALL CONTROL WIRING SHALL BE 600V #12 TYPE MTW, SCADA WIRING SHALL BE #18.
- ALL POWER WIRING SHALL BE 600V TYPE RHH/RHW.
- ALL WIRING WITHIN THE CABINET SHALL BE COLOR CODED AS INDICATED:

R = RED	Y = YELLOW
B = BLACK	W = WHITE
BL = BLUE	G = GREEN
	GR = GREY
- MOSCAD I/O WIRING SHALL BE:
DIGITAL INPUT (DI) WIRING SHALL BE #18 MTW PURPLE.
ANALOG INPUT (AI) WIRING SHALL BE #18, 2/C SHIELDED.
AI AND DI WIRING MAY BE BUNDLED TOGETHER, BUT SHALL NOT BE BUNDLED WITH OTHER WIRING.
- ALL DIMENSIONS ARE IN INCHES (MILLIMETERS) UNLESS OTHERWISE INDICATED.
- SCHEMATIC SHOWN WITH BREAKER OPEN, CONTACTOR OPEN, CABINET DOOR CLOSED, CLOCK NOT ACTIVE (DE-ENERGIZED STATE).
- A LAMINATED COPY OF THE CIRCUIT SCHEMATIC AND SCADA I/O DIAGRAM (NO SMALLER THAN 11"x17" EACH) SHALL BE ATTACHED TO THE INSIDE OF THE CONTROLLER WITH STAINLESS STEEL SCREWS.

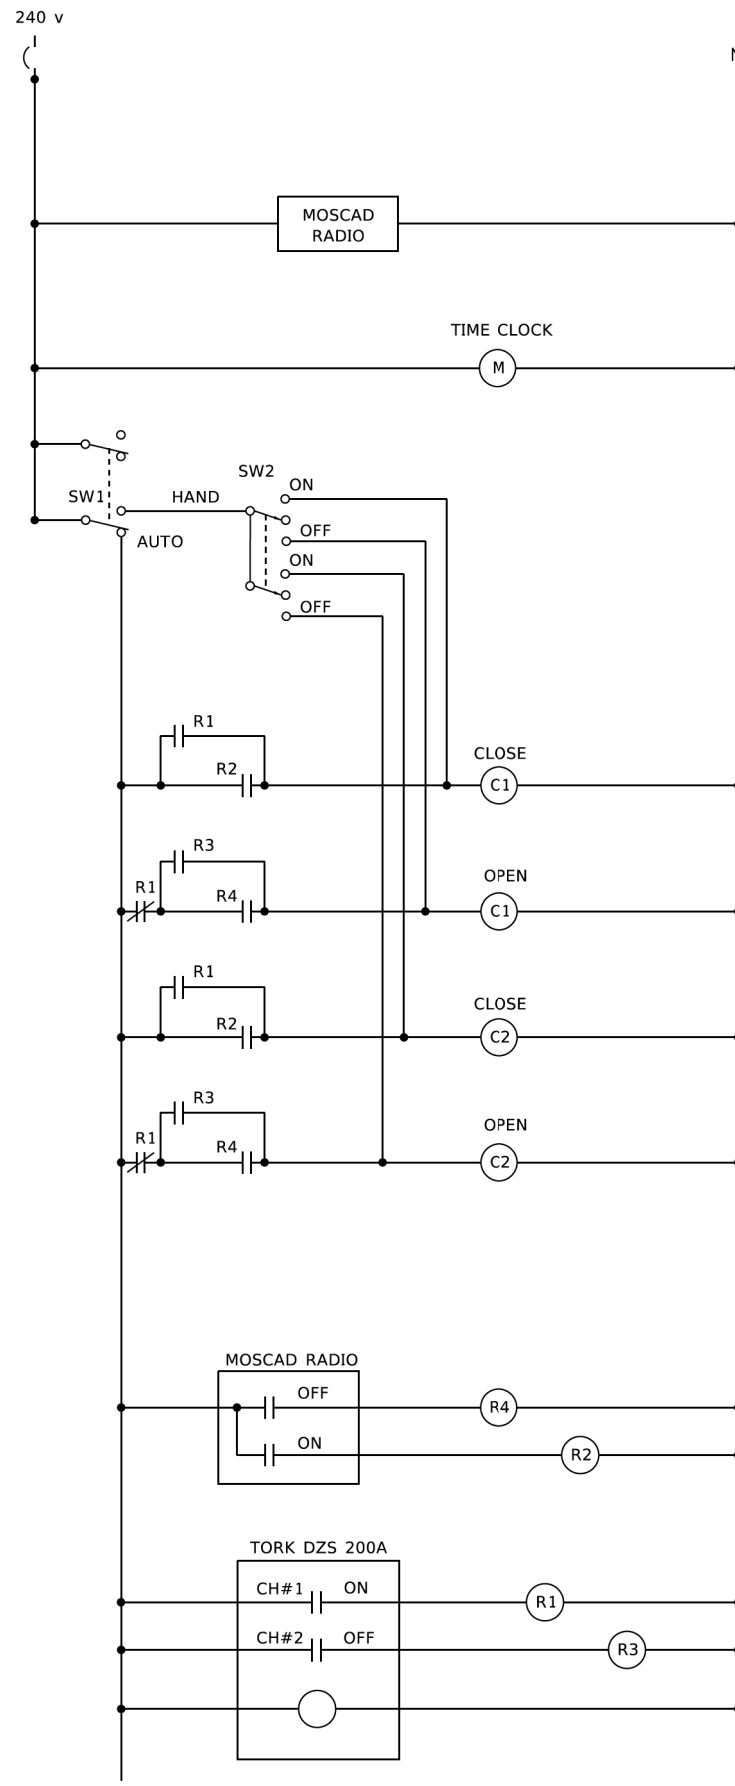

CONTROL CIRCUIT LADDER LOGIC DIAGRAM

MOSCAD I/O ASSIGNMENTS		
TERM	MOSCAD DESTINATION	DESCRIPTION OF INPUT
1	DIGITAL INPUT 1	ALARM KNOWLEDGE
2	DIGITAL INPUT 2	DOOR OPEN
3	DIGITAL INPUT 3	MAIN(S) BREAKER OPEN
4	DIGITAL INPUT 4	CONTACTOR 1 OPEN
5	DIGITAL INPUT 5	CONTACTOR 2 OPEN
6	DIGITAL INPUT 6	CABINET IN NON-AUTO
7	DIGITAL INPUT 7	BACK-UP CLOCK OFF CALL
8	DIGITAL INPUT 8	BACK-UP CLOCK ON CALL
17	24 V+	24+VDC
18	DI COMMON	COMMON
21	K1 C	K1 COMMON
22	K1 NO	LIGHTS ON CALL
24	K2 C	K2 COMMON
25	K2 NO	LIGHTS OFF CALL
32	ANALOG INPUT 1 (+)	CABINET NEUTRAL CURRENT
33	ANALOG INPUT 1 (-)	CABINET NEUTRAL CURRENT
34	ANALOG INPUT 2 (+)	CABINET SERVICE VOLTAGE
35	ANALOG INPUT 2 (-)	CABINET SERVICE VOLTAGE
40	P. GROUND	GROUND

ALL ANALOG INPUTS WILL BE 4-20 MA ONLY. DIGITAL OUTPUT RELAYS WILL BE ELECTRICALLY ENERGIZED AND MOMENTARILY HELD
MIXED I/O MODULE MODEL NUMBER V436

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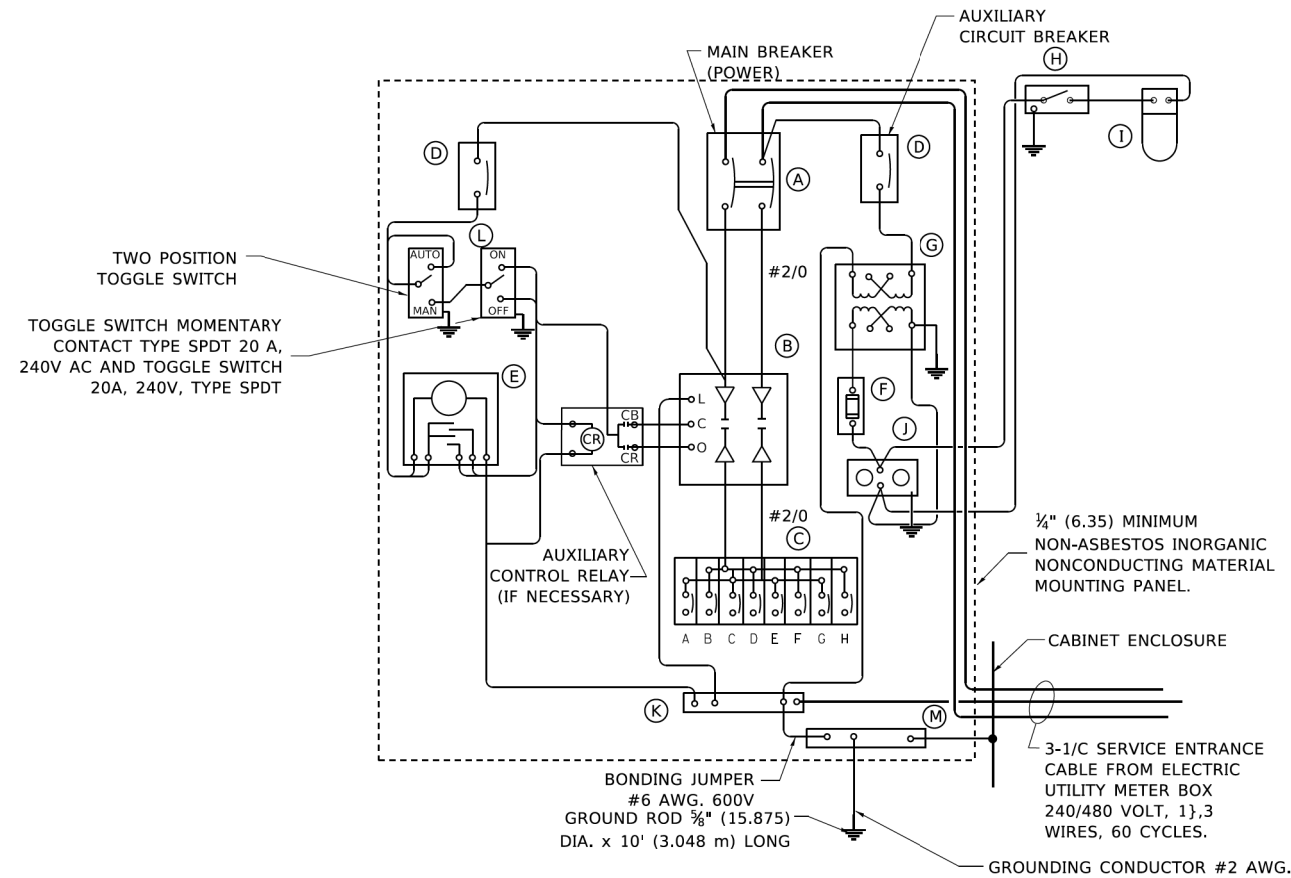
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PLOT DATE = 4/19/2019	DATE -	REVISED - R. TOMSONS 03-29-12

**STATE OF ILLINOIS
DEPARTMENT OF TRANSPORTATION**

**LIGHTING CONTROLLER, BASE MOUNTED,
480VOLT, 200AMP (DUAL) RADIO SCADA**

SCALE: NONE SHEET 4 OF 4 SHEETS STA. TO STA.


F.A. RTE.	SECTION	COUNTY	TOTAL SHEETS	SHEET NO.
0085	19-00511-00-SP	McHENRY	45	39
BE-205		CONTRACT NO. 61J51		
ILLINOIS FED. AID PROJECT				



PANEL WIRING DIAGRAM

PANEL EQUIPMENT

BILL OF MATERIAL		
ITEM	QUANTITY	DESCRIPTION
A	1	MAIN CIRCUIT BREAKER, 2 POLE, 600 VOLT 100 AMP. FRAME, 100 AMP. NON-INTERCHANGEABLE TRIP INTERRUPTING RATING NEMA-22000 AMP. AT 480 VOLT.
B	1	REMOTE CONTROL SWITCH, ELECTRICALLY OPERATED, MECHANICALLY HELD, 2 POLE, SINGLE THROW, 100 AMP., 600 VOLTS CONTROL CIRCUIT 240 VOLT.
C	8	CIRCUIT BREAKERS, 1 POLE, 100AMP. FRAME, 50 AMP. NON-INTERCHANGEABLE TRIP INTERRUPTING RATING NEMA-10,000 AMP. AT 240 V.
D	2	CONTROL CIRCUIT-CIRCUIT BREAKER. 1 POLE, 240 V., 100 AMP. FRAME, 15 AMP. NON-INTERCHANGEABLE TRIP INTERRUPTING RATING NEMA-5000 AMP. AT 240 V.
E	1	ASTRONOMIC MICROPROCESSOR-BASED 2-CHANNEL CONTROLLER (TIME SWITCH).
F	1	20 AMP, 120 VOLT FUSE.
G	1	1.5 KVA, SINGLE PHASE, ENCAPSULATED TRANSFORMER 240 X 480 / 120 X 240 VOLT, 60 Hz.
H	1	SPST 20A SWITCH ON DOOR, TO TURN LIGHT ON WHEN DOOR IS OPEN.
I	1	INCANDESCENT LIGHTING FIXTURE ENCLOSED AND GASKETED WITH 60 WATT, 120 V. LAMP.
J	1	20 AMP, 120 VOLT, DUPLEX RECEPTACLE, GFCI.
K	1	COPPER GROUND BUS 1#4" (6.35) X 1" (25.4) X 12" (304.8 mm) LONG MOUNTED ON PANEL WITH LUGS AND 4 SPARE LUGS
L	1	TOGGLE SWITCHES MOUNTED IN 4" (101.6) X 4" (101.6 mm) BOX.
M	1	COPPER GROUND BUS 1#4" (6.35) X 1" (25.4) X 12" (304.8 mm) LONG MOUNTED ON PANEL WITH LUGS AND SPARE LUGS.

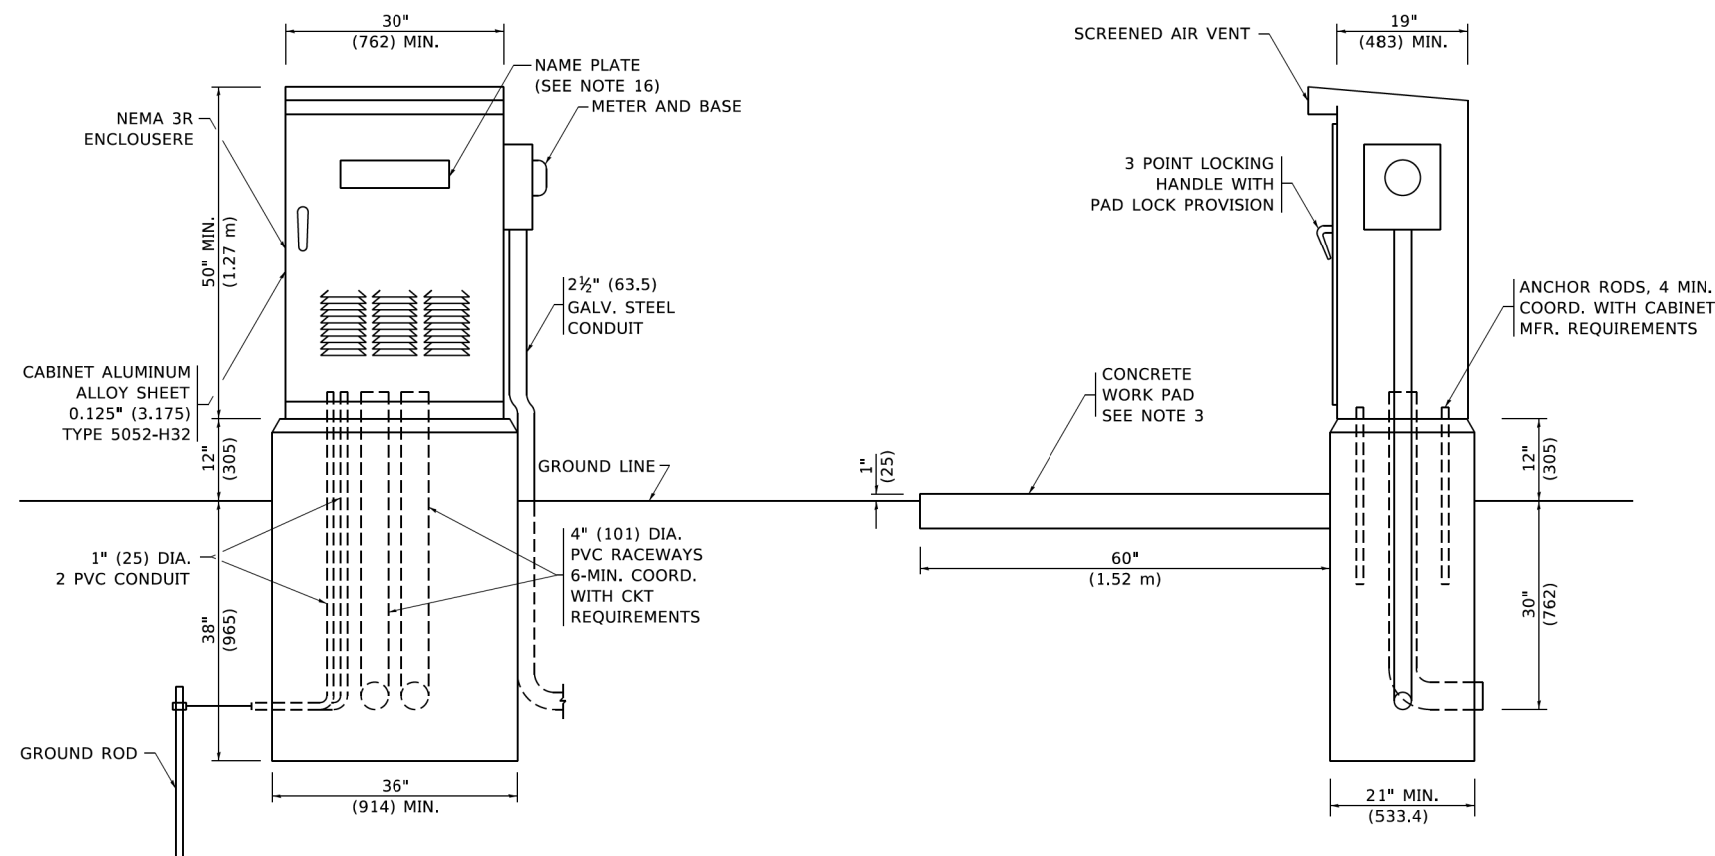

NOTES

- ALL DIMENSIONS ARE IN INCHES (MILLIMETERS) UNLESS OTHERWISE SHOWN.
- FOUNDATION SIZE SHALL BE COORDINATED WITH CABINET SIZE AND MFR.
- IN FRONT OF CONTROL CABINET DOOR, REMOVE VEGETATION AND 2" (50.8 mm) TOP SOIL, LEVEL THE AREA AND ON TOP, PLACE LENGTH WISE PARALLEL TO CONTROL CABINET, A CONCRETE PAD 36" (914.4 mm) x 60" (18.288 m) x 4" (101 mm) MIN. SIZE. THE COST OF LABOR AND MATERIALS ARE INCLUDED IN THE COST OF THE CONTROLLER.
- DOOR SHALL BE CONSTRUCTED FROM SAME TYPE OF MATERIAL AND THICKNESS AS CABINET.
- DOOR SHALL BE EQUIPPED WITH THREE POINT LATCHING MECHANISM WITH NYLON ROLLERS AT TOP THE BOTTOM.
- DOOR HINGE SHALL BE A HEAVY GAUGE CONTINUOUS HINGE WITH A 1#4" (6.35 mm) DIA. STAINLESS STEEL HINGE PIN.
- ALL EXTERNAL HARDWARE SHALL BE STAINLESS STEEL.
- CONTROL WIRING TO BE #12 AWG, 600V, TYPE "SIS" GRAY SWITCH BOARD WIRE, STRANDED COPPER.
- METER BOX SHALL BE MOUNTED ON THE SIDE OF CONTROL CABINET, NEAR TO THE SERVICE POLE.
- CABINETS SHALL BE PRIMED AND PAINTED AS SPECIFIED.
- THE HEADS OF CONNECTORS SCREWS SHALL BE PAINTED WHITE FOR NEUTRAL BAR CONNECTION AND GREEN FOR GROUND BAR CONNECTORS.
- ALL WIRING WITHIN THE CABINET SHALL BE COLOR CODED AS INDICATED.
R = RED BL = BLUE = WHITE
B = BLACK Y = YELLOW G = GREEN
- PROVIDE SEALING GROMMETS FOR ALL OPEN WIRING EXTENDED FROM DEVICES IN BOXES OR CABINETS WITHIN THE CONTROL CABINET.
- ALL WIRING SHALL BE NEATLY DRESSED AND SUPPORTED.
- THE CONTROLLER SHALL BE CONSTRUCTED TO U.L. STD. 508 AND BEAR THE U.L. LABEL "ENCLOSED INDUSTRIAL CONTROL PANEL".
- 12" (304.8) X 16" (406.4 mm) STAINLESS STEEL EXTERIOR NAMEPLATE SHALL BE ENGRAVED TO "STATE OF ILLINOIS LIGHTING CONTROLS" UNLESS OTHERWISE SPECIFIED.

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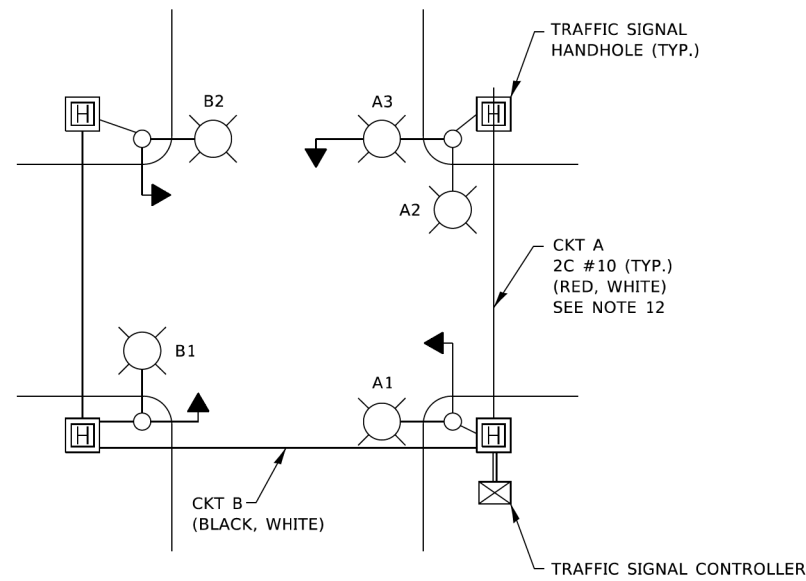
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PLOT DATE = 4/19/2019	DATE -	REVISED -

**STATE OF ILLINOIS
DEPARTMENT OF TRANSPORTATION**



**LIGHTING CONTROLLER
SINGLE DOOR**

SCALE: NONE SHEET 1 OF 1 SHEETS STA. TO STA.

F.A. RTE.	SECTION	COUNTY	TOTAL SHEETS	SHEET NO.
0085	19-00511-00-SP	McHENRY	45	40
BE-215		CONTRACT NO. 61J51		
ILLINOIS FED. AID PROJECT				



TYPICAL LIGHTING CIRCUIT
(NOT TO SCALE)

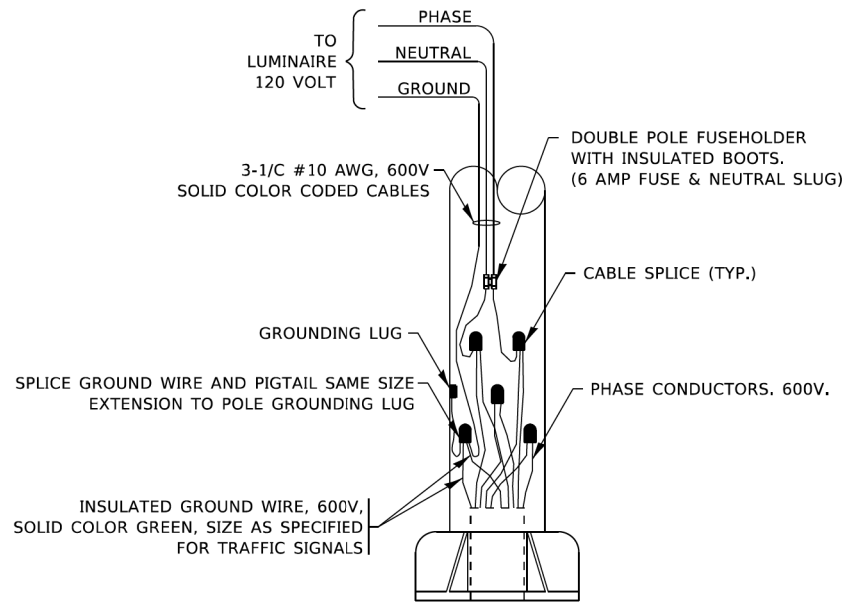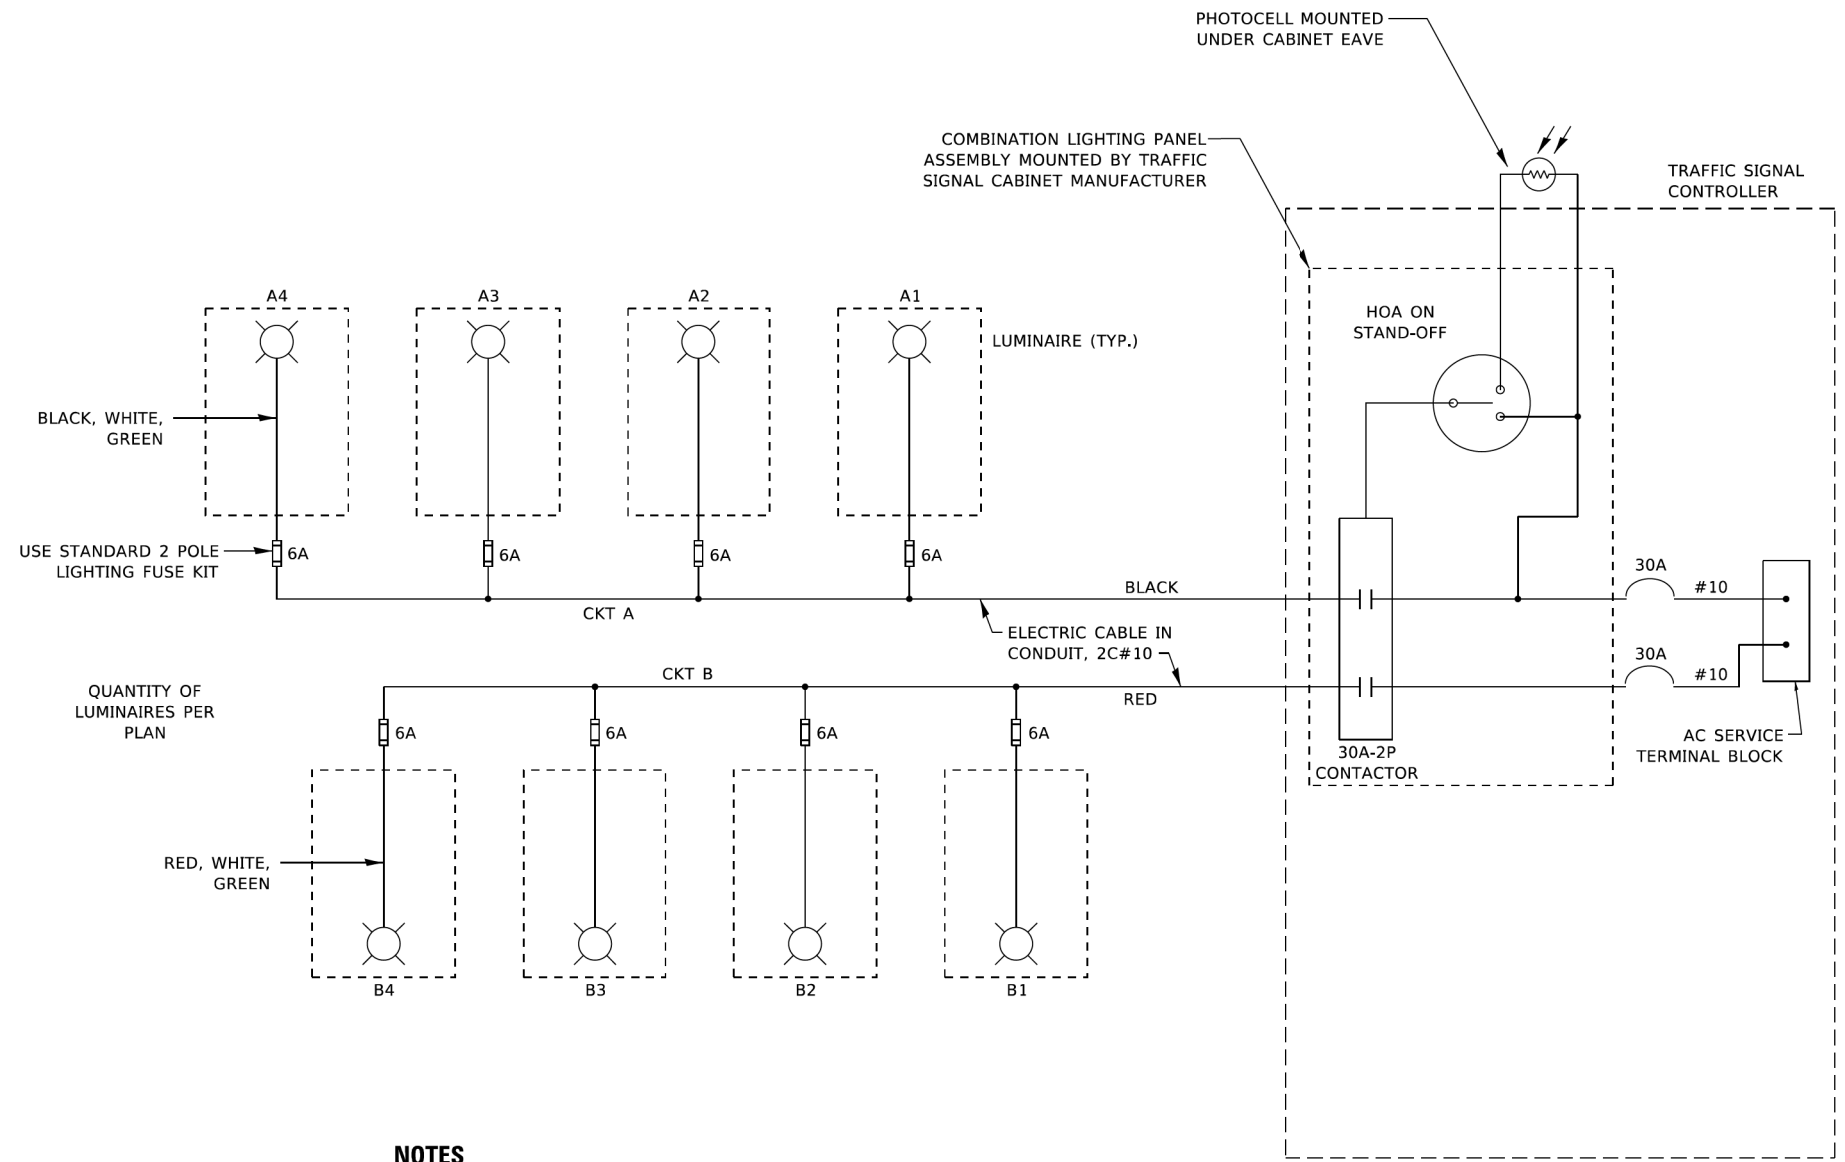

COMBINATION POLE WIRING DETAIL
(NOT TO SCALE)

- NOTES**
1. 4 LUMINAIRES PER CIRCUIT, MAXIMUM.
 2. TWO #10 (XLP-TYPE USE) CABLES TO BE USED FOR LIGHTING CIRCUITS.
 3. ROUTE LIGHTING CIRCUITS IN TRAFFIC SIGNAL CONDUIT SYSTEM.
 4. ALL SPLICES AND CONNECTIONS FOR ROADWAY LIGHTING SHALL BE AT POLE BASE ONLY.
 5. FOR LIGHTING CIRCUITS, CONNECT TWO CIRCUIT BREAKERS TO AC SERVICE TERMINAL BLOCK.
 6. ALL WIRING SHALL BE NEATLY DRESSED, IDENTIFIED BY TAGS, AND SUPPORTED. (UNDERGROUND SPLICING OF LIGHTING CONDUCTORS IS NOT PERMITTED).
 7. THE H.O.A. SWITCH SHALL BE LABELED AS "LIGHTING CONTROL" WITH THE POSITIONS "AUTO", "OFF" AND "TEST" WITH ENGRAVED NAME PLATES.
 8. LIGHTING CONNECTED TO UPS BYPASS CIRCUIT.
 9. COMBINATION LIGHTING MUST BE INSTALLED PRIOR TO SIGNAL TURN ON.
 10. LUMINAIRE VOLTAGE SHALL BE 120V
 11. POLE WIRING & FUSE KITS ARE INCLUDED IN THE LUMINAIRE PAY ITEM.
 12. THE UNDERGROUND EQUIPMENT GROUND WIRE IS SHOWN IN THE TRAFFIC SIGNAL PLANS AND IS INCLUDED IN THE SIGNAL PLANS. IT IS SHARED GROUND BETWEEN SIGNALS AND LIGHTING.


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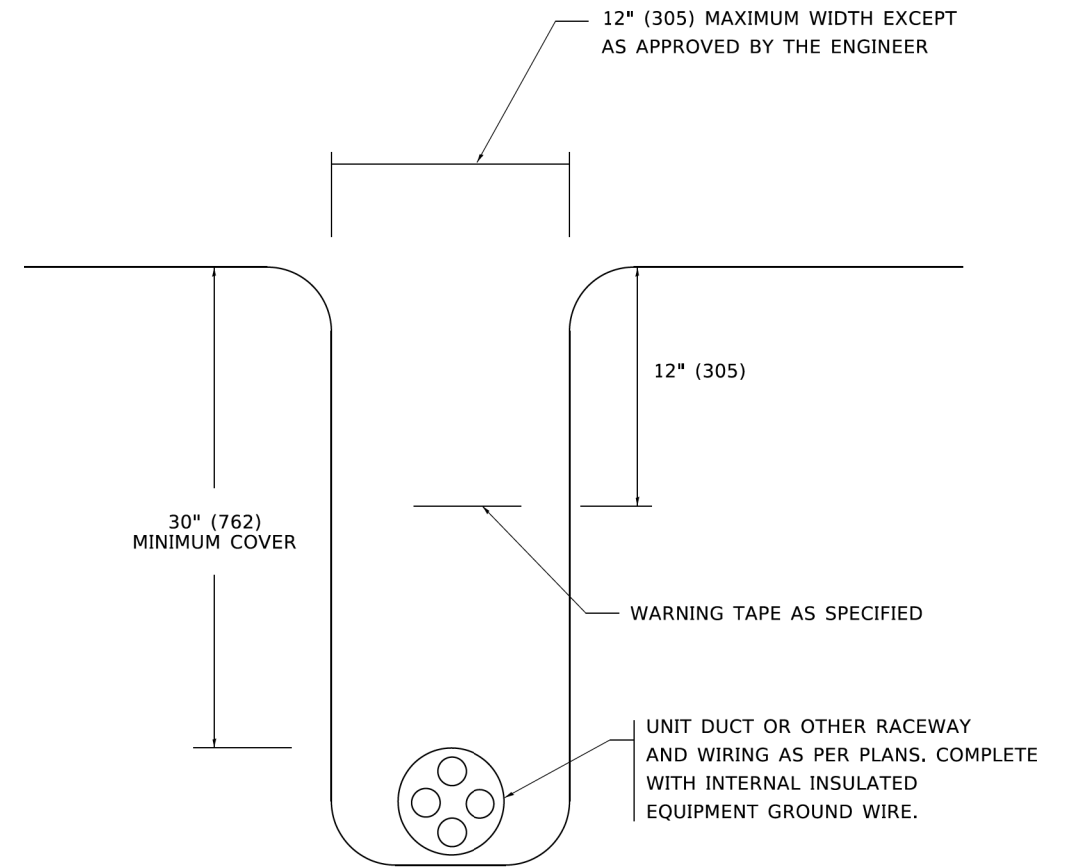
**STATE OF ILLINOIS
DEPARTMENT OF TRANSPORTATION**

COMBINATION LIGHTING, TRAFFIC SIGNAL SCHEMATIC
SCALE: NONE SHEET 1 OF 1 SHEETS STA. TO STA.


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BE-240		CONTRACT NO. 61J51		
ILLINOIS FED. AID PROJECT				



TYPICAL SPLICE DETAIL
N.T.S.

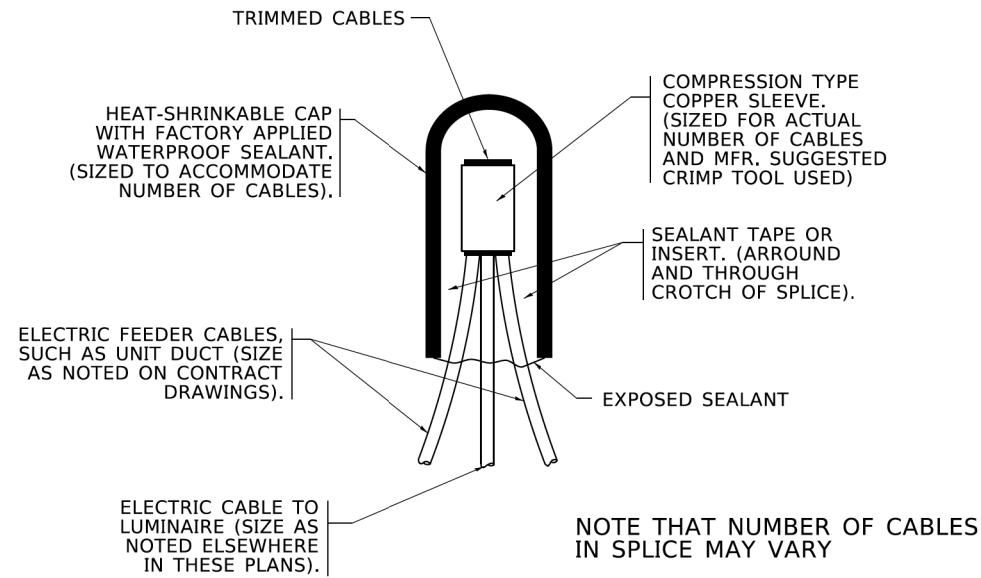

TYPICAL WIRING IN TRENCH DETAIL
N.T.S.

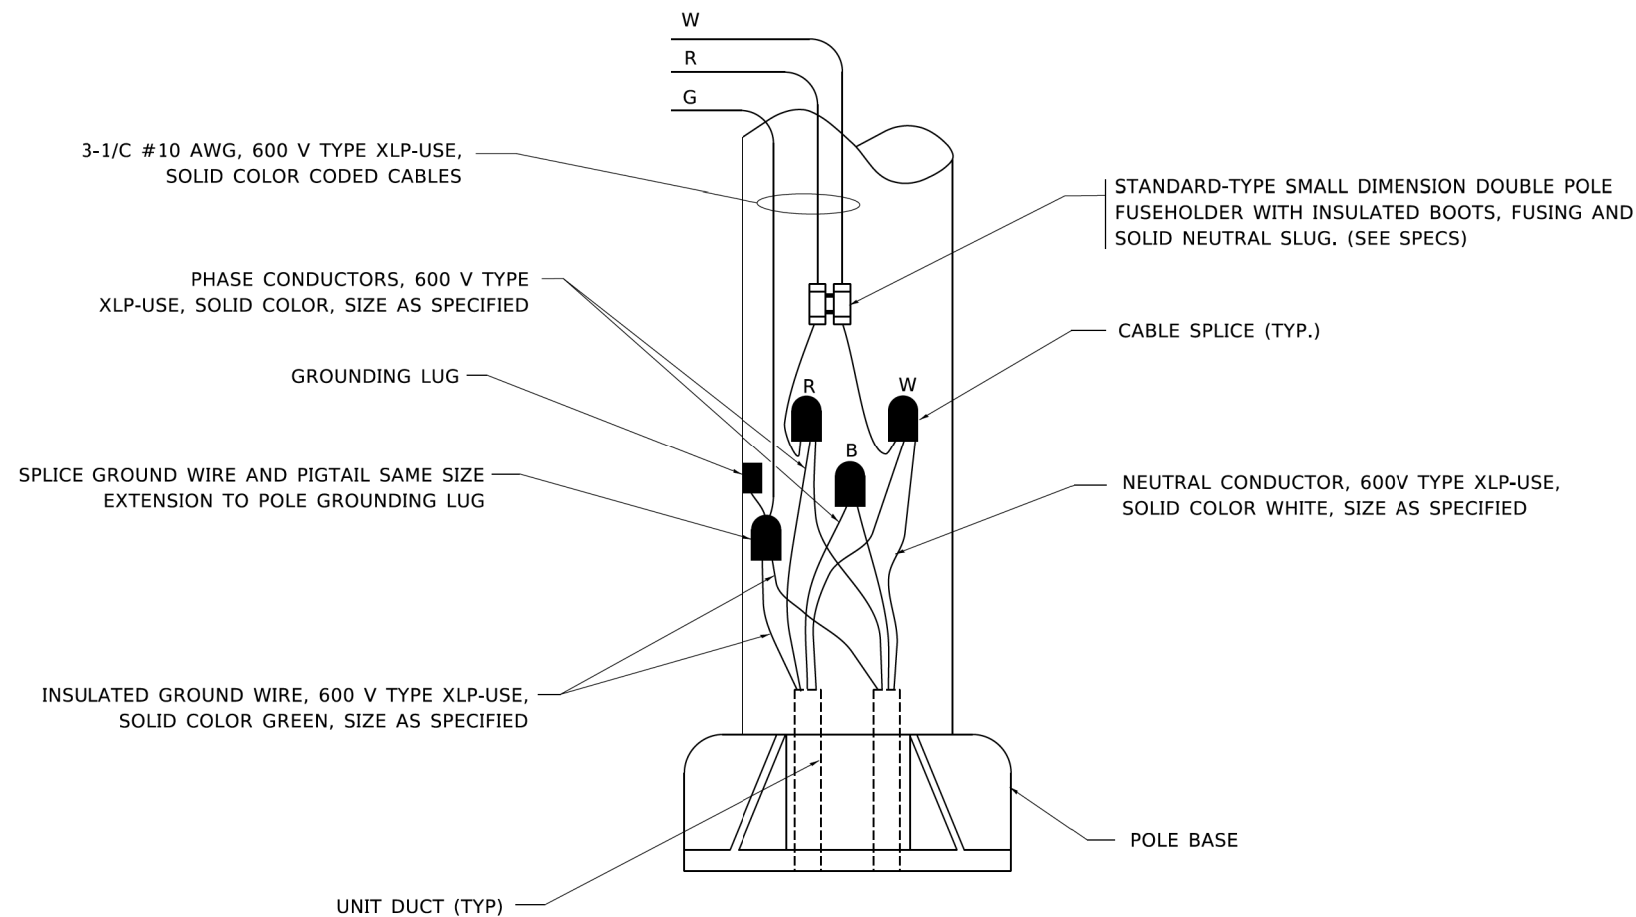

POLE WIRING DETAIL
N.T.S.

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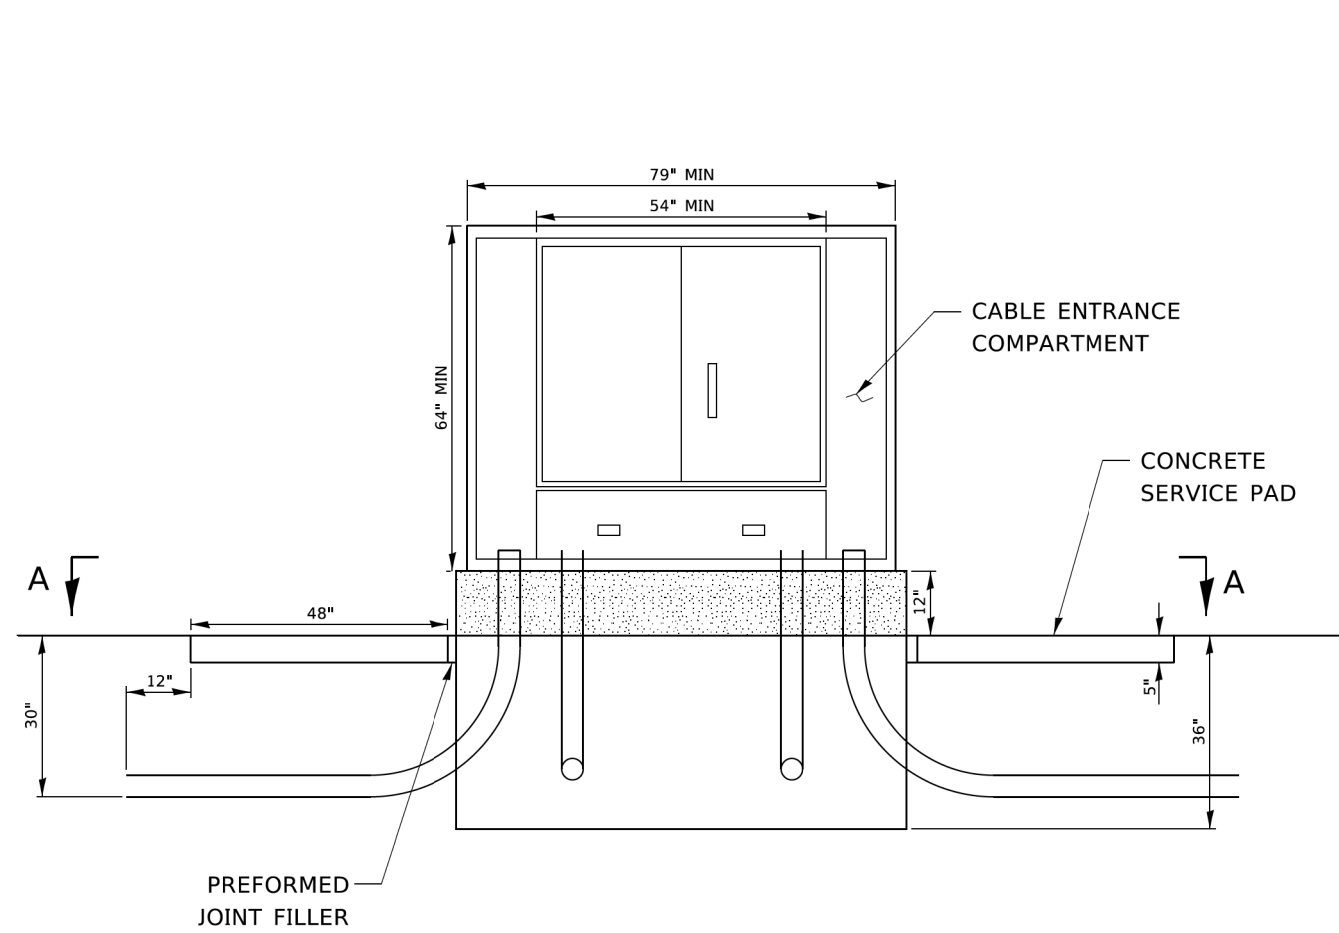
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STATE OF ILLINOIS
DEPARTMENT OF TRANSPORTATION


MISC. ELECTRICAL DETAILS
SHEET A

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0085	19-00511-00-SP	McHENRY	45	42
BE-702			CONTRACT NO. 61J51	
ILLINOIS FED. AID PROJECT				



ELEVATION VIEW

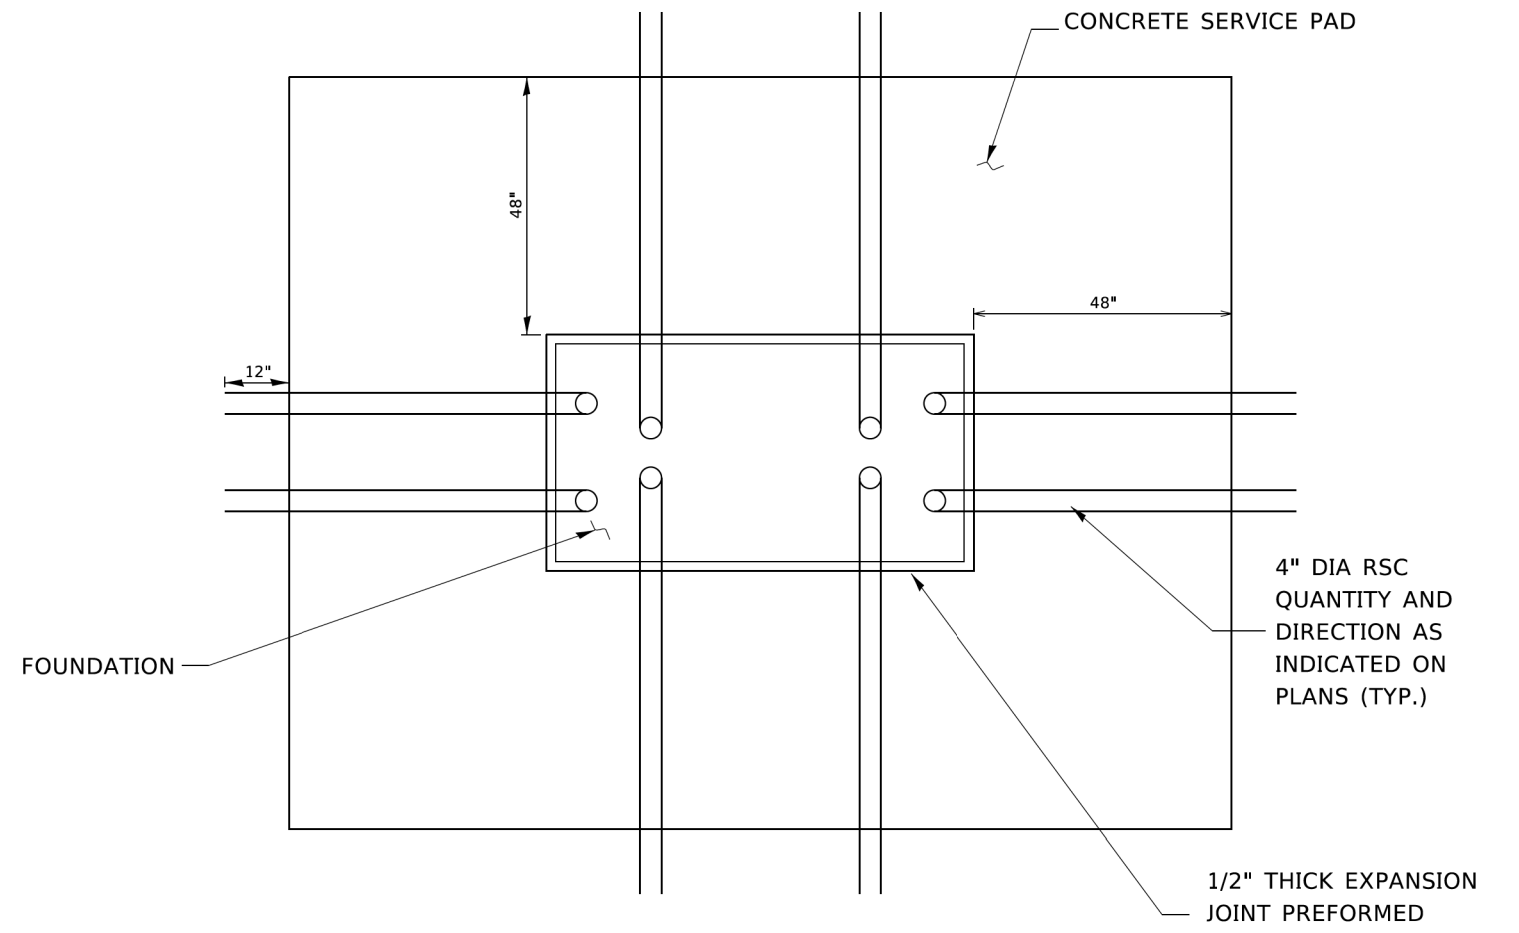

SECTION A-A

NOTES:

CABINET:
ALUMINUM 5052-H32

HARDWARE:
TYPE 304 STAINLESS STEEL

FINISH:
POLYESTER POWDER COATED GRAY

RACKS:
3/16" STEEL E.I.A. / T.I.A. SPACING (10-32 THREADS)

DOORS:
3 POINT LATCH, LATCH CONTROL SWITCH, PIANO HINGE, WIND STOP

CABLE ENTRANCE COMPARTMENT:
FOUR SLACK STORAGE BRACKETS WITH HEAVY DUTY VELCRO STRAPS TO SECURE CABLES,
TWO ENTRY HOLES FOR BRINGING CABLES INTO THE MAIN CABINET

MAIN CABINET:
2-9"-23" ADJUSTABLE WIDTH RACKS, ADJUSTABLE FRONT TO REAR POSITION (43" TALL)
2-19"-23" ADJUSTABLE WIDTH RACKS, SWING OUT (40" TALL)
166" OF TOTAL INCHES OF RACK SPACE (95 RU)
4-15" WATT SHATTER-SHIELD LIGHT FIXTURES

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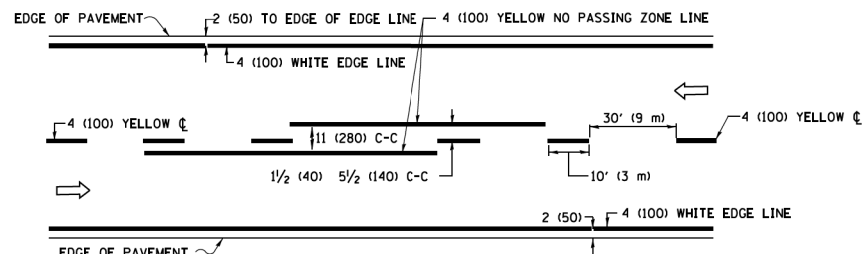
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**STATE OF ILLINOIS
DEPARTMENT OF TRANSPORTATION**


FIBER OPTIC INTERCONNECT CABINET

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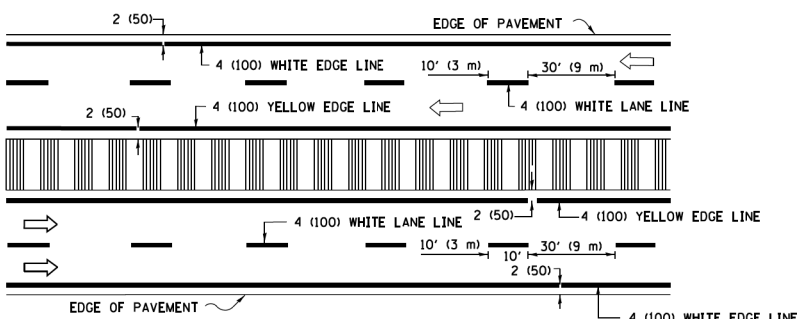
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ILLINOIS FED. AID PROJECT				



2-LANE ROADWAY

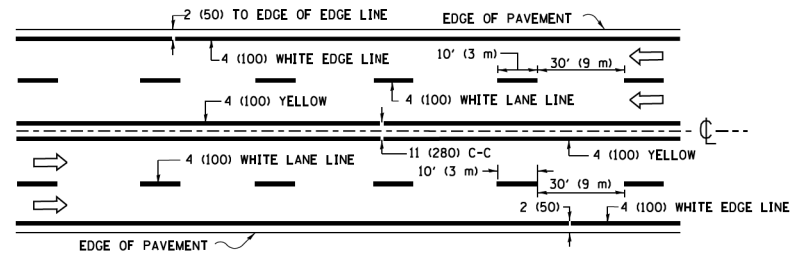


MULTI-LANE UNDIVIDED




MULTI-LANE DIVIDED WITH MEDIAN

TYPICAL LANE AND EDGE LINE MARKING

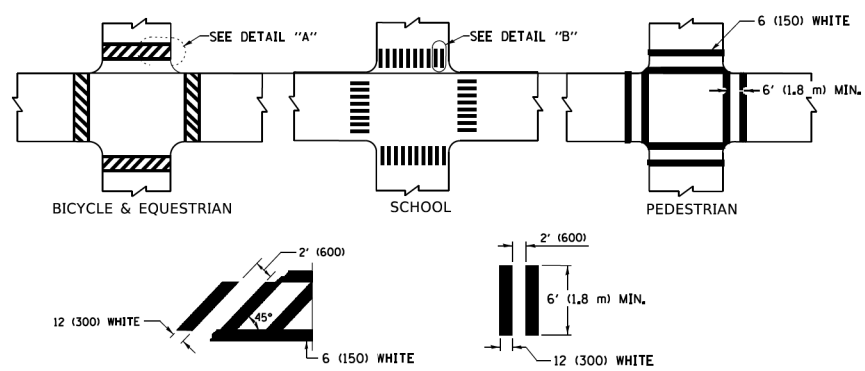


TYPICAL CROSSWALK MARKING


* MARKINGS SHALL BE INSTALLED PARALLEL TO THE CENTERLINE OF THE ROAD WHICH IT CROSSES

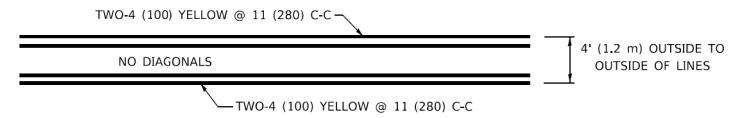


4' (1.2 m) WIDE MEDIANS ONLY

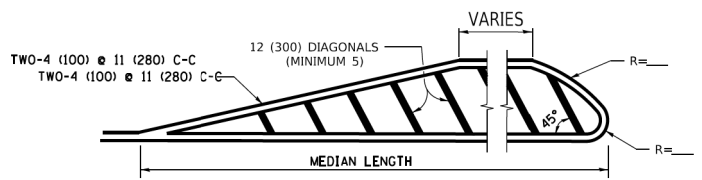

MEDIANS OVER 4' (1.2 m) WIDE

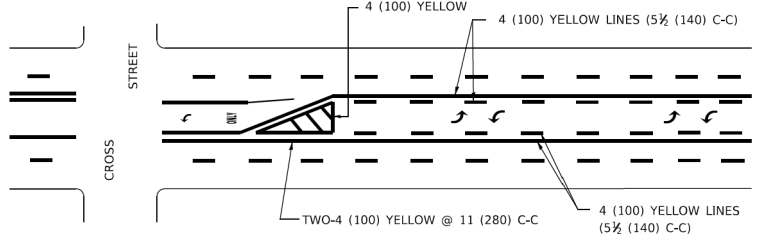


MEDIAN WITH TWO-WAY LEFT TURN LANE TYPICAL PAINTED MEDIAN MARKING

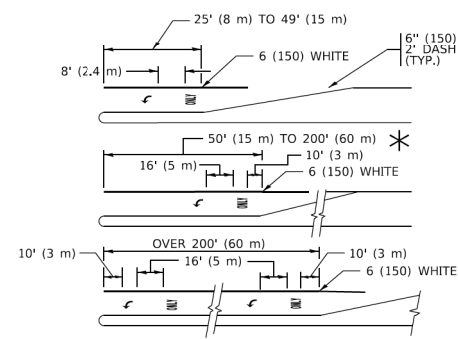


TYPICAL LEFT (OR RIGHT) TURN LANE

TYPICAL TURN LANE MARKING

FULL SIZE LETTERS 8' (2.4 m) AND ARROWS SHALL BE USED.
 AREA = 15.6 SQ. FT. (1.5 m²) ONLY AREA = 20.8 SQ. FT. (1.9 m²)
 * TURN LANES IN EXCESS OF 400' (120 m) IN LENGTH MAY HAVE AN ADDITIONAL SET OF ARROW - "ONLY" INSTALLED MIDWAY BETWEEN THE OTHER TWO SETS OF ARROW - "ONLY".

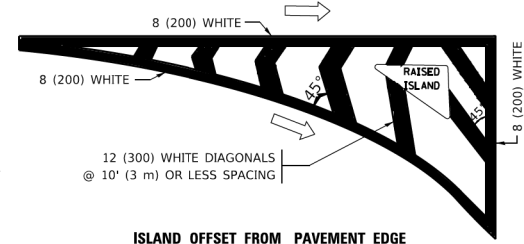


ISLAND OFFSET FROM PAVEMENT EDGE

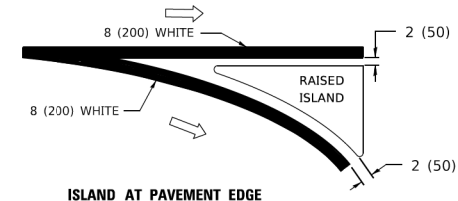


ISLAND AT PAVEMENT EDGE

TYPICAL ISLAND MARKING

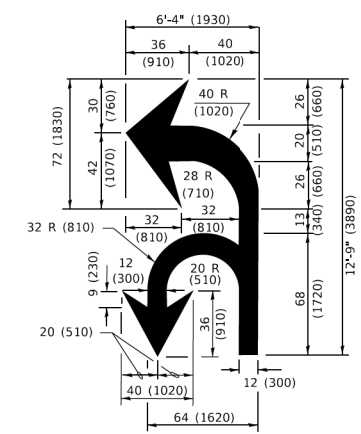

COMBINATION LEFT AND U-TURN

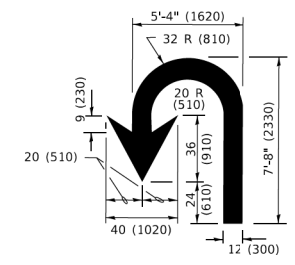

U-TURN

LANE REDUCTION TRANSITION
 * LANE REDUCTION ARROWS REQUIRED AT SPEEDS OF 45 MPH OR GREATER OR WHEN SPECIFIED IN PLANS.

D(FT)	SPEED LIMIT
345	30
425	35
500	40
580	45
665	50
750	55

TYPE OF MARKING	WIDTH OF LINE	PATTERN	COLOR	SPACING / REMARKS
CENTERLINE ON 2 LANE PAVEMENT	4 (100)	SKIP-DASH	YELLOW	10' (3 m) LINE WITH 30' (9 m) SPACE
CENTERLINE ON MULTI-LANE UNDIVIDED PAVEMENT	2 @ 4 (100)	SOLID	YELLOW	11 (280) C-C
NO PASSING ZONE LINES: FOR ONE DIRECTION FOR BOTH DIRECTIONS	4 (100) 2 @ 4 (100)	SOLID SOLID	YELLOW YELLOW	5 1/2 (140) C-C FROM SKIP-DASH CENTERLINE 11 (280) C-C OMIT SKIP-DASH CENTERLINE BETWEEN
LANE LINES	4 (100) 5 (125) ON FREEWAYS	SKIP-DASH SKIP-DASH	WHITE WHITE	10' (3 m) LINE WITH 30' (9 m) SPACE
DOTTED LINES (EXTENSIONS OF CENTER, LANE OR TURN LANE MARKINGS)	SAME AS LINE BEING EXTENDED	SKIP-DASH	SAME AS LINE BEING EXTENDED	2' (600) LINE WITH 6' (1.8 m) SPACE
EDGE LINES	4 (100)	SOLID	YELLOW-LEFT WHITE-RIGHT	OUTLINE MEDIANS IN YELLOW
TURN LANE MARKINGS	6 (150) LINE; FULL SIZE LETTERS & SYMBOLS (8' (2.4m))	SOLID	WHITE	SEE TYPICAL TURN LANE MARKING DETAIL
TWO WAY LEFT TURN MARKING	2 @ 4 (100) EACH DIRECTION 8' (2.4m) LEFT ARROW	SKIP-DASH AND SOLID IN PAIRS	YELLOW WHITE	10' (3 m) LINE WITH 30' (9 m) SPACE FOR SKIP-DASH; 5 1/2 (140) C-C BETWEEN SOLID LINE AND SKIP-DASH LINE SEE TYPICAL TWO-WAY LEFT TURN MARKING DETAIL
CROSSWALK LINES (PEDESTRIAN) A. DIAGONALS (BIKE & EQUESTRIAN) B. LONGITUDINAL BARS (SCHOOL)	2 @ 6 (150) 2' (600) APART 2' (600) APART	SOLID SOLID SOLID	WHITE WHITE WHITE	NOT LESS THAN 6' (1.8 m) APART SEE TYPICAL CROSSWALK MARKING DETAILS.
STOP LINES	24 (600)	SOLID	WHITE	PLACE 4' (1.2 m) IN ADVANCE OF AND PARALLEL TO CROSSWALK, IF PRESENT. OTHERWISE, PLACE AT DESIRED STOPPING POINT. PARALLEL TO CROSSROAD CENTERLINE, WHERE POSSIBLE.
PAINTED MEDIANS	2 @ 4 (100) WITH 12 (300) DIAGONALS @ 45° NO DIAGONALS USED FOR 4' (1.2 m) WIDE MEDIANS	SOLID	YELLOW: TWO WAY TRAFFIC WHITE: ONE WAY TRAFFIC	11 (280) C-C FOR THE DOUBLE LINE SEE TYPICAL PAINTED MEDIAN MARKING.
GORE MARKING AND CHANNELIZING LINES	8 (200) WITH 12 (300) DIAGONALS @ 45°	SOLID	WHITE	DIAGONALS: 15' (4.5 m) C-C (LESS THAN 30MPH (50 km/h)) 20' (6 m) C-C (30 MPH (50 km/h) TO 45MPH (70 km/h)) 30' (9 m) C-C (OVER 45MPH (70 km/h))
RAILROAD CROSSING	24 (600) TRANSVERSE LINES: "RR" 15' 6" (1.8 m) LETTERS; 16 (400) LINE FOR "X"	SOLID	WHITE	SEE STATE STANDARD 780001 AREA OF: "R"=3.6 SQ. FT. (0.33 m ²) EACH "X"=54.0 SQ. FT. (5.0 m ²)
SHOULDER DIAGONALS (REQUIRED FOR SHOULDERS > 8')	12 (300) @ 45°	SOLID	WHITE - RIGHT YELLOW - LEFT	50' (15 m) C-C (LESS THAN 30MPH (50 km/h)) 75' (25 m) C-C (30 MPH (50 km/h) TO 45MPH (70 km/h)) 150' (45 m) C-C (OVER 45MPH (70 km/h))
U TURN ARROW	SEE DETAIL	SOLID	WHITE	16.3 SF
2 ARROW COMBINATION LEFT AND U TURN	SEE DETAIL	SOLID	WHITE	30.4 SF

FOR FURTHER DETAILS ON PAVEMENT MARKING REFER TO STANDARD SPECIFICATIONS FOR ROAD AND BRIDGE CONSTRUCTION AND STATE STANDARD 780001.

All dimensions are in inches (millimeters) unless otherwise shown.

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PLOT SCALE = 50.0000" / 1"	CHECKED -	REVISED - C. JUCIUS 07-01-13
PLOT DATE = 3/4/2019	DATE - 03-19-90	REVISED - C. JUCIUS 12-21-15
		REVISED - C. JUCIUS 04-12-16

**STATE OF ILLINOIS
DEPARTMENT OF TRANSPORTATION**

DISTRICT ONE		F.A. RTE.	SECTION	COUNTY	TOTAL SHEETS	SHEET NO.
TYPICAL PAVEMENT MARKINGS		0085	19-00511-00-SP	McHENRY	45	44
SCALE: NONE		SHEET 1 OF 2 SHEETS		STA. TO STA.	CONTRACT NO. 61J51	
		ILLINOIS		FED. AID PROJECT		

