

COUNTY

TAZEWELL 1366 1

# **PACKAGING SET**

DESCRIPTION SHEET NO.

> **COVER SHEET** INDEX OF SHEETS

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8-10 **GENERAL NOTES MASTER SUMMARY OF QUANTITIES** 11-24

MASTER EARTHWORK & RUMBLE STRIP SCHEDULES

URS CORPORATION







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> DAILY & ASSOCIATES ENGINEERS, INC. PEORIA. ILLINOIS

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NAME

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> > DRAWN BY

DATE 02/14/2005

COUNTY TOTAL SHEET SHEETS NO.

TAZEWELL 1366 2

TO STA.

FED. ROAD DIST. NO. 4 ILLINOIS FED. AID PROJECT

SECTION

\* (90-11)R-2;90(13,14,14-1)R-1

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# | F.A.I. | SECTION | COUNTY | SHEETS | NO. | 74 | \* | TAZEWELL | 1366 | 3 STA. TO STA. FED. ROAD DIST. NO. 4 ILLINOIS FED. AID PROJECT

\* (90-11)R-2;90(13,14,14-1)R-1

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SHEET	NO.	DESCRIPTION
89	•	COVER SHEET
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	7-055 0-902	F.A.I. ROUTE (I-74) TOTAL BILL OF MATERIALS - PLAN SET #3 (FOR INFORMATION ONLY)
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90		STATUS OF UTILITIES TO BE ADJUSTED WASHINGTON STREET
	, 5–918	F.A.I. ROUTE 74 (1–74) TYPICAL SECTION MAINLINE & RAMPS L–3 & L–4
	9-922	TYPICAL SECTION SHEETS - WASHINGTON STREET
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93		ALIGNMENTS, TIES & BENCH MARK WASHINGTON STREET
	2–933	SCHEMATIC DRAWING F.A.I. ROUTE 74 (I–74) MAINLINE
	4-935	SCHEMATIC DRAWING WASHINGTON STREET
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93	7	MAINTENANCE OF TRAFFIC SCHEMATIC DRAWING MAINLINE PRE-STAGE 3
93	8	MAINTENANCE OF TRAFFIC SCHEMATIC DRAWING MAINLINE STAGE 3A
93	9945	MAINTENANCE OF TRAFFIC PLANS MAINLINE STAGE 3A
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95	3-958	MAINTENANCE OF TRAFFIC PLANS MAINLINE STAGE 3B
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	2–974	MAINTENANCE OF TRAFFICE PLANS WASHINGTON STREET STAGE 3-1
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	6-978	CONCEPTUAL TEMPORARY INFORMATION SIGNING PLANS WASHINGTON STREET STAGE 3B-2
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	8-991	ROADWAY PLAN F.A.I. ROUTE 74 (1-74) PLAN RAMPS L-1, L-2, L-3 AND L-4
	2-997	ROADWAY PLAN WASHINGTON STREET
	8-999	F.A.I. ROUTE 74 (I–74) ROADWAY PROFILE MAINLINE
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101	12-1013	DRAINAGE & UTILITIES PLANS F.A.I. ROUTE 74 (I–74) RAMPS L–1 AND L–2
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101	16-1021	
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10		INTERSECTION DETAIL RAMPS L-1 AAND L-2 AT WASHINGTON STREET
10:		INTERSECTION DETAIL WASHINGTON STREET AT 1–74
10:		INTERSECTION DETAIL RAMPS L-3 AND L-4 AT WASHINGTON STREET
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10		RAMP L-3 GORE DETAILS F.A.I. 74 (1-74)
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SHEET NO.	DESCRIPTION
1043	BRIDGE APPROACH PAVEMENT (SPECIAL) DETAIL I-74 BRIDGE OVER WAHINGTON STREET S.N. 090-0163 (WB)
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1047-1049	DRAINAGE DETAIL TYPE A GUTTER (MODIFIED) (INLET, OUTLET & INLETS, SPECIAL)
1050	DRAINAGE DETAIL OUTLET TYPE 1 (MODIFIED) FOR TYPE A GUTTER (MODIFIED)
1051-1052	DRAINAGE DETAIL INLETS, SPECIAL (MODIFIED)
1053	DRAINAGE DETAIL MANHOLES, SPECIAL, 1.2 m DIAMETER STA.153 + 933.720 (W.B. I-74)
1054	DRAINAGE DETAIL ARTICULATED BLOCK MATS
1055	DRAINAGE DETAIL BENCH DRAINS
1056	MISCELLANEOUS DETAIL SUPER ELEVATION TABLES – RAMP L–4
1057	MISCELLANEOUS DETAIL SUPER ELEVATION TABLES – RAMP L–3
1058	MISCELLANEOUS DETAIL UNDERCUT DETAIL F.A.I. ROUTE 74 (W.B. I–74) – MAINLINE AND RAMPS
1059	MISCELLANEOUS DETAIL PIPE CULVERT (1650mm) EXTENSION COLLAR (WITHOUT END SECTION)
1060	MISCELLANEOUS DETAIL CONCRETE BARRIER DETAILS RAMP L-3 & L-4
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1063	TEMPORARY EROSION CONTROL WASHINGTON STREET
1064-1080	
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1179–1195	CROSS SECTION WASHINGTON STREET

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INDEX OF SHEETS,

HIGHWAY STANDARDS,

COMMITMENTS AND

GENERAL NOTES

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DATE 02/14/2005 CHECKED BY

• (90-11)R-2;90(13,14,14-1)R-1

# DS7 SET 3 OF 4

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1196	1	Cover Sheet
1197	2	Index of Sheets. Highway Standards
1198–1200	3-5	Set 3 Total Bill of Materials
1201	MCL 1	Advance Construction Signing
1202-1205	MCL 2-5	Temporary Striping Details
1206	MCL 6	Advance Construction Signing
1207-1210	MCL 7-10	Permanent Striping Details
1211	L 1	Index of General Electrical and Construction Notes
1212	L 2	Bill of Materials
1213	L 3	Electrical Legend
1214	L 4	Lighting Criteria
1215	L 5	Pole and Luminaire Schedule
1216-1220	L 6-10	Proposed Lighting Plan W.B. I-74, Sta. 152 + 400 to Sta. 154 + 500
1221–1222	L 11–12	Proposed Lighting Plan N. Main St. Sta. 2+000 to Sta. 2+847
1223	L 13	Bridge Lighting Plan - Ramp K-2 Over N. Main St.
1224–1225	L 14–15	Bridge Lighting Plan — W.B. I–74 Over N. Main St.
1226	L 16	Bridge Lighting Plan — Ramp K–2 Over Ramp J–3
1227	L 17	Bridge Lighting Plan – W.B. I–74 Over Camp St.
1228–1229	L 18–19	Bridge Lighting Plan – W.B. I–74 Over Washington St.
1230–1231	L 20-21	Wiring Plan, W.B. I-74
1232	L 22	Wiring Plan, N. Main St.
1233	L 23	Lighting Controllers "M" & "W" Wiring and Details
1234	L 24	Lighting Controller "A" Wiring and Details
1235–1236	L 25–26	Lighting Removal Plan, W.B. I–74 Sta. 152 + 400 to Sta. 154 + 800
1237	L 27	Lighting Removal Plan, N. Main St. North of I—74
1238	L 28	Electric Service Installation and Trench Detail
1239	L 29	Proposed Lighting Controller Wiring and Details, Type CB-RCS-200
1240	L 30	Lighting Details
1241-1242	L 31–32	Miscellaneous Lighting Details
1243	L 33	Miscellaneous Underpass Lighting Details
1244	L 34	Miscellaneous High Mast Pole and Luminaire Details
1245	L 35	Light Tower Foundation (Type 2 In–Field)
1246	L 36	Light Tower Foundation Notes and Anchor Bolt Details
1247-1251	L 37-41	Light Tower Soil Borings
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1266	S 15	Bill of Materials — Ground Mounted Sign (Removals)
1267-1268	S 16-17	Bill of Materials — Ground Mounted Signs (Proposed)
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1271	S 20	Bill of Materials—Overhead Signs
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1293-1302	S 42-51	Guide Sign Panel Details and Regulatory and Warning Sign Details
1303–1313	S 52-62	Overhead Sign Structures
1314–1323	S 63-72	Cantilever Sign Structures
1324	S 73	Soil Boring Logs
1325	S 74	Sign—Support, Parapet Mounted, Type 1

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1328	ITS 3	Bill of Materials
1329	ITS 4	Legend
1330	ITS 5	System Component Location Map
1331	ITS 6	Microwave Detector Subsystem MDS-I-74-01B (Sta. 152 + 725) Microwave Detector Station Site Layout
1332	ITS 7	Microwave Detector Mounting Details
1333	ITS 8	Microwave Detector Installation Details
1334	ITS 9	Nonintrusive Detector Pole Foundation Detail
1335	ITS 10	Highway–Rail Information Warning Sign Subsystem HRI–MN(EP)–03 (Main St. North) Highway–Rail Information Sign Site Layout
1336	ITS 11	Highway-Rail Information Sign Installation Detail
1337	ITS 12	Equipment Cabinet Details
1338	ITS 13	ITS Component Identification Plaque

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1349	11	Maintenance of Traffic
1350-1358	12-20	Roadway Plans
1359	21	Pavement Marking Plan
1360	22	Pavement Overlay Under Structure Detail
1361	23	Class B Patches (Special) Detail
1362	24	Butt Joint (Special) Detail
1363-1366	2528	District CADD Standards

			6	8201
F.A.I. RTE.	SECTION	COUNTY	TOTAL SHEETS	SHEET NO.
74	•	TAZEWELL	1366	5
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\* (90-11)R-2;90(13,14,14-1)R-1

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# HIGHWAY STANDARDS

HIGHWAY
STANDARD
NUMBER

# TITLE

BRIDGE APPROACH PAVEMENT (DRAIN DETAIL)

SHOULDER WIDENING FOR TYPE 1 (SPECIAL) GUARDRAIL TERMINALS

SHOULDER INLET WITH CURB

STEEL PLATE BEAM GUARDRAIL

 			·	20701
F.A.I. RTE.	SECTION	COUNTY	TOTAL	
74	•	TAZEWELL	1366	6
STA.		TO STA.		
FED. RO	AD DIST. NO. 4	ILLINOIS FED.	AID PROJ	ECT

\* (90-11)R-2;90(13,14,14-1)R-1

000001-04	STANDARD SYMBOLS, ABBREVIATIONS AND PATTERNS	631011-02	TRAFFIC BARRIER TERMINAL TYPE 2
001001	AREAS OF REINFORCEMENT REBARS	<b>631026</b> -02	TRAFFIC BARRIER TERMINAL TYPE 5 & 5A
202001	EARTH MEDIAN DITCH CHECK	631031 - 05	TRAFFIC BARRIER TERMINAL, TYPE 6
280001-02	TEMPORARY EROSION CONTROL SYSTEMS	635001	DELINEATORS
353001-01	PCC BASE COURSE WITH BITUMINOUS CONCRETE BINDER AND SURFACE COURSES	635006-02	REFLECTOR AND TERMINAL MARKER PLACEMENT
420001~05	PAVEMENT JOINTS	635011-01	REFLECTOR MARKER AND MOUNTING DETAILS
420101-02	7.2 m (24') JOINTED PCC PAVEMENT	664001-01	CHAIN LINK FENCE
420111-01	PCC PAVEMENT ROUNDOUTS	701006 - 02	OFF-RD OPERATIONS, 2L, 2W, 4.5 m (15') TO 600 mm (24") FROM PAVEMENT EDGE
420206 - 05	ENTRANCE RAMP TERMINAL (JOINTED PCC RAMP PAVEMENT ADJACENT TO CRC MAINLINE PAVEMENT)	701101-01	OFF-RD OPERATIONS, MULTILANE, 4.5 M (15') TO 600 mm (24") FROM PAVEMENT EDGE
<b>420306</b> -05	EXIT RAMP TERMINAL (JOINTED PCC RAMP PAVEMENT ADJACENT TO CRC MAINLINE PAVEMENT)	701106-01	OFF-RD OPERATIONS, MULTILANE, MORE THAN 4.5 M (15') AWAY
420401-05	BRIDGE APPROACH PAVEMENT	701201-02	LANE CLOSURE, 2L, 2W, DAY ONLY, FOR SPEEDS $\geq$ 45 MPH
420501-02	PCC PAVEMENT AND PCC BASE COURSE ADJACENT TO RAILROAD GRADE CROSSING	701301-02	LANE CLOSURE, 2L, 2W, SHORT TIME OPERATIONS
420701 - 01	PAVEMENT FABRIC	701306-01	LANE CLOSURE, 2L, 2W, SLOW MOVING OPERATIONS DAY ONLY, FOR SPEEDS ≥ 45 MPH
421201-04	7.2 m (24') CRC PAVEMENT (WITH LUG SYSTEM)	701400 - 02	APPROACH TO LANE CLOSURE, FREEWAY/EXPRESSWAY
424001-03	CURB RAMPS FOR SIDEWALKS	701401-03	LANE CLOSURE, FREEWAY/EXPRESSWAY
442101-05	CLASS B PATCHES	701402 - 05	LANE CLOSURE, FREEWAY/EXPRESSWAY, WITH BARRIER
442201-01	CLASS C AND D PATCHES	701406 - 04	LANE CLOSURE, FREEWAY/EXPRESSWAY, DAY OPERATIONS ONLY
515001-02	NAME PLATE FOR BRIDGES	701411-03	LANE CLOSURE, MULTILANE, AT ENTRANCE OR EXIT RAMP, FOR SPEEDS > 45 MPH
542101	REINFORCED CONCRETE END SECTIONS FOR PIPE CULVERTS 375 mm (15") THRU	701416-05	LANE CLOSURE, FREEWAY/EXPRESSWAY, WITH CROSSOVER AND BARRIER
	900 mm (36") DIA. AT RIGHT ANGLES WITH ROADWAY	701421 - 01	LANE CLOSURE, MULTILANE, DAY OPERATIONS ONLY, FOR SPEEDS > 45 MPH TO 55 MPH
542106	REINFORCED CONCRETE END SECTIONS FOR PIPE CULVERT 1050 mm (42")	701422 - 01	LANE CLOSURE, MULTILANE, FOR SPEEDS ≥ 45 MPH TO 55 MPH
	THRU 1500 mm (60") DIA. AT RIGHT ANGLES WITH ROADWAY	701426 - 02	LANE CLOSURE, MULTILANE, INTERMITTENT OR MOVING OPER., FOR SPEEDS > 45 MPH
542201	REINFORCED CONCRETE END SECTIONS FOR PIPE CULVERTS 375 mm (15")	701446	TWO LANE CLOSURE FREEWAY/EXPRESSWAY
	THRU 900 mm (36") DIA. SKEWED WITH ROADWAY	701501-03	URBAN LANE CLOSURE, 2L, 2W, UNDIVIDED
542301	PRECAST REINFORCED CONCRETE FLARED END SECTION	701502 - 01	URBAN LANE CLOSURE, 2L, 2W, WITH BIDIRECTIONAL LEFT TURN LANE
542306	PRECAST REINFORCED CONCRETE ELLIPTICAL FLARED END SECTION	701601 - 04	URBAN LANE CLOSURE, MULTILANE, 1W OR 2W WITH NONTRAVERSABLE MEDIAN
542401	METAL END SECTION FOR PIPE CULVERTS	701602 - 02	URBAN LANE CLOSURE, MULTILANE, 2W WITH BIDIRECTIONAL LEFT TURN LANE
542501	INLET BOX TYPE 600 (24) A	701701- 04	URBAN LANE CLOSURE, MULTILANE INTERSECTION
542526	INLET BOX TYPE F 600 mm (24")	701801 - 03	LANE CLOSURE MULTILANE 1W OR 2W CROSSWALK OR SIDEWALK CLOSURE
601001	SUB-SURFACE DRAINS	702001 - 05	TRAFFIC CONTROL DEVICES
601101	CONCRETE HEADWALL FOR PIPE DRAIN	704001 - 02	TEMPORARY CONCRETE BARRIER
602101-01	DRAINAGE STRUCTURES TYPES 1, 2, & 3	720001	SIGN PANEL MOUNTING DETAILS
602301	INLET - TYPE A	720006	SIGN PANEL ERECTION DETAILS
602306	INLET - TYPE B	720011	METAL POSTS FOR SIGNS, MARKERS & DELINEATORS
602401	MANHOLE TYPE A	720016-0	MAST ARM MOUNTED STREET NAME SIGNS
602406-01	MANHOLE TYPE A 1800 mm (72") DIAMETER	720021 - 01	SIGN PANELS EXTRUDED ALUMINUM TYPE
602601	PRECAST REINFORCED CONCRETE FLAT SLAB TOP	729001	APPLICATIONS OF TYPES A & B METAL POSTS (FOR SIGNS & MARKERS)
602701	CAST IRON STEPS	780001 - 01	TYPICAL PAVEMENT MARKINGS
604001-02	FRAME AND LIDS TYPE 1	781001 - OZ	TYPICAL APPLICATIONS RAISED REFLECTIVE PAVEMENT MARKERS
604006 - 02	FRAME AND GRATE TYPE 3	805001	ELECTRIC SERVICE INSTALLATION DETAILS
604021-01	BASE, FRAME AND LIDS, TYPE 5	814001	CONCRETE HANDHOLES
604036 - 01	GRATE TYPE 8	814006	DOUBLE HANDHOLES
604041-01	FRAME AND GRATE TYPE 9	857001	STANDARD PHASE DESIGNATION DIAGRAMS AND PHASE SEQUENCES
604071-02	FRAME AND GRATE TYPE 20	857006	SUPERVISED RAILROAD INTERCONNECT CIRCUIT
604101	MEDIAN INLET FOR 600 mm (24") REINFORCED CONCRETE PIPE	877011 - 02	STEEL COMBINATION MAST ARM ASSEMBLY AND POLE
606001-02	CONCRETE CURB TYPE B AND COMBINATION CONCRETE CURB AND GUTTER	<b>878001</b> -03	CONCRETE FOUNDATION DETAILS
606006	OUTLETS FOR CONC. CURB AND GUTTER TYPE B-15.60 (B-6.24)	880001	SPAN WIRE MOUNTED SIGNALS AND FLASHING BEACON INSTALLATION
606101-01	TYPE A GUTTER (INLET, OUTLET & ENTRANCE)	880006	TRAFFIC SIGNAL MOUNTING DETAILS
606111-01	OUTLETS TYPE 2 FOR TYPE A GUTTER	886001	DETECTOR LOOP INSTALLATIONS
606301 - OZ	PC CONCRETE ISLANDS AND MEDIANS CORDUCATED BC CONCRETE MEDIANS		
606306 - 01	CORRUGATED PC CONCRETE MEDIANS  PRINCE ADDROACH CHOIN DEB DAVERSENT AND DRAIN		REVISIONS
609001-02	BRIDGE APPROACH SHOULDER PAVEMENT AND DRAIN		NAME DATE ILLINOIS DEPARTMENT OF TRAN

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F.A.I. RTE.	SECTION	COUNTY	TOTAL SHEETS	SHEET NO.
74	*	TAZEWELL	1366	7
STA. TO STA.				
FED. RO	AD DIST. NO. 4	ILLINOIS FED.	AID PROJ	ECT

DISTRICT 4 STANDARD NUMBER	TITLE	I-74 STANDARD NUMBER	STA. TO STA.  FED. ROAD DIST. NO. 4   ILLINOIS   FED. AID PROJE  (90-11)R-2;90(13,14,14-1)R-1  TITLE
205001-D4 280001-D4 280101-D4 281001-D4 406001-D4 406001-D4 420401-D4 423001-D4 440001-D4 542016-D4 601101-D4 601201-D4 601201-D4 60206-D4 60206-D4 602016-D4 602010-D4 602010-D4 602010-D4 602010-D4 60401-D4	SLOPE STEPS DETAIL TYPICAL APPLICATION OF SILT FILTER FENCE EROSION CONTROL AGGREGATE DITCH CHECK RIPRAP DITCH FOR EROSION PROTECTION PAVEMENT OVERLAY UNDER STRUCTURES SPECIAL TREATMENT BUTT JOINTS BRIDGE APPROACH DETAIL SUBURBAN ENTRANCES WITH CURBED RADII BITUMINOUS SURFACE REMOVAL (COLD MILLING) BITUMINOUS SURFACE REMOVAL OVER PATCHES PIPE CULVERT EXTENSION COLLAR (WITHOUT END SECTION) SLOPE DRAIN DETAILS FOR BURIED PIPES BACKSLOPE DRAINS PIPE ELBOW DETAILS OF SEEPAGE COLLARS FOR BURIED PIPES INLETS, TYPE G-1, SPECIAL INLETS, TYPE G-1 DOUBLE, SPECIAL INLETS, TYPE G-1, SPECIAL INLET-MANHOLE, TYPE G-1, SPECIAL TEMPORARY INLET DRAINAGE TREATMENT MANHOLE, SPECIAL FRAME AND GRATES FOR TYPE G-1 AND TYPE G-1, SPECIAL FRAME AND GRATES FOR TYPE G-1 AND MEDIAN INLET (604101), SPECIAL FRAME & GRATE ADJUSTING RING TYPE 37 GRATE TYPE A GUTTER, (MODIFIED) (INLET, OUTLET & ENTRANCE) OUTLET TYPE 1 (MODIFIED) FOR TYPE A GUTTER (MODIFIED) CONCRETE THRUST BLOCKS GUARDRAIL EROSION CONTROL TREATMENTS	420101-174 420206-174 420306-174 420401-174 420402-174 421001-174 421206-174 483001-174 503002-174 503002-174 601001-174 602101-174 637001-174 637001-174 637001-174 701004-174 701101-174 701403-174 701411-174 733002-174 857003-174	JOINTED PCC PAVEMENT FOR RAMPS TYPICAL ENTRANCE RAMP TERMINAL (JOINTED PCC RAMP ADJACENT TO CRC PAVEMENT) TYPICAL EXIT RAMP TERMINAL (JOINTED PCC RAMP ADJACENT TO CRC PAVEMENT) BRIDGE APPROACH PAVEMENT (SPECIAL) EXPANSION JOINT MAINLINE AND RAMP BRIDGE APPROACH EXPANSION JOINT DETAIL BAR REINFORCEMENT FOR CRC PAVEMENT 10.8 M CRC PAVEMENT (WITH LUG SYSTEM) PCC SHOULDER FOR MAINLINE AND RAMPS BRIDGE MEDIAN BARRIERS AND BRIDGE PARAPET CONFIGURATION RUSTICATION DETAILS AND APPLICATION SUB-SURFACE DRAINS DRAINAGE STRUCTURE TYPE 1A & 1B 1.2M x 0.9M AND 1.2M x 1.5M FOR H ≤ 2.4M DRAINAGE STRUCTURES TYPES 1, 2 & 3 GUARDRAIL AGGREGATE EROSION CONTROL TREATMENT & CONCRETE SHOULDER CURB CONCRETE BARRIER, DOUBLE FACE (MODIFIED) & CONCRETE BARRIER TRANSITION (MODIFIED) FOR SIGN STRUCTURE, HIGH MAST LIGHT TOWER, AND PIER FOUNDATIONS CONCRETE BARRIER, SINGLE FACE (MODIFIED) 1-74 SHOULDER RUMBLE STRIPS TYPICAL CRASH INVESTIGATION SITE (CIS) — SIGNING DETAIL TRAFFIC CONTROL DETAILS FOR FREEWAY SHOULDER CLOSURES PARTIAL RAMP CLOSURES TRAFFIC CONTROL DETAILS FOR FREEWAY SHOULDER CLOSURE MULTILANE WEAVE SHOULDER LANE ENTRANCE AND EXIT RAMP CLOSURE DETAILS SIGN SUPPORT, PARAPET MOUNTED, TYPE 1 BATTERY BACKUP SYSTEM
635101-D4	GUARDRAIL AND BARRIER WALL DELINEATION		

# **COMMITMENTS**

667101-D4

720006-D4

780001-D4

836002-D4

COMMITMENTS ARE NOT TO BE ALTERED WITHOUT THE WRITTEN APPROVAL OF ALL PARTIES TO WHICH THE COMMITMENT WAS MADE.

**GROUND MOUNT SIGN STRUCTURE DETAILS** 

TYPICAL PAVEMENT MARKINGS

PERMANENT SURVEY TIE & PERMANENT SURVEY MARKERS TY. I- TY. II

DETAIL FOR TRAFFIC COUNTERS USING TERMINAL FACILITY

- 1. THE EAST PEORIA FESTIVAL OF LIGHTS PARADE IS HELD IN LATE NOVEMBER (SEE THE SPECIAL PROVISONS FOR EXACT DATES). THE PARADE ROUTE INCLUDES PORTIONS OF WASHINGTON STREET ON THIS PROJECT. THE RESIDENT ENGINEER SHALL CONTACT MR. RICK JEREMIAH, EAST PEORIA DIRECTOR OF PUBLIC WORKS, A MINIMUM OF 14 CALENDAR DAYS PRIOR TO THE EVENT TO NOTIFY THE CITY OF LANE CLOSURES OR WORK REDUCTIONS ON THE PROJECT. THE CONTACT PHONE NUMBER 309-698-4716.
- 2. PARCEL NO. 415P062TE, COMMITMENT TO HAGERTY STEEL & ALUMINUM COMPANY TO PROVIDE AT LEAST ONE LANE OPEN TO TRAFFIC AT THEIR ENTRANCE AT ALL TIMES. AFTER CONSTRUCTION, THE TEMPORARY EASEMENT AREA WILL BE RETURNED TO A SIMILAR CONDITION AS IT NOW EXISTS.
- 3. LETTER OF UNDERSTANDING WITH THE CITY OF EAST PEORIA. A COPY OF THE LETTER IS ON FILE AT THE RESIDENT ENGINEERS FIELD OFFICE.

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i	DAILY & ASSOCIATES,	
	ENGINEERS, INC.	
	PEORIA. ILLINOIS	
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DATE ILLINOIS DEPARTMENT OF TRANSPORTATION

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#### SOIL REPORT AVAILABILITY

All soils data collected and processed for the Soils Report made in conjunction with the design of this improvement is on file at the District Office where it is available for the inspection of Contractors or prospective bidders.

#### **AVAILABILITY OF ELECTRONIC FILES**

MicroStation and GEOPAK files of this project will be made available to the Contractor. If there is a conflict between the electronic files and the printed contract plans and documents, the printed contract plans and documents shall take precedence over the electronic files. The Contractor shall accept all risk associated with using the electronic files and shall hold the Department harmless for any errors or omissions in the electronic files and the data contained therein. Errors or delays resulting from the use of the electronic files by the Contractor shall not result in an extension of time for any interim or final completion date or shall not be considered cause for additional compensation. The Contractor shall not use, share, or distribute these electronic files except for the purpose of constructing this contract. Any claims by third parties due to use or errors shall be the sole responsibility of the Contractor. The Contractor shall include this disclaimer with the transfer of these electronic files to any other parties and shall include appropriate language binding them to similar responsibilities.

#### UTILITIES - LOCATIONS/INFORMATION ON PLANS

The locations of existing water mains, gas mains, sewers, electric power lines, telephone lines and other utilities as shown on the plans are based on careful field investigation and the best information available, but they are not guaranteed. Unless elevations are shown — all utility locations shown on the cross sections are based on the approximate depth supplied by the utility company. It shall be the Contractor's responsibility to ascertain their exact location from the utility companies and by field inspection.

#### TREE REMOVAL - UTILITY RELOCATION

Tree removal may be necessary prior to utility companies being able to relocate their facilities outside the construction limits. The Contractor should coordinate any contract tree removal activities with the utility companies to eliminate conflicts and potential delays caused by utility tree removal activities or incomplete utility relocations

## PLAN ELEVATIONS - U.S.G.S. MEAN SEA LEVEL DATUM

All elevations shown on the plans are established from U.S.G.S. mean sea level datum.

## PROPERTY OWNER ACCESS REQUIREMENT

Access must be maintained to all existing properties during construction per article 107.09 unless arrangements are made in writing by the Coontractor with the property owners with a copy to the Engineer for short-term closures.

#### CONSECUTIVE SIDE STREET (ROAD) CLOSURE - PROHIBITED

- 1. No two consecutive side streets (roads) may be closed at the same time during construction. The Contractor must alternate streets (roads).
- 2. Adjacent side roads will not be closed simultaneously. BLR standard 21 shall be used for all local road closures without any entrances within the closed area. BLR Standard 22 can be used where it is necessary to allow local traffic access.

TEMPORARY MATERIAL REQUIREMENTS - UTILITY AND DRIVEWAY CROSSINGS Incidental bituminous surface shall be used for all temporary side road crossings. Aggregate surface course may be used for all driveway crossings except during winter shutdown in accordance with article 107.09.

#### WINTER SHUTDOWN RESTRICTIONS ON COLD MILLED PROJECTS

Prior to winter shutdown the following steps shall be taken:

- All cold milled surfaces shall be overlaid.
- All Lanes shall be reopened to traffic.
- Manholes, where applicable, shall be adjusted to the elevation of the binder to ease

plowing snow, and re-adjusted to finished grade in the Spring. The initial manhole adjustment will be paid for at the contract unit price and any re-adjustment, as directed by the Engineer, will be paid for in accordance with Article 109.04.

- Temporary or permanent pavement marking shall be placed as applicable.

## **GENERAL NOTES (continued)**

#### CRITICAL PATH WORK SCHEDULE REQUIREMENT

The Contractor will submit to the Engineer a satisfactory progress schedule and critical path schedule which show the proposed sequence of work at the time of the pre-construction conference.

#### CLEARING

At locations where clearing is indicated on the plans beyond the limits of the proposed excavation or embankment, the Contractor shall restore the disturbed earth by blading and shaping to blend with the adjacent ground. The clearing will not be paid for separately but shall be included in the cost of Earth Excavation. Payment for reseeding or resodding shall be as provided in the plans.

#### TREE REMOVAL

The District Four Tree Committee should be contacted and prior approval obtained for any tree removal beyond the limits/locations included in the plans.

#### **ENVIRONMENTAL REVIEWS**

Prior to the use of any proposed borrow areas, use areas (temporary access roads, detours, run-arounds. etc.) and/or waste areas, the Contractor shall file the required environmental resource request surveys according to Section 107.22 of the Standard Specifications. These surveys are required in order for the Department to conduct cultural and biological resource surveys for the proposed site.

Prior to any waste materials being removed from the construction site the required environmental resource surveys will need to be obtained and filed by the Contractor, Excess waste products removed from the construction site shall be disposed of as required in Section 202.03 of the Standard Specifications.

Any protruding metal bars shall be removed prior to the disposal of broken concrete at approved disposal sites.

The required environmental resource documentation shall include the following:

- \*BDE Form 2289 (Environmental Survey Request)
- \*A location map showing the size limits and location of the use area
- \*Signed property owner agreement form
- \*Color photographs depicting the use area

Please note that a minimum of two weeks shall be allowed for the District to obtain the required environmental clearances.

## SEEDING - SIDESLOPE RIPPING

All slopes steeper than 1 to 3 and over 4.5 m (15 ft.) in height shall be ripped. This shall consist of ripping between 450 mm to 600 mm (18 inches to 24 inches) deep normal to the slope. The interval of ripping along the slope shall be 3.6 m (12 ft.). This work shall be done after the seed bed has been prepared but before any fertilizer or seed has been applied. The fertilizer and seed shall be applied within a 24-hour period after the ripping has been done. This work will not be paid for separately but will be included in the cost of the various items of seeding involved.

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74		TAZEWELL	1366	8							
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\* (90-11)R-2:90(13.14.14-1)R-1

ENGINEERS, INC.

ILLINOIS DEPARTMENT OF TRANSPORTATION

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#### AGGREGATE (BASE COURSE), TYPE B

Aggregate (Base Course), Type B shall be required for all granular construction of side roads, entrances, and mailhox turnouts, whether or not portions of the surfaces thus constructed are to be covered with a bituminous surface, except where noted differently on the plans.

#### LABORATORY TESTING OF SUPERPAVE MIXES

Some aggregate compositions produce inconsistent results when burned in the ignition oven. The Engineer will determine whether the ignition oven or AC nuclear gauge will be required after the aggregate sources have been identified.

#### **PAVEMENT STATION NUMBERS & PLACEMENT**

The Contractor shall provide labor and materials required to imprint pavement station numbers in the finished surface of the pavement and/or overlay. The numbers shall be approximately 20 mm (3/4 inch) wide, 125 mm (5 inches) high and 15 mm (5/8 inch) deep.

The pavement station numbers shall be installed as specified herein: Interval - 100 meters (metric stationing) or 200 feet (English stationing) Bottom of Numbers - 150 mm (6 inches) from the inside edge of the pavement marking Location:

\*2, 3, & 5 Lane Pavements - right edge of pavement in direction of increasing stations \*Multi-Lane Divided Roadways - outside edge of pavement in both directions

\*Ramps - along baseline edge of pavement

Position - stations shall be placed so they can be read from the adjacent shoulder Format - Metric (English) pavement stations shall use this format "XX + X00 (XXX)", where X represents the pavement station

This work will not be paid for separately, but will be considered included in the cost of the associated pavement and/or overlay pay items.

#### MINIMUM VERTICAL CLEARANCE

The Contractor shall verify the existing structure vertical clearance prior to placing bituminous overlay under any structure. A minimum 4.65 m vertical clearance shall be maintained under all structures.

#### **BUTT JOINT CUTTING TIME RESTRICTION**

Butt joints shall not be milled more than three (3) days prior to placement of the bituminous surface course.

#### PAVING SURFACE COURSE, CL I CONTINUOUS

Continuous paving operations on the main roadway shall be maintained at all times during the construction of the bituminous surface. No interruptions for side roads, entrances, turn lanes, etc. will be allowed.

#### FINAL FINISH ON P.C. CONCRETE PAVEMENT, TYPE B

A Type "B" final finish, obtained in accordance with Article 420.11 (e)(2) of the Standard Specifications, shall be provided for the Portland Cement Concrete Pavement.

#### ADDITIONAL BITUMINOUS OVERLAY IN LIEU OF PATCHING

An additional thickness of bituminous overlay is being placed on this project to allow pavement patching to be either eliminated or reduced to a very limited quantity. The intent of this treatment is to minimize or eliminate the need for any pavement patching.

# **GENERAL NOTES (continued)**

#### REFLECTIVE CRACK CONTROL PLACEMENT

Reflective crack control treatment shall be placed on the binder coures.

### ORDERING LENGTH CONFIRMATION - DRAINAGE ITEMS

The Contractor shall consult with the Engineer in regard to the exact length of the box/pipe culverts, storm sewers, and/or pipe drains required prior to ordering these

#### **EXISTING DRAINAGE PIPES CONNECTED TO NEW STRUCTURES**

In accordance with Section 602 of the Standard Specifications, the connecting of existing drain tiles, pipe culverts, or storm sewers to the proposed drainage system structures will not be paid for separately but shall be considered as included in the pay items provided.

#### TAPER REMOVAL @ FRAME & GRATES ADJUSTED BY OTHERS

At locations where frames and grates have previously been adjusted by others and they are surrounded by bituminous tapers, the Contractor for this contract shall remove and dispose of the bituminous taper material prior to the placement of the bituminous surface course. This work will not be paid for separately, but will be considered as included in the cost of the BITUMINOUS SURFACE COURSE

#### TRANSITION PAYMENT METHOD - NEW/OLD CONSTRUCTION

Three meter (3 m) (10 ft.) transitions shall be used to match proposed items of work to existing items in the field unless otherwise shown. The transition shall be paid for at the contract unit price for the proposed item of work specified.

#### SIGN POST HOLES

Vertical holes shall be constructed in the island pavement and/or concrete median of the type specified or concrete median surface 100 mm (4 inches). The holes shall be 600 mm (24 inches) in diameter or 600 mm (24 inches) square and they shall be free of any obstructions, except earth, for a depth of 1.5 m (5 feet) at the locations shown on the plans or as directed by the Engineer. Any holes not used for the placement of signs shall be filled and compacted flush with the top of the island pavement, concrete median of the types specified, or concrete median surface 100 mm (4 inches). The top 75 mm (3 inches) of said compacted fill shall consist of a bituminous concrete mixture. All holes in which the sign posts are installed at the time of this contract shall be similarly filled.

This work, including any required pavement removal necessary to construct the sign post holes, will not be paid for separately but shall be included in the contract unit price per square meter (square foot) for ISLAND PAVEMENT and/or CONCRETE MEDIAN of the type specified, or CONCRETE MEDIAN SURFACE, 100 mm (4 inches).

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74 •					TAZEWELL	1366	9						
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FED BOAD DIST NO 4 ILLINOIS FED AID PROJECT													

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\* (90-11)R-2:90(13,14,14-1)R-1

DATLY & ASSOCIATES ENGINEERS, INC. PEORIA. ILLINOIS

ILLINOIS DEPARTMENT OF TRANSPORTATION

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DATE 01/12/2005

# **GENERAL NOTES (continued)**

#### **ENGINEERS FIELD OFFICE**

Add the following sentence to the end of paragraph 670.02 (i) and 670.04 (E):

All of the telephone lines provided shall have unpublished numbers.

#### SIGNIN

Sign locations may vary from the stations shown on the plans in accordance with directions from the Engineer at the time of construction. Sign locations may be adjusted in the field to avoid any found utilities.

All wood post locations shall be verified with the Bureau of Operations, Traffic Section, before installation.

#### TRAFFIC SIGNALS. REMOVAL/RETURNED TO IDOT

All equipment removed under "Remove Existing Traffic Control Equipment" is to be returned to the Illinois Department of Transportation, District Four, Bureau of Operations, Traffic Operations Building, at 5826 North Knoxville Avenue, Peoria, Illinois.

#### TRAFFIC COUNTER LOOP DETECTOR INSTALLATION

The Resident Engineer and/or Contractor shall notify the Traffic Studies Technician in Program Development at least one week prior to the installation to determine exact location.

#### TRAFFIC SIGNAL, EXISTING, OPERATIONAL DURING NEW CONSTRUCTION

The existing traffic signals shall remain in operation during installation of the proposed traffic signals.

## TRAFFIC SIGNALS, MAINTENANCE OF EXISTING DURING CONSTRUCTION

Any maintenance of the existing signals shall be considered as extra work in accordance with Article 109.04 of the Standard Specifications.

#### STRUCTURAL SHOP DRAWING REVIEW

# THE FOLLOWING TABLE OUTLINES SHOP DRAWING SUBMITTAL REQUIREMENTS:

STRUCTURE NUMBER	DESIGN CONSULTANT (FOR REVIEW)	CONSTRUCTION ENGINEER (FOR INFORMATION)
090-0009 090-0159 090-0160 090-0163 090-8512 090-8513	URS CORPORATION 3040 N. UNIVERSITY AVENUE SUITE ONE DECATUR, ILLINOIS 62526—1343 ATTN: MR. JAMES MARTY 217-875-4800	APPLICABLE CONTRACT CONSTRUCTION ENGINEER
090-0156	ALFRED BENESCH AND COMPANY 205 N. MICHIGAN AVENUE SUITE 2400 CHICAGO, ILLINOIS 60601 ATTN: MR. DAVID MORRILL 312-565-0450	APPLICABLE CONTRACT CONSTRUCTION ENGINEER
SIGN STRUCTURES	ALFRED BENESCH AND COMPANY 205 N. MICHIGAN AVENUE SUITE 2400 CHICAGO, ILLINOIS 60601 ATTN: MR. DAVID MORRILL 312-565-0450	APPLICABLE CONTRACT CONSTRUCTION ENGINEER

F.A.I. RTE.	SECTION	COUNTY	TOTAL	SHEE NO.
74	•	TAZEWELL	1366	10
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#### AESTHETICS ELEMENTS SHOP DRAWINGS REVIEW

AESTHETICS ELEMENT SHOP DRAWINGS SHALL BE SUBMITTED BY THE FABRICATOR TO THE DESIGN CONSULTANT AND/OR TO THE AESTHETIC DESIGNER FOR REVIEW AS DENOTED IN THE TABLE BELOW. A CONCURRENT COPY OF THE TRANSMITTAL LETTER SHALL BE SUBMITTED TO THE CONSTRUCTION ENGINEER AND TO THE DISTRICT IMPLEMENTATION ENGINEER.

THE FOLLOWING TABLE OUTLINES THE RESPONSIBILITIES FOR REVIEW OF THE SHOP DRAWINGS AS THEY PERTAIN TO THE AESTHETIC ELEMENTS. SHOP DRAWINGS SHALL BE ADDRESSED TO:

#### AESTHETICS DESIGNER

ALFRED BENESCH AND COMPANY 205 N. MICHIGAN AVENUE SUITE 2400 CHICAGO, ILLINOIS 60601 ATTN: MR. DAVID MORRILL 312-565-0450 DESIGN CONSULTANT
URS CORPORATION
3040 N. UNIVERSITY AVENUE
SUITE ONE
DECATUR, ILLINOIS 62526-1343
ATTN: MR. JAMES MARTY
217-875-4800

iTEM	AESTHETICS DESIGNER	DESIGN CONSULTANT	COMMENTS
BOLLARDS AND BOLLARD LUMINARIES (FINISH SAMPLES, CALCULATIONS, SHOP DRAWINGS AND MOCKUPS) INCLUDING INSTALL BOLLARD PROCEDURE AND ELLIPTICAL STEEL ANGLES	х		THE GENERAL CONTRACTORS SHALL SUBMIT BOLLARD INSTALLATION METHOD AND PROCEDURE SHOP DRAWMINGS FOR APPROVAL IF THEIR PROPOSED INSTALLATION METHOD AND PROCEDURE DEVIATES FROM THE FABRICATOR'S APPROVED METHOD.
PAINT OVER GALVANIZING		x	DESIGN CONSULTANT TO ENSURE THAT THE GENERAL NOTE ON THE SHOP DRAWINGS REFLECT THAT THE CONTRACTOR'S PAINT OVER GALVANIZED PROCESS MEETS THE REQUIREMENTS OF THE CONTRACT.
FORMLINERS (LIMESTONE, FIN & GRID AND PARAPET)	x		
RAILINGS		х	THE SHOP DRAWINGS SHALL BE SENT TO THE DESIGN CONSULTANT WHO PREPARED THE STRUCTURAL PLANS.
SCUPPERS		х	THE SHOP DRAWINGS SHALL BE SENT TO THE DESIGN CONSULTANT WHO PREPARED THE STRUCTURAL PLANS.

#### **BITUMINOUS CONCRETE MIXTURE REQUIREMENTS**

The following mixture requirements are applicable for this project:

LOCATION(S):	ALL (EXCEPT PLAN SET 4***)	ALL (EXCEPT PLAN SET 4***)	ALL (EXCEPT PLAN SET 4***)	ALL (EXCEPT PLAN SET 4***)	PLAN SET 4***	PLAN SET 4***	PLAN SET 4***	
MIXTURE USE(S):  SURFACE COURSE  BASE COURSE (ALL THICKNESSES) & CLASS D PATCHES		THICKNESSES) & CLASS D	BITUMINOUS SHOULDERS (BOTTOM LIFT) & STABILIZED SUB-BASE	BITUMINOUS SHOULDERS (TOP LIFT)	1–74 SURFACE COURSE	1-74 BINDER COURSE	I-74 BITUMINOUS SHOULDERS	
AC/PG:	PG 64-22	PG 64-22	PG 58-22	PG 58-22	SBS OR SBR PG 76-22	SBS OR SBR PG 76-22	SBS OR SBR PG 64-22	
RAP %: (MAX)**	10 %	15 %	30 %	30 %	0 % *	0 % *	30 % *	
DESIGN AIR VOIDS:	4.2 % @ Ndes = 70	4.2 % @ Ndes = 70	4.0 % @ Ndes = 30	3.0 % @ Ndes = 30	4.2 % @ Ndes = 90	4.2 % @ Ndes = 90	3.0 % @ Ndes = 30	
MIXTURE COMPOSITION: (GRADATION MIXTURE)	IL 9.5 OR 12.5	IL 19.0	IL 19.0 L (LOW ESAL)	IL 9.5 L (LOW ESAL)	IL 9.5 OR IL 12.5	IL 19.0	IL 9.5L	
FRICTION AGGREGTE	MIX D	N/A	N/A	MIXTURE C	MIXTURE E	N/A	MIX C	

\* IF THE RAP OPTION IS SELECTED, THE ASPHALT CEMENT GRADE MAY NEED TO BE ADJUSTED; THIS WILL BE DETERMINED BY THE ENGINEER.

\*\*IF > 15% RAP IS USED. THE CONTRACTOR MAY BE REQUIRED TO USE A SOFTER GRADE OF ASPHALT AS DETERMINED BY THE MATERIALS ENGINEER.

\*\*\* THIS INCLUDES ALL 1-74 PAVING EAST OF STATION 154+780 ONLY.

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COUNTY TOTAL SHEET SHEET SHEET NO.

TAZEWELL 1366 11 F.A.I. RTE. 74 SECTION STA. TO STA. FED. ROAD DIST. NO. 4 ILLINOIS FED. AID PROJECT

\* (90-11)R-2;90(13,14,14-1)R-1

URBAN 90% FED 10% STATE 90% FED 10% STATE CONSTRUCTION TYPE CODE

FOR ALL PLAN SETS				CONSTRUCTION TYPE CODE											
			INTERSTATE ROADWAY 3 LANE	INTERSTATE ROADWAY 2 LANE	INTERSTATE ROADWAY	ARTERIAL ROADWAY	ARTERIAL ROADWAY	BRIDGE	BRIDGE	BRIDGE	BRIDGE	RETAINING WALL	OVERHEAD SIGNS	LIGHTING	TRAFFIC SIGNALS
CODE NO. PAY ITEM	UNIT	TOTAL QUANTITY	(1) J000-2A	(2) J000-2A	(2A) I000-2A	(3) 1000-2A	(4) J000-2A	(5) X281-2A	(6) X581-2A	(7) <b>X271</b> -2A	(8) X971-2A	(9) Y007	Y002-1C	Y030-1E	Y031-1F
28000300 TEMPORARY DITCH CHECKS	EACH	95	83			1	11								
28000500 INLET AND PIPE PROTECTION	EACH	290	268	22											
50100300 REMOVAL OF EXISTING STRUCTURES NO. 1	EACH	1						1							
50100400 REMOVAL OF EXISTING STRUCTURES NO. 2	EACH	1							1						
50100500 REMOVAL OF EXISTING STRUCTURES NO. 3	EACH	1						1							
50104400 CONCRETE HEADWALL REMOVAL	EACH	33	16	11		5	1								
50104710 REMOVAL OF EXISTING BEARINGS	EACH	10									10				
50104800 REMOVAL OF EXISTING CONCRETE DECK	L SUM	1								~	1				
50300100 FLOOR DRAINS	EACH	7									7				
50300310 ELASTOMERIC BEARING ASSEMBLY, TYPE I	EACH	12									12				
50300320 ELASTOMERIC BEARING ASSEMBLY, TYPE II	EACH	28								4	24				
50300330 ELASTOMERIC BEARING ASSEMBLY, TYPE III	EACH	4								4					
50500505 STUD SHEAR CONNECTORS	EACH	245B								4892	12334	7232			
50500715 JACK AND REMOVE EXISTING BEARINGS	EACH	30									30				
50600300 CLEANING AND PAINTING STEEL BRIDGE	L SUM	1									1				
50606400 CONTAINMENT AND DISPOSAL OF LEAD PAINT CLEANING RESIDUES	L SUM	1									1				
51500100 NAME PLATES	EACH	7						2	1	1	1	2			
54244805 INLET BOX, STANDARD 542501	EACH	i		1											
54246205 INLET BOX, STANDARD 542526	EACH	1		1											
60100060 CONCRETE HEADWALL FOR PIPE DRAINS	EACH	29	15	12		2									
60240301 INLETS, TYPE B, TYPE 8 GRATE	EACH	1	1												
60240303 INLETS, TYPE B, TYPE 9 FRAME AND GRATE	EACH	3	3												
60240324 INLETS, TYPE B, TYPE 20 FRAME AND GRATE	EACH	2	2				-								
60241900 INLETS, TYPE G-1, SPECIAL	EACH	61	2			38	21								
60242400 INLETS, SPECIAL	EACH	7		7											
60247132 DRAINAGE STRUCTURES, TYPE 1A WITH ONE TYPE 20 FRAME AND GRATE	EACH	15	15							,					
60255500 MANHOLES TO BE ADJUSTED	EACH	7					7								
60260100 INLETS TO BE ADJUSTED	EACH	1				1									
60260500 INLETS TO BE ADJUSTED WITH NEW TYPE 3 FRAME AND GRATE	EACH	7					7								
60403400 GRATES, TYPE A	EACH	5		5											
60500040 REMOVING MANHOLES	EACH	2				2									
60500060 REMOVING INLETS	EACH	40	30	9			1								
60500105 FILLING MANHOLES	EACH	2					2								
60500305 FILLING INLETS	EACH	2					2								
60603300 GUTTER OUTLET	EACH	3		3											
60900215 TYPE C INLET BOX, STANDARD 609001	EACH	5	4	1											

(6) BRIDGE PLANS SN 090-0159 (SN 090-0005) (WB I-74 OVER ALTORFER LANE AND TP&W RAILROAD)
(7) BRIDGE PLANS SN 090-0156 (SN 090-0010 EB & SN 090-0011 WB) (RAMP K-2 OVER MAIN STREET AND RAMP J-3)
(8) BRIDGE PLANS SN 090-0009 (WB I-74 OVER CAMP STREET, FARM CREEK AND TP&W RAILROAD)
(9) RETAINING WALL SN 090-8512 (ALONG RAMP J-3) RETAINING WALL SN 090-8513 (ALONG RAMP K-2)

	REVISIONS						
	NAME	DATE					
DAILY & ASSOCIATES, ENGINEERS, INC. PEORIA, ILLINOIS							

ILLINOIS DEPARTMENT OF TRANSPORTATION

SUMMARY OF QUANTITIES

DRAWN BY

△ SFTY-3N □ SFTY-3C ○ Y080 Ø NON-PARTICIPATING

SUMMARY OF QUANTITIES

FOR ALL PLAN SETS

(1) I-74 STA. 152+445.837 TO STA. 153+892.180 (2) I-74 STA. 153+892.180 TO STA. 154+970.000 (2A) I-74 EB STA. 154+780.000 TO STA. 157+666.230 & I-74 WB STA. 154+952.000 TO STA. 157+666.230 (3) MAIN STREET STA. 2+800.000 TO STA. 4+157.000 (4) MAIN STREET STA. 2+015.141 TO STA. 2+310.000, MAIN STREET STA. 2+015.141 TO STA. 2+310.000, WASHINGTON STREET STA. 99+730.000 TO STA. 100+210.000 (5) BRIDGE PLANS SN 090-0160 (SN 090-0006) (WB I-74 OVER MAIN STREET) & BRIDGE PLANS SN 090-0163 (WB I-74 OVER WASHINGTON STREET)

DATE 02/14/2005

CHECKED BY

COUNTY TOTAL SHEET SHEETS NO. SECTION TAZEWELL 1366 12 STA. TO STA.

FED. ROAD DIST. NO. 4 ILLINOIS FED. AID PROJECT

5% STATE • (90-11)R-2;90(13,14,14-1)R-1 5% (114

300 M

90% FED

90% FFD 90% FED 10% STATE 10% STATE CONSTRUCTION TYPE CODE

URBAN

FOR ALL PLAN SETS INTERSTATE INTERSTATE INTERSTATE TRAFFIC ROADWAY ROADWAY ARTERIAL ARTERIAL RETAINING OVERHEAD TRAFFIC SIGNALS 3 I ANE 2 LANE ROADWAY ROADWAY BRIDGE BRIDGE BRIDGE BRIDGE WALL SIGNS LIGHTING SIGNALS AT BLACK JACK (2A) TOTAL (2) CODE NO. PAY ITEM UNIT BCU0 7031-1F J000-2A J000-2A I000-2A I000-2A J000-2A X281-2A X581-2A X271-2A X971-2A Y002-10 Y031-1F 60900315 TYPE D INLET BOX, STANDARD 609006 EACH 60900515 CONCRETE THRUST BLOCKS EACH 61000115 TYPE E INLET BOX, STANDARD 610001 EACH 61000225 TYPE F INLET BOX, STANDARD 610001 EACH 63100045 TRAFFIC BARRIER TERMINAL, TYPE 2 EACH 63100085 TRAFFIC BARRIER TERMINAL, TYPE 6 EACH 63100167 TRAFFIC BARRIER TERMINAL TYPE 1, SPECIAL (TANGENT) EACH 8 63500105 DELINEATORS EACH 66600105 FURNISHING AND ERECTING RIGHT-OF-WAY MARKERS 66700205 PERMANENT SURVEY MARKERS, TYPE I EACH 67100100 MOBILIZATION L SUM 0.5 70101800 TRAFFIC CONTROL AND PROTECTION (SPECIAL) L SUM 0.65 70103817 TRAFFIC CONTROL SURVEILLANCE (SPECIAL) CAL DA 440 440 72400100 REMOVE SIGN PANEL ASSEMBLY - TYPE A EACH 72400200 REMOVE SIGN PANEL ASSEMBLY - TYPE B EACH 72400500 RELOCATE SIGN PANEL ASSEMBLY - TYPE A 72400600 RELOCATE SIGN PANEL ASSEMBLY - TYPE B EACH 73600100 REMOVE OVERHEAD SIGN STRUCTURE - SPAN EACH 73600200 REMOVE OVERHEAD SIGN STRUCTURE - CANTILEVER EACH 73602000 REMOVE OVERHEAD SIGN STRUCTURE - BRIDGE MOUNTED EACH 73700100 REMOVE GROUND-MOUNTED SIGN SUPPORT EACH 23 73700200 REMOVE CONCRETE FOUNDATION - GROUND MOUNT 23 73700300 REMOVE CONCRETE FOUNDATION - OVERHEAD EACH \* 78100100 RAISED REFLECTIVE PAVEMENT MARKER 977 577 EACH 171 229 78100300 REPLACEMENT REFLECTOR EACH 78200500 BARRIER WALL MARKERS EACH 117 78201000 TERMINAL MARKER - DIRECT APPLIED EACH 10 78300200 RAISED REFLECTIVE PAVEMENT MARKER REMOVAL EACH 640 229 290 80400100 ELECTRIC SERVICE INSTALLATION EACH # 80500200 SERVICE INSTALLATION, TYPE B EACH 80500205 SERVICE INSTALLATION, TYPE B (MODIFIED) EACH 81400100 HANDHOLE EACH 81400200 HEAVY-DUTY HANDHOLE EACH 81400400 CONCRETE HANDHOLE EACH 19-17 81400600 CONCRETE DOUBLE HANDHOLE EACH 82102400 LUMINAIRE, SODIUM VAPOR, HORIZONTAL MOUNT, 400 WATT EACH 19

O YOSO Ø NON-PARTICIPATING

\* SPECTALTY ITEM

SUMMARY OF QUANTITIES

(1) I-74 STA. 152+445.837 TO STA. 153+892.180 (2) I-74 STA. 153+892.180 TO STA. 154+970.000 (2A) I-74 EB STA. 154+780.000 TO STA. 157+666.230 & I-74 WB STA. 154+952.000 TO STA. 157+666.230 (3) MAIN STREET STA. 2+800.000 TO STA. 4+157.000 (4) MAIN STREET STA. 2+015.141 TO STA. 2+310.000, MAIN STREET STA. 2+02.933 TO STA. 2+800.000, & WASHINGTON STREET STA. 99+730.000 TO STA. 100+210.000 (5) BRIDGE PLANS SN 090-0160 (SN 090-0006) (WB I-74 OVER MAIN STREET) & BRIDGE PLANS SN 090-0163 (WB I-74 OVER WASHINGTON STREET)

(6) BRIDGE PLANS SN 090-0159 (SN 090-0005) (WB I-74 0VER ALTORFER LANE AND TP&W RAILROAD)
(7) BRIDGE PLANS SN 090-0156 (SN 090-0010 EB & SN 090-0011 WB) (RAMP K-2 0VER MAIN STREET AND RAMP J-3)
(8) BRIDGE PLANS SN 090-0009 (WB I-74 0VER CAMP STREET, FARM CREEK AND TP&W RAILROAD)

(9) RETAINING WALL SN 090-8512 (ALONG RAMP J-3) RETAINING WALL SN 090-8513 (ALONG RAMP K-2)

DAILY & ASSOCIATES, ENGINEERS, INC. PEORIA, ILLINOIS	REVISIO NAME
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ILLINOIS DEPARTMENT OF TRANSPORTATION

SUMMARY OF QUANTITIES

DATE 02/14/2005

DATE

DRAWN BY CHECKED BY

68201

COUNTY TOTAL SHEET SHEETS NO.

TAZEWELL 1366 13 F.A.I. RTE. SECTION FED. ROAD DIST. NO. 4 ILLINOIS FED. AID PROJECT

Paloreo 5% STATE Sho city

URBAN

• (90-11)R-2;90(13,14,14-1)R-1

TRAFFIC SIGNALS AT BLACKJACK BUYO

Y031-1F

SUMMARY OF QUANTITIES					90% FED 10% STATE							90% 10% S			
FOR ALL PLAN SETS				INTERSTATE	INTERSTATE			CONSTRUCT	ION TYPE CO	DDE			0./50//5.0		
			ROADWAY 3 LANE	ROADWAY 2 LANE	ROADWAY	ROADWAY	ROADWAY	BRIDGE	BRIDGE	BRIDGE	BRIDGE	RETAINING WALL	OVERHEAD SIGNS	LIGHTING	TRAFFIC SIGNALS
CODE NO. PAY ITEM	UNIT	TOTAL QUANTITY	(1) J000-2A	(2) J000-2A	(2A) 1000-2A	(3) 1000-2A	(4) J000-2A	(5) X281-2A	(6) X581-2A	(7) X2 <b>71-2</b> A	(8) X971-2A	(9) Y007	Y002-1C	Y030-1E	Y031-1F
# 82500530 LIGHTING CONTROLLER TYPE CB-RCS 100AMP - 240VOLT	EACH	1												1	
# 82500560 LIGHTING CONTROLLER TYPE CB-RCS 200AMP - 480VOLT	EACH	1												1	
82500605 LIGHTING CONTROLLER PHOTOCELL RELAY	EACH	1												1	
84100110 REMOVAL OF TEMPORARY LIGHTING UNITS	EACH	4												4	
84200500 REMOVAL OF EXISTING LIGHTING UNIT, SALVAGE	EACH	16												16	
84200600 REMOVAL OF EXISTING LIGHTING UNIT, NO SALVAGE	EACH	45												45	
84200800 POLE FOUNDATION, REMOVED	EACH	61												61	
85700200 FULL-ACTUATED CONTROLLER AND TYPE IV CABINET	EACH	2													2
86301000 TERMINAL FACILITY	EACH	1			1										
4 86400100 TRANSCEIVER - FIBER OPTIC	EACH	2													21
88200110 TRAFFIC SIGNAL BACKPLATE, LOUVERED	EACH	20													20 පි
88800100 PEDESTRIAN PUSH-BUTTON	EACH	2													-2-
89000200 TEMPORARY TRAFFIC SIGNAL INSTALLATION	L SUM	2													2
89502375 REMOVE EXISTING TRAFFIC SIGNAL EQUIPMENT	EACH	1													11
89502380 REMOVE EXISTING HANDHOLE	EACH	8					3								5
89502385 REMOVE EXISTING CONCRETE FOUNDATION	EACH	8					3						-		5
M2010110 TREE REMOVAL (6 TO 15 UNITS DIAMETER)	UNIT	267				214	53								
M2010210 TREE REMOVAL (OVER 15 UNITS DIAMETER)	UNIT	176	94			64	18								
M2010500 TREE REMOVAL, HECTARES	HA	1	0.7			0.25									
M2011000 TEMPORARY FENCE	METER	1703.0	1703						·						
M2020010 EARTH EXCAVATION	CU M	64865	52185	12680											
* M2021200 REMOVAL AND DISPOSAL OF UNSUITABLE MATERIAL	CU M	3460	1105	1790		565									
M2021400 SUB-BASE GRANULAR MATERIAL, TYPE A	M TON	11751					11751								
M2021500 SUB-BASE GRANULAR MATERIAL, TYPE B	M TON	6512				6512									
M2040800 FURNISHED EXCAVATION	CU M	12165	6135	2995			3034								
M2070220 POROUS GRANULAR EMBANKMENT	CU M	2831						502	360	111		1858			
M2080250 TRENCH BACKFILL, SPECIAL	CU M	2104	281	1596		175	52								
M2101000 GEOTECHNICAL FABRIC FOR GROUND STABILIZATION	SQ M	39015	25607	13408											
M2113100 TOPSOIL FURNISH AND PLACE, 100MM	SQ M	48636.0	23595.0	1757.0			23284.0								
★ M2500110   SEEDING, CLASS 1A	НА	4.0	3.9				0.1								
M2500210 SEEDING, CLASS 2A	HA	2.6		2.6											
M2500312 SEEDING, CLASS 4A	HA	3,1	3.1						***						
M2500322 SEEDING, CLASS 5A	HA	0.4	0.4												
M2500400 NITROGEN FERTILIZER NUTRIENT	KG	644.0	377.0	260.0			7,0								
M2500500 PHOSPHORUS FERTILIZER NUTRIENT	KG	644	377	260			7								
							7								
M2500600 POTASSIUM FERTILIZER NUTRIENT	KG	644	377	260											

△ SFTY-3N
□ SFTY-3C
○ Y080
Ø NON-PARTICIPATING \* SPECIALTY ITEM

(1) I-74 STA. 152+445.837 TO STA. 153+892.180
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(2A) I-74 EB STA. 154+780.000 TO STA. 157+666.230 & I-74 WB STA. 154+952.000 TO STA. 157+666.230
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(4) MAIN STREET STA. 2+800.000 TO STA. 4+157.000, MAIN STREET STA. 2+402.933 TO STA. 2+800.000, & WASHINGTON STREET STA. 99+730.000 TO STA. 100+210.000
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DAILY & ASSOCIATES,		L
ENGINEERS, INC.		L
PEORIA, ILLINOIS		L
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NS | DATE | ILLINOIS DEPARTMENT OF TRANSPORTATION

SUMMARY OF QUANTITIES

DATE 02/14/2005

DRAWN BY

CHECKED BY

COUNTY TOTAL SHEET SHEETS NO.
TAZEWELL 1366 14 SECTION

STA. TO STA. FED. ROAD DIST. NO. 4 | ILLINOIS FED. AID PROJECT

\* (90-11)R-2;90(13,14,14-1)R-1

SUMMARY OF QUANTITIES		1	90% FED 0% STATE							90% 10% S	FED STATE				
FOR ALL PLAN SETS			INTERSTATE	INTERSTATE	INTERSTATE			CONSTRUCT	ION TYPE C	ODE					
			ROADWAY 3 LANE	ROADWAY 2 LANE	ROADWAY	ARTERIAL ROADWAY	ARTERIAL ROADWAY	BRIDGE	BRIDGE	BRIDGE	BRIDGE	RETAINING WALL	OVERHEAD SIGNS	LIGHTING	TRAFFIC SIGNALS
CODE NO. PAY ITEM	UNIT	TOTAL QUANTITY	(1) J000-2A	(2) J000-2A	(2A) I000-2A	(3) I000-2A	(4) J000-2A	(5) X281-2A	(6) X581-2A	(7) <b>X27 -2A</b>	(8) X971-2A	(9) Y007	Y002-1C	Y030-1E	Y031-1F
M2500700 AGRICULTURAL GROUND LIMESTONE	M TON	33	21	11.7			0,3								
M2510120 MULCH, METHOD 2	M TON	4.0	4.0							~~~~					
M2510130 MULCH, METHOD 3	M TON	11.7		11.7											
M2510630 EROSION CONTROL BLANKET	SQ M	39120.0	39120.0												
M2800250 TEMPORARY EROSION CONTROL SEEDING	KG	12713	12713												
M2800400 PERIMETER EROSION BARRIER	METER	6195	5303	481			411								
M2810707 STONE DUMPED RIPRAP, CLASS A4	SQ M	551	551												
M2820100 FILTER FABRIC FOR USE WITH RIPRAP	SQ M	2201	551	1650											
M2850300 ARTICULATED BLOCK MAT	SQ M	2012	362	1650											
M3113100 SUB-BASE GRANULAR MATERIAL (SPECIAL) .	CU M	557					557							/	
M3511100 AGGREGATE BASE COURSE, TYPE B 100MM	SQ M	520	520												
M3530250 PORTLAND CEMENT CONCRETE BASE COURSE 250MM	SQ M	10055				10055									
M3530300 PORTLAND CEMENT CONCRETE BASE COURSE 300MM	SQ M	92					92								
M3540250 PORTLAND CEMENT CONCRETE BASE COURSE WIDENING 250MM	SQ M	525				525									
M3540300 PORTLAND CEMENT CONCRETE BASE COURSE WIDENING 300MM	SQ M	181					180.86								
M4060085 PORTLAND CEMENT CONCRETE SURFACE REMOVAL - BUTT JOINT	SQ M	137				137									
M4060200 BITUMINOUS MATERIALS (PRIME COAT)	M TON	93	43.8	5.8	25.6	17.7									
M4060300 AGGREGATE (PRIME COAT)	M TON	248	43.0	3.0	135.9	112									
				24.2	135.5										
M4060980 BITUMINOUS SURFACE REMOVAL - BUTT JOINT	SQ M	418		216		202									
M4060990 TEMPORARY RAMP	SQ M	284			284										
M4080400 INCIDENTAL BITUMINOUS SURFACING	M TON	3					3								
M4202255 PORTLAND CEMENT CONCRETE PAVEMENT 250MM (JOINTED)	SQ M	22582	4650	5344			12588	1							
M4205000 BRIDGE APPROACH PAVEMENT	SQ M	, 727	727												
M4205050 BRIDGE APPROACH PAVEMENT (SPECIAL)	SQ M	586	439	147											
M4205200 PROTECTIVE COAT	SQ M	91358	29768	43253		2757	15580								
M4210290 CONTINUOUSLY REINFORCED PORTLAND CEMENT CONCRETE PAVEMENT 290MM	SQ M	18305	10820	7485										<b></b>	
M4214290 PAVEMENT REINFORCEMENT 290MM	SQ M	18305	10820	7485											
M4217072 LUG SYSTEM COMPLETE 7.2 METER	EACH	2		2											
M4230200 PORTLAND CEMENT CONCRETE DRIVEWAY PAVEMENT, 200MM	SQ M	286				99	187								
M4240100 PORTLAND CEMENT CONCRETE SIDEWALK 100MM	SQ M	137	55				82							-	
M4400025 BITUMINOUS SURFACE REMOVAL 25MM	SQ M	24929				24929									
M4400040 BITUMINOUS SURFACE REMOVAL 40MM	SQ M	39807			39807										
M4400050 BITUMINOUS SURFACE REMOVAL 50MM	SQ M	21				-	21								
M4400075 BITUMINOUS SURFACE REMOVAL 75MM	SQ M	1754.0		1754.0											
M4401000 BITUMINOUS SURFACE REMOVAL (VARIABLE DEPTH)	SQ M	9383			3625		5757.72								
M4402000 PAVEMENT REMOVAL	SQ M	25777	12288	12340			1149.08								
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△ SFTY-3N
□ SFTY-3C
○ Y080
Ø NON-PARTICIPATING \* SPECIALTY ITEM

(1) I-74 STA. 152+445.837 TO STA. 153+892.180 (2) I-74 STA. 153+892.180 TO STA. 154+970.000 (2A) I-74 EB STA. 154+780.000 TO STA. 157+666.230 & I-74 WB STA. 154+952.000 TO STA. 157+666.230 (3) MAIN STREET STA. 2+800.000 TO STA. 4+157.000 (4) MAIN STREET STA. 2+015.141 TO STA. 2+310.000, MAIN STREET STA. 2+402.933 TO STA. 2+800.000, & WASHINGTON STREET STA. 99+730.000 TO STA. 100+210.000 (5) BRIDGE PLANS SN 090-0160 (SN 090-0006) (WB I-74 OVER MAIN STREET) & BRIDGE PLANS SN 090-0163 (WB I-74 OVER WASHINGTON STREET)

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DAILY & ASSOCIATES, ENGINEERS, INC.	N
PEORIA, ILLINOIS	

NS ILLINOIS DEPARTMENT OF TRANSPORTATION 발

SUMMARY OF QUANTITIES

DATE 02/14/2005

DRAWN BY CHECKED BY

TOTAL SHEET SHEETS NO. SECTION COUNTY TAZEWELL 1366 15 TO STA.

FED. ROAD DIST. NO. 4 ILLINOIS FED. AID PROJECT \* (90-11)R-2;90(13,14,14-1)R-1

STA.

SUMMARY OF QUANTITIES 90% FED 90% FED 10% STATE 10% STATE CONSTRUCTION TYPE CODE FOR ALL PLAN SETS INTERSTATE | INTERSTATE INTERSTATE ROADWAY ROADWAY ARTERIAL ARTERIAL RETAINING OVERHEAD BRIDGE LIGHTING 3 LANE 2 LANE ROADWAY ROADWAY BRIDGE BRIDGE BRIDGE WALL SIGNS SIGNALS (2A) TOTAL (2) (3) (4) (6) CODE NO. PAY ITEM UNIT J000-2A 1000-2A I000-2A J000-2A X581-2A X271-2A METER M4402020 CURB REMOVAL 300 300 M4402040 COMBINATION CURB AND GUTTER REMOVAL 1502 1020 M4402050 SIDEWALK REMOVAL 45,65 SQ M 362 362.37 M4402200 BITUMINOUS MEDIAN SURFACE REMOVAL SQ M M4402280 CONCRETE BARRIER REMOVAL M4402530 PAVED SHOULDER REMOVAL SQ M 14809 7998 6811 M4402600 PORTLAND CEMENT CONCRETE SHOULDER REMOVAL 342 342 SQ M M4405000 PAVED DITCH REMOVAL METER 1237 480 M4426225 CLASS B PATCHES, TYPE II, 250MM SQ M 709 709 M4426250 CLASS B PATCHES, TYPE II, 375MM SQ M 1491 369.4 1122 M4426450 CLASS B PATCHES, TYPE IV, 375MM SQ M 113 2359 M4429400 SAW CUTS M4430020 STRIP REFLECTIVE CRACK CONTROL TREATMENT METER 5768 5528 239.9 M4812000 AGGREGATE SHOULDERS, TYPE B M TON 3231 660 1207 1364 M4820000 BITUMINOUS SHOULDERS M TON 3289 3289 M4820200 BITUMINOUS SHOULDERS 200MM SQ M 514 514 M4820250 BITUMINOUS SHOULDERS 250MM SQ M 570 M4830250 PORTLAND CEMENT CONCRETE SHOULDERS - 250MM SQ M 7617 4040 3422 M4830290 PORTLAND CEMENT CONCRETE SHOULDERS - 290MM SQ M 8312 3545 4767 M5010240 CONCRETE REMOVAL CU M 122 122.2 306 M5010465 SLOPE WALL REMOVAL SQ M 306 M5010522 PIPE CULVERT REMOVAL 260 M5020100 STRUCTURE EXCAVATION CU M 378 £199 568 2552 M5020400 ROCK EXCAVATION FOR STRUCTURES 22.3 CILM 8.0 6.6 M5030030 PREFORMED JOINT SEAL 64MM M5030105 NEOPRENE EXPANSION JOINT 50MM METER 80 M5030300 CLASS MS CONCRETE CU M 41 M5030350 CONCRETE STRUCTURES CU M 2615 262 568 M5030360 CONCRETE SUPERSTRUCTURE CU M 2335.8 SQ M 8544.0 1538.0 M5030390 BRIDGE DECK GROOVING 1457.0 3799.0 M5030450 PROTECTIVE COAT SO M 10666.0 4787.0 2043.0 1624.0 2212.0 SQ M M5030710 FORMED CONCRETE REPAIR (DEPTH EQUAL TO OR LESS THAN 125MM) 4.0 M5041219 FURNISHING AND ERECTING PRECAST PRESTRESSED CONCRETE I-BEAMS, 1219MM METER 695.5

△ SFTY-3N □ SFTY-3C O Y080 Ø NON-PARTICIPATING

M5041372 FURNISHING AND ERECTING PRECAST PRESTRESSED CONCRETE I-BEAMS, 1372MM

M5050105 FURNISHING AND ERECTING STRUCTURAL STEEL

M5050405 FURNISHING AND ERECTING STRUCTURAL STEEL

(1) I-74 STA. 152+445.837 TO STA. 153+892.180 (2) I-74 STA. 153+892.180 TO STA. 154+970.000 (2A) I-74 EB STA. 154+780.000 TO STA. 157+666.230 & I-74 WB STA. 154+952.000 TO STA. 157+666.230 (3) MAIN STREET STA. 2+800.000 TO STA. 4+157.000 (4) MAIN STREET STA. 2+015.141 TO STA. 2+310.000, MAIN STREET STA. 2+402.933 TO STA. 2+800.000, & WASHINGTON STREET STA. 99+730.000 TO STA. 100+210.000 (5) BRIDGE PLANS SN 090-0160 (SN 090-0006) (WB I-74 OVER MAIN STREET) & BRIDGE PLANS SN 090-0163 (WB I-74 OVER WASHINGTON STREET)

METER

L SUM

KG

352

3290.0

(6) BRIDGE PLANS SN 090-0159 (SN 090-0005) (WB I-74 OVER ALTORFER LANE AND TP&W RAILROAD)
(7) BRIDGE PLANS SN 090-0156 (SN 090-0010 EB & SN 090-0011 WB) (RAMP K-2 OVER MAIN STREET AND RAMP J-3)
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	REVISIO	DNS	_
	NAME	DATE	I
DAILY & ASSOCIATES,			
ENGINEERS, INC.			
PEORIA, ILLINOIS			Ε
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ILLINOIS DEPARTMENT OF TRANSPORTATION

SUMMARY OF QUANTITIES

COUNTY SHEETS NO.
TAZEWELL 1366 16 F.A.I. SECTION 74 • STA. TO STA. FED. ROAD DIST. NO. 4 ILLINOIS FED. AID PROJECT

\* (90-11)R-2;90(13,14,14-1)R-1

URBAN 90% FED 10% STATE 90% FED 10% STATE

			INTERSTATE ROADWAY 3 LANE	INTERSTATE ROADWAY 2 LANE	INTERSTATE ROADWAY	ARTERIAL ROADWAY	ARTERIAL ROADWAY	BRIDGE	BRIDGE	BRIDGE	BRIDGE	RETAINING WALL	OVERHEAD SIGNS	LIGHTING	TRAFFIC SIGNALS
CODE NO. PAY ITEM	UNIT	TOTAL QUANTITY	(1) J000-2A	(2) J000-2A	(2A) 1000-2A	(3) 1000-2A	(4) J000-2A	(5) X281-2A	(6) X581-2A	(7) X271-2A	(8) X971-2A	(9) YOO7	Y002-1C	Y030-1E	Y031-1F
M5050410 STRUCTURAL STEEL REMOVAL	KG	1540.0	0000 ZA	0000 ZA	1000 24	1000 24	0000 ZM	AZOI ZA	X301 ZX	72 JI 24	1540.0	1001	1002 10	1030 IL	, 031 11
* M5070207 TREATED TIMBER LAGGING	SQ M	23.0										23.0			
₩ M5070209 UNTREATED TIMBER LAGGING	SQ M	1371										1371			
M5070213 FURNISHING SOLDIER PILES (BUILT-UP SECTION)	METER	1160										1160.4			
M5070215 FURNISHING SOLDIER PILES (W SECTION)	METER	233										233,3			
			470	1000			270					233.5		-	
M5080105 REINFORCEMENT BARS	KG	2140	470	1220		80	370								
M5080205 REINFORCEMENT BARS, EPOXY COATED	KG	538840		3790				85170	74290	127230	158600	89760			
M5110100 SLOPE WALL 100 MM	SQ M	2965.0						1108.0	1064.0	311.0	482.0				
M5110200 SLOPE WALL 150 MM	SQ M	107.0									107.0				
M5120160 FURNISHING STEEL PILES HP310X79	METER	132									132				
M5120166 FURNISHING STEEL PILES HP310X94	METER	292						292							
M5120170 FURNISHING STEEL PILES HP310X110	METER	504						504							
M5120175 FURNISHING STEEL PILES HP310X125	METER	604							603.5		-				
M5120180 FURNISHING STEEL PILES HP360X108	METER	524.5									524.5				
										100.0	324.0				
M5120190 FURNISHING STEEL PILES HP360X132	METER	186.0								186.0					
M5120210 FURNISHING STEEL PILES HP360X174	METER	627.0							627.0						
M5120315 DRIVING STEEL PILES	METER	2868.5						796.0	1230.0	186.0	656.5				
M5120460 TEST PILE STEEL HP310X79	EACH	2.0									2.0				
M5120475 TEST PILE STEEL HP310X125	EACH	1.0							1.0						
M5120480 TEST PILE STEEL HP360X108	EACH	1.0									1.0				
M5120490 TEST PILE STEEL HP360X132	EACH	2.0	-							2.0					<b></b>
M5120510 TEST PILE STEEL HP360X174	EACH	1							1						
M542E112 PRECAST REINFORCED CONCRETE FLARED END SECTIONS 300MM	EACH	:25				16	9								
M542E120 PRECAST REINFORCED CONCRETE FLARED END SECTIONS 450MM	EACH	3				2	1								
M542E128 PRECAST REINFORCED CONCRETE FLARED END SECTIONS 600MM	EACH	7	2	1		4									
M542E136 PRECAST REINFORCED CONCRETE FLARED END SECTIONS 750MM	EACH	4				3	1								
M542E536 PRECAST REINFORCED CONCRETE FLARED END SECTIONS, EQUIVALENT ROUND-SIZE 750MM	EACH	1					1								
M542E628 PRECAST REINFORCED CONCRETE FLARED END SECTIONS - ELLIPTICAL, EQUIVALENT ROUND-SIZ	EACH	1		1											
M542F012 METAL END SECTIONS 300MM	EACH	12	12												
M542I055 PIPE CULVERTS, CLASS A, TYPE 2 900MM	METER	29	29												
M542U425 PIPE CULVERTS, CLASS D, TYPE 2 450MM (TEMPORARY)	METER	4	4												
M5422120 PIPE CULVERTS, TYPE 1, REINFORCED CONCRETE - ARCH, EQUIVALENT ROUND-SIZE 600MM	METER			39											
		39		39											
M5429910 CONCRETE COLLAR	CU M	4				2.4	1.1								
M5500030 STORM SEWERS, CLASS A, TYPE 1 300MM	METER	396.0	9.0			186.0	201.0								
M5500050 STORM SEWERS, CLASS A, TYPE 1 450MM	METER	107.0				103.0	4.0								
M5500065 STORM SEWERS, CLASS A, TYPE 1 600MM	METER	23.5				23.5									

△ SFTY-3N
□ SFTY-3C
○ Y080
Ø NON-PARTICIPATING

\* SPECIALTY ITEM

SUMMARY OF QUANTITIES

FOR ALL PLAN SETS

(1) I-74 STA, 152+445.837 TO STA, 153+892,180 (2) I-74 STA, 153+892,180 TO STA, 154+970,000 (2A) I-74 EB STA, 154+780,000 TO STA, 157+666,230 & I-74 WB STA, 154+952,000 TO STA, 157+666,230 (3) MAIN STREET STA, 2+800,000 TO STA, 4+157,000 (4) MAIN STREET STA, 2+800,000 TO STA, 4+157,000, MAIN STREET STA, 2+402,933 TO STA, 2+800,000, & WASHINGTON STREET STA, 99+730,000 TO STA, 100+210,000 (5) BRIDGE PLANS SN 090-0160 (SN 090-0006) (WB I-74 OVER MAIN STREET) & BRIDGE PLANS SN 090-0163 (WB I-74 OVER WASHINGTON STREET)

(6) BRIDGE PLANS SN 090-0159 (SN 090-0005) (WB I-74 OVER ALTORFER LANE AND TP&W RAILROAD)
(7) BRIDGE PLANS SN 090-0156 (SN 090-0010 EB & SN 090-0011 WB) (RAMP K-2 OVER MAIN STREET AND RAMP J-3)
(8) BRIDGE PLANS SN 090-0009 (WB I-74 OVER CAMP STREET, FARM CREEK AND TP&W RAILROAD)
(9) RETAINING WALL SN 090-8512 (ALONG RAMP J-3) RETAINING WALL SN 090-8513 (ALONG RAMP K-2)

	REVISIONS
DA	NAME
DAILY & ASSOCIATES, ENGINEERS, INC. PEORIA, ILLINOIS	

ILLINOIS DEPARTMENT OF TRANSPORTATION

SUMMARY OF QUANTITIES

COUNTY TOTAL SHEET SHEETS NO.
TAZEWELL 1366 17 F.A.I. RTE. 74 SECTION STA. TO STA. FED. ROAD DIST. NO. 4 ILLINOIS FED. AID PROJECT

\* (90-11)R-2;90(13,14,14-1)R-1

SUMMARY OF QUANTITIES					90% FED 10% STATE							90%	FED STATE		
FOR ALL PLAN SETS								CONSTRUCT	ION TYPE C	ODE		10%	DIAIL		
			ROADWAY 3 LANE	INTERSTATE ROADWAY 2 LANE	ROADWAY	ARTERIAL ROADWAY	ARTERIAL ROADWAY	BRIDGE	BRIDGE	BRIDGE	BRIDGE	RETAINING WALL	OVERHEAD SIGNS	LIGHTING	TRAFFIC SIGNALS
CODE NO. PAY ITEM	UNIT	TOTAL QUANTITY	(1) J000-2A	(2) J000-2A	(2A) 1000-2A	(3) I000-2A	(4) J000-2A	(5) X281-2A	(6) X581-2A	(7) X <b>2]]</b> 1-2A	(8) X971-2A	(9) Y007	Y002-1C	Y030-1E	Y031-1F
M5500070 STORM SEWERS, CLASS A, TYPE 1 675MM	METER	6.0				6.0						ļ			
M5500075 STORM SEWERS, CLASS A, TYPE 1 750MM	METER	77.0	63.5			3.0	10.5								
M5500430 STORM SEWERS, CLASS A, TYPE 2 300MM	METER	364.0	104.0			260.0									
M5500450 STORM SEWERS, CLASS A, TYPE 2 450MM	METER	189.5				162.5	27.0								
M5500465 STORM SEWERS, CLASS A, TYPE 2 600MM	METER	1056.0	511.5	408.5		136.0									
M5500475 STORM SEWERS, CLASS A, TYPE 2 750MM	METER	128.0				124.0	4.0								
M5500485 STORM SEWERS, CLASS A, TYPE 2 900MM	METER	38.5		38.5											
M5500495 STORM SEWERS, CLASS A, TYPE 2 1050MM	METER	15.0		15.0											
M5500515 STORM SEWERS, CLASS A, TYPE 2 1650MM	METER	45.5		45.5											
M5500830 STORM SEWERS, CLASS A, TYPE 3 300MM	METER	64.5				64.5									
M5500865 STORM SEWERS, CLASS A, TYPE 3 600MM	METER	42.5	42.5												
M5500875 STORM SEWERS, CLASS A, TYPE 3 750MM	METER	161.0		161.0											
M5501230 STORM SEWERS, CLASS A, TYPE 4 300MM	METER	17.5				17.5									
M5501275 STORM SEWERS, CLASS A, TYPE 4 750MM	METER	16.5				16.5									
M5510025 STORM SEWER REMOVAL 300MM	METER	20.5		11.0			9.5							-	
M5510035 STORM SEWER REMOVAL 375MM	METER	31.0		31.0											
M5510040 STORM SEWER REMOVAL 400MM	METER	46.0	46.0												
M5510060 STORM SEWER REMOVAL GOOMM	METER	45.5	37.0			8.5									
M5510070 STORM SEWER REMOVAL 750MM	METER	42		39			2.5								
M5510080 STORM SEWER REMOVAL 900MM	METER	7				6.5								-	
M5510105 STORM SEWER REMOVAL 1500MM	METER	1		1											
M5510110 STORM SEWER REMOVAL 1650MM	METER	2		2											
M5870020 BRIDGE SEAT SEALER	SQ M	115								42	73				
M5900100 EPOXY CRACK SEALING	METER	34									34				
M5910100 GEOCOMPOSITE WALL DRAIN	SQ M	781										781			
M6010080 FRENCH DRAINS	CU M	29										29			
M6010125 PIPE DRAINS 300MM	METER	256	218.5	37											
M6010130 PIPE DRAINS 375MM	METER	11		10.5											
M6010135 PIPE DRAINS 450MM	METER	122		122											
M6010605 PIPE UNDERDRAINS 100MM	METER	3433	973	2459.5											
M6010610 PIPE UNDERDRAINS 150MM	METER	153.0		128.5		24.5									
M6010705 PIPE UNDERDRAINS 100MM (SPECIAL)	METER	1502.0	1435.0	67.0									.,		
M6010710 PIPE UNDERDRAINS 150MM (SPECIAL)	METER	2.0		2.0											
MGO21405 MANHOLES, TYPE A, 1.2M DIAMETER, TYPE 1 FRAME, OPEN LID	EACH	3.0		2.0		1.0									
M6021410 MANHOLES, TYPE A, 1.2M DIAMETER, TYPE 1 FRAME, CLOSED LID	EACH	21.0	1.0	3.0		× 14.0	3.0								
MGO21445 MANHOLES, TYPE A, 1.2M DIAMETER, TYPE 9 FRAME AND GRATE	EACH	2.0	2.0												
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Ø NON-PARTICIPATING

(1) I-74 STA. 152+445.837 TO STA. 153+892.180 (2) I-74 STA. 153+892.180 TO STA. 154+970.000 (2A) I-74 EB STA. 154+780.000 TO STA. 157+666.230 & I-74 WB STA. 154+952.000 TO STA. 157+666.230 (3) MAIN STREET STA. 2+800.000 TO STA. 4+157.000 (4) MAIN STREET STA. 2+015.141 TO STA. 2+310.000, MAIN STREET STA. 2+015.141 TO STA. 2+310.000, MAIN STREET STA. 2+402.933 TO STA. 2+800.000, & WASHINGTON STREET STA. 99+730.000 TO STA. 100+210.000 (5) BRIDGE PLANS SN 090-0160 (N 090-0006) (WB I-74 OVER MAIN STREET) & BRIDGE PLANS SN 090-0163 (WB I-74 OVER WASHINGTON STREET)

(6) BRIDGE PLANS SN 090-0159 (SN 090-0005) (WB I-74 OVER ALTORFER LANE AND TP&W RAILROAD)
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(8) BRIDGE PLANS SN 090-0009 (WB I-74 OVER CAMP STREET, FARM CREEK AND TP&W RAILROAD)
(9) RETAINING WALL SN 090-8512 (ALONG RAMP J-3) RETAINING WALL SN 090-8513 (ALONG RAMP K-2)

	REVISIO	ONS
	NAME	DATE
<b>LC7-1</b>		
DAILY & ASSOCIATES,		
ENGINEERS, INC.		
PEORIA, ILLINOIS		
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ILLINOIS DEPARTMENT OF TRANSPORTATION

SUMMARY OF QUANTITIES

TOTAL SHEE SHEETS NO.

F.A.I. RYE. SECTION COUNTY TAZEWELL 1366 18 STA. TO STA. FED. ROAD DIST. NO. 4 ILLINOIS FED. AID PROJECT

\* (90-11)R-2;90(13,14,14-1)R-1

10% STATE 10% STATE FOR ALL PLAN SETS CONSTRUCTION TYPE CODE INTERSTATE | INTERSTATE | INTERSTATE ROADWAY ROADWAY ARTERIAL ARTERIAL RETAINING ROADWAY 2 LANE ROADWAY ROADWAY BRIDGE BRIDGE BRIDGE BRIDGE WALL SIGNS LIGHTING SIGNALS TOTAL QUANTITY (2) (2A) (4) (6) CODE NO. PAY ITEM UNIT J000-2A J000-2A 1000-2A 1000-2A X281-2A X581-2A X271-2A X971-2A Y007 Y002-1C Y030-1E Y031-1F J000-2A M6021485 MANHOLES, TYPE A, 1.2M DIAMETER, TYPE 37 GRATE EACH 6,0 M6021610 MANHOLES, TYPE A, 1.5M DIAMETER, TYPE 1 FRAME, CLOSED LID M6021805 MANHOLES, TYPE A, 1.8M DIAMETER, TYPE 1 FRAME, OPEN LID EACH M6021810 MANHOLES, TYPE A, 1.8M DIAMETER, TYPE 1 FRAME, CLOSED LIC EACH M6021845 MANHOLES, TYPE A, 1.8M DIAMETER, TYPE 9 FRAME AND GRATE EACH M6023005 MANHOLES, SPECIAL, 1.2M DIAMETER EACH M6060010 CLASS SI CONCRETE (OUTLET) 17.2 6.6 M6060260 CONCRETE GUTTER, TYPE A 139.6 M6060270 CONCRETE GUTTER, TYPE A (MODIFIED) METER 843 499.7 342.8 M6060500 COMBINATION CONCRETE CURB AND GUTTER, TYPE B-15.30 METER 871 50.2 368 368.84 84 METER M6060600 COMBINATION CONCRETE CURB AND GUTTER, TYPE B-15.45 33.0 33.0 M6060700 COMBINATION CONCRETE CURB AND GUTTER, TYPE B-15.60 METER 4381.0 88.0 2888.0 1405.0 M6062100 COMBINATION CONCRETE CURB AND GUTTER, TYPE M-15.15 METER 22.7 12.7 10.0 M6062400 COMBINATION CONCRETE CURB AND GUTTER, TYPE M-15.60 METER 11.0 18.2 M6063600 CONCRETE MEDIAN SURFACE, 100MM 2133.3 23.0 17.0 SQ M 2093.3 M6064100 CONCRETE MEDIAN, TYPE SB-15.30 SQ M 374.0 374.0 M6064800 CONCRETE MEDIAN, TYPE SM SQ M 12.0 12.0 46066000 CORRUGATED MEDIAN SQ M 57.1 51.1 M6300100 STEEL PLATE BEAM GUARD RAIL, TYPE A METER 259 11.43 198.12 49.53 M6320030 GUARDRAIL REMOVAL METER 1283 703 284 197 M6330610 REMOVE AND RE-ERECT STEEL PLATE BEAM GUARD RAIL 1291 1291 M6370120 CONCRETE BARRIER, DOUBLE FACE (MODIFIED) METER 566 566 M6370140 CONCRETE BARRIER, SINGLE FACE (MODIFIED) METER 1372.00 1372.00 M6420015 SHOULDER RUMBLE STRIP 19080 13202.2 METER M6640100 CHAIN LINK FENCE, 1.2 METER 192.00 192,00 M6640120 CHAIN LINK FENCE, 1.8 METER METER 29 28.5 M6640650 CHAIN LINK GATES, 1.8M X 2.4M SINGLE EACH M6641920 CHAIN LINK FENCE REMOVAL 165 M6641930 CHAIN LINK FENCE TO BE REMOVED AND RE-ERECTED METER 187.0 187.0 352.9 M7030100 SHORT- TERM PAVEMENT MARKING METER 24194.9 20993.0 2849.0 M7030220 TEMPORARY PAVEMENT MARKING - LINE 100MM 11201 M7030240 TEMPORARY PAVEMENT MARKING - LINE 150MM METER 1400 1400 527 527 M7030250 TEMPORARY PAVEMENT MARKING - LINE 200MM METER M7030510 PAVEMENT MARKING TAPE, TYPE III - LETTERS AND SYMBOLS M7030520 PAVEMENT MARKING TAPE, TYPE III 100MM METER 29947 25993 3954 M7030540 PAVEMENT MARKING TAPE, TYPE III 150MM METER 749 749

90% FFD

△ SFTY-3N □ SFTY-3C O YOSO Ø NON-PARTICIPATING

\* SPECIALTY ITEM

(1) I-74 STA. 152+445.837 TO STA. 153+892.180 (2) I-74 STA. 153+392.180 TO STA. 154+970.000 (2A) I-74 EB STA. 154+780.000 TO STA. 157+666.230 & I-74 WB STA. 154+952.000 TO STA. 157+666.230 (3) MAIN STREET STA. 2+800.000 TO STA. 4+157.000 (4) MAIN STREET STA. 2+015.141 TO STA. 2+310.000, MAIN STREET STA. 2+015.141 TO STA. 2+310.000, & WASHINGTON STREET STA. 99+730.000 TO STA. 100+210.000 (5) BRIDGE PLANS SN 090-0160 (SN 090-0006) (WB I-74 OVER WASHINGTON STREET)

SUMMARY OF QUANTITIES

(6) BRIDGE PLANS SN 090-0159 (SN 090-0005) (WB I-74 OVER ALTORFER LANE AND TP&W RAILROAD)
(7) BRIDGE PLANS SN 090-0156 (SN 090-0010 EB & SN 090-0011 WB) (RAMP K-2 OVER MAIN STREET AND RAMP J-3)
(8) BRIDGE PLANS SN 090-0009 (WB I-74 OVER CAMP STREET, FARM CREEK AND TP&W RAILROAD)
(9) RETAINING WALL SN 090-8512 (ALONG RAMP J-3) RETAINING WALL SN 090-8513 (ALONG RAMP K-2)

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DAILY & ASSOCIATES, ENGINEERS, INC.			
PEORIA, ILLINOIS			D

90% FED

ILLINOIS DEPARTMENT OF TRANSPORTATION &

SUMMARY OF QUANTITIES

DRAWN BY CHECKED BY DATE 02/14/2005

F.A.I. RTE. 74 SECTION TO STA. FED. ROAD DIST. NO. 4 | ILLINOIS | FED. AID PROJECT

• (90-11)R-2;90(13,14,14-1)R-1

	SUMMARY OF QUANTITIES					90% FED .0% STATE								FED STATE		
	FOR ALL PLAN SETS			INTERSTATE	INTERSTATE	INTERSTATE			CONSTRUCT	ION TYPE C	ODE	<u> </u>	1		T	
				ROADWAY 3 LANE	ROADWAY 2 LANE	ROADWAY	ARTERIAL ROADWAY	ARTERIAL ROADWAY	BRIDGE	BRIDGE	BRIDGE	BRIDGE	RETAINING WALL	OVERHEAD SIGNS	LIGHTING	TRAFFIC SIGNALS
CODE NO.	PAY ITEM	UNIT	TOTAL QUANTITY	(1) J000-2A	(2) J000-2A	(2A) 1000-2A	(3) 1000-2A	(4) J000-2A	(5) X281-2A	(6) X581-2A	(7) X <b>231</b> -2A	(8) X971-2A	(9) Y007	Y002-1C	Y030-1E	Y031-1F
₩7030550	PAVEMENT MARKING TAPE, TYPE III 200MM	METER	52		52											
₩7030560	PAVEMENT MARKING TAPE, TYPE III 300MM	METER	218	218												
<b>Ж</b> м7030580	PAVEMENT MARKING TAPE, TYPE III 600MM	METER	163	163												
M7030610	TEMPORARY PAINT PAVEMENT MARKING, LETTERS AND SYMBOLS	SQ M	9					8.69								
M7030620	TEMPORARY PAINT PAVEMENT MARKING LINE 100MM	METER	98					98.06								
M7030650	TEMPORARY PAINT PAVEMENT MARKING LINE GOOMM	METER	21					21.2								
M7031000	WORK ZONE PAVEMENT MARKING REMOVAL	SQ M	6166	5497		87	547	35,29								
M7040100	TEMPORARY CONCRETE BARRIER	METER	1470	832.65	637											
M7040200	RELOCATE TEMPORARY CONCRETE BARRIER	METER	156	155.55												
M7040300	RELOCATE TEMPORARY CONCRETE BARRIER (STATE OWNED)	METER	564		564											
M7040400	TEMPORARY CONCRETE BARRIER (STATE OWNEO)	METER	1302	1302.35												
<b>₩</b> M7200100	SIGN PANEL - TYPE 1	SQ M	15.00	7.00	7.00		1.00									
₩ M7200200	SIGN PANEL - TYPE 2	SO M	19	14	5											
₩ M7200300	SIGN PANEL - TYPE 3	SQ M	298	39	146			24						89		
★ M7210100	SIGN PANEL OVERLAY	SQ M	4.00		4.00											
₩7210105	SIGN PANEL OVERLAY, SPECIAL	SQ M	61	28	33											
M7240330	REMOVE SIGN PANEL - TYPE 3	SQ M	13				13									
	RELOCATE SIGN PANEL - TYPE 3	SQ M	49				49									
	STRUCTURAL STEEL SIGN SUPPORT - BREAKAWAY	KG	8840	1880	6080			880								
	TELESCOPING STEEL SIGN SUPPORT	METER	5				5									
							3									
	METAL POST - TYPE A	METER	9	4	5											
	METAL POST - TYPE B	METER	8		8								l			
M7300100	WOOD SIGN SUPPORT	METER	133	76	42		6	10								
M7330050	OVERHEAD SIGN STRUCTURE - SPAN, TYPE I-S (1.22M X 1.37M)	METER	23.0											23.0		
M7340100	CONCRETE FOUNDATIONS	CU M	33.4	7.7	21.5		4.2									
M7340200	DRILLED SHAFT CONCRETE FOUNDATIONS	CU M	31.6											31.6		
∦ M7800100	THERMOPLASTIC PAVEMENT MARKING - LETTERS AND SYMBOLS	SQ M	59.2				42.6	16.6								
₩7800105	THERMOPLASTIC PAVEMENT MARKING - LINE 100MM	METER	5550.0				5378.0	172.0								
₩7800115	THERMOPLASTIC PAVEMENT MARKING - LINE 150MM	METER	1442.8				1263.0	179.8								
₩7800120	THERMOPLASTIC PAVEMENT MARKING - LINE 200MM	METER	945.0				785.0	160.0								
₩7800125	THERMOPLASTIC PAVEMENT MARKING - LINE 300MM	METER	579				558	21		'						
₩ M7800140	THERMOPLASTIC PAVEMENT MARKING - LINE GOOMM	METER	106				85	21								
<b>★</b> M7800600	EPOXY PAVEMENT MARKING - LETTERS AND SYMBOLS	SQ M	41		7			34								
₩ M7800605	EPOXY PAVEMENT MARKING - LINE 100MM	METER	1030					1030								
₩7800615	EPOXY PAVEMENT MARKING - LINE 150MM	METER	444					444								
₩ M7800620	EPOXY PAVEMENT MARKING - LINE 200MM	METER	472					472								
													<u> </u>			

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○ Y080
Ø NON-PARTICIPATING

\* SPECTALTY THEMS

(1) I-74 STA, 152+445.837 TO STA, 153+892.180
(2) I-74 STA, 153+892.180 TO STA, 154+970.000
(2A) I-74 EB STA, 154+780.000 TO STA, 157+666.230 & I-74 WB STA, 154+952.000 TO STA, 157+666.230
(3) MAIN STREET STA, 2+800.000 TO STA, 4+157.000
(4) MAIN STREET STA, 2+800.000 TO STA, 2+310.000, MAIN STREET STA, 2+402.933 TO STA, 2+800.000, & WASHINGTON STREET STA, 99+730.000 TO STA, 100+210.000
(5) BRIDGE PLANS SN 090-0160 (SN 090-0066) (WB I-74 OVER MAIN STREET) & BRIDGE PLANS SN 090-0163 (WB I-74 OVER WASHINGTON STREET)

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	REVISION	ONS	Ī
<b>D</b> A	NAME	DATE	]
DAILY & ASSOCIATES, ENGINEERS, INC. PEORIA, ILLINOIS			

ILLINOIS DEPARTMENT OF TRANSPORTATION

SUMMARY OF QUANTITIES

DRAWN BY

DATE 02/14/2005 CHECKED BY

RTE. 74 90% FED FED. ROAD DIST. NO. 4 ILLINOIS FED. AID PROJECT SUMMARY OF QUANTITIES 90% FFD 90% FFD 5%STATE 10% STATE 10% STATE 5% CITY \* (90-11)R-2;90(13,14,14-1)R-1 FOR ALL PLAN SETS CONSTRUCTION TYPE CODE TRAFFIC SHNALS INTERSTATE | INTERSTATE | INTERSTATE AT BLACKJACK BLVD ROADWAY RETAINING OVERHEAD ROADWAY ARTERIAL 3 LANE 2 LANE ROADWAY ROADWAY BRIDGE BRIDGE BRIDGE BRIDGE WALL SIGNS LIGHTING SIGNALS TOTAL QUANTITY (2) (2A) (3) (4) (5) (6) (7) (8) CODE NO. PAY ITEM UNIT Y002-1C Y030-1E Y031-1F AS-IFSX X971-2A J000-2A J000-2A I000-2A I000-2A X281-2A X581-2A Y007 J000-2A METER M7800625 EPOXY PAVEMENT MARKING - LINE 300MM M7800640 EPOXY PAVEMENT MARKING - LINE 600MM METER 93 93 \* M7802010 POLYUREA PAVEMENT MARKING TYPE I - LINE 100MM 9315 3760 METER 29917 5557 11201 84 M7802015 POLYUREA PAVEMENT MARKING TYPE I - LINE 150MM METER 4361 1400 526 M7802020 POLYUREA PAVEMENT MARKING TYPE I - LINE 200MM 1314 MT802030 POLYUREA PAVEMENT MARKING TYPE I - LINE 300MM METER 510 286 50 \* M7802060 POLYUREA PAVEMENT MARKING TYPE I - LINE 600MM METER M7830100 PAVEMENT MARKING REMOVAL SQ M 391 351 40 M8100240 CONDUIT IN TRENCH, 30MM DIA., PVC METER 33 28 3431 M8100260 CONDUIT IN TRENCH, 50MM DIA., PVC METER 2812 METER M8100280 CONDUIT IN TRENCH, 75MM DIA., PVC 880 844 **36**- 25 M8100290 CONDUIT IN TRENCH, 90MM DIA., PVC 64 <del>64</del> 22 METER M8101450 CONDUIT PUSHED. 50MM DIA. PVC METER 344.0 29.0 107.0 43 64 METER 32.0 M8101470 CONDUIT PUSHED, 75MM DIA., PVC 32.0 M8101480 CONDUIT PUSHED, 90MM DIA., PVC 107,043 64 METER 107.0 M8110130 CONDUIT ATTACHED TO STRUCTURE, 25MM DIA., GALVANIZED STEEL METER 344.0 344.0 M8110190 CONDUIT ATTACHED TO STRUCTURE, 90MM DIA., GALVANIZED STEEL METER 6.0 6.0 M8120210 CONDUIT EMBEDDED IN STRUCTURE, 25 MM DIA. PVC METER 17.0 17.0 M8120230 CONDUIT EMBEDDED IN STRUCTURE, 50 MM DIA. PVC 67.0 METER 67.0 M8120250 CONDUIT EMBEDDED IN STRUCTURE, 75 MM DIA, PVC 386.0 METER 386.0 M8130120 JUNCTION BOX, STAINLESS STEEL, ATTACHED TO STRUCTURE, 150MM X 150MM X 100MM EACH 41.0 41.0 M8130415 JUNCTION BOX, STAINLESS STEEL, EMBEDDED IN STRUCTURE, 300MM X 300MM X 200MM EACH 8.0 8.0 M8131500 JUNCTION BOX, NON-METALLIC, EMBEDDED IN STRUCTURE, 675MM X 400MM X 300MM EACH 3.0 M8150200 TRENCH AND BACKFILL FOR ELECTRICAL WORK METER 3158.2 23.7 1219.0 1901.0 M8150205 TRENCH AND BACKFILL FOR ELECTRICAL WORK (SPECIAL) 8.4 M8170030 ELECTRIC CABLE IN CONDUIT, 600V (XLP-TYPE USE) 1/C NO. 8 METER 1609 1609 <u>-51</u> 24 27 M8170040 ELECTRIC CABLE IN CONDUIT, 600V (XLP-TYPE USE) 1/C NO. 6 METER 2991 2940 M8170050 ELECTRIC CABLE IN CONDUIT, 600V (XLP-TYPE USE) 1/C NO. 4 1807 1807 M8170060 ELECTRIC CABLE IN CONDUIT, 600V (XLP-TYPE USE) 1/C NO. 2 METER 5400 5400 M8170090 ELECTRIC CABLE IN CONDUIT, 600V (XLP-TYPE USE) 1/C NO. 3/0 METER 45.0 45.0 M8300415 LIGHT POLE, ALUMINUM, 13.5M M.H., 2.4M DAVIT ARM EACH 4.0 M8301815 LIGHT POLE, ALUMINUM, TRANSFORMER BASE, 13.5M M.H., 2.4M DAVIT ARM EACH 8.0 M8360100 LIGHT POLE FOUNDATION, 600MM DIAMETER METER 30.0 30.0 M8370100 LIGHT TOWER FOUNDATION METER 62.6 62.6 M8731220 ELECTRIC CABLE IN CONDUIT, SIGNAL NO. 14 3C METER 63 <del>63</del> 26 o -853 M8731240 ELECTRIC CABLE IN CONDUIT, SIGNAL NO. 14 5C METER 853

O Y080

Ø NON-PARTICIPATING

\* SPECIALTY ITEMS

(1) I-74 STA. 152+445.837 TO STA. 153+892.180 (2) I-74 STA. 153+892.180 TO STA. 154+970.000 (2A) I-74 EB STA. 154+780.000 TO STA. 157+666.230 & I-74 WB STA. 154+952.000 TO STA. 157+666.230 (3) MAIN STREET STA. 2+800.000 TO STA. 4+157.000 (4) MAIN STREET STA. 2+800.000 TO STA. 2+310.000, MAIN STREET STA. 2+402.933 TO STA. 2+800.000, & WASHINGTON STREET STA. 99+730.000 TO STA. 100+210.000 (5) BRIDGE PLANS SN 090-0160 (SN 090-0006) (WB I-74 OVER MAIN STREET) & BRIDGE PLANS SN 090-0163 (WB I-74 OVER WASHINGTON STREET)

BRIDGE PLANS SN 090-0159 (SN 090-0005) (WB I-74 OVER ALTORFER LANE AND TP&W RAILROAD)
BRIDGE PLANS SN 090-0156 (SN 090-0010 EB & SN 090-0011 WB)
(RAMP K-2 OVER MAIN STREET AND RAMP J-3)
BRIDGE PLANS SN 090-0009 (WB I-74 OVER CAMP STREET,
FARM CREEK AND TP&W RAILROAD)

RETAINING WALL SN 090-8512 (ALONG RAMP J-3) RETAINING WALL SN 090-8513 (ALONG RAMP K-2)

<b>D</b> A	NAME
DAILY & ASSOCIATES, ENGINEERS, INC. PEORIA, ILLINOIS	

REVISIONS

ILLINOIS DEPARTMENT OF TRANSPORTATION

SUMMARY OF QUANTITIES

DRAWN BY CHECKED BY

DATE 02/14/2005

TOTAL SHEET SHEETS NO.

TAZEWELL 1366 20

COUNTY

TO STA.

SECTION

URBAN URBAN 0% FED 90% FED 10% STATE 90% FED SUMMARY OF QUANTITIES 10% STATE 5% CITY FOR ALL PLAN SETS CONSTRUCTION TYPE CODE INTERSTATE INTERSTATE INTERSTATE TRAFFIC EIGNALS ARTERIAL ARTERIAL RETAINING OVERHEAD TRAFFIC ROADWAY ROADWAY ROADWAY 2 LANE ROADWAY ROADWAY BRIDGE BRIDGE BRIDGE BRIDGE WALL SIGNS LIGHTING SIGNALS (2) (2A) (3) (4) (5) (6) (7) CODE NO. PAY ITEM Y002-10 Y031-1F X971-2A Y030-1E J000-2A J000-2A I000-2A 1000-2A J000-2A X281-2A X581-2A X271-2A Y007 M8731250 ELECTRIC CABLE IN CONDUIT, SIGNAL NO. 14 7C METER 244.0 M8731510 ELECTRIC CABLE IN CONDUIT, LEAD-IN, NO. 18 3 PAIR 33.6 33.6 177.0 M8731800 ELECTRIC CABLE IN CONDUIT, SERVICE, NO. 6 2 C M8750510 TRAFFIC SIGNAL POST, GALVANIZED STEEL 4.85 METER 3.0 3.0 EACH M8770760 STEEL COMBINATION MAST ARM ASSEMBLY AND POLE 11.58 METER 2:0 EACH 2.0 MB780100 CONCRETE FOUNDATION, TYPE A M8780200 CONCRETE FOUNDATION, TYPE D METER 2.2 2.2 1,1 M8780300 CONCRETE FOUNDATION, TYPE E 600MM DIAMETER METER M8780400 CONCRETE FOUNDATION, TYPE E 750MM DIAMETER METER M8860100 DETECTOR LOOP, TYPE I METER 49.0 49.0 M8860400 DETECTOR LOOP, SPECIAL METER MX030199 TEMPORARY PAVEMENT SQ M 12378.0 6525.0 5853.0 MXO30217 PIPE CULVERT REMOVAL 375MM METER 31.0 31.0 MX030218 PIPE CULVERT REMOVAL 450MM MX030345 LIGHTWEIGHT CELLULAR CONCRETE FILL 51.7 51.7 CU M MX030396 FILL EXISTING STORM SEWERS CU M 100 99.5 MX030472 FORM LINER GRID AND FIN SURFACE 1492.3 MX032083 GUARDRAIL AGGREGATE EROSION CONTROL M TON 350 223 127 63.0 278.0 MX032134 BRACED EXCAVATION 5060 165.0 CU M MX032138 PIPE ELBOW 600MM EACH 6.0 MX032186 PIPE ELBOW 300MM EACH 25 25 154 MXO32188 CLASS SI CONCRETE, SPECIAL 154,2 CU M MX032693 REMOVE TEMPORARY CONCRETE BARRIER, STATE OWNED MX033104 PIPE ELBOW 450MM EACH 12 \* MX033109 DRILLING AND SETTING SOLDIER PILES CU M 749 749 MX033182 APPLY DUST SUPPRESSION AGENTS UNIT 1676.0 627.0 352.0 551.0 146.0 MX033183 SOIL STABILIZERS 46268 13500 9450 18134 5184 KG MX033192 AGGREGATE SUBBASE M TON 39026 18355 19945 \* MX033194 WHITEWASH SQ M 46448.0 24710.0 21738.0 MX033447 PIPE CULVERT REMOVAL 600MM METER MX033450 CONCRETE BARRIER, DOUBLE FACE (SPECIAL) CU M MX033456 NONINTRUSIVE DETECTOR POLE 9.1 METER EACH MX033460 WET TEMPORARY PAVEMENT MARKING TAPE, TYPE III, 100 MM METER 342 342 MX033462 REMOVAL AND DISPOSAL OF TEMPORARY CONCRETE BARRIER (STATE OWNED) 708 707.6 MX203010 SPECIAL EXCAVATION CU M 11470.0 11470

TOTAL SHEET SHEETS NO. SECTION RTE. TAZEWELL 1366 21 74 TO STA. FED. ROAD DIST. NO. 4 ILLINOIS FED. AID PROJECT

5% STATE \* (90-11)R-2:90(13.14.14-1)R-1

AT BLACKJACK BLVO

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△ SFTY-3N
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Ø NON-PARTICIPATING

\* SPECIALTY ITEMS

MX406M20 LEVELING BINDER (MACHINE METHOD), SUPERPAVE N70

(1) I-74 STA. 152+445.837 TO STA. 153+892.180 (2) I-74 STA. 153+892.180 TO STA. 154+970.000 (2A) I-74 EB STA. 154+780.000 TO STA. 157+666.230 & I-74 WB STA. 154+952.000 TO STA. 157+666.230 (3) MAIN STREET STA. 2+800.000 TO STA. 4+157.000 (4) MAIN STREET STA. 2+015.141 TO STA. 2+310.000, MAIN STREET STA. 2+015.141 TO STA. 2+310.000, WASHINGTON STREET STA. 99+730.000 TO STA. 100+210.000 (5) BRIDGE PLANS SN 090-0160 (SN 090-0006) (WB I-74 OVER MAIN STREET) & BRIDGE PLANS SN 090-0163 (WB I-74 OVER WASHINGTON STREET)

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(6) BRIDGE PLANS SN 090-0159 (SN 090-0005) (WB I-74 OVER ALTORFER LANE AND TP&W RAILROAD)
(7) BRIDGE PLANS SN 090-0156 (SN 090-0010 EB & SN 090-0011 WB) (RAMP K-2 OVER MAIN STREET AND RAMP J-3)
(8) BRIDGE PLANS SN 090-0009 (WB I-74 OVER CAMP STREET, FARM CREEK AND TP&W RAILROAD)
(9) RETAINING WALL SN 090-8512 (ALONG RAMP J-3) RETAINING WALL SN 090-8513 (ALONG RAMP K-2)

	REVI
	NAME
76.	
DAILY & ASSOCIATES,	
ENGINEERS, INC.	
PEORIA, ILLINOIS	
	J

ILLINOIS DEPARTMENT OF TRANSPORTATION

SUMMARY OF QUANTITIES

DRAWN BY

DATE 02/14/2005 CHECKED BY

COUNTY TOTAL SHEET SHEET SHEETS NO. TAZEWELL 1366 22 F.A.I. RTE. 74 SECTION TO STA.

URBAN 90% FED 5% STATE 5% CITY • (90-11)R-2;90(13,14,14-1)R-1

FED. ROAD DIST. NO. 4 ILLINOIS FED. AID PROJECT

TRAFFIC SIGNALS

AT BLACKJACK BLVD Yosi-IF

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	SUMMARY OF QUANTITIES				90% FED 10% STATE								FED STATE			
	FOR ALL PLAN SETS			INTERSTATE	INTERSTATE	INTERSTATE		Γ	CONSTRUCT	ION TYPE C	ODE T			Γ		
				ROADWAY 3 LANE	ROADWAY 2 LANE	ROADWAY	ARTERIAL ROADWAY	ARTERIAL ROADWAY	BRIDGE	BRIDGE	BRIDGE	BRIDGE	RETAINING WALL	OVERHEAD SIGNS	LIGHTING	TRAFFIC SIGNALS
	CODE NO. PAY ITEM	UNIT	TOTAL QUANTITY	(1) J000-2A	(2) J000-2A	(2A) 1000-2A	(3) 1000-2A	(4) J000-2A	(5) X281-2A	(6) X581-2A	(7) X2 <b>7</b> [-2A	(8) X971-2A	(9) Y007	Y002-1C	Y030-1E	Y031-1F
	MX406022 BITUMINOUS CONCRETE SURFACE COURSE, SUPERPAVE, MIX "D", N50	M TON	544	3000 ZA	0000 ZA	1000 24	1000 24	544.2	AZOI ZA	A302 ER	AEJI ER	NSII EN	1001	1002 10	1000 12	10011
	MX406024 BITUMINOUS CONCRETE SURFACE COURSE, SUPERPAVE, MIX "D", N70	M TON	3607		187.5		3419									
	MX406066 POLYMERIZED BITUMINOUS CONCRETE SURFACE COURSE, SUPERPAVE, MIX "E", N90	M TON	3905			3905										
	MX406214 BITUMINOUS CONCRETE BINDER COURSE, SUPERPAVE, IL-19.0, N50	M TON	544					544.2								
,	MX406216 BITUMINOUS CONCRETE BINDER COURSE, SUPERPAVE, IL-19.0, N70	M TON	6836		281		6555									
- '-	MX406248 POLYMERIZED BITUMINOUS CONCRETE BINDER COURSE, SUPERPAVE, IL-19.0, N90	M TON	5845			5845										
	MX406295 BITUMINOUS CONCRETE BINDER COURSE, SUPERPAVE, IL-19.0L (LOW ESAL)	M TON	14288	7656	6629			3								
	MX500133 FLOATING BEARINGS, FIXED - 1850 KN	EACH	4								4					
	MX500325 FLOATING BEARINGS, GUIDED EXPANSION, 1500 KN	EACH	16								4	12			-	
									ļ			12				
	MX500335 FLOATING BEARINGS, GUIDED EXPANSION, 2000 KN	EACH	8								8					
	MX504002 FURNISHING AND ERECTING PRECAST PRESTRESSED CONCRETE BULB T-BEAMS 1829 MM	METER	380						380							
*	MX509Q25 ALUMINUM RAILING, TYPE H, SPECIAL	METER	117						117							
	MXGO2751 INLET-MANHOLE, TYPE G-1, 1.2M DIAMETER, SPECIAL	EACH	5				5									
	MXG02756 INLET-MANHOLE, TYPE G-1, 1.5M DIAMETER, SPECIAL	EACH	22				20	2								
	MX637112 CONCRETE BARRIER TRANSITION (MODIFIED)	METER	10.0	10.0												
	MX704005 TEMPORARY CONCRETE BARRIER (TO REMAIN PERMANENTLY)	METER	106.8		106.8											
	MX704200 REMOVE TEMPORARY CONCRETE BARRIER	METER	1470	832.65	637											
×	MX720100 TEMPORARY SIGN PANEL ASSEMBLY	SQ M	60	32.3	28.1											
	MX721010 COMPOSITE TEMPORARY SIGN OVERLAY	SQ M	35	22	12.9											
	MX733010 OVERHEAD SIGN STRUCTURE - CANTILEVER, TYPE II-C-S (1),90M X 1.68M)	METER	9.00											9		
*	MX871055 FIBER OPTIC CABLE IN CONDUIT, NO. 62.5/125, MM12F SM12F	METER	1516													1516
ء. ماد	MX873027 ELECTRIC CABLE IN CONDUIT, GROUNDING, NO. 6 1C	METER	177													
4	MX877017 STEEL COMBINATION MAST ARM ASSEMBLY AND POLE 15,85 METER	EACH	1					<u> </u>	1							_1_
	MX877020 STEEL COMBINATION MAST ARM ASSEMBLY AND POLE 16,76 METER	EACH	3													3 2
									ļ							
	MX878030 CONCRETE FOUNDATION, TYPE E 900MM DIAMETER	METER	25.0													9 25.0
*	MZ008830 DRILLED SHAFT IN SOIL 915MM	METER	25.5								25.5					
*	MZOO8880 DRILLED SHAFT IN SOIL 1830MM	METER	1								1			<del> </del>		
*	MZO08930 DRILLED SHAFT IN ROCK 760MM	METER	21								21					
->	MZO08980 DRILLED SHAFT IN ROCK 1830MM	METER	17								17					
	MZ017205 DOWEL BARS 38MM	EACH	4313.0	21.0		3180.0	1112.0								-	
	MZO21500 EXPANSION JOINT 75MM	METER	118.8		74.8	44.0										
	MZ022400 FABRIC REINFORCED ELASTOMERIC TROUGH	METER	36.9								17.5	19.4				
	MZ022800 FENCE REMOVAL	METER	137.0	137.0				<b> </b>					ļ	<u> </u>		
	MZ047300 PROTECTIVE SHIELD	SQ M	2959						1099	310		1550				
	X0301840 DRILL AND GROUT #35 TIE BARS	EACH	1308	196			1112							<u> </u>		
	X0321809 PERMANENT GROUND ANCHOR	EACH	204.0										204.0			
		1	1						<u> </u>			<u> </u>				

△ SFTY-3N
□ SFTY-3C
○ Y080
Ø NON-PARTICIPATING

\* SPECIALTY ITEMS

(1) I-74 STA. 152+445.837 TO STA. 153+892.180 (2) I-74 STA. 153+392.180 TO STA. 154+970.000 (2A) I-74 EB STA. 154+780.000 TO STA. 157+666.230 & I-74 WB STA. 154+952.000 TO STA. 157+666.230 (3) MAIN STREET STA. 2+800.000 TO STA. 4+157.000 (4) MAIN STREET STA. 2+015.141 TO STA. 2+310.000, MAIN STREET STA. 2+02.933 TO STA. 2+800.000, & WASHINGTON STREET STA. 99+730.000 TO STA. 100+210.000 (5) BRIDGE PLANS SN 090-0160 (SN 090-0006) (WB I-74 OVER MAIN STREET) & BRIDGE PLANS SN 090-0163 (WB I-74 OVER WASHINGTON STREET)

(6) BRIDGE PLANS SN 090-0159 (SN 090-0005) (WB I-74 OVER ALTORFER LANE AND TP&W RAILROAD)
(7) BRIDGE PLANS SN 090-0156 (SN 090-0010 EB & SN 090-0011 WB) (RAMP K-2 OVER MAIN STREET AND RAMP J-3)
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(9) RETAINING WALL SN 090-8512 (ALONG RAMP J-3) RETAINING WALL SN 090-8513 (ALONG RAMP K-2)

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AILY & ASSOCIATES.	
ENGINEERS, INC.	
PEORIA, ILLINOIS	

| DATE | ILLINOIS DEPARTMENT OF TRANSPORTATION

SUMMARY OF QUANTITIES

DATE 02/14/2005

DRAWN BY CHECKED BY

F.A.I. RTE. URBAN 90% FED FED. ROAD DIST. NO. 4 ILLINOIS FED. AID PROJECT 90% FED 90% FFD 5% STATE 10% STATE 10% STATE \* (90-11)R-2;90(13,14,14-1)R-1 CONSTRUCTION TYPE CODE 5% CITY INTERSTATE | INTERSTATE | INTERSTATE TRAFFIC SIGNALS RETAINING OVERHEAD ROADWAY ROADWAY ARTERIAL ARTERIAL ROADWAY AT BLACKJACK BLUD ROADWAY ROADWAY BRIDGE BRIDGE BRIDGE BRIDGE WALL SIGNS LIGHTING SIGNALS (2A) (2) (3) (4) (5) (6) Y631-1F J000-2A J000-2A I000-2A X281-2A X581-2A X271-2A X971-2A Y002-10 Y030-1E J000-2A Y007 2-1 49 <del>3</del> 2 0.5 0.5 7-4

△ SFTY-3N □ SFTY-3C O Y080

Ø NON-PARTICIPATING

CODE NO. PAY ITEM

\* 0 X0323677 STREET SWEEPING

X0323678 DUST CONTROL PADS

X0323778 DRAINAGE SCUPPERS, TYPE 1 X0323779 DRAINAGE SCUPPERS, TYPE 2

XO323830 DRAINAGE SCUPPERS, DS-11

X0323968 HIGHWAY-RAIL INFORMATION SIGN

\* X0323970 UNDERPASS LUMINAIRE, INSTALL ONLY

\* X0323971 HIGH MAST LUMINAIRE, INSTALL ONLY

X0323959 FORM LINER MOCKUP

X0504200 CONCRETE HEADWALL

X0976500 END SECTIONS TO BE REMOVED

X4207500 CONCRETE PAVEMENT WARRANTY

X7015000 CHANGEABLE MESSAGE SIGN

X8350100 LIGHT TOWER, INSTALL ONLY

Z0000100 ABANDON EXISTING CULVERT

X6020065 INLETS, TYPE G-1, DOUBLE (SPECIAL)

X6700410 ENGINEER'S FIELD OFFICE, TYPE A (SPECIAL)

X7011015 TRAFFIC CONTROL AND PROTECTION (EXPRESSWAYS)

X8800020 SIGNAL HEAD ,LED, 1-FACE, 3-SECTION, MAST-ARM MOUNTED X8800035 SIGNAL HEAD ,LED, 1-FACE, 3-SECTION, BRACKET MOUNTED

X8800038 SIGNAL HEAD ,LED, 1-FACE, 4-SECTION, MAST ARM MOUNTED

X8800040 SIGNAL HEAD ,LED, 1-FACE, 5-SECTION, BRACKET MOUNTED

X8810610 PEDESTRIAN SIGNAL HEAD, LED, 1-FACE, BRACKET MOUNTED

X6700600 ENGINEER'S FIELD LABORATORY (SPECIAL)

X0322050 RAISED REFLECTIVE PAVEMENT MARKER, REFLECTOR REMOVAL

X0323073 CLEAN EXISTING PAVEMENT EDGE JOINT X0323481 VIDEO VEHICLE DETECTION, 4 CAMERAS

X0323639 INSTALL BOLLARD AND LUMINAIRES

X0323713 RADIO INTERCONNECT SYSTEM COMPLETE, LOCAL

X0323920 POLE MOUNTED EQUIPMENT CABINET, TYPE B

X0323921 POLE MOUNTED EQUIPMENT CABINET, TYPE C

X0323989 REINSTALL TEMPORARY SIGN PANEL ASSEMBLY

X0349800 CONCRETE HEADWALL FOR PIPE UNDERDRAIN REMOVAL

X6330100 REMOVE AND RE-ERECT TRAFFIC BARRIER TERMINAL, TYPE 1 SPECIAL

X0323997 SIGN SUPPORT, PARAPET MOUNTED, TYPE I

X0324134 BATTERY BACKUP SYSTEM WITH CABINET

SUMMARY OF QUANTITIES

FOR ALL PLAN SETS

TOTAL

299.0

1167

62

24

49

24

24

84

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(1) I-74 STA, 152+445.837 TO STA, 153+892.180 (2) I-74 STA, 153+892.180 TO STA, 154+970.000 (2A) I-74 EB STA, 154+780.000 TO STA, 157+666.230 & I-74 WB STA, 154+952.000 TO STA, 157+666.230 (3) MAIN STREET STA, 2+800.000 TO STA, 4+157.000 (4) MAIN STREET STA, 2+400.000 TO STA, 4+157.000, MAIN STREET STA, 2+402.933 TO STA, 2+800.000, & WASHINGTON STREET STA, 99+730.000 TO STA, 100+210.000 (5) BRIDGE PLANS SN 090-0160 (SN 090-0006) (WB I-74 OVER MAIN STREET) & BRIDGE PLANS SN 090-0163 (WB I-74 OVER WASHINGTON STREET)

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FARM CREEK AND TP&W RAILROAD)

RETAINING WALL SN 090-8512 (ALONG RAMP J-3) RETAINING WALL SN 090-8513 (ALONG RAMP K-2)

DAILY & ASSOCIATES, ENGINEERS, INC. PEORIA, ILLINOIS	
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ILLINOIS DEPARTMENT OF TRANSPORTATION

SUMMARY OF QUANTITIES

COUNTY TOTAL SHEET SHEETS NO.
TAZEWELL 1366 23

SECTION

TO STA.

STA.

URBAN SUMMARY OF QUANTITIES 90% FED 90% FED 10% STATE 10% STATE FOR ALL PLAN SETS INTERSTATE INTERSTATE
ROADWAY ROADWAY INTERSTATE ARTERIAL RETAINING OVERHEAD ROADWAY ARTERIAL ROADWAY ROADWAY BRIDGE BRIDGE BRIDGE LIGHTING 3 LANE 2 LANE (2) (2A) (3) (4) (5) (6) CODE NO. PAY ITEM UNIT Y002-1C X2.<u>71</u>-2A 61 X971-2A Y031-1F J000-2A I000-2A J000~2A X281-2A X581-2A Y007 Y030-1E J000-2A I000-2A Z0002600 BAR SPLICERS EACH 514 172 Z0007900 BUTT JOINTS EACH 0.2 Z0013798 CONSTRUCTION LAYOUT 0.3 0.1 L SUM 0.4 Z0018800 DRAINAGE SYSTEM L SUM 0.19 0.67 0.14 Z0024478 FLEXIBLE DELINEATORS EACH 309 Δ Z0030020 IMPACT ATTENUATORS (FULLY REDIRECTIVE, NARROW), TEST LEVEL 2 EACH △ Z0030030 IMPACT ATTENUATORS (FULLY REDIRECTIVE, NARROW), TEST LEVEL 3 EACH △ Z0030255 IMPACT ATTENUATORS, TEMPORARY (FULLY REDIRECTIVE, NARROW), TEST LEVEL 2 EACH △ Z0030350 IMPACT ATTENUATORS, RELOCATE (NON-REDIRECTIVE), TEST LEVEL 3 EACH Z0031405 JACKING AND SHORING EXISTING GIRDERS L SUM Z0048665 RAILROAD PROTECTIVE LIABILITY INSURANCE L SUM A ZOOSOOOO REMOVAL AND REINSTALLATION OF EXISTING IMPACT ATTENUATORS EACH Z0064540 SEEPAGE CCLLAR EACH 23 Z0076600 TRAINEES HOUR 3000 1400 #4001602 DRILLED SHAFT IN SOIL, 1980MM METER 4.5 #4001603 BITUMINOUS SURFACE REMOVAL - BUTT JOINT (SPECIAL) SQ M 1571.0 1571 #4001614 CLASS B PATCHES (SPECIAL) SQ M 107 107.2 \*4001616 PAVED DITCH REMOVAL, SPECIAL 380 SQ M #4001617 PIPE CULVERT REMOVAL 300MM 42 METER 42 "4001618 MANHOLES, TYPE A, 1.2M DIAMETER, FLAT SLAB TOP EACH #4001620 LIGHT POLE, GALVANIZED STEEL, 13.5 M MH, 4.5 M DAVIT ARM EACH \*4001621 STORM SEWER CLASS A, TYPE 1 750MM EQUIVALENT METER #4001624 AGGREGATE SPECIAL M TON 5.0 #4001625 CONCRETE BARRIER BASE SQ M \*4001626 CONCRETE COLLAR, CULVERT NO. 1 #4001627 FRAMES AND GRATES, TYPE 20, INSTALL ONLY EACH

			6	8201
F.A.I. RTE.	SECTION	COUNTY	TOTAL SHEETS	SHEET NO.
74		TAZEWELL	1366	24
STA	,	TO STA.		
FED. RO	DAD DIST. NO. 4	THE INOIS FED	AID PROJ	FCT

\* (90-11)R-2:90(13,14,14-1)R-1

△ SFTY-3N □ SFTY-3C ○ Y080 Ø NON-PARTICIPATING

(1) I-74 STA. 152+445.837 TO STA. 153+892.180
(2) I-74 STA. 153+892.180 TO STA. 154+970.000
(2A) I-74 EB STA. 154+970.000 TO STA. 157+666.230 & I-74 WB STA. 154+952.000 TO STA. 157+666.230
(3) MAIN STREET STA. 2+800.000 TO STA. 4+157.000
(4) MAIN STREET STA. 2+015.141 TO STA. 2+800.000, & WASHINGTON STREET STA. 2+402.933 TO STA. 2+800.000, & WASHINGTON STREET STA. 99+730.000 TO STA. 100+210.000
(5) BRIDGE PLANS SN 090-0160 (SN 090-0066) (WB I-74 OVER MAIN STREET) & BRIDGE PLANS SN 090-0163 (WB I-74 OVER WASHINGTON STREET)

(6) BRIDGE PLANS SN 090-0159 (SN 090-0005) (WB I-74 OVER
ALTORFER LANE AND TP&W RAILROAD)
(7) BRIDGE PLANS SN 090-0156 (SN 090-0010 EB & SN 090-0011 WB)
(RAMP K-2 OVER MAIN STREET AND RAMP J-3)
(8) BRIDGE PLANS SN 090-0009 (WB I-74 OVER CAMP STREET,
FARM CREEK AND TP&W RAILROAD)

(9) RETAINING WALL SN 090-8513 (ALONG RAMP J-3) RETAINING WALL SN 090-8513 (ALONG RAMP K-2)

ĺ		REVISION		
		NAME	DATE	ILLINOIS DEPA
				SUMMA
	DAILY & ASSOCIATES,			
	ENGINEERS, INC.		-	
	PEORIA, ILLINOIS			DATE 02/14/2005

ILLINOIS DEPARTMENT OF TRANSPORTATION

SUMMARY OF QUANTITIES

CHECKED BY

DRAWN BY

\* (90-11)R-2;90(13,14,14-1)R-1

SHOULDER RUMBLE STRIP	
LOCATION	METER
EB STA. 151+371.000 TO STA. 151+415.000 RT.	44.0
EB STA. 151+605.100 TO STA. 151+937.500 RT.	332.4
EB STA. 151+760.000 TO STA. 152+000.000 LT.	240.0
EB STA. 152+127.600 TO STA. 152+445.800 RT.	318.2
EB STA. 152+109.700 TO STA. 152+445.800 LT.	336.1
EB STA. 152+445.837 TO STA. 153+892.180	1475.0
EB STA. 153+977.774 TO STA. 154+298.692 RT.	320.9
EB STA. 154+512.766 TO STA. 154+780.000 RT.	267.2
EB STA. 153+892.180 TO STA. 154+780.000 LT.	887.8
EB STA. 154+780.000 TO STA. 157+666.230 RT.	2806.8
EB STA. 154+780.000 TO STA. 157+666.230 LT.	2886.2
WB STA. 151+371.000 TO STA. 151+390.000 LT.	19.0
WB STA. 151+771.100 TO STA. 151+984.700 LT.	213.6
WB STA. 151+760.100 TO STA. 151+995.200 RT.	235.2
WB STA. 152+114.200 TO STA. 152+445.800 RT.	331.6
WB STA. 152+312.700 TO STA. 152+445.800 RT.	133.1
WB STA. 152+445.837 TO STA. 153+892.180	1465.0
WB STA. 154+006.185 TO STA. 154+324.718 LT.	318.5
WB STA. 154+525.000 TO STA. 154+780.000 LT.	255.0
WB STA. 153+892.180 TO STA. 154+780.000 RT.	887.8
WB STA. 154+952.000 TO STA. 157+666.230 RT.	2714.2
WB STA. 154+952.000 TO STA. 157+666.230 LT.	2591.8
TOTAL (MAINLINE ONLY)	19080

			Earthwork S	chedule					
LOCATION	TOTAL EXCAVATION (CUT)	2 SPECIAL EXCAVATION	3 UNSUITABLE MATERIAL	EARTH EXCAVATION	5 EXCAVATION TO BE USED IN EMBANKMENT (ADJUSTED FOR SHRINKAGE)	6 EMBANKMENT (FILL)	7 EARTHWORK WASTE (+ FURNISHED EX (-)	+) OR	8 TOPSOIL FURNISH AND PLACE 100 MM
	(COL 2 + COL 3+ CCL 4)				(COL 2 or COL 4 x 0.75)		(COL 5 - 0	COL 6)	
STAGE 3A							(17 47512	(	
I-74 STA 152+444.837 TO STA 153+828.180	2,349	0	0	2,349	1,762	4,051	-2,28	9	2,468
I-74 STA 153+892.180 TO STA 154+250.000	4,278	0	417	3,861	2,896	5,671	-2,77	'5	805
MAIN STREET STA 2+402.000 TO STA 4+157.000	12,033	11,470	563	0	8,603	11,636	-3,03	54	23,284
RAMP K-2 STA 10+635.511 TO STA 10+691.236	22	0	0	22	17	1,909	-1,89	3	982
RAMP J-4 STA 10+230.000 TO STA 10+301.000	1,200	0	0	1,200	900	2,852	-1,95	2	2,427
RAMP L-4 STA 10+250.000 TO STA 10+300.000	464	0	0	464	348	567	-219	)	158
SUBTOTAL	20,346	11,470	980	7,896	14,525	26,686	-12,16	52	30,124
STAGE 3B									
I-74 STA 153+079.792 TO STA 153+499.000	7,857	0	0	7,857	5,893	275	5,618	3	3,109
I-74 STA 154+250.000 TO STA 154+850.000	6,607	0	1,081	5,526	4,145	2,928	1,217	7	448
RAMP J-3 STA 10+149.000 TO STA 10+351.000	17,725	0	1,003	16,722	12,542	29	12,51	3	1,441
RAMP K-2 STA 10+051.874 TO STA 10+423.029	2,979	0	102	2,877	2,158	2,875	-717	,	2,854
RAMP L-4 STA 10+000.000 TO STA 10+250.000	3,115	0	290	2,825	2,119	40	2,079	9	346
EXISTING RAMP 20 & 21 GRADING STA 800+000.000 TO STA 800+120.000	713	0	0	713	535	902	-367		3,062
SUBTOTAL	38,996	0	2,476	36,520	27,390	7,049	20,341		11,260
STAGE 3C									
I-74 STA 152+723.598 TO STA 152+975.000	483	0	0	483	362	1,138	-776	3	1,825
RAMP J-4 STA 10+064.000 TO STA 10+301.000	19,960	0	0	19,960	14,970	470	14,50	0	5,427
SUBTOTAL	20,443	0	0	20,443	15,332	1,608	13,72	4	7,252
TOTAL	79,785	11,470	3,456	64,859	57,247	35,343	34,066	-12,162	48,636

EARTH EXCAVATION SHRINKAGE FACTOR = 25%

DESCRIPTION	QUANTITIES		CROSS SECTION LEGEND STAGE 3A	STAGE 3B	STAGE_3C
SPECIAL EXCAVATION	11,470	SPECIAL EXCAVATION	S3A	S3B	S3C
REMOVAL AND DISPOSAL OF UNSUITABLE MATERIAL	3,460	UNSUITABLE MATERIAL	U3A	U3B	u3C
EARTH EXCAVATION	64,860	EARTH EXCAVATION	E3A	E3B	E3C
FURNISHED EXCAVATION	12,165	EMBANKMENT	F3A	F3B	F3C
TOPSOIL FURNISH AND PLACE, 100 mm	48,636	TOPSOIL FURNISH AND PLACE	T3A	тзв	T3C

DAILY & ASSOCIATES, ENGINEERS, INC. PEORIA, ILLINOIS

DATE ILLINOIS DEPARTMENT OF TRANSPORTATION

F.A.I. ROUTE 74 (I-74) SCHEDULE OF QUANTITIES

DRAWN BY CHECKED BY DATE 01/14/2005

**SET 1 OF 4** 

FOR MASTER INDEX OF SHEETS, SEE SHEET NO. 2

FOR HIGHWAY STANDARDS LIST FOR ALL PLAN SETS SEE SHEET 5

**DESIGN DESIGNATION:** 

7625 (25) INTERSTATE 38.28 (PCC-30) 1455 (25) INTERSTATE 9.23 (PCC-30)

STATE OF ILLINOIS DEPARTMENT OF TRANSPORTATION

# PLANS FOR PROPOSED FEDERAL AID INTERSTATE

F.A.I. ROUTE 74 (WB I-74) SECTION (90-11)R-2; 90(13, 14, 14-1)R-1 **PROJECT** 

> **TAZEWELL COUNTY** C-94-010-02

RECONSTRUCTION OF I-74 WESTBOUND LANES AND RAMPS FROM N. MAIN STREET TO WASHINGTON STREET

# SURVEY BOOK NO.

2845B 2845C


2845F

**METRIC RATIOS** 

FULL SIZE PLANS HAVE BEEN PREPARED USING STANDARD ENGINEERING SCALES. REDUCED SIZED PLANS WILL NOT CONFORM TO STANDARD SCALES. IN MAKING MEASUREMENTS ON REDUCED PLANS, THE ABOVE SCALES MAY BE USED.

JOINT UTILITY LOCATION INFORMATION FOR EXCAVATION 1-800-892-0123

**CONTRACT NO. 68201** CATALOG NO. 031087-18D

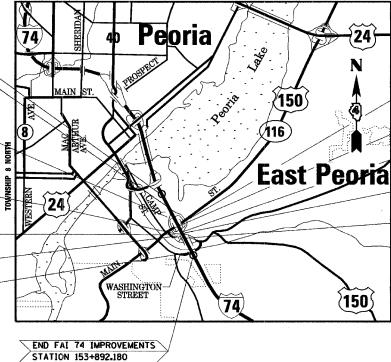

RANGE 8 EAST - 4TH P.M

MAP SCALE 1:50,000

GROSS LENGTH OF SECTION AND PROJECT = 2272.026 METERS = 2.272 KILOMETERS NET LENGTH OF SECTION AND PROJECT = 2272.026 METERS = 2.272 KILOMETERS

FAI 74 OVER MAIN STREET SN 090-0160 STA. 153+020.792 TO 153+079.792

MAIN STREET IMPROVEMENTS (1938\_102 m) STA. 2+218.898 TO 4+157.000

RAMP J-3 RETAINING WALL SN 090-8512 STA. 10+037.700 TO 10+212.930

RAMP K-2 RETAINING WALL SN 090-8513 STA, 10+378,450 TO 10+507,550

NPDES PERMIT REQUIRED

QC/QA BITUMINOUS

QC/QA CONCRETE

FAI 74 OVER CAMP STREET, FARM CREEK AND TP&W R.R. SN 090-0009 STA. 153+496.485 TO 153+741.610



COUNTY

74 (90-II)R-2;90(I3,I4,I4-I)R-I TAZEWELL /36

**DESIGN NO. D-94-010-02** 

DATE: 12-20-04

BITUMINOUS SUPERPAVE PRINTED BY THE AUTHORITY OF THE STATE OF ILLINOIS

MR. JAMES J. MARTY - PROJECT MANAGER (217) 875-4800

BEGIN FAI 74 IMPROVEMENTS STATION 151+620.154

STA. 152+656.108 TO 152+714.598

STA. 10+423.029 TO 10+635.511

RAMP J-3 IMPROVEMENTS (225.954 STA. 10+145.073 TO 10+371.027

RAMP K-2 IMPROVEMENTS (632,106 m STA. 10+052,874 TO 10+684,980

FAI 74 OVER WASHINGTON STREET SN 090-0163

STA. 153+828.180 TO 153+892.180

RAMP J-4 IMPROVEMENTS (304,713 m) STA. 10+017,097 TO 10+321.810

FAI 74 OVER ALTORFER LANE AND TP&W R.R. SN 090-0159

RAMP K-2 OVER MAIN STREET AND RAMP J-3 SN 090-0156

FAI 74 (WB 1-74)

# INDEX OF SHEETS FOR PLAN SET 1 OF 4

PROFILE (RAMP J-3)

PROFILE (RAMP J-4)

PROFILE (RAMP K-2)

PROFILES (MAIN STREET)

DRAINAGE AND UTILITIES (WB I-74)

DRAINAGE AND UTILITIES (MAIN STREET)

249

250

251 252-254

255-270 271-297

F.A.I. RTE.	SECTION	COUNTY	TOTAL SHEETS	SHEET NO.
74	(90-11)R-2;90(13,14,14-1)R-1	TAZEWELL	1366	27
ST	L TO	STA.		

SHEET NO.	DESCRIPTION	SHEET NO.	DESCRIPTION
26	COVER SHEET	298-302	CROSS SECTION SHEAR LINES
27	INDEX OF SHEETS	303-304	RIGHT OF WAY PLANS
28	GENERAL NOTES	305-314	INTERSECTION DETAILS
29-43	TOTAL BILL OF MATERIALS	315-327	TRAFFIC SIGNAL PLANS
44-45	STATUS OF UTILITIES TO BE ADJUSTED	328-334	PAVEMENT MARKING (WB I-74)
46-47	EXISTING TYPICAL SECTIONS (WB I-74)	335-339	PAVEMENT MARKING (MAIN STREET)
48	EXISTING TYPICAL SECTIONS (RAMPS)	340-346	TEMPORARY GUIDE SIGN DETAILS
49-54	EXISTING TYPICAL SECTIONS (MAIN STREET)	347-372	CONCEPTUAL TEMPORARY INFORMATION SIGNING PLANS
55-65	PROPOSED TYPICAL SECTIONS (WB I-74)	373-375	RAMP GORE AND PAVEMENT DETAILS
66-69	PROPOSED TYPICAL SECTIONS (RAMP J-3)	376	PAVEMENT JOINT DETAIL ALTORFER LANE AT MAIN STREET
70-72	PROPOSED TYPICAL SECTIONS (RAMP J-4)	377-382	BRIDGE APPROACH PAVEMENT DETAILS
73-78	PROPOSED TYPICAL SECTIONS (RAMP K-2)	383-385	MISCELLANEOUS DETAILS - IMPACT ATTENUATORS
79-85	PROPOSED TYPICAL SECTIONS (MAIN STREET)	386-387	EROSION CONTROL PLANS
86-90	PROPOSED TYPICAL SECTIONS (SIDE ROADS)	388	EXISTING GENERAL PLAN AND ELEVATION AT PROPOSED STRUCTURE # SN 090-0159
91-115	SCHEDULE OF QUANTITIES	389-421	BRIDGE PLANS SN 090-0159 (WB I-74 AND RAMP J-4 OVER ALTORFER LANE AND TP&W RR)
116-117	REFERENCE TIES AND BENCHMARKS	422	EXISTING GENERAL PLAN AND ELEVATION AT PROPOSED STRUCTURE # SN 090-0160
118-121	SCHEMATIC DRAWINGS	423-447	BRIDGE PLANS SN 090-0160 (WB I-74 OVER MAIN STREET)
122	MAINTENANCE OF TRAFFIC - GENERAL NOTES AND LEGENDS	448	EXISTING GENERAL PLAN AND ELEVATION AT PROPOSED STRUCTURE # SN 090-0009
123-124	MAINTENANCE OF TRAFFIC - STAGE 3A-1 CONSTRUCTION SEQUENCING	449-516	BRIDGE PLANS SN 090-0009 (WB I-74 OVER CAMP STREET, FARM CREEK AND TP&W RR))
125-133	MAINTENANCE OF TRAFFIC - STAGE 3A-1	517	EXISTING GENERAL PLAN AND ELEVATION AT PROPOSED STRUCTURE # SN 090-0163
134-135	MAINTENANCE OF TRAFFIC - STAGE 3A (WITH SUB-STAGE 2) CONSTRUCTION SEQUENCING	518-545	BRIDGE PLANS SN 090-0163 (WB I-74 OVER WASHINGTON STREET)
136-153	MAINTENANCE OF TRAFFIC - STAGE 3A	546-601	BRIDGE PLANS SN 090~0156 (RAMP K-2 OVER MAIN STREET & RAMP J-3)
154-164	MAINTENANCE OF TRAFFIC - STAGE 3A-2	602-622	RETAINING WALL 81 SN 090-8512 (RAMP J-3)
165-166	MAINTENANCE OF TRAFFIC - STAGE 3A (WITH SUB-STAGE 3) CONSTRUCTION SEQUENCING	623-642	RETAINING WALL 82 SN 090-8513 (RAMP K-2)
167-183	MAINTENANCE OF TRAFFIC - STAGE 3A-3	643-662	D4 CADD STANDARDS
184-185	MAINTENANCE OF TRAFFIC - STAGE 3A (WITH SUB-STAGE 4) CONSTRUCTION SEQUENCING	663-682	I-74 PROJECT STANDARDS
186-198	MAINTENANCE OF TRAFFIC - STAGE 3A-4	683-763	CROSS SECTIONS - I-74 W.B.
199-200	MAINTENANCE OF TRAFFIC - STAGE 3A (WITH SUB-STAGE 5) CONSTRUCTION SEQUENCING	764-776	CROSS SECTIONS - RAMP J-3
201	MAINTENANCE OF TRAFFIC - STAGE 3B CONSTRUCTION SEQUENCING	777-791	CROSS SECTIONS - RAMP J-4
202-208	MAINTENANCE OF TRAFFIC - STAGE 3B	792-821	CROSS SECTIONS - RAMP K-2
209	MAINTENANCE OF TRAFFIC - STAGE 3C CONSTRUCTION SEQUENCING	822-893	CROSS SECTIONS - MAIN STREET
210	MAINTENANCE OF TRAFFIC - STAGE 3C	894-895	CROSS SECTIONS - EXISTING RAMP 20 & 21 GRADING
211-217	PLANS (WB I-74)		
218-244	PLANS (MAIN STREET)		
245-246	PLANS (BLACKJACK BLVD.)		
247-248	PROFILE (WB I-74)		

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-	URS CORPORATION		
	ST. LOUIS, MO		

ILLINOIS DEPARTMENT OF TRANSPORTATION

INDEX OF SHEETS

DATE 12/20/04

DRAWN BY MLS
CHECKED BY SRS

COUNTY SHEETS NO. SECTION 74 (90-1)/R-2490(3,14,14-1)/R-1 TAZEWELL /366 Z8 STA. TO STA. FED. ROAD DIST. NO. 4 ILLINOIS FED. AID PROJECT

## PROJECT SPECIFIC NOTES

 $\underline{\text{CROSS}}$  Sections in the cross sections use the following legends with end areas computed in  $\mathsf{m}^2$ 

SPECIAL EXCAVATION UNSUITABLE MATERIAL EARTH EXCAVATION EMBANKMENT TOPSOIL FURNISH AND PLACE T

FINAL FINISH ON PORTLAND CEMENT CONCRETE PAVEMENT A TYPE "A" FINAL FINISH SHALL BE PROVIDED ON 1-74 MAINLINE RAMP AND MAIN STREET PCC PAVEMENTS.

A TYPE "B" FINAL FINISH, OBTAINED IN ACCORDANCE WITH ARTICLE 420.11(E)(2) OF THE STANDARD SPECIFICATIONS, SHALL BE PROVIDED ON OFF SYSTEM STREET PCC PAVEMENTS EXCEPT MAIN STREET.

#### ACCESS CONTROL FENCE

THE CONTRACTOR SHALL TEMPORARILY RE-ERECT ACCESS CONTROL FENCE UNLESS THE CONTRACTION SMALL TEMPORABILY RE-ERECT ACCESS CONTROL FENCE ONLESS CONSTRUCTION OPERATIONS ARE ON GOING AND WORKERS ARE PRESENT UNTIL THE PERMANENT ACCESS CONTROL FENCE IS INSTALLED. THIS WORK INCLUDING ADDITIONAL TEMPORARY FENCE REQUIRED TO MAINTAIN THE INTEGRITY OF THE ACCESS CONTROL FENCE SHALL BE INCLUDED IN THE COST OF PERMANENT FENCE.

## EXISTING DRAINAGE:

THE CONTRACTOR SHALL VERIFY ALL EXISTING ELEVATIONS CRITICAL TO THE PROPOSED DRAINAGE PATTERNS IN SET 1 OF 4 PRIOR TO PERFORMING ANY DRAINAGE RELATED WORK. THE CONTRACTOR SHALL NOTIFY THE ENGINEER IMMEDIATELY IF ANY DISCREPANCIES ARE FOUND.

#### TEMPORARY CONCRETE BARRIER:

ANY TEMPORARY CONCRETE BARRIER TO BE REMOVED AND RELOCATED THAT IS NOT NEEDED FOR THE NEXT SUBSEQUENT STAGE OF CONSTRUCTION SHALL BE STORED IN A MANNER AND LOCATION THAT DOES INTERFERE WITH CONSTRUCTION. THIS WORK SHALL NOT BE PAID FOR SEPARATELY BUT WILL BE CONSIDERED AS INCLUDED IN THE PAY ITEMS PROVIDED.

#### EARTHWORK STAGING:

EARTHWORK QUANTITIES DESIGNATED AS STAGE 3A-1 IN THE CROSS SECTIONS ARE SCHEDULED AS STAGE 3A.

	REVI	SIONS			
	NAME	DATE	] ILLI	NOIS DEPARTME	NT OF TRANSPO
			l		
				GENER	AL NOTES
			]		
UKS			1		
URS CORPORATION			-		DRAWN BY
ST. LOUIS, MO			DATE	12/20/04	CHECKED BY

OF TRANSPORTATION

DRAWN BY SRS

CHECKED BY JJM

COUNTY TOTAL SHEET SHEETS NO.
TAZEWELL /366 29 F.A.I. RTE. SECTION STA. TO STA. FED. ROAD DIST. NO. ILLINOIS FED. AID PROJECT

\*(90-11)R-2;90(13,14,14-1)R-1

							r	URBAN	1			
					IM		Bi				M	
					90% FED			FED		90%		
	BILL OF MATERIALS FOR SET 1 OF 4				10% STATE	*****	1	STATE		10%	STATE	
	FOR INFORMATION ON W				Т	1	CONSTRUC	TION TYPE	CODE	1		
	FOR INFORMATION ONLY			INTERSTATE	ARTERIAL	ARTERIAL	BRIDGE	BRIDGE	BRIDGE	BRIDGE	RETAIN	TRAFFIC
				ROADWAY	ROADWAY	ROADWAY					WALL	SIGNALS
		····	74711	3 LANE (1)	(2)	(3)	(4)	(5)	(6)	(7)	(8)	
ODE NO.	PAY ITEM	UNIT	TOTAL QUANTITY	J000-2A	1000-2A	J000-2A	X281-2A	X581-2A	X281-2A	1	Y007	Y031-1F
8000300	TEMPORARY DITCH CHECKS	EACH	95	83	1	11						
28000500	INLET AND PIPE PROTECTION	EACH	268	268								-
	DELIQUAL OF SVICTING STRUCTURES NO. 4	FIOU										
50100300	REMOVAL OF EXISTING STRUCTURES NO. 1	EACH	. 1				1					
50100400	REMOVAL OF EXISTING STRUCTURES NO. 2	EACH	1					1				
50100500	REMOVAL OF EXISTING STRUCTURES NO. 3	EACH	1				1					
50104400	CONCRETE HEADWALL REMOVAL	EACH	22	16	5	1						
30104400		LACIT	44	10								
50104710	REMOVAL OF EXISTING BEARINGS	EACH	10							10		
50104800	REMOVAL OF EXISTING CONCRETE DECK	L SUM	1							1		
50300100	FLOOR DRAINS	EACH	7							7		:
50300310	ELASTOMERIC BEARING ASSEMBLY, TYPE I	EACH	12							12		
50300320	ELASTOMERIC BEARING ASSEMBLY, TYPE II	EACH	28						4	24		
50300330	ELASTOMERIC BEARING ASSEMBLY, TYPE III	EACH	4						4		***************************************	
50500505	STUD SHEAR CONNECTORS	EACH	24314						4748	12334	7232	
50500715	JACK AND REMOVE EXISTING BEARINGS	EACH	30							30		
50600300	CLEANING AND PAINTING STEEL BRIDGE	L SUM	1							1	:	
50606400	CONTAINMENT AND DISPOSAL OF LEAD PAINT CLEANING RESIDUES	L CIM	1							1		
30606400	CONTAINMENT AND DISPOSAL OF LEAD PAINT CLEANING RESIDUES	L SUM	1							1		
51500100	NAME PLATES	EACH	7				2	1	1	1	2	-
60100060	CONCRETE HEADWALL FOR PIPE DRAINS	EACH	17	15	2							
60240301	INLETS, TYPE B, TYPE 8 GRATE	EACH	1	1								
60240303	INLETS, TYPE B, TYPE 9 FRAME AND GRATE	EACH	3	3								-
60240324	INLETS, TYPE B, TYPE 20 FRAME AND GRATE	EACH	2	Ź								
60241900	INLETS, TYPE G-1, SPECIAL	EACH	61	2	38	21					<u> </u>	
50247132	DRAINAGE STRUCTURES, TYPE 1A WITH ONE TYPE 20 FRAME AND GRATE	EACH	15	15	ļ							

(1) WB I-74 STA 152+445.837 TO STA 153+892.180

(2) MAIN STREET STA 2+800.000 TO STA 4+157.000

(3) MAIN STREET STA 2+402.933 TO STA 2+800.000

(4) BRIDGE PLANS SN 090-0160 (EX SN 090-0006) (WB I-74 OVER MAIN STREET)
BRIDGE PLANS SN 090-0163 (EX SN 090-0011) (WB I-74 OVER WASHINGTON STREET)

(5) BRIDGE PLANS SN 090-0159 (EX SN 090-0005) (WB I-74 OVER ALTORFER LANE AND TP&W RAILROAD)
(6) BRIDGE PLANS SN 090-0156 (RAMP K-2 OVER MAIN STREET)
(7) BRIDGE PLANS SN 090-0009 (WB I-74 OVER CAMP STREET, FARM CREEK AND TP&W RAILROAD)

(8) RETAINING WALL SN 090-8512 (ALONG RAMP J-3)
RETAINING WALL SN 090-8513 (ALONG RAMP K-2)

URS URS CORPORATION DECATUR, ILLINOIS

ILLINOIS DEPARTMENT OF TRANSPORTATION FAI ROUTE 74 (I-74)

TOTAL BILL OF MATERIALS

DRAWN BY MLS CHECKED BY JJM

DATE 12-20-04

F.A.I. RTE. 74 COUNTY TOTAL SHEET NO.
TAZEWELL 1366 30 SECTION TO STA. STA. FED. ROAD DIST. NO. ILLINOIS FED. AID PROJECT

\*(90-11)R-2;90(13,14,14-1)R-1

								URBAN				
					IM		В	RI		1	M	
					90% FED		80%	FED		90%	FED	
	BILL OF MATERIALS FOR SET 1 OF 4				10% STATE		20%	STATE		10%	STATE	
							CONSTRUC	TION TYPE	CODE			
	FOR INFORMATION ONLY			INTERSTATE ROADWAY 3 LANE	ARTERIAL ROADWAY	ARTERIAL ROADWAY	BRIDGE	BRIDGE	BRIDGE	BRIDGE	RETAIN WALL	TRAFFIC SIGNALS
<b>CODE NO.</b> 60260100	PAY ITEM  INLETS TO BE ADJUSTED	UNIT EACH	TOTAL OUANTITY	(1) J000-2A	(2) 1000-2A	(3) J000-2A	(4) X281-2A	(5) X581-2A	(6) X281-2A	(7) X971-2A	(8) Y007	Y031-1F
60500040	REMOVING MANHOLES	EACH	2		2							
60500060	REMOVING INLETS	EACH	31	30		1						
60900215	TYPE C INLET BOX, STANDARD 609001	EACH	4	4								
60900315	TYPE D INLET BOX, STANDARD 609006	EACH	1	1								
60900515	CONCRETE THRUST BLOCKS	EACH	14	14								
61000115	TYPE E INLET BOX, STANDARD 610001	EACH	5	5								
61000225	TYPE F INLET BOX, STANDARD 610001	EACH	1	1								
63100045	TRAFFIC BARRIER TERMINAL, TYPE 2	EACH	3	1	2							
63500105	DELINEATORS	EACH	42	42								
66600105	FURNISHING AND ERECTING RIGHT-OF-WAY MARKERS	EACH	10		4	6						
66700205	PERMANENT SURVEY MARKERS, TYPE I	EACH	12		7	1	2	1		1		
72400600	RELOCATE SIGN PANEL ASSEMBLY - TYPE B	EACH	1	1								
78100100	RAISED REFLECTIVE PAVEMENT MARKER	EACH	577	577								
78200500	BARRIER WALL MARKERS	EACH	117	117								
78201000	TERMINAL MARKER - DIRECT APPLIED	EACH	5	5								
78300200	RAISED REFLECTIVE PAVEMENT MARKER REMOVAL	EACH	411		290	121						
80500205	SERVICE INSTALLATION, TYPE B (MODIFIED)	EACH	2									2
81400400	CONCRETE HANDHOLE	EACH	19					<u> </u>		<b> </b>		19
81400600	CONCRETE DOUBLE HANDHOLE	EACH	2				<u> </u>					2
82102400	LUMINAIRE, SODIUM VAPOR, HORIZONTAL MOUNT, 400 WATT	EACH	7									7
85700200	FULL-ACTUATED CONTROLLER AND TYPE IV CABINET	EACH	2									2
86400100	TRANSCEIVER - FIBER OPTIC	EACH	2									2
			<del> </del>	L	1	L		1		1	1	1\$

(1) WB I-74 STA 152+445.837 TO STA 153+892.180

(2) MAIN STREET STA 2+800.000 TO STA 4+157.000

(3) MAIN STREET STA 2+402.933 TO STA 2+800.000

(4) BRIDGE PLANS SN 090-0160 (EX SN 090-0006) (WB I-74 OVER MAIN STREET)
BRIDGE PLANS SN 090-0163 (EX SN 090-0011) (WB I-74 OVER WASHINGTON STREET)
(5) BRIDGE PLANS SN 090-0159 (EX SN 090-0005) (WB I-74 OVER ALTORFER LANE AND TP&W RAILROAD)

(6) BRIDGE PLANS SN 090-0159 (EX SN 090-0005) (WB 1-74 OVER ALTORFER LANE AND TP&W RAI (7) BRIDGE PLANS SN 090-0009 (WB 1-74 OVER CAMP STREET) (8) RETAINING WALL SN 090-8512 (ALONG RAMP J-3) RETAINING WALL SN 090-8513 (ALONG RAMP K-2)

REVISIONS NAME

DATE ILLINOIS DEPARTMENT OF TRANSPORTATION FAI ROUTE 74 (1-74)

TOTAL BILL OF MATERIALS

DATE 12-20-04


DRAWN BY MLS CHECKED BY JJM

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			00002	
F.A.I. RTE.	SECTION	COUNTY	TOTAL	
74	*	TAZEWELL	1366	31
		TO STA.		
		ILLINOIS FED.	AID PROJ	ECT

·····								URBAN				
					IM		В	RI		I	M	entro de series de s
					90% FED		80%	FED		90%	FED	
	BILL OF MATERIALS FOR SET 1 OF 4				10% STATE		20%	STATE		10%	STATE	
					·		CONSTRUC	TION TYPE	CODE	T		<del></del>
	FOR INFORMATION ONLY			INTERSTATE ROADWAY 3 LANE	ARTERIAL ROADWAY	ROADWAY	BRIDGE	BRIDGE	BRIDGE	BRIDGE	RETAIN WALL	TRAFFIC SIGNALS
ODE NO.	PAY ITEM	UNIT	TOTAL QUANTITY	(1) J000-2A	(2) 1000-2A	(3) J000-2A	(4) X281-2A	(5) X581-2A	(6) X281-2A	(7) X971-2A	(8) Y007	Y031-1F
8200110	TRAFFIC SIGNAL BACKPLATE, LOUVERED	EACH	20									20
8800100	PEDESTRIAN PUSH-BUTTON	EACH	2									2
9000200	TEMPORARY TRAFFIC SIGNAL INSTALLATION	L SUM	2							-		2
9502375	REMOVE EXISTING TRAFFIC SIGNAL EQUIPMENT	EACH	1									1
9502380	REMOVE EXISTING HANDHOLE	EACH	5									5
9502385	REMOVE EXISTING CONCRETE FOUNDATION	EACH	5									5
2010110	TREE REMOVAL (6 TO 15 UNITS DIAMETER)	UNIT	267		214	53						
2010210	TREE REMOVAL (OVER 15 UNITS DIAMETER)	UNIT	176	94	64	18						
12010500	TREE REMOVAL, HECTARES	НА	1.0	0.7	0.3							
2011000	TEMPORARY FENCE	METER	1703	1703							***************************************	
2020010	EARTH EXCAVATION	CU M	52183	51470		713						
2021200	REMOVAL AND DISPOSAL OF UNSUITABLE MATERIAL	CU M	1668	1105	563							
2021400	SUB-BASE GRANULAR MATERIAL, TYPE A	M TON	11751			11751						
2021500	SUB-BASE GRANULAR MATERIAL, TYPE B	M TON	6512		6512							
2040800	FURNISHED EXCAVATION	CU M	3400		3713	-313						
2070220	POROUS GRANULAR EMBANKMENT	CU M	2831				502	360	111		1858	
2080250	TRENCH BACKFILL, SPECIAL	CU M	508	281	175	52						
2101000	GEOTECHNICAL FABRIC FOR GROUND STABILIZATION	SQ M	25607.0	25607.0				-				
2113100	TOPSOIL FURNISH AND PLACE, 100MM	SQ M	46954	20608	17528	8818						
2500110	SEEDING, CLASS 1A	НА	3. 9	3. 9								
2500312	SEEDING, CLASS 4A	НА	3. 1	3. 1								
2500322	SEEDING, CLASS 5A	НА	0.4	0.4								
2500400	NITROGEN FERTILIZER NUTRIENT	KG	377	377		<del> </del>						

<sup>(1)</sup> WB I-74 STA 152+445.837 TO STA 153+892.180

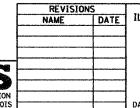

ILLINOIS DEPARTMENT OF TRANSPORTATION FAI ROUTE 74 (1-74)

TOTAL BILL OF MATERIALS

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DATE 12-20-04

<sup>(2)</sup> MAIN STREET STA 2+800.000 TO STA 4+157.000

<sup>(3)</sup> MAIN STREET STA 2+402.933 TO STA 2+800.000

<sup>(4)</sup> BRIDGE PLANS SN 090-0160 (EX SN 090-0006) (WB I-74 OVER MAIN STREET)
BRIDGE PLANS SN 090-0163 (EX SN 090-0011) (WB I-74 OVER WASHINGTON STREET)

(5) BRIDGE PLANS SN 090-0159 (EX SN 090-0005) (WB I-74 OVER ALTORFER LANE AND TP&W RAILROAD)

(6) BRIDGE PLANS SN 090-0156 (RAMP K-2 OVER MAIN STREET)

<sup>(7)</sup> BRIDGE PLANS SN 090-0009 (WB 1-74 OVER CAMP STREET, FARM CREEK AND TP&W RAILROAD)


<sup>(8)</sup> RETAINING WALL SN 090-8512 (ALONG RAMP J-3)
RETAINING WALL SN 090-8513 (ALONG RAMP K-2)

_	F.A.I. RTE.	SECTION	COUNTY	TOTAL SHEETS	SHEET NO.
	74	*	TAZEWELL	1366	32
	STA.		TO STA.		
	FED RO	ON TOTAL	THE THOIS FED	ATD PROJ	FCT

\*(90-11)R-2;90(13,14,14-1)R-1

								URBAN				
					IM		Ві	R1		1	M	
					90% FED		80%	FED		90%	FED	
	BILL OF MATERIALS FOR SET 1 OF 4				10% STATE		20% 5	STATE		10%	STATE	· · · · · · · · · · · · · · · · · · ·
					··		CONSTRUC	TION TYPE	CODE	_	p	
	FOR INFORMATION ONLY			INTERSTATE ROADWAY 3 LANE	ARTERIAL ROADWAY	ARTERIAL ROADWAY	BRIDGE	BRIDGE	BRIDGE	BRIDGE	RETAIN WALL	TRAFFIC SIGNALS
CODE NO. M2500500	PAY ITEM PHOSPHORUS FERTILIZER NUTRIENT	UNIT KG	TOTAL QUANTITY 377	(1) J000-2A 377	(2) 1000-2A	(3) J000-2A	(4) X281-2A	(5) X581-2A	(6) X281-2A	(7) X971-2A	(8) Y007	Y031-1F
		NO NO										
M2500600	POTASSIUM FERTILIZER NUTRIENT	KG	377	377								
M2500700	AGRICULTURAL GROUND LIMESTONE	M TON	21.0	21.0								
M2510115	MULCH, METHOD 2	HA	4.0	4.0								
M2510630	EROSION CONTROL BLANKET	SQ M	39120	39120								
M2800250	TEMPORARY EROSION CONTROL SEEDING	KG	12713	12713								
M2800400	PERIMETER EROSION BARRIER	METER	5303	5303								
M2810707	STONE DUMPED RIPRAP, CLASS A4	SQ M	551	551								
M2820100	FILTER FABRIC FOR USE WITH RIPRAP	SQ M	551	551								
M2850300	ARTICULATED BLOCK MAT	SQ M	362	362								
M3511100	AGGREGATE BASE COURSE, TYPE B 100MM	SQ M	520	520						·		
M3530250	PORTLAND CEMENT CONCRETE BASE COURSE 250MM	SQ M	10055		10055							
M3540250	PORTLAND CEMENT CONCRETE BASE COURSE WIDENING 250MM	SQ M	525		525							
M4060085	PORTLAND CEMENT CONCRETE SURFACE REMOVAL - BUTT JOINT	SQ M	137		137							
M4060100	BITUMINOUS MATERIALS (PRIME COAT)	LITER	64797	46106	18691							
M4060300	AGGREGATE (PRIME COAT)	M TON	112		112							
M4060980	BITUMINOUS SURFACE REMOVAL - BUTT JOINT	SQ M	202		202							
M4060990	TEMPORARY RAMP	SQ M	58		58							
M4080400	INCIDENTAL BITUMINOUS SURFACING	M TON	3			3						
M4202255	PORTLAND CEMENT CONCRETE PAVEMENT 250MM (JOINTED)	SQ M	17238	4650		12588						
M4205000	BRIDGE APPROACH PAVEMENT	SQ M	727	727								
M4205050	BRIDGE APPROACH PAVEMENT (SPECIAL)	SQ M	439	439								
M4205100	PAVEMENT FABRIC	SQ M	10055		10055							

<sup>(1)</sup> WB I-74 STA 152+445.837 TO STA 153+892.180

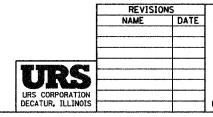

ILLINOIS DEPARTMENT OF TRANSPORTATION FAI ROUTE 74 (I-74)

TOTAL BILL OF MATERIALS

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<sup>(2)</sup> MAIN STREET STA 2+800,000 TO STA 4+157,000

<sup>(3)</sup> MAIN STREET STA 2+402.933 TO STA 2+800.000

<sup>(4)</sup> BRIDGE PLANS SN 090-0160 (EX SN 090-0006) (WB I-74 OVER MAIN STREET)
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(7) BRIDGE PLANS SN 090-0009 (WB I-74 OVER CAMP STREET, FARM CREEK AND TP&W RAILROAD)

(8) PRIAINING WALL SN 090-8512 (ALONG RAMP L-3)

<sup>(8)</sup> RETAINING WALL SN 090-8512 (ALONG RAMP J-3)
RETAINING WALL SN 090-8513 (ALONG RAMP K-2)

			M2520	2
F.A.I. RTE.	SECTION	COUNTY	TOTAL SHEETS	SHEET NO.
		TAZEWELL	1366	33
		TO STA.		
		ILLINOIS FED.	AID PROJ	ECT

\*(90-11)R-2;90(13,14,14-1)R-1

						······································	<del>,</del>	URBAN		<del></del>		
					IM		В	RI		1	М	
					90% FED		80%	FED		90%	FED	
	BILL OF MATERIALS FOR SET 1 OF 4				10% STATE		20%	STATE		10%	STATE	
							CONSTRUC	TION TYPE	CODE			
	FOR INFORMATION ONLY			INTERSTATE	ARTERIAL	ARTERIAL	BRIDGE	BRIDGE	BRIDGE	BRIDGE	RETAIN	TRAFFIC
				ROADWAY	ROADWAY	ROADWAY					WALL	SIGNALS
				3 LANE								
CODE NO	DAY 1754		TOTAL	(1)	(2)	(3)	(4)	(5)	(6)	(7)	(8)	VA21 15
M4205200	PROTECTIVE COAT	UNIT SQ M	QUANTITY 48105	<b>J000-2A</b> 29768	1000-2A 2757	<b>J000-2A</b> 15580	X281-2A	X581-2A	X281-2A	X971-2A	Y007	Y031-1F
M4210290	CONTINUOUSLY REINFORCED PORTLAND CEMENT CONCRETE PAVEMENT 290MM	SQ M	10820	10820								
M4214290	PAVEMENT REINFORCEMENT 290MM	SQ M	10820	10820								
M4230200	PORTLAND CEMENT CONCRETE DRIVEWAY PAVEMENT, 200MM	SQ M	286		99	187	-					
17.120000		34 10	200									
M4240100	PORTLAND CEMENT CONCRETE SIDEWALK 100MM	SQ M	91.0	55.0		36.0	<u> </u>					
M4400025	BITUMINOUS SURFACE REMOVAL 25MM	SQ M	24929		24929							
M4400050	BITUMINOUS SURFACE REMOVAL 50MM	SQ M	21			21						<del>                                     </del>
M4402000	PAVEMENT REMOVAL	SQ M	12288	12288								
M4402020	CURB REMOVAL	METER	300	300								
102020				300								
M4402040	COMBINATION CURB AND GUTTER REMOVAL	METER	119	119	:							
M4402280	CONCRETE BARRIER REMOVAL	METER	67	67								
M4402530	PAVED SHOULDER REMOVAL	W 03	7000	7998								
M4402530	PAVED SHOULDER REMOVAL	SQ M	7998	(330								
M4405000	PAVED DITCH REMOVAL	METER	480	480								
M4426225	CLASS B PATCHES, TYPE II, 250MM	SQ M	709		709							
M4426450	CLASS B PATCHES, TYPE IV, 375MM	SQ M	113	113	<u> </u>							
M4429400	SAW CUTS	METER	856	71	785							
M4430020	STRIP REFLECTIVE CRACK CONTROL TREATMENT	METER	5528		5528							
M4430020	STATE ALL ELECTIVE GRACK CONTROL TREATMENT	METEN	3320		3320							
M4812000	AGGREGATE SHOULDERS, TYPE B	M TON	660	660								
M4820200	BITUMINOUS SHOULDERS 200MM	SQ M	514	514								
			4405	4040		155						
M4830250	PORTLAND CEMENT CONCRETE SHOULDERS - 250MM	SQ M	4195	4040		155						
M4830290	PORTLAND CEMENT CONCRETE SHOULDERS - 290MM	SQ M	3545	3545								
M5010240	CONCRETE REMOVAL	CU M	122. 2							122.2		
M5010465	SLOPE WALL REMOVAL	SQ M	306		<b>_</b>					306		<del></del>

(1) WB I-74 STA 152+445.837 TO STA 153+892.180

(2) MAIN STREET STA 2+800.000 TO STA 4+157.000

(3) MAIN STREET STA 2+402.933 TO STA 2+800.000

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(8) RETAINING WALL SN 090-8512 (ALONG RAMP J-3)
RETAINING WALL SN 090-8513 (ALONG RAMP K-2)

REVISIONS NAME

ILLINOIS DEPARTMENT OF TRANSPORTATION FAI ROUTE 74 (I-74)

TOTAL BILL OF MATERIALS

DATE 12-20-04

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COUNTY TOTAL SHEET SHEETS NO.
TAZEWELL 1366 34 F.A.I. RTE. 74 SECTION STA. TO STA. FED. ROAD DIST. NO. ILLINOIS FED. AID PROJECT

								URBAN							
					IM		В	RI	IM						
					90% FED			FED			FED				
	BILL OF MATERIALS FOR SET 1 OF 4				10% STATE		L	STATE		10%	STATE				
	FOR INFORMATION ONLY			14177767477			CONSTRUC	TION TYPE (	Γ	Γ		<u> </u>			
	FOR INFORMATION ONLY			INTERSTATE ROADWAY 3 LANE	ROADWAY	ROADWAY	BRIDGE	BRIDGE	BRIDGE	BRIDGE	RETAIN WALL	TRAFFIC			
ODE NO.	PAY ITEM	UNIT	TOTAL QUANTITY	(1) J000-2A	(2) 1000-2A	(3) J000-2A	(4) X281-2A	(5) X581-2A	(6) X281-2A	(7) X971-2A	(8) Y007	Y031-1F			
5010522	PIPE CULVERT REMOVAL	METER	260	213	17	30									
5020100	STRUCTURE EXCAVATION	CU M	2615				584	378	262	568	823				
5020400	ROCK EXCAVATION FOR STRUCTURES	CU M	8						8						
5030030	PREFORMED JOINT SEAL 64MM	METER	58.5					58.5							
5030105	NEOPRENE EXPANSION JOINT 50MM	METER	80.0	, , , , , , , , , , , , , , , , , , , ,						80.0					
5030350	CONCRETE STRUCTURES	CU M	2151.6				254.0	265.5	195.4	510.0	926.7				
5030360	CONCRETE SUPERSTRUCTURE	CU M	2335.8				498.5	436.9	538.9	861.5					
5030390	BRIDGE DECK GROOVING	SQ M	8544				1750	1457	1538	3799					
5030450	PROTECTIVE COAT	SQ M	10666				2043	1624	2212	4787		,			
5030710	FORMED CONCRETE REPAIR (DEPTH EQUAL TO OR LESS THAN 125MM)	SQ M	4							4					
5041219	FURNISHING AND ERECTING PRECAST PRESTRESSED CONCRETE I-BEAMS, 1219MM	METER	695.5					695.5							
5041372	FURNISHING AND ERECTING PRECAST PRESTRESSED CONCRETE I-BEAMS, 1372MM	METER	352. 0				352.0								
5050105	FURNISHING AND ERECTING STRUCTURAL STEEL	L SUM	1						0, 70	0.30					
5050405	FURNISHING AND ERECTING STRUCTURAL STEEL	KG	3290								3290				
5050410	STRUCTURAL STEEL REMOVAL	KG	1540							1540					
5070207	TREATED TIMBER LAGGING	SQ M	23								23				
5070209	UNTREATED TIMBER LAGGING	SQ M	1371								1371				
5070213	FURNISHING SOLDIER PILES (BUILT UP SECTION)	METER	1160.4								1160.4				
5070215	FURNISHING SOLDIER PILES (W SECTION)	METER	233. 3								233. 3	***************************************			
5080105	REINFORCEMENT BARS	KG	120		80	40									
5080205	REINFORCEMENT BARS, EPOXY COATED	KG	535050				85170	74290	127230	158600	89760				
5110100	SLOPE WALL 100 MM	SQ M	2965				1108	1064	311	482					
15110200	SLOPE WALL 150MM	SQ M	107							107					

(1) WB I-74 STA 152+445.837 TO STA 153+892.180

(2) MAIN STREET STA 2+800.000 TO STA 4+157.000

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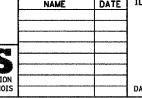
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(8) RETAINING WALL SN 090-8512 (ALONG RAMP J-3) RETAINING WALL SN 090-8513 (ALONG RAMP K-2)



REVISIONS
NAME DATE
ILLINOIS DEPARTMENT OF TRANSPORTATION
FAI ROUTE 74 (I-74)

TOTAL BILL OF MATERIALS

DRAWN BY MLS CHECKED BY JJM

DATE 12-20-04

(3) MAIN STREET SYA 2+402.933 TO STA 2+800.000

COUNTY TOTAL SHEET SHEETS NO.
TAZEWELL 1366 35 F.A.I. RTE. 74 SECTION STA. TO STA. FED. ROAD DIST. NO. ILLINOIS FED. AID PROJECT

								URBAN				
					IM		В	RI			М	
					90% FED		80%	FED			FED	
	BILL OF MATERIALS FOR SET 1 OF 4				10% STATE		<u> </u>	STATE		10%	STATE	· · · · · · · · · · · · · · · · · · ·
	EAD INTARWATIAN AND				T	Ι	CONSTRUC	TION TYPE	CODE	T	T	T
	FOR INFORMATION ONLY			INTERSTATE ROADWAY 3 LANE	ROADWAY	ROADWAY	BRIDGE	BRIDGE	BRIDGE	BRIDGE	RETAIN WALL	TRAFFI SIGNAL
ODE NO.	PAY ITEM	UNIT	TOTAL QUANTITY	(1) J000-2A	(2) 1000-2A	(3) J000-2A	(4) X281-2A	(5) X581-2A	(6) X281-2A	(7) X971-2A	(8) Y007	Y031-11
15120160	FURNISHING STEEL PILES HP310X79	METER	132.0							132.0		
<b>4</b> 5120166	FURNISHING STEEL PILES HP310X94	METER	292.0				292.0					
45120170 45120175	FURNISHING STEEL PILES HP310X110	METER	504.0				504.0					
M5120175	FURNISHING STEEL PILES HP310X125	METER	603.5					603.5				
15120180	FURNISHING STEEL PILES HP360X108	METER	524.5							524.5		
M5120190	FURNISHING STEEL PILES HP360X132	METER	186.0						186.0			
M5120210	FURNISHING STEEL PILES HP360X174	NETED	627.0					607.0				
13120210	FUNNISHING STEEL FILES HESGOATTY	METER	627.0					627.0				
45120315	DRIVING STEEL PILES	METER	2868.5				796.0	1230.0	186.0	656.5		
M5120460	TEST PILE STEEL HP310X79	EACH	2							2		
M5120475	TEST PILE STEEL HP310X125	EACH	1					1				
M5120480	TEST PILE STEEL HP360X108	EACH	1							1		
M5120490	TEST PILE STEEL HP360X132	EACH	2						2			
M5120510	TEST PILE STEEL HP310X174	EACH	1					1				
/542E112	PRECAST REINFORCED CONCRETE FLARED END SECTIONS 300MM	EACH	25		16	9						
M542E120	PRECAST REINFORCED CONCRETE FLARED END SECTIONS 450MM	EACH	3		2	1						
/542E128	PRECAST REINFORCED CONCRETE FLARED END SECTIONS 600MM	EACH	6	2	4							
M542E136	PRECAST REINFORCED CONCRETE FLARED END SECTIONS 750MM	EACH	4		3	1						<del> </del>
1542E536	PRECAST REINFORCED CONCRETE FLARED END SECTIONS, EQUIVALENT ROUND-SIZE 750MM	EACH	1			1			*			
M542F012	METAL END SECTIONS 300MM	EACH	12	12								
M542I055	PIPE CULVERTS, CLASS A, TYPE 2 900MM	METER	29.0	29.0								
<b>1542U42</b> 5	PIPE CULVERTS, CLASS D, TYPE 2 450MM (TEMPORARY)	METER	4. 0	4.0								
M5429910	CONCRETE COLLAR	CU M	3.5		2.4	1.1						
15500030	STORM SEWERS, CLASS A, TYPE 1 300MM	METER	396.0	9, 0	186.0	201.0						
45500050	STORM SEWERS, CLASS A. TYPE 1 450MM	METER	107.0	<u> </u>	103.0	4.0						


(1) WB I-74 STA 152+445.837 TO STA 153+892.180

(2) MAIN STREET STA 2+800.000 TO STA 4+157.000

(3) MAIN STREET SYA 2+402.933 TO STA 2+800.000

(4) BRIDGE PLANS SN 090-0160 (EX SN 090-0006) (WB I-74 OVER MAIN STREET)
BRIDGE PLANS SN 090-0163 (EX SN 090-0011) (WB I-74 OVER WASHINGTON STREET)
(5) BRIDGE PLANS SN 090-0159 (EX SN 090-0005) (WB I-74 OVER ALTORFER LANE AND TP&W RAILROAD)

(6) BRIDGE PLANS SN 090-0159 (EX SN 090-0005) (WB 1-74 OVER ALIGNER LANE AND TP&W RAI (7) BRIDGE PLANS SN 090-0009 (WB 1-74 OVER CAMP STREET) (8) RETAINING WALL SN 090-8512 (ALONG RAMP J-3) RETAINING WALL SN 090-8513 (ALONG RAMP K-2)

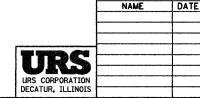

REVISIONS
NAME DATE ILLINOIS DEPARTMENT OF TRANSPORTATION FAI ROUTE 74 (I-74)

TOTAL BILL OF MATERIALS

DRAWN BY MLS DATE 12-20-04 CHECKED BY JJM

COUNTY TOTAL SHEET NO.
TAZEWELL 1366 36 F.A.I. RTE. SECTION TO STA. STA. FED. ROAD DIST. NO. ILLINOIS FED. AID PROJECT

							<b></b>	URBAN				
					IM 90% FED		ļ	RI FED			M FED	
	BILL OF MATERIALS FOR SET 1 OF 4				10% STATE		20%	STATE		10%	STATE	
							CONSTRUC	TION TYPE (	CODE			
	FOR INFORMATION ONLY			INTERSTATE ROADWAY 3 LANE	ARTERIAL ROADWAY	ARTERIAL ROADWAY	BRIDGE	BRIDGE	BRIDGE	BRIDGE	RETAIN WALL	TRAFFIC SIGNALS
ODE NO.	PAY ITEM	UNIT	TOTAL QUANTITY	(1) J000-2A	(2) 1000-2A	(3) J000-2A	(4) X281-2A	(5) X581-2A	(6) X281-2A	(7) X971-2A	(8) Y007	Y031-1F
15500065	STORM SEWERS, CLASS A, TYPE 1 600MM	METER	23.5		23.5							
5500070	STORM SEWERS, CLASS A, TYPE 1 675MM	METER	6. 0		6.0							
5500075	STORM SEWERS, CLASS A, TYPE 1 750MM	METER	77.0	63.5	3.0	10.5						
15500430	STORM SEWERS, CLASS A, TYPE 2 300MM	METER	364, 0	104.0	260.0							
15500450	STORM SEWERS, CLASS A, TYPE 2 450MM	METER	189.5		162.5	27.0						
15500465	STORM SEWERS, CLASS A, TYPE 2 600MM	METER	647.5	511.5	136.0							
15500475	STORM SEWERS, CLASS A, TYPE 2 750MM	METER	128.0		124.0	4.0						
15500830	STORM SEWERS, CLASS A, TYPE 3 300MM	METER	64.5		64.5							
15500865	STORM SEWERS, CLASS A, TYPE 3 GOOMM	METER	42.5	42.5								
15501230	STORM SEWERS, CLASS A, TYPE 4 300MM	METER	17.5		17.5							
M5501275	STORM SEWERS, CLASS A, TYPE 4 750MM	METER	16.5		16.5							
<b>15510025</b>	STORM SEWER REMOVAL 300MM	METER	9. 5			9.5						
M5510040	STORM SEWER REMOVAL 400MM	METER	46.0	46.0								
M5510060	STORM SEWER REMOVAL GOOMM	METER	45.5	37.0	8. 5							
15510070	STORM SEWER REMOVAL 750MM	METER	2.5			2.5						
15510080	STORM SEWER REMOVAL 900MM	METER	6.5		6.5							
15870020	BRIDGE SEAT SEALER	SQ M	115						42	73		
15900100	EPOXY CRACK SEALING	METER	34							34		
M5910100	GEOCOMPOSITE WALL DRAIN	SQ M	781								781	
M6010080	FRENCH DRAINS	СП М	29								29	
16010125	PIPE DRAINS 300MM	METER	218.5	218.5								
16010605	PIPE UNDERDRAINS 100MM	METER	973. 0	973.0								
M6010610	PIPE UNDERDRAINS 150MM	METER	24.5		24.5							
					1		1					

(1) WB I-74 STA 152+445.837 TO STA 153+892.180

(2) MAIN STREET STA 2+800.000 TO STA 4+157.000

(3) MAIN STREET STA 2+402.933 TO STA 2+800.000


(4) BRIDGE PLANS SN 090-0160 (EX SN 090-0006) (WB I-74 OVER MAIN STREET)
BRIDGE PLANS SN 090-0163 (EX SN 090-0011) (WB I-74 OVER WASHINGTON STREET)

(5) BRIDGE PLANS SN 090-0159 (EX SN 090-0005) (WB I-74 OVER ALTORFER LANE AND TP&W RAILROAD)

(6) BRIDGE PLANS SN 090-0156 (RAMP K-2 OVER MAIN STREET)

(7) BRIDGE PLANS SN 090-0009 (WB I-74 OVER CAMP STREET, FARM CREEK AND TP&W RAILROAD)

(8) RETAINING WALL SN 090-8512 (ALONG RAMP J-3)
RETAINING WALL SN 090-8513 (ALONG RAMP K-2)

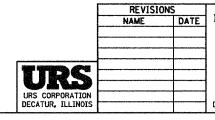

ILLINOIS DEPARTMENT OF TRANSPORTATION FAI ROUTE 74 (I-74)

TOTAL BILL OF MATERIALS

DRAWN BY MLS DATE 12-20-04 CHECKED BY JJM

F.A.I. RTE. TOTAL SHEET SHEETS NO. SECTION COUNTY TAZEWELL STA. TO STA. FED. ROAD DIST. NO. ILLINOIS FED. AID PROJECT

			· · · · · · · · · · · · · · · · · · ·				URBAN	·			
				IM	*	BF	RI			М	
				90% FED		80%	FED		90%	FED	
BILL OF MATERIALS FOR SET 1 OF 4				10% STATE		20% 5	STATE		10%	STATE	
			****	y	·	CONSTRUCTION TYPE CODE					
FOR INFORMATION ONLY			INTERSTATE	ARTERIAL	ARTERIAL	BRIDGE	BRIDGE	BRIDGE	BRIDGE	RETAIN	TRAFFIC
			ROADWAY	ROADWAY	ROADWAY					WALL	SIGNALS
			3 LANE								
DE NO. PAY ITEM	UNIT	TOTAL QUANTITY	(1) J000-2A	(2) 1000-2A	(3) J000-2A	(4) X281-2A	(5) X581-2A	(6) X281-2A	(7) X971-2A	(8) Y007	Y031-1F
010705 PIPE UNDERDRAINS 100MM (SPECIAL)	METER	1435.0	1435.0	1000 ZA	0000 ZA	ALUI EA	X301 ZX	ALUI ZA	X311 2A	1001	1031 11
OOLAGE MANUALES TYPE A 1 ON DIAMETED TYPE 1 FORME ODEN LID	EACH	1									
021405 MANHOLES, TYPE A, 1.2M DIAMETER, TYPE 1 FRAME, OPEN LID	EACH	1		1			***************************************	·····			<del> </del>
021410 MANHOLES, TYPE A, 1.2M DIAMETER, TYPE 1 FRAME, CLOSED LID	EACH	18	1	14	3						
021445 MANHOLES, TYPE A, 1.2M DIAMETER, TYPE 9 FRAME AND GRATE	EACH	2	2								
	F1011										
021485 MANHOLES, TYPE A, 1.2M DIAMETER, TYPE 37 GRATE	EACH	1	<del></del>	1							
021610 MANHOLES, TYPE A, 1.5M DIAMETER, TYPE 1 FRAME, CLOSED LID	EACH	12		11	1						
021805 MANHOLES, TYPE A, 1.8M DIAMETER, TYPE 1 FRAME, OPEN LID	EACH	2	2								
		law .									
021810 MANHOLES, TYPE A, 1.8M DIAMETER, TYPE 1 FRAME, CLOSED LID	EACH	1	1								
021845 MANHOLES, TYPE A. 1.8M DIAMETER, TYPE 9 FRAME AND GRATE	EACH	1	1								
060010 CLASS SI CONCRETE (OUTLET)	CU M	10.3	2. 7	1.0	6.6						
OBSOITS CONCRETE CONTENT	00 111	10. 3	۷. ۱	1.0	0.0						
060260 CONCRETE GUTTER, TYPE A	METER	180.6	139.6		41.0						
060270 CONCRETE GUTTER, TYPE A (MODIFIED)	METER	499.7	499.7								
OCORDO CONDINATION CONCRETE CURB AND CUTTED TYPE D 15 70	METER	450.0	84.0		7000						
060500 COMBINATION CONCRETE CURB AND GUTTER, TYPE B-15.30	METER	452.0	84.0		368.0				***************************************		
060600 COMBINATION CONCRETE CURB AND GUTTER, TYPE B-15.45	METER	33.0	33.0								
060700 COMBINATION CONCRETE CURB AND GUTTER, TYPE B-15.60	METER	3819.0		2888.0	931.0				<u></u>		
ACCION CONDITION CONDETT AND AND CUTTED TYPE AND A				40.0							
062100 COMBINATION CONCRETE CURB AND GUTTER, TYPE M-15.15	METER	10.0		10.0							
062400 COMBINATION CONCRETE CURB AND GUTTER, TYPE M-15,60	METER	11.0		11.0							
063600 CONCRETE MEDIAN SURFACE, 100MM	SQ M	1346		17	1329						
064100 CONCRETE MEDIAN, TYPE SB-15.30	SQ M	156			156				***************************************		-
064800 CONCRETE MEDIAN, TYPE SM	SQ M	12		12							
300100 STEEL PLATE BEAM GUARD RAIL, TYPE A	METER	60.96	11, 43	49, 53							
			11,43								
320030 GUARDRAIL REMOVAL	METER	942	703	42	197						
370120 CONCRETE BARRIER, DOUBLE FACE (MODIFIED)	METER	566	566								

(1) WB I-74 STA 152+445.837 TO STA 153+892.180

(2) MAIN STREET STA 2+800.000 TO STA 4+157.000

(3) MAIN STREET STA 2+402.933 TO STA 2+800.000

(4) BRIDGE PLANS SN 090-0160 (EX SN 090-0006) (WB I-74 OVER MAIN STREET)

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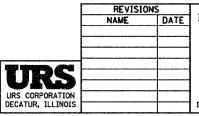
(5) BRIDGE PLANS SN 090-0159 (EX SN 090-0005) (WB I-74 OVER ALTORFER LANE AND TP&W RAILROAD)

(6) BRIDGE PLANS SN 090-0156 (RAMP K-2 OVER MAIN STREET)

(7) BRIDGE PLANS SN 090-0009 (WB I-74 OVER CAMP STREET, FARM CREEK AND TP&W RAILROAD)

(8) RETAINING WALL SN 090-8512 (ALONG RAMP J-3)

RETAINING WALL SN 090-8513 (ALONG RAMP K-2)



ILLINOIS DEPARTMENT OF TRANSPORTATION FAI ROUTE 74 (1-74)

TOTAL BILL OF MATERIALS

DRAWN BY MLS CHECKED BY JJM

DATE 12-20-04


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F.A.I. RTE.	SECTION	COUNTY	TOTAL SHEETS	SHEET NO.
	*	TAZEWELL	1366	38
STA.		TO STA.		
FED. RO	AD DIST. NO.	ILLINOIS FED.	AID PROJ	ECT

\*(90-11)R-2;90(13,14,14-1)R-1

	BILL OF MATERIALS FOR SET 1 OF 4				IM 90% FED 10% STATE		80% 20%	URBAN RI FED STATE TION TYPE	CODE	90%	M FED STATE	
	FOR INFORMATION ONLY			INTERSTATE ROADWAY 3 LANE	ARTERIAL ROADWAY	ARTERIAL ROADWAY	BRIDGE	BRIDGE	BRIDGE	BRIDGE	RETAIN WALL	TRAFFIC SIGNALS
CODE NO.	PAY ITEM	UNIT	TOTAL QUANTITY	(1) J000-2A	(2) I000-2A	(3) J000-2A	(4) X281-2A	(5) X581-2A	(6) X281-2A	(7) X971-2A	(8) Y007	Y031-1F
16370140	CONCRETE BARRIER, SINGLE FACE (MODIFIED)	METER	1372	1372								
16640100	CHAIN LINK FENCE, 1.2 METER	METER	192.0	192.0								
16641920	CHAIN LINK FENCE REMOVAL	METER	165.0	165.0								
17030100	SHORT-TERM PAVEMENT MARKING	METER	20993	20993								
17030510	PAVEMENT MARKING TAPE, TYPE III-LETTERS AND SYMBOLS	SQ M	98	98								
17030520	PAVEMENT MARKING TAPE, TYPE III 100MM	METER	25993	25993								
M7030540	PAVEMENT MARKING TAPE, TYPE III 150MM	METER	749	749								
17030560	PAVEMENT MARKING TAPE, TYPE III 300MM	METER	218	218								
M7030580	PAVEMENT MARKING TAPE, TYPE III 600MM	METER	163	163								
M7031000	WORKZONE PAVEMENT MARKING REMOVAL	SQ M	5497	5497								
7040100	TEMPORARY CONCRETE BARRIER	METER	832.65	832, 65								
M7040200	RELOCATE TEMPORARY CONCRETE BARRIER	METER	155.55	155.55								
17040400	TEMPORARY CONCRETE BARRIER (STATE OWNED)	METER	1302.35	1302.35								
M7210105	SIGN PANEL OVERLAY (SPECIAL)	SQ M	28	28								
M7800100	THERMOPLASTIC PAVEMENT MARKING - LETTERS AND SYMBOLS	SQ M	42.63		42.63							
7800105	THERMOPLASTIC PAVEMENT MARKING - LINE 100MM	METER	5378		5378							
17800115	THERMOPLASTIC PAVEMENT MARKING - LINE 150MM	METER	1263		1263							
17800120	THERMOPLASTIC PAVEMENT MARKING - LINE 200MM	METER	785		785							
w7800125	THERMOPLASTIC PAVEMENT MARKING - LINE 300MM	METER	558		558							
M7800140	THERMOPLASTIC PAVEMENT MARKING - LINE 600MM	METER	85		85							
M7800600	EPOXY PAVEMENT MARKING - LETTERS AND SYMBOLS	SQ M	33. 81			33. 81						
M7800605	EPOXY PAVEMENT MARKING - LINE 100MM	METER	1030			1030						
w7800615	EPOXY PAVEMENT MARKING - LINE 150MM	METER	444			444						
	152+445, 837 TO STA 153+892, 180 (4) BRIDGE PLANS SN 090-0160 (EX SN 090-0006) (WB I-74 OVER MAIN						Г	REVISIO	ons	LINOIS DEPA		s

<sup>(1)</sup> WB I-74 STA 152+445.837 TO STA 153+892.180

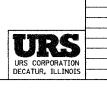

DATE ILLINOIS DEPARTMENT OF TRANSPORTATION FAI ROUTE 74 (I-74)

TOTAL BILL OF MATERIALS

DRAWN BY MLS DATE 12-20-04 CHECKED BY JJM

<sup>(2)</sup> MAIN STREET STA 2+800.000 TO STA 4+157.000

<sup>(3)</sup> MAIN STREET STA 2+402.933 TO STA 2+800.000

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(8) RETAINING WALL SN 090-8512 (ALONG RAWP J-3)
RETAINING WALL SN 090-8513 (ALONG RAWP K-2)

F.A.I. RTE. SECTION STA. TO STA. FED. ROAD DIST. NO. ILLINOIS FED. AID PROJECT

\*(90-li)R-2;90(l3,l4,l4-l)R-l

							<del> </del>	URBAN				
					IM			RI			М	
					90% FED			FED			FED	
	BILL OF MATERIALS FOR SET 1 OF 4				10% STATE			STATE		10%	STATE	
	FOR INFORMATION ONLY							CONSTRUCTION TYPE CODE				
	FOR INFORMATION ONLY			INTERSTATE ROADWAY 3 LANE	ROADWAY	ROADWAY	BRIDGE	BRIDGE	BRIDGE	BRIDGE	RETAIN WALL	TRAFFIC SIGNALS
CODE NO.	PAY ITEM	UNIT	TOTAL QUANTITY	(1) J000-2A	(2) 1000-2A	(3) J000-2A	(4) X281-2A	(5) X581-2A	(6) X281-2A	(7) X971-2A	(8) Y007	Y031-1F
M7800620	EPOXY PAVEMENT MARKING - LINE 200MM	METER	472			472						
M7800625	EPOXY PAVEMENT MARKING - LINE 300MM	METER	81			81						
M7800640	EPOXY PAVEMENT MARKING - LINE 600MM	METER	93			93						
M7802010	POLYUREA PAVEMENT MARKING TYPE I - LINE 100MM	METER	9399	9315		84						
M7802015	POLYUREA PAVEMENT MARKING TYPE I - LINE 150MM	METER	1896	1896								
M7802020	POLYUREA PAVEMENT MARKING TYPE I - LINE 200MM	METER	2827	2812		15						
M7802030	POLYUREA PAVEMENT MARKING TYPE I - LINE 300MM	METER	286	286								
M7802060	POLYUREA PAVEMENT MARKING TYPE I - LINE GOOMM	METER	11			11						
M8100260	CONDUIT IN TRENCH, 50MM DIA., PVC	METER	2812.0									2812.0
M8100280	CONDUIT IN TRENCH, 75MM DIA., PVC	METER	36.0									36.0
M8100290	CONDUIT IN TRENCH, 90MM DIA., PVC	METER	64.0									64.0
M8101450	CONDUIT PUSHED, 50MM DIA., PVC	METER	107.0									107.0
M8101480	CONDUIT PUSHED, 90MM DIA., PVC	METER	107.0									107.0
M8110190	CONDUIT ATTACHED TO STRUCTURE, 90MM DIA., GALVANIZED STEEL	METER	6. 1									6. 1
M8150200	TRENCH AND BACKFILL FOR ELECTRICAL WORK	METER	1901.0									1901.0
M8170040	ELECTRIC CABLE IN CONDUIT, 600V (XLP-TYPE USE) 1/C NO. 6	METER	51.0									51.0
M8731220	ELECTRIC CABLE IN CONDUIT, SIGNAL NO. 14 3C	METER	63.0									63.0
M8731240	ELECTRIC CABLE IN CONDUIT, SIGNAL NO. 14 5C	METER	853. 0									853.0
M8731250	ELECTRIC CABLE IN CONDUIT, SIGNAL NO. 14 7C	METER	244.0									244.0
M8750510	TRAFFIC SIGNAL POST, GALVANIZED STEEL 4.85 METER	EACH	3									3
M8770760	STEEL COMBINATION MAST ARM ASSEMBLY AND POLE 11.58 METER	EACH	2									2
M8780100	CONCRETE FOUNDATION, TYPE A	METER	2. 7									2. 7
M8780200	CONCRETE FOUNDATION, TYPE D	METER	2. 2			<del>                                     </del>						2. 2
L				L	1		İ	L		<u> </u>	<u> </u>	SHEET

(1) WB I-74 STA 152+445.837 TO STA 153+892.180

(2) MAIN STREET STA 2+800.000 TO STA 4+157.000

(3) MAIN STREET STA 2+402.933 TO STA 2+800.000

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DATE ILLINOIS DEPARTMENT OF TRANSPORTATION FAI ROUTE 74 (I-74)

TOTAL BILL OF MATERIALS

DRAWN BY MLS DATE 12-20-04

CHECKED BY JJM

SECTION	COUNTY	TOTAL SHEETS	SHEET NO.
*	TAZEWELL	1366	40
	TO STA.		
DAD DIST. NO.	ILLINOIS FED.	AID PROJ	ECT
	*	* TAZEWELL TO STA.	* TAZEWELL 1366 TO STA.

\*(90-11)R-2;90(13,14,14-1)R-1

								URBAN	T			+ · · · · · · · · · · · · · · · · · · ·		
					IM 90% FED		ļ	RI	IM					
					80%	FED		90%	FED					
	BILL OF MATERIALS FOR SET 1 OF 4				STATE									
					7	T	CONSTRUC	TION TYPE	CODE	T -		T		
	FOR INFORMATION ONLY			INTERSTATE	ARTERIAL	ARTERIAL	BRIDGE	BRIDGE	BRIDGE	BRIDGE	RETAIN	TRAFFIC		
				ROADWAY	ROADWAY	ROADWAY					WALL	SIGNALS		
				3 LANE		(7)								
CODE NO.	PAY ITEM	UNIT	TOTAL QUANTITY	(1) J000-2A	(2) I000-2A	(3) J000-2A	(4) X281-2A	(5) X581-2A	(6) X281-2A	(7) X971-2A	(8) Y007	Y031-1F		
V8780400	CONCRETE FOUNDATION, TYPE E 750MM DIAMETER	METER	3.0									3.0		
MX030199	TEMPORARY PAVEMENT	SQ M	12378	6525		5853						1		
WX030133	TEM VIGINI LAVENIEN	30 111	12310	6323		3033								
MX030345	LIGHTWEIGHT CELLULAR CONCRETE FILL	CU M	51.7								51.7			
MX030396	FILL EXISTING STORM SEWERS	CU M	99. 5		99.5									
10070470	FORM LINED COLD AND EIN CUREAGE	50.14	1400								1400			
MX030472	FORM LINER GRID AND FIN SURFACE	SQ M	1492								1492			
MX032134	BRACED EXCAVATION	CU M	443				165			278				
MX032138	PIPE ELBOW GOOMM	EACH	6	6										
MX032186	PIPE ELBOW 300MM	EACH	25	25			1					-		
MX032188	CLASS SI CONCRETE, SPECIAL	си м	154. 2	154.2										
MX032693	REMOVE TEMPORARY CONCRETE BARRIER, STATE OWNED	METER	2025. 20	2025.20										
MX033109	DRILLING AND SETTING SOLDIER PILES	CU M	749.0								749.0			
MX033182	APPLY DUST SUPPRESSION AGENTS	UNIT	1125	627	352	146								
MX033183	SOIL STABILIZERS	KG	36818	13500	18134	5184								
WX033103	JOJE JIADILIZENO		30010	13500	10131	3101								
MX033192	AGGREGATE SUBBASE	M TON	19081	18355		726								
MX033194	WHITEWASH .	SQ M	24710	24710										
MX033462	REMOVAL AND DISPOSAL OF TEMPORARY CONCRETE BARRIER (STATE OWNED)		707.60	707.60			ļ							
MAUJJ462	REMOVAL AND DISPOSAL OF TEMPORARY CONCRETE BARRIER (STATE OWNED)	METER	101.60	701.60										
MX203010	SPECIAL EXCAVATION	CU M	11470		5900	5570								
MX406024	BITUMINOUS CONCRETE SURFACE COURSE, SUPERPAVE, MIX "D", N70	M TON	3419		3419	<u> </u>								
MX406216	BITUMINOUS CONCRETE BINDER COURSE, SUPERPAVE, IL-19.0, N70	M TON	6555		6555	+		<u> </u>	<u> </u>		•			
MX406295	BITUMINOUS CONCRETE BINDER COURSE, SUPERPAVE, IL - 19.0L (LOW ESAL)	M TON	7659	7656		3								
MX500133	FLOATING BEARINGS, FIXED-1850KN	EACH	4						4					
MX500325	FLOATING BEARINGS, GUIDED EXPANSION, 1500KN	EACH	20						8	12		<u> </u>		
мХ500335	FLOATING BEARINGS, GUIDED EXPANSION, 2000KN	EACH	4						4					
MX504002	FURNISHING AND ERECTING PRECAST PRESTRESSED CONCRETE BULB T-BEAMS, 1829MM	METER	380	<u> </u>	L		380	L		L		SHEET 1		

(1) WB I-74 STA 152+445.837 TO STA 153+892.180

(2) MAIN STREET STA 2+800.000 TO STA 4+157.000

(4) BRIDGE PLANS SN 090-0160 (EX SN 090-0006) (WB I-74 OVER MAIN STREET)
BRIDGE PLANS SN 090-0163 (EX SN 090-0011) (WB I-74 OVER WASHINGTON STREET)

(5) BRIDGE PLANS SN 090-0159 (EX SN 090-0005) (WB I-74 OVER ALTORFER LANE AND TP&W RAILROAD)

(6) BRIDGE PLANS SN 090-0156 (RAMP K-2 OVER MAIN STREET)

(7) BRIDGE PLANS SN 090-0009 (WB I-74 OVER CAMP STREET, FARM CREEK AND TP&W RAILROAD)

(8) RETAINING WALL SN 090-8512 (ALONG RAWP J-3)
RETAINING WALL SN 090-8513 (ALONG RAWP K-2)

(3) MAIN STREET STA 2+402.933 TO STA 2+800.000

REVISIONS
NAME DATE ILLINOIS DEPARTMENT OF TRANSPORTATION FAI ROUTE 74 (I-74)

TOTAL BILL OF MATERIALS

DATE 12-20-04

DRAWN BY MLS CHECKED BY JJM

		00	64 B	
F.A.I. RTE.	SECTION	COUNTY	TOTAL SHE SHEETS NO.	
	*	TAZEWELL	1366 41	/
STA.		TO STA.		
FED. RO	AD DIST. NO.	ILLINOIS FED.	AID PROJECT	

\*(90-11)R-2;90(13,14,14-1)R-1

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					IM		В	RI			М		
					90% FED		80%	FED		90%	FED		
	BILL OF MATERIALS FOR SET 1 OF 4				10% STATE		<u> </u>	STATE	10% STATE				
					CONSTRUCTION TYPE CODE								
	FOR INFORMATION ONLY			INTERSTATE ROADWAY 3 LANE	ARTERIAL ROADWAY	ARTERIAL ROADWAY	BRIDGE	BRIDGE	BRIDGE	BRIDGE	RETAIN WALL	TRAFFIC SIGNALS	
CODE NO.	PAY ITEM	UNIT	TOTAL QUANTITY	(1) J000-2A	(2) 1000-2A	(3) J000-2A	(4) X281-2A	(5) X581-2A	(6) X281-2A	(7) X971-2A	(8) Y007	Y031-1F	
MX509025	ALUMINUM RAILING, TYPE H, SPECIAL	METER	117.0	5000 ZA	1000 2A	UUUU ZA	117.0	XJUI ZA	XEUI ZA	7311 27	1001	1031 11	
MX602751	INLET-MANHOLE, TYPE G-1, 1.2M DIAMETER, SPECIAL	EACH	5		5								
MX602756	INLET-MANHOLE, TYPE G-1, 1.5M DIAMETER, SPECIAL	EACH	22		20	2							
MX637112	CONCRETE BARRIER TRANSITION (MODIFIED)	METER	10	10									
MX704200	REMOVE TEMPORARY CONCRETE BARRIER	METER	832.65	832.65									
MX720100	TEMPORARY SIGN PANEL ASSEMBLY	SQ M	32.3	32.3									
MX721010	COMPOSITE TEMPORARY SIGN OVERLAY	SQ M	22	22									
MX871055	FIBER OPTIC CABLE IN CONDUIT, NO. 62.5/125, MM12F SM12F	METER	1516.0									1516.0	
MX877017	STEEL COMBINATION MAST ARM ASSEMBLY AND POLE 15.85 METER	EACH	1									1	
MX877020	STEEL COMBINATION MAST ARM ASSEMBLY AND POLE 16.76 METER	EACH	3									3	
MX878030	CONCRETE FOUNDATION, TYPE E 900MM DIAMETER	METER	25									25	
MZ008830	DRILLED SHAFT IN SOIL, 915MM	METER	25.5						25.5			-	
		METER											
MZ008880	DRILLED SHAFT IN SOIL, 1830MM		1.0						1.0				
MZ008930	DRILLED SHAFT IN ROCK, 760MM	METER	20.5						20, 5				
MZ008980	DRILLED SHAFT IN ROCK, 1830MM	METER	16.5						16.5				
MZ017205	DOWEL BARS 38MM	EACH	1133	21	1112								
MZ022400	FABRIC REINFORCED ELASTOMERIC TROUGH	METER	36.9						17.5	19.4		-	
MZ047300	PROTECTIVE SHIELD	SQ M	2959				1099	310		1550			
								1 310					
X0301840	DRILL AND GROUT #35 TIE BARS	EACH	1308	196	1112			<u> </u>				-	
X0321809	PERMANENT GROUND ANCHOR	EACH	204								204		
X0323481	VIDEO VEHICLE DETECTION, 4 CAMERAS	EACH	2									2	
X0323639	INSTALL BOLLARD AND LUMINAIRES	EACH	4				4					+	
												SHEET 13	

(1) WB I-74 STA 152+445,837 TO STA 153+892,180

(2) MAIN STREET STA 2+800.000 TO STA 4+157.000

(4) BRIDGE PLANS SN 090-0160 (EX SN 090-0006) (WB I-74 OVER MAIN STREET)
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(5) BRIDGE PLANS SN 090-0159 (EX SN 090-0005) (WB I-74 OVER ALTORFER LANE AND TP&W RAILROAD)

(6) BRIDGE PLANS SN 090-0156 (RAMP K-2 OVER MAIN STREET)

(7) BRIDGE PLANS SN 090-0009 (WB I-74 OVER CAMP STREET, FARM CREEK AND TP&W RAILROAD)

(8) RETAINING WALL SN 090-8512 (ALONG RAMP J-3)
RETAINING WALL SN 090-8513 (ALONG RAMP K-2)

(3) MAIN STREET STA 2+402.933 TO STA 2+800.000

REVISIONS
NAME DATE ILLINOIS DEPARTMENT OF TRANSPORTATION FAI ROUTE 74 (I-74)

TOTAL BILL OF MATERIALS

DRAWN BY MLS CHECKED BY JJM DATE 12-20-04

COUNTY TOTAL SHEETS NO.
TAZEWELL 1366 42 F.A.I. RTE. SECTION STA. TO STA. FED. ROAD DIST. NO. ILLINOIS FED. AID PROJECT

\*(90-11)R-2;90(13,14,14-1)R-1

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					IM		Ві	<b>?</b> I		I	М		
					90% FED		80%	FED		90%	FED		
	BILL OF MATERIALS FOR SET 1 OF 4				10% STATE		20% 5	STATE		10%	STATE		
							CONSTRUC	TION TYPE (	CODE				
	FOR INFORMATION ONLY			INTERSTATE	ARTERIAL	ARTERIAL	BRIDGE	BRIDGE	BRIDGE	BRIDGE	RETAIN	TRAFFIC	
				ROADWAY	ROADWAY	ROADWAY					WALL	SIGNALS	
				3 LANE						man de la companya de			
CODE NO.	PAY ITEM	UNIT	TOTAL QUANTITY	(1) J000-2A	(2) 1000-2A	(3) J000-2A	(4) X281-2A	(5) X581-2A	(6) X281-2A	(7) X971-2A	(8) Y007	Y031-1F	
(0323677	STREET SWEEPING	HOUR	767	462	251	54	7201 ZA	7301 24	7201 2A	A3/1 2A	1001	1031-11	
(0323678	DUST CONTROL PADS	EACH	62	36	21	5							
(0323616	DOST CONTROL FADS	EACH	62	76	21	3							
(0323778	DRAINAGE SCUPPERS, TYPE 1	EACH	16				4		5	7			
x0323779	DRAINAGE SCUPPERS, TYPE 2	EACH	2				2						
X0323830	DRAINAGE SCUPPERS, DS-11	EACH	7					7					
								·					
X0323989	REINSTALL TEMPORARY SIGN PANEL ASSEMBLY	EACH	28	28									
(0324134	BATTERY BACKUP SYSTEM WITH CABINET	EACH	3									3	
K0349800	CONCRETE HEADWALL FOR PIPE UNDERDRAIN REMOVAL	EACH	2	2									
X0504200	CONCRETE HEADWALL	EACH	3	3									
X0976500	END SECTIONS TO BE REMOVED	EACH	19	6	10	3			·				
X6020065	INLETS, TYPE G-1, DOUBLE (SPECIAL)	EACH	6	<del>.,</del>	5	1							
V7015000	CHANGEABLE MESSAGE SIGN	CAL NO	0.4		0.0	20							
(7015000	CHANGEABLE MESSAGE SIGN	CAL MO	84	28	28	28							
x8800020	SIGNAL HEAD , LED, 1-FACE, 3-SECTION, MAST-ARM MOUNTED	EACH	18									18	
K8800035	SIGNAL HEAD , LED, 1-FACE, 3-SECTION, BRACKET MOUNTED	EACH	7									7	
X8800038	SIGNAL HEAD , LED, 1-FACE, 4-SECTION, MAST ARM MOUNTED	EACH	1									1	
												-	
K8800040	SIGNAL HEAD , LED, 1-FACE, 5-SECTION, BRACKET MOUNTED	EACH	4									4	
X8810610	PEDESTRIAN SIGNAL HEAD, LED, 1-FACE, BRACKET MOUNTED	EACH	2									2	
Z0000100	ABANDON EXISTING CULVERT	EACH	1	1				1					
			E14				183	170	6.1	98			
20002600	BAR SPLICERS	EACH	514				183	172	61	38			
Z0018800	DRAINAGE SYSTEM	L SUM	1					0.19	0.67	0.14			
20024478	FLEXIBLE DELINEATORS	EACH	309	309									
20030020	IMPACT ATTENUATORS (FULLY REDIRECTIVE, NARROW) TEST LEVEL 2	EACH	2	2									
20030030	IMPACT ATTENUATORS (FULLY REDIRECTIVE, NARROW) TEST LEVEL 3	EACH	3	3	ļ								

(1) WB I-74 STA 152+445.837 TO STA 153+892.180

(2) MAIN STREET STA 2+800.000 TO STA 4+157.000

(3) MAIN STREET STA 2+402.933 TO STA 2+800.000

(4) BRIDGE PLANS SN 090-0160 (EX SN 090-0006) (WB I-74 OVER MAIN STREET)
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(7) BRIDGE PLANS SN 090-0009 (WB I-74 OVER CAMP STREET, FARM CREEK AND TP&W RAILROAD) (8) RETAINING WALL SN 090-8512 (ALONG RAMP J-3)

RETAINING WALL SN 090-8513 (ALONG RAMP K+2)

REVISIONS DATE URS URS CORPORATION DECATUR, ILLINOIS

ILLINOIS DEPARTMENT OF TRANSPORTATION FAI ROUTE 74 (1-74)

TOTAL BILL OF MATERIALS

DRAWN BY MLS CHECKED BY JJM

DATE 12-20-04

			00	201	
F.A.I. RTE.	SECTION	COUN	TY	SHEETS	SHEET NO.
	*	TAZEW	1366	43	
STA.		TO STA.			
FED. ROA	D DIST. NO.	ILLINOIS	FED.	AID PROJ	ECT

(90-i)R-2:90(3.i4.i4-i)R-!	-2;90(13,14,14-1)R-	ı
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*								URBAN					
					IM		BRI			I	M		
				90% FED			80%	FED					
	BILL OF MATERIALS FOR SET 1 OF 4				10% STATE		20% \$	STATE		10% 5	STATE		
				***************************************			CONSTRUC	TION TYPE (	CODE				
	FOR INFORMATION ONLY			INTERSTATE	ARTERIAL	ARTERIAL	BRIDGE	BRIDGE	BRIDGE	BRIDGE	RETAIN	TRAFFIC	
	TON THE ONLY			ROADWAY			BRIDGE	DRIDGE	BRIDGE	BRIDGE			
				3 LANE	ROADWAY	ROADWAY					WALL	SIGNALS	
			TOTAL	(1)	(2)	(3)	(4)	(5)	(6)	(7)	(8)		
CODE NO.	PAY ITEM	UNIT	QUANTITY	J000-2A	1000-2A	J000-2A	X281-2A	X581-2A	X281-2A	X971-2A	Y007	Y031-1F	
Z0030250	IMPACT ATTENUATORS, TEMPORARY (NON-REDIRECTIVE), TEST LEVEL 3	EACH	1	1									
Z0030350	IMPACT ATTENUATORS, RELOCATE (NON-REDIRECTIVE), TEST LEVEL 3	EACH	1	1					,				
20030330	IMPACT ATTENDATORS, RELOCATE (NON-REDIRECTIVE), TEST LEVEL S	- LAOII	1	1									
Z0031405	JACKING AND SHORING EXISTING GIRDERS	L SUM	1							1			
70004540	CEEDAGE COLLAD	EACH	17									-	
Z0064540	SEEPAGE COLLAR	EACH	1 /	17								+	
Z0076870	UNDERDRAIN CONNECTION TO STRUCTURE	EACH	23	23									
	DDV// FD C//FT VI COV / 4000M		4 5						4.5				
#4001602	DRILLED SHAFT IN SOIL, 1980MM	METER	4.5						4.5		<u> </u>	-	
#4001620	LIGHT POLE, GALVANIZED STEEL, 13.5 M M.H., 4.5 M DAVIT ARM	EACH	1									1	
#4001621	STORM SEWER CLASS A, TYPE 1 750MM EQUIVALENT	METER	32			32		1				İ	

(1) WB I-74 STA 152+445.837 TO STA 153+892.180

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SHEET 15 OF 15

S | DATE | ILLINOIS DEPARTMENT OF TRANSPORTATION | FAI ROUTE 74 (I-74)

TOTAL BILL OF MATERIALS

DATE 12-20-04

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| F.A.I. | SECTION | COUNTY | TOTAL | SHEET | SHEET |

## SCHEDULE OF CONFLICTING UTILITIES - (MAIN LINE) I-74 WEST BOUND

					I I I WEST DOOND					
OWNER	ROUTE/STREET	OFFSET	STATION	TYPE OF UTILITY	TYPE OF CONFLICT	DISPOSITION	ADDRESS	PHONE NO.	CONTACT	REMARKS
AT&T .	I-74 (WB)	RUNS PERPENDICULAR TO ¢	152+681	F.O. CABLE	BRIDGE FDN.	CAUTION	AT&T	(630) 240-1373	DAVID BUGGAR	-
CITY OF EAST PEORTA (SANITARY)	[-74 (WB)	RUNS PERPENDICULAR TO ¢	. 152+677	100mm SANITARY FORCE MAIN	BRIDGE FON.	CAUTION	CITY OF EAST PEORIA (SANITARY)	(309) 698-4716	JACKIE HARMANN	-
WILLIAMS COMMUNICATIONS	E-74 (WB)	RUNS PERPENDICULAR TO ¢	152+692	F,O, CABLE	BRIDGE FDN.	CAUTION	WILLIAMS COMMUNICATIONS	(630) 375-5877	JOE PROTSMAN	-
McLE00	[~74 (WB)	RUNS PERPENDICULAR TO &	153+026	F.O. CABLE	BRIDGE FDN.	CAUTION	MoLEOD	(217) 876-7194	CARL ATTEBERRY	-
INSIGHT	[-74 (WB)	RUNS PERPENDICULAR TO ¢	153+032	CABLE T.V.	BRIDGE FDN.	CAUTION	INSIGHT	(309) 686-267?	BRUCE VON BRETHORST	-
CITY OF EAST PEORIA (WATER)	[-74 (W3)	RUNS PERPENDICULAR TO ¢	153+037	250MM WATER MAIN	BRIDGE FDN.	CAUTION	CITY OF EAST PEORIA (WATER)	(309) 698-4716	STEVE FURGUSON :	-
AMEREN CILCO (GAS)	J-74 (W8)	RUNS PERPENDICULAR TO ¢	153+064	300mm GAS	BRIDGE FDM.	CAUTION	AMEREN CILCO (GAS)	(309) 444-7915	REED COOLING	-
T&TA	[-74 (W3)	RUNS PERPENDICULAR TO ¢	153+085	F.O. CABLE	BRIDGE FDN.	CAUTION	ATS,T	(630) 240-1373	DAVID BUGGAR	,
AMEREN CILCO (ELECTRIC)	[-74 (W3)	4m± R <sup>T</sup> - 15m± ∟T	153+582± +o 153+596±	ELECTRIC DUCTS	PIER FOUNDATION	RELOCATE	AMEREN CILCO (SLECTRIC)	(309) 693-4731	DAN URBANIAK	w.
SPRINT	[-74 (W3)	RUNS PERPENDICULAR TO ¢	153+603	F.O. CABLE	BRIDGE FDN.	CAUTION	SPRINT	(800) 521-0579	TBD	
AT&T	[-74 (WS)	RUNS PERPENDICULAR TO ¢	153+606	F.O. CABLE	BRIDGE FDN.	CAUTION	AT&T	(630) 240-1373	DAVID BUGGAR	-
· INSIGHT	1~74 (WB)	RUNS PERPENDICULAR TO ¢	153+712	CABLE T.V.	BRIDGE FON.	CAUTION	INSIGHT	(309) 686-2677	BRUCE VON BRETHORST	-
CITY OF EAST PEORIA (WATER)	[-74 (WR)	RUNS PERPENDICULAR TO ¢	153+841	WATER MAIN	BRIDGE FON.	CAUTION	CITY OF EAST PEORIA (WATER)	(309) 698-4716	STEVE FURGUSON	-
INSIGHT	[-74 (WB)	4n± RT ~ 16m± LT	153+837±	BURISO DUCT W/ CABLE	BURIED ABUTMENT	RELOCATE	INSIGHT	(309) 686-2677	BRUCE VON BRETHORST	
CITY OF EAST PEORIA (SANITARY)	I-74 (WB)	18m± LT · 4m± RT	153+851± +o 153+852±	750mm SANITARY MAIN	PIER FOUNDATION	CAUTION	CITY OF EAST PEGRIA (SANITARY)	(309) 698-4716	JACKIE HARMANN	-
AMEREN CILCO (GAS)	I-74 (WE)	RUNS PERPENDICULAR TO ¢	153+854	LOOMM GAS MAIN	BRJDGE FON./PIER	RELOCATE	AMEREN CILCO (GAS)	(309) 444-79!5	REED COOLING	=
McLEOD ·	1-74 (WB)	RUNS PERPENDICULAR TO ¢	153+856	F.O. CABLE	BRIDGE FON./PIER	RELOCATE	McLECD	(217) 876-7194	CARL ATTEBERRY	-
CITY OF EAST PEOR!A (SANITARY)	I-74 (WB)	18m± LT - 14m± RT	153÷857±	375mm SANITARY MAIN	PIER	RELOCATED/ ABANDONED	CITY OF EAST PEORIA (SANITARY)	(309) 698-4716	JACKIE HARMANN	-
CITY OF EAST PEORIA (SANITARY)	I-74 (WB)	24.lm l,T = 16.0m RT	153+650 to 153+720	350 SANITARY	PIER	CAUTION	CITY OF EAST PEORIA (SANITARY)	(309) 698-4716	JACKIE HARMANN	-

#### SCHEDULE OF CONFLICTING UTILITIES - (MAIN LINE) I-74 RAMP J-3, EXIT (STA. 10+000 TO STA. 10+400)

		10.7			7					
OWNER	ROUTE/STREET	OFFSET	STATION	TYPE OF UTILITY	TYPE OF CONFLICT	DISPOSITION	ADDRESS	PHONE NO.	CONTACT	REMARKS
. AY&*	RAMP J-3 EXIT	RUNS PERPENDICULAR TO Q	10+351	F.O. CABLE	PAV'T CONST.	CAUTION	AT&T	(630) 240-1373	DAVID BUGGAR	-

#### SCHEDULE OF CONFLICTING UTILITIES - (MAIN LINE) I-74 RAMP J-4, EXIT (STA. 10+000 TO STA. 10+600)

OWNER	ROUTE/STREET	OFFSET	STATION	TYPE OF UTILITY	TYPE OF CONFLICT	DISPOSITION	ADDRESS	PHONE NO.	CONTACT -	REMARKS
McLEOD	RAMP J-4 ENT.	RUNS PERPENDICULAR TO &	10+022	F.O. CABLE	PAY'T CONST./CUT	CAUTION	McLEOD	(217) 876-7194	CARL ATTEBERRY	=
CITY OF EAST PEORIA (WATER)	RA¥P J-4 ENT,	RUNS PERPENDICULAR TO Q	10+030	250mm WATER MAIN	PAV'T CONST,	CALTION	CITY OF EAST PEORIA (WATER)	(309) 696-4716	STEVE FURGUSON	-
SBC	RAMP J-4 ENT,	RUNS PERPENDICULAR TO ¢	10+295	TE: EPHONE	PAV'T CONST,	CAUTION	SBC	(217) 789-8883	RICH WEINGAND	=
CITY OF EAST PEORIA (WATER)	RAWP J-4 ENT.	RUNS PERPENDICULAR TO Q	10÷296	300mm WATER MAIN	PAV'T CONST.	CAUTION	CITY OF EAST PEORIA (WATER)	(309) 698-4716	STEVE FURGUSON	-

#### SCHEDULE OF CONFLICTING UTILITIES - (MAIN LINE) I-74 RAMP K-2, EXIT (STA. 10+000 TO STA. 10+900)

OWNER	ROUTE/STREET	OFFSET -	STATION	TYPE OF UTILITY	TYPE OF CONFLICT	DISPOSITION	ADDRESS	PHONE NO.	CONTACT	REMARKS
AT&T	RAMP K-2 EXIT	RUNS PERPENDICULAR TO Q	10+572	F.O. CABLE	BRIDGE FDN.	CAUTION	AT&T	(630) 240-1373	DAVID BUGGAR	-
AMEREN CILCO (GAS) .	RAMP K-2 EXIT	RUNS PERPENDICULAR TO C	10+592	300min GAS	BRIDGE FON.	CAUTION	AMEREN CILCO (GAS)	(309) 444-7915	REED COOLING	=
CITY OF EAST PEORIA (WATER)	RAMP K-2 EXIT	RUNS PERPENDICULAR TO \$	10+619	250mm WATER MAIN	BRIDGE FON.	CAUTION	CITY OF EAST PEORIA (WATER)	(309) 698-4716	STEVE FURGUSON	
INSIGHT	RAMP K-2 EXIT	RUNS PERPENDICULAR TO C	. 10+624	CABLE T.V.	BRIDGE FON.	CAUTION	INSIGHT	(309) 686-2677	BRUCE VON BRETHORST	-
MoLEOD .	RAMP K-2 EXIT	RUNS PERPENDICULAR TO &	10+630	F.O. CABLE	BREDGE FON.	CAUTION	WollEGD	(217) 876-7194	. CARL ATTEBERRY	4

MAUHER STUTZ, INC.

ENGINEERS SURVEYORS

ILLINOIS DEPARTMENT OF TRANSPORTATION

STATUS OF UTILITIES
TO BE ADJUSTED

SHEET 1 OF 2

DATE 12/20/04

REVISIONS NAME [

> DRAWN BY JAM CHECKED BY MJS

F.A.I. SECTION COUNTY TOTAL SHEET SHOOT TAY TAZEWELL 366 45

STA. TO STA.

FED. ROAD DIST. NO. 4 ILLINOIS FED. AID PROJECT

\* (90-11)R-2;90(13,14,14-1)R-1

# SCHEDULE OF CONFLICTING UTILITIES - (OFF SYSTEM) MAIN STREET


OWNER	ROUTE/STREET	OFFSET	STATION	TYPE OF UTILITY	TYPE OF CONFLICT	DISPOSITION	ADDRESS	PHONE NO.	CONTACT	REMARKS
SBC	MAIN STREET	15.1m LT - 9.5m LT	2+400.00 to 4+025.00	TELEPHONE DUCT	PAY'T CONST/STORM SEWER	RELOCATE	SBC	(217) 789-8883	RICH WEINGAND	
AMEREN CILCO (GAS)	MAIN STREET	11.1m RT - 15.8m RT	2+203,00 to 4+150,00	300inmi GAS	PAY'T CONST./C & G/INLET/ STORM SEWER/MANHOLES	RELOCATE	AMEREN CILCO (GAS)	(309) 444-7915	REED COOLING	
ITY OF EAST PEORIA (WATER)	MAIN STREET	4.6m LT - 15.8m RT	2+400,00 to 3+000,00	150mm WATER	MANHOLE/ PAY'T CONST./ STORM SEWER	CAUTION	CITY OF EAST PEDRIA (WATER)	(309) 698-4716	STEVE FURGUSON	# ## ## ## 1 1 m
INSIGHT	MAIN STREET	18.5m LT - 15.4m LT	2÷400.00 to 2+490.00	CABLE T.V.	PAV'T CONST.	RELOCATE	INSIGHT	(309) 686-2677	BRUCE VON BRETHORST	*** ** *******************************
AMEREN CILCO (ELECTRIC)	MAIN STREET	11m# LT - 15m# RT	2+403± to 2-489±	AERIAL ELECTRIC	BRIDGE	RELOCATE	AMEREN CILCO (ELECTRIC)	(309) 693-4731	DAN URBANIAK	(An of 5 H)
AMEREN CILCO (ELECTRIC)	MAJN STREET	28m± RT	2+445±	POWER POLE	CULVERT/ DITCH/ CUT	RELOCATE	AMEREN CILCO (ELECTRIC)	(309) 693-4731	DAN URBANIAK	
AMEREN CILCO (ELECTRIC)	MAIN STREET	24,5m± RT	2+450±	POWER POLE	STORM SEWER	CAUTION	AMEREN CILCO (ELECTRIC)	(309) 693-4731	DAN URBANIAK	
AMEREN CILCO (ELECTRIC)	MAIN STREET	15m± LT	2+489±	POWER POLE	PAVEMENT	RELOCATE	AMEREN CILCO (ELECTRIC)	(309) 693-4731	JAN URBANIAK	
AMEREN CILCO (ELECTRIC)	MAIN STREET	15m# RT	2+572±	POWER POLE	PAVEMENT	RELOCATÉ	AMEREN CILCO (ELECTRIC)	(309) 693-4731	DAN URBANIAK	A Para Later Control of Control o
SBC :	MAIN STREET	9.6m LT - 8.0m LT	2+660.00 to 3+850.00	TELEPHONE CABLE/VANHOLE	PAV'T CONST.	RELOCATE	SBC	(217) 789-8883	RICH WEINGAND	
SBC	MAIN STREET	13.2m LT - 39.0m LT	2+665.00 to 2+680.00	F.O. CABLE	PAV'T CONST/STORM SEWER	RELOCATE	SBC	(217) 789-8883	RICH WEINGAND	· v. · · yy- · · · · · · · · · · · · · · · ·
AMEREN CILCO (ELECTRIC)	MAIN STREET	18m= RT	2+691±	POWER POLE	MANHOLE	CAUTION	AMEREN CILCO (ELECTRIC)	(309) 693-4731	DAN JRBANIAK	
AMEREN CIECO (ELECTRIC)	MAIN STREET	42m± (,T	2+691±	POWER □OLE	CCC & G	RELOCATE	AMEREN CILCO (ELECTRIC)	(309) 693-4731	DAN JRBANİAK	
ITY OF EAST PEORIA (WATER).	. MAIN STREET	7m± RT	2-694±	WATER VALVE	PAVEMENT	RELOCATE	CITY OF EAST PEORIA (WATER)	(309) 698-4716	STEVE FURGUSON	
AMEREN CILCO (GAS)	MAIN STREET	14.0m RT - 21.8m RT	2+698.00 to 2+890.00	50mm GAS	STORM SEWER/ PAV'T CONST,/ C & G	RELOCATE	AMEREN CILCO (GAS)	(309) 444-7915	REED COOLING	
AMEREN CILCO (ELECTRIC)	MAIN STREET	18m± R <sup>∓</sup>	2+734±	POWER POLE	CCC & G	RELOCATE	AMEREN CILCO (ELECTRÍC)	(309) 693-4731	DAN URBANIAK	***************************************
ITY OF EAST PEORIA (WATER)	MAIN STREET	22m± LT	2+750±	250mm WATER MAIN	CULVERT	CAUTION	CITY OF EAST PEORIA (WATER)	(309) 698-4716	- STEVE FURGUSON	
ITY OF EAST PEORIA (WATER)	MAIN STREET	12m± RT	2+775±	WATER VALVE	PAVEMENT	RELOCATE	CITY OF EAST PEORIA (WATER)	(309) 698-4716	STEVE FURGUSON	
AMEREN CILCO (ELECTRIC)	MAIN STREET	18m ± 7.7	2+778±	POWER POLE	GUTTER	RELOCATE	AMEREN CILCO (ELECTRIC)	(309) 693-4731	DAN URBANIAK	
ITY OF EAST PEORIA (WATER)	MAIN STREET	14m± RT	2+782±	WATER VALVE	GUTTER, STORM SEWER	RELOCATE	CITY OF EAST PEORIA (WATER)	(309) 698-4716	STEVE FURGUSON	
CITY OF EAST PEORIA (SANITARY)	MAIN STREET	13m± RT - 14m± RT	2+794± to 2+809±	250mm ŞANITARY MAIN	PAVEMENT/ CCC & G	RELOCATE	CITY OF EAST PEORIA (SANITARY)	(309) 698-4716	JACKIE HARMANN	
AMEREN CILCO (ELECTRIC)	MAIN STREET	18m± LT.	2+824±	POWER POLE	STORW SEWER	CAUTION/ SUPPORT	AMEREN CILCO (ELECTRIC)	(309) 693-4731	DAN URBANIAK	
SBC	MAIN STREET	17.9m RT - 21.5m RT	2+920.00 to 2+975.00	TELEPHONE CABLE	PAVIT CONST/STORM SEWER	HELOCATE	SBC	(217) 789-8883	RICH WEINGAND	
AMEREN CILCO (GAS)	MAIN STREET	13m± RT	2+930=	100mm MAIN IN 200mm CASING	INLET	RELOCATE	AMEREN CILCO (SAS)	(309) 444-7915	REED COGLING	
AMEREN CRICO (ELECTRIC)	MAIN STREET	30m± LT	2+941±	POWER POLE	CCC & G/ GRADING	CAUTION	AMEREN CILCO (ELECTRIC)	(309) 693-4731	DAN URBANIAK	
CITY OF EAST PEORIA (SANITARY)	MAIN STREET	17m± RT - 13,5m± LT	3+479± to 3+497±	SANITARY SEWER LINE	PAVEMENT	CAUTION/ RELOCATE	CITY OF EAST PEORIA (SANITARY)	(309) 898-4716	JACKIE HARMANN	
AMERIN CILCO (GAS)	MAIN STREET	21m ± RT - 20m ± RT	3+656± to 3+700±	100mm GAS MAIN	MANHOLES/ STORM SEWER	RELOCATE	AMEREN CILCO (GAS)	(309) 444-7915	REED COOLING	
ITY OF EAST PEORIA (WATER)	WAIN STREET	16.5m± RT - 15.5m± RT	3+705± to 3+733±	300mm WATER MAIN	PAVEMENT	RELOCATE	CITY OF EAST PEORIA (WATER)	(309) 696-4716	STEVE FURGUSON	
AMEREN CILCO (ELECTRIC)	MAIN STREET	23.5m± RT	3+763±	POWER POLE	GRADING	CAUTION	AMEREN CILCO (ELECTRIC)	(309) 693-4731	DAN URBANIAK	
AMEREN CILCO (GAS)	MAIN STREET	14,0m RT	3+773.00	25mm GAS	PAV'T CONST,	CAUTION	AMEREN CILCO (GAS)	(309) 444-7915	REED COOLING	
AMEREN CILCO (ELECTRIC)	WALN STREET	i7m± RT	3+864±	POWER POLE GUY	MANHOLE/ STORM SEWER	RELOCATE	AMEREN CILCO (ELECTRIC)	(309) 693-4731	DAN URBANJAK	

NOTES: CUT DIMENSION IS DISTANCE FROM TOP OF UTILITY TO BOTTOW OF PROPOSED BASE,

AATUR = ABANDONED ACCORDING TO UTILITY RECORDS

SBC IS CALLED OUT AS AMERITECH ON THE PLAN SHEETS.

	REVISIONS	5					
	NAME	DATE	ILLIN	IOIS DEPARTMEN	II OF	TRANSPO	RIATION
				STATUS (		JTILITI JUSTED	ES
<b>Y</b>				SHEET	2 0	F 2	
MAURER & STUTZ, INC.						DRAWN BY	JAM
			DATE	12/20/04		CHECKED BY	MJS

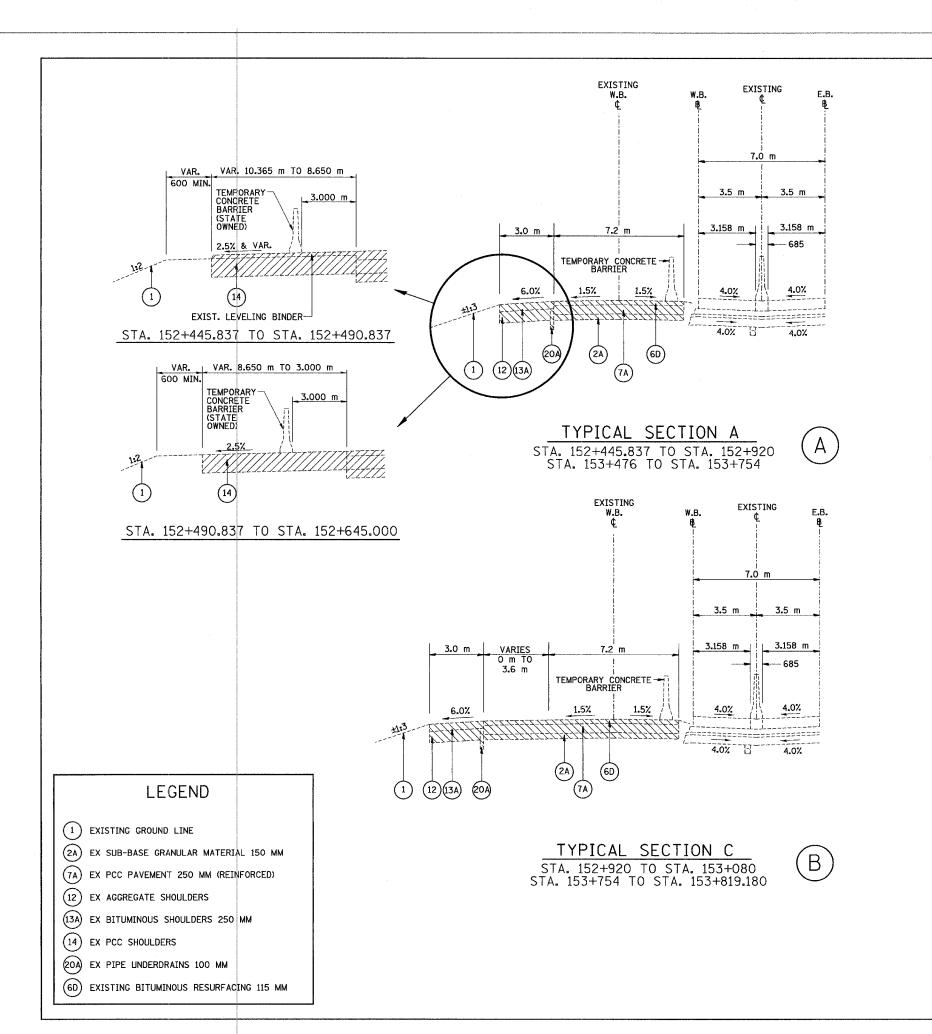

F.A.I. RTE. SECTION COUNTY SHEETS NO.

74 \* TAZEWELL 366 46

STA. TO STA.

FED. ROAD DIST. NO. ILLINOIS FED. AID PROJECT

\* (90-II)R-2; 90(I3,I4,I4-I)R-I

INDICATES ITEMS TO BE REMOVED

NOTES

ALL DIMENSIONS ARE IN MILLIMETERS (mm) UNLESS OTHERWISE STATED.

NAME DATE

URS

URS CORPORATION
ST. LOUIS, MO

ILLINOIS DEPARTMENT OF TRANSPORTATION FAI ROUTE 74 (I-74)

EXISTING TYPICAL SECTIONS

FAI ROUTE 74 (I-74) (WB)

SECTIONS A & B

DRAWN BY DER
12/20/04 CHECKED BY MLB

3.0 m VARIES 7.2 m 3.5 m 3.5 m

TEMPORARY CONCRETE BARRIER

4.0% 4.0% 4.0%


4.0% 4.0%

INDICATES ITEMS TO BE REMOVED

NOTE

ALL DIMENSIONS ARE IN MILLIMETERS (mm) UNLESS OTHERWISE STATED.


TYPICAL SECTION D STA. 153+080 TO STA. 153+369

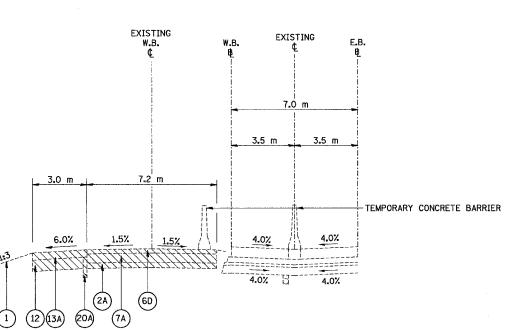

### LEGEND

- 1 EXISTING GROUND LINE
- (2A) EX SUB-BASE GRANULAR MATERIAL 150 MM
- (7A) EX PCC PAVEMENT 250 MM (REINFORCED)
- (12) EX AGGREGATE SHOULDERS
- (13A) EX BITUMINOUS SHOULDERS 250 MM
- EX PIPE UNDERDRAINS 100 MM
- (6D) EXISTING BITUMINOUS RESURFACING 115 MM

TYPICAL SECTION B STA. 153+369 TO STA. 153+476

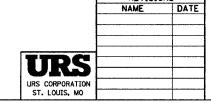


ILLINOIS DEPARTMENT OF TRANSPORTATION
FAI ROUTE 74 (I-74)


EXISTING TYPICAL SECTIONS
FAI ROUTE 74 (I-74) (WB)

SECTIONS C & D


DRAWN BY DER
DATE 12/20/04 CHECKED BY MLB

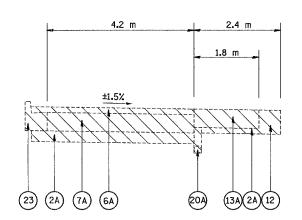


RAMP 18 (STA. 0+048.0 TO 0+329.2)

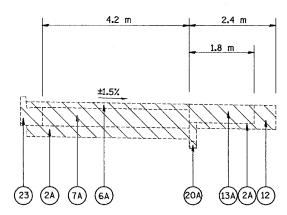


RAMP 20 (STA. 6+012.0 TO 6+22.3)

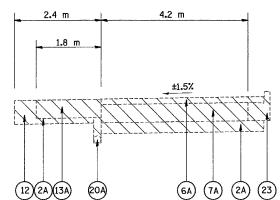

RAMP 23 (STA, 1+052,9 TO 1+281,5)

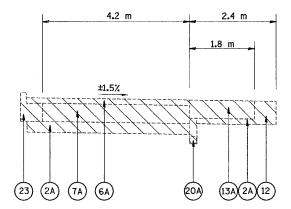

RAMP 19 (STA. 5+004.6 TO 5+199.0)

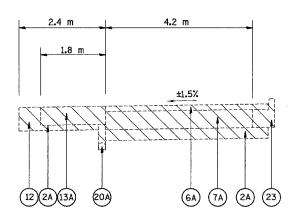

RAMP 21 (STA. 7+232.0 TO 7+464.4)



INDICATES ITEMS TO BE REMOVED

NOTES:

ALL DIMENSIONS ARE IN MILLIMETERS (mm) UNLESS OTHERWISE STATED.

### LEGEND


- (1) EXISTING GROUND LINE
- (2A) EX SUB-BASE GRANULAR MATERIAL 150 MM
- (6A) EX BITUMINOUS RESURFACING 75 MM
- (7A) EX PCC PAVEMENT 250 MM (REINFORCED)
- (12) EX AGGREGATE SHOULDERS
- (13A) EX BITUMINOUS SHOULDERS 250 MM
- (20A) EX PIPE UNDERDRAINS 100 MM
- (23) EX COMBINATION CONCRETE CURB & GUTTER


REVISIONS NAME **URS** URS CORPORATION ST. LOUIS, MO

ILLINOIS DEPARTMENT OF TRANSPORTATION FAI ROUTE 74 (I-74) EXISTING TYPICAL SECTIONS RAMPS NUMBERS 18, 19, 20, 21 & 23

DRAWN BY DER

DATE 12/20/04 CHECKED BY MLB

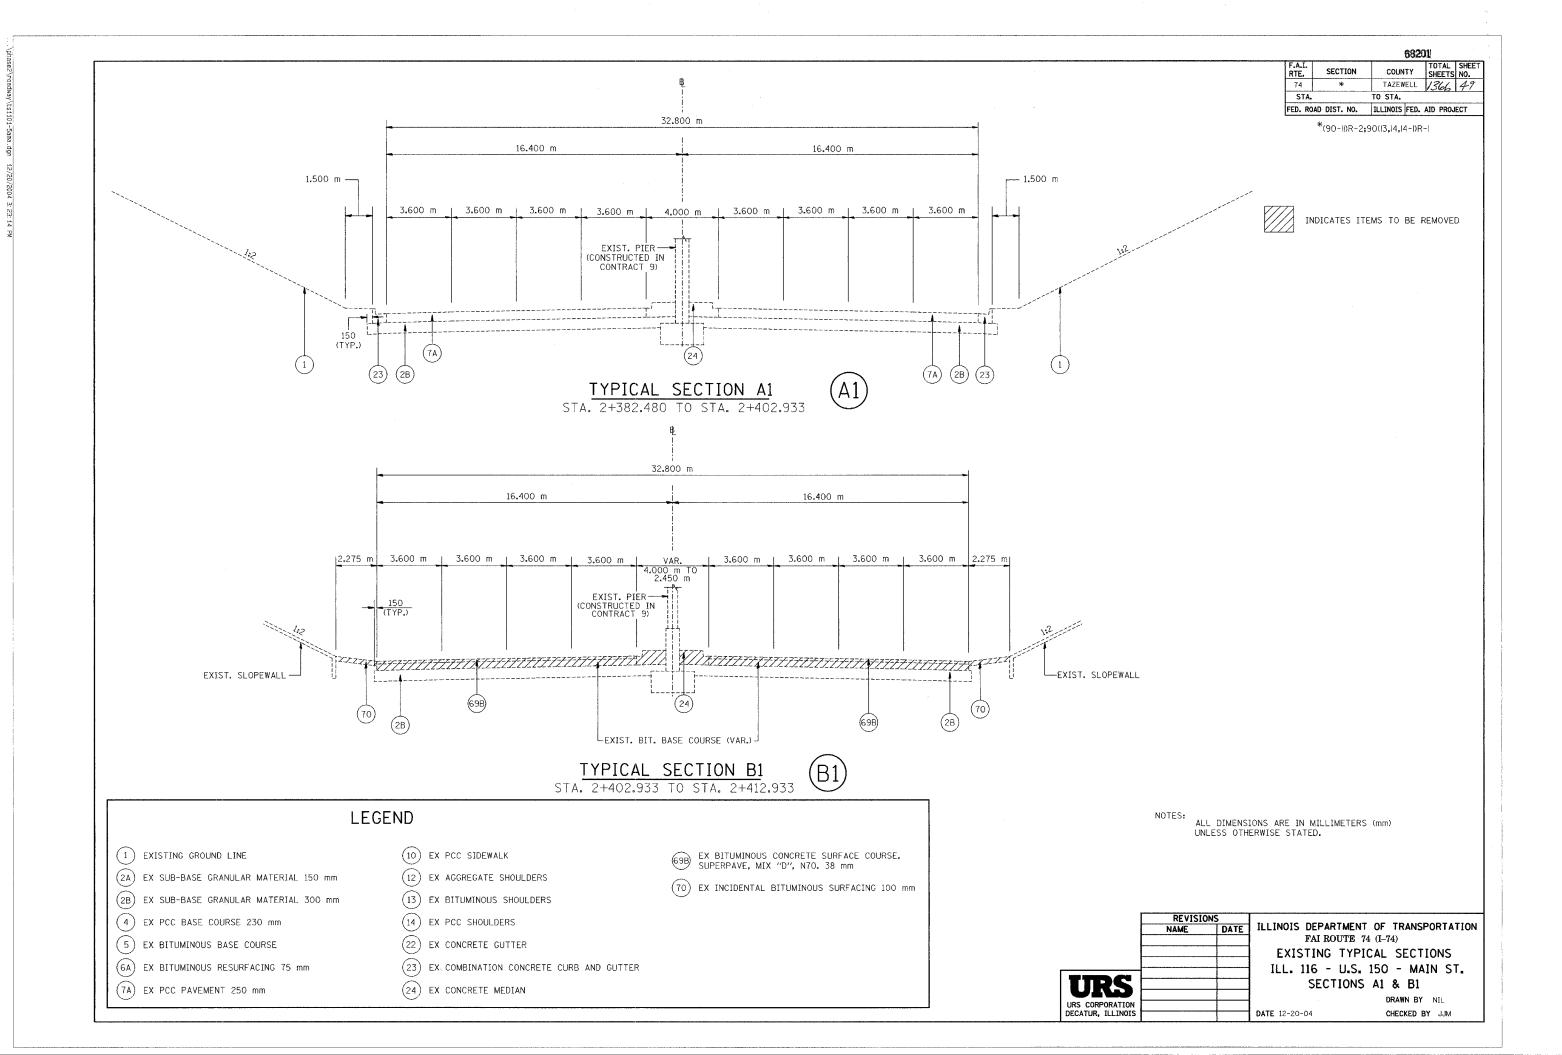

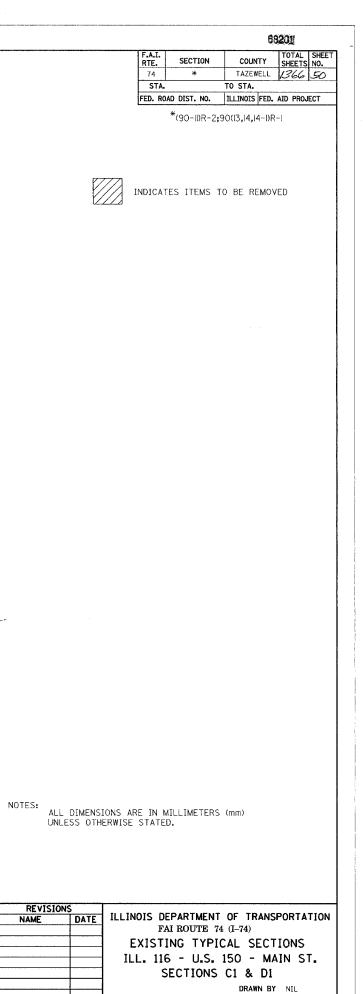



**DATE** 12-20-04

CHECKED BY JJM

**URS** 

URS CORPORATION

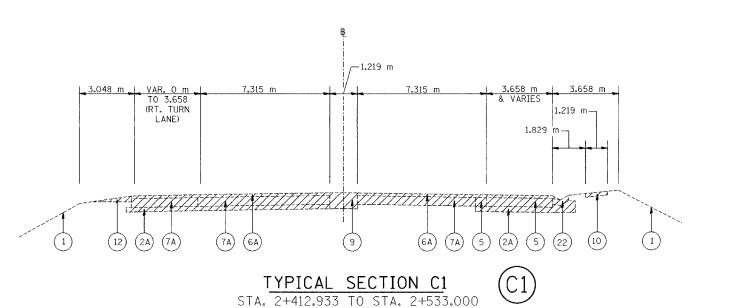

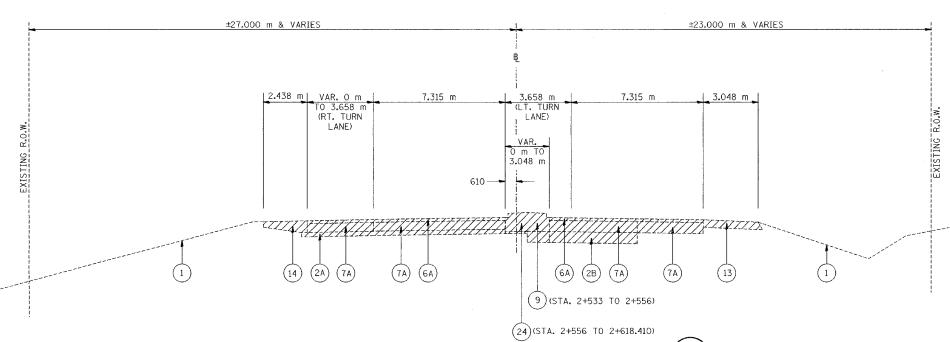

TYPICAL SECTION D1 STA. 2+533.000 TO STA. 2+618.410

LEGEND

(1) EXISTING GROUND LINE

(2A) EX SUB-BASE GRANULAR MATERIAL 150 mm

(2B) EX SUB-BASE GRANULAR MATERIAL 300 mm

(4) EX PCC BASE COURSE 230 mm

(5) EX BITUMINOUS BASE COURSE

(6A) EX BITUMINOUS RESURFACING 75 mm

(7A) EX PCC PAVEMENT 250 mm

(9) EX TEMPORARY PAVEMENT

(10) EX PCC SIDEWALK

(12) EX AGGREGATE SHOULDERS

(13) EX BITUMINOUS SHOULDERS


(14) EX PCC SHOULDERS

(22) EX CONCRETE GUTTER

(23) EX COMBINATION CONCRETE CURB AND GUTTER

(24) EX CONCRETE MEDIAN


TOTAL SHEET SHEETS NO. F.A.I. RTE. SECTION COUNTY TAZEWELL 74 STA. TO STA. FED. ROAD DIST. NO. ILLINOIS FED. AID PROJECT ±27.000 m & VARIES ±23.000 m & VARIES \*(90-11)R-2;90(13,14,14-1)R-1 2.438 m | VAR. 3.658 m | 3.658 m 7.315 m TO 0 m (RT. TURN LANE) LANE) INDICATES ITEMS TO BE REMOVED 610 ---(14) (2A) (7A) (6A) (2B) (7A) TYPICAL SECTION E1 STA. 2+618.410 TO STA. 2+667.000 ±18.000 m & VARIES ±24.000 m & VARIES - 3.048 m ( STA. 2+667± TO 2+771±) 2.438 m (STA. 2+771± TO 2+800) 1.219 m-VAR. 0 m TO 3,658 m 3.658 m (RT.TURN LANE) LANE) 610 ---(6A) (7A) (2B) TYPICAL SECTION F1 STA. 2+667.000 TO STA. 2+800.000 LEGEND ALL DIMENSIONS ARE IN MILLIMETERS (mm) UNLESS OTHERWISE STATED. (1) EXISTING GROUND LINE (10) EX PCC SIDEWALK (2A) EX SUB-BASE GRANULAR MATERIAL 150 mm (12) EX AGGREGATE SHOULDERS (2B) EX SUB-BASE GRANULAR MATERIAL 300 mm (13) EX BITUMINOUS SHOULDERS REVISIONS NAME (4) EX PCC BASE COURSE 230 mm (14) EX PCC SHOULDERS ILLINOIS DEPARTMENT OF TRANSPORTATION FAI ROUTE 74 (I-74) (5) EX BITUMINOUS BASE COURSE (22) EX CONCRETE GUTTER EXISTING TYPICAL SECTIONS (6A) EX BITUMINOUS RESURFACING 75 mm (23) EX COMBINATION CONCRETE CURB AND GUTTER ILL. 116 - U.S. 150 - MAIN ST. SECTIONS E1 & F1 (7A) EX PCC PAVEMENT 250 mm (24) EX CONCRETE MEDIAN DRAWN BY NIL URS CORPORATION DECATUR, ILLINOIS DATE 12-20-04 CHECKED BY JJM

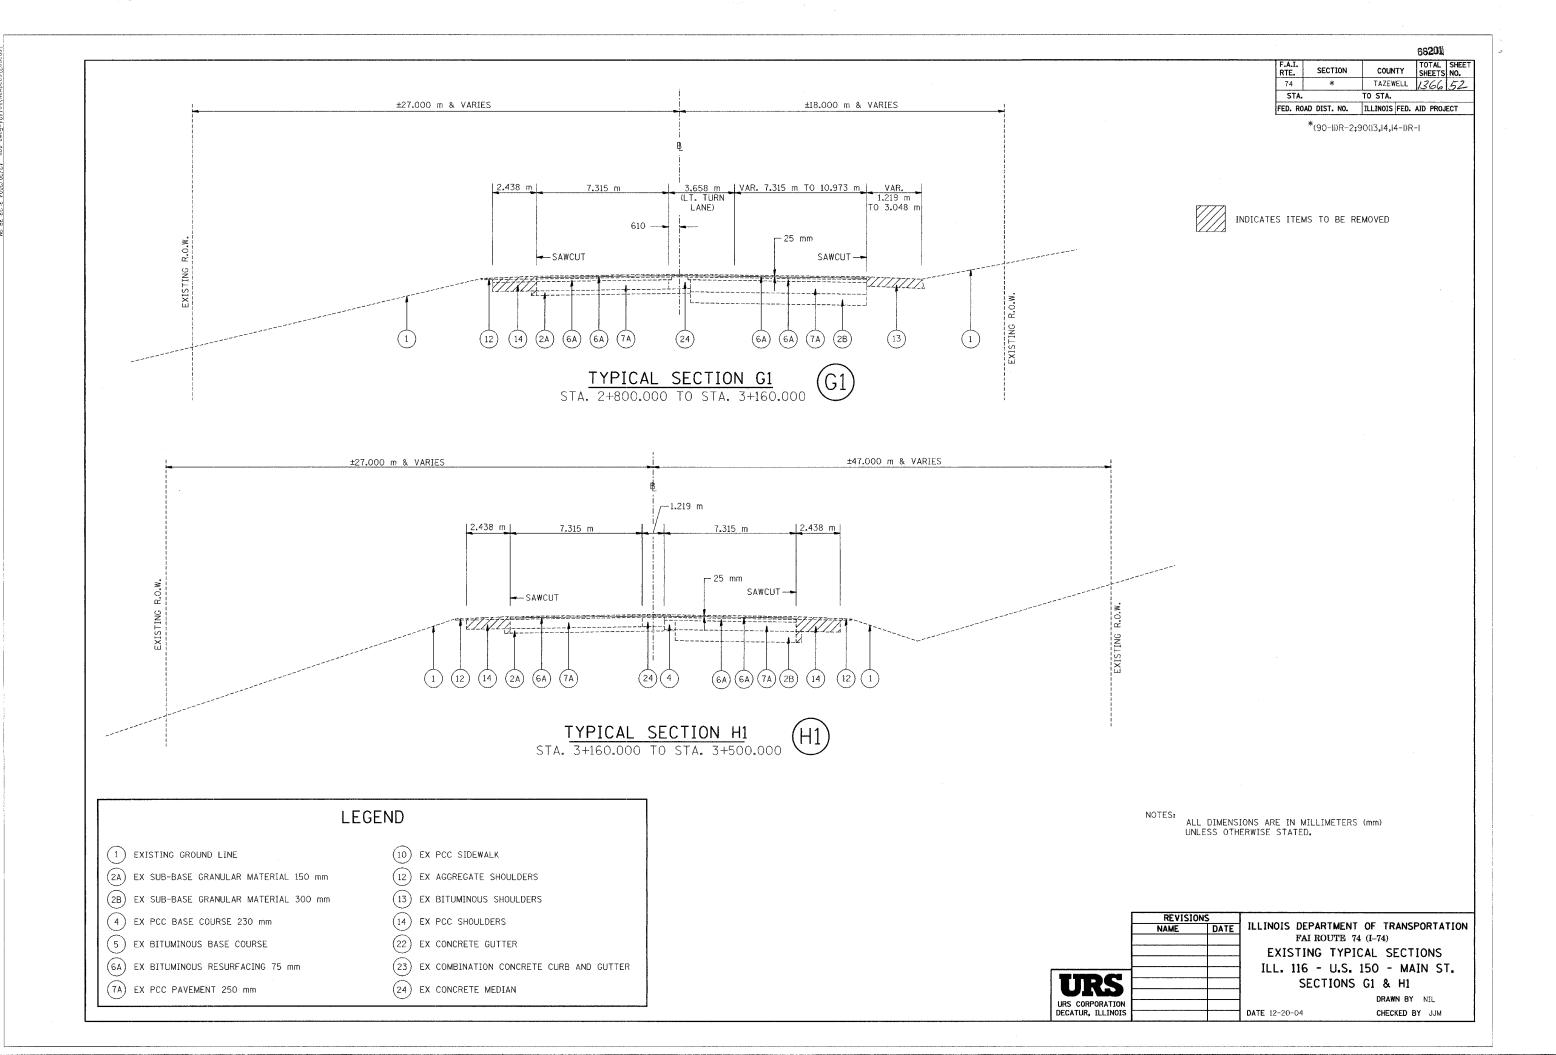


68201 COUNTY SHEETS NO.
TAZEWELL 1366 53 F.A.I. RTE. SECTION 74 STA. TO STA. FED. ROAD DIST. NO. ILLINOIS FED. AID PROJECT

\*(90-11)R-2;90(13,14,14-1)R-1

INDICATES ITEMS TO BE REMOVED

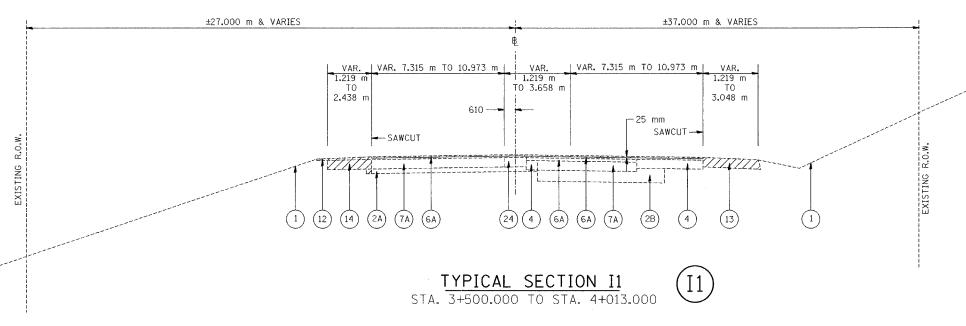

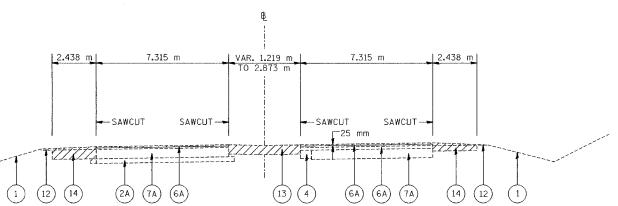

TYPICAL SECTION J1 STA. 4+013.000 TO STA. 4+157.000

LEGEND

- (1) EXISTING GROUND LINE
- (2A) EX SUB-BASE GRANULAR MATERIAL 150 mm
- (2B) EX SUB-BASE GRANULAR MATERIAL 300 mm
- (4) EX PCC BASE COURSE 230 mm
- (5) EX BITUMINOUS BASE COURSE
- (6A) EX BITUMINOUS RESURFACING 75 mm
- (7A) EX PCC PAVEMENT 250 mm

- (10) EX PCC SIDEWALK
- (12) EX AGGREGATE SHOULDERS
- (13) EX BITUMINOUS SHOULDERS
- (14) EX PCC SHOULDERS
- (22) EX CONCRETE GUTTER
- (23) EX COMBINATION CONCRETE CURB AND GUTTER
- (24) EX CONCRETE MEDIAN

ALL DIMENSIONS ARE IN MILLIMETERS (mm) UNLESS OTHERWISE STATED.

	NAME	DATE	11
	1		
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URS CORPORATION			
DECATUR THINDIS	<u> </u>		DAT

REVISIONS

ILLINOIS DEPARTMENT OF TRANSPORTATION FAI ROUTE 74 (I-74) EXISTING TYPICAL SECTIONS ILL. 116 - U.S. 150 - MAIN ST. SECTIONS II & J1

DRAWN BY MLS

DATE 12-20-04


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F.A.I. RTE.	SECTION	COUN	ITY		TAL	SHEET NO.
74	*	TAZEW	/ELL	13	366	54
STA.		TO STA.				
FED. ROA	D DIST. NO.	ILLINOIS	FED.	AID	PROJ	ECT

\*(90-11)R-2;90(13,14,14-1)R-1



INDICATES ITEMS TO BE REMOVED

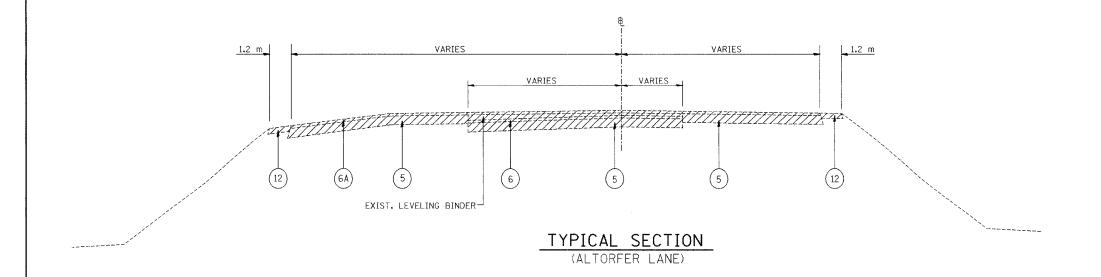

LEGEND

- (1) EXISTING GROUND LINE
- (2A) EX SUB-BASE GRANULAR MATERIAL 150 mm
- (2B) EX SUB-BASE GRANULAR MATERIAL 300 mm
- (4) EX PCC BASE COURSE 230 mm
- (5) EX BITUMINOUS BASE COURSE
- (6) EX BITUMINOUS RESURFACING
- (6A) EX BITUMINOUS RESURFACING 75 mm

- (7A) EX PCC PAVEMENT 250 mm
- (10) EX PCC SIDEWALK
- (12) EX AGGREGATE SHOULDERS
- (13) EX BITUMINOUS SHOULDERS
- (14) EX PCC SHOULDERS
- (22) EX CONCRETE GUTTER
- (23) EX COMBINATION CONCRETE CURB AND GUTTER

REVISIONS NAME


NOTES:
ALL DIMENSIONS ARE IN MILLIMETERS (mm)
UNLESS OTHERWISE STATED.




ILLINOIS DEPARTMENT OF TRANSPORTATION FAI ROUTE 74 (I-74) EXISTING TYPICAL SECTIONS ILL. 116 - U.S. 150 - MAIN ST. ALTORFER LANE


DATE 12-20-04

CHECKED BY JJM

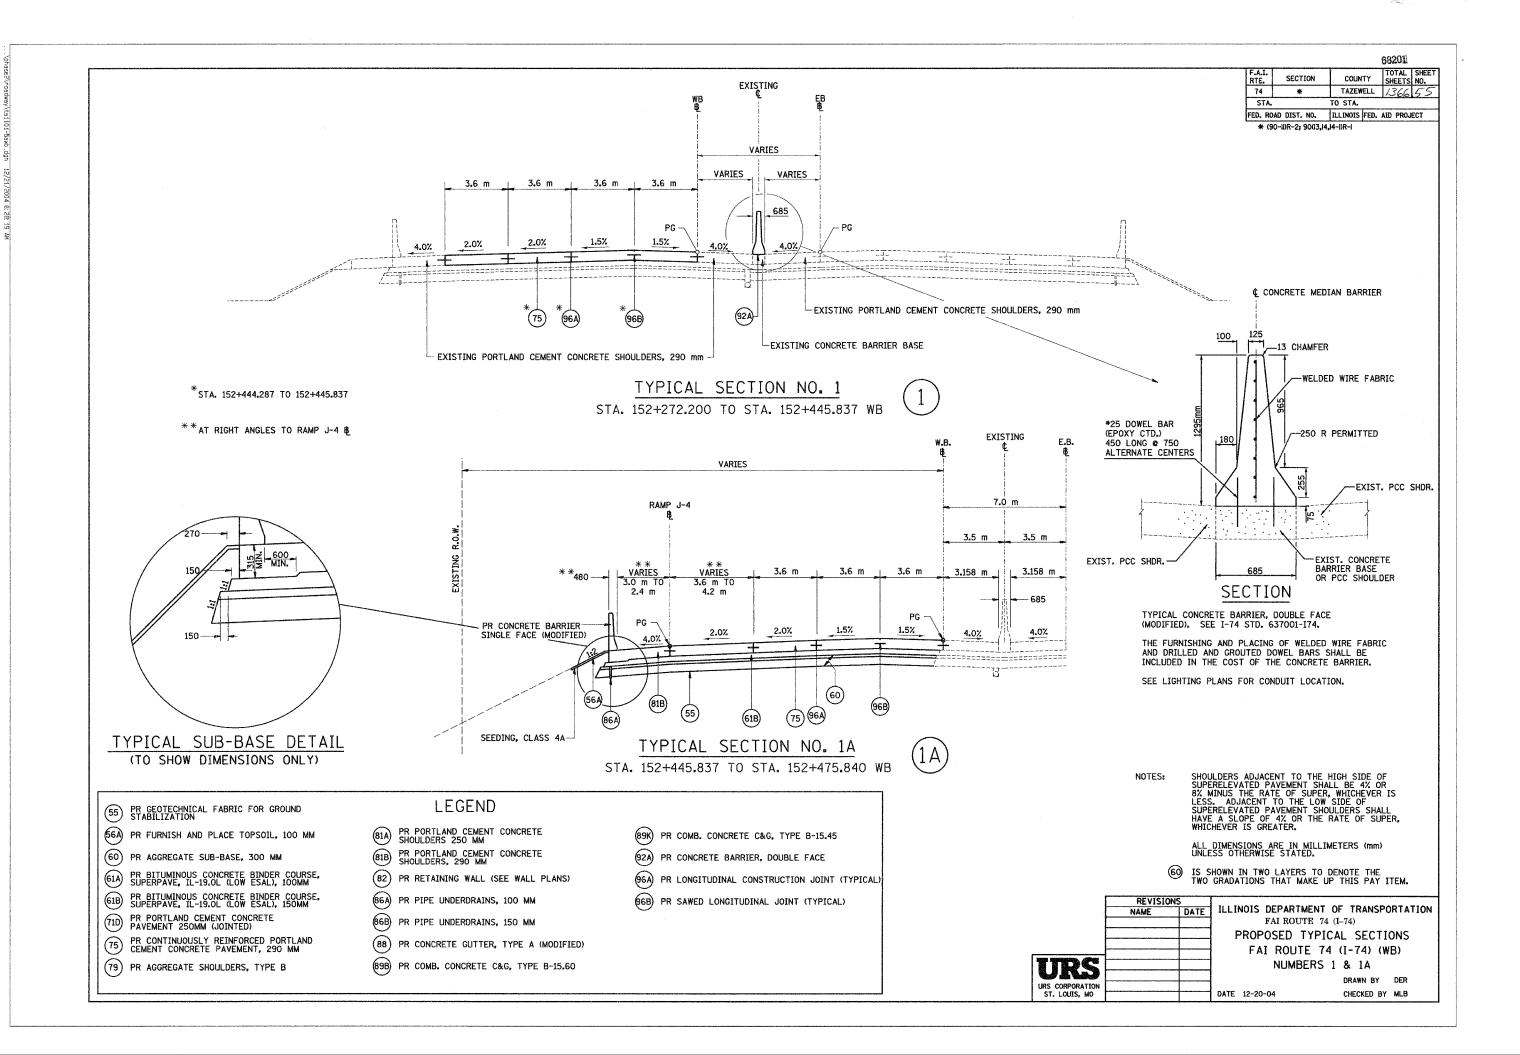

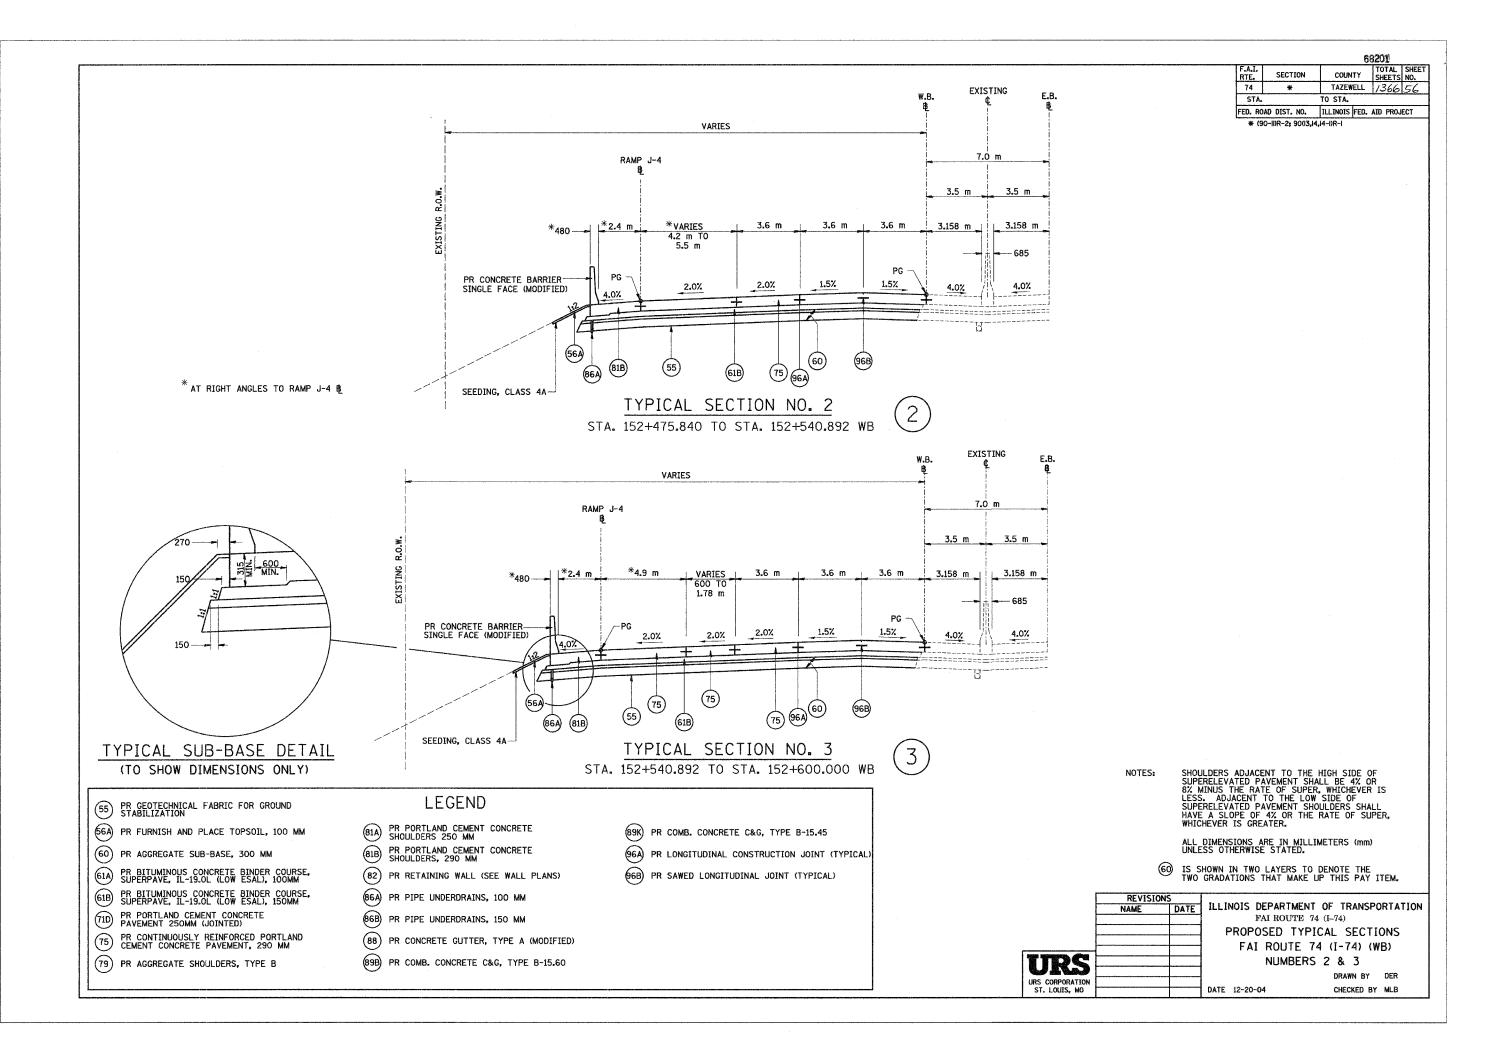

\* (90-li)R-2; 90(13,14,14-1)R-1

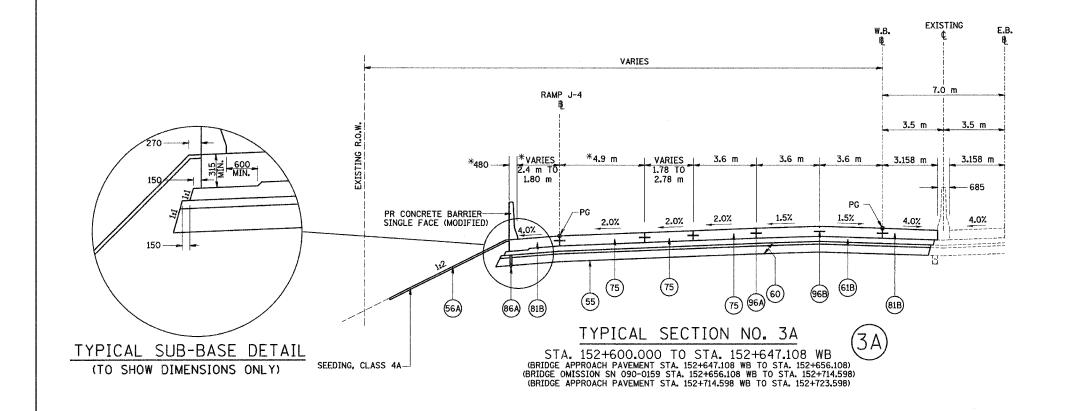

\* AT RIGHT ANGLES TO RAMP J-4 BL

PR GEOTECHNICAL FABRIC FOR GROUND STABILIZATION

(56A) PR FURNISH AND PLACE TOPSOIL, 100 MM

60) PR AGGREGATE SUB-BASE, 300 MM

PR BITUMINOUS CONCRETE BINDER COURSE, SUPERPAVE, IL-19.0L (LOW ESAL), 100MM

61B) PR BITUMINOUS CONCRETE BINDER COURSE, SUPERPAVE, IL-19.0L (LOW ESAL), 150MM

PR PORTLAND CEMENT CONCRETE PAVEMENT 250MM (JOINTED)

75 PR CONTINUOUSLY REINFORCED PORTLAND CEMENT CONCRETE PAVEMENT, 290 MM

(79) PR AGGREGATE SHOULDERS, TYPE B

LEGEND

PR PORTLAND CEMENT CONCRETE SHOULDERS 250 MM

81B) PR PORTLAND CEMENT CONCRETE SHOULDERS, 290 MM

82) PR RETAINING WALL (SEE WALL PLANS)

86A) PR PIPE UNDERDRAINS, 100 MM

86B) PR PIPE UNDERDRAINS, 150 MM

(88) PR CONCRETE GUTTER, TYPE A (MODIFIED)
(89B) PR COMB. CONCRETE C&G, TYPE B-15.60

(89K) PR COMB. CONCRETE C&G, TYPE B-15.45

96A) PR LONGITUDINAL CONSTRUCTION JOINT (TYPICAL)

(96B) PR SAWED LONGITUDINAL JOINT (TYPICAL)

NOTES:

SHOULDERS ADJACENT TO THE HIGH SIDE OF SUPERELEVATED PAVEMENT SHALL BE 4% OR 8% MINUS THE RATE OF SUPER, WHICHEVER IS LESS. ADJACENT TO THE LOW SIDE OF SUPERELEVATED PAVEMENT SHOULDERS SHALL HAVE A SLOPE OF 4% OR THE RATE OF SUPER, WHICHEVER IS GREATER.

ALL DIMENSIONS ARE IN MILLIMETERS (mm) UNLESS OTHERWISE STATED.

60 IS SHOWN IN TWO LAYERS TO DENOTE THE TWO GRADATIONS THAT MAKE UP THIS PAY ITEM.


TIDE	
UILD	
URS CORPORATION	
ST. LOUIS, MO	


> PROPOSED TYPICAL SECTIONS FAI ROUTE 74 (I-74) (WB) NUMBERS 3A

DRAWN BY DER


DATE 12-20-04


CHECKED BY MLB

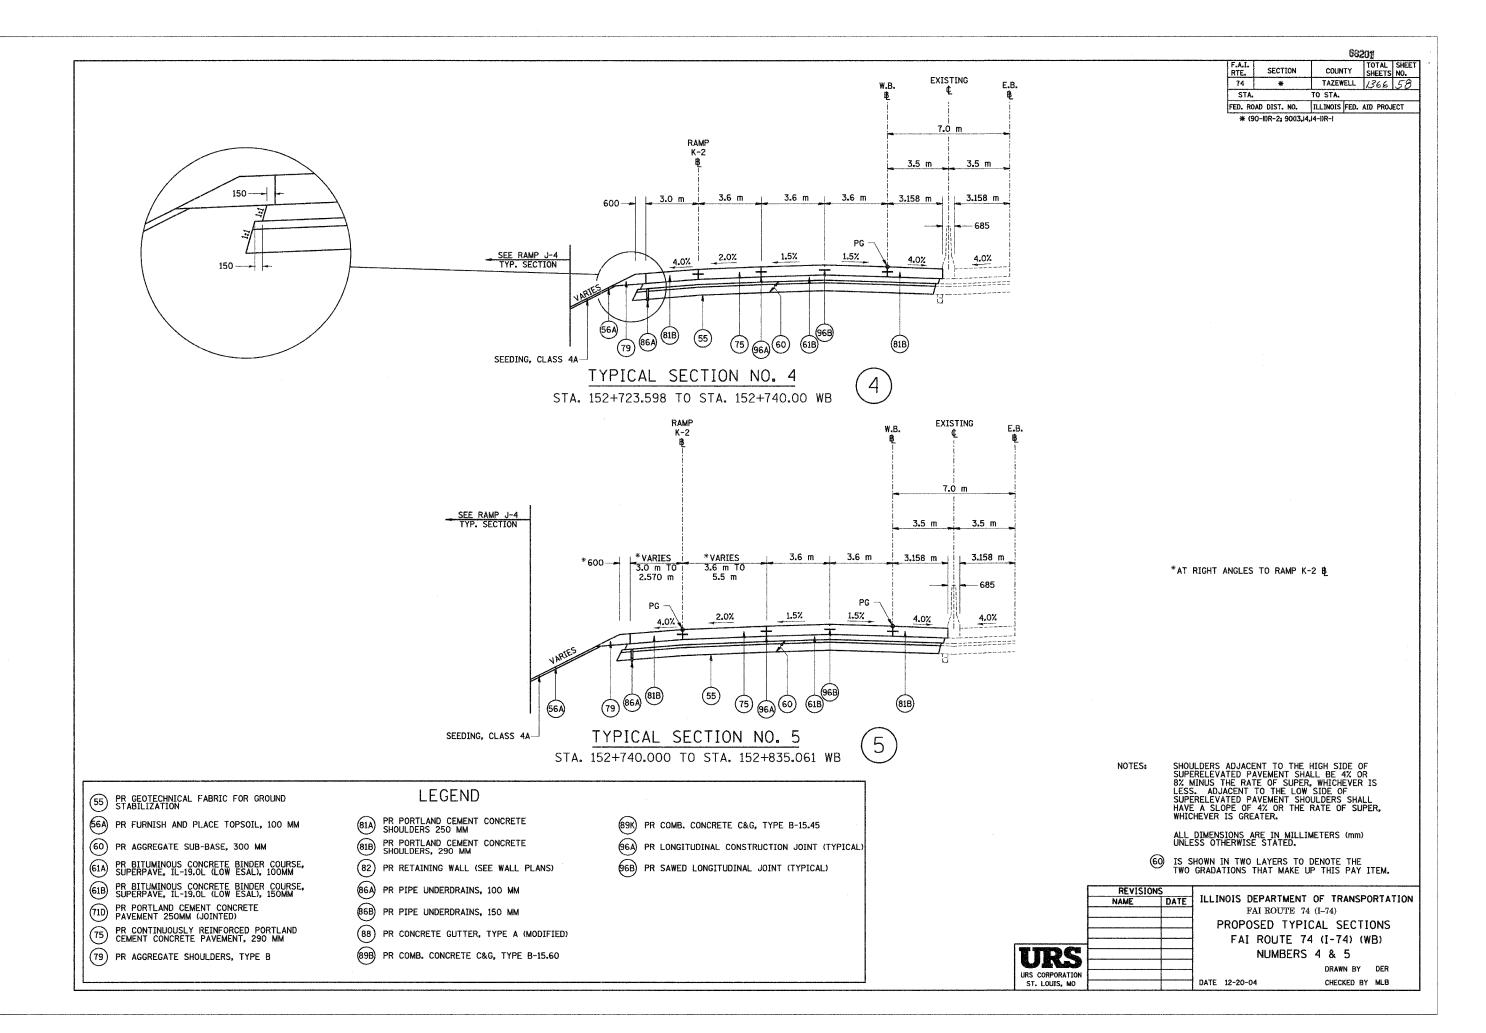

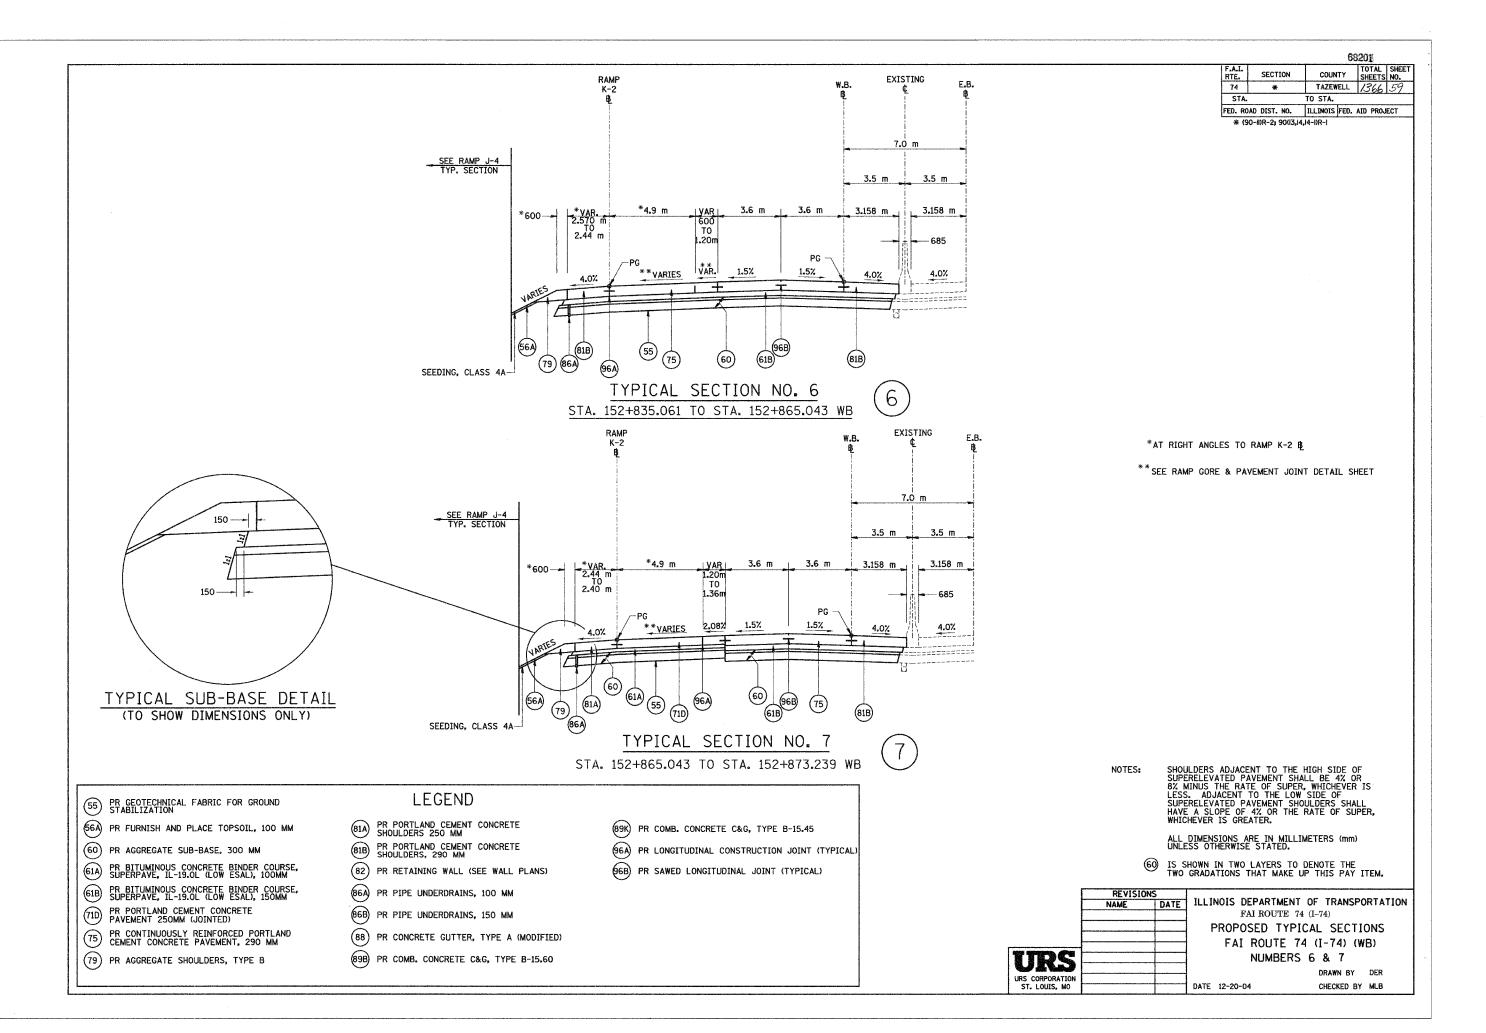



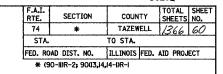

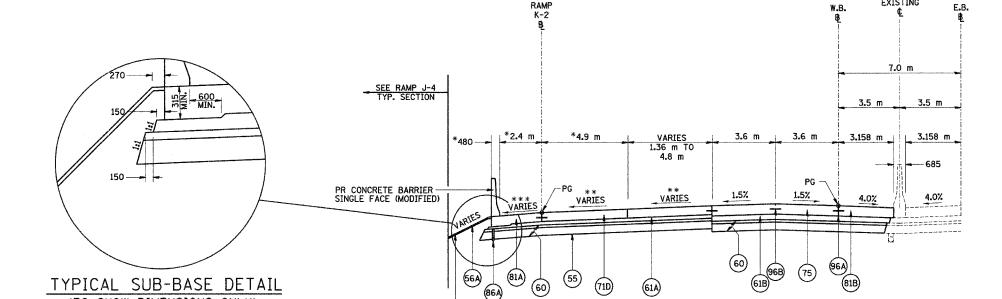

SEEDING, CLASS 4A-


TYPICAL SECTION NO. 8 STA. 152+873.239 TO STA. 152+969.330 WB

\*\*\* STA. 152+873.239 TO STA. 152+925.061 - SLOPE = 4.0% STA. 152+925.061 TO STA. 152+969.330 - SLOPE VARIES FROM 4.0% TO 4.85%

8

\*AT RIGHT ANGLES TO RAMP K-2 B

\*\* SEE RAMP GORE & PAVEMENT JOINT DETAIL SHEET

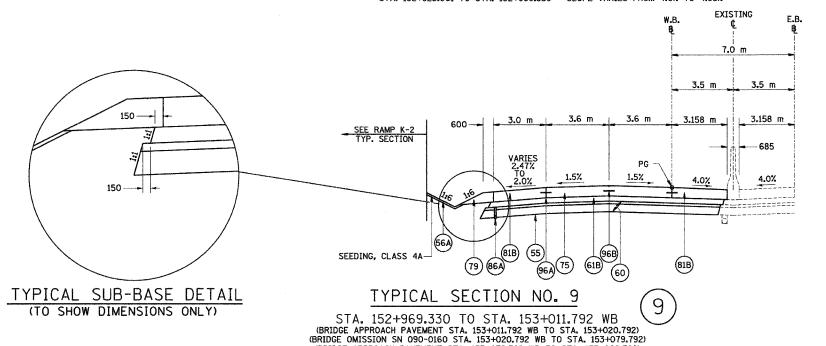

60)

PR GEOTECHNICAL FABRIC FOR GROUND STABILIZATION

TYPICAL SUB-BASE DETAIL

(TO SHOW DIMENSIONS ONLY)

(56A) PR FURNISH AND PLACE TOPSOIL, 100 MM

(60) PR AGGREGATE SUB-BASE, 300 MM

- PR BITUMINOUS CONCRETE BINDER COURSE, SUPERPAVE, IL-19.0L (LOW ESAL), 100MM
- 61B PR BITUMINOUS CONCRETE BINDER COURSE, SUPERPAVE, IL-19.0L (LOW ESAL), 150MM
- PR PORTLAND CEMENT CONCRETE PAVEMENT 250MM (JOINTED)
- 75) PR CONTINUOUSLY REINFORCED PORTLAND CEMENT CONCRETE PAVEMENT, 290 MM
- (79) PR AGGREGATE SHOULDERS, TYPE B

LEGEND

- PR PORTLAND CEMENT CONCRETE SHOULDERS 250 MM
- PR PORTLAND CEMENT CONCRETE SHOULDERS, 290 MM
- (82) PR RETAINING WALL (SEE WALL PLANS)
- 86A) PR PIPE UNDERDRAINS, 100 MM
- PR PIPE UNDERDRAINS, 150 MM
- (88) PR CONCRETE GUTTER, TYPE A (MODIFIED)
- (89B) PR COMB. CONCRETE C&G, TYPE B-15.60

PR COMB. CONCRETE C&G, TYPE B-15.45

(BRIDGE APPROACH PAVEMENT STA. 153+079.792 WB TO STA. 153+088.792)

- PR LONGITUDINAL CONSTRUCTION JOINT (TYPICAL)
- PR SAWED LONGITUDINAL JOINT (TYPICAL)

NOTES:

SHOULDERS ADJACENT TO THE HIGH SIDE OF SUPERELEVATED PAVEMENT SHALL BE 4% OR 8% MINUS THE RATE OF SUPER, WHICHEVER IS LESS. ADJACENT TO THE LOW SIDE OF SUPERELEVATED PAVEMENT SHOULDERS SHALL HAVE A SLOPE OF 4% OR THE RATE OF SUPER, WHICHEVER IS GREATER.

ALL DIMENSIONS ARE IN MILLIMETERS (mm) UNLESS OTHERWISE STATED.

(60) IS SHOWN IN TWO LAYERS TO DENOTE THE TWO GRADATIONS THAT MAKE UP THIS PAY ITEM.

TIDE	
UND	
URS CORPORATION	
ST. LOUIS, MO	


REVISIONS
NAME | DATE | ILLINOIS DEPARTMENT OF TRANSPORTATION FAI ROUTE 74 (I-74)

> PROPOSED TYPICAL SECTIONS FAI ROUTE 74 (I-74) (WB) NUMBERS 8 & 9


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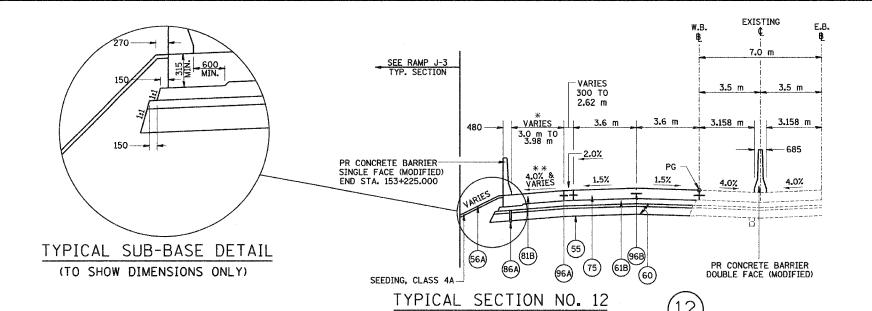
DATE 12-20-04


CHECKED BY MLB



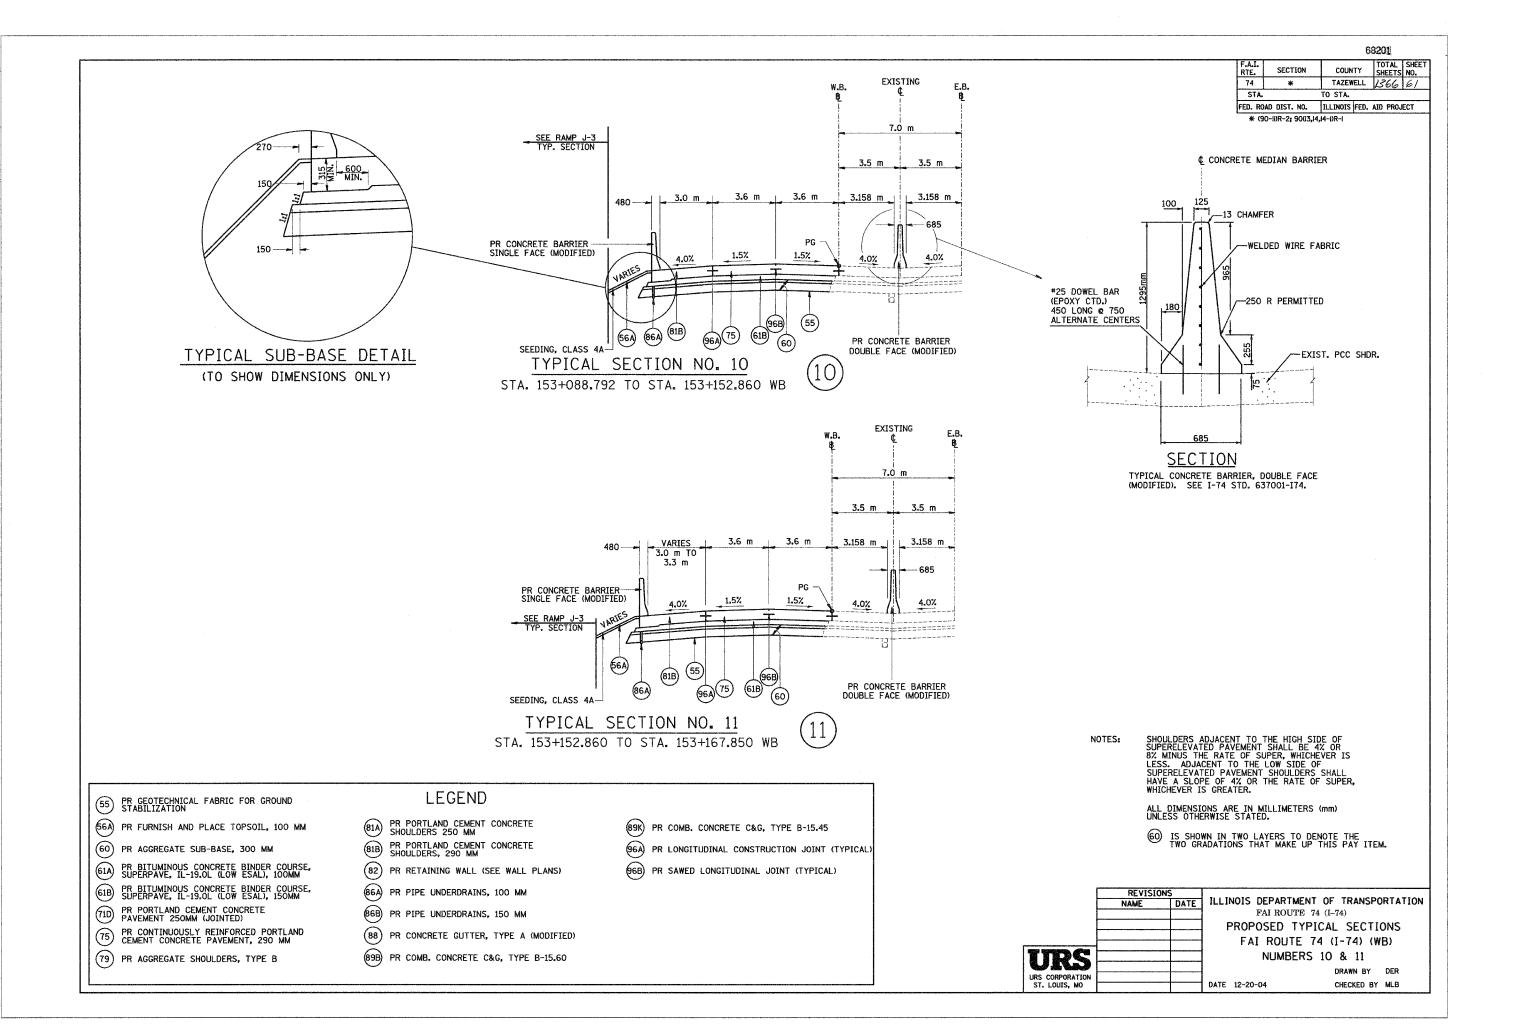



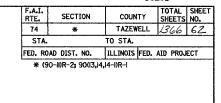

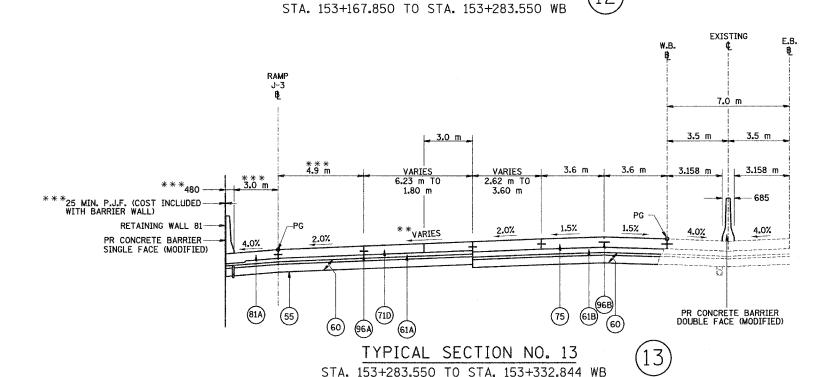

\* SEE IMPACT ATTENUATOR DETAIL SHEET

\*\* SEE RAMP GORE & PAVEMENT JOINT DETAIL SHEET

 $^{*\,*\,*}$  AT RIGHT ANGLES TO RAMP J-3 BL

NOTES:

SHOULDERS ADJACENT TO THE HIGH SIDE OF SUPERELEVATED PAVEMENT SHALL BE 4% OR 8% MINUS THE RATE OF SUPER, WHICHEVER IS LESS. ADJACENT TO THE LOW SIDE OF SUPERELEVATED PAVEMENT SHOULDERS SHALL HAVE A SLOPE OF 4% OR THE RATE OF SUPER, WHICHEVER IS GREATER.

ALL DIMENSIONS ARE IN MILLIMETERS (mm) UNLESS OTHERWISE STATED.

(60) IS SHOWN IN TWO LAYERS TO DENOTE THE TWO GRADATIONS THAT MAKE UP THIS PAY ITEM.

REVISIONS
NAME DATE

URS

URS CORPORATION
ST. LOUIS, MO

ILLINOIS DEPARTMENT OF TRANSPORTATION
FAI ROUTE 74 (I-74)
PROPOSED TYPICAL SECTIONS
FAI ROUTE 74 (I-74) (WB)
NUMBERS 12 & 13

DRAWN BY DER

DATE 12-20-04

CHECKED BY MLB

PR GEOTECHNICAL FABRIC FOR GROUND STABILIZATION

(56A) PR FURNISH AND PLACE TOPSOIL, 100 MM

(60) PR AGGREGATE SUB-BASE, 300 MM

61A) PR BITUMINOUS CONCRETE BINDER COURSE, SUPERPAVE, IL-19.0L (LOW ESAL), 100MM

61B PR BITUMINOUS CONCRETE BINDER COURSE, SUPERPAVE, IL-19.0L (LOW ESAL), 150MM

71D PR PORTLAND CEMENT CONCRETE PAVEMENT 250MM (JOINTED)

75) PR CONTINUOUSLY REINFORCED PORTLAND CEMENT CONCRETE PAVEMENT, 290 MM

(79) PR AGGREGATE SHOULDERS, TYPE B

LEGEND

PR PORTLAND CEMENT CONCRETE SHOULDERS 250 MM

81B) PR PORTLAND CEMENT CONCRETE SHOULDERS, 290 MM

82) PR RETAINING WALL (SEE WALL PLANS)


86A) PR PIPE UNDERDRAINS, 100 MM


(86B) PR PIPE UNDERDRAINS, 150 MM


(88) PR CONCRETE GUTTER, TYPE A (MODIFIED) (89B) PR COMB. CONCRETE C&G, TYPE B-15.60 (89K) PR COMB. CONCRETE C&G, TYPE B-15.45

(96A) PR LONGITUDINAL CONSTRUCTION JOINT (TYPICAL)

(96B) PR SAWED LONGITUDINAL JOINT (TYPICAL)

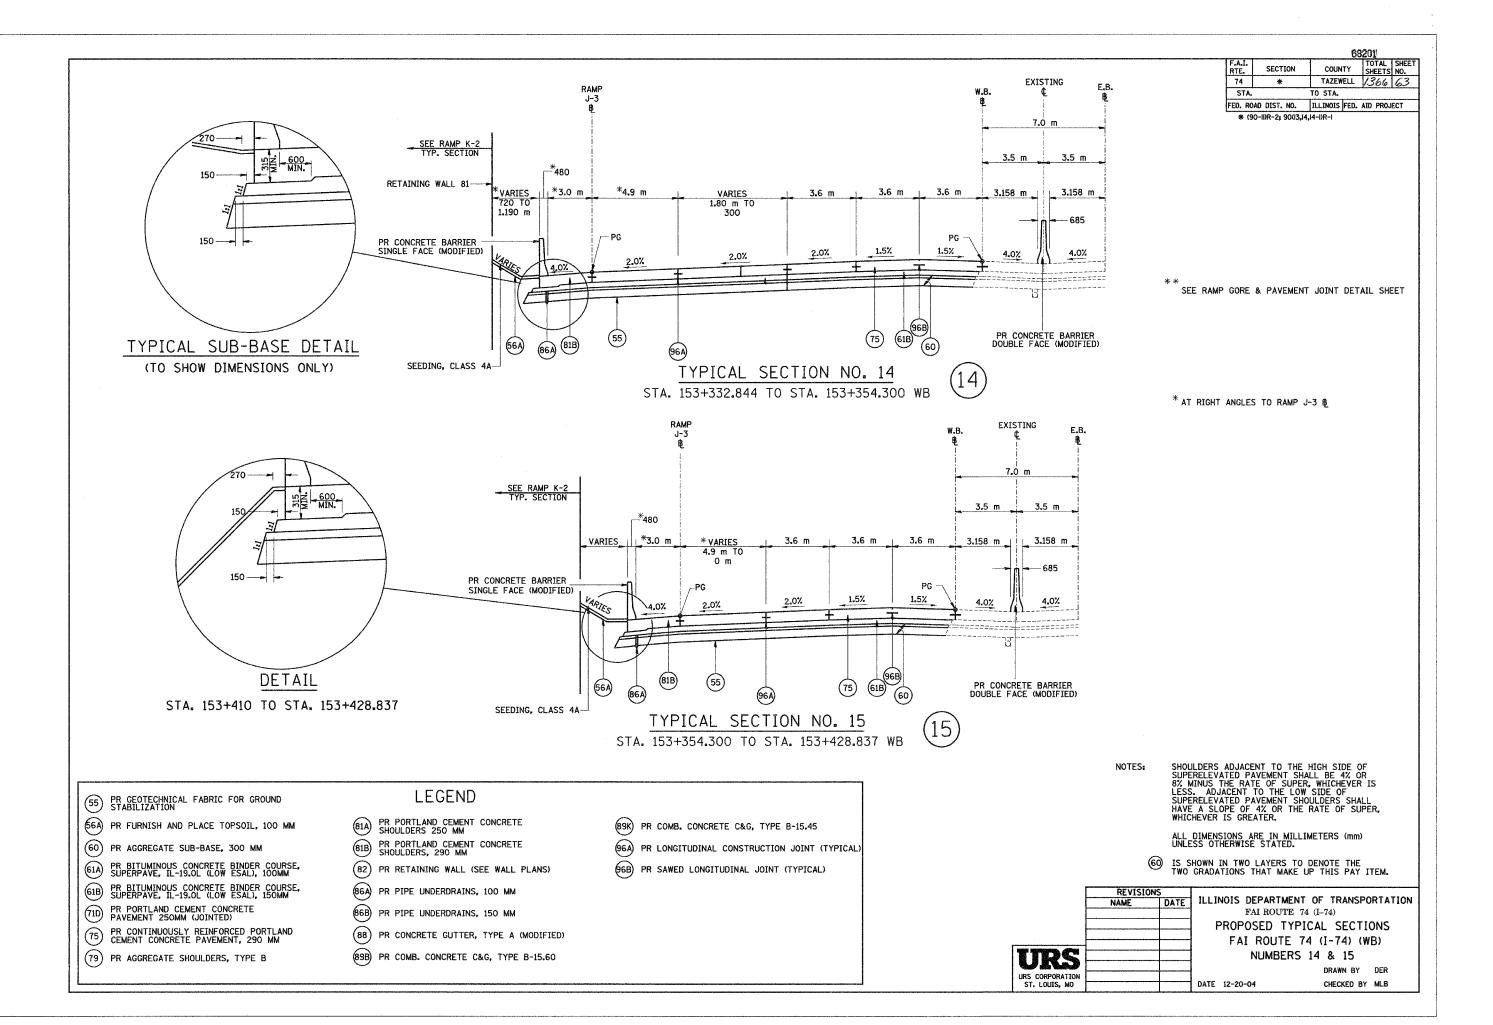

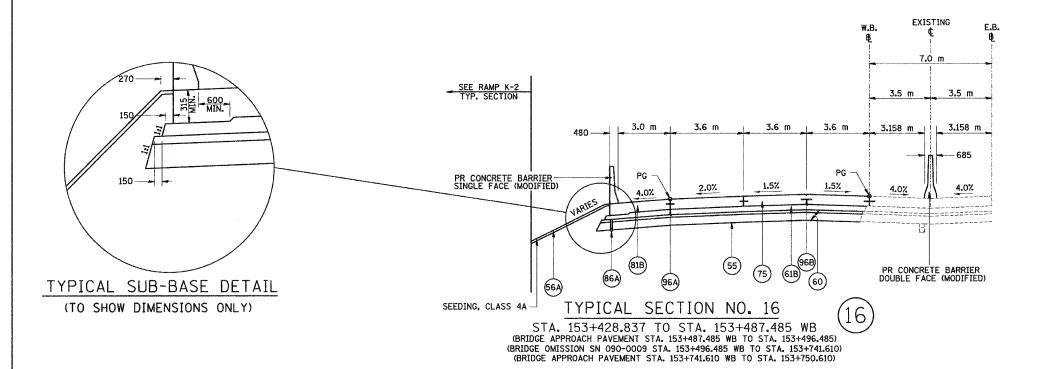

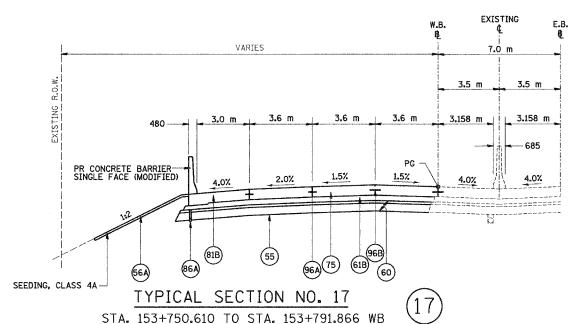

(56A) PR FURNISH AND PLACE TOPSOIL. 100 MM

PR GEOTECHNICAL FABRIC FOR GROUND STABILIZATION

(60) PR AGGREGATE SUB-BASE, 300 MM

61A PR BITUMINOUS CONCRETE BINDER COURSE, SUPERPAVE, IL-19.0L (LOW ESAL), 100MM

61B PR BITUMINOUS CONCRETE BINDER COURSE, SUPERPAVE, IL-19.0L (LOW ESAL), 150MM

PR PORTLAND CEMENT CONCRETE PAVEMENT 250MM (JOINTED)

PR CONTINUOUSLY REINFORCED PORTLAND CEMENT CONCRETE PAVEMENT, 290 MM

(79) PR AGGREGATE SHOULDERS, TYPE B

LEGEND

PR PORTLAND CEMENT CONCRETE SHOULDERS 250 MM

81B) PR PORTLAND CEMENT CONCRETE SHOULDERS, 290 MM

(82) PR RETAINING WALL (SEE WALL PLANS)

86A) PR PIPE UNDERDRAINS, 100 MM

(86B) PR PIPE UNDERDRAINS, 150 MM

(88) PR CONCRETE GUTTER, TYPE A (MODIFIED) (89B) PR COMB. CONCRETE C&G, TYPE B-15.60

(89K) PR COMB. CONCRETE C&G, TYPE B-15.45

(96A) PR LONGITUDINAL CONSTRUCTION JOINT (TYPICAL)

(96B) PR SAWED LONGITUDINAL JOINT (TYPICAL)

NOTES:

REVISIONS NAME DATE

SHOULDERS ADJACENT TO THE HIGH SIDE OF SUPERELEVATED PAVEMENT SHALL BE 4% OR 8% MINUS THE RATE OF SUPER, WHICHEVER IS LESS. ADJACENT TO THE LOW SIDE OF SUPERELEVATED PAVEMENT SHOULDERS SHALL HAVE A SLOPE OF 4% OR THE RATE OF SUPER, WHICHEVER IS GREATER.

ALL DIMENSIONS ARE IN MILLIMETERS (mm) UNLESS OTHERWISE STATED.

60 IS SHOWN IN TWO LAYERS TO DENOTE THE TWO GRADATIONS THAT MAKE UP THIS PAY ITEM.

		. 41.111.75	D
	DC		
	PORATION		
ST. LO	UIS, MO		


ILLINOIS DEPARTMENT OF TRANSPORTATION FAI ROUTE 74 (I-74)

PROPOSED TYPICAL SECTIONS FAI ROUTE 74 (I-74) (WB) NUMBERS 16 & 17

DRAWN BY DER

DATE 12-20-04

CHECKED BY MLB

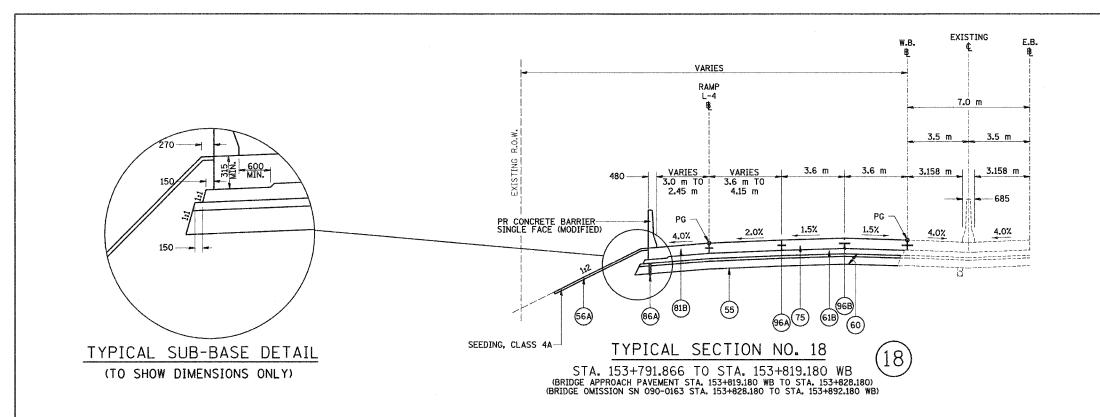

NOTES:

SHOULDERS ADJACENT TO THE HIGH SIDE OF SUPERELEVATED PAVEMENT SHALL BE 4% OR 8% MINUS THE RATE OF SUPER, WHICHEVER IS LESS. ADJACENT TO THE LOW SIDE OF SUPERELEVATED PAVEMENT SHOULDERS SHALL HAVE A SLOPE OF 4% OR THE RATE OF SUPER, WHICHEVER IS GREATER.

ALL DIMENSIONS ARE IN MILLIMETERS (mm) UNLESS OTHERWISE STATED.

60 IS SHOWN IN TWO LAYERS TO DENOTE THE TWO GRADATIONS THAT MAKE UP THIS PAY ITEM.

URS DATE 12-20-04

ILLINOIS DEPARTMENT OF TRANSPORTATION FAI ROUTE 74 (I-74)

PROPOSED TYPICAL SECTIONS FAI ROUTE 74 (I-74) (WB) NUMBER 18

DRAWN BY DER CHECKED BY MLB

COUNTY SHEETS NO.
TAZEWELL 1366 65

TO STA. FED. ROAD DIST. NO. ILLINOIS FED. AID PROJECT

SECTION

\* (90-li)R-2; 90(13,14,14-l)R-l

RTE.

74

STA.

PR GEOTECHNICAL FABRIC FOR GROUND STABILIZATION

56A) PR FURNISH AND PLACE TOPSOIL, 100 MM

(60) PR AGGREGATE SUB-BASE, 300 MM

61A PR BITUMINOUS CONCRETE BINDER COURSE, SUPERPAVE, IL-19.0L (LOW ESAL), 100MM

61B PR BITUMINOUS CONCRETE BINDER COURSE, SUPERPAVE, IL-19.0L (LOW ESAL), 150MM

PR PORTLAND CEMENT CONCRETE PAVEMENT 250MM (JOINTED)

75) PR CONTINUOUSLY REINFORCED PORTLAND CEMENT CONCRETE PAVEMENT, 290 MM

(79) PR AGGREGATE SHOULDERS, TYPE B

LEGEND

PR PORTLAND CEMENT CONCRETE SHOULDERS 250 MM

PR PORTLAND CEMENT CONCRETE SHOULDERS, 290 MM

(82) PR RETAINING WALL (SEE WALL PLANS)

86A) PR PIPE UNDERDRAINS, 100 MM

86B) PR PIPE UNDERDRAINS, 150 MM


(88) PR CONCRETE GUTTER, TYPE A (MODIFIED)


(89B) PR COMB. CONCRETE C&G, TYPE B-15.60


(89K) PR COMB. CONCRETE C&G, TYPE B-15.45


(96A) PR LONGITUDINAL CONSTRUCTION JOINT (TYPICAL)


(96B) PR SAWED LONGITUDINAL JOINT (TYPICAL)

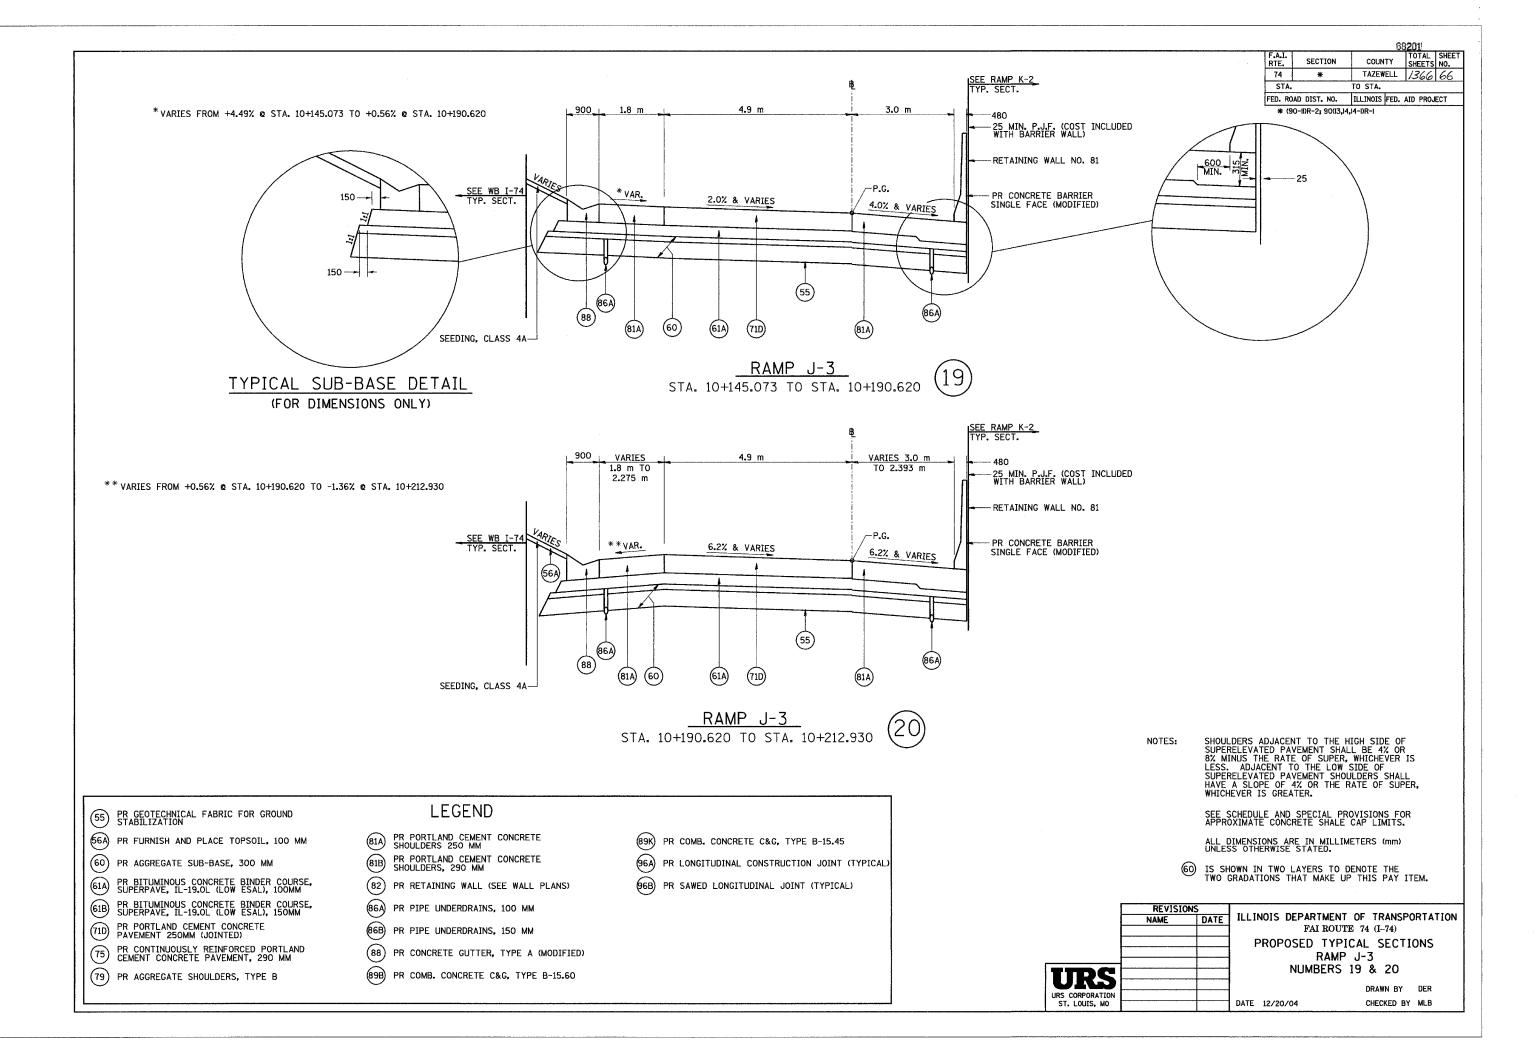


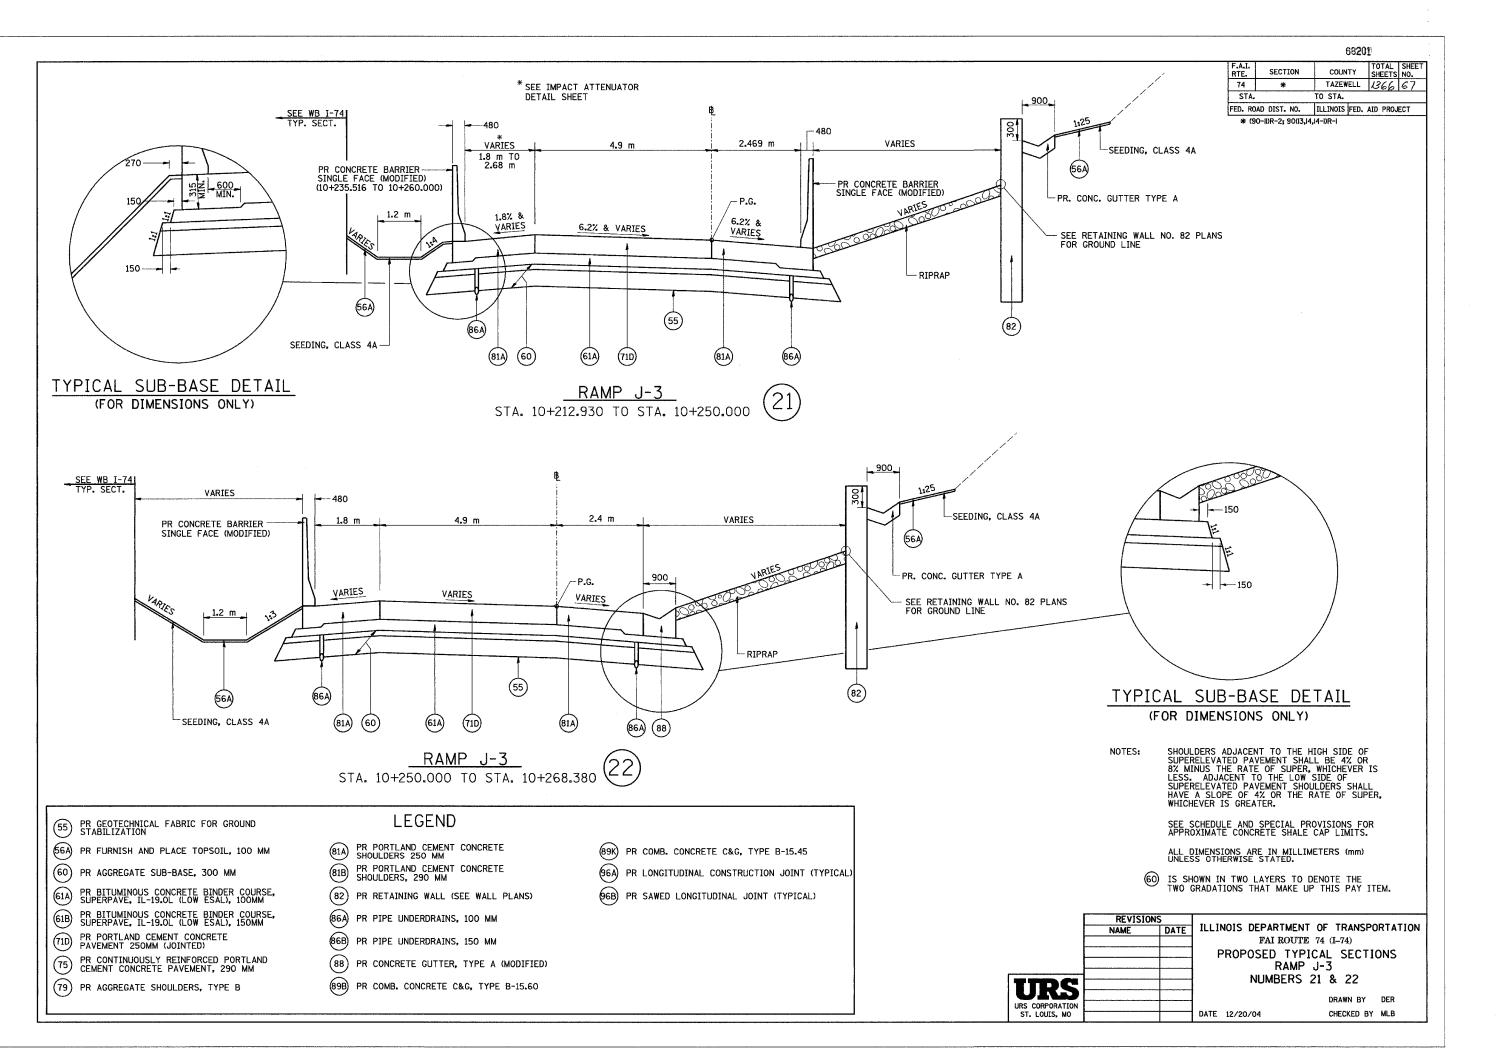


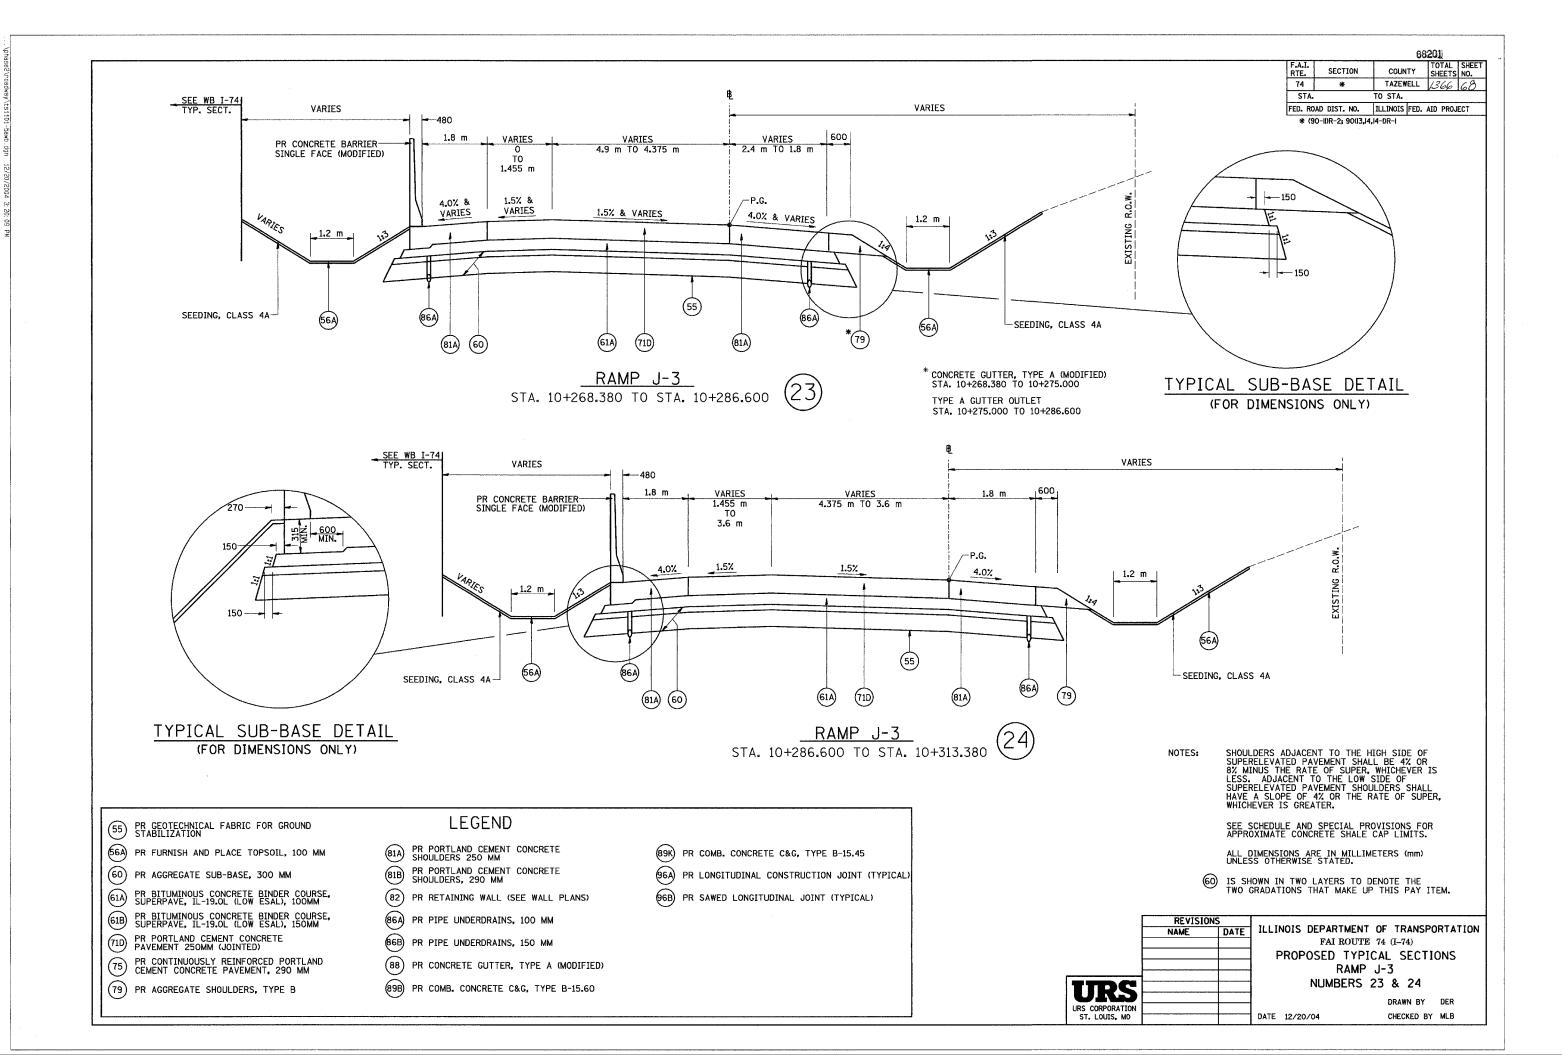


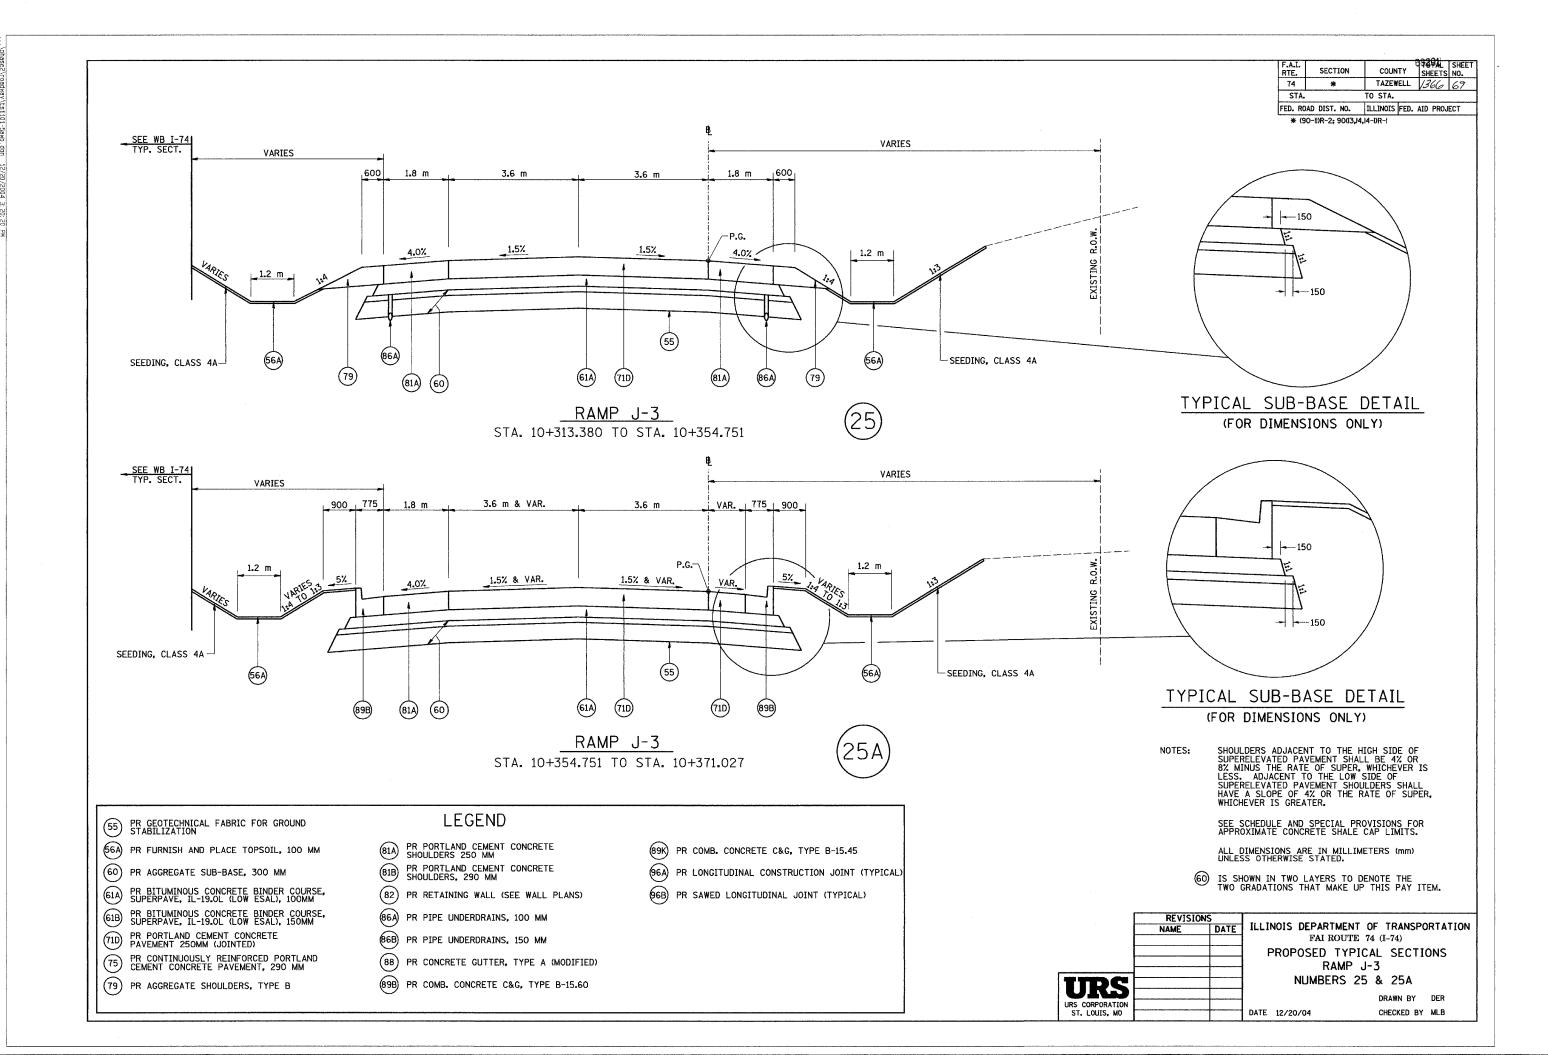


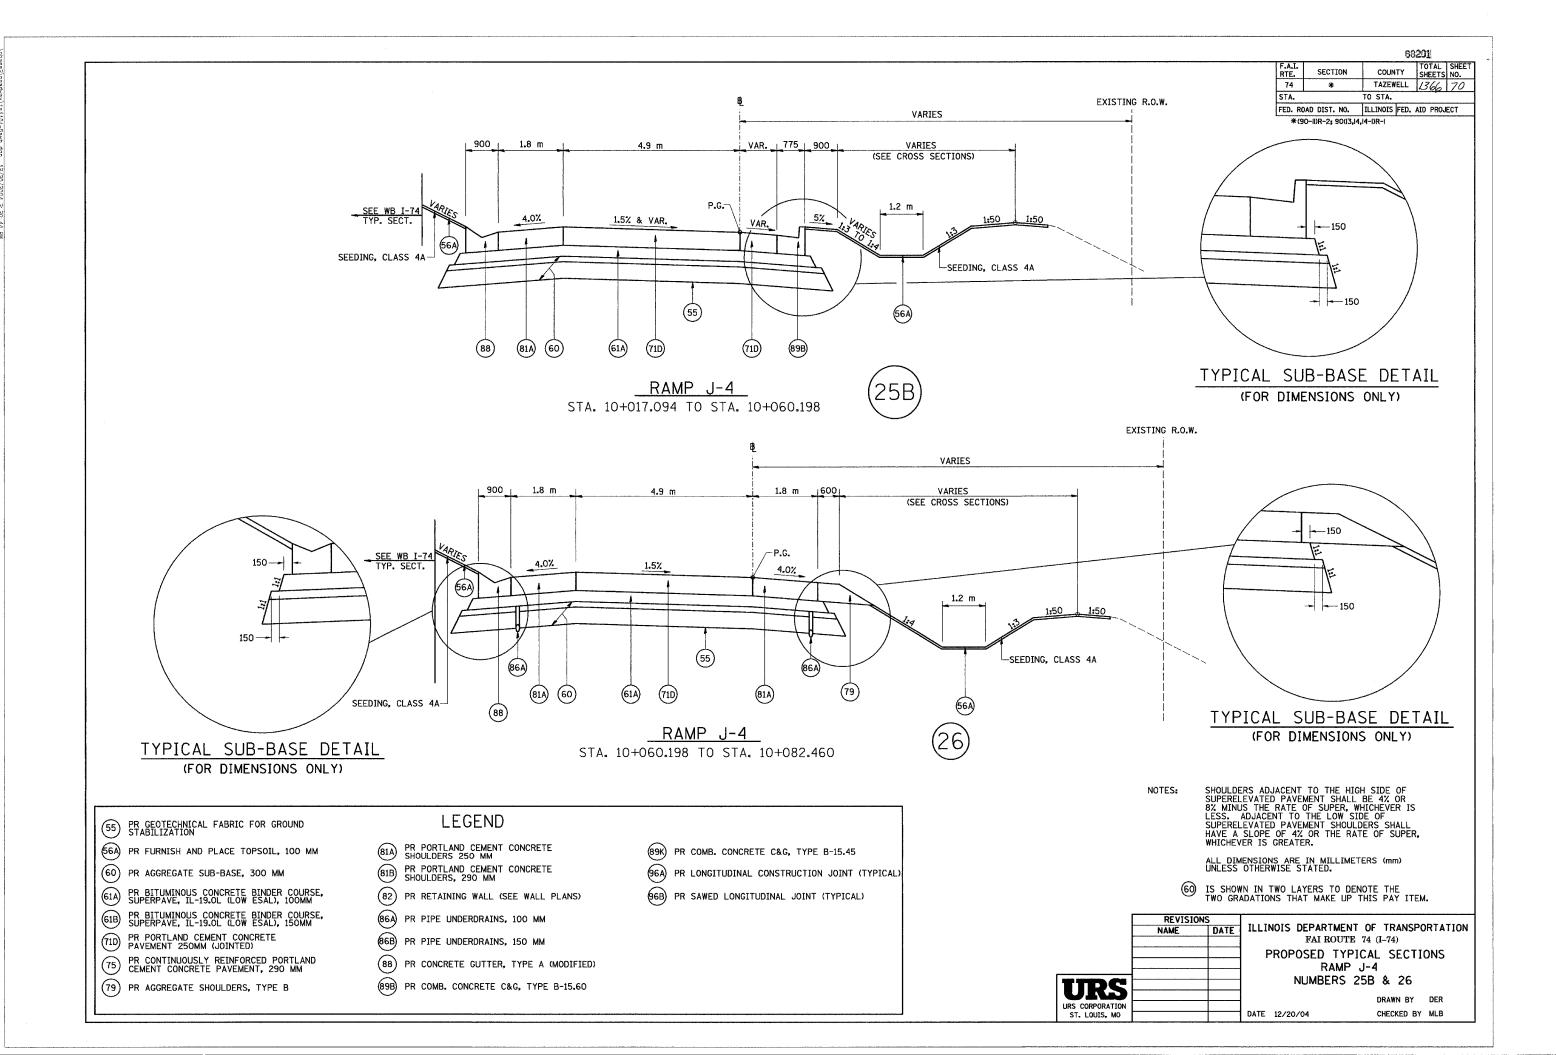


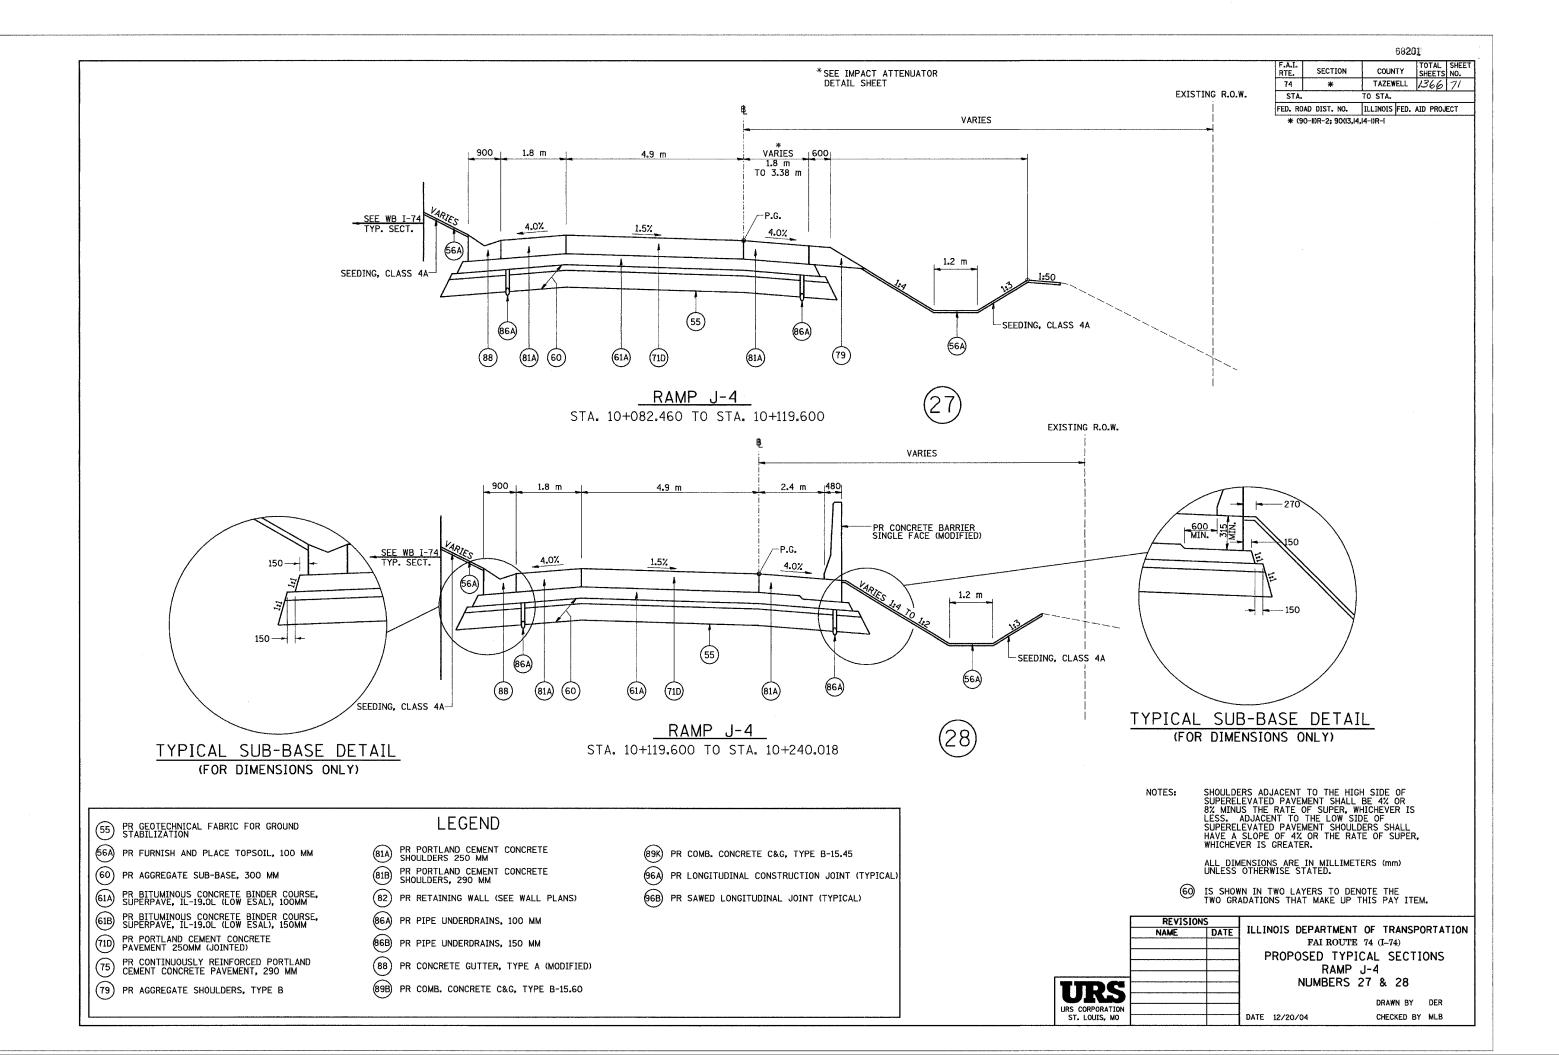


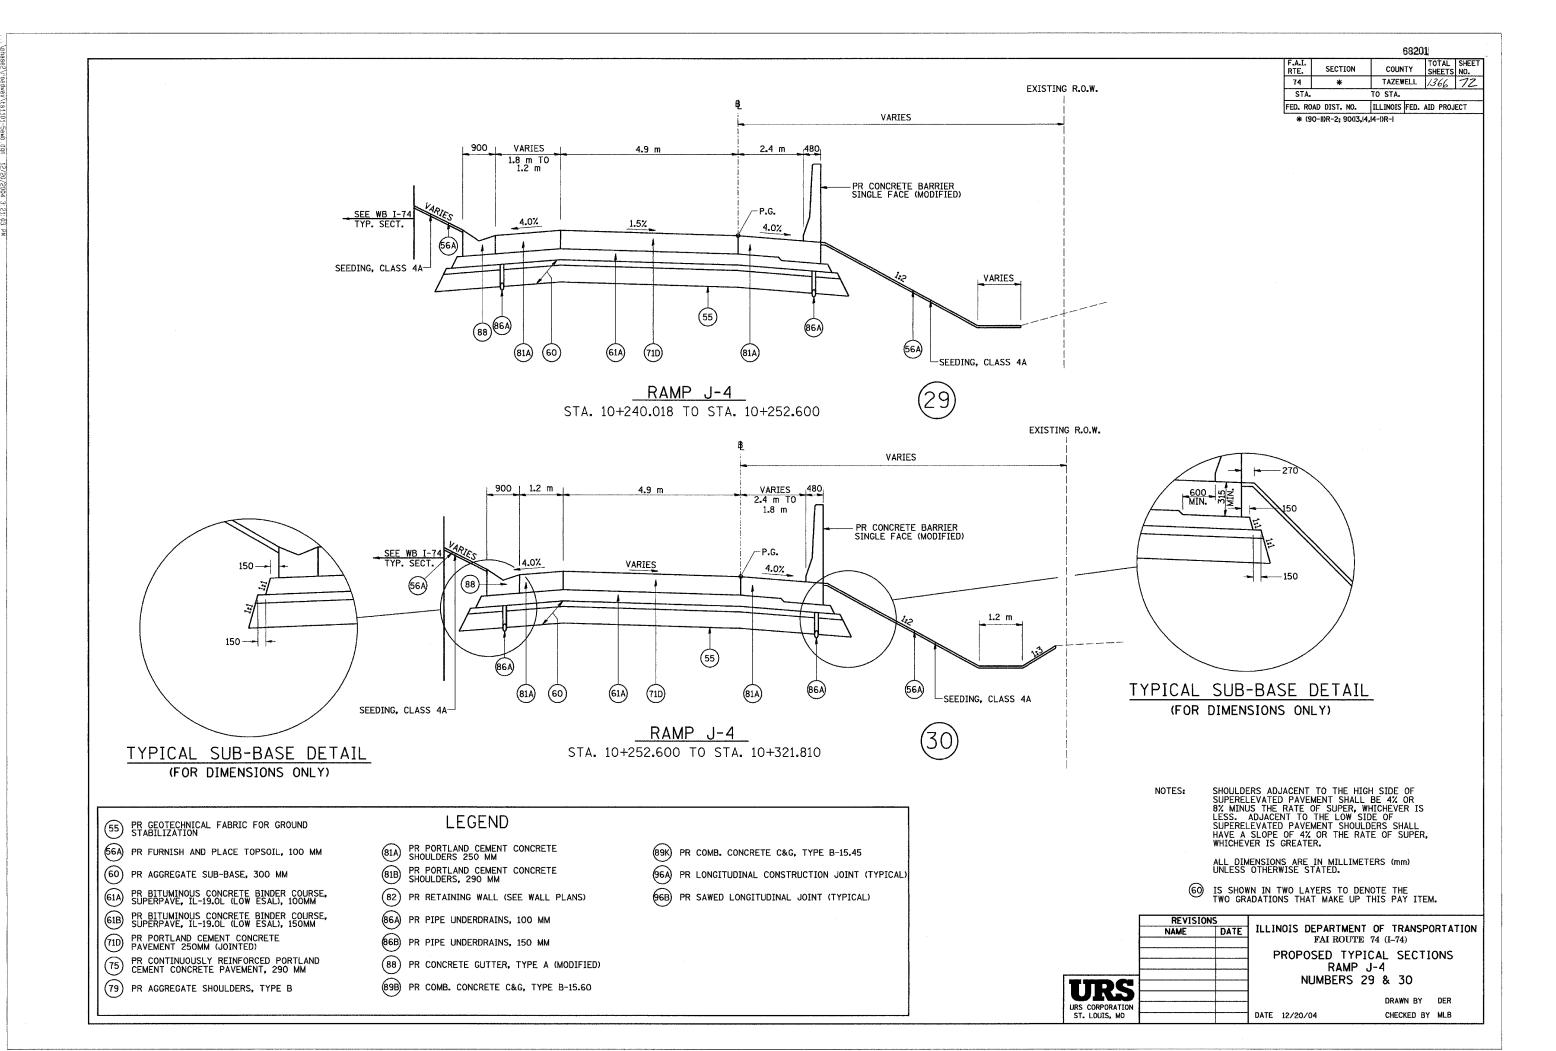


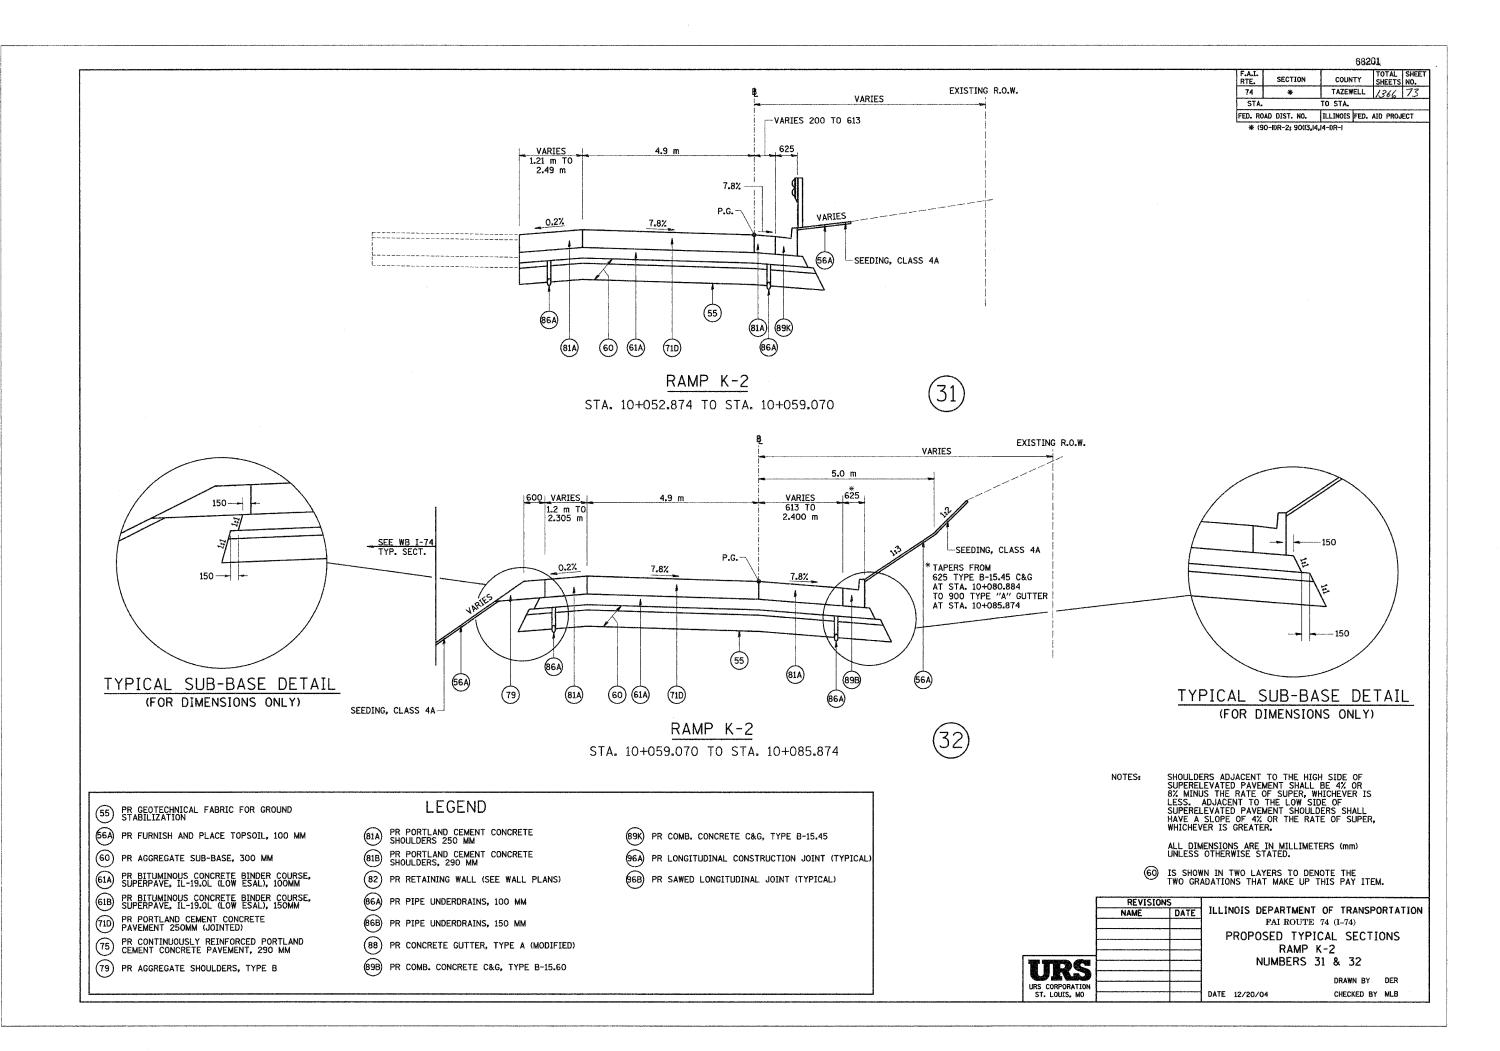

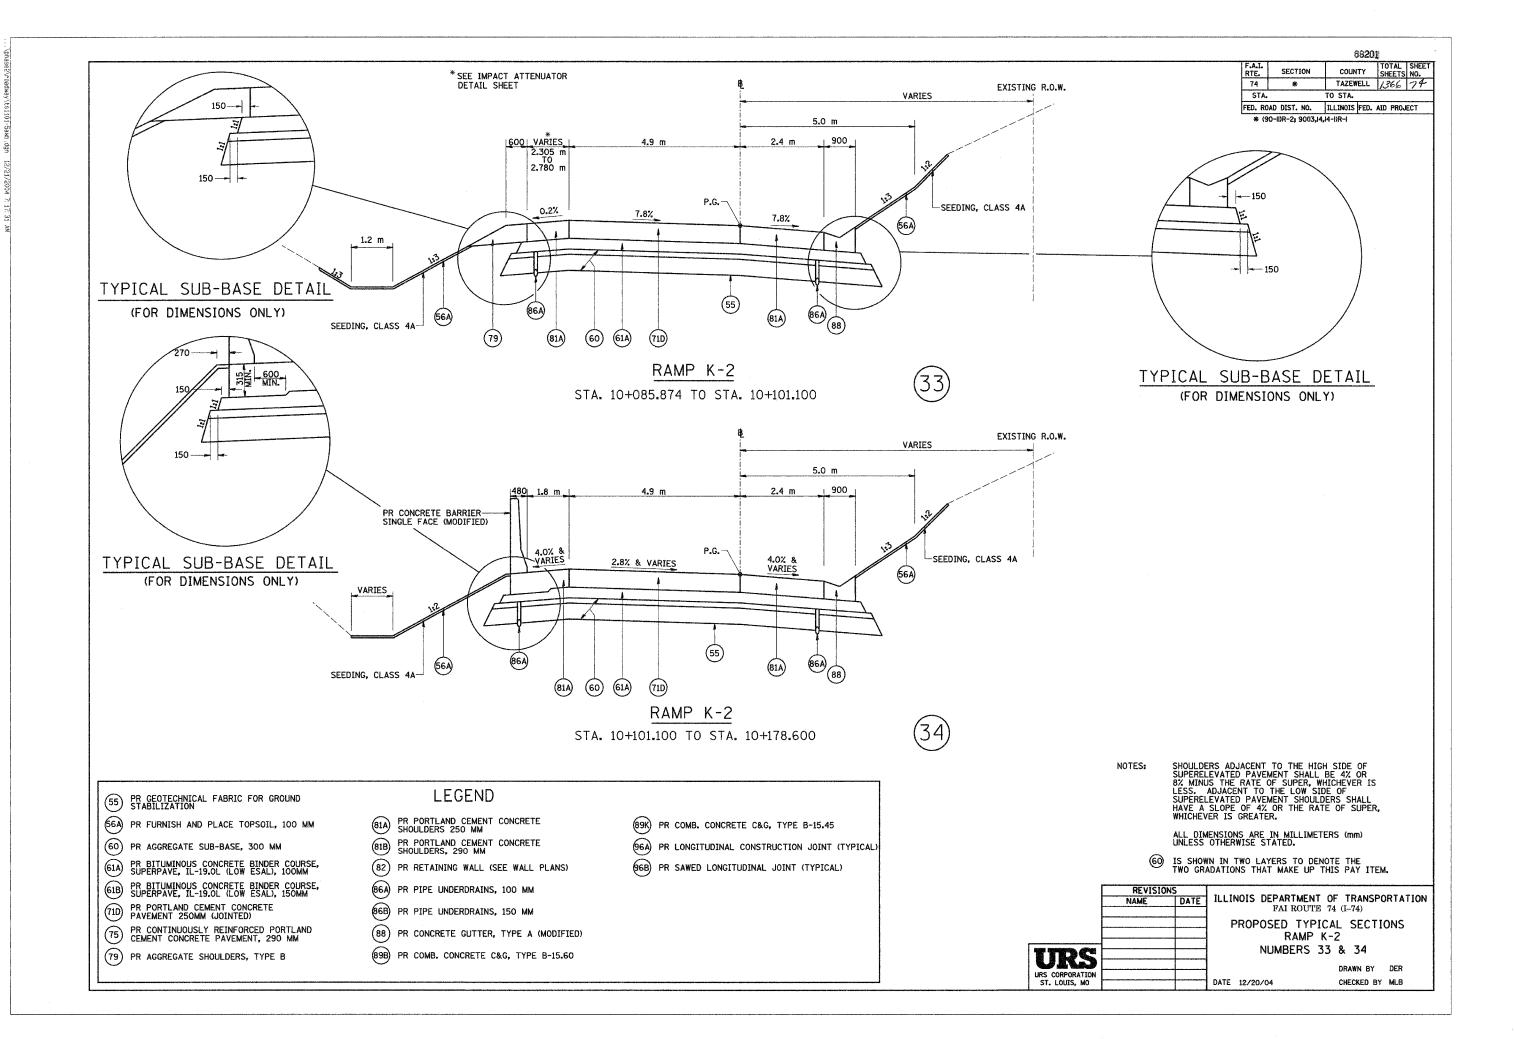


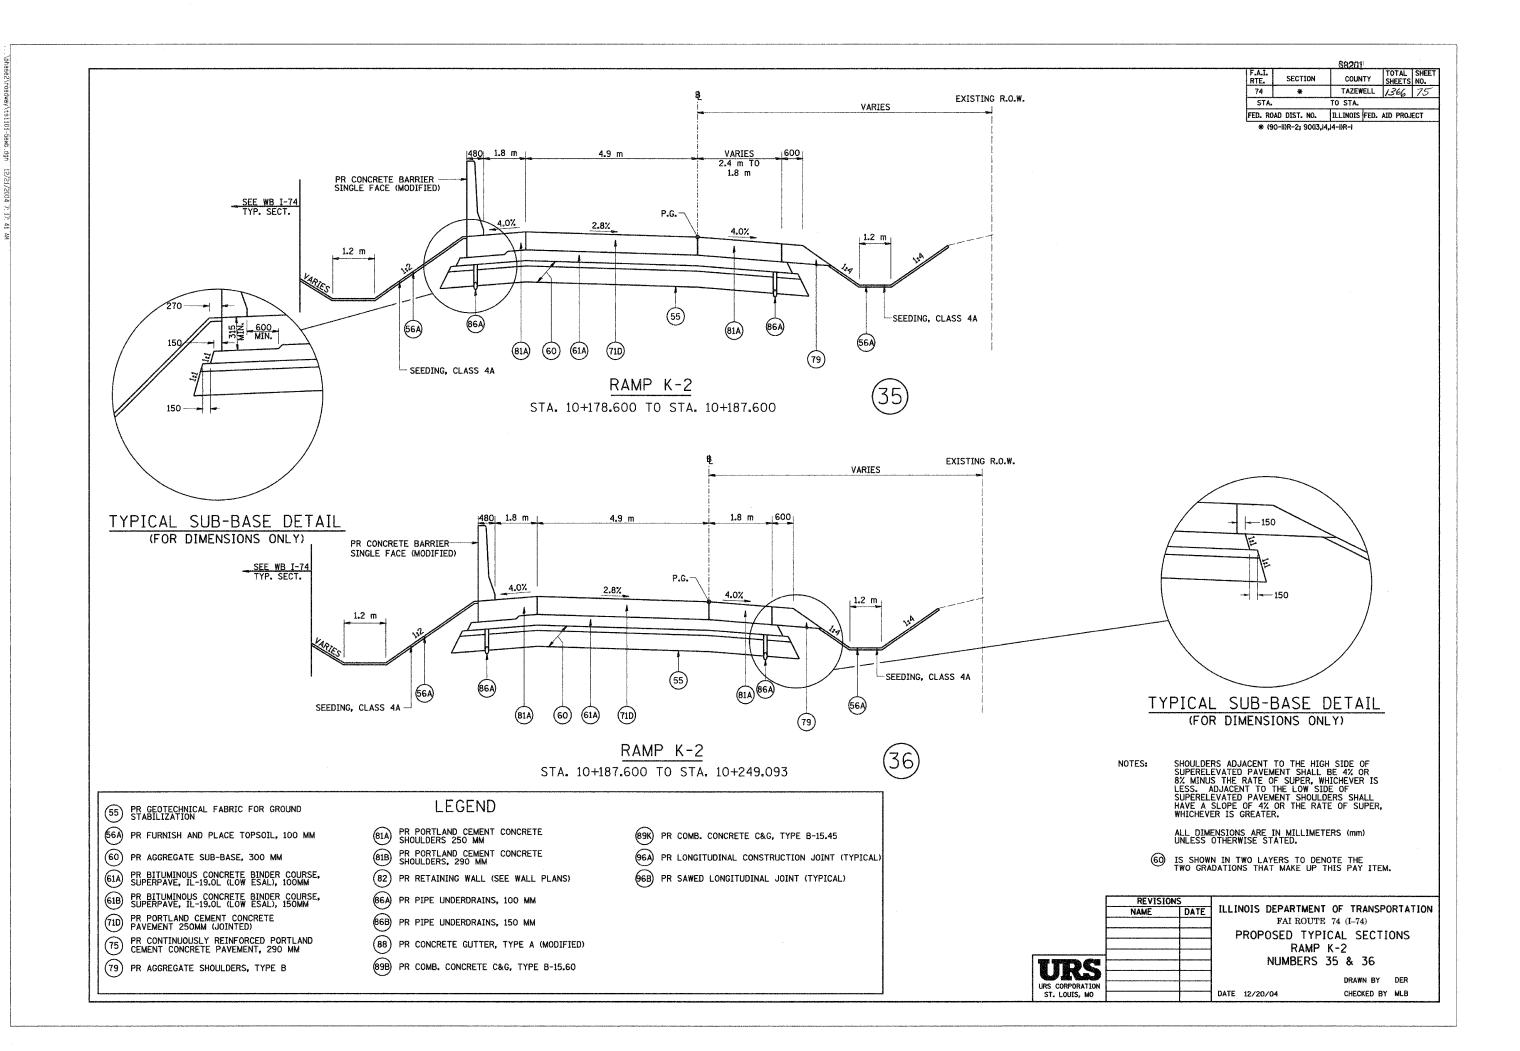

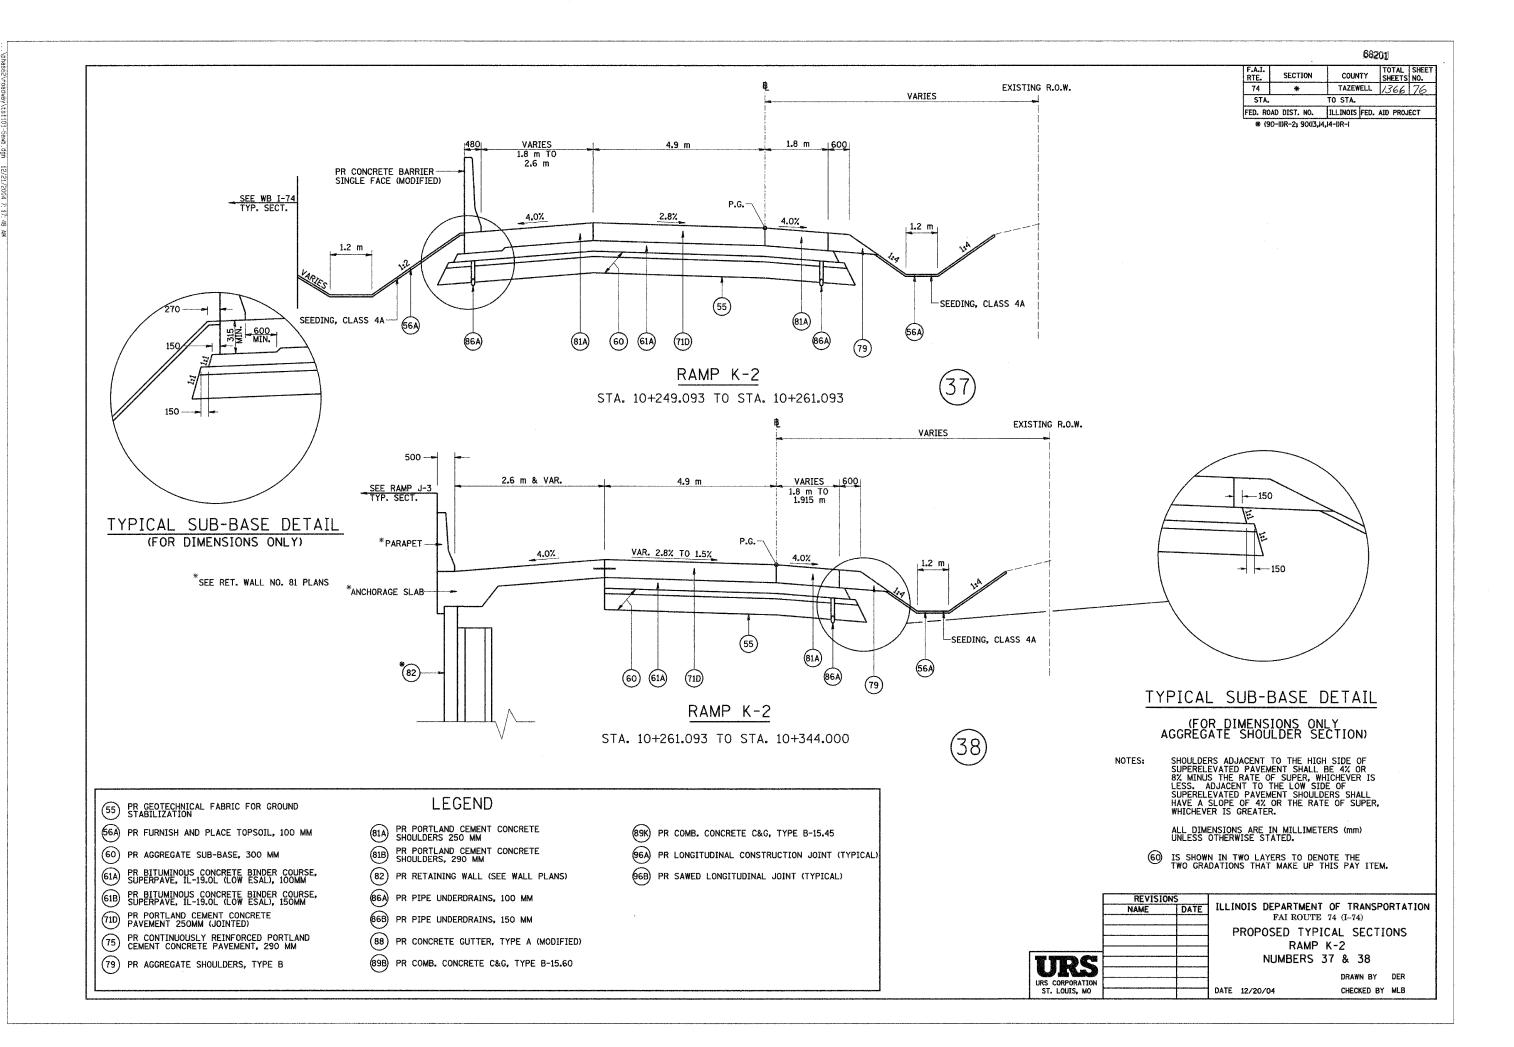

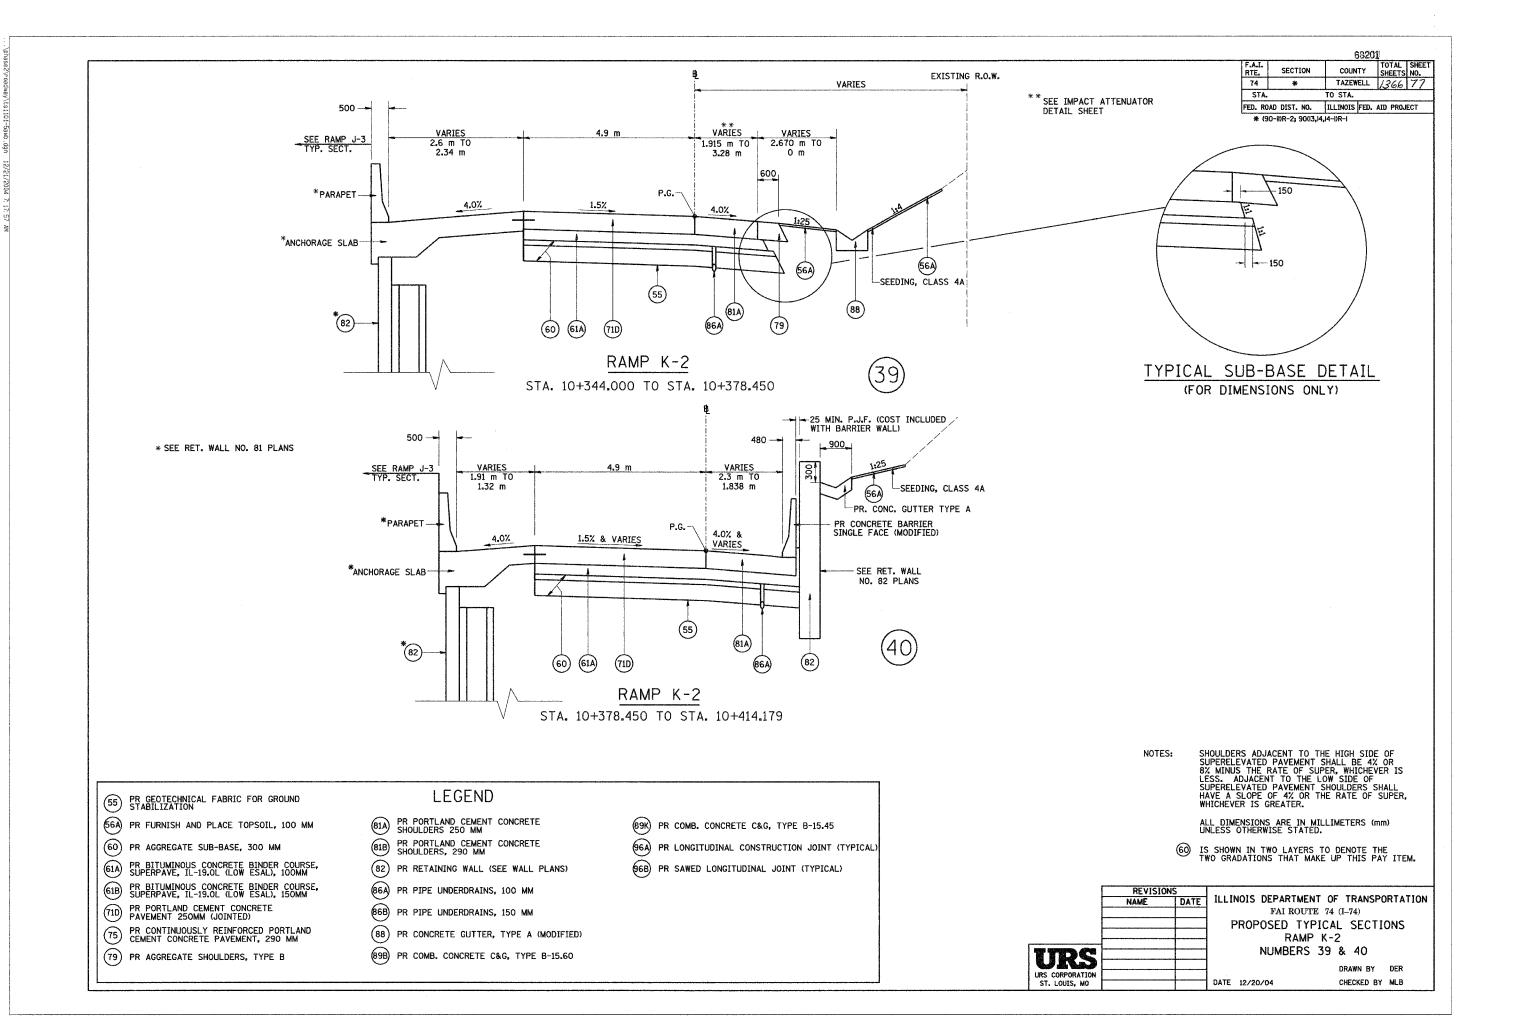

\* (90-IDR-2; 90(13,14,14-DR-1

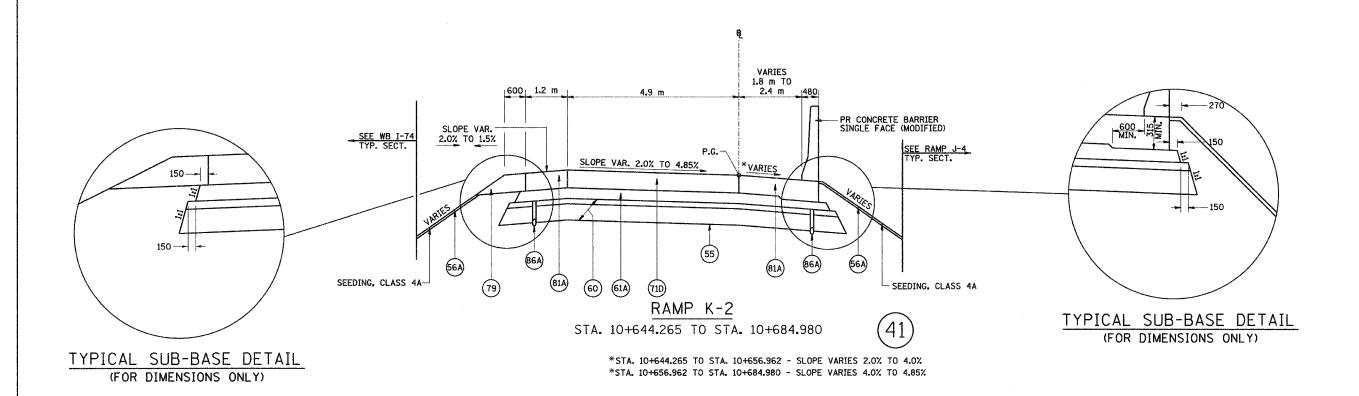

55) PR GEOTECHNICAL FABRIC FOR GROUND STABILIZATION

56A) PR FURNISH AND PLACE TOPSOIL, 100 MM

- (60) PR AGGREGATE SUB-BASE, 300 MM
- 61A PR BITUMINOUS CONCRETE BINDER COURSE, SUPERPAVE, IL-19.0L (LOW ESAL), 100MM
- PR BITUMINOUS CONCRETE BINDER COURSE, SUPERPAVE, IL-19.0L (LOW ESAL), 150MM
- 71D PR PORTLAND CEMENT CONCRETE PAVEMENT 250MM (JOINTED)
- PR CONTINUOUSLY REINFORCED PORTLAND CEMENT CONCRETE PAVEMENT, 290 MM
- (79) PR AGGREGATE SHOULDERS, TYPE B

# LEGEND

- PR PORTLAND CEMENT CONCRETE SHOULDERS 250 MM
- PR PORTLAND CEMENT CONCRETE SHOULDERS, 290 MM
- PR RETAINING WALL (SEE WALL PLANS)
- 86A) PR PIPE UNDERDRAINS, 100 MM
- 86B) PR PIPE UNDERDRAINS, 150 MM
- (88) PR CONCRETE GUTTER, TYPE A (MODIFIED)
- (89B) PR COMB. CONCRETE C&G, TYPE B-15.60

- (89K) PR COMB. CONCRETE C&G, TYPE B-15.45
- 96A) PR LONGITUDINAL CONSTRUCTION JOINT (TYPICAL)
- 96B) PR SAWED LONGITUDINAL JOINT (TYPICAL)

NOTES:

SHOULDERS ADJACENT TO THE HIGH SIDE OF SUPERELEVATED PAVEMENT SHALL BE 4% OR 8% MINUS THE RATE OF SUPER, WHICHEVER IS LESS. ADJACENT TO THE LOW SIDE OF SUPERELEVATED PAVEMENT SHOULDERS SHALL HAVE A SLOPE OF 4% OR THE RATE OF SUPER, WHICHEVER IS GREATER.

ALL DIMENSIONS ARE IN MILLIMETERS (mm) UNLESS OTHERWISE STATED.


(6) IS SHOWN IN TWO LAYERS TO DENOTE THE TWO GRADATIONS THAT MAKE UP THIS PAY ITEM.


URS CORPORATION ST. LOUIS, MO


DATE ILLINOIS DEPARTMENT OF TRANSPORTATION
FAI ROUTE 74 (I-74)


PROPOSED TYPICAL SECTIONS RAMP K-2 NUMBERS 41


DATE 12/20/04 CHECKED BY MLB

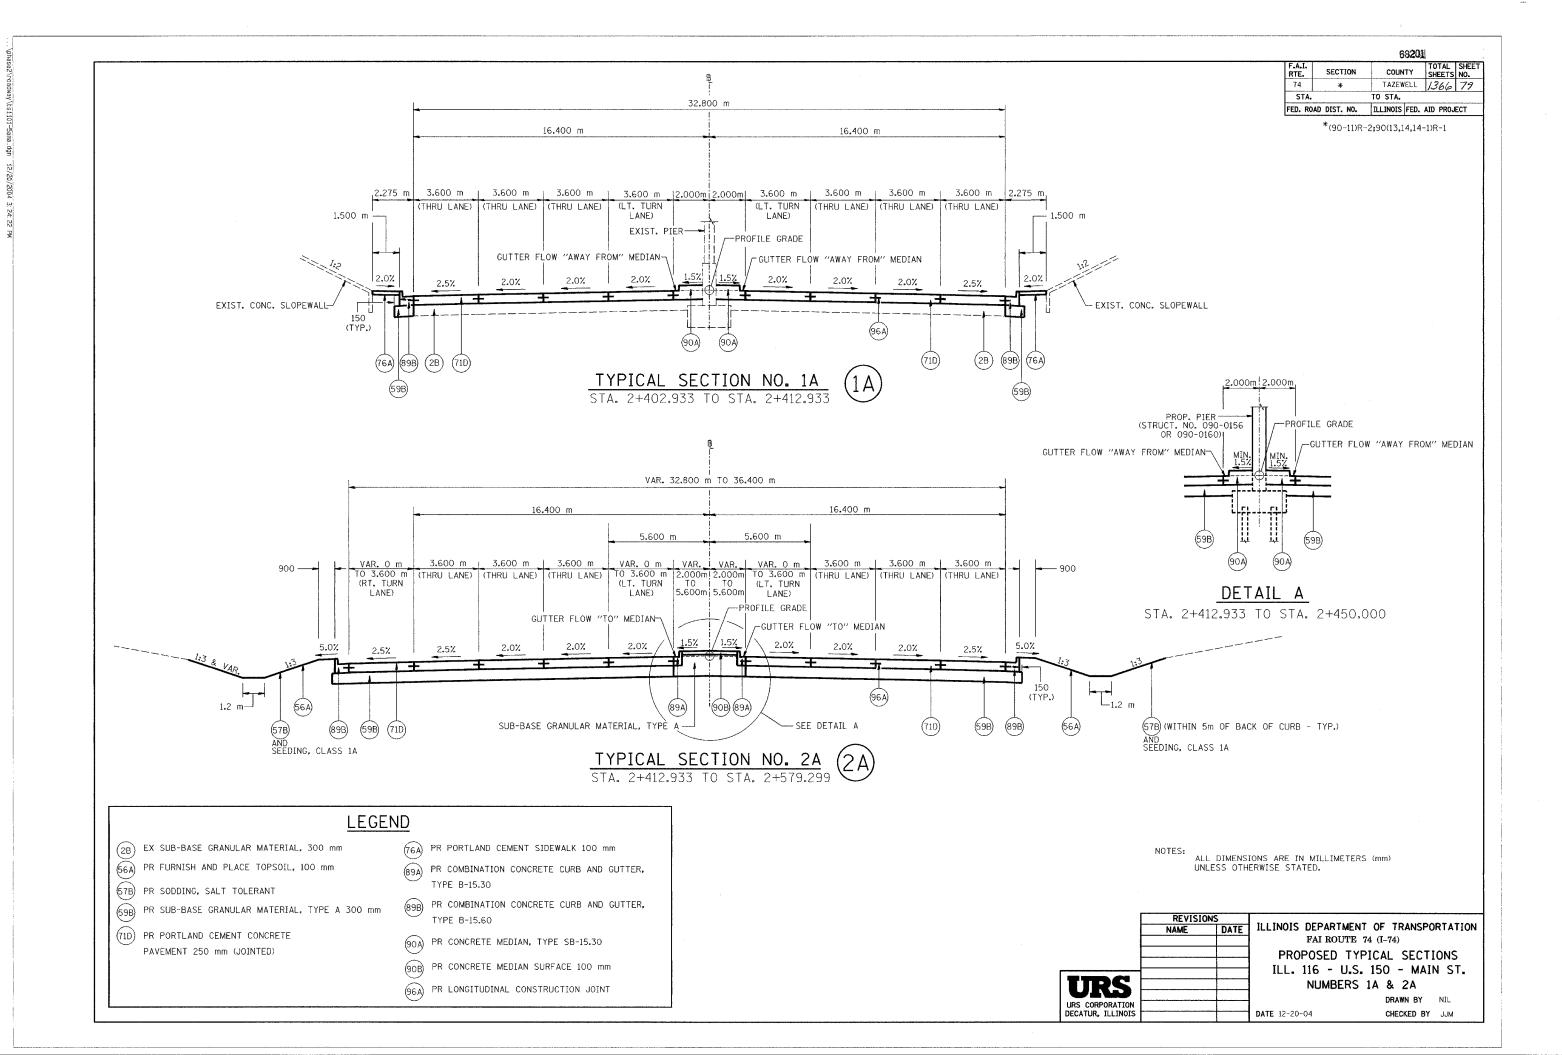


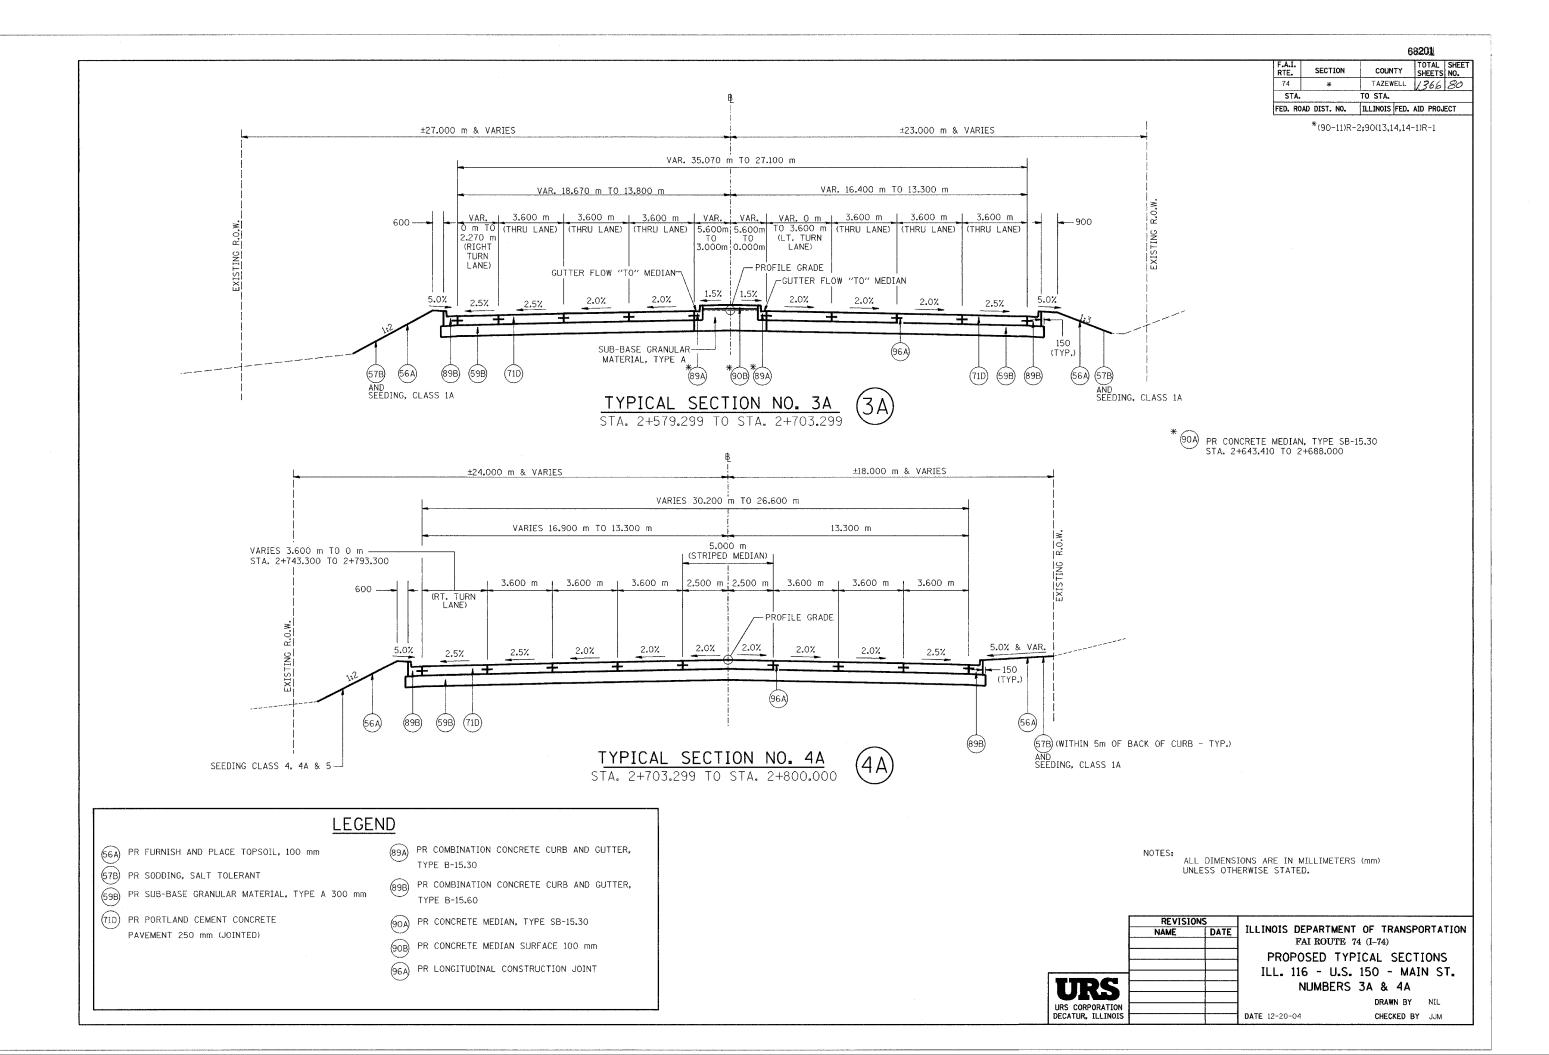


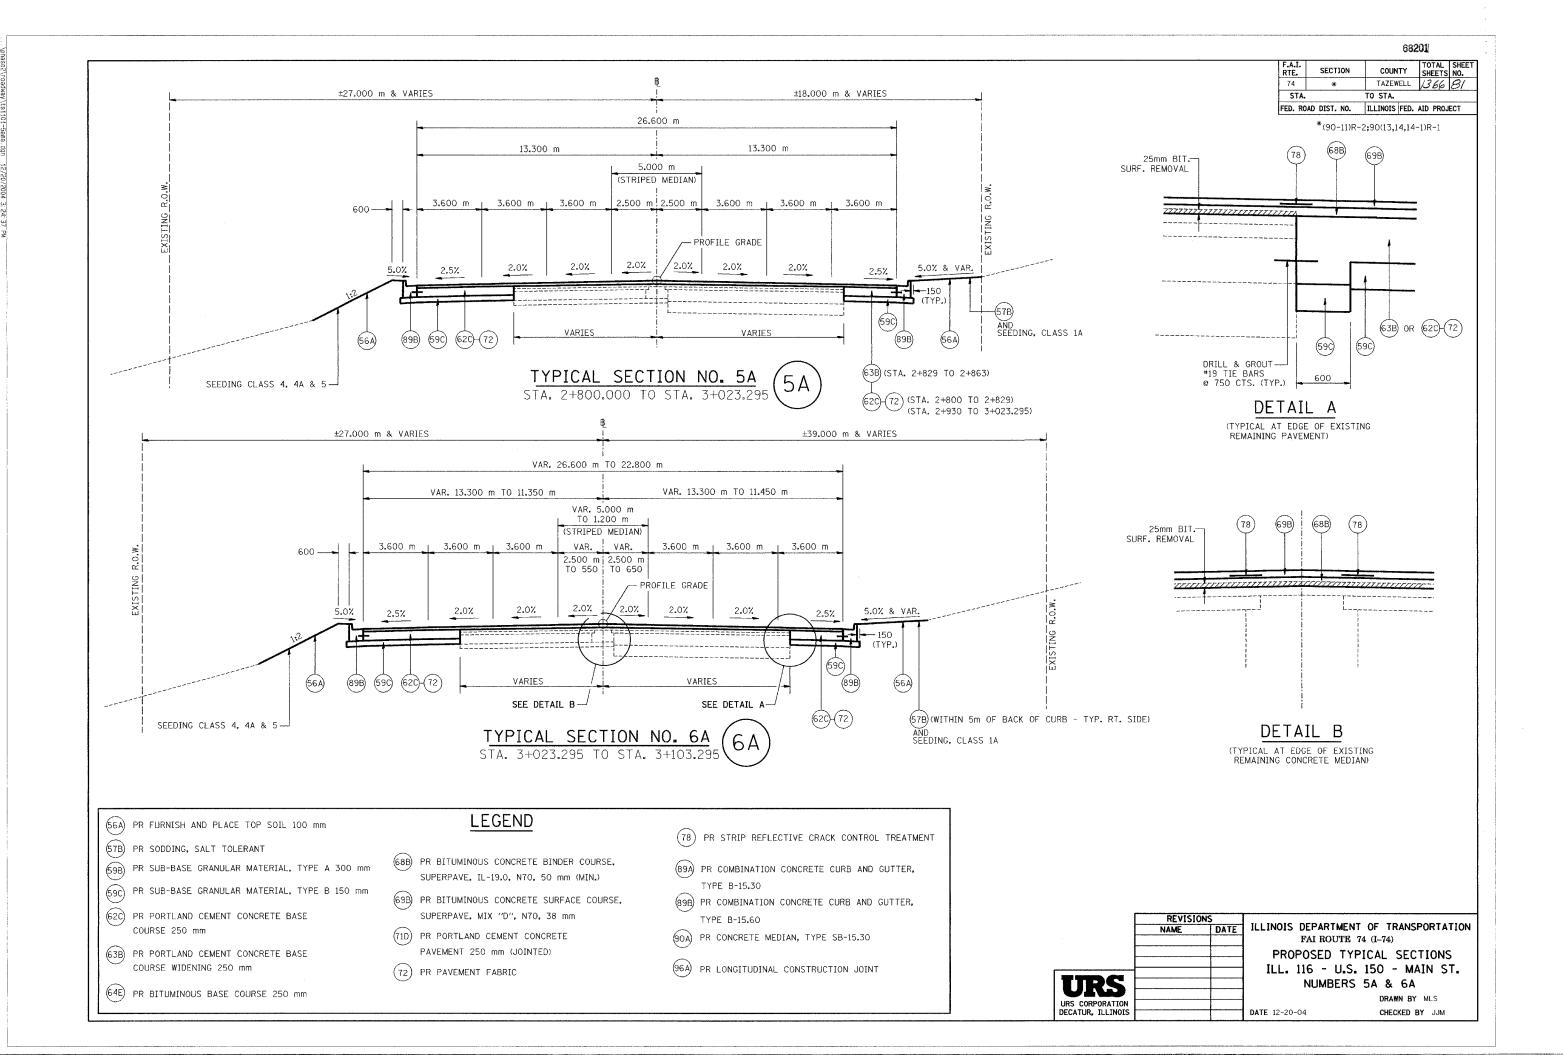

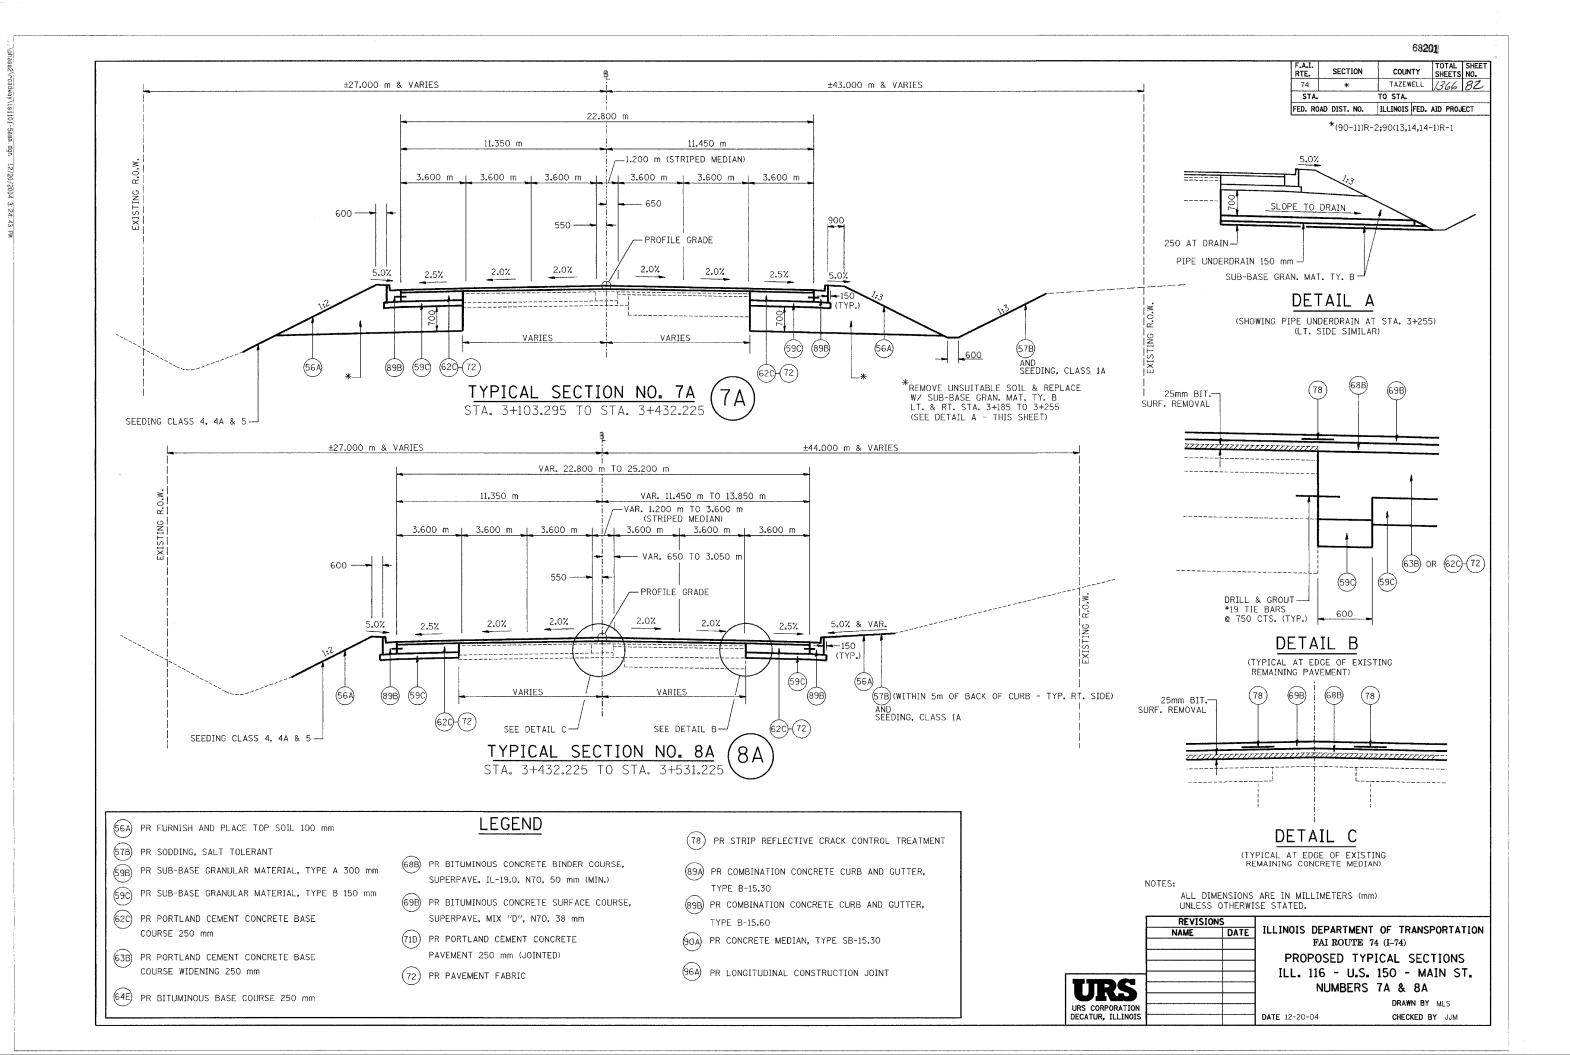


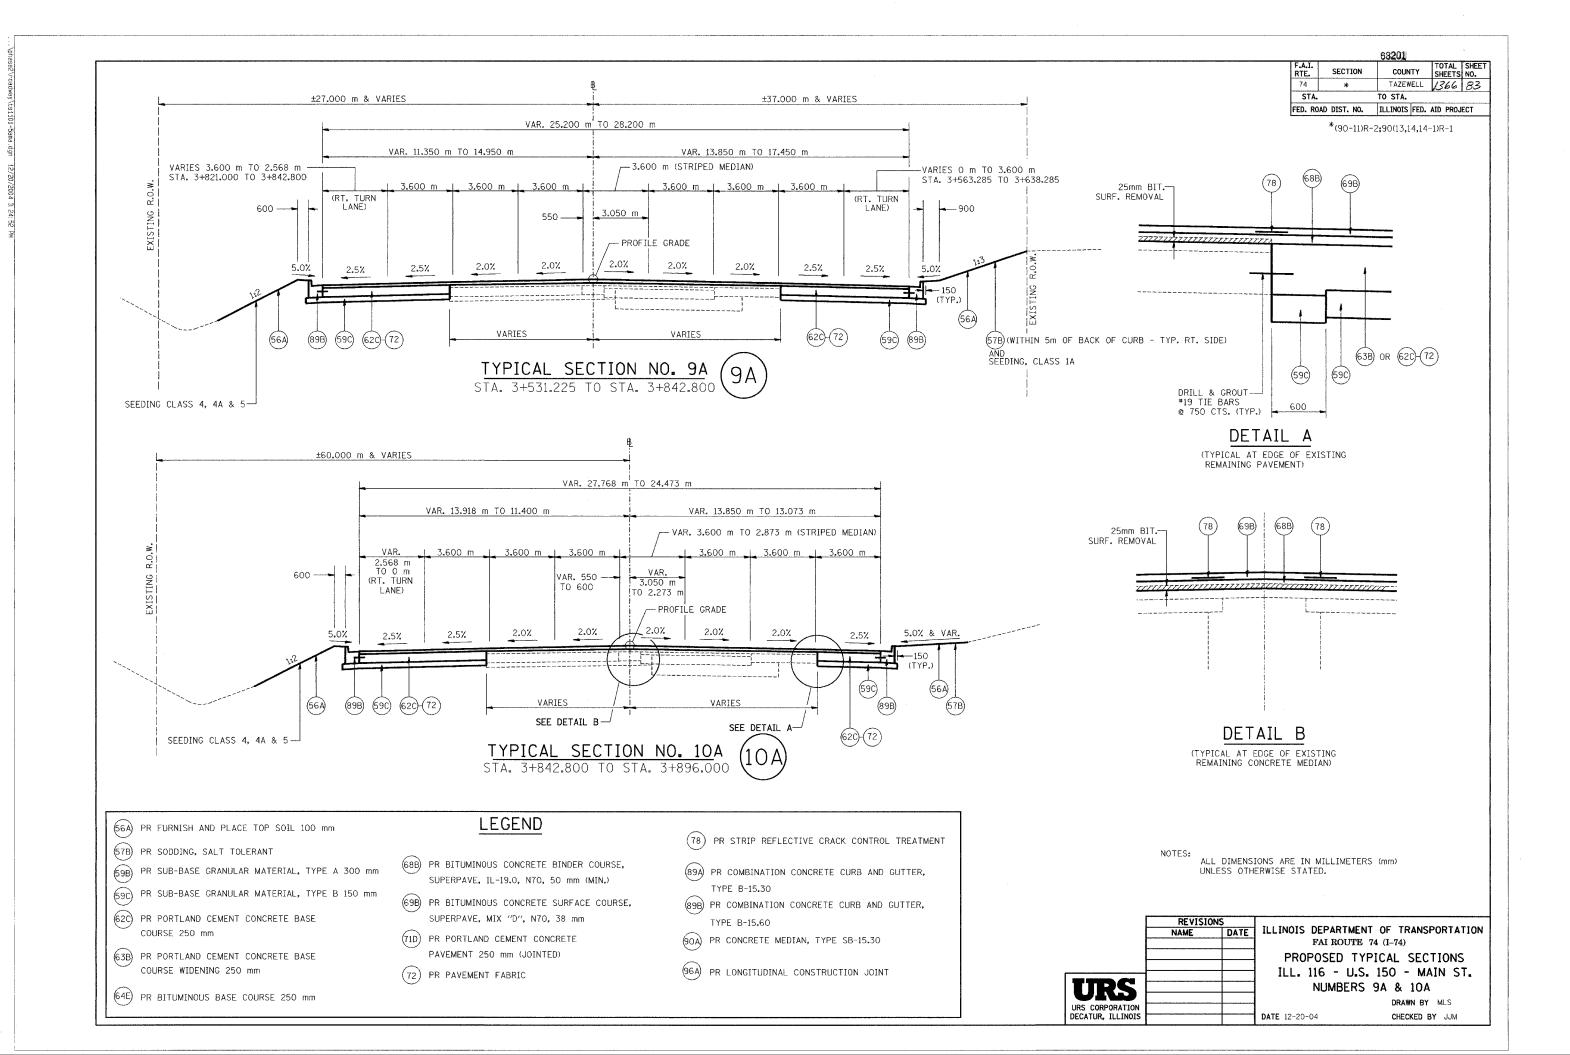

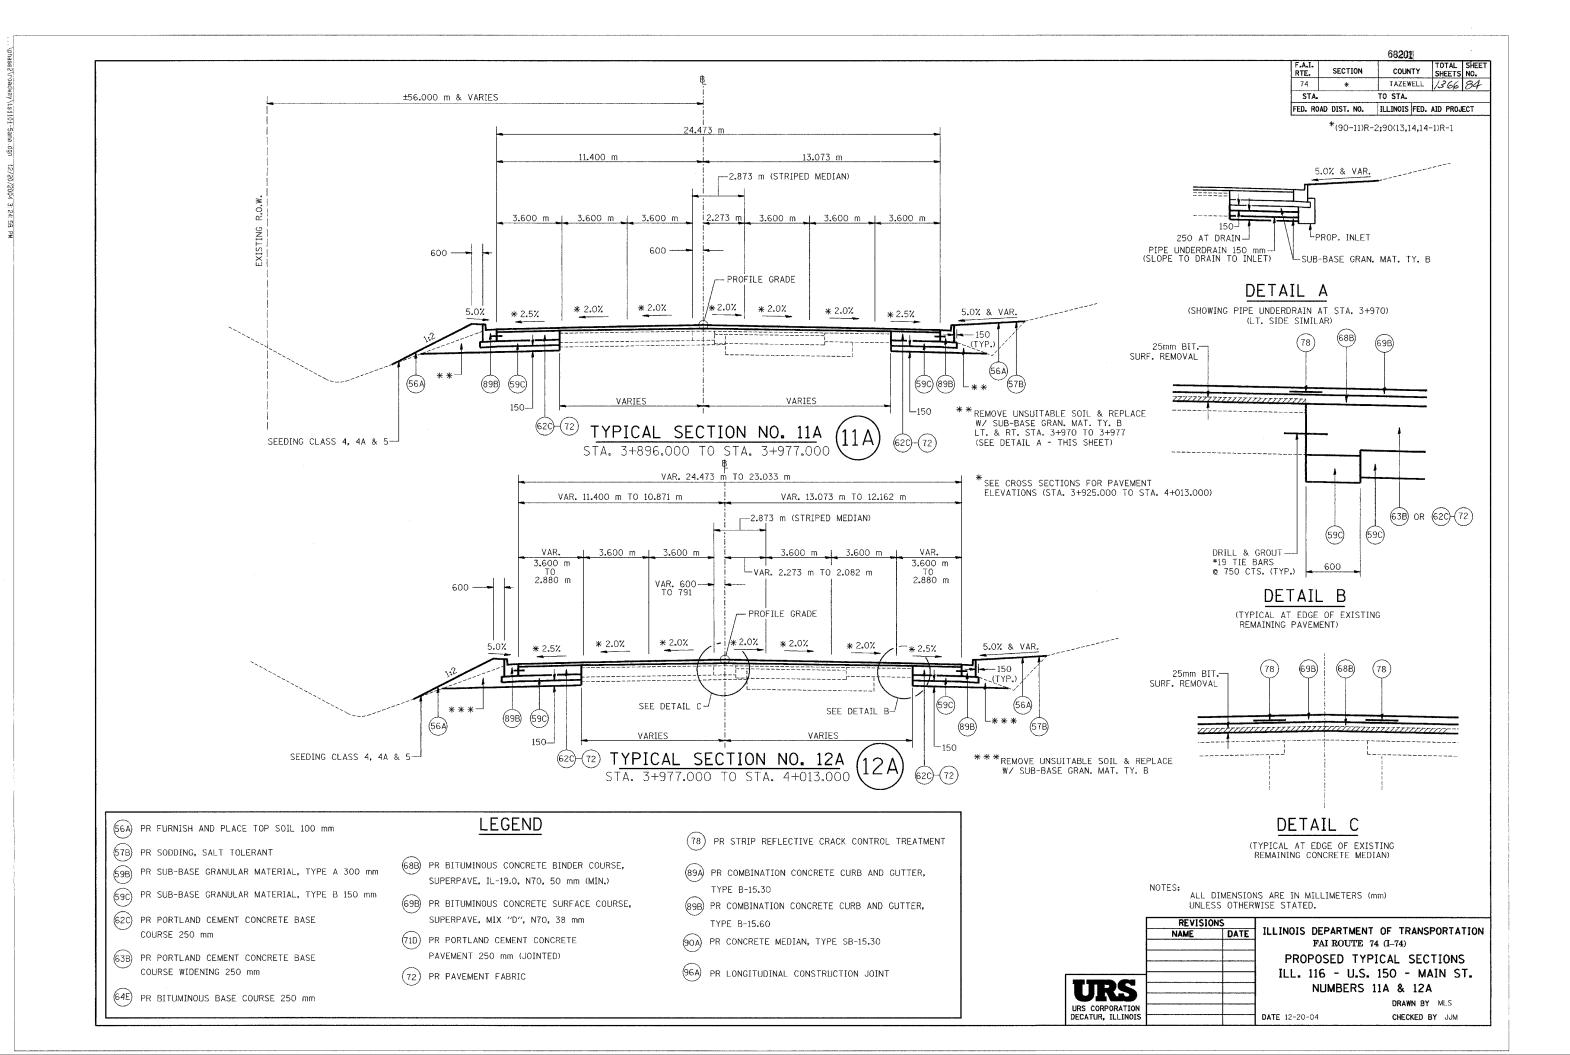

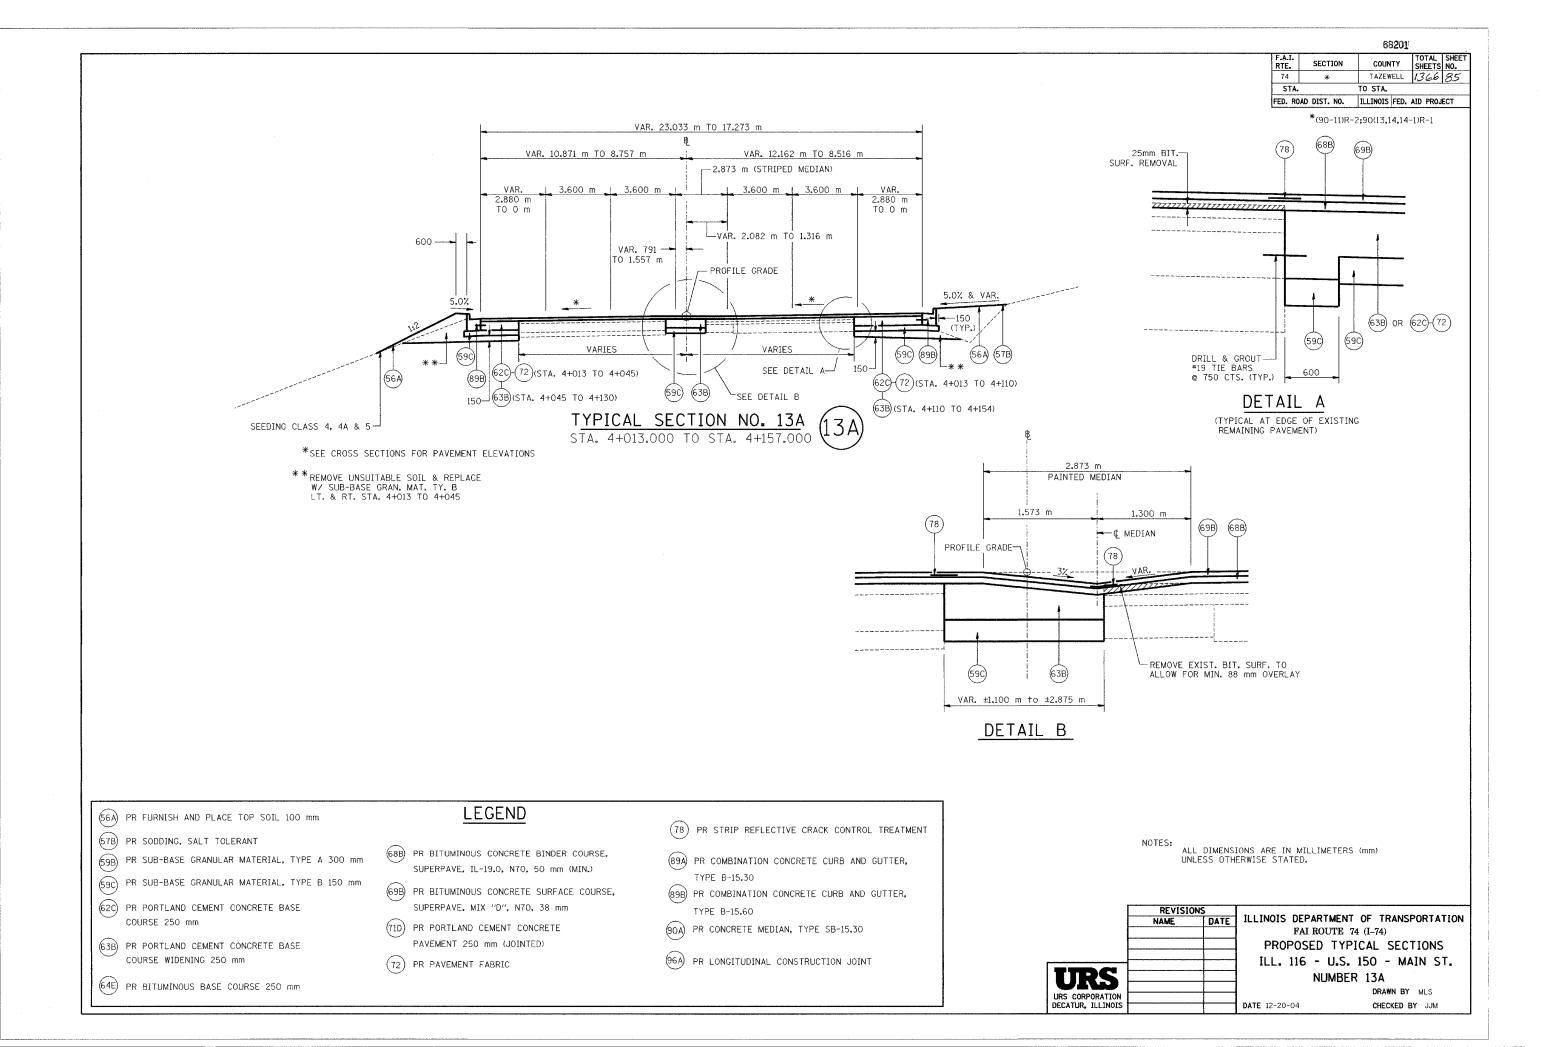

FED. ROAD DIST. NO. ILLINOIS FED. AID PROJECT \*(90-11)R-2:90(13.14.14-1)R-1

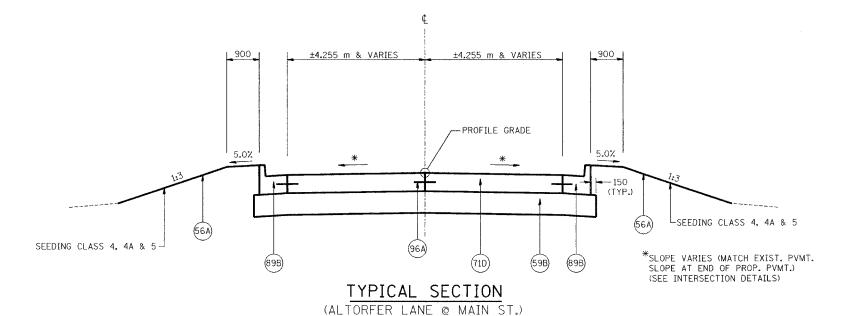

900\_ 3.350 m & VARIES . 3.350 m & VARIES . -PROFILE GRADE 5.0% <del>-</del>—150

(STA. 399+938.180 TO 399+986.610)

TYPICAL SECTION (FRONTAGE RD. @ ALTORFER LANE)

(STA. 9+963.333 TO 9+995.245)

96A

\*SLOPE VARIES (MATCH EXIST. PVMT. SLOPE AT END OF PROP. PVMT.) (SEE INTERSECTION DETAILS)

SEEDING CLASS 4, 4A & 5

(56A) PR FURNISH AND PLACE TOP SOIL 100 mm

(57B) PR SODDING, SALT TOLERANT

(59B) PR SUB-BASE GRANULAR MATERIAL, TYPE A 300 mm

(59C) PR SUB-BASE GRANULAR MATERIAL, TYPE B 150 mm

(62C) PR PORTLAND CEMENT CONCRETE BASE COURSE 250 mm

(63B) PR PORTLAND CEMENT CONCRETE BASE COURSE WIDENING 250 mm

(64E) PR BITUMINOUS BASE COURSE 250 mm

LEGEND

(68B) PR BITUMINOUS CONCRETE BINDER COURSE, SUPERPAVE, IL-19.0, N70, 50 mm (MIN.)

(69B) PR BITUMINOUS CONCRETE SURFACE COURSE, SUPERPAVE, MIX "D", N70, 38 mm

(71D) PR PORTLAND CEMENT CONCRETE PAVEMENT 250 mm (JOINTED)

SEEDING CLASS 4, 4A & 5

(78) PR STRIP REFLECTIVE CRACK CONTROL TREATMENT

(89A) PR COMBINATION CONCRETE CURB AND GUTTER, TYPE B-15.30

(89B) PR COMBINATION CONCRETE CURB AND GUTTER, TYPE B-15.60

(90A) PR CONCRETE MEDIAN, TYPE SB-15.30

(96A) PR LONGITUDINAL CONSTRUCTION JOINT


NOTES: ALL DIMENSIONS ARE IN MILLIMETERS (mm) UNLESS OTHERWISE STATED.

SHEET 1 OF 5

	REVISION	S	
	NAME	DATE	ILLINOIS DEPARTMENT OF TRANSPORTATION FAI ROUTE 74 (I-74)
		<del> </del>	PROPOSED TYPICAL SECTIONS
		<b></b>	SIDE RD.
			ALTORFER LN. @ MAIN ST. &
URS			FRONTAGE RD. @ ALTORFER LN.
URS CORPORATION		<del> </del>	DRAWN BY MLS
DECATUR, ILLINOIS		1	DATE 12-20-04 CHECKED BY JJM




\*(90-11)R-2;90(13,14,14-1)R-1

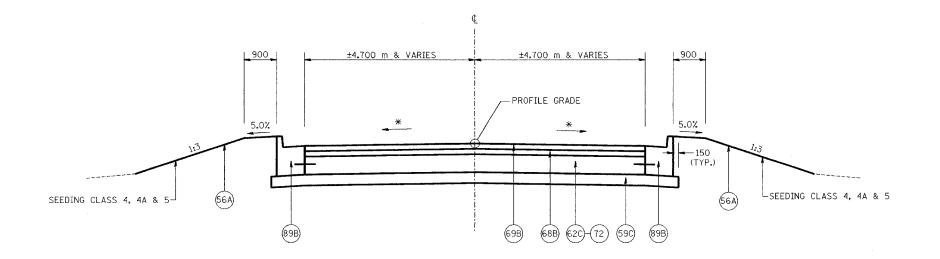

# TYPICAL SECTION

(NATIONAL STREET) (STA. 199+958.700 TO 199+986.700)

\* SLOPE VARIES (MATCH EXIST. PVMT. SLOPE AT END OF PROP. PVMT.) (SEE INTERSECTION DETAILS)

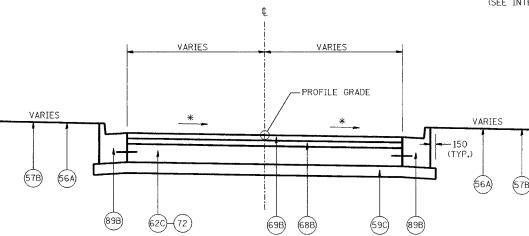

# TYPICAL SECTION

(CATERPILLAR TRAIL @ MAIN ST.) (STA. 200+013.300 TO 200+021.957) \* SLOPE VARIES (MATCH EXIST. PVMT. SLOPE AT END OF PROP. PVMT.) (SEE INTERSECTION DETAILS)

- (56A) PR FURNISH AND PLACE TOP SOIL 100 mm
- (57B) PR SODDING, SALT TOLERANT
- (59B) PR SUB-BASE GRANULAR MATERIAL, TYPE A 300 mm
- (59C) PR SUB-BASE GRANULAR MATERIAL, TYPE B 150 mm
- 62C) PR PORTLAND CEMENT CONCRETE BASE COURSE 250 mm
- (63B) PR PORTLAND CEMENT CONCRETE BASE COURSE WIDENING 250 mm
- (64E) PR BITUMINOUS BASE COURSE 250 mm

# **LEGEND**

- (68B) PR BITUMINOUS CONCRETE BINDER COURSE, SUPERPAVE, IL-19.0, N70, 50 mm
- (69B) PR BITUMINOUS CONCRETE SURFACE COURSE, SUPERPAVE, MIX "D", N70, 38 mm
- (71D) PR PORTLAND CEMENT CONCRETE
  PAVEMENT 250 mm (JOINTED)
- (72) PR PAVEMENT FABRIC

- (78) PR STRIP REFLECTIVE CRACK CONTROL TREATMENT
- (89A) PR COMBINATION CONCRETE CURB AND GUTTER,
  TYPE B-15.30
- (89B) PR COMBINATION CONCRETE CURB AND GUTTER, TYPE B-15.60
- (90A) PR CONCRETE MEDIAN, TYPE SB-15.30
- (96A) PR LONGITUDINAL CONSTRUCTION JOINT

NOTES:


ALL DIMENSIONS ARE IN MILLIMETERS (mm) UNLESS OTHERWISE STATED.


SHEET 2 OF 5


URS
URS CORPORATION
DECATUR, ILLINOIS
DO


PROPOSED TYPICAL SECTIONS
SIDE RD.
NATIONAL STREET &
CATERPILLAR TRAIL @ MAIN ST.

DATE 12-20-04 CHECKED BY JJM

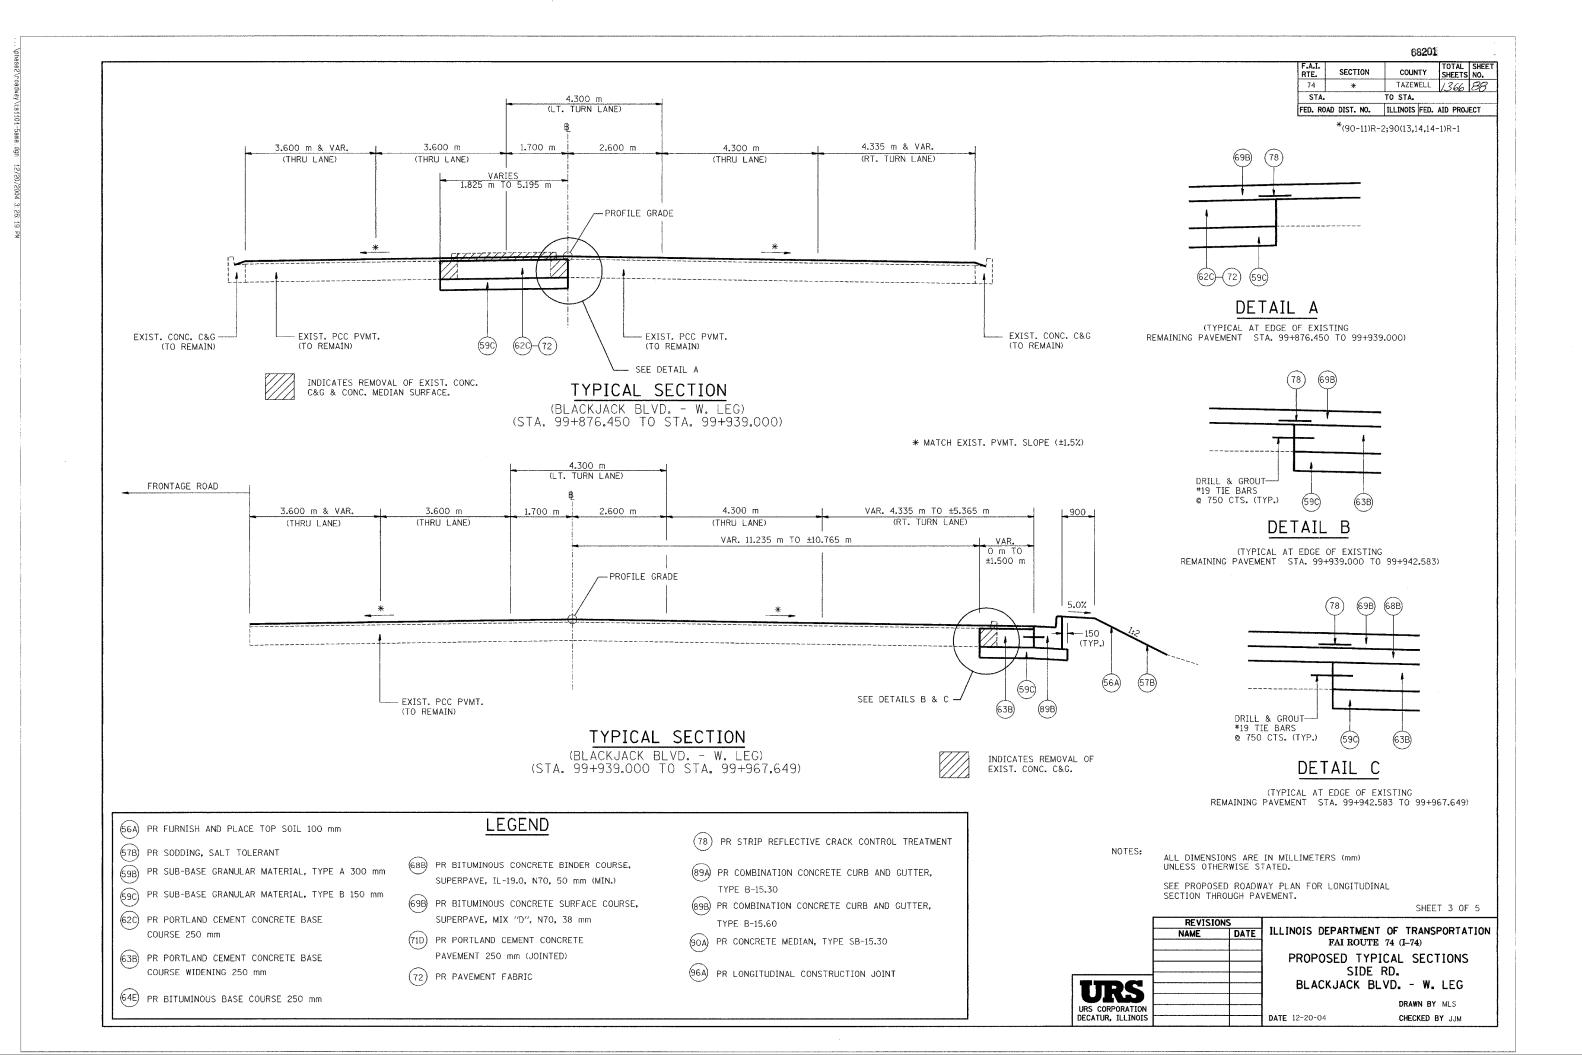

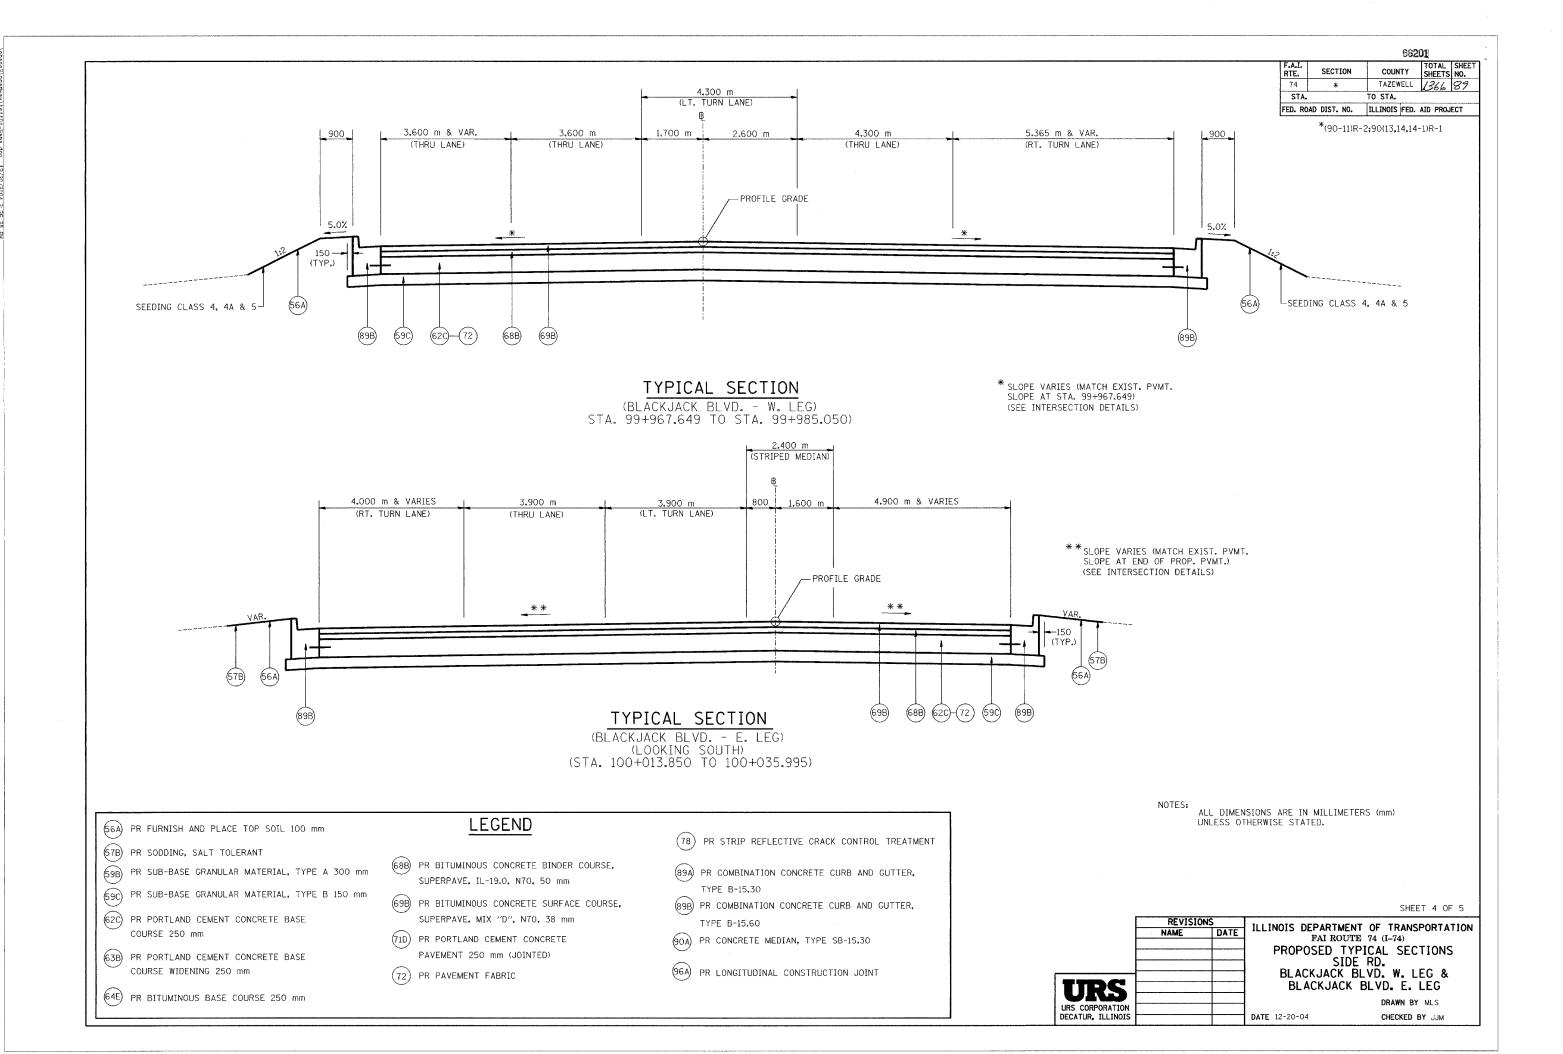

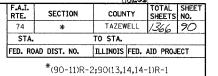

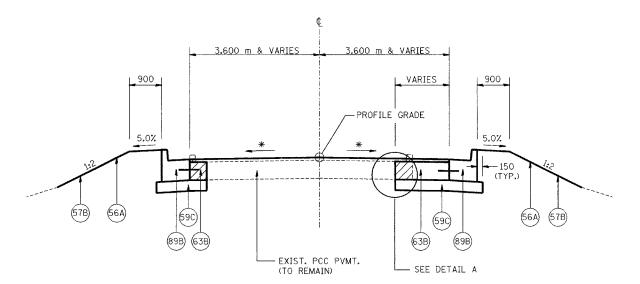

INDICATES REMOVAL OF EXIST. CONC. C&G.

# TYPICAL SECTION

(FRONTAGE RD. @ BLACKJACK BLVD. - W. LEG) (STA. 10+008.900 TO 10+030.825)

\* MATCH EXIST. PVMT. SLOPE (±1.5%)

DRILL & GROUT— #19 TIE BARS @ 750 CTS. (TYP.) (59C)

(TYPICAL AT EDGE OF EXISTING REMAINING PAVEMENT)

(69B) (68B)

(56A) PR FURNISH AND PLACE TOP SOIL 100 mm

(57B) PR SODDING, SALT TOLERANT

(59B) PR SUB-BASE GRANULAR MATERIAL, TYPE A 300 mm

(59C) PR SUB-BASE GRANULAR MATERIAL, TYPE B 150 mm

(62C) PR PORTLAND CEMENT CONCRETE BASE COURSE 250 mm

(63B) PR PORTLAND CEMENT CONCRETE BASE COURSE WIDENING 250 mm

(64E) PR BITUMINOUS BASE COURSE 250 mm

LEGEND

(68B) PR BITUMINOUS CONCRETE BINDER COURSE, SUPERPAVE, IL-19.0, N70, 50 mm (MIN.)

(69B) PR BITUMINOUS CONCRETE SURFACE COURSE, SUPERPAVE, MIX "D", N70, 38 mm

(71D) PR PORTLAND CEMENT CONCRETE PAVEMENT 250 mm (JOINTED)

(72) PR PAVEMENT FABRIC

(78) PR STRIP REFLECTIVE CRACK CONTROL TREATMENT

(89A) PR COMBINATION CONCRETE CURB AND GUTTER,

(89B) PR COMBINATION CONCRETE CURB AND GUTTER, TYPE B-15,60


(90A) PR CONCRETE MEDIAN, TYPE SB-15.30

(96A) PR LONGITUDINAL CONSTRUCTION JOINT

REVISIONS NAME

NOTES: ALL DIMENSIONS ARE IN MILLIMETERS (mm) UNLESS OTHERWISE STATED.

SHEET 5 OF 5

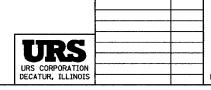

ILLINOIS DEPARTMENT OF TRANSPORTATION FAI ROUTE 74 (I-74) PROPOSED TYPICAL SECTIONS SIDE RD. FRONTAGE RD. @ BLACKJACK BLVD.

DATE 12-20-04 CHECKED BY JJM

#### EARTHWORK SCHEDULE

	1			4	r	T	7	
LOCATION	TOTAL EXCAVATION (CUT)	2 SPECIAL EXCAVATION	3 UNSUITABLE MATERIAL	EARTH EXCAVATION	5 EXCAVATION TO BE USED IN EMBANKMENT (ADJUSTED FOR SHRINKAGE)	6 EMBANKMENT (FILL)	EARTHWORK BALANCE WASTE (+) OR FURNISHED EXCAVATION (-)	8 TOPSOIL FURNISH AND PLACE 100 MM
	(COL 2 + COL 3+ COL 4)				(COL 4 × 0.75)		(COL 5 - COL 6)	
	CU M	си м	CU M	си м	CU M	си м	сим	SQ M
STAGE 3A								
I-74 WB STA 152+444.837 TO STA 152+656,108	1,463	0	0	1,463	1,097	463	634	694
I-74 WB STA 152+714.598 TO STA 153+020.792	251	o	0	251	188	2,955	~2,767	570
I-74 WB STA 153+079.792 TO STA 153+168.000	93	0	0	93	70	49	21	0
I-74 WB STA 153+469.000 TO STA 153+499.000	155	0	0	155	116	268	-152	312
I-74 WB STA 153+741.674 TO STA 153+828.180	387	0	0	387	290	316	-26	892
RAMP J4 STA 10+230.000 TO STA 10+301.000	44	0	0	44	33	2,809	-2,776	1,170
RAMP K2 STA 10+635.511 TO STA 10+691.236	22	0	0	22	17	1,013	-977	177
SUBTOTAL	2,415	0	0	2,415	1,811	7,873	-6,062	3,815
STAGE 3A-3								
RAMP J4 STA 10+033.000 TO STA 10+066.000	1,156	0	0	1,156	867	43	824	1,257
RAMP K2 STA 10+635.511 TO STA 10+676.000	0	0	0	0	0	896	-896	805
SUBTOTAL	1,156	0	0	1,156	867	939	-72	2,062
STAGE 3B			THE CONTRACTOR OF THE CONTRACT					
I-74 WB STA 153+079.792 TO STA 153+499.000	7,857	0	0	7,857	5,893	275	5,618	3,109
RAMP J3 STA 10+149.000 TO STA 10+351.000	17,250	0	1003	16,722	12,542	29	12,513	1,441
RAMP K2 STA 10+051.874 TO STA 10+423.029	2,979	0	102	2,877	2,158	2,875	-717	2,854
SUBTOTAL	28,086	0	1105	27,456	20,592	3,179	17,413	7,404
STAGE 3C								
I-74 WB STA 152+723.598 TO STA 152+975.000	483	0	0	483	362	1,138	-776	1,825
RAMP J4 STA 10+064.000 TO STA 10+301.000	19,960	0	0	19,960	14,970	470	14,500	5,427
SUBTOTAL	20,443	0	0	20,443	15,332	1,608	13,724	7,252

F.A.I. RTE.	SECTION	SECTION		COUNTY			SHEET NO.
74	(90-11)R-2;90(13,14,14-	1)R-1				366	9/
STA	•	TO	STA.				
FED. R	DAD DIST. NO.	I	LINOIS	FED.	AID	PROJ	ECT

\*NOT A TOTAL QUANTITY (FOR TOTAL QUANTITY ADD SIMILAR PAY ITEMS)

EARTH EXCAVATION SHRINKAGE FACTOR = 25%

WB I-74 & RAMPS

TOTAL

52,100

CROSS SECTION LEGEND DESCRIPTION **QUANTITIES** STAGE 3A STAGE 3A-3 STAGE 3B STAGE 3C EARTH EXCAVATION \* 51,470 CU M EARTH EXCAVATION E3A-1 E3A-3 E3B E3C TOPSOIL FURNISH AND PLACE, 100 mm \*20,533 SQ M TOPSOIL FURNISH AND PLACE T3A-1 T3A-3 ТЗВ T3C U3C REMOVAL AND DISPOSAL OF UNSUITABLE MATERIAL \*1105 CU M UNSUITABLE MATERIAL U3A-1 U3A-3 υзв

51,470

38,602

13,599

25,003

20,533

1105

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REVISIONS
NAME DATE ILLINOIS DEPARTMENT OF TRANSPORTATION SCHEDULE OF QUANTITIES I-74 WB RAMPS J-3 & J-4

DRAWN BY CW

DATE 12-20-04

CHECKED BY JJM

### GUARDRAIL REMOVAL

LOCATION	GUARDRAIL REMOVAL
STATION TO STATION	(METER)
MAINLINE (I-74 WB)	
152+716.6 TO 152+767.5 LT	51
152+911.7 TO 153+026.9 LT	115
153+070.5 TO 153+080.3 LT	10
153+445.7 TO 153+503.7 LT	58
153+742.0 TO 153+825.2 RT	83
153+747.2 TO 153+825.2 LT	78
RAMP 18	
0+109.0 T0 0+329.2 RT	220
RAMP 20	
6+123.0 TO 6+211.3 RT	88
TOTAL	* 703

### CURB AND GUTTER REMOVAL

LOCATION	CURB REMOVAL (METER)	COMBINATION CURB & GUTTER REMOVAL (METER)
RAMP 18		
0+109.0 TO 0+200.6 LT	92	
RAMP 19		
5+030.3 TO 5+130.0 LT	100	
RAMP 20		
6+123.0 TO 6+188.5 LT	66	
RAMP 21		
7+367.0 TO 7+394.8 RT	28	
RAMP 23		
1+052.9 TO 1+066.4 LT	14	
1+052.9 TO 1+171.7 RT		119
TOTAL	300	119

# TREE REMOVAL

LOCATION	OVER 15 (UNIT)	AREA (HA)
MAINLINE (I-74 WB)	1	
153+751.2, 23.5M LT	20	
153+755.5, 34.8M LT	30	
153+773.7, 26.6M LT	18	
153+784.5, 28.2M LT	26	
152+712.0 TO 152+810.0 LT		0.24
153+140.0 TO 153+300.0 LT		0,22
153+300.0 TO 153+473.0 LT		0,26
TOTAL	* 94	* 0. 72

#### MISC. REMOVAL

LOCATION STATION	CONCRETE BARRIER REMOVAL (METER)	CHAIN LINK FENCE REMOVAL (METER)
MAINLINE (I-74 WB)		
152+657.7 LT		32
152+712.9 LT		32
153+177.3 TO 153+244.0	67	
153+749.8 TO 153+822.9 LT		73
TOTAL	67	* 137

#### PAVEMENT AND SHOULDER REMOVAL

LOCATION	ESS X.)	PAVEMENT	ESS X.)	SHOI RE	AVED ULDER MOVAL	PAVED DITCH
	THICKNESS (APPROX.)	REMOVAL (SQ M)	THICKNESS (APPROX.)	BIT (SO M)	PCC (SQ M)	(METER)
STATION TO STATION	F 3		F 3			
MAINLINE (I-74 WB)				<del>                                     </del>		ļ
152+444. 287 TO 152+445. 837 LT	250	22		$\vdash$		<b>_</b>
152+445. 837 TO 152+657. 800 LT	_	1514	050	1	1271	
152+445.800 TO 152+645.000 LT	+		250	1	1331	-
152+445, 800 TO 152+657, 800 LT	_		250 250	282		
152+645.000 TO 152+657.800 LT 152+712.900 TO 153+000.000 LT	250	2545	250	14		1
152+712.900 TO 153+000.000 LT 152+712.900 TO 152+767.900 LT	250	2545	250	92		
152+767. 500 TO 152+767. 900 LT			250	503	·	<del> </del>
152+712, 900 TO 153+000, 000 LT	+		250	344		<del>-</del>
152+921, 400 TO 153+000, 000 LT			250	152		+
153+000.000 TO 153+027.800 LT	250	304	250	69		·
153+071. 300 TO 153+300. 000 LT	250	2118	230	1 03		1
153+071, 300 TO 153+300, 000 LT	230	2110	250		747	<u> </u>
153+077, 400 TO 153+181, 800 LT			250		362	1
153+182, 400 TO 153+181, 800 LT	1		250	1	608	<b>†</b>
153+300.000 TO 153+369.600 LT		-	250	1	253	†
153+300.000 TO 153+500.800 LT			250		450	
153+300,000 TO 153+500.800 LT	250	1726		1		
153+369. 200 TO 153+500. 800 LT	1		250		326	
153+470.000 TO 153+580.000 LT				1		125
153+744.600 TO 153+825.200 LT	250	699				
153+744.600 TO 153+825.200 LT			250	269		
RAMP 18						
0+109,000 TO 0+329,200 LT	250	917	050	704		-
0+109.000 TO 0+329.200 RT			250	391		
0+200.600 TO 0+300.800 LT			250	142		
RAMP 19 5+004.600 TO 5+130.000 LT	250	670				
5+004.600 TO 5+130.000 LT 5+004.600 TO 5+130.000 RT	250	610	250	240		
RAMP 20						
6+123,000 TO 6+211.300 LT	250	393				1
6+123,000 TO 6+211,300 RT	200	000	250	175		
6+187.100 TO 6+198.100 LT			250	13		
RAMP 21						
7+367.000 TO 7+399.000 LT			250	58		1
7+367.000 TO 7+464.400 RT	250	424		L		
7+367.000 TO 7+471.000 LT	1					104
7+399.000 TO 7+464.400 LT			250	ļl	126	
7+394.800 TO 7+441.900 RT	-		250		58	1.
RAMP 23						
1+052.900 T0 1+281.400 LT	250	956				
1+065.800 TO 1+250.000 LT	1		250	273		
1+171.700 TO 1+284.400 RT			250	206		
1+184.800 TO 1+194.100 RT	4			<u> </u>		25
SUBTOTAL Total		12288		3223 74	4261 184	* 254

THICKNESSES SHOWN ABOVE ARE APPROXIMATE AS NOTED. VARIANCES IN THICKNESS SHALL NOT BE PAID FOR SEPARATELY BUT INCLUDED IN THE COST OF THE PAY ITEM.

\*NOT A TOTAL QUANTITY (FOR TOTAL QUANTITY ADD SIMILAR PAY ITEMS)

URS CORPORATION ST. LOUIS, MO

ILLINOIS DEPARTMENT OF TRANSPORTATION SCHEDULE OF QUANTITIES I-74 WB RAMPS J-3 & J-4

DRAWN BY CGF DATE 12-20-04 CHECKED BY RLS

TO STA.

# INTERSTATE PAVING SCHEDULE

LOCATION	GEOTECHNICAL FABRIC FOR GROUND STABILIZATION (SO M)	BITUMINOUS MATERIALS (PRIME COAT) (LITER)	CONT REIN PCC PAVT 290 MM (SO M)	PAVEMENT REINFORCEMENT 290 MM (SO M)	PCC PAVT JOINTED 250MM (SQ M)	BRIDGE APPROACH PAVT (SO M)	BRIDGE APPROACH PAVT (SPECIAL) (SO M)	PROTECTIVE COAT (SO M)	AGG SHDRS TYPE B (M TON)	PCC SHDRS 250MM (SO M)	PCC SHDRS 290 MM (SO M)	AGGREGATE SUB-BASE 300 MM (M TON)	WHITEWASH (SO M)	BITUMINOUS CONCRETE BINDER COURSE, SUPERPAVE IL -19.OL (LOW ESAL) 150MM (M TON)	BITUMINOUS CONCRETE BINDER COURSE, SUPERPAVE IL -19.OL (LOW ESAL) 100 MM (M TON)
MAINLINE															
152+272.200 TO 152+445.837			22	22				493							
152+445.837 TO 152+700.000	2322	4348	2174	2174		97		2419			148	1693	2322	833	
152+700.000 TO 153+000.000	2978	4692	1990	1990		124		3079	52		965	2920	4006	1438	
153+000.000 TO 153+300.000	2707	5144	1820	1820			218	3661	157		752	1876	2578	924	
153+300.000 TO 153+600.000	2058	4554	2035	2035		129		3087			226	2138	2933	1053	
153+600.000 TO 153+892.180	1033	1844	659	659		129	137	1299			232	746	992	358	
RAMP J-3				<u> </u>											
10+000,000 TO 10+129,000	1038	1822	322	322	270			1227		115	334	281	386		92
10+129.000 TO 10+350.000	2703	4504			1310			2607	122	1009		1917	2509		600
RAMP J-4					<b></b>							<u> </u>			
10+065.000 TO 10+345.000	2945	5230			1258	84		3182	50	1118		2091	2727		652
10+345.000 TO 10+600.000	1792	3386	1133	1133		91		2211			499	1274	1657	600	
RAMP K-2															
10+052.874 TO 10+352.500	2930	5262			1468			3488	212	1205		1955	2665		643
10+352.500 TO 10+653.500	509	1100			344	73	84	1161	10	169		419	560		134
10+653.500 TO 10+954.000	2592	4220	665	665				1854	33	424	389	1045	1375		329
SUBTOTALS TOTALS	25607	46106	10820	10820	* 4650	727	439	* 29768	* 636	* 4040	3545	* 18355	24710	5206 * 76!	* 2450

# TRAFFIC BARRIER SCHEDULE

LOCATION	BARRIER WALL MARKERS (EACH)	STEEL PLATE BEAM GUARDRAIL TYPE A (METER)	DELINEATORS (EACH)	CONCRETE BARRIER DOUBLE FACE (MODIFIED) (METER)	CONCRETE BARRIER SINGLE FACE (MODIFIED) (METER)	CONCRETE BARRIER TRANSITION (MODIFIED) (METER)
MAINLINE				477 6	1	
152+272, 200 TO 152+445, 837 RT	16			173.6		
152+969.330 TO 153+011.792 LT			2			
153+087.555 TO 153+225.000 LT	1				137.4	
153+089.194 TO 153+300.000 RT	18			210.9		
153+202.437 TO 153+283.550 LT			2			····
153+300,000 TO 153+403,242 RT	10			103.2		
153+403, 242 TO 153+407, 992 RT	***************************************					4. 75
153+411.992 TO 153+416.742 RT						4. 75
153+416. 742 TO 153+494. 454 RT	8			77, 7		
153+428.942 TO 153+501.477 LT	4				72.5	
153+752.616 TO 153+819.180 LT	4				66. 6	
RAMP J-3						
10+000, 105 TO 10+129, 360 RT	6				129.4	
10+129.360 TO 10+250.000 RT	5				120.6	
10+145.073 TO 10+235.516 LT			3		1	
10+235.516 TO 10+314.519 LT	4				79.0	
10+271.505 TO 10+350.000 RT			3			
RAMP J-4		· · · · · · · · · · · · · · · · · · ·				
10+065.000 TO 10+119.597 RT			2			
10+065.000 TO 10+119.397 KT			9			
10+119,600 TO 10+330,696 RT	9		<del>                                     </del>		211.1	
10+389, 309 TO 10+600, 000 RT	9		·		210.1	
10+363, 303   0 10+600, 000 R	9				210.1	-
RAMP K-2						
10+052.874 TO 10+064.344 RT		11.43				
10+052.874 TO 10+101.030 LT			2	***************************************		
10+052.874 TO 10+352.500 RT		· · · · · · · · · · · · · · · · · · ·	10			····
10+101.030 TO 10+261.093 LT	7				160.1	
10+352.500 TO 10+413.450 RT			2			
10+370.000 TO 10+413.450 RT	4				43.4	
10+639.185 TO 10+653.500 RT					14.3	
10+653.500 TO 10+780.519 RT	6				127.0	
10+644.360 TO 10+684.984 LT			2			
10+780.519 TO 10+930.000 RT			5			
TOTAL	117	* 11.43	42	565.4	1371.5	10

\*NOT A TOTAL QUANTITY (FOR TOTAL QUANTITY ADD SIMILAR PAY ITEMS)

REVISIONS NAME URS URS CORPORATION ST. LOUIS, MO

ILLINOIS DEPARTMENT OF TRANSPORTATION SCHEDULE OF QUANTITIES I-74 WB RAMPS J-3 & J-4

DRAWN BY CGF

DATE 12-20-04

CHECKED BY RLS

FED. ROAD DIST. NO. 4 ILLINOIS FED. AID PROJECT

# TRAFFIC PROTECTION SCHEDULE

LOCATION	TRAFFIC BARRIER TERMINAL TYPE 2 (EACH)	TERMINAL MARKERS - DIRECT APPLIED (EACH)	IMPACT ATTENUATORS (FULLY REDIRECTIVE, NARROW) TEST LEVEL 2 (EACH)	IMPACT ATTENUATORS (FULLY REDIRECTIVE, NARROW TEST LEVEL 3 (EACH)
MAINLINE				
153+202,437 LT		1		1
RAMP J-3				
10+235.516 LT		1		1
RAMP J-4				
10+119.600 RT		1		1
RAMP K-2				
10+064.344 RT	1			
10+101.030 LT		1	1	
10+370.000 RT		1	1	
TOTAL	* 1	5	2	3

# DUST CONTROL

LOCATION	STREET SWEEPING (HOUR)	APPLY DUST SUPPRESSION AGENTS (UNIT)	SOIL Stabilizer (KG)	DUST CONTROL PADS (EACH)
MAINLINE				
152+445.837 TO 152+700.000	52	70	1350	4
152+700.000 TO 153+000.000	52	70	1350	4
153+000.000 TO 153+300.000	52	70	1350	4
153+300.000 TO 153+600.000	52	70	1350	4
153+600.000 TO 153+892.180	52	70	450	4
RAMP J-3	49	69	1350	4
RAMP J-4	49	68	4500	4
RAMP K-2				
10+052.874 TO 10+352.500	52	70	1350	4
10+352.500 TO 10+654	52	70	450	4
TOTAL	* 462	* 627	* 13500	* 36

#### CHAIN LINK FENCE SCHEDULE

STATION	то	STATION	CHAIN LINK FENCE 1.2 METER (METER)
MAINLINE			
153+750.100, 14.3M LT	TO	153+827.930, 14.3M LT	121.0
RAMP J-4	T		
10+332.000, 25.3M RT	TO	10+332.580, 3.9M RT	21.4
10+387.110, 25.2M RT	TO	10+387.820, 3.9M RT	21.3
		TOTAL	* 163.7

#### CURB AND GUTTER SCHEDULE

LOCATION	CLASS SI CONC OUTLET (CU M)	CONCRETE GUTTER TYPE A (METER)	CONCRETE GUTTER TYPE A (MODIFIED) (METER)	CONCRETE CURB & GUTTER B-15.45 (METER)
RAMP J-3				J
10+145.073 TO 10+235.516 LT			90.4	
10+250,000 TO 10+275,000 RT			25.0	
STA. 10+275.000 RT	2.7			
RAMP J-4		5-74-5	***************************************	
10+065.000 TO 10+322.209 LT			257.2	
RAMP K-2		<u></u>		
10+052,874 TO 10+085,874				33.0
10+085,874 TO 10+178,600 RT			92.7	
10+344,000 TO 10+378,450 RT			34.4	
10+378.450 TO 10+507.550 RT		139.6		
TOTAL	* 2.7	* 139.6	499.7	33.0

# CONCRETE SHALE CAP SCHEDULE

LOCATION	CLASS SI CONCRETE SPECIAL (CU M)
<b>RAMP J-3</b> STA. 10+175 TO 10+350	154.2
TOTAL	154, 2

ESTIMATED LIMITS WHERE SHALE MAY BE ENCOUNTERED PER GEOTECHNICAL SOILS REPORT

\*NOT A TOTAL QUANTITY (FOR TOTAL QUANTITY ADD

ILLINOIS DEPARTMENT OF TRANSPORTATION SCHEDULE OF QUANTITIES I-74 WB RAMPS J-3 & J-4

DRAWN BY CGF

DATE 12-20-04

# PAVEMENT MARKING SCHEDULE

LOCATION	TYPE		UREA 100MM YELLOW (METER)	POLYUREA LINE 150MM WHITE (METER)	POLYUREA LINE 200MM WHITE (METER)	POLYUREA LINE 300MM WHITE (METER)	RAISED REFLECTIVE PAVEMENT MARKER (EACH)
EASTBOUND							LAGII
MAINLINE 151+620.154 TO 151+850.000	SKIP-DASH			84		<u> </u>	15
1317620, 134 10 1317830, 000	SOLID	230	230	04			10
151+850.000 TO 152+150.000	DOTTED SKIP-DASH			171	30		41
	SOLID	183	300		118		
152+150.000 TO 152+445.837	SKIP-DASH SOLID	296	296	216			36
152+445.837 TO 152+700.000	SKIP-DASH	2 30		132			37
	SOLID		254		163		
152+700.000 TO 153+000.000	SKIP-DASH			150			44
	SOLID DOTTED	57	300		173 16		
153+000.000 TO 153+300.000	SKIP-DASH			93			23
	SOLID DOTTED	295	300		5 40	<del> </del>	
153+300.000 T0 153+600.000	SKIP-DASH			75			35
153+600,000 TO 153+892,180	SOLID SKIP-DASH		300	132	300		30
	SOLID	247	292		45		
	DOTTED				12		
RAMP J-1 10+068,624 TO 10+231,824	SKIP-DASH			58			7.7
10+068,624 10 10+231,824	SOLID			58	163		23
10+231.824 TO 10+255.242	DIAGONALS SOLID				24	68	
10+251.824 10 10+255.242	DIAGONALS					22	
RAMP K-1		<del></del>					
10+068.808 TO 10+161.937	SOLID				93		8
	DIAGONALS					29	
RAMP J-2							
10+242.470 TO 10+248.000	SOLID DIAGONALS				5	7	
10+248.000 TO 10+530.853	SOLID				280		23
	DIAGONALS					100	
WESTBOUND							
MAINLINE 152+150.000 TO 152+445.837	SKIP-DASH			181			37
	SOLID	203	296		90		
152+445.837 TO 152+700.000	SKIP-DASH			143			39
	SOLID	65	254		189		
152+700.000 TO 153+000.000	SKIP-DASH			84			34
153+000.000 TO 153+300.000	SOLID SKIP-DASH	155	300	72	260		23
13370001000 10 13313001000	SOLID	284	300	( 6.	16		
153+300.000 TO 153+600.000	DOTTED SKIP-DASH			138	33	1	39
100 000,000 10 100 000,000	SOLID	246	300		54		
153+600.000 TO 153+892.180	DOTTED SKIP-DASH			117	30		28
	SOLID	257	292		100		
RAMP H-3							
10+000.000 T0 10+161.620	SKIP-DASH SOLID	162		41	90		14
	DIAGONALS	104				24	
RAMP J-4			<b> </b>				
10+065.000 TO 10+345.000	SOLID	280	257		24		2
10+345.000 TO 10+534.716	SOLID	190			190	<u> </u>	16
RAMP K-2 10+052.874 TO 10+352.500	SOLID	300	300				
10+352.500 TO 10+653.500	SOLID	301	301				
10+653.500 TO 10+848.862	SOLID	146	31		164		13
RAMP J-3	COLTS	F. A			p+ A		4 4
10+074.856 TO 10+129.000	SOLID DIAGONALS	54			54	20	14
10+129.000 TO 10+350.000	SKIP-DASH	221	205	9	1.7		
	SOLID DIAGONALS		205		16	16	
RAMP L-4	SOLID	35			35		3
SUBTOTAL	1 20010	4207	5108			<del> </del>	
TOTAL		*931		1896	*2812	286	577
		·					

 		0020	E)	
F.A.I. RTE.	SECTION	COUNTY	TOTAL SHEETS	SHEET NO.
74	(90-11)R-2;90(13,14,14-1)R-1	TAZEWELL	1366	95
STA	. T	O STA.		
FFD. R	DAD DIST. NO. 4 1	I I INOIS FED	ATD PROJ	FCT

\*NOT A TOTAL QUANTITY (FOR TOTAL QUANTITY ADD SIMILAR PAY ITEMS)

URS URS CORPORATION ST. LOUIS, MO

ILLINOIS DEPARTMENT OF TRANSPORTATION

SCHEDULE OF QUANTITIES

I-74 WB

RAMPS J-3 & J-4

RAMPS J-3 & J-4

DATE 12-20-04

CHECKED BY RLS

ET SDATE-A-TIME HERES STIME HERES
N FILE NAME GOES HERE-SIZE IS LARGE ENOUGH FOR LONG FILE NAME

#### 

\*(90-11)R-2;90(13,14,14-1)R-1

#### EARTHWORK SCHEDULE


	1 1	2	3	4	5	6	7	8
LOCATION	TOTAL EXCAVATION (CUT)	SPECIAL EXCAVATION	UNSUITABLE MATERIAL	EARTH EXCAVATION	EXCAVATION TO BE USED IN EMBANKMENT (ADJUSTED FOR SHRINKAGE)	EMBANKMENT (FILL)	EARTHWORK BALANCE WASTE (+) OR FURNISHED EXCAVATION (-)	TOPSOIL FURNISH AND PLACE 100 MM
	(COL 2 + COL 3+ COL 4)				(COL 2 or 4 x 0.75)		(COL 5 - COL 6)	
	CU M	CU M	CU M	CU M	CU M	си м	CU M	SQ M
STAGE 3A-2								
MAIN STREET STA 2+402 TO STA 2+800	2,245	2,245	0	0	1,684	631	1,053	2,607
MAIN STREET STA 2+800 TO STA 4+157	3,786	3,496	290	0	2,622	2,949	-327	8,029
SUBTOTAL	6,031	5,741	290	0	4,306	3,580	726	10,636
STAGE 3A-3								
MAIN STREET STA 2+402 TO STA 2+800	2,886	2,886	0	0	2,165	2,035	130	3,149
MAIN STREET STA 2+800 TO STA 4+157	2,677	2,404	273	0	1,803	5,170	-3,367	9,499
SUBTOTAL	5,563	5,290	273	0	3,968	7,205	-3,237	12,648
STAGE 3A-4								
MAIN STREET STA 2+402 TO STA 2+800	439	439	0	0	329	832	-503	0
MAIN STREET STA 2+800 TO STA 4+157	0	0	0	0	0	19	-19	0
SUBTOTAL	439	439	0	0	329	851	-522	0
STAGE 3B								
EXISTING RAMP 20 & 21 GRADING STA 800+000 TO STA 800+120	713	0	0	713	535	902	-367	3,062
SUBTOTAL	713	0	0	713	535	902	-367	3,062
TOTAL	12,746	11,470	563	713	9,137	12,538	-3400	26,346

EARTH EXCAVATION SHRINKAGE FACTOR = 25%

# CROSS SECTION LEGEND

				***************************************		
DESCRIPTION	QUANTITIES		STAGE 3A-2	STAGE 3A-3	STAGE 3A-4	STAGE 3B
SPECIAL EXCAVATION	11,470 CU M	SPECIAL EXCAVATION	S3A2	S3A3	S3A4	S3B
REMOVAL AND DISPOSAL OF UNSUITABLE MATERIAL	* 563 CU M	UNSUITABLE MATERIAL	U3A2	U3A3	U3A4	U3B
EARTH EXCAVATION	* 713 CU M	EARTH EXCAVATION	E3A2	E3A3	E3A4	E3B
FURNISHED EXCAVATION	3,400 CU M	EMBANKMENT	F3A2	F3A3	F3A4	F3B
TOPSOIL FURNISH AND PLACE, 100 mm	* 26,346 SQ M	TOPSOIL FURNISH AND PLACE	T3A2	T3A3	T3A4	T3B

\* NOT A TOTAL QUANTITY (FOR TOTAL QUANTITY ADD SIMILAR PAY ITEMS)

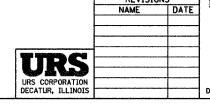

ILLINOIS DEPARTMENT OF TRANSPORTATION
FAI ROUTE 74 ([-74)

SCHEDULE OF QUANTITIES MAIN STREET RAMPS J-3 & J-4

DRAWN BY SRS

Date 12-20-04 Checked by JJM

#### PAVEMENT REMOVAL

LOCATION	(SOM)
	(DEPTH =
	±325mm)
	1323(18)17
MAIN STREET	
STA 2+402.933 TO 2+450.000	1144
STA 2+450.000 TO 2+600.000	3291
STA 0+048 TO 0+109 (RAMP 18)	280
STA 5+130 TO 5+199 (RAMP 19)	261
STA 6+012 TO 6+055 (RAMP 20)	642
STA 7+232 TO 7+281 (RAMP 21)	591
STA 2+600.000 TO 2+750.000	3027
STA 2+750.000 TO 2+800.000	1089
RT STA 2+864.000 TO 2+900.000	17
RT STA 2+900.000 TO 2+930.000	19
SIDEROADS	
ALTORFER ROAD AND FRONTAGE ROAD	1071
NATIONAL STREET	595
CATERPILLAR TRAIL	190
BLACKJACK BLVD (WEST LEG)	611
BLACKJACK BLVD (EAST LEG)	572
	1
TOTAL	* * 13400
	L

LOCATION	(SO M) (DEPTH = ±200mm)
MAIN STREET	
CE RT STA 2+664.751	133
CE RT STA 2+705, 459	87
CE RT STA 2+738.536	45
PE RT STA 3+993.559	67
PE RT STA 4+073.830	84
PE RT STA 4+119.318	36
TOTAL	** 452

#### DRIVEWAY PAVEMENT REMOVAL

LOCATION	(SO M) (DEPTH = ±200mm)
MAIN STREET	
CE RT STA 2+664.751	133
CE RT STA 2+705,459	87
CE RT STA 2+738.536	45
PE RT STA 3+993.559	67
PE RT STA 4+073.830	84
PE RT STA 4+119.318	36
TOTAL	* * 452

#### COUNTY SHEETS NO. TAZEWELL 1366 97 SECTION STA. TO STA. FED. ROAD DIST. NO. | ILLINOIS | FED. AID PROJECT

\* (90-II)R-2;90(I3,I4,I4-I)R-I

# MISCELLANEOUS REMOVAL SCHEDULE

LOCATION	SIDEWALK (SO M)	ISLAND (SO M)	MEDIAN (SOM)	GUARD RAIL (METER)
	(DEPTH = ±100mm)	(DEPTH = ±625mm)	(DEPTH = ±625mm)	
MAIN STREET				
RT STA 2+440, 200 TO 2+450, 000	10			
STA 2+402.933 TO 2+415.933			38	
LT STA 5+130.000 TO 5+138.000 (RAMP 19)			14	
RT STA 7+295.000 TO 7+367.000 (RAMP 21)			55	
STA 2+556.000 TO 2+600.000			108	
RT STA 2+450.000 TO 2+520.000	78			
RT STA 0+109.000 (RAMP 18) TO 2+600.000				119
RT STA 6+099.000 TO 6+123.000 (RAMP 20)				24
STA 2+600.000 TO 2+618.410			48	
LT STA 2+600.000 TO 2+654.000				54
LT STA 2+690.000		22		
RT STA 2+789.000	5			
RT STA 2+852.000	9			
LT STA 2+930,000		14		
RT STA 3+737.000		42		
RT STA 3+750, 300 TO 3+792, 600				4.2
BLACKJACK BLVD				
STA 99+909,000 TO 99+939.000			56	
TOTALS	** 102	* * 78	** 319	* 239

#### PAVED SHOULDER REMOVAL

LOCATION	TYPE	(SO M) (DEPTH = ±250mm)
MAIN STREET		
LT STA 5+130,000 TO 5+191,000 (RAMP 19)	BIT	115
RT STA 0+056.000 TO 0+109.000 (RAMP 18)	BIT	94
LT STA 0+056,000 (RAMP 18) TO 2+600,000	CONC	137
RT STA 2+520,000 TO 6+055,000 (RAMP 20)	BIT	127
RT STA 2+533.000 TO 7+257.000 (RAMP 21)	BIT	182
LT STA 6+055.000 TO 6+123.000 (RAMP 20)	BIT	143
RT STA 7+281.000 (RAMP 21) TO 2+600.000	BIT	95
RT STA 7+281.000 TO 7+367.000 (RAMP 21)	BIT	171
LT STA 2+600.000 TO 2+675.000	CONC	146
RT STA 2+600,000 TO 2+700,000	BIT	289
LT STA 399+965.000(ALTORFER ST) TO 2+750.000	BIT	32
RT STA 2+711,000 TO 2+750,000	BIT	117
LT STA 2+750.000 TO 2+807.000	BIT	84
LT STA 2+807.000 TO 2+900.000	CONC	182
RT STA 2+750.000 TO 2+900.000	BIT	308
LT STA 2+900.000 TO 2+908.000	CONC	23
RT STA 2+900.000 TO 2+938.000	BIT	34
RT STA 2+951,000 TO 3+050,000	BIT	308
LT STA 2+965,000 TO 3+050,000	CONC	122
LT STA 3+050.000 TO 3+200.000	CONC	325
RT STA 3+050,000 T0 3+160,000	BIT	311
RT STA 3+160,000 TO 3+200,000	CONC	94
LT STA 3+200,000 TO 3+350,000	CONC	375
RT STA 3+200,000 TO 3+350,000	CONC	365
LT STA 3+350,000 TO 3+500,000	CONC	364
RT STA 3+350.000 TO 3+500.000	CONC	346
LT STA 3+500,000 TO 3+650,000	CONC	357
RT STA 3+500,000 TO 3+650,000	BIT	391
LT STA 3+650.000 TO 3+693.000	CONC	97
RT STA 3+650.000 TO 3+717.000	BIT	93
LT STA 3+750.000 TO 3+800.000	CONC	73
RT STA 3+752.000 TO 3+800.000	BIT	139
RT STA 100+025.000 TO 100+036.000(BLACKJACK BLVD)	BIT	33
LT STA 100+027.000 TO 100+036.000(BLACKJACK BLVD)	BIT	18
LT STA 3+800.000 TO 3+950.000	CONC	297
RT STA 3+800.000 TO 3+950.000	BIT	438
LT STA 3+950.000 TO 4+100.000 RT STA 3+950.000 TO 4+100.000	CONC	354
STA 4+013,000 TO 4+100,000	BIT	359 117
LT STA 4+100,000 TO 4+157,000	CONC	131
RT STA 4+100,000 TO 4+157,000	BIT	140
STA 4+100.000 TO 4+162.000	BIT	156
518 4:100,000 10 4:102,000		136
TOTAL		* * 8082

#### BITUMINOUS SURFACE REMOVAL

LOCATION	25mm (SO M)	50mm (SQ M)
MAIN STREET		
STA 2+800.000 TO 2+900.000	2108	
STA 2+900,000 TO 3+050,000	3301	
STA 3+050.000 TO 3+200.000	2616	
STA 3+200.000 TO 3+350.000	2385	
STA 3+350.000 TO 3+500.000	2407	
STA 3+500.000 TO 3+650.000	2713	
STA 3+650.000 TO 3+800.000	3468	
STA 3+800,000 TO 3+950,000	2788	
STA 3+950,000 TO 4+100,000	2446	
STA 4+100.000 TO 4+148.000	697	
ALTORFER FRONTAGE ROAD		
STA 9+960.332 TO 9+963.332		21
TOTAL	24929	21

- \* NOT A TOTAL QUANTITY (FOR TOTAL QUANTITY ADD SIMILAR PAY ITEMS)
- \*\* THE REMOVAL QUANTITIES ARE PROVIDED FOR INFORMATIONAL PURPOSES ONLY AND THE REMOVAL ITEMS SHOWN ARE TO BE PAID FOR AS SPECIAL EXCAVATION.

DATE 12-20-04

URS URS CORPORATION DECATUR, ILLINOIS

ILLINOIS DEPARTMENT OF TRANSPORTATION FAI ROUTE 74 (I-74)

SCHEDULE OF QUANTITIES MAIN STREET RAMPS J-3 & J-4

> DRAWN BY SRS CHECKED BY JJM

# CURB AND GUTTER REMOVAL

LOCATION	GUTTER (METER)	COMB CURB & GUTTER (METER)	GUTTER OUTLET (METER)
MAIN STREET			
RT STA 2+440.200 TO 2+444.000		4	
RT STA 2+444,000 TO 2+450,000	6		
RT STA 2+450.000 TO 2+520.000	70		9
LT STA 2+452.800 TO 5+191.000 (RAMP 19)		1.4	***************************************
LT STA 5+130,000 TO 5+189,000 (RAMP 19)		64	
LT STA 0+048.000 TO 0+109.000 (RAMP 18)		66	
LT STA 2+510.000 TO 2+537.000		27	
LT STA 6+022.000 TO 6+055.000 (RAMP 20)		40	
RT STA 7+257.000 TO 7+281.000 (RAMP 21)		25	
LT STA 2+460.000 TO 2+537.000		90	
LT STA 6+055,000 TO 6+123.000 (RAMP 20)		76	
RT STA 7+281.000 TO 7+367.000 (RAMP 21)		80	
LT STA 9+963, 332 (FRONTAGE RD) TO RT 399+938, 180 (ALTORFER RD)	ļ	53	
LT STA 399+938.180 TO 399+949.000 (ALTORFER RD)	ļ	11	·
RT STA 2+771,000 TO 2+814,000	43		
LT STA 2+908.000 TO 199+958.700 (NATIONAL ST)		44	
LT STA 199+958.700 (NATIONAL ST) TO 2+965.000		40	
LT STA 99+874.650 TO 99+909.000 (BLACKJACK BLVD)		35	
RT STA 99+874,650 TO 99+909.000 (BLACKJACK BLVD)	<b></b>	35	
RT STA 99+938.100 TO 99+965.800 (BLACKJACK BLVD)	<b>-</b>	27	
LT STA 99+927.200 (BLACKJACK BLVD) TO 10+030.825 (FRONTAGE RD)		32	
RT STA 10+030,825 (FRONTAGE RD) TO LT 99+965,900 (BLACKJACK BLVD)	-	29	
TOTALS	**119	* * 792	* * 9

		68	201	
F.A.I. RTE.	SECTION	COUNTY	TOTAL SHEETS	SHEET NO.
74	*	TAZEWELL	1366	98
STA.		TO STA.		
FED. ROA	DIST. NO.	ILLINOIS FED.	AID PROJ	ECT


\*(90-II)R-2;90(I3,I4,I4-I)R-I

# TREE REMOVAL

LOCATION	6 TO 15 (UNIT)	OVER 15 (UNIT)	HECTARES (HA)
MAIN STREET			
32.5M RT STA 2+438.5	8		
27.OM LT STA 2+439.0	12		
26.0M LT STA 2+440.5	6		
38. OM LT STA 2+446.5	15		
53.0M LT STA 2+446.5	12		
26. OM LT STA 2+446.5		18	
15. OM LT STA 2+831.5			
21.0M LT STA 2+831.5	14		
15.6M LT STA 2+836.3	8		
18. 2M LT STA 2+837. 4	6		
19. 4M LT STA 2+840.5	8		
14.5M LT STA 2+840.8 14.6M LT STA 2+845.6	10		
14.6M LT STA 2+845.6 21.4M RT STA 2+855.3	6 12		
16. OM LT STA 2+858. 4	14		ļ
21. 2M RT STA 2+862. 2	12		
21. 2M RT STA 2+867. 3	6	<del></del>	
13.8M LT STA 2+869.0	12		
22.5M RT STA 2+873.0	8	* ***	
13. 7M LT STA 2+873. 8		16	
18.3M LT STA 2+874.7	10		
14. OM LT STA 2+876. 8	14		
16. OM LT STA 2+878.2	12		
15.5M LT STA 2+878.6	8		
13.9M LT STA 2+879.3	14		
12.6M LT STA 2+882.9	12		
17.5M LT STA 2+847.3	12		
15.4M LT STA 2+869.4		18	
19.4M LT STA 2+904.6		30	
25.5M LT STA 3+950.3	8		
RT STA 2+991.0 TO 3+050.0			0.007
RT STA 3+050.0 TO 3+122.0			0.021
RT STA 3+220.0 TO 3+275.0			0.024
RT STA 3+381.0 TO 3+424.0			0.026
LT STA 3+858.0 TO 3+950.0			0.085
LT STA 3+950.0 TO 4+007.0		<del></del>	0.046
LT STA 4+048.0 TO 4+100.0			0.038
LI 51A 4+100.0 10 4+106.0			0.005
	· · · · · · · · · · · · · · · · · · ·		
TOTALS	267	* 82	* 0. 3

\* NOT A TOTAL QUANTITY (FOR TOTAL QUANTITY ADD SIMILAR PAY ITEMS)

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ILLINOIS DEPARTMENT OF TRANSPORTATION FAI ROUTE 74 (I-74)

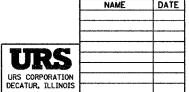SCHEDULE OF QUANTITIES MAIN STREET RAMPS J-3 & J-4

> DRAWN BY SRS CHECKED BY JUM

DATE 12-20-04

\*(90-|i)R-2;90(|3,|4,|4-|)R-| | F.A.I. | SECTION COUNTY TOTAL SHEET SHEETS NO.
TAZEWELL 1366 99 74 STA. TO STA. FED. ROAD DIST. NO. ILLINOIS FED. AID PROJECT

# PAVEMENT MARKING SCHEDULE

MAIN STREET   2+218.898 TO 2+550.000   9M-3M SKIP   (INCLUDING FON DU LAC DRIVE)   15-LT OR RT   TURN LANES   MEDIANS   STOP LINES   DOTTED   DIAGONALS   DOTTED   DIAGONALS   DOTTED   DIAGONALS   DOTTED   DIAGONALS   DOTTED	R RT ARROWS NES SENES SKIP-DASH R RT ARROWS NES LID STORMS LID STORMS LID STORMS LID STORMS	LETTERS AND SYMBOLS (SO M)	UNE 16 (METER)	YELLOW (METER)	LINE 150MM WHITE (METER)	LINE 200MM WHITE (METER)	LINE 30 WHITE (METER)	YELLOW (METER)	LINE 600MM WHITE (METER)	LETTERS AND SYMBOLS (SQ M)	LINE 1 WHITE (METER)	OOMM YELLOW (METER)	LINE 150MM WHITE (METER)	LINE 200MM WHITE (METER)	LINE WHITE (METER)	YELLOW (METER)	LINE 600MM WHITE (METER)
### WAIN STREET  2+218.898 TO 2+550.000	SKIP-DASH R RT ARROWS NES S NES SKIP-DASH R RT ARROWS NES LID S NES	(SO M)	( ME TER )	YELLOW (METER)	WHITE	WHITE (METER)	WHITE (METER)	YELLOW (METER)	WHITE (METER)	SYMBOLS (SQ M)	WHITE (METER)	YELLOW (METER)	WHITE	WHITE (METER)	WHITE (METER)	YELLOW (METER)	WHITE (METER)
TURN LANES   MEDIANS   STOP LINES   DOTTED	R RT ARROWS NES SENES SKIP-DASH R RT ARROWS NES LID STORMS LID STORMS LID STORMS LID STORMS	1. 47															
TURN LANES   MEDIANS   STOP LINES   DOTTED	R RT ARROWS NES SENES SKIP-DASH R RT ARROWS NES LID STORMS LID STORMS LID STORMS LID STORMS	1, 47						1					I				<del>                                     </del>
TURN LANES   MEDIANS   STOP LINES   DOTTED	ANES  SKIP-DASH R RT ARROWS NES  ID S NES ALS	1.47	20							22.05			216				
## MEDIANS   STOP LINES	SKIP-DASH R RT ARROWS NNES ID S INES	1.47	20				<del></del>			22.05				338			<del></del>
2+550, 000 TO 2+900, 000	KIP-DASH R RT ARROWS NNES ID S NNES ALS	1.47	20									338		999			
2+550, 000 TO 2+900, 000	KIP-DASH R RT ARROWS NNES ID S NNES ALS	1.47	20						5								75
TURN LANES   SOLID   DBL SOLID   DBL SOLID   DBL SOLID   MEDIANS   STOP LINES   DIAGONALS   DOTTED   ISLANDS   STOP LINES   DIAGONALS   DOTTED   ISLANDS   STOP LINES   DIAGONALS   DOTTED   TURN LANES   MEDIANS   STOP LINES   DIAGONALS   DOTTED   DOTT	ID 5 INES ALS	1. 47	30		108	ļ					18		228	8			<b> </b>
TURN LANES   SOLID   DBL SOLID   DBL SOLID   DBL SOLID   MEDIANS   STOP LINES   DIAGONALS   DOTTED   ISLANDS   STOP LINES   DIAGONALS   DOTTED   ISLANDS   STOP LINES   DIAGONALS   DOTTED   TURN LANES   MEDIANS   STOP LINES   DIAGONALS   DOTTED   DOTT	ID 5 INES ALS		20		100					8, 82							(
MEDIANS   STOP LINES   DIAGONALS   DOTTED	S INES ALS													114			
MEDIANS   STOP LINES   DIAGONALS   DOTTED	S INES ALS											278					<b> </b>
STOP LINES	INES ALS		ļ	400		<b> </b>		ļ		<b></b>		332					<b></b>
ISLANDS	5	1	<u> </u>	1		<u> </u>											18
ISLANDS	5							70								46	
2+900. 000 TO 3+250.000 (INCLUDING NATIONAL STREET) (INCLUDING NATIONAL STREET)  4-LT OR RT TURN LANES MEDIANS STOP LINES DIAGONALS AF600.000 TO 3+600.000  3+250.000 TO 3+600.000  3+600.000 TO 3+950.000  3+600.000 TO 3+950.000  3+600.000 TO 3+950.000  3+600.000 TO 3+950.000  4-LT OR RT TURN LANES DBL SOLID MEDIAN STOP LINES CROSSWALK DIAGONALS DOTTED  3+950.000 TO 4+157.000  BLACKJACK BOULEVARD (WEST LEG) (INCLUDING FRONTAGE ROAD)  BLACKJACK BOLEVARD (WEST LEG) DBL SOLID MEDIAN DIAGONALS DBL SOLID MEDIAN DIAGONALS STOP LINES DBL SOLID MEDIAN DIAGONALS STOP LINES DBL SOLID MEDIAN DIAGONALS STOP LINES STOP LINES DBL SOLID	KIP-DASH	ļ									64			12	35		<del></del>
TURN LANES   MEDIANS   STOP LINES   DIAGONALS   DOTTED		-	6	ļ	342	1					04				33		l
TURN LANES   MEDIANS   STOP LINES   DIAGONALS   DOTTED	R RT ARROWS	5. 88			312	ļ											
STOP LINES	NES					85											
3+250,000 TO 3+600,000  9M-3M SKIP 1-TURN ARR TURN LANES MEDIAN DBL SOLID DIAGONALS 3+600,000 TO 3+950,000  9M-3M SKIP 13-LT OR R TURN LANES DBL SOLID MEDIAN STOP LINES CROSSWALK DIAGONALS DOTTED 3+950,000 TO 4+157,000  9M-3M SKIP MEDIAN DIAGONALS DOTTED  9M-3M SKIP MEDIAN DIAGONALS TURN LANES CROSSWALK DIAGONALS DOTTED  9M-3M SKIP MEDIAN DIAGONALS TURN LANES DBL SOLID MEDIAN DIAGONALS STOP LINES DBL SOLID MEDIAN DIAGONALS TURN LANES DBL SOLID MEDIAN DIAGONALS STOP LINES DOTTED	INIC			1250		ļ											<b></b>
3+250,000 TO 3+600,000	II S							91									l
3+250,000 TO 3+600,000  9M-3M SKIP 1-TURN ARR TURN LANES MEDIAN DBL SOLID DIAGONALS 3+600,000 TO 3+950,000  9M-3M SKIP 13-LT OR R TURN LANES DBL SOLID MEDIAN STOP LINES CROSSWALK DIAGONALS DOTTED 3+950,000 TO 4+157,000  9M-3M SKIP MEDIAN DIAGONALS DOTTED  9M-3M SKIP MEDIAN DIAGONALS TURN LANES CROSSWALK DIAGONALS DOTTED  9M-3M SKIP MEDIAN DIAGONALS TURN LANES DBL SOLID MEDIAN DIAGONALS STOP LINES DBL SOLID MEDIAN DIAGONALS TURN LANES DBL SOLID MEDIAN DIAGONALS STOP LINES DOTTED						8											
TURN LANES   MEDIAN   DBL SOLID   DIAGONALS   STOP LINES   CROSSWALK   DIAGONALS   DOTTED   DIAGONALS   DOTTED   DOTTED   DEL SOLID   DIAGONALS   DOTTED   DOTTED   DIAGONALS   DOTTED   DIAGONALS	SKIP-DASH				348											VA. 1	
MEDIAN   DBL SOLID   DTAGONALS   DBL SOLID   DTAGONALS   DBL SOLID   DTAGONALS   DBL SOLID   DTAGONALS   DBL SOLID   DBL SOLID   MEDIAN   STOP LINES   CROSSWALK   DTAGONALS   DOTTED   DAGONALS   DOTTED   MEDIAN   DTAGONALS   DTAGONALS   DTAGONALS   DTAGONALS   DTAGONALS   DTAGONALS   DTAGONALS   DTAGONALS   DTAGONALS   DBL SOLID   MEDIAN   DTAGONALS   DBL SOLID   MEDIAN   DBL SOLID   MEDIAN   DBL SOLID   MEDIAN   DTAGONALS   STOP LINES   DOTTED	ARROW	1.47		ļ		1.5									***************************************		<b></b>
DBL SOLID			<b> </b>	1341		15											<del>                                     </del>
DIAGONALS   9M-3M SKIP   13-LT OR R   TURN LANES   DBL SOLID   MEDIAN   STOP LINES   CROSSWALK   DIAGONALS   DOTTED   MEDIAN   DIAGONALS   DOTTED   MEDIAN   DIAGONALS   DBL SOLID   MEDIAN   DBL SOLID   MEDIAN   DIAGONALS   DBL SOLID   MEDIAN   DIAGONALS   STOP LINES   DOTTED   DO	ID			30													f
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TURN LANES DBL SOLID MEDIAN STOP LINES CROSSWALK DIAGONALS 3+950.000 TO 4+157.000  BLACKJACK BOULEVARD (WEST LEG) (INCLUDING FRONTAGE ROAD)  MEDIAN TURN LANES DBL SOLID MEDIAN DIAGONALS  DBL SOLID MEDIAN DIAGONALS STOP LINES DOTTED	SKIP-DASH	10 11			312												<b> </b>
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MEDIAN STOP LINES CROSSWALK DIAGONALS DOTTED  3+950.000 TO 4+157.000  BLACKJACK BOULEVARD (WEST LEG) (INCLUDING FRONTAGE ROAD)  MEDIAN DIAGONALS  BLACKJACK BOULEVARD (WEST LEG)  MEDIAN TURN LANES DBL SOLID MEDIAN DIAGONALS STOP LINES DOTTED	ID			316		† <u></u>											
CROSSWALK DIAGONALS DOTTED 3+950.000 TO 4+157.000  BLACKJACK BOULEVARD (WEST LEG) (INCLUDING FRONTAGE ROAD)  (INCLUDING FRONTAGE ROAD)  BLACKJACK BOULEVARD (WEST LEG)  OBL SOLID MEDIAN DIAGONALS  STOP LINES DOTTED				652													
BLACKJACK BOULEVARD (WEST LEG)  (INCLUDING FRONTAGE ROAD)  MEDIAN  OTAGONALS  BLACKJACK BOULEVARD (WEST LEG)  MEDIAN  OTAGONALS  BLACKJACK BOULEVARD (WEST LEG)  MEDIAN  DBL SOLID  MEDIAN  DIAGONALS  STOP LINES  DOTTED	INES					L			38								<b></b>
3+950.000 TO 4+157.000  3+950.000 TO 4+157.000  BLACKJACK BOULEVARD (WEST LEG)  (INCLUDING FRONTAGE ROAD)  (INCLUDING FRONTAGE ROAD)  (INCLUDING FRONTAGE ROAD)  DBL SOLID  MEDIAN  DIAGONALS  STOP LINES  DOTTED	ALK NIS		ļ	<b>}</b>		80		90									<del> </del>
3+950.000 TO 4+157.000  BLACKJACK BOULEVARD (WEST LEG)  (INCLUDING FRONTAGE ROAD)				1		6	· · · · · · · · · · · · · · · · · · ·	1 30									·
BLACKJACK BOULEVARD (WEST LEG)  (INCLUDING FRONTAGE ROAD)	SKIP-DASH				120												
BLACK JACK BOULEVARD (WEST LEG)  (INCLUDING FRONTAGE ROAD)				828													<b></b>
DBL SOLID MEDIAN DIAGONALS STOP LINES DOTTED	1F2							144									<b></b>
DBL SOLID MEDIAN DIAGONALS STOP LINES DOTTED	SKIP-DASH		6		33	<del> </del>											f
DBL SOLID MEDIAN DIAGONALS STOP LINES DOTTED	RT ARROWS	8, 82	, in the second	1		<b>†</b>											
STOP LINES DOTTED	ANES					150											<b></b>
STOP LINES DOTTED	_10			152 288		<b>[</b>											<del> </del>
STOP LINES DOTTED	ALS			200				16									l
DOTTED	INES							1	22				***************************************				
						6										-	<b></b>
BLACKJACK BOULEVARD (EAST LEG) 4-LT OR RE	R RT ARROWS	5.88		<b>-</b>		66	12										
TURN LANES	ANES	J. 00		<u> </u>		34				<del> </del>							f
MEDIAN DIAGONALS				80													
DIAGONALS	A I C							9	10								ļ
STOP LINES DOTTED	TNEC	-	<b> </b>	1		7		<b> </b>	12	<del>                                     </del>							l
ISLAND	INES		1	1		20	7		· · · · · · · · · · · · · · · · · · ·	<b> </b>							
	INES					1											
RAMP J-3 2-LT OR R	INES									2.94							
TOTALS	R RT ARROWS	42.63	41	5337	1263	785	19	539	85	33. 81	82	948	444	472	35	46	93

# PAVEMENT MARKING SCHEDULE

			POLYUREA	- TYPE I	
		LINE	1 00MM	LINE 200MM	L I NE 600MM
LOCATION	ТҮРЕ	WHITE (METER)	YELLOW (METER)	WHITE (METER)	WHITE (METER)
RAMP J-3	SOLID			15	
STA. 10+350 TO MAIN ST.	STOP LINES				11
	EDGE LINES	5	15		
RAMP J-4	EDGE LINES	15	49	<b></b>	
MAIN ST. TO STA. 10+065					
TOTALS		20	64	*15	11
		*8	4		

\* NOT A TOTAL QUANTITY (FOR TOTAL QUANTITY ADD SIMILAR PAY ITEMS)

NAME	DATE	F
		SCHE
		F
		<b>DATE</b> 12-20-04
	NAME	NAME DATE

REVISIONS ILLINOIS DEPARTMENT OF TRANSPORTATION FAI ROUTE 74 (I-74)

SCHEDULE OF QUANTITIES MAIN STREET RAMPS J-3 & J-4

> DRAWN BY SRS CHECKED BY JUM

 F.A.I. RTE.	SECTION	COUNTY	TOTAL	
74	*	TAZEWELL	1366	100
STA.		TO STA.		
FED. RO	AD DIST. NO.	ILLINOIS FED.	AID PROJ	ECT

\* (90-II)R-2;90(I3,I4,I4-I)R-I

# R.O.W. MARKERS

	LOCATION	EACH
MAIN STREET		
26.691M LT.	STA. 2+682.586	1
40.616M LT.	STA. 2+682.692	1
50.594M LT.	STA. 2+694.207	1
62.393M LT.	STA. 2+694.592	1
62.232M LT.	STA. 2+706.618	1
25.230M LT.	STA. 2+714.012	1
27.450M LT.	STA. 2+920.235	1
41.338M LT.	STA. 2+931.808	1
41.228M LT.	STA. 2+944.862	1
27.450M LT.	STA. 2+955.440	1
	TOTAL	10

# DUST CONTROL SCHEDULE

LOCATION	STREET SWEEPING (HOUR)	APPLY DUST SUPPRESSION AGENTS (UNIT)	SOIL STABILIZERS (KG)	DUST CONTROL PADS (EACH)
MAIN STREET				·····
2+300 TO 2+450,000	7	12	405	1
2+450,000 TO 2+600,000	23	108	3330	2
2+600.000 TO 2+750.000	24	26	1449	2
2+750,000 TO 2+900,000	23	45	2676	2
2+900,000 TO 3+050,000	24	33	1512	2
3+050.000 TO 3+200.000	23	52	2757	2
3+200.000 TO 3+350.000	24	48	2568	2
3+350,000 TO 3+500.000	23	43	1727	2
3+500.000 TO 3+650.000	24	30	1767	2
3+650,000 TO 3+800.000	23	37	1952	2
3+800.000 TO 3+950.000	24	33	1904	2
3+950.000 TO 4+100.000	23	20	925	2
4+100.000 TO 4+157.000	9	5	211	1
BLACKJACK BOULEVARD	31	6	135	2
TOTALS	* 305	* 498	* 23318	* 26

# PERMANENT SURVEY MARKERS

LOCATION	TYPE 1 (EACH)
MAIN STREET	
PI STA 2+579.299	1
POT STA 2+900.000	1
POT STA 3+200.000	1
POT STA 3+500.000	1
POT STA 3+800.000	1
PC STA 4+038.852	1
PI STA 4+095.543	1
PT STA 4+152, 181	111
TOTAL	* 8

# BUTT JOINT SCHEDULE

LOCATION	PCC SURF REMOVAL (SQ M)	BIT SURF REMOVAL (SQ M)	TEMP RAMP (SO M)
MAIN STREET			
LT STA 4+157.000		66	11
RT STA 4+157.000		67	11
BLACKJACK BLVD			
LT STA 99+885.450	66		1.1
RT STA 99+885.450	71		1.2
FRONTAGE ROAD AT BLACKJACK BLVD			l
STA 10+030.825		69	13
TOTALS	137	202	58

\* NOT A TOTAL QUANTITY (FOR TOTAL QUANTITY ADD SIMILAR PAY ITEMS)

REVISIONS
NAME DATE

URS
URS CORPORATION
DECATUR, ILLINOIS

ILLINOIS DEPARTMENT OF TRANSPORTATION FAI ROUTE 74 (I-74)

> SCHEDULE OF QUANTITIES MAIN STREET RAMPS J-3 & J-4

**DATE** 12-20-04

DRAWN BY SRS CHECKED BY JJM