


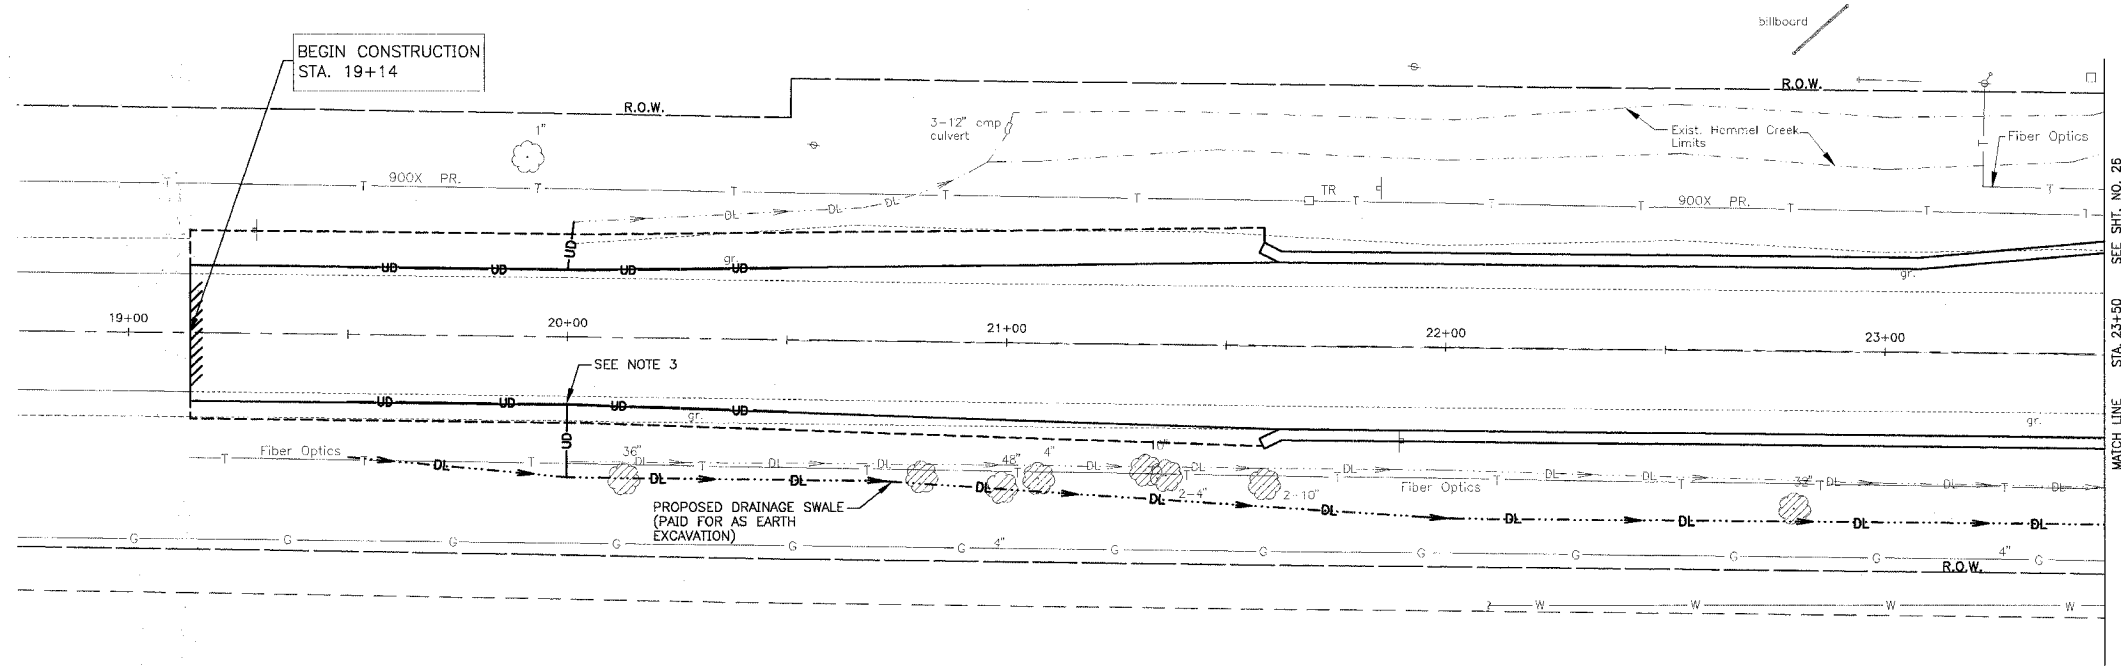


SCALE: 1" = 20'



- NOTE:
- SEE SHT. 15 FOR GEOMETRIC INFORMATION.
 - DATUM CORRELATION: BAXTER & WOODMAN, INC. SURVEY DATA SHOULD BE ADJUSTED BY -0.12' TO MATCH FEMA REFERENCE MARK DATUM.
 - PLACE PIPE UNDERDRAINS IN 25-FOOT LINEAL SECTIONS AT A DEPTH OF 30-INCHES IN ALL ROADWAY LOW SPOTS.

U.S. RTE. 52

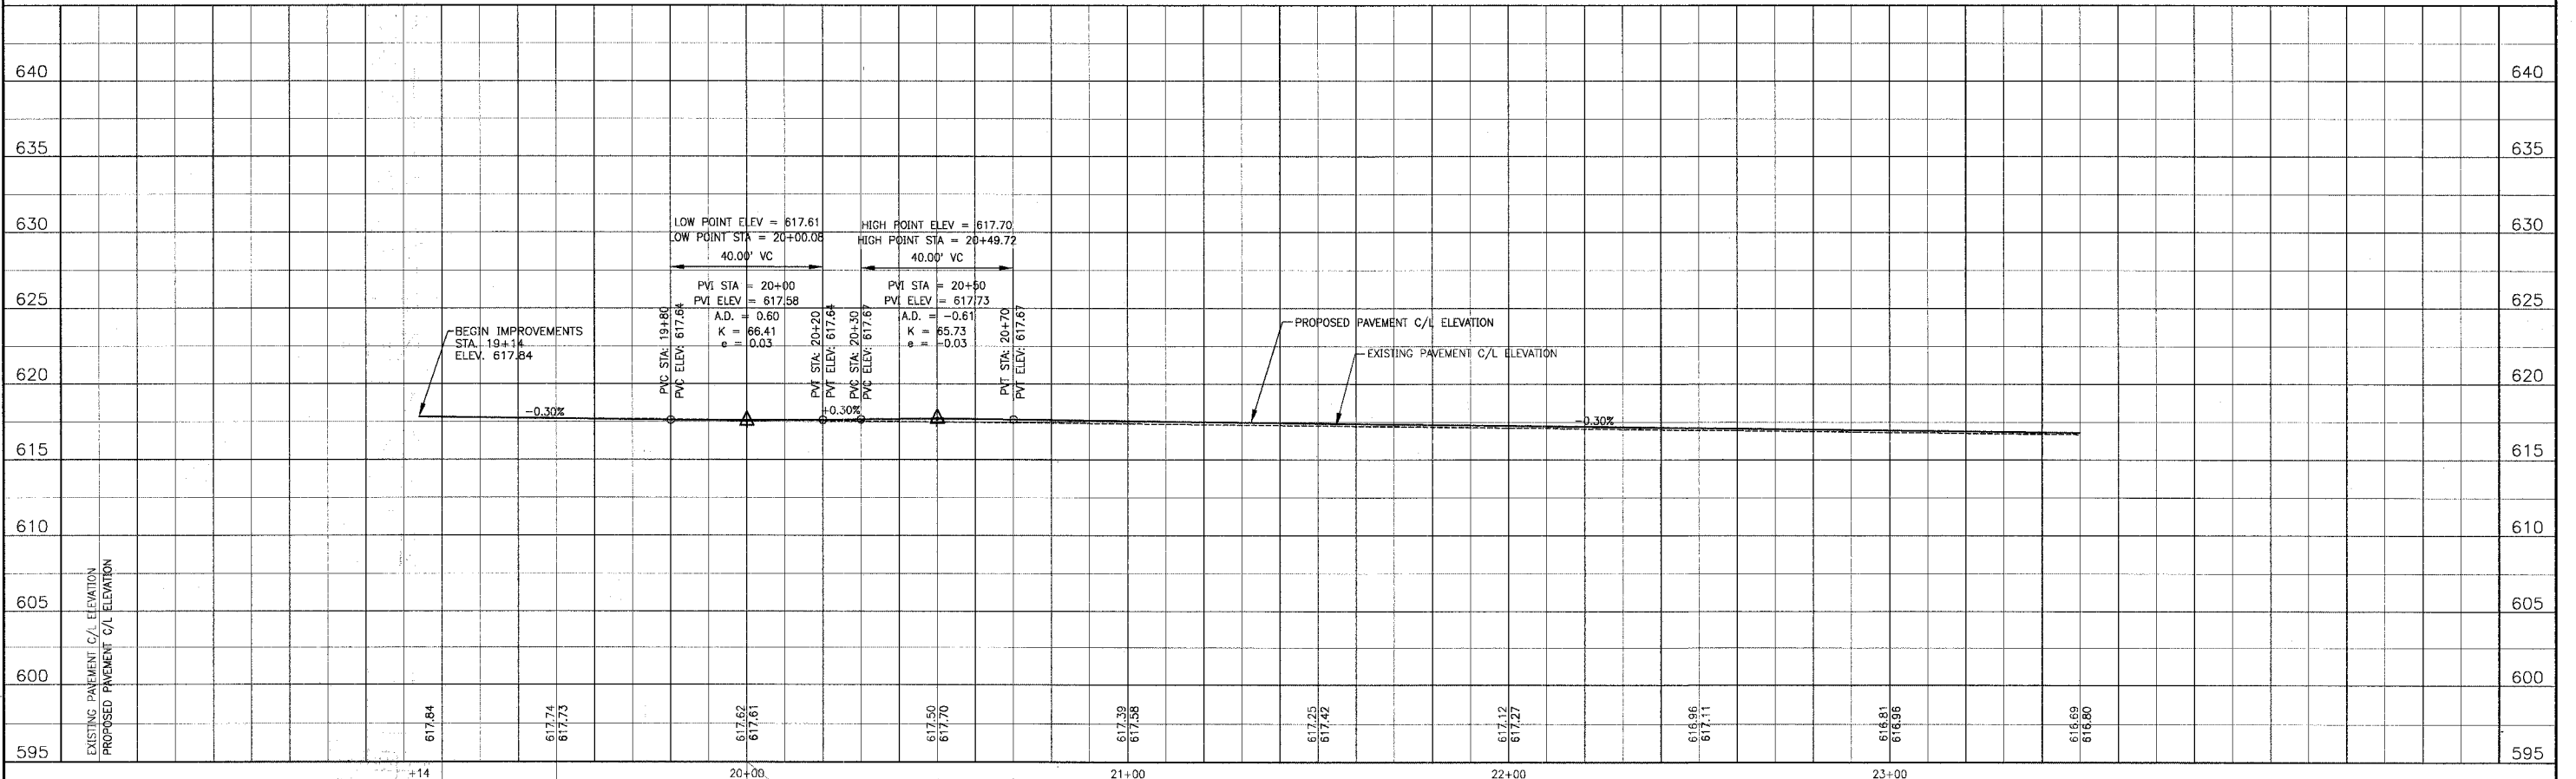

I:\SHRWD\010665\DWG\10665-10665-PRF.dwg
 Plotted: 1-04-05 @ 10:52am By: 231Lkb
 Copyright © 2004, By Baxter & Woodman, Inc.
 State of Illinois - Professional Design Firm
 License No. - 184-001121 - Expires 4-30-05

REV. NO.	DATE	DESCRIPTION
1	12-21-04	PER I.D.O.T. REVIEW

CONSULTANTS: BAXTER & WOODMAN

DRAWING FILE: [] PLOTTED BY: []

BAXTER & WOODMAN
 Consulting Engineers

Baxter & Woodman
 Crystal Lake, Illinois 815.459.1260
 Burlington, Wisconsin 262.763.7834
 Mokena, Illinois 708.478.2090
 DeKalb, Illinois 815.787.3111
 Craylake, Illinois 847.223.5088
 Rockford, Illinois 815.489.1651

VILLAGE OF SHOREWOOD, ILLINOIS
U.S. ROUTE 52 IMPROVEMENTS

U.S. ROUTE 52
STA. 19+00 TO STA. 23+50
DRAINAGE & UTILITY PLAN

DESIGNED BY LDH	SCALE VERT: 1"=5'
DRAWN BY UKB	HORIZ: 1"=20'
CHECKED BY LDH	PROJECT NO. 010665
DATE 10-05-04	SHEET NO. 25 OF 85