




PLAN	DATE
BY	
CHECKED	
DESIGNED	
NOTED	
ALIGNED	
ASSEMBLED	
FILED	
NO.	

PROFILE	DATE
BY	
CHECKED	
DESIGNED	
NOTED	
ALIGNED	
ASSEMBLED	
FILED	
NO.	

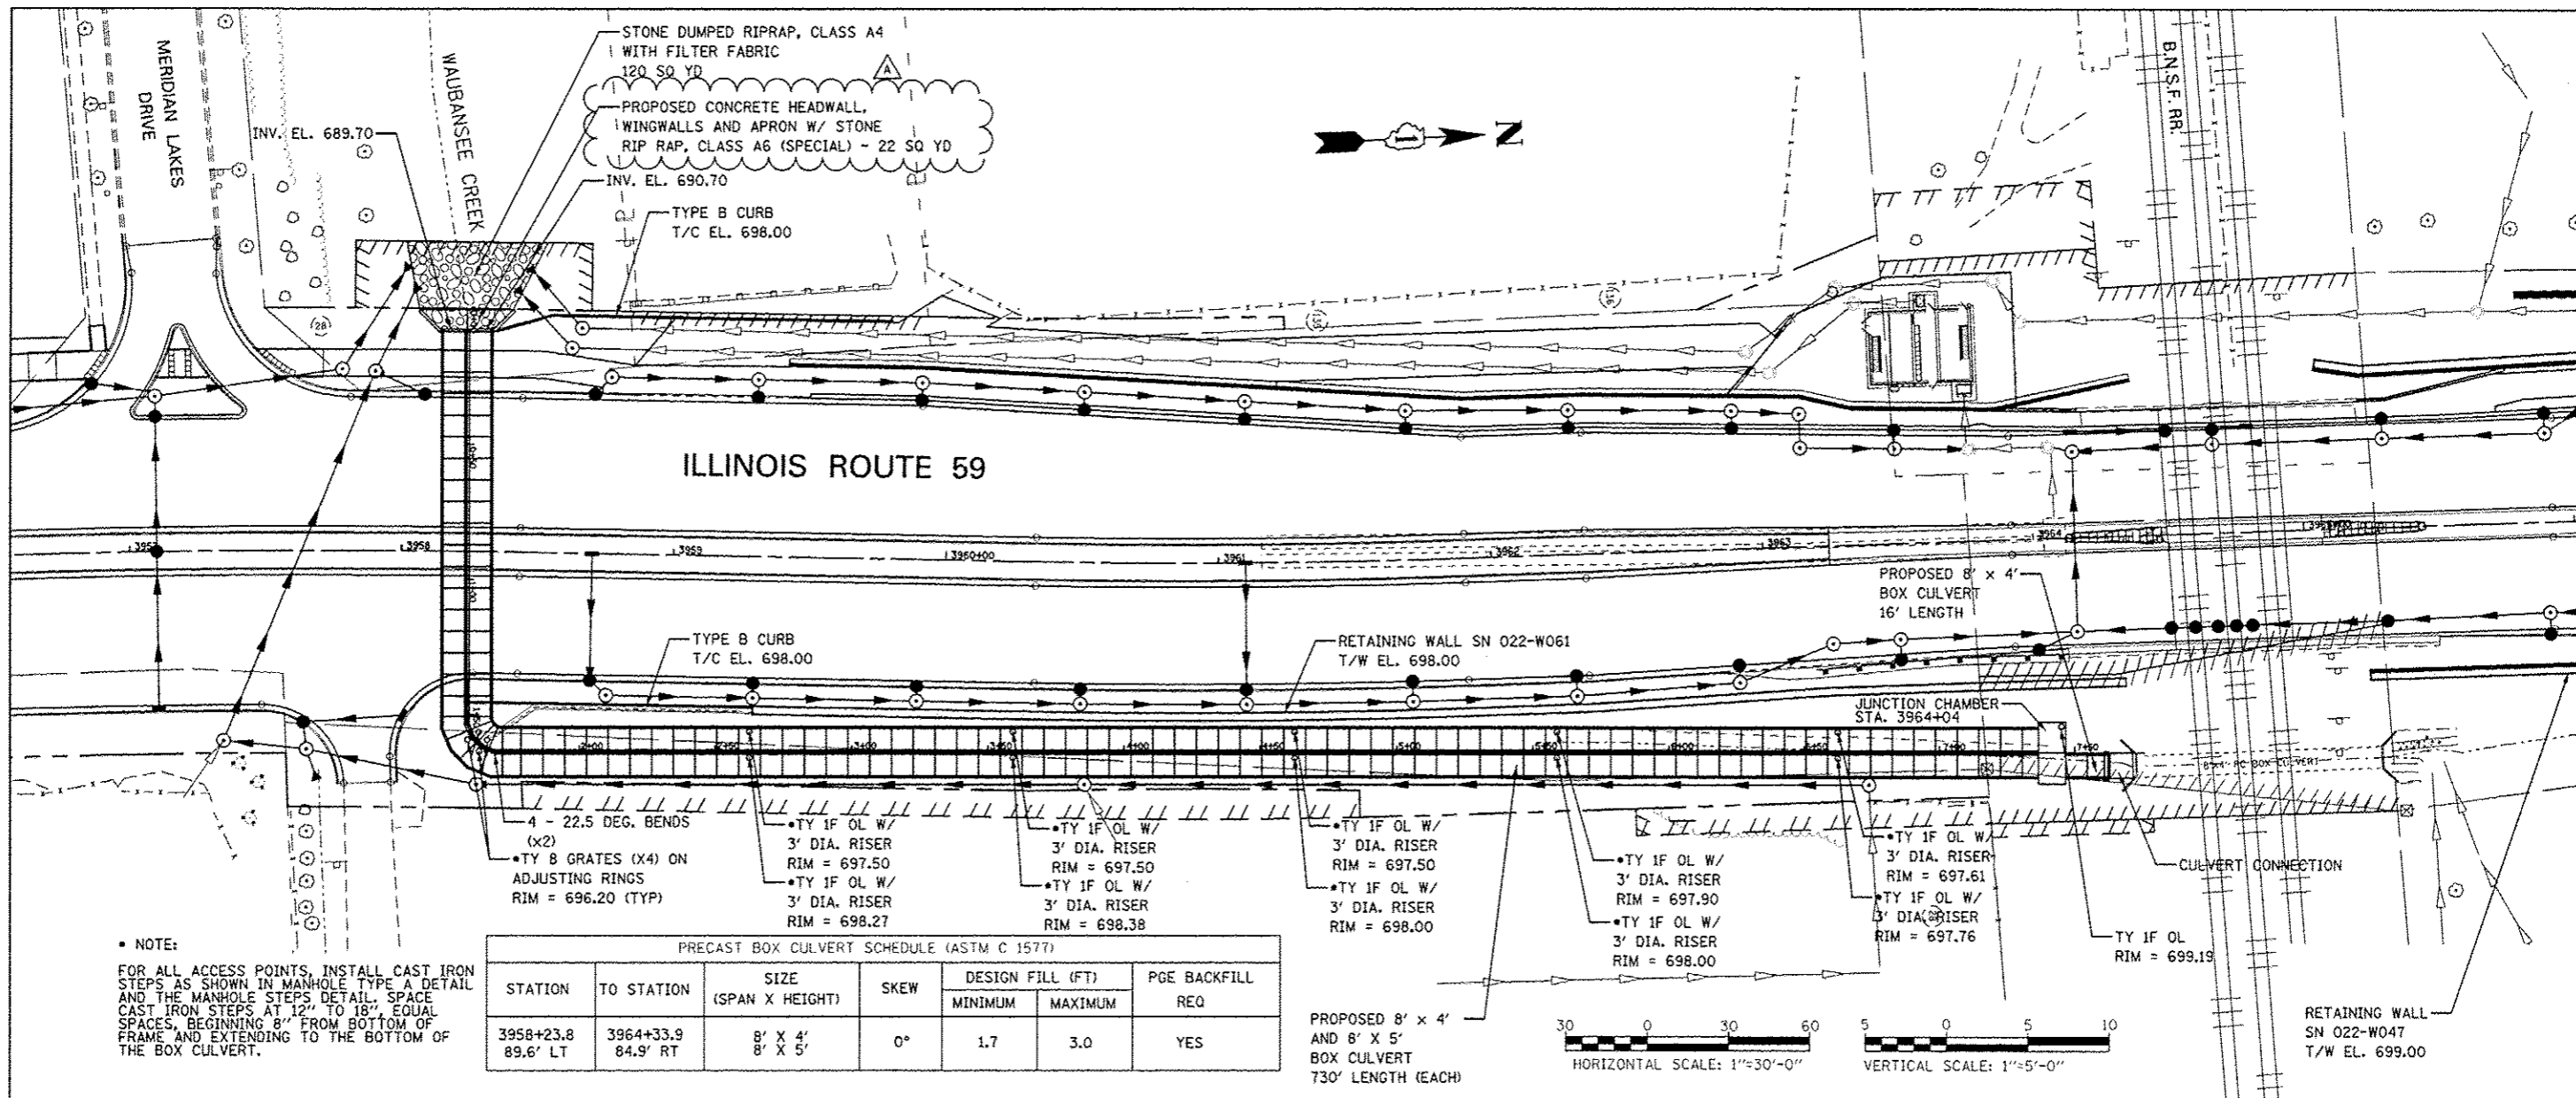

PRECAST BOX CULVERT SCHEDULE (ASTM C 1577)

STATION	TO STATION	SIZE (SPAN X HEIGHT)	SKEW	DESIGN FILL (FT)		PGE BACKFILL REQ
				MINIMUM	MAXIMUM	
3958+23.8 89.6' LT	3964+33.9 84.9' RT	8' X 4' 8' X 5'	0°	1.7	3.0	YES

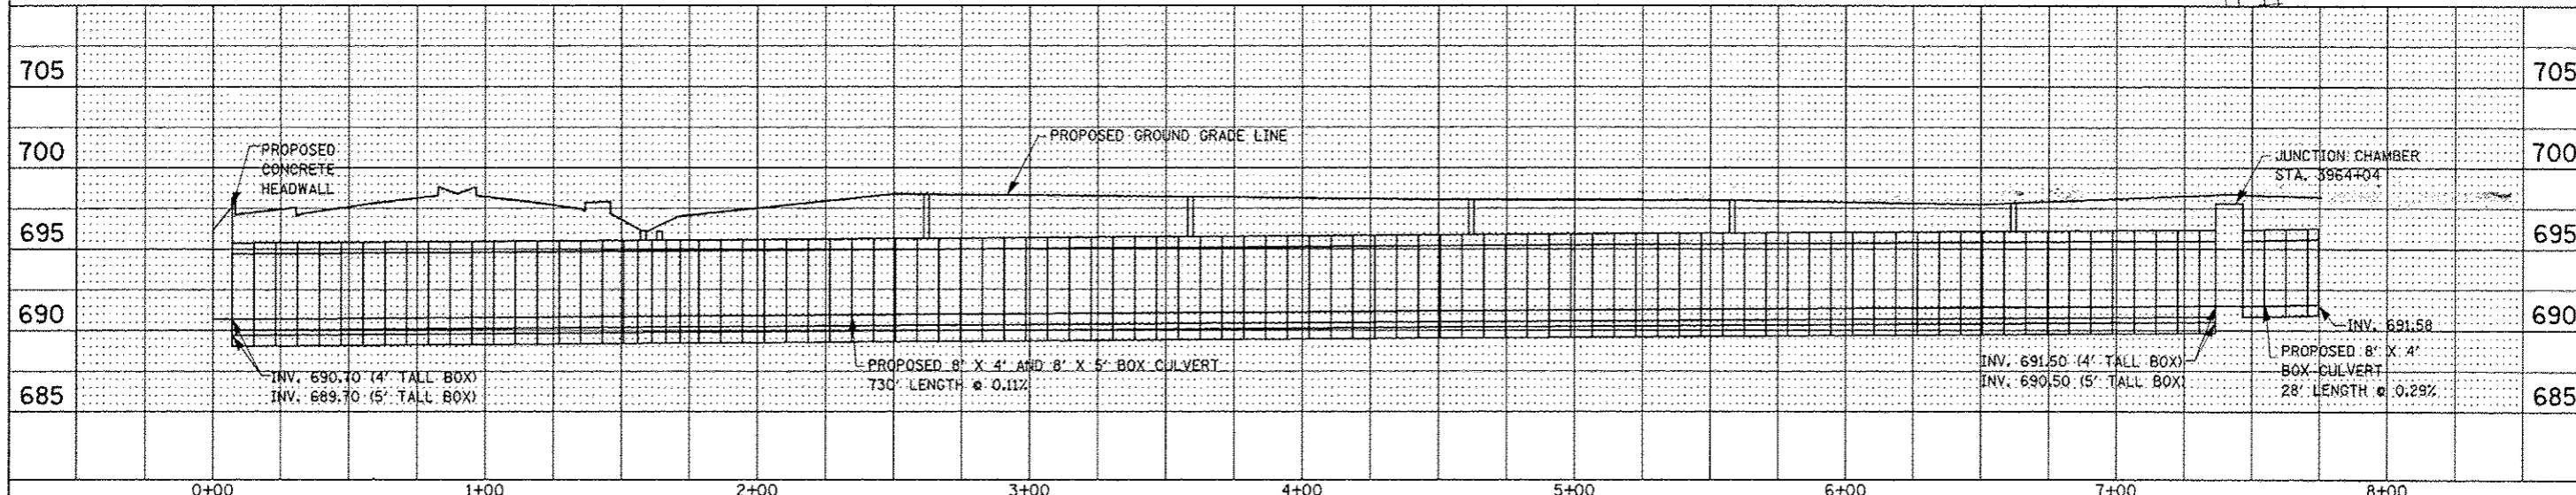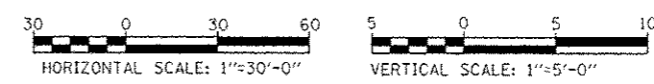

DESIGNED	PJO	REVISED	-ADDENDUM A 02/20/2013
DRAWN	KES	REVISED	-
CHECKED	JCM	REVISED	-
DATE	12/14/2012	REVISED	-

STATE OF ILLINOIS  
 DEPARTMENT OF TRANSPORTATION

PROPOSED DRAINAGE PLAN & PROFILE  
 WAUBANSEE CREEK - DOUBLE BOX CULVERT (SN:0220010)  
 SCALE: AS SHOWN SHEET NO. 25 OF 25 SHEETS STA. TO STA.

F.A.P. RTE.	SECTION	COUNTY	TOTAL SHEET NO.
338	(112 & 113) WRS-7	DUPAGE	1156 491
DP-16		CONTRACT NO. 60R30	
FED. ROAD DIST. NO. ILLINOIS FED. AID PROJECT			