CO062 TOTAL SHEETS = 69

## 100% SUBMITTAL CONSTRUCTION PLANS

# REMOVE AND REPLACE ALL TAXI GUIDANCE SIGNS ON THE AIRPORT


COLES COUNTY MEMORIAL AIRPORT (MTO)
MATTOON-CHARLESTON, COLES COUNTY, ILLINOIS

IDA PROJECT NO. MTO-4511 SBG PROJECT NO. 3-17-SBGP-XX


#### SCOPE OF WORK:

THIS PROJECT SHALL CONSIST OF THE REMOVAL AND REPLACEMENT OF THE TAXI GUIDANCE SIGNS ON THE AIRFIELD AND THE ASSOCIATED DUCTS, CABLING AND VAULT WORK.

COLES COUNTY -MEMORIAL AIRPORT

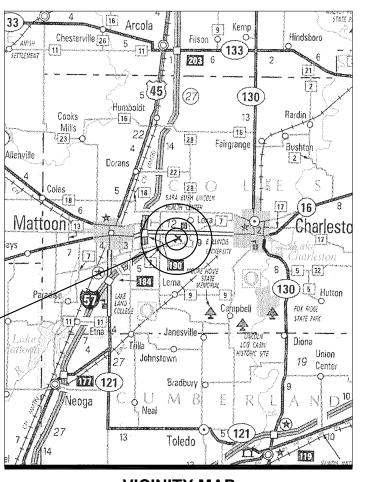

**VICINITY MAP** 

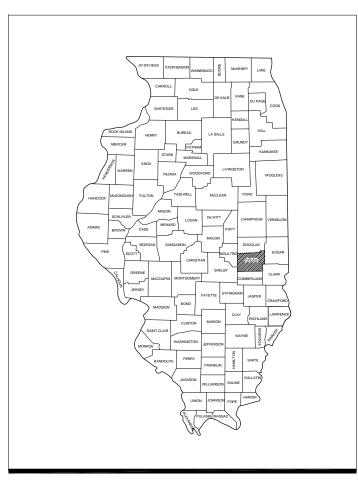

**LOCATION MAP** 

#### NOTICE TO CONTRACTORS AND BIDDERS

THESE CONSTRUCTION PLANS RELY UPON THE SPECIAL PROVISIONS AND THE SPECIFICATIONS TO PROVIDE FOR A COMPLETE DESCRIPTION OF THE WORK AND CONSTRUCTION REQUIREMENTS. THE PLANS SHALL ONLY BE USED IN COMBINATION WITH ALL CONTRACT DOCUMENTS.

No.	Issue/Description	Sheets Changed	Date	Ву





COLES COUNTY MEMORIAL AIRPORT
432 Airport Road
Mattoon, Illinois 61938
Telephone: 217.234.7120
Fax: 217.234.7116

Andrew J. Fearn
Airport Manager

	SUMMARY OF QUANTITIES						
ITEM NO.	DESCRIPTION	UNIT	TOTAL QUANTITY	AS-BUILT QUANTITY			
AR108158	1/C #8 5 KV UG CABLE IN UD	L.F.	14,778				
AR109200	INSTALL ELECTRICAL EQUIPMENT	L.S.	1				
AR109902	REMOVE ELECTRICAL EQUIPMENT	L.S.	1				
AR110013	3" DIRECTIONAL BORE	L. F.	1,175				
AR125442	TAXI GUIDANCE SIGN, 2 CHARACTER	EACH	4				
AR125443	TAXI GUIDANCE SIGN, 3 CHARACTER	EACH	16				
AR125444	TAXI GUIDANCE SIGN, 4 CHARACTER	EACH	6				
AR125445	TAXI GUIDANCE SIGN, 5 CHARACTER	EACH	4				
AR125446	TAXI GUIDANCE SIGN, 6 CHARACTER	EACH	22				
AR125447	TAXI GUIDANCE SIGN, 7 CHARACTER	EACH	3				
AR125448	TAXI GUIDANCE SIGN, 8 CHARACTER	EACH	1				
AR125565	SPLICE CAN	EACH	4				
AR125904	REMOVE TAXI GUIDANCE SIGN	EACH	58				
AR150510	ENGINEER'S FIELD OFFICE	L.S.	1				
AR150520	MOBILIZATION	L.S.	1				
AR620520	PAVEMENT MARKING-WATERBORNE	S. F.	345				
AR620525	PAVEMENT MARKING-BLACK BORDER	S. F.	575				
AR800493	TAXI SIGN, 5 CHARACTER, UNLIGHTED	EACH	2				
AR800497	CONSTRUCTION SAFETY AND PHASING	L.S.	1				

	INDEX TO SHEETS				
SHEET NO.	DESCRIPTION				
1	COVER SHEET				
3	SUMMARY OF QUANTITIES AND INDEX TO SHEETS PROPOSED SAFETY PLAN				
4	PROPOSED SAFETY PLAN NOTES				
5	PROPOSED SAFETY AND PHASING PLAN WORK AREA 1				
6	PROPOSED SAFETY AND PHASING PLAN WORK AREA 2				
7	PROPOSED SAFETY AND PHASING PLAN WORK AREA 3				
8 9	PROPOSED SAFETY AND PHASING PLAN WORK AREA 4 PROPOSED SAFETY AND PHASING PLAN WORK AREA 5				
10	PROPOSED SAFETY AND PHASING PLAN WORK AREA 6				
11	KEY PLAN				
12	EXISTING TAXI GUIDANCE SIGN PLAN SHEET 1				
13 14	EXISTING TAXI GUIDANCE SIGN PLAN SHEET 2  EXISTING TAXI GUIDANCE SIGN PLAN SHEET 3				
15	EXISTING TAXI GUIDANCE SIGN PLAN SHEET 4				
16	EXISTING TAXI GUIDANCE SIGN PLAN SHEET 5				
17	EXISTING TAXI GUIDANCE SIGN PLAN SHEET 6				
18 19	EXISTING TAXI GUIDANCE SIGN PLAN SHEET 7  EXISTING TAXI GUIDANCE SIGN PLAN SHEET 8				
20	EXISTING TAXI GUIDANCE SIGN PLAN SHEET 9				
21	EXISTING TAXI GUIDANCE SIGN PLAN SHEET 10				
22	EXISTING TAXI GUIDANCE SIGN PLAN SHEET 11				
23	EXISTING TAXI GUIDANCE SIGN PLAN SHEET 12  EXISTING TAXI GUIDANCE SIGN PLAN SHEET 13				
25	EXISTING TAXI GUIDANCE SIGN PLAN SHEET 13  EXISTING TAXI GUIDANCE SIGN PLAN SHEET 14				
26	EXISTING TAXI GUIDANCE SIGN PLAN SHEET 15				
27	EXISTING TAXI GUIDANCE SIGN PLAN SHEET 16				
28	EXISTING TAXI GUIDANCE SIGN PLAN SHEET 17				
29 30	PROPOSED TAXI GUIDANCE SIGN PLAN SHEET 1 PROPOSED TAXI GUIDANCE SIGN PLAN SHEET 2				
31	PROPOSED TAXI GUIDANCE SIGN PLAN SHEET 3				
32	PROPOSED TAXI GUIDANCE SIGN PLAN SHEET 4				
33	PROPOSED TAXI GUIDANCE SIGN PLAN SHEET 5				
34 35	PROPOSED TAXI GUIDANCE SIGN PLAN SHEET 6 PROPOSED TAXI GUIDANCE SIGN PLAN SHEET 7				
36	PROPOSED TAXI GUIDANCE SIGN PLAN SHEET 8				
37	PROPOSED TAXI GUIDANCE SIGN PLAN SHEET 9				
38	PROPOSED TAXI GUIDANCE SIGN PLAN SHEET 10				
39 40	PROPOSED TAXI GUIDANCE SIGN PLAN SHEET 11  PROPOSED TAXI GUIDANCE SIGN PLAN SHEET 12				
41	PROPOSED TAXI GUIDANCE SIGN PLAN SHEET 13				
42	PROPOSED TAXI GUIDANCE SIGN PLAN SHEET 14				
43	PROPOSED TAXI GUIDANCE SIGN PLAN SHEET 15				
45	PROPOSED TAXI GUIDANCE SIGN PLAN SHEET 16  PROPOSED TAXI GUIDANCE SIGN PLAN SHEET 17				
46	TAXI GUIDANCE SIGN SCHEDULE				
47	PAVEMENT MARKING AND DETAILS				
48	TAXI GUIDANCE SIGN DETAILS				
49 50	UNLIGHTED SIGN DETAILS  AIRFIELD LIGHTING CABLE SPLICE DETAILS				
51	CONDUIT TRENCH DETAILS				
52	ELECTRICAL NOTES SHEET 1				
53 54	ELECTRICAL NOTES SHEET 2				
55	GROUND RESISTANCE TESTING DETAILS GROUNDING DETAILS				
56	GROUNDING NOTES				
57	ELECTRICAL LEGEND AND ABBREVATIONS				
58	EXISTING FLOOR PLAN FOR VAULT				
59 60	EXISTING ELECTRICAL ONE LINE DIAGRAM FOR VAULT  EXISTING HIGH VOLTAGE WIRING SCHEMATIC FOR RUNWAYS				
61	EXISTING HIGH VOLTAGE WIRING SCHEMATIC FOR TAXIWAYS				
62	NEW FLOOR PLAN FOR VAULT				
63	PROPOSED ELECTRICAL ONE LINE DIAGRAM FOR VAULT				
64 65	PROPOSED HIGH VOLTAGE WIRING SCHEMATIC FOR RUNWAYS  PROP HIGH VOLTAGE WIRING SCHEMATIC FOR TXY CKTS 1, 2, 3, 3A, & 4				
66	PROP HIGH VOLTAGE WIRING SCHEMATIC FOR TXY CKTS 5, 6, & 7				
67	AIRFIELD LIGHTING CONTROL WIRING SCHEMATIC FOR RUNWAYS				
68	AIRFIELD LIGHTING CONTROL WIRING SCHEMATIC FOR TAXIWAYS				
69	LEGEND PLATES SCHEDULES				



Hanson Professional Services Inc. 1525 S. 6th Street Springfield, IL 62568 phone: 217-788-2450 fax: 217-788-2503

Illinois Licensed Professional Service Corporation #184-001084

COLES COUNTY AIRPORT
AUTHORITY
COLES COUNTY MEMORIAL AIRPORT

REMOVE AND REPLACE ALL TAXI GUIDANCE SIGNS ON THE AIRPORT

IDA No: MTO-4511 SBG Project No: 3-17-SBGP-XX

Contract No. CO062

	NO.	DATE	DES	CRIPT	ION
	INO.	DAIL	DES	DWN	REV
	ISSUE:	APRIL 1	5, 201	6	
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PROJECT NO: 13A0121D

CAD FILE: C-002-SOQ.DWG

DESIGN BY: KNL 02/17/2016

DRAWN BY: MLH 02/26/2016

REVIEWED BY: LDH 03/08/2016

SHEET TITLE

SUMMARY OF QUANTITIES AND INDEX TO SHEETS

#### PROPOSED SAFETY PLAN

- GENERAL THE COLES COUNTY MEMORIAL AIRPORT IS COMPRISED OF TWO PAVED RUNWAYS AND A STOL (SHORT TAKEOFF AND LANDING) TURF RUNWAY. THE PROPOSED CONSTRUCTION WILL NECESSITATE CLOSING BOTH PAVED RUNWAYS AND THE STOL TURF RUNWAY 18-36. ANY TIME THE CONTRACTOR IS WORKING WITHIN 250' OF A RUNWAY CENTERLINE (FOR RUNWAY 11-29 OR RUNWAY 6-24) THE RUNWAY WILL BE CLOSED. ANY TIME THE CONTRACTOR IS WORKING WITHIN 150' OF THE CENTERLINE OF THE STOL TURF RUNWAY 18-36. IT SHALL BE CLOSED. ANYTIME THE CONTRACTOR IS WORKING WITHIN 93' OF A TAXIWAY CENTERLINE, THE TAXIWAY SHALL BE CLOSED. RUNWAY AND TAXIWAY CLOSURES WILL BE IN ACCORDANCE WITH THE PROPOSED PHASING PLAN. WHEN THE CONTRACTOR RE-OPENS A RUNWAY ALL AREAS WITHIN THE SAFETY AREA WILL BE SMOOTH GRADED TO THE SATISFACTION OF THE RESIDENT ENGINEER. ALL WORK INCLUDED IN OPENING AND CLOSING A RUNWAY WILL BE PAID FOR UNDER ITEM AR800497 CONSTRUCTION SAFETY AND PHASING, PER LUMP SUM.
- <u>IDENTIFICATION</u> WHEN THE CONTRACTORS VEHICLES AND EQUIPMENT ARE ON THE AIRPORT THEY SHALL BE PROPERLY MARKED WITH THREE (3') FOOT SQUARE CHECKERED FLAGS (INTERNATIONAL ORANGE AND WHITE). THE CONTRACTOR WILL ALSO PROVIDE WORKERS WITH SOME TYPE OF TAG OR GARMENT TO IDENTIFY THE PERSON AS BEING PART OF THE CONSTRUCTION
- RADIO CONTROL THE CONTRACTOR WILL BE REQUIRED TO BE IN TWO-WAY RADIO CONTACT (122.70 MHz.) WITH THE AIRPORT UNICOM. THIS WILL KFFP THE CONTRACTOR IN CONSTANT CONTACT WITH THE COLES COUNTY MEMORIAL AIRPORT AND ENABLE THE AIRPORT TO IMMEDIATELY CONTACT THE CONTRACTOR IN CASE OF AN AERONAUTIC EMERGENCY THAT WOULD REQUIRE ACTION BY THE CONTRACTOR AND/OR HIS PERSONNEL.
- AIRFIELD SAFETY ASSURANCE AIRFIELD SAFETY SHALL BE THE NUMBER ONE PRIORITY AT ALL TIMES. ANY INDIVIDUALS RESPONSIBLE FOR INCURSIONS OR POTENTIAL INCURSIONS WITH AIR TRAFFIC DUE TO NON-COMPLIANCE WITH THE REQUIREMENTS SET FORTH IN THE THESE PLANS, SPECIFICATIONS, SPECIAL PROVISIONS, AND FAA ADVISORY CIRCULAR 150/5370-2F WILL BE SUBJECT TO AN IMMEDIATE SUSPENSION OF THEIR DRIVING PRIVILEGES ON THE AIRPORT OR A COMPLETE RESTRICTION FROM ENTERING THE ACTIVE AIRCRAFT OPERATION AREA ALTOGETHER. THE AIRPORT MANAGER OR AIRPORT REPRESENTATIVE MAY STOP THE WORK AT ANY TIME THEY BELIEVE AIRFIELD SAFETY IS BEING COMPROMISED.

#### SCOPE OF WORK

THIS PROJECT SHALL CONSIST OF THE REMOVAL AND REPLACEMENT OF TAXI GUIDANCE SIGNS ON THE AIRFIELD AND THE ASSOCIATED DUCTS, CABLING AND VAULT WORK.

#### AIRPORT SECURITY NOTE

AIRPORT SECURITY WILL BE MAINTAINED AT ALL TIMES. THE CONTRACTOR WILL CLOSE AND LOCK THE EXISTING ACCESS GATES IN THE HAUL ROUTES AT THE END OF FACH WORKING DAY.

#### HEIGHT OF CONSTRUCTION EQUIPMENT

THE MAXIMUM ANTICIPATED HEIGHT OF THE CONSTRUCTION EQUIPMENT WILL BE 25 FEET. THE TALLEST EQUIPMENT IS EXPECTED TO BE A DUMP TRUCK, CONCRETE TRUCK, OR LINE TRUCK.

#### HAUL ROUTE AND VEHICLE PARKING

THE CONTRACTOR WILL USE THE DESIGNATED HAUL ROUTES AND PARKING AREAS AS SHOWN ON THIS SHEET. THE PROPOSED PARKING AREAS WILL BE APPROXIMATELY 100' X 200'. THE CONTRACTOR WILL BE REQUIRED TO MAINTAIN THE PROPOSED HAUL ROUTES AND PARKING AREAS THROUGHOUT THE COURSE OF THE PROJECT. AREAS DAMAGED OUTSIDE OF THESE AREAS WILL BE REPAIRED BY THE CONTRACTOR AND AT THE CONTRACTOR'S OWN EXPENSE. AT THE CONCLUSION OF THE PROJECT THE CONTRACTOR SHALL RESTORE THE HAUL ROUTES AND PARKING AREAS AS NEEDED TO RESTORE THEM TO THEIR ORIGINAL STATE. RESTORATION OF THE HAUL ROUTES AND PARKING AREAS WILL BE CONSIDERED INCIDENTAL TO THE PROJECT AND NO ADDITIONAL COMPENSATION WILL BE ALLOWED.

	HORIZONTAL AND VERTICAL CONTROL DATA					
NO.	DESCRIPTION	NORTHING	EASTING	ELEV.		
1	BM 1 - CHISELED X NE CORNER OF INLET FRAME	1,025,082	996,948	707.85		
2	BM 2 - CHISELED X NE CORNER OF INLET FRAME	1,024,711	997,928	708.84		
3	BM 3 - CHISELED X NE CORNER OF INLET FRAME	1,024,453	998,648	707.22		
4	BM 4 - CHISELED X NE CORNER OF INLET FRAME	1,024,108	999,586	712.33		
5	BM 5 - CHISELED X NE CORNER OF INLET FRAME	1,023,869	1,000,247	711.49		
6	BM 6 - CHISELED X NE CORNER OF INLET FRAME	1,023,373	1,001,301	708.64		
7	BM 7 - CHISELED X NE CORNER OF INLET FRAME	1,022,907	1,002,299	708.72		
8	NGS – "COLES AIRPORT AZ MK", BRASS DISK	1,026,015.02	995,319.32	_		
9	NGS – "COLES AIRPORT", BRASS DISK	1,025,751.34	998,427.68	_		

## CRITICAL POINT DATA

POINT NUMBER	LATITUDE	LONGITUDE	ELEVATION (MSL)	HEIGHT (AGL)	EQUIPMENT ELEVATION (MSL)	WORK AREA
C.P. #1	N039* 28' 52.4556"	W088* 16' 39.7699"	705.00'	25'	730.00'	ALL PHASES
C.P. #2	N039° 28' 38.8171"	W088* 16' 52.7118"	720.30'	25'	745.30'	PHASE 1
C.P. #3	N039° 28' 41.9286"	W088* 16' 50.5449"	717.85	25'	742.85	PHASE 2
C.P. #4	N039* 28' 44.9789"	W088* 16' 43.6719"	715.00'	25'	740.00'	PHASE 2
C.P. #5	N039° 28' 42.1332"	W088* 17' 05.2116"	715.00'	25'	740.00'	PHASE 2
C.P. #6	N039° 28' 39.5101"	W088* 16' 43.1628"	718.64	25'	743.64'	PHASE 3
C.P. #7	N039* 28' 42.9808"	W088* 16' 35.3353"	715.00'	25'	740.00'	PHASE 3
C.P. #8	N039° 28' 39.1749"	W088* 16' 50.3279"	720.22'	25'	745.22'	PHASE 4
C.P. #9	N039° 28' 43.5038"	W088* 17' 03.5426"	714.50'	25'	739.50'	PHASE 4
C.P. #10	N039° 28' 44.5006"	W088° 16' 38.3269"	715.69'	25'	740.69'	PHASE 5
C.P. #11	N039° 28' 46.4513"	W088° 16' 44.2810"	713.00'	25'	738.00'	PHASE 5
C.P. #12	N039° 28' 53.6817"	W088° 17' 05.5363"	710.00'	25'	735.00'	PHASE 6
C.P. #13	N039° 28' 51.6521"	W088° 16' 58.5497"	709.00'	25'	734.00'	PHASE 6

SEE SAFETY AND PHASING PLAN FOR RESPECTIVE WORK AREA FOR ADDITIONAL INFORMATION.

COORDINATES SHOWN ARE NAD 83.

SITE ELEVATIONS BASED ON SURVEY DATA AND EXISTING BASE MAPPING.

	HORIZONTAL AND VERTICAL CONTROL DATA					
NO.	DESCRIPTION	NORTHING	EASTING	ELEV.		
1	BM 1 - CHISELED X NE CORNER OF INLET FRAME	1,025,082	996,948	707.85		
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50'	RUNWAY ©
	EXISTING RUNWAY

YELLOW IN COLOR

#### DETAIL OF CROSS FOR CLOSED RUNWAY

1. THE CROSSES WILL BE YELLOW IN COLOR AND SHALL BE MADE OF A SUITABLE MATERIAL AS APPROVED BY THE AIRPORT MANAGER. ON RUNWAY 6-24 THE CROSSES WILL BE PLACED OVER THE NUMERALS. ON RUNWAY 11-29 THE CROSSES WILL BE PLACED OVER THE NUMERALS LINLESS. SHOWN OTHERWISE. THE CROSSES WILL BE SECURED IN A MANNER APPROVED BY THE AIRPORT MANAGER. THE PROPOSED CROSSES WILL BE PLACED EACH DAY THE RUNWAY IS CLOSED AND REMOVED WHEN THE RUNWAY IS RE-OPENED. THE CONTRACTOR WILL BE RESPONSIBLE FOR THE PLACEMENT AND REMOVAL OF THE CROSSES. COST OF CONSTRUCTING. PLACING MAINTAINING AND REMOVING CROSSES WILL BE PAID FOR LINDER ITEM AR800497 CONSTRUCTION SAFETY AND PHASING, PER LUMP SUM.

#### UTILITY NOTE

1. THE LOCATION, SIZE, AND TYPE OF MATERIAL OF EXISTING UNDERGROUND AND/OR ABOVEGROUND UTILITIES INDICATED ON THE PLANS ARE NOT REPRESENTED AS BEING ACCURATE, SUFFICIENT OR COMPLETE. NEITHER THE OWNER NOR THE ENGINEER ASSUMES ANY RESPONSIBILITY WHATEVER I RESPECT TO THE ACCURACY, COMPLETENESS, OR SUFFICIENCY OF THE INFORMATION. THERE IS NO GUARANTEE, EITHER EXPRESSED OR IMPLIED, THAT THE LOCATIONS, SIZE AND TYPE OF MATERIAL OF EXISTING UNDERGROUND UTILITIES INDICATED ARE REPRESENTATIVE OF THOSE TO BE ENCOUNTERED IN THE CONSTRUCTION. IT SHALL BE THE CONTRACTOR'S RESPONSIBILITY TO DETERMINE THE ACTUAL LOCATION OF ALL SUCH FACILITIES, INCLUDING SERVICE CONNECTIONS TO UNDERGROUND UTILITIES. PRIOR TO CONSTRUCTION, THE CONTRACTOR SHALL NOTIFY THE UTILITY COMPANIES OF HIS OPERATIONAL PLANS AND SHALL OBTAIN FROM THE RESPECTIVE UTILITY COMPANIES DETAILED INFORMATION AND ASSISTANCE RELATIVE TO THE LOCATION OF THEIR FACILITIES AND THE WORKING SCHEDULE OF THE COMPANIES FOR REMOVAL OR ADJUSTMENT WHERE REQUIRED. IN THE EVENT AN UNEXPECTED UTILITY INTERFERENCE IS ENCOUNTERED DURING CONSTRUCTION, THE CONTRACTOR SHALL IMMEDIATELY NOTIFY THE UTILITY COMPANY OF JURISDICTION. THE OWNER'S REPRESENTATIVE AND/OR THE RESIDENT ENGINEER SHALL ALSO BE IMMEDIATELY NOTIFIED. ANY DAMAGE TO SUCH MAINS AND SERVICES SHALL BE RESTORED TO SERVICE AT ONCE AND PAID FOR BY THE CONTRACTOR A NO ADDITIONAL COST TO THE CONTRACT. ALL UTILITY CABLES AND LINES SHALL BE LOCATED BY THE RESPECTIVE UTILITY. CONTACT JULIE (JOINT UTILITY LOCATION INFORMATION FOR EXCAVATORS) FOR UTILITY INFORMATION. PHONE: 1-800-892-0123. CONTACT THE FAA (FEDERAL AVIATION ADMINISTRATION) FOR ASSISTANCE IN LOCATING FAA CABLES AND UTILITIES LOCATION OF FAA POWER, CONTROL, AND COMMUNICATION CABLES SHALL B COORDINATED WITH AND/OR LOCATED BY THE FAA. ALSO CONTACT AIRPORT DIRECTOR/MANAGER AND AIRPORT PERSONNEL FOR ASSISTANCE IN LOCATING UNDERGROUND AIRPORT CABLES AND/OR UTILITIES. ALSO COORDINATE

#### COLES MATTOON \_LAFAYETTE 14. 15. 22 & 23 \_COLES COUNTY MEMORIAL AIRPORT 432 AIRPORT ROAD

#### **LEGEND** EXISTING PAVEMENTS HALF SIZE SCALE: 1"= 1000' FULL SIZE SCALE: 1"= 500'

FXISTING BUILDINGS

PROPOSED HAUL ROUTE AND EQUIPMENT PARKING AREA

250' 500'

REMOVE AND REPLACE ALL TAXI **GUIDANCE SIGNS ON** THE AIRPORT

Offices Nationwide

1525 S. 6th Street

Illinois Licensed

#184-001084

Springfield, IL 62568

phone: 217-788-2450 fax: 217-788-2503

www.hanson-inc.com

Hanson Professional Services Inc.

Professional Service Corporation

**COLES COUNTY AIRPORT** 

- AUTHORITY

IDA No: MTO-4511 SBG Project No: 3-17-SBGP-XX

Contract No. CO062

	NO.	DATE	DESCRIPTION		
	INO.	DATE	DES	DWN	REV
	ISSUE:	APRIL 1	5, 201	6	
i	PROJEC	CT NO: 1	3A012	1D	
	CAD FIL	E: C-00	3-SFY.	DWG	
	DECION	D)/ I/N	1 00/	17/004	_

DESIGN BY: KNL 02/17/2016 DRAWN BY: MLH 02/26/2016 REVIEWED BY: LDH 03/08/2016

SHEET TITLE

PROPOSED SAFETY PLAN

#### BARRICADES AND TRAFFIC CONES IT WILL BE THE CONTRACTOR'S RESPONSIBILITY TO PLACE AND MAINTAIN BARRICADES AND TRAFFIC CONES AS SHOWN

ON THE PROPOSED PHASING PLANS AND/OR AS DIRECTED BY THE AIRPORT MANAGER. THE PLACEMENT, MAINTENANCE AND REMOVAL OF THE BARRICADES AND TRAFFIC CONES WILL BE PAID FOR UNDER ITEM AR800497 CONSTRUCTION SAFETY AND PHASING, PER LUMP SUM.

#### **CONTRACTOR RESPONSIBILITIES**


- THE CONTRACTOR'S EQUIPMENT PARKING AND MATERIAL STORAGE AREAS WILL BE AS SHOWN ON THIS SHEET.
- THE CONTRACTOR'S EMPLOYEES WILL PARK THEIR VEHICLES IN THESE AREAS. ONLY CONTRACTOR VEHICLES WILL BE ALLOWED OUTSIDE THESE AREAS.
- THE CONTRACTOR AND HIS EMPLOYEES WILL BE RESTRICTED TO THE WORK AREA AND ALL OTHER AREAS OF THE AIRPORT ARE "OFF LIMITS" TO THEM.
- 4. THE COLES COUNTY MEMORIAL AIRPORT AUTHORITY REQUIRES PERSONNEL DRIVING ON THE AIRPORT TO ATTEND A DRIVERS TRAINING CLASS PRESENTED BY THE AIRPORT MANAGER. THE CONTRACTOR WILL ARRANGE WITH THE AIRPORT MANAGER FOR HIS PERSONNEL TO ATTEND THE DRIVING CLASS. ONLY THESE PERSONNEL WILL BE ALLOWED TO DRIVE ON THE AIRPORT OUTSIDE OF THE AREA RESTRICTED FOR THE PROPOSED CONSTRUCTION. THOSE DRIVERS NOT DRIVING OUTSIDE OF THE PROPOSED CONSTRUCTION AREA WILL NOT BE REQUIRED TO ATTEND THE DRIVING CLASS.

#### **EROSION CONTROL**

THIS PROJECT WILL NOT DISTURB MORE THAN 1 ACRE OF LAND, THEREFORE A N.P.D.E.S. PERMIT WILL NOT BE REQUIRED.

#### AIRCRAFT OPERATION LINE


THE CONTRACTOR WILL LOCATE THIS LINE AT THE START OF CONSTRUCTION AND WILL PLACE FLAGGED LATHE EVERY 150' ALONG IT. THIS LINE WILL BE THE LIMITS THAT ALL CONTRACTOR PERSONNEL MAY VENTURE WHEN A RUNWAY IS NOT CLOSED. THE CONTRACTOR WILL MAINTAIN THE LATHE LINE FOR RUNWAYS.

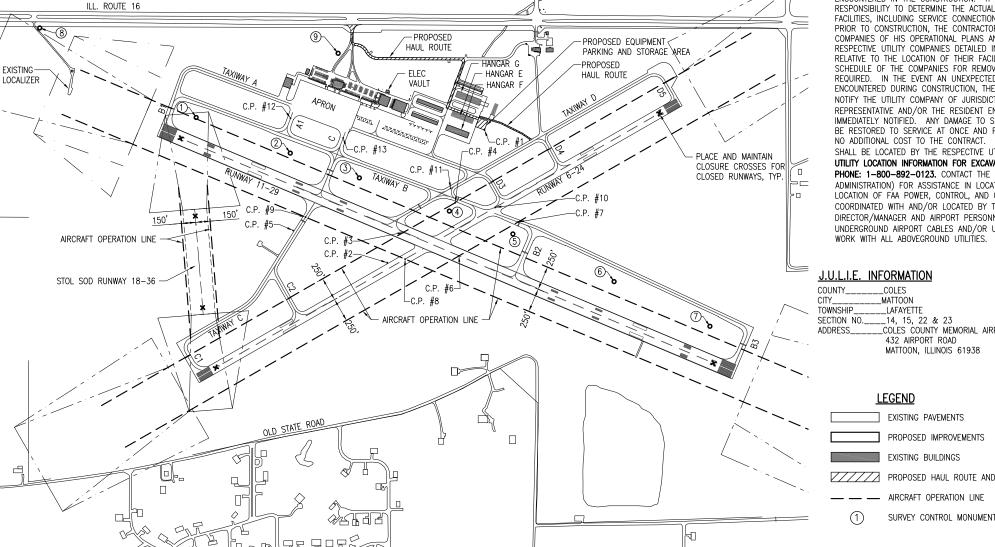

### MODIFIED TYPE II BARRICADE

#### BARRICADE NOTES

- IT WILL BE THE CONTRACTOR'S RESPONSIBILITY TO PLACE AND MAINTAIN BARRICADES AS SHOWN ON THE PLANS AND AS DIRECTED BY THE AIRPORT MANAGER.
- ALL CONSTRUCTION SIGNS AND TRAFFIC CONTROL DEVICES SHALL CONFORM TO THE MANUAL ON UNIFORM TRAFFIC CONTROL DEVICES INCLUDING THE ILLINOIS SUPPLEMENT (LATEST EDITION) AND THE FAA ADVISORY CIRCULARS (LATEST EDITION) UNLESS NOTED OTHERWISE. THE FAA OR MORE STRINGENT SPECIFICATIONS SHAUL GOVERN.
- MODIFIED TYPE II BARRICADES SHALL BE SPACED END TO END THE WIDTH OF THE PAVEMENT IN 4' INCREMENTS AS DIRECTED BY THE ENGINEER. BARRICADES ARE TO BE SET BACK 93' FROM THE ACTIVE TAXIWAY CENTERLINE OR AS SHOWN ON THE PLANS.
- 4. CONSTRUCTION RED WARNING LIGHT: THESE ARE PORTABLE, LENS DIRECTED, ENCLOSED LIGHTS. THE COLOR OF THE LIGHT EMITTED SHALL BE RED. THEY MAY BE USED IN EITHER A STEADY BURN (TYPE C) OR LOW INTENSITY FLASHING MODE (TYPE A) UNLESS NOTED OTHERWISE.
- THE LIGHTING SHALL BE MAINTAINED IN OPERATION DURING THE HOURS OF DARKNESS BETWEEN 1/2 HOUR AFTER SUNSET AND 1/2 HOUR BEFORE SUNRISE AND WHEN CONDITIONS EXIST WHICH TEND TO OBSCURE VISION.
- BARRICADES SHALL BE SECURED TO THE GROUND BY APPROVED METHODS TO PREVENT MOVEMENT BY PROP WASH, JET BLAST OR OTHER WIND CURRENTS.
- 7. THE COLOR COMBINATION ON TYPE II BARRICADES IS ORANGE AND WHITE. THE ORANGE STRIPES SHALL BE ENCAPSULATED LENS REFLECTIVE SHEETING. THE WHITE STRIPES SHALL BE EITHER ENCAPSULATED OR ENCLOSED LENS REFLECTIVE SHEETING AND MUST BE IN ACCEPTABLE CONDITION
- 8. COST FOR PLACING, MAINTAINING, AND REMOVING BARRICADES WILL BE PAID FOR UNDER ITEM AR800497 CONSTRUCTION SAFETY AND PHASING, PER LUMP SUM.

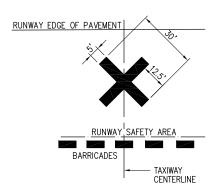

- 1. TEMPORARY "CLOSED TAXIWAY" MARKINGS SHALL BE "AVIATION YELLOW"
- TEMPORARY "CLOSED TAXIWAY" MARKINGS SHALL BE CONSTRUCTED USING TEMPORARY PAINT SUCH AS SEYMOUR TEMPORARY MARKER, PART NO. 20-636, OR AN EQUIVALENT PAINT EASILY REMOVED WITH WATER WITHOUT DEFACING THE PAVEMENT.
- TEMPORARY "CLOSED TAXIWAY" MARKINGS SHALL BE PLACED WHEN THE RUNWAY IS
  OPEN AND THE TAXIWAY IS CLOSED MORE THAN 72 HOURS. THE "CLOSED TAXIWAY"
  MARKINGS SHALL BE PLACED AS SHOWN ON THIS SHEET.
- 4. THE PROPOSED CROSSES WILL BE PLACED EACH DAY THE TAXIWAY IS CLOSED AND REMOVED WHEN THE TAXIWAY IS RE-OPENED. THE CONTRACTOR WILL BE RESPONSIBLE FOR THE PLACEMENT AND REMOVAL OF THE CROSSES. "CLOSED TAXIWAY" MARKINGS SHALL NOT BE A PAY ITEM BUT WILL BE PAID FOR UNDER ITEM AR800497 CONSTRUCTION SAFETY AND PHASING, PER LUMP SUM.

#### TEMPORARY TAXIWAY CLOSURE CROSS DETAIL

NOT TO SCALE

#### GENERAL NOTES

- THE CONTRACTOR SHALL FURNISH ALL LABOR, MATERIAL, EQUIPMENT, AND TRANSPORTATION NECESSARY TO CONSTRUCT ALL ELEMENTS OF THE PROJECT AS DESCRIBED IN THE CONSTRUCTION PLANS AND SPECIFICATIONS.
- THE RULES, REGULATIONS, AND SPECIFICATIONS NOTED HEREIN SHALL BE CONSIDERED AS MINIMUM REQUIREMENTS. THEY SHALL NOT PROHIBIT THE CONTRACTOR FROM FURNISHING AND INSTALLING HIGHER GRADES OF MATERIAL THAN ARE SPECIFIED HERFIN
- 3. THE CONSTRUCTION ENTRANCES AS SHOWN ON THE SAFETY PLAN SHALL BE USED FOR THE PROJECT. ACCESS TO THE PROJECT FOR ALL HAULING OF MATERIALS AND EQUIPMENT SHALL BE RESTRICTED TO THE DESIGNATED CONSTRUCTION ENTRANCES AND HAUL ROUTES. ACCESS TO THE WORK AREAS FROM THE STAGING AREA SHALL BE COORDINATED WITH THE RESIDENT ENGINEER/RESIDENT TECHNICIAN AND AIRPORT MANAGEMENT
- 4. IT SHALL BE THE RESPONSIBILITY OF THE CONTRACTOR TO PROTECT, PRESERVE AND REPAIR THE EXISTING AIRFIELD AND ROADWAY PAVEMENTS AT ALL TIMES. THE CONTRACTOR SHALL REPAIR ANY DAMAGE TO EXISTING ELECTRICAL, DRAINAGE, AND PAVEMENT STRUCTURES AT NO ADDITIONAL COST TO THE CONTRACT.
- 5. CONTRACTOR IS REQUIRED TO PROVIDE THEIR OWN RESTROOM FACILITIES.
- 6. UNLESS OTHERWISE NOTED, ALL DISTURBED AREAS OUTSIDE OF THE PROPOSED CONSTRUCTION LIMITS SHALL BE GRADED, SEEDED AND/OR HYDROMULCH SEEDED AT NO ADDITIONAL COST TO THE CONTRACT.
- 7. ALL WASTE MATERIAL SHALL BE HAULED FROM THE AIRPORT AND PROPERLY DISPOSED OF UNITESS OTHERWISE SPECIFIED HERFIN
- 8. THE CONTRACTOR SHALL BE RESPONSIBLE FOR OBTAINING PERMITS FOR HAULING ON PUBLIC ROADS, AS APPLICABLE. THE CONTRACTOR SHALL BE RESPONSIBLE FOR CORRECTING ANY DAMAGES TO ANY PAVEMENTS (PUBLIC OR PRIVATE) CAUSED BY HIS/HER CONSTRUCTION EQUIPMENT OR PERSONNEL.
- THE OWNER SHALL HAVE THE RIGHT OF FIRST REFUSAL FOR ALL SALVAGEABLE MATERIAL REMOVED ON THE PROJECT.
- THE CONTRACTOR SHALL PROVIDE ONE SET OF REDLINED RECORD DRAWINGS TO THE RESIDENT ENGINEER/RESIDENT TECHNICIAN AT THE COMPLETION OF THE PROJECT.
- 11. CONTRACTOR SHALL NOTE THAT ALL AREAS WITHIN THE AIRPORT PROPERTY LINE AND OUTSIDE THE CONSTRUCTION LIMITS MAY BE USED FOR AGRICULTURAL PURPOSES. THE CONSTRUCTION LIMITS SHALL BE RESTRICTED TO AREAS THAT ARE ABSOLUTELY NECESSARY TO DISTURB TO COMPLETE THE REQUIRED WORK ITEMS. LIMITS SHALL BE COORDINATED WITH THE RESIDENT ENGINEER PRIOR TO BEGINNING ANY WORK. ALL AREAS WHICH HAVE BEEN FARMED AND OR DESIGNATED TO BE FARMED AFTER THE PROJECT COMPLETION, AND HAVE BEEN DISTURBED BY CONSTRUCTION ACTIVITY, SHALL BE CHISEL PLOWED (36" MAX.) OR OTHERWISE SCARIFIED TO RETURN THE AREA TO A REASONABLE TILLABLE CONDITION (IF SO PERMITTED BY THE AIRPORT MANAGER.)
- 12. CONTRACTOR SHALL RESTORE TO ORIGINAL CONDITION ALL GRASS, STONE, OR PAVEMENT DISTURBED BY CONTRACTOR'S CONSTRUCTION OPERATIONS, STAGING, AND CONSTRUCTION ACCESS ROUTES. DISTURBED AREAS WILL BE REPAIRED, GRADED, MULCHED AND SEEDED UNLESS OTHERWISE NOTED. STAGING AREA AND SITE ACCESS RESTORATION SHALL BE INCLUDED IN THE COST OF THE PROJECT.
- 13. THE PROJECT PAY ITEMS ARE INTENDED TO BE INCLUSIVE OF ALL WORK TO BE PERFORMED AS SHOWN IN THESE PLANS. ALL INCIDENTAL WORK REQUIRED TO COMPLETE THE PROJECT TO THE SATISFACTION OF THE RESIDENT ENGINEER/RESIDENT TECHNICIAN IS TO BE INCLUDED IN THE COSTS OF PERFORMING THESE ITEMS.
- 14. APPROXIMATE LOCATIONS OF UNDERGROUND UTILITIES ARE SHOWN THROUGHOUT THESE PLANS. THE CONTRACTOR SHALL DETERMINE EXACT LOCATIONS AND PROTECT THESE UTILITIES DURING CONSTRUCTION ANY UTILITIES DAMAGED DURING CONSTRUCTION SHALL BE REPAIRED AT THE CONTRACTOR'S EXPENSE. CONTRACTOR SHALL COORDINATE WITH THE PROPER PERSONS FOR THE PURPOSE OF LOCATING AND PROTECTING EXISTING UNDERGROUND UTILITIES.
- THE CONTRACTOR MUST AT ALL TIMES MAINTAIN PROPER DRAINAGE FOR ALL AREAS AFFECTED BY HIS WORK.

#### SAFETY NOTES

- 1. FOLLOWING ARE THE CONSTRUCTION SAFETY PROCEDURES THAT THE CONTRACTOR SHALL FOLLOW THROUGHOUT THIS PROJECT. ADDITIONAL REQUIREMENTS ARE SHOWN ON THE SAFETY AND PHASING NOTES AND DETAILS SHEET.
- ALL PROVISIONS OF THE LATEST EDITION OF FAA ADVISORY CIRCULAR AC 150/5370-2 (CURRENT EDITION),
  "OPERATIONAL SAFETY ON AIRPORTS DURING CONSTRUCTION", APPLY TO THIS CONTRACT, EXCEPT AS MODIFIED
  BY THIS SAFETY PLAN, OR AS MODIFIED BY THE OWNER THROUGH THE RESIDENT ENGINEER AT THE
  PRECONSTRUCTION CONFERENCE. OR DURING THE COURSE OF THE CONTRACT.
- 3. THE CONTRACTORS SHALL MINIMIZE DISRUPTION OF STANDARD OPERATING PROCEDURES FOR AERONAUTICAL ACTIVITY BY REMAINING WITHIN THE PRESCRIBED STAGING, CONSTRUCTION, AND PHASING AREAS PRESENTED ON THE PROJECT SAFETY AND PHASING PLANS.
- 4. NO UNAUTHORIZED PERSONNEL SHALL ENTER ANY AREA OF THE AIRPORT THAT COULD POTENTIALLY BE HAZARDOUS. THE ENGINEER, ENGINEER'S REPRESENTATIVE AND/OR AIRPORT MANAGER RESERVE THE RIGHT TO SUSPEND OPERATIONS IN ORDER TO MAINTAIN SAFETY AT THE AIRPORT.
- CONTRACTOR EQUIPMENT, VEHICLES, AND PROJECT MATERIALS SHALL BE STORED AT THE STAGING AREA SHOWN ON THE PLAN VIEW, EXCEPT AS OTHERWISE PROVIDED FOR AT THE PRECONSTRUCTION CONFERENCE.
- 6. ALL CONSTRUCTION EQUIPMENT OPERATING IN THE PRESCRIBED CONSTRUCTION AREA IS REQUIRED TO DISPLAY A CHECKERBOARD FLAG PROPERLY LOCATED AND/OR A ROTATING BEACON (STROBE) AS SPECIFIED IN AC 150/5210-5, "PAINTING, MARKING, AND LIGHTING OF VEHICLES USED ON AN AIRPORT" LATEST EDITION.
- 7. NO CONSTRUCTION MATERIAL STOCKPILES SHALL BE LOCATED WITHIN 250' OF RUNWAYS 11-29 AND 6-24 CENTERLINE WHEN ACTIVE, WITHIN 93' OF AN ACTIVE TAXIWAY CENTERLINE, WITHIN 81' OF AN ACTIVE TAXI LANE CENTERLINE, OR PENETRATE A PART 77 IMAGINARY SURFACE (PROVIDED BY THE ENGINEER) EXTENDING OUT AND UPWARDS FROM ALL SIDES OF AN ACTIVE RUNWAY.
- 8. CLOSED AIRFIELD PHASING AREAS, OPEN TRENCHES, AND STOCKPILED MATERIALS AT THE CONSTRUCTION SITE SHALL BE PROMINENTLY MARKED WITH LIGHTED BARRICADES WITH STEADY BURNING OR FLASHING RED LIGHTS AS SPECIFIED IN 150/5370-2, "OPERATIONAL SAFETY ON AIRPORT DURING CONSTRUCTION, LATEST EDITION. LIGHTED BARRICADES MUST BE NO TALLER THAN 24" (EXCLUSIVE OF SUPPLEMENTARY LIGHTS) ON THE TAXIWAYS AND COMPLY WITH ADVISORY CIRCULAR 150/5370-2, LATEST EDITION. CONTRACTOR SHALL NIGHT CHECK BARRICADES DAILY FOR PROPER OPERATION.
- NO OPEN TRENCHES WITHIN 250' OF RUNWAYS 11-29 AND 6-24 CENTERLINE WHEN ACTIVE, WITHIN 93' OF AN
  ACTIVE TAXIWAY CENTERLINE, OR WITHIN 81' OF AN ACTIVE TAXI LANE CENTERLINE, WILL BE PERMITTED. OTHER
  TRENCHES SHALL BE MAINTAINED SAFE, I.E., BARRICADED OR COVERED WITH STEEL PLATES IN ALL OTHER
  APPAS
- OPEN TRENCHES, EXCAVATIONS, AND STOCKPILED MATERIALS AT THE CONSTRUCTION SITE SHOULD BE PROMINENTLY MARKED WITH ORANGE FLAGS AND LIGHTED WITH FLASHING YELLOW LIGHTS DURING HOURS OF RESTRICTED VISIBILITY AND/OR DARKNESS.
- 11. NO OPEN FLAME WELDING OR TORCH CUTTING OPERATION IS PERMITTED UNLESS ADEQUATE FIRE AND SAFETY PRECAUTIONS ARE PROVIDED AND HAVE BEEN APPROVED BY THE AIRPORT MANAGER. NO FLARE POTS ARE ALLOWED ON THE PROJECT.
- 12. SOIL, DEBRIS, AND LOOSE MATERIAL DROPPED OR TRUCKED ONTO AIRPORT ROADS, TAXIWAYS, AND SOD SURFACES, OR WHICH CAN BE BLOWN ONTO SUCH SURFACES, SHALL BE IMMEDIATELY SWEPT, PICKED UP AND REMOVED, OR PLACED INTO CLOSED CONTAINERS. ANY DAMAGE TO AIRPORT PROPERTY SHALL BE REPAIRED IMMEDIATELY AT NO COST TO THE OWNER.
- 13. EACH CONTRACTOR SHALL BE RESPONSIBLE FOR LOCATING AND MAINTAINING AIRPORT LIGHTING AND NAVIGATIONAL ELECTRICAL SYSTEMS DURING CONSTRUCTION. A CONTACT PERSON AND TELEPHONE NUMBER FOR 24 HOUR EMERGENCY IMMEDIATE REPAIR SHALL BE SUBMITTED TO THE AIRPORT MANAGER AND ENGINEER. HAUL ROUTES CROSSING PAVEMENT, DRAINAGE, MISCELLANEOUS. STRUCTURES AND/OR AIRFIELD CABLES SHALL BE PROTECTED FROM DAMAGE
- 14. ALL AIRCRAFT AND AIRPORT OPERATIONS HAVE THE RIGHT-OF-WAY. CONTRACTOR TO YIELD TO VEHICLES AND REMAIN CLEAR AT ALL TIMES.
- 15. CONTRACTOR SHALL PLACE, SECURE, AND MAINTAIN LIGHTED BARRICADES AND CLOSURE CROSSES WHEN A RUNWAY/TAXIWAY/APRON IS CLOSED OR AS REQUIRED BY THE PLANS AND DESIGNATED BY THE ENGINEER.
- 16. CONTRACTOR SHALL MARK HAZARDOUS AREA WITH STEADY-BURNING OR FLASHING RED AND YELLOW LIGHTS DURING PERIODS OF LOW VISIBILITY AS REQUIRED.
- 17. THE CONTRACTOR SHALL PERIODICALLY PERFORM ONSITE INSPECTIONS THROUGHOUT THE DURATION OF THE PROJECT WITH THE IMMEDIATE REMEDY OF ANY DIFFERENCES, WHETHER CAUSED BY NEGLIGENCE, OVERSIGHT, OR PROJECT SCOPE CHANGE
- 18. CONTRACTOR SHALL MOVE MAINTENANCE OF TRAFFIC COMPONENTS AT THE DIRECTION OF THE AIRPORT MANAGER AND/OR THE RESIDENT ENGINEER/RESIDENT TECHNICIAN AT NO ADDITIONAL COST.
- 19. CONTRACTOR SHALL NOT REMOVE THE BARRICADES WITHOUT THE APPROVAL BY THE AIRPORT MANAGER AND/OR RESIDENT ENGINEER/RESIDENT TECHNICIAN.
- 20. CONTRACTOR SHALL MAINTAIN FLASHERS, SIGNS AND/OR BARRICADES AS REQUIRED BY THE PLANS, CITY OR COUNTY REGULATIONS OR CONTRACTOR ACTIVITIES. CONTRACTOR SHALL OBTAIN ANY AND ALL REQUIRED LOCAL PERMITS UNLESS SPECIFIED OTHERWISE.
- 21. THE CONTRACTOR SHALL UTILIZE WATER AND/OR CHEMICALS APPROVED BY THE ENGINEER AS NECESSARY TO CONTROL DUST.
- 22. CONSTRUCTION EQUIPMENT OR CONSTRUCTION ACTIVITY WILL NOT BE PERMITTED WITHIN THE RUNWAY SAFETY AREA OF ANY ACTIVE RUNWAY CENTERLINE OR WITHIN THE OBJECT FREE AREA OF AN ACTIVE TAXIWAY OR APRON.
- 23. UNLESS SPECIFIED OTHERWISE, COST FOR THE ABOVE WILL BE PAID FOR UNDER ITEM AR800497 CONSTRUCTION SAFETY AND PHASING, PER LUMP SUM.

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Illinois Licensed Professional Service Corporation #184-001084

COLES COUNTY AIRPORT
AUTHORITY
COLES COUNTY MEMORIAL AIRPORT

IDA No: MTO-4511 SBG Project No: 3-17-SBGP-XX

Contract No. CO062

PROJECT NO: 13A0121D

CAD FILE: G-004-NOTES.DWG

DESIGN BY: KNL 02/17/2016

DRAWN BY: RAD 02/29/2016

REVIEWED BY: KNL 03/08/2016

SHEET TITLE

PROPOSED SAFETY PLAN NOTES

### 1. SEE "PROPOSED SAFETY PLAN" FOR CRITICAL POINT

HANGAR G

— HANGAR E

HANGAR

CRITICAL POINT DATA

PROPOSED EQUIPMENT

-PROPOSED

AIRCRAFT OPERATION LINE

+

HAUL ROUTE

PARKING AND STORAGE AREA

RUNWAY/TAXIWAY CLOSURE DISTANCES				
LOCATION	DISTANCE FROM CENTERLINE			
RUNWAY 11-29	250 FT.			
RUNWAY 6-24	250 FT.			
STOL SOD RUNWAY 18-36	150 FT.			
ALL TAXIWAYS	93 FT.			
ALL TAXI LANES	81 FT.			

HAUL ROUTE

WORK AREA

AIRCRAFT OPERATION LINE


VAULT

C.P. #2

OLD STATE ROAD

#### WORK AREA 1 NOTES

- 1. WORK AREA 1 INCLUDES REMOVAL AND INSTALLATION OF TAXI GUIDANCE SIGNS AND THE ASSOCIATED WORK AT THE INTERSECTION OF RUNWAY 11-29 AND RUNWAY 6-24, AND THE INTERSECTION OF TAXIWAY B AND RUNWAY 6-24. RUNWAY 11-29 AND THE ASSOCIATED TAXIWAYS WILL BE CLOSED DURING THE CONSTRUCTION WEEK AND REOPENED AT THE END OF EACH CONSTRUCTION WEEK. RUNWAY 6-24 WILL BE CLOSED FOR THE CONSTRUCTION WEEK OR THE RESPECTIVE CONSTRUCTION DURATION OF WORK AREA 1 WHICHEVER IS LESS. THE APRON WILL BE OPEN DURING THIS PHASE. RUNWAY 18-36 WILL BE CLOSED DURING THIS
- 2. DURING THE TIME OF THE RUNWAY CLOSURES CONDUIT BORING INSTALLATION MAY BE DONE ON TAXIWAYS B1, B2, B3, C, C1, C2, D, D3, D4, AND D5 SIMULTANEOUSLY WITH THE WORK AT THE INTERSECTION OF RUNWAY 11-29 AND RUNWAY 6-24, AND THE INTERSECTION OF TAXIWAY B AND RUNWAY 6-24 TAXIWAYS WILL BE CLOSED ANY TIME WORK IS BEING PERFORMED WITHIN 93' OF A TAXIWAY CENTERLINE. PROVIDE BARRICADES FOR CLOSED TAXIWAYS.
- IT IS ANTICIPATED THAT WORK IN THE ELECTRICAL VAULT WILL OCCUR CONCURRENTLY WITH WORK ON THE AIRFIELD. THEREFORE THE VAULT WORK SHALL BE COMPLETED WITHIN THE OVERALL PROJECT CONTRACT
- CLOSURE CROSSES AND BARRICADES SHALL BE IN PLACE PRIOR TO BEGINNING CONSTRUCTION.
- RUNWAY 11-29 WILL BE NOTAMED "CLOSED". THE CONTRACTOR SHALL COORDINATE WITH THE AIRPORT AT LEAST 48 HOURS BEFORE BEGINNING THIS PHASE SO THAT NOTAMS MAY BE COORDINATED.
- RUNWAY 6-24 WILL BE NOTAMED "CLOSED". THE CONTRACTOR SHALL COORDINATE WITH THE AIRPORT AT LEAST 48 HOURS BEFORE BEGINNING THIS PHASE SO THAT NOTAMS MAY BE COORDINATED.
- 6. RUNWAY 18-36 WILL BE NOTAMED "CLOSED". THE CONTRACTOR SHALL COORDINATE WITH THE AIRPORT AT LEAST 48 HOURS BEFORE BEGINNING THIS PHASE SO THAT NOTAMS MAY BE COORDINATED.
- 7. AT ALL TIMES THE CONTRACTOR'S OPERATIONS SHALL BE SUCH AS TO MINIMIZE CLOSURES.
- WHEN A RUNWAY IS CLOSED THE RESPECTIVE RUNWAY LIGHTING AND NAVAIDS FOR THAT RUNWAY SHALL BE SHUT OFF. COORDINATE SHUT OFF OF NAVAIDS WITH THE AIRPORT MANAGER.
- THE AIRPORT WILL REMAIN OPEN DURING ALL CONSTRUCTION PHASES TO ACCOMMODATE AGRICULTURAL AIR OPERATIONS AND HELICOPTER OPERATIONS. THE AIRPORT MANAGER WILL RETAIN THE RIGHT TO OPEN TAXIWAY A OR TAXIWAY D WHERE NECESSARY TO ACCOMMODATE AGRICULTURAL AIR OPERATIONS.
- 10. WHERE CONTRACTOR HAS MULTIPLE CREWS, THEY MAY WORK IN WORK AREAS 1 & 6 SIMULTANEOUSLY.
- 11. MAINTAIN ARFF (AIRCRAFT RESCUE AND FIRE FIGHTING) FACILITY ACCESS TO THE AIRFIELD FOR ALL PHASES OF WORK. CONTRACTOR SHALL COORDINATE LOCATIONS AND SPACING OF BARRICADES WITH THE AIRPORT MANAGER TO MAINTAIN ARFF EMERGENCY ACCESS ROUTES TO THE AIRFIELD. THE MATTOON FIRE DEPARTMENT ARFF FACILITY PERSONNEL WILL COORDINATE WITH THE AIRPORT MANAGER THROUGHOUT THE TAXI

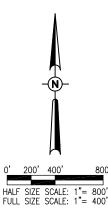

**LEGEND** EXISTING PAVEMENTS

PROPOSED WORK AREA

EXISTING BUILDINGS

PROPOSED HAUL ROUTE AND EQUIPMENT PARKING AREA

— — AIRCRAFT OPERATION LINE

● ● PROPOSED BARRICADES

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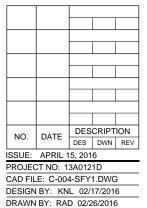
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**COLES COUNTY AIRPORT** AUTHORITY

REMOVE AND REPLACE ALL TAXI **GUIDANCE SIGNS ON** THE AIRPORT

IDA No: MTO-4511 SBG Project No: 3-17-SBGP-XX

Contract No. CO062



PROPOSED SAFETY AND PHASING PLAN

**WORK AREA 1** 

REVIEWED BY: LDH 03/08/2016

SHEET TITLE

ILL. ROUTE 16

150'

AIRCRAFT OPERATION LINE

STOL SOD RUNWAY 18-36 -

**EXISTING** 

LOCALIZER

#### RUNWAY/TAXIWAY CLOSURE DISTANCES DISTANCE FROM CENTERLINE RUNWAY 11 RUNWAY 6-24 STOL SOD RUNWAY 18-36

#### CRITICAL POINT DATA

1. SEE "PROPOSED SAFETY PLAN" FOR CRITICAL POINT

#### WORK AREA 2 NOTES

- 1. WORK AREA 2 INCLUDES REMOVAL AND INSTALLATION OF TAXI GUIDANCE SIGNS AND THE ASSOCIATED WORK ON RUNWAY 11-29 AND TAXIWAY B WEST OF RUNWAY 6-24 AND THE WEST PORTION OF TAXIWAY A WEST OF THE RURAL KING HANGAR. IT ALSO WILL INCLUDE REMOVAL AND INSTALLATION OF TAXI GUIDANCE SIGNS NORTH OF THE STOL (SHORT TAKE OFF AND LANDING) TURF RUNWAY 18-36. RUNWAY 11-29 AND THE ASSOCIATED TAXIWAYS WILL BE CLOSED DURING THE CONSTRUCTION WEEK AND REOPENED ON THE WEEKENDS OR AT THE END OF EACH CONSTRUCTION WEEK. RUNWAY 6-24 WILL BE OPEN DURING THIS PHASE. THE APRON AND TAXIWAY A EAST OF THE APRON WILL BE OPEN DURING THIS PHASE. RUNWAY 18-36 WILL BE CLOSED DURING THIS PHASE.
- 2. IT IS ANTICIPATED THAT WORK IN THE ELECTRICAL VAULT WILL OCCUR CONCURRENTLY WITH WORK ON THE AIRFIELD. THEREFORE THE VAULT WORK SHALL BE COMPLETED WITHIN THE OVERALL PROJECT CONTRACT
- 3. CLOSURE CROSSES AND BARRICADES SHALL BE IN PLACE PRIOR TO BEGINNING CONSTRUCTION
- RUNWAY 11-29 WILL BE NOTAMED "CLOSED". THE CONTRACTOR SHALL COORDINATE WITH THE AIRPORT AT LEAST 48 HOURS BEFORE BEGINNING THIS PHASE SO THAT NOTAMS MAY BE COORDINATED.
- RUNWAY 18-36 WILL BE NOTAMED "CLOSED". THE CONTRACTOR SHALL COORDINATE WITH THE AIRPORT AT LEAST 48 HOURS BEFORE BEGINNING THIS PHASE SO THAT NOTAMS MAY BE COORDINATED.
- 6. AT ALL TIMES THE CONTRACTOR'S OPERATIONS SHALL BE SUCH AS TO MINIMIZE CLOSURES.
- WHEN A RUNWAY IS CLOSED THE RESPECTIVE RUNWAY LIGHTING AND NAVAIDS FOR THAT RUNWAY SHALL BE SHUT OFF. COORDINATE SHUT OFF OF NAVAIDS WITH THE AIRPORT MANAGER.
- 8. THE AIRPORT WILL REMAIN OPEN DURING ALL CONSTRUCTION PHASES TO ACCOMMODATE AGRICULTURAL AIR OPERATIONS AND HELICOPTER
- 9. WHERE CONTRACTOR HAS MULTIPLE CREWS, THEY MAY WORK IN WORK AREAS 2 & 3 SIMULTANEOUSLY.
- 10. WHEN CROSSING AN ACTIVE RUNWAY, CONTRACTOR EMPLOYEES, STAFF, CONCRETE TRUCKS, ETC. SHALL BE ESCORTED ACROSS THE RUNWAY BY THE RESIDENT ENGINEER/RESIDENT TECHNICIAN OR OTHER AIRPORT DESIGNATED AUTHORIZED PERSONNEL.
- 11. MAINTAIN ARFF (AIRCRAFT RESCUE AND FIRE FIGHTING) FACILITY ACCESS TO THE AIRFIELD FOR ALL PHASES OF WORK. CONTRACTOR SHALL COORDINATE LOCATIONS AND SPACING OF BARRICADES WITH THE AIRPORT MANAGER TO MAINTAIN ARFF EMERGENCY ACCESS ROUTES TO THE AIRFIELD. THE MATTOON FIRE DEPARTMENT ARFF FACILITY PERSONNEL WILL COORDINATE WITH THE AIRPORT MANAGER THROUGHOUT THE TAXI SIGN REPLACEMENT PROJECT.

**LEGEND** 

EXISTING PAVEMENTS

EXISTING BUILDINGS

PROPOSED WORK AREA



Offices Nationwide

www.hanson-inc.com

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phone: 217-788-2450 fax: 217-788-2503

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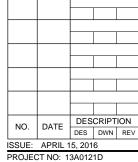
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**COLES COUNTY AIRPORT** AUTHORITY

SBG Project No: 3-17-SBGP-XX

Contract No. CO062




CAD FILE: C-005-SFY1.DWG

DESIGN BY: KNL 02/17/2016 DRAWN BY: RAD 02/26/2016 REVIEWED BY: LDH 03/08/2016

SHEET TITLE

PROPOSED SAFETY AND PHASING PLAN WORK AREA 2

6

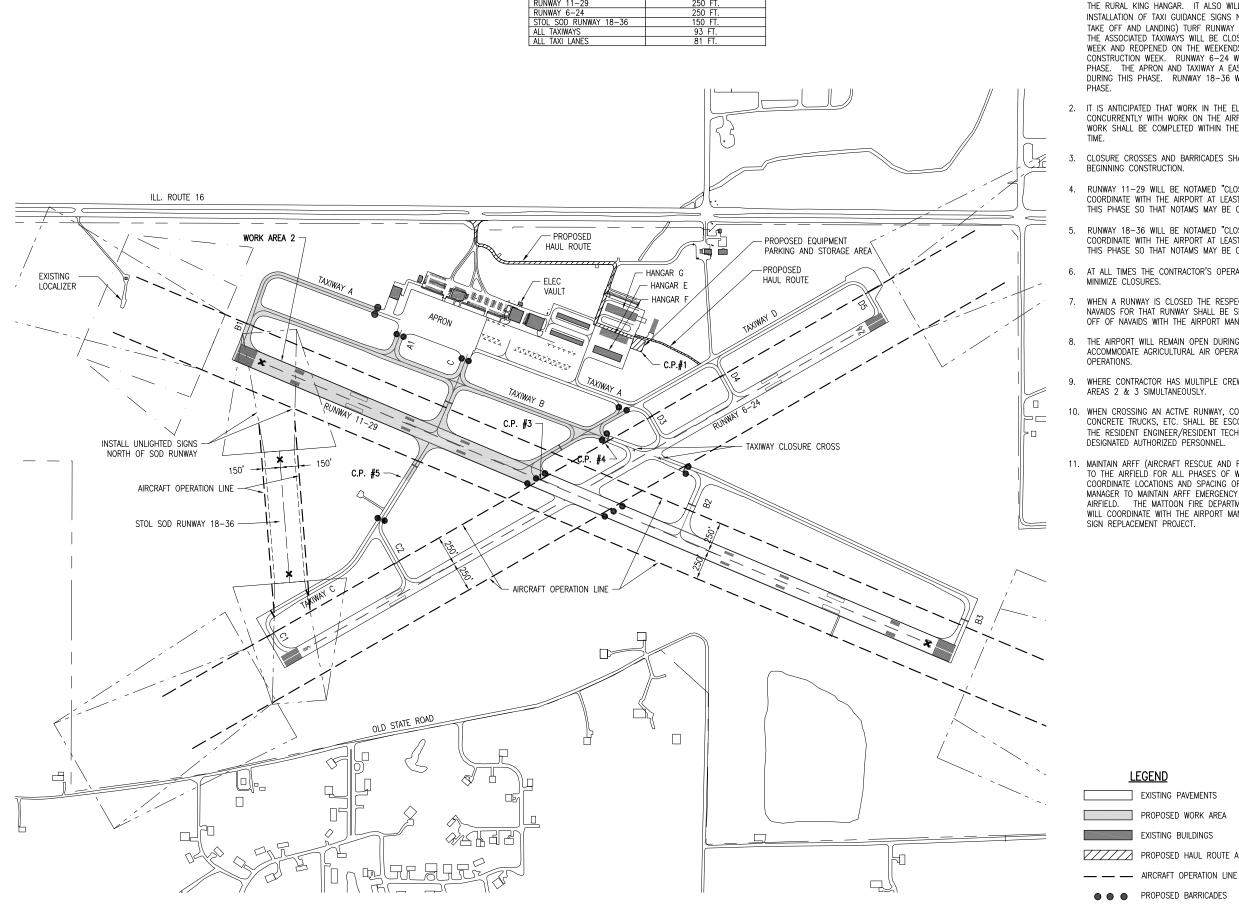

#### RUNWAY/TAXIWAY CLOSURE DISTANCES DISTANCE FROM CENTERLINE RUNWAY 11 RUNWAY 6-24 STOL SOD RUNWAY 18-36

#### CRITICAL POINT DATA

1. SEE "PROPOSED SAFETY PLAN" FOR CRITICAL POINT

#### WORK AREA 3 NOTES

- 1. WORK AREA 3 INCLUDES REMOVAL AND INSTALLATION OF TAXI GUIDANCE SIGNS AND THE ASSOCIATED WORK ON RUNWAY 11-29 AND TAXIWAY B EAST OF RUNWAY 6-24. RUNWAY 11-29 AND THE ASSOCIATED TAXIWAYS WILL BE CLOSED DURING THE CONSTRUCTION WEEK AND REOPENED ON THE WEEKENDS OR AT THE END OF EACH CONSTRUCTION WEEK. RUNWAY 6-24 WILL BE OPEN DURING THIS PHASE. THE APRON AND WILL BE OPEN DURING THIS PHASE. RUNWAY 18-36 WILL BE CLOSED DURING THIS PHASE.
- 2. IT IS ANTICIPATED THAT WORK IN THE ELECTRICAL VAULT WILL OCCUR CONCURRENTLY WITH WORK ON THE AIRFIELD. THEREFORE THE VAULT WORK SHALL BE COMPLETED WITHIN THE OVERALL PROJECT CONTRACT
- 3. CLOSURE CROSSES AND BARRICADES SHALL BE IN PLACE PRIOR TO BEGINNING CONSTRUCTION.
- RUNWAY 11-29 WILL BE NOTAMED "CLOSED". THE CONTRACTOR SHALL COORDINATE WITH THE AIRPORT AT LEAST 48 HOURS BEFORE BEGINNING THIS PHASE SO THAT NOTAMS MAY BE COORDINATED.
- RUNWAY 18-36 WILL BE NOTAMED "CLOSED". THE CONTRACTOR SHALL COORDINATE WITH THE AIRPORT AT LEAST 48 HOURS BEFORE BEGINNING THIS PHASE SO THAT NOTAMS MAY BE COORDINATED.
- 6. AT ALL TIMES THE CONTRACTOR'S OPERATIONS SHALL BE SUCH AS TO MINIMIZE CLOSURES.
- WHEN A RUNWAY IS CLOSED THE RESPECTIVE RUNWAY LIGHTING AND NAVAIDS FOR THAT RUNWAY SHALL BE SHUT OFF. COORDINATE SHUT OFF OF NAVAIDS WITH THE AIRPORT MANAGER.
- 8. THE AIRPORT WILL REMAIN OPEN DURING ALL CONSTRUCTION PHASES TO ACCOMMODATE AGRICULTURAL AIR OPERATIONS AND HELICOPTER
- 9. WHERE CONTRACTOR HAS MULTIPLE CREWS, THEY MAY WORK IN WORK AREAS 2 & 3 SIMULTANEOUSLY.
- 10. WHEN CROSSING AN ACTIVE RUNWAY, CONTRACTOR EMPLOYEES, STAFF, CONCRETE TRUCKS, ETC. SHALL BE ESCORTED ACROSS THE RUNWAY BY THE RESIDENT ENGINEER/RESIDENT TECHNICIAN OR OTHER AIRPORT DESIGNATED AUTHORIZED PERSONNEL.
- 11. MAINTAIN ARFF (AIRCRAFT RESCUE AND FIRE FIGHTING) FACILITY ACCESS TO THE AIRFIELD FOR ALL PHASES OF WORK. CONTRACTOR SHALL COORDINATE LOCATIONS AND SPACING OF BARRICADES WITH THE AIRPORT MANAGER TO MAINTAIN ARFF EMERGENCY ACCESS ROUTES TO THE THE MATTOON FIRE DEPARTMENT ARFF FACILITY PERSONNEL WILL COORDINATE WITH THE AIRPORT MANAGER THROUGHOUT THE TAXI SIGN REPLACEMENT PROJECT.



Offices Nationwide

www.hanson-inc.com

1525 S. 6th Street Springfield, IL 62568

phone: 217-788-2450 fax: 217-788-2503

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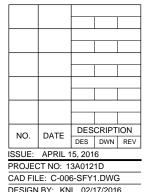
Professional Service Corporation

**COLES COUNTY AIRPORT** 

REMOVE AND REPLACE ALL TAXI **GUIDANCE SIGNS ON** THE AIRPORT

IDA No: MTO-4511 SBG Project No: 3-17-SBGP-XX

Contract No. CO062




DRAWN BY: RAD 02/26/2016 REVIEWED BY: LDH 03/08/2016

0' 200' 400' SHEET TITLE HALF SIZE SCALE: 1"= 800'

FULL SIZE SCALE: 1"= 400'

PROPOSED SAFETY AND PHASING PLAN **WORK AREA 3** 

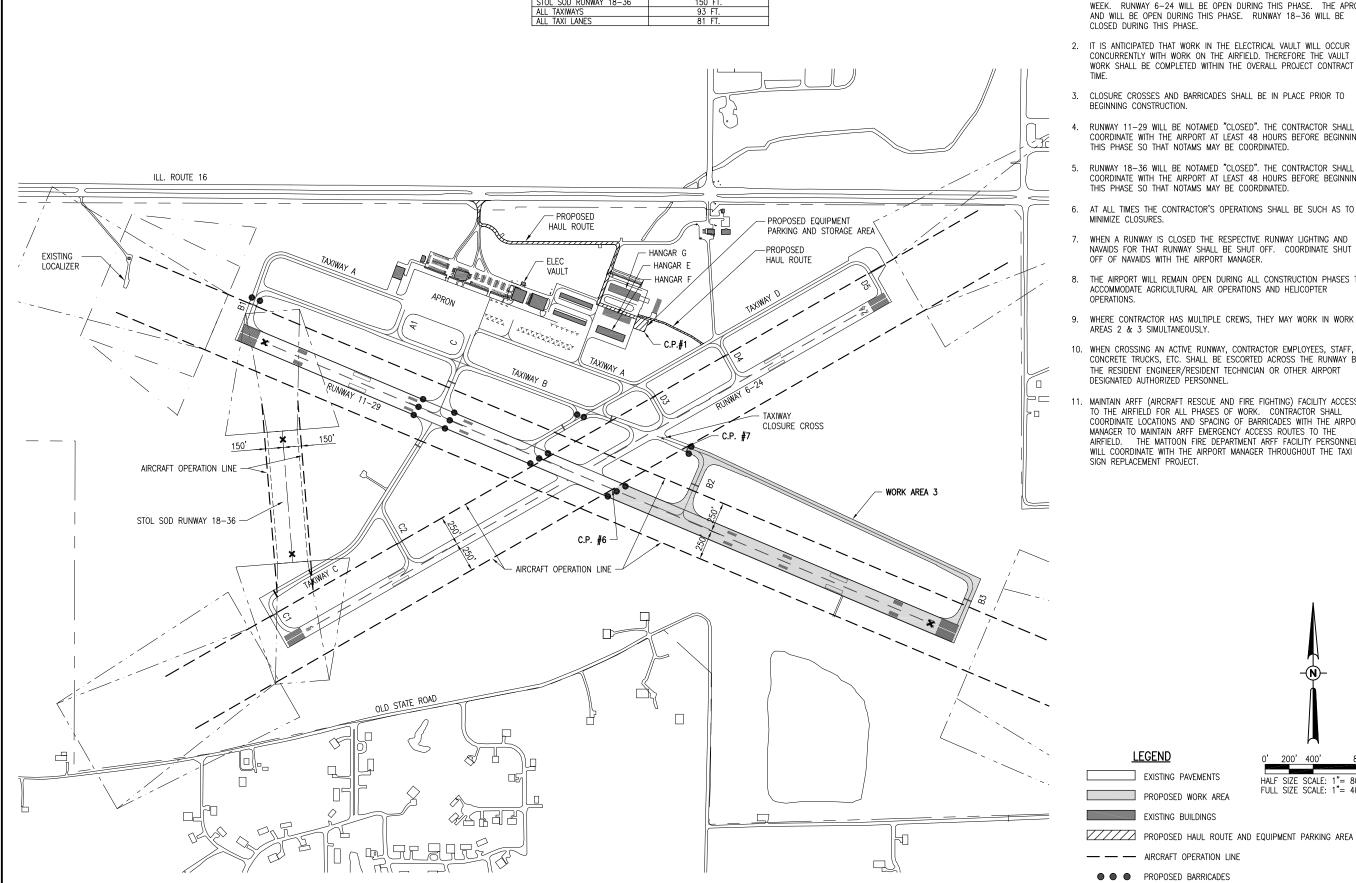

PROPOSED BARRICADES

# RUNWAY/TAXIWAY CLOSURE DISTANCES LOCATION DISTANCE FROM CENTERLINE RUNWAY 11-29 250 FT. RUNWAY 6-24 250 FT. STOL SOD RUNWAY 18-36 150 FT. ALL TAXIWAYS 93 FT. ALL TAXI LANES 81 FT.

#### CRITICAL POINT DATA

SEE "PROPOSED SAFETY PLAN" FOR CRITICAL POINT
DATA

#### WORK AREA 4 NOTES

- 1. WORK AREA 4 INCLUDES REMOVAL AND INSTALLATION OF TAXI GUIDANCE SIGNS AND THE ASSOCIATED WORK ON RUNWAY 6-24 AND TAXIWAY C SOUTH OF RUNWAY 11-29. RUNWAY 6-24 AND THE ASSOCIATED TAXIWAYS WILL BE CLOSED DURING THE CONSTRUCTION WEEK AND REOPENED ON THE WEEKENDS OR END OF THE CONSTRUCTION WEEK. RUNWAY 11-29 AND TAXIWAY B WILL BE OPEN DURING THIS PHASE. THE APRON AND WILL BE OPEN DURING THIS PHASE. RUNWAY 18-36 WILL BE CLOSED DURING THIS PHASE.
- IT IS ANTICIPATED THAT WORK IN THE ELECTRICAL VAULT WILL OCCUR CONCURRENTLY WITH WORK ON THE AIRFIELD. THEREFORE THE VAULT WORK SHALL BE COMPLETED WITHIN THE OVERALL PROJECT CONTRACT TIME.
- 3. CLOSURE CROSSES AND BARRICADES SHALL BE IN PLACE PRIOR TO BEGINNING CONSTRUCTION.
- RUNWAY 6-24 WILL BE NOTAMED "CLOSED". THE CONTRACTOR SHALL COORDINATE WITH THE AIRPORT AT LEAST 48 HOURS BEFORE BEGINNING THIS PHASE SO THAT NOTAMS MAY BE COORDINATED.
- RUNWAY 18-36 WILL BE NOTAMED "CLOSED". THE CONTRACTOR SHALL COORDINATE WITH THE AIRPORT AT LEAST 48 HOURS BEFORE BEGINNING THIS PHASE SO THAT NOTAMS MAY BE COORDINATED.
- AT ALL TIMES THE CONTRACTOR'S OPERATIONS SHALL BE SUCH AS TO MINIMIZE CLOSURES.
- WHEN A RUNWAY IS CLOSED THE RESPECTIVE RUNWAY LIGHTING AND NAVAIDS FOR THAT RUNWAY SHALL BE SHUT OFF. COORDINATE SHUT OFF OF NAVAIDS WITH THE AIRPORT MANAGER.
- 8. THE AIRPORT WILL REMAIN OPEN DURING ALL CONSTRUCTION PHASES TO ACCOMMODATE AGRICULTURAL AIR OPERATIONS AND HELICOPTER OPERATIONS.
- WHERE CONTRACTOR HAS MULTIPLE CREWS, THEY MAY WORK IN WORK AREAS 4 & 5 SIMULTANEOUSLY.
- 10. WHEN CROSSING AN ACTIVE RUNWAY, CONTRACTOR EMPLOYEES, STAFF, CONCRETE TRUCKS, ETC. SHALL BE ESCORTED ACROSS THE RUNWAY BY THE RESIDENT ENGINEER/RESIDENT TECHNICIAN OR OTHER AIRPORT DESIGNATED AUTHORIZED PERSONNEL.
- 11. MAINTAIN ARFF (AIRCRAFT RESCUE AND FIRE FIGHTING) FACILITY ACCESS TO THE AIRFIELD FOR ALL PHASES OF WORK. CONTRACTOR SHALL COORDINATE LOCATIONS AND SPACING OF BARRICADES WITH THE AIRPORT MANAGER TO MAINTAIN ARFF EMERGENCY ACCESS ROUTES TO THE AIRFIELD. THE MATTOON FIRE DEPARTMENT ARFF FACILITY PERSONNEL WILL COORDINATE WITH THE AIRPORT MANAGER THROUGHOUT THE TAXI SIGN REPLACEMENT PROJECT.

COLES COLETY MEMORIAL AIRPORT

**COLES COUNTY AIRPORT** 

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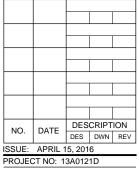
Hanson Professional Services Inc.

Professional Service Corporation

REMOVE AND REPLACE ALL TAXI GUIDANCE SIGNS ON THE AIRPORT

IDA No: MTO-4511 SBG Project No: 3-17-SBGP-XX

Contract No. CO062



PROJECT NO: 13A0121D

CAD FILE: C-007-SFY1.DWG


DESIGN BY: KNL 02/17/2016

DRAWN BY: RAD 02/26/2016

REVIEWED BY: LDH 03/08/2016

SHEET TITLE

PROPOSED SAFETY AND PHASING PLAN WORK AREA 4

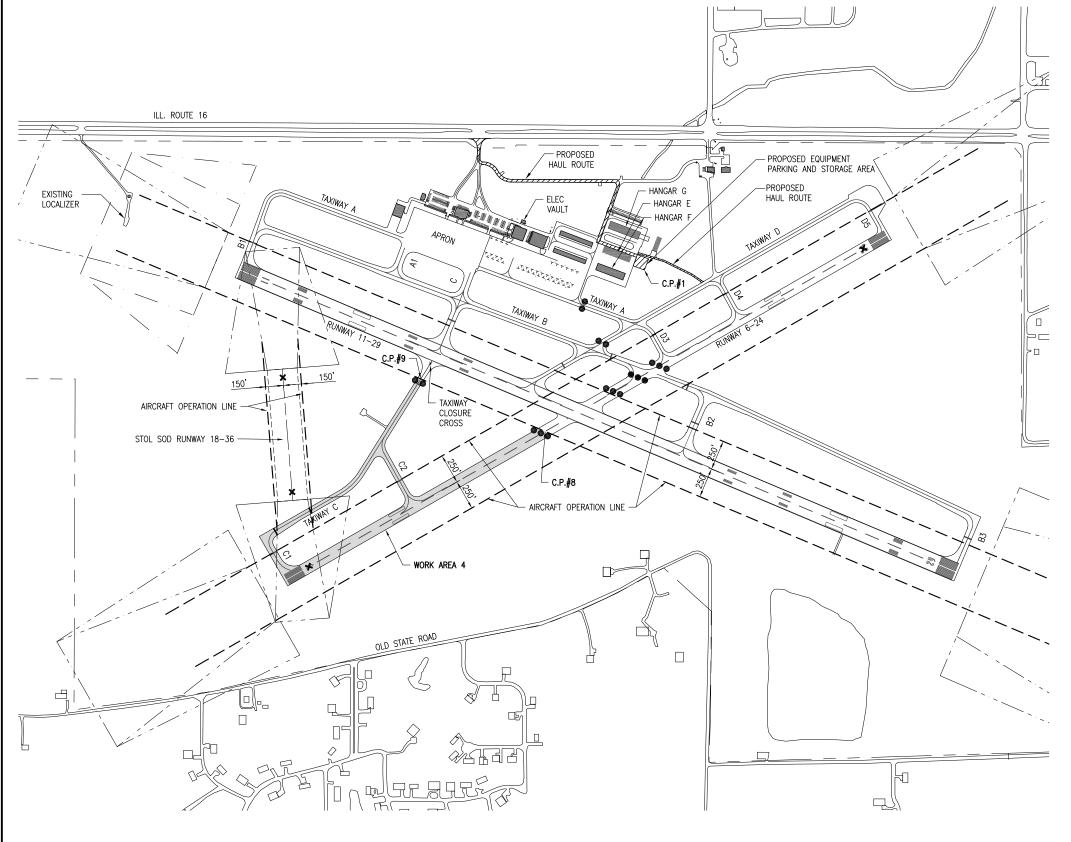

LEGEND

EXISTING PAVEMENTS

PROPOSED WORK AREA

EXISTING BUILDINGS

PROPOSED HAUL ROUTE AND EQUIPMENT PARKING AREA

AIRCRAFT OPERATION LINE

## RUNWAY/TAXIWAY CLOSURE DISTANCES LOCATION DISTANCE FROM CENTERLINE RUNWAY 11-29 250 FT. RUNWAY 6-24 250 FT. STOL SOD RUNWAY 18-36 150 FT.

#### CRITICAL POINT DATA

SEE "PROPOSED SAFETY PLAN" FOR CRITICAL POINT
DATA

#### WORK AREA 5 NOTES

- 1. WORK AREA 5 INCLUDES REMOVAL AND INSTALLATION OF TAXI GUIDANCE SIGNS AND THE ASSOCIATED WORK ON RUNWAY 6-24 AND TAXIWAY D NORTH OF TAXIWAY B. RUNWAY 6-24 AND THE ASSOCIATED TAXIWAYS WILL BE CLOSED DURING THE CONSTRUCTION WEEK AND REOPENED ON THE WEEKENDS OR END OF THE CONSTRUCTION WEEK. RUNWAY 11-29 AND TAXIWAY B WILL BE OPEN DURING THIS PHASE. THE APRON AND WILL BE OPEN DURING THIS PHASE. RUNWAY 18-36 WILL BE OPEN DURING THIS PHASE.
- IT IS ANTICIPATED THAT WORK IN THE ELECTRICAL VAULT WILL OCCUR
  CONCURRENTLY WITH WORK ON THE AIRFIELD. THEREFORE THE VAULT
  WORK SHALL BE COMPLETED WITHIN THE OVERALL PROJECT CONTRACT
  TIME
- 3. CLOSURE CROSSES AND BARRICADES SHALL BE IN PLACE PRIOR TO BEGINNING CONSTRUCTION.
- RUNWAY 6-24 WILL BE NOTAMED "CLOSED". THE CONTRACTOR SHALL COORDINATE WITH THE AIRPORT AT LEAST 48 HOURS BEFORE BEGINNING THIS PHASE SO THAT NOTAMS MAY BE COORDINATED.
- 5. AT ALL TIMES THE CONTRACTOR'S OPERATIONS SHALL BE SUCH AS TO MINIMIZE CLOSURES
- WHEN A RUNWAY IS CLOSED THE RESPECTIVE RUNWAY LIGHTING AND NAVAIDS FOR THAT RUNWAY SHALL BE SHUT OFF. COORDINATE SHUT OFF OF NAVAIDS WITH THE AIRPORT MANAGER.
- THE AIRPORT WILL REMAIN OPEN DURING ALL CONSTRUCTION PHASES TO ACCOMMODATE AGRICULTURAL AIR OPERATIONS AND HELICOPTER OPERATIONS
- 8. WHERE CONTRACTOR HAS MULTIPLE CREWS, THEY MAY WORK IN WORK AREAS 4 & 5 SIMULTANEOUSLY.
- WHEN CROSSING AN ACTIVE RUNWAY, CONTRACTOR EMPLOYEES, STAFF, CONCRETE TRUCKS, ETC. SHALL BE ESCORTED ACROSS THE RUNWAY BY THE RESIDENT ENGINEER/RESIDENT TECHNICIAN OR OTHER AIRPORT DESIGNATED AUTHORIZED PERSONNEL.
- 10. MAINTAIN ARFF (AIRCRAFT RESCUE AND FIRE FIGHTING) FACILITY ACCESS TO THE AIRFIELD FOR ALL PHASES OF WORK. CONTRACTOR SHALL COORDINATE LOCATIONS AND SPACING OF BARRICADES WITH THE AIRPORT MANAGER TO MAINTAIN ARFF EMERGENCY ACCESS ROUTES TO THE AIRFIELD. THE MATTOON FIRE DEPARTMENT ARFF FACILITY PERSONNEL WILL COORDINATE WITH THE AIRPORT MANAGER THROUGHOUT THE TAXI SIGN REPLACEMENT PROJECT.

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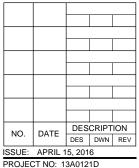
Professional Service Corporation

**COLES COUNTY AIRPORT** 

REMOVE AND REPLACE ALL TAXI GUIDANCE SIGNS ON THE AIRPORT

IDA No: MTO-4511 SBG Project No: 3-17-SBGP-XX

Contract No. CO062



PROJECT NO: 13A0121D


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DESIGN BY: KNI. 02/17/2016

CAD FILE: C-008-SFY1.DWG
DESIGN BY: KNL 02/17/2016
DRAWN BY: RAD 02/26/2016
REVIEWED BY: LDH 03/08/2016

SHEET TITLE

PROPOSED SAFETY AND PHASING PLAN WORK AREA 5

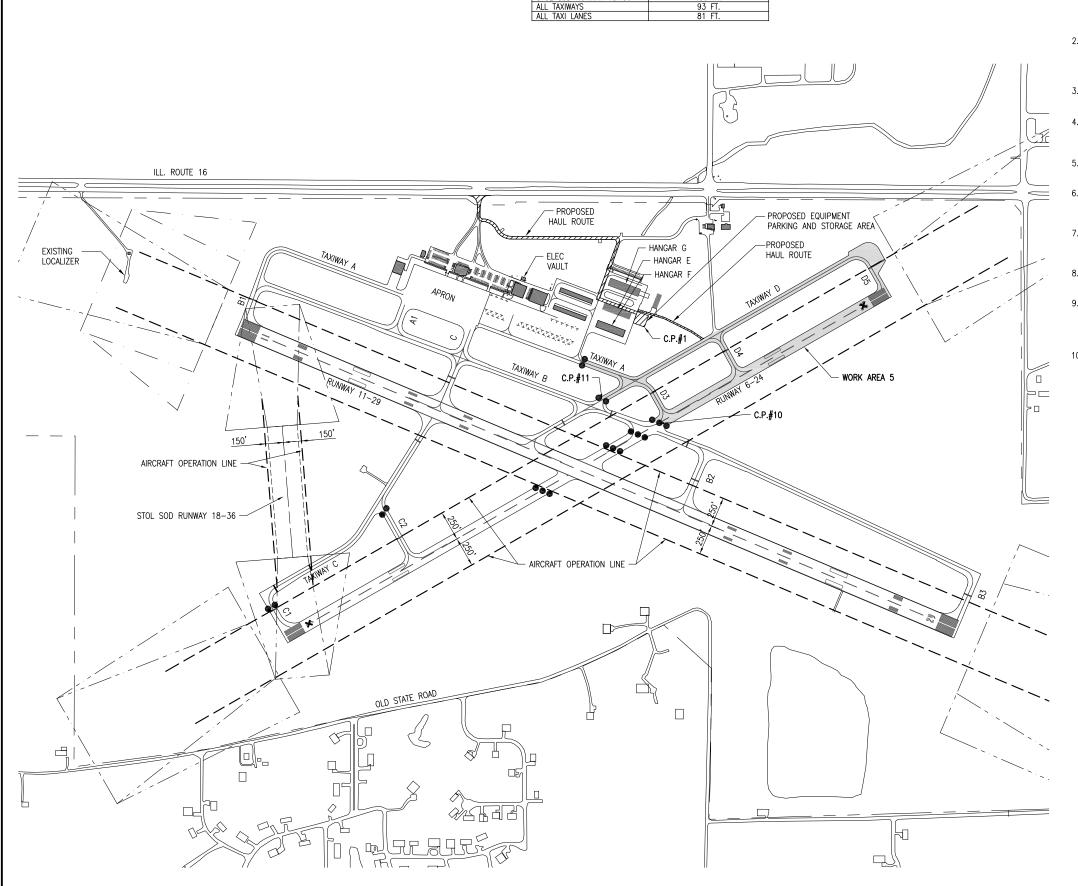

#### RUNWAY/TAXIWAY CLOSURE DISTANCES DISTANCE FROM CENTERLINE RUNWAY 11 RUNWAY 6-24 STOL SOD RUNWAY 18-3

#### CRITICAL POINT DATA

1. SEE "PROPOSED SAFETY PLAN" FOR CRITICAL POINT

#### WORK AREA 6 NOTES

- 1. WORK AREA 6 INCLUDES REMOVAL AND INSTALLATION OF TAXI GUIDANCE SIGNS AND THE ASSOCIATED WORK ON TAXIWAY A EAST OF THE RURAL KING HANGAR AND THE SOUTH SIDE PORTION OF THE APRON. THIS AREA WILL BE CLOSED DURING THE CONSTRUCTION WEEK AND REOPENED ON THE WEEKENDS OR END OF THE CONSTRUCTION WEEK. THE REMAINING PORTION OF THE APRON WILL BE OPEN DURING THIS PHASE. RUNWAY 11-29 AND TAXIWAY B WILL BE OPEN DURING THIS PHASE. RUNWAY 6-24 WILL BE OPEN DURING THIS PHASE. RUNWAY 18-36 WILL BE OPEN DURING THIS PHASE.
- 2. IT IS ANTICIPATED THAT WORK IN THE ELECTRICAL VAULT WILL OCCUR CONCURRENTLY WITH WORK ON THE AIRFIELD. THEREFORE THE VAULT WORK SHALL BE COMPLETED WITHIN THE OVERALL PROJECT CONTRACT
- 3. CLOSURE CROSSES AND BARRICADES SHALL BE IN PLACE PRIOR TO
- THE RESPECTIVE TAXIWAY AND APRON AREAS WILL BE NOTAMED "CLOSED". THE CONTRACTOR SHALL COORDINATE WITH THE AIRPORT AT LEAST 48 HOURS BEFORE BEGINNING THIS PHASE SO THAT NOTAMS MAY
- AT ALL TIMES THE CONTRACTOR'S OPERATIONS SHALL BE SUCH AS TO MINIMIZE CLOSURES.
- THE AIRPORT WILL REMAIN OPEN DURING ALL CONSTRUCTION PHASES TO ACCOMMODATE AGRICULTURAL AIR OPERATIONS AND HELICOPTER
- WHEN CROSSING AN ACTIVE RUNWAY, CONTRACTOR EMPLOYEES, STAFF, CONCRETE TRUCKS, ETC. SHALL BE ESCORTED ACROSS THE RUNWAY BY THE RESIDENT ENGINEER/RESIDENT TECHNICIAN OR OTHER AIRPORT DESIGNATED AUTHORIZED PERSONNEL.
- 10. MAINTAIN ARFF (AIRCRAFT RESCUE AND FIRE FIGHTING) FACILITY ACCESS TO THE AIRFIELD FOR ALL PHASES OF WORK. CONTRACTOR SHALL COORDINATE LOCATIONS AND SPACING OF BARRICADES WITH THE AIRPORT MANAGER TO MAINTAIN ARFF EMERGENCY ACCESS ROUTES TO THE THE MATTOON FIRE DEPARTMENT ARFF FACILITY PERSONNEL WILL COORDINATE WITH THE AIRPORT MANAGER THROUGHOUT THE TAXI

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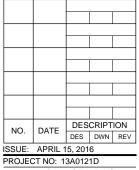
**COLES COUNTY AIRPORT** 

AUTHORITY

REMOVE AND REPLACE ALL TAXI **GUIDANCE SIGNS ON** THE AIRPORT

IDA No: MTO-4511 SBG Project No: 3-17-SBGP-XX

Contract No. CO062



CAD FILE: C-009-SFY1.DWG DESIGN BY: KNL 02/17/2016 DRAWN BY: RAD 02/26/2016


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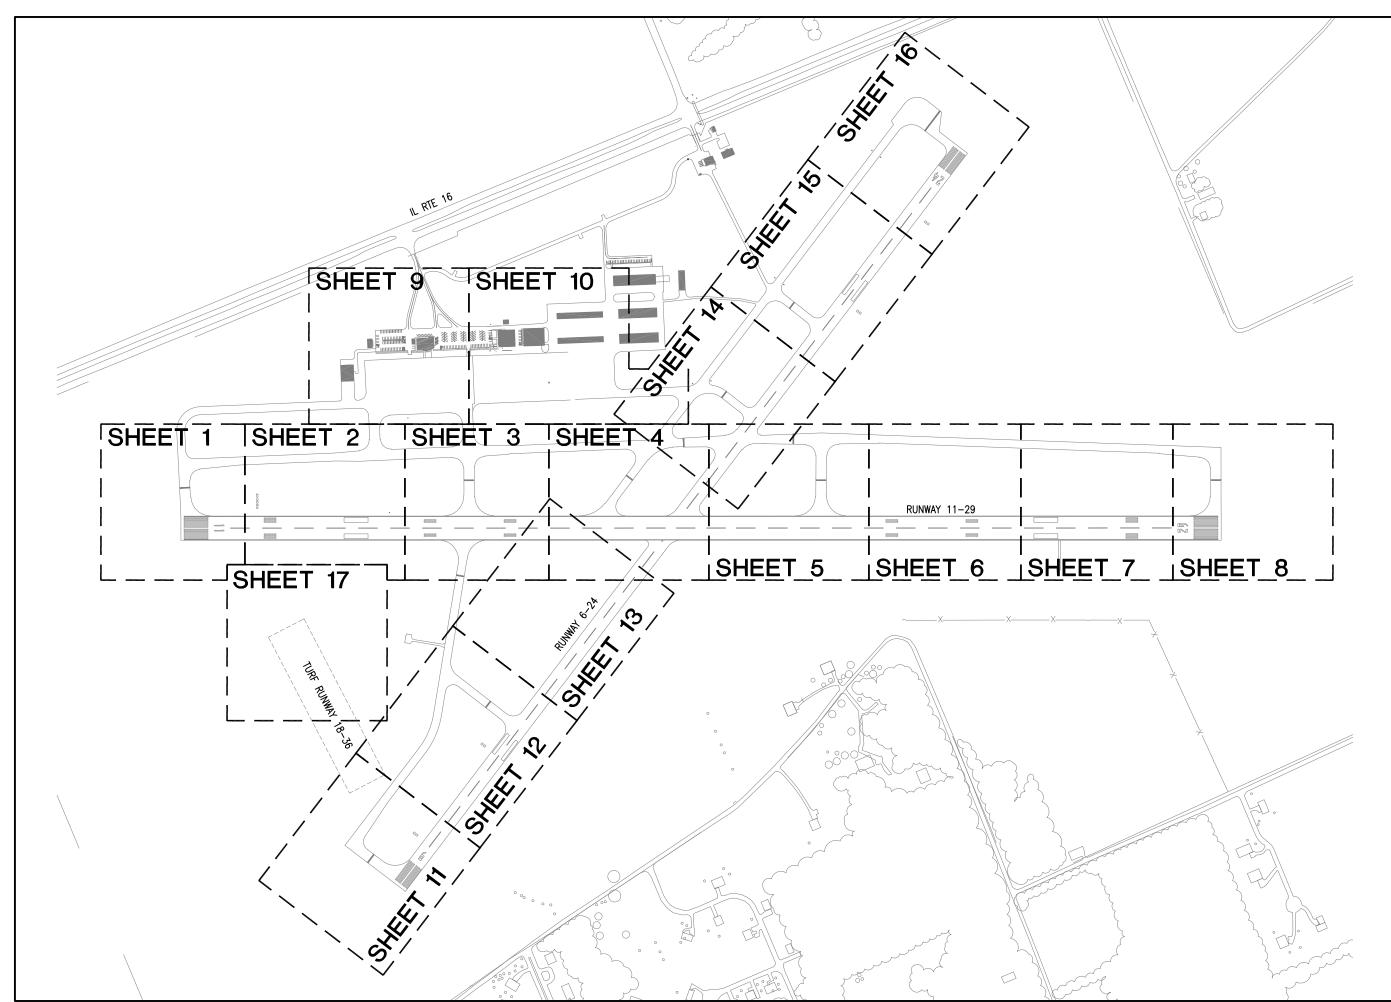
SHEET TITLE

200' 400'

HALF SIZE SCALE: 1"= 800' FULL SIZE SCALE: 1"= 400'

> PROPOSED SAFETY AND PHASING PLAN **WORK AREA 6**



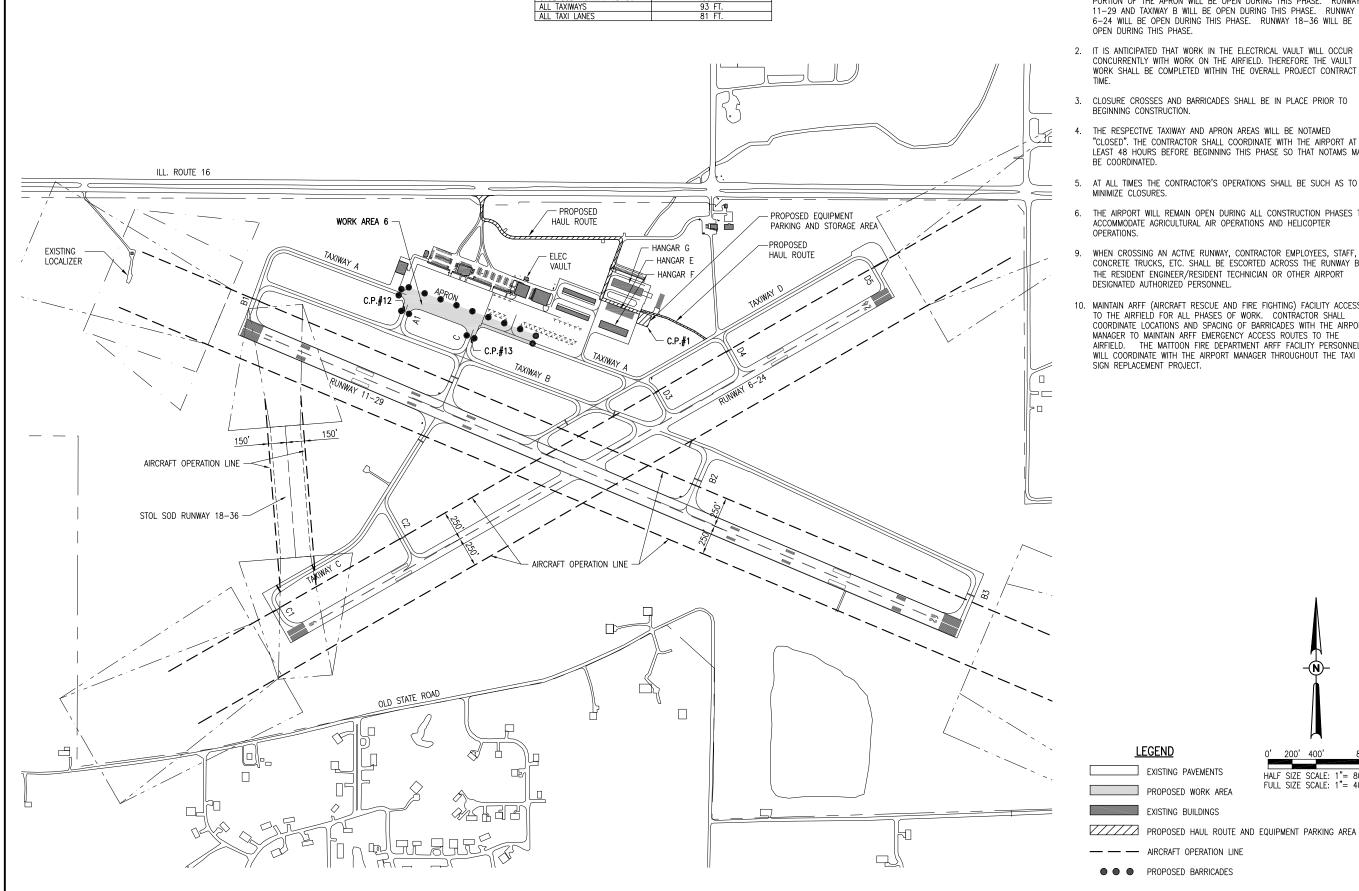



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COLES COUNTY AIRPORT


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COLES COUNTY MEMORIAL AIRPORT

REMOVE AND REPLACE ALL TAXI GUIDANCE SIGNS ON THE AIRPORT

IDA No: MTO-4511 SBG Project No: 3-17-SBGP-XX

Contract No. CO062

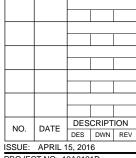

PROJECT NO: 13A0121D

CAD FILE: C-101-KEY.DWG


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DRAWN BY: MLH 02/17/2016

REVIEWED BY: LDH 03/08/2016

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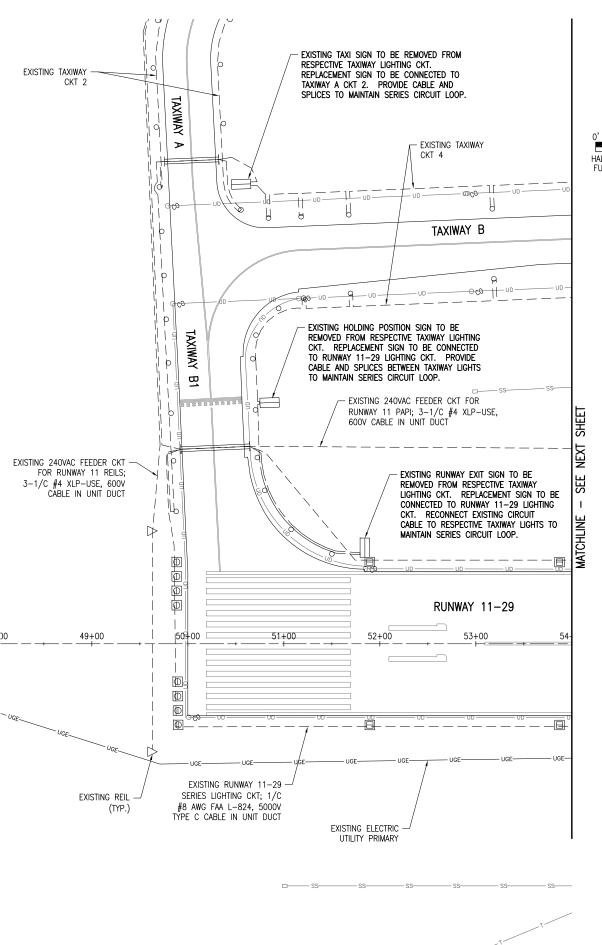
**KEY PLAN** 





- CONTRACTOR SHALL COMPLY WITH THE REQUIREMENTS OF FAA AC NO. 150/5370-2F (OR MOST CURRENT ISSUE) "OPERATIONAL SAFETY ON AIRPORTS DURING CONSTRUCTION"
- CONTRACTOR SHALL COMPLY WITH THE APPLICABLE REQUIREMENTS OF NFPA 70E STANDARD FOR ELECTRICAL SAFETY IN THE WORKPLACE.
- 5. THE EXISTING TAXI GUIDANCE SIGNS, THEIR ISOLATED TRANSFORMERS, AND THE CONCRETE FOUNDATIONS DESIGNATED FOR REMOVAL SHALL BE REMOVED AND DISPOSED OF, OFF THE AIRPORT SITE IN A LEGAL MANNER. THE AIRPORT WILL RETAIN THE RIGHT OF FIRST REFUSAL REGARDING SALVAGE OF SIGNS, OR SIGN PARTS. SIGNS NOT SALVAGED BY THE AIRPORT SHALL BE REMOVED AND DISPOSED OF OFF THE AIRPORT SITE. REMOVAL OF THE EXISTING TAXI GUIDANCE SIGNS WILL BE PAID FOR UNDER ITEM AR125904 REMOVE TAXI GUIDANCE SIGN, PER EACH.
- 6. EXISTING RUNWAY EXIT SIGNS AND HOLDING POSITION SIGNS ARE UNDERSTOOD TO BE CONNECTED TO TAXIWAY LIGHTING CIRCUITS. REPLACEMENT RUNWAY EXIT SIGNS AND HOLDING POSITION SIGNS SHALL BE CONNECTED TO THE RESPECTIVE RUNWAY LIGHTING CIRCUIT. PROVIDE CABLE AND SPLICES TO MAINTAIN AIRFIELD LIGHTING SERIES CIRCUIT LOOPS. CABLE SHALL BE 1/C #8 AWG FAA L-824, 5000 VOLT TYPE C UG CABLE IN UNIT DUCT. SPLICES SHALL BE FAA L-823 SIZED FOR THE RESPECTIVE CABLE.
- ALL ABOVEGROUND JUMPERS SHALL BE IN A DUCT WITH ALL CONNECTIONS SEALED.
  THE CONTRACTOR SHALL SECURE, IDENTIFY AND PLACE ALL TEMPORARY EXPOSED
  WIRING IN CONDUIT, DUCT, OR UNIT DUCT TO PREVENT ELECTROCUTION AND FIRE
  IGNITION SOURCES AS PER THE REQUIREMENTS OF FAA 150/5370-2F, OPERATION
  SAFETY ON AIRPORTS DURING CONSTRUCTION, SECTION 218, c.
- 8. THE CONTRACTOR IS REQUIRED TO FILL IN ALL HOLES AND DEPRESSIONS RESULTING FROM THE LIGHT, AND/OR BASE REMOVAL WITH EARTH MATERIAL. THE AREAS SHALL BE COMPACTED TO PREVENT FUTURE SETTLEMENT AND FERTILIZED, SEEDED, AND MULCHED IN ACCORDANCE WITH ITEMS 901 AND 908 RESPECTIVELY.
- 9. WHEN A RESPECTIVE RUNWAY IS CLOSED THE NAVAIDS FOR THAT RUNWAY SHALL BE SHUT OFF.
- 10. CONTRACTOR SHALL CONFIRM RESPECTIVE AIRFIELD LIGHTING CIRCUITS.
- 11. NO CONNECTION TO AN ACTIVE LIGHTING CIRCUIT SHALL BE BROKEN UNTIL THE CIRCUIT HAS BEEN TURNED OFF IN ACCORDANCE WITH THE ABOVE NOTE 1.

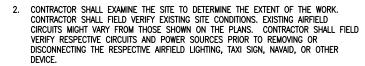THE LOCATION, SIZE, AND TYPE OF MATERIAL OF EXISTING UNDERGROUND AND/OR ABOVEGROUND UTILITIES INDICATED ON THE PLANS ARE NOT REPRESENTED AS BEING ACCURATE, SUFFICIENT OR COMPLETE. NEITHER THE OWNER NOR THE ENGINEER ASSUMES ANY RESPONSIBILITY WHATEVER IN RESPECT TO THE ACCURACY, COMPLETENESS, OR SUFFICIENCY OF THE INFORMATION. THERE IS NO GUARANTEE, EITHER EXPRESSED OR IMPLIED, THAT THE LOCATIONS, SIZE AND TYPE OF MATERIAL OF EXISTING UNDERGROUND UTILITIES INDICATED ARE REPRESENTATIVE OF THOSE TO BE ENCOUNTERED IN THE CONSTRUCTION. IT SHALL BE THE CONTRACTOR'S RESPONSIBILITY TO DETERMINE THE ACTUAL LOCATION OF ALL SUCH FACILITIES, INCLUDING SERVICE CONNECTIONS TO UNDERGROUND UTILITIES. PRIOR TO CONSTRUCTION, THE CONTRACTOR SHALL NOTIFY THE UTILITY COMPANIES OF HIS OPERATIONAL PLANS AND SHALL OBTAIN FROM THE RESPECTIVE UTILITY COMPANIES OF HIS OPERATIONAL PLANS AND SHALL OBTAIN FROM THE RESPECTIVE UTILITY COMPANIES OF HIS OPERATIONAL PLANS AND SHALL OBTAIN FROM THE RESPECTIVE UTILITY COMPANIES OF HIS OPERATION, THE CONTRACTOR SHALL NOTIFY THE CONTINUOUS OF THE LOCATION OF THEIR FACILITIES AND THE WORKING SCHEDULE OF THE COMPANIES FOR REMOVAL OR ADJUSTMENT WHERE REQUIRED. IN THE EVENT AN UNEXPECTED UTILITY INTERFERENCE IS ENCOUNTERED DURING CONSTRUCTION, THE CONTRACTOR SHALL IMMEDIATELY NOTIFY THE UTILITY COMPANY OF JURISDICTION. THE OWNER'S REPRESENTATIVE AND/OR THE RESIDENT ENGINEER SHALL ALSO BE IMMEDIATELY NOTIFIED. ANY DAMAGE TO SUCH MAINS AND SERVICES SHALL BE RESTORED TO SERVICE AT ONCE AND PAID FOR BY THE CONTRACTOR AT NO ADDITIONAL COST TO THE CONTRACT.

ALL UTILITY CABLES AND LINES SHALL BE LOCATED BY THE RESPECTIVE UTILITY. CONTACT JULE (JOINT UTILITY LOCATION INFORMATION FOR EXCAVATORS) FOR UTILITY INFORMATION, PHONE: 1-800-892-0123. CONTACT THE FAA (FEDERAL AVIATION ADMINISTRATION) FOR ASSISTANCE IN LOCATING FAA CABLES AND UTILITIES. LOCATION OF FAA POWER, CONTROL, AND COMMUNICATION CABLES SHALL BE COORDINATED WITH AND/OR LOCATED BY THE FAA. ALSO CONTACT AIRPORT DIRECTOR/MANAGER AND AIRPORT PERSONNEL FOR ASSISTANCE IN LOCATING UNDERGROUND AIRPORT CABLES AND/OR UTILITIES. ALSO COORDINATE WORK WITH ALL ABOYEGROUND UTILITIES.




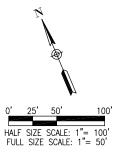

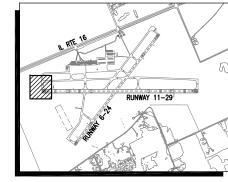

<u>KEY MAP</u>

**LEGEND** 

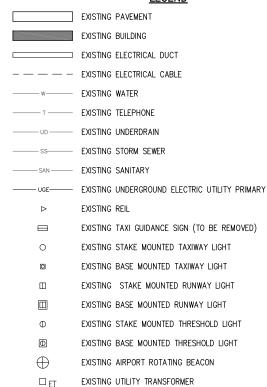



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COLES COUNTY AIRPORT
AUTHORITY
COLES COUNTY MEMORIAL AIRPORT

REMOVE AND REPLACE ALL TAXI GUIDANCE SIGNS ON THE AIRPORT

IDA No: MTO-4511 SBG Project No: 3-17-SBGP-XX


Contract No. CO062

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DESIGN	BY: KN	L 02/	13/201	6
DRAWN	BY: MLI	H 02/1	7/2016	3

SHEET TITLE

EXISTING TAXI GUIDANCE SIGN PLAN SHEET 1

REVIEWED BY: LDH 03/08/2016

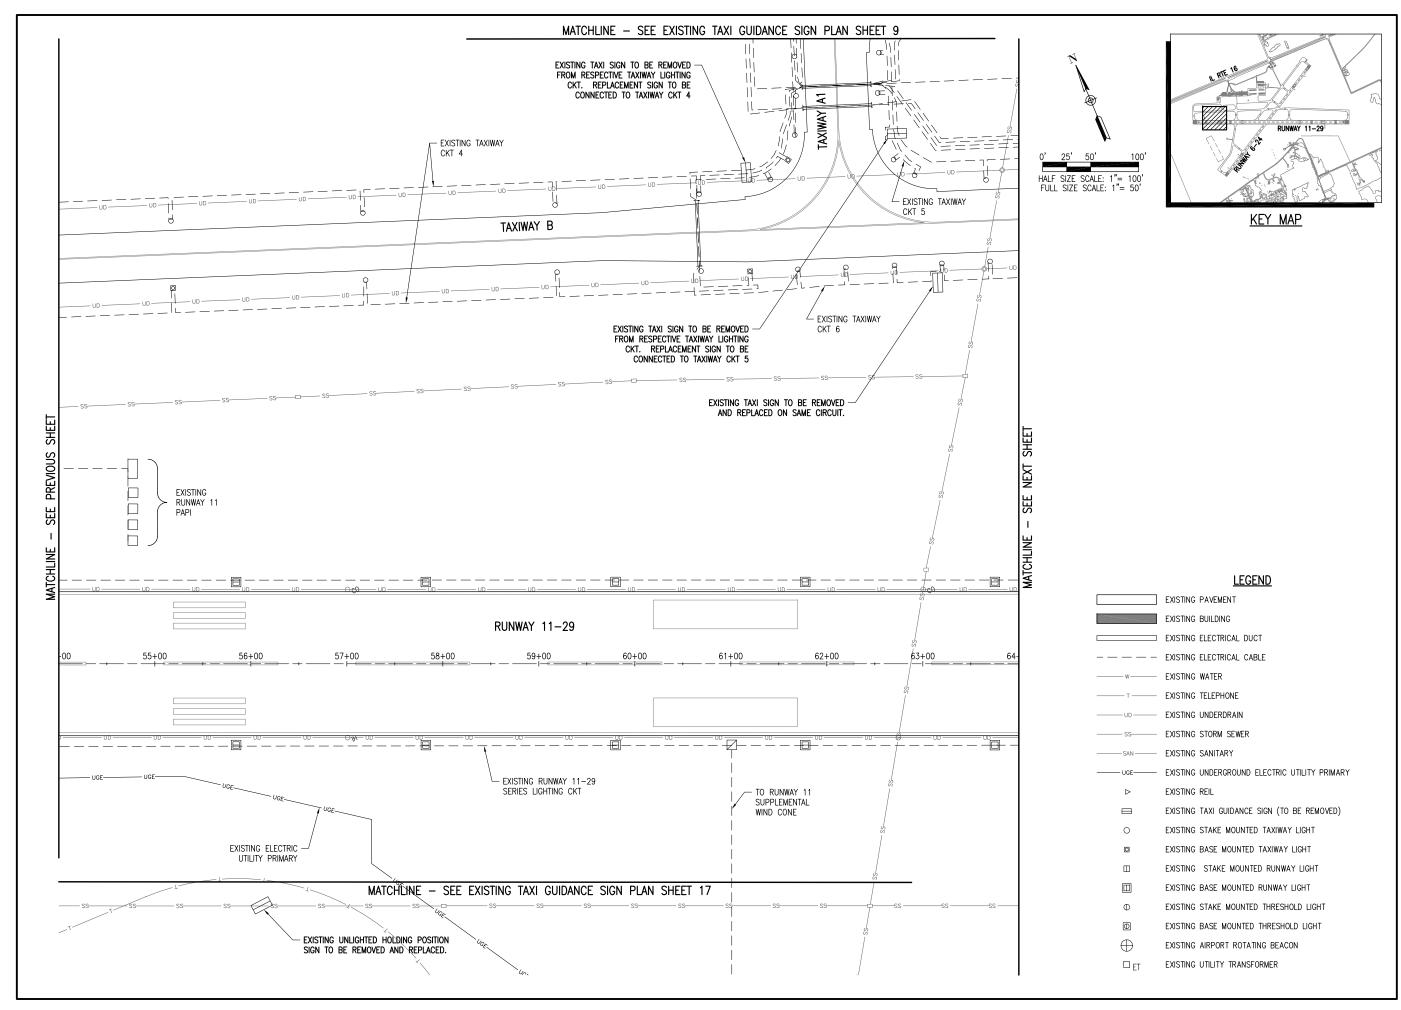



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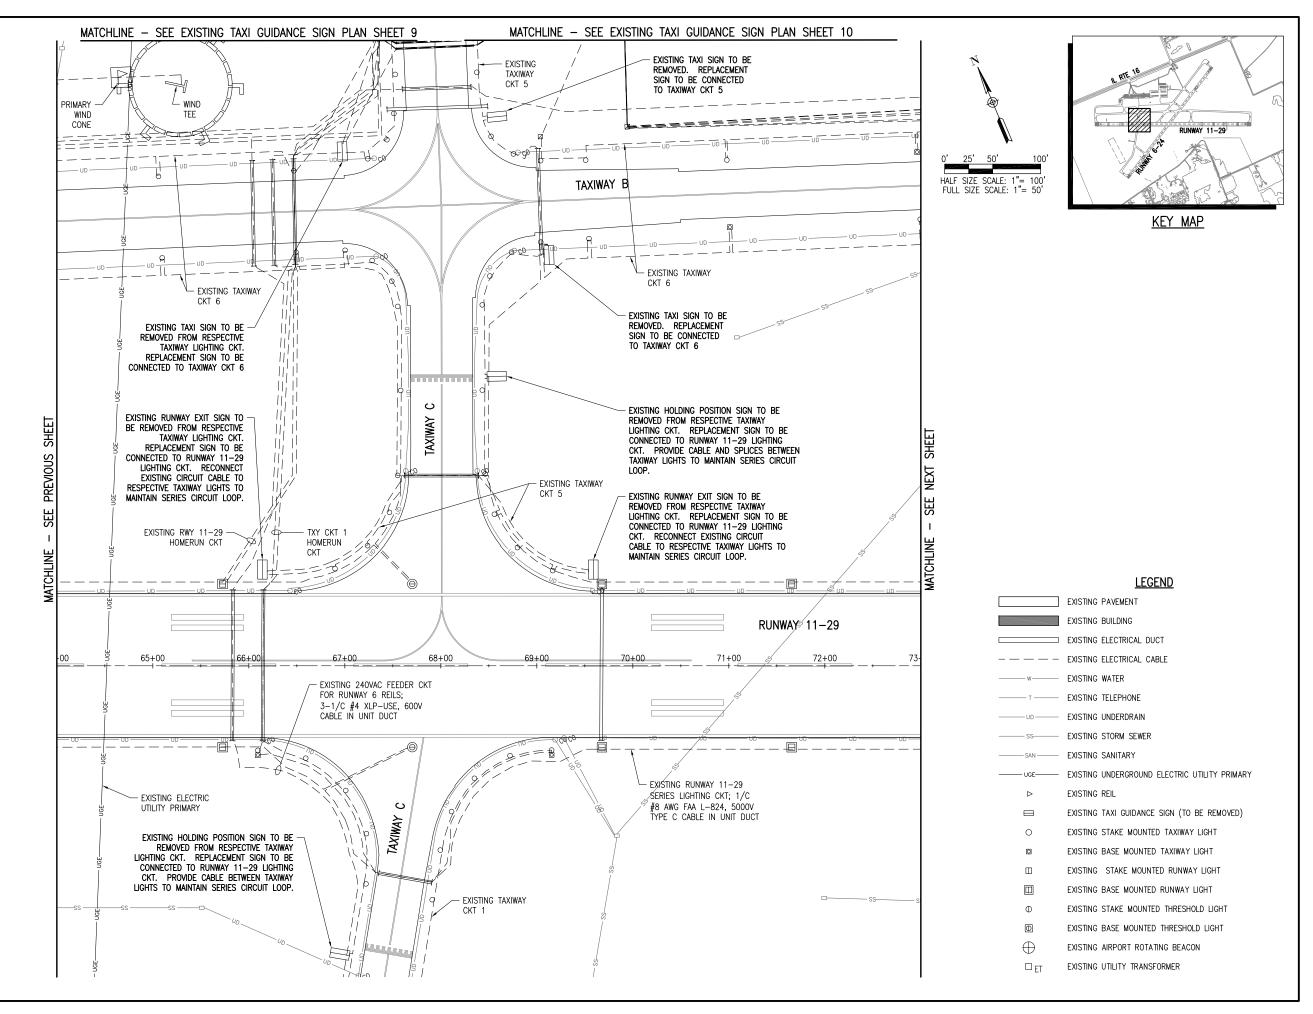
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SHEET TITLE



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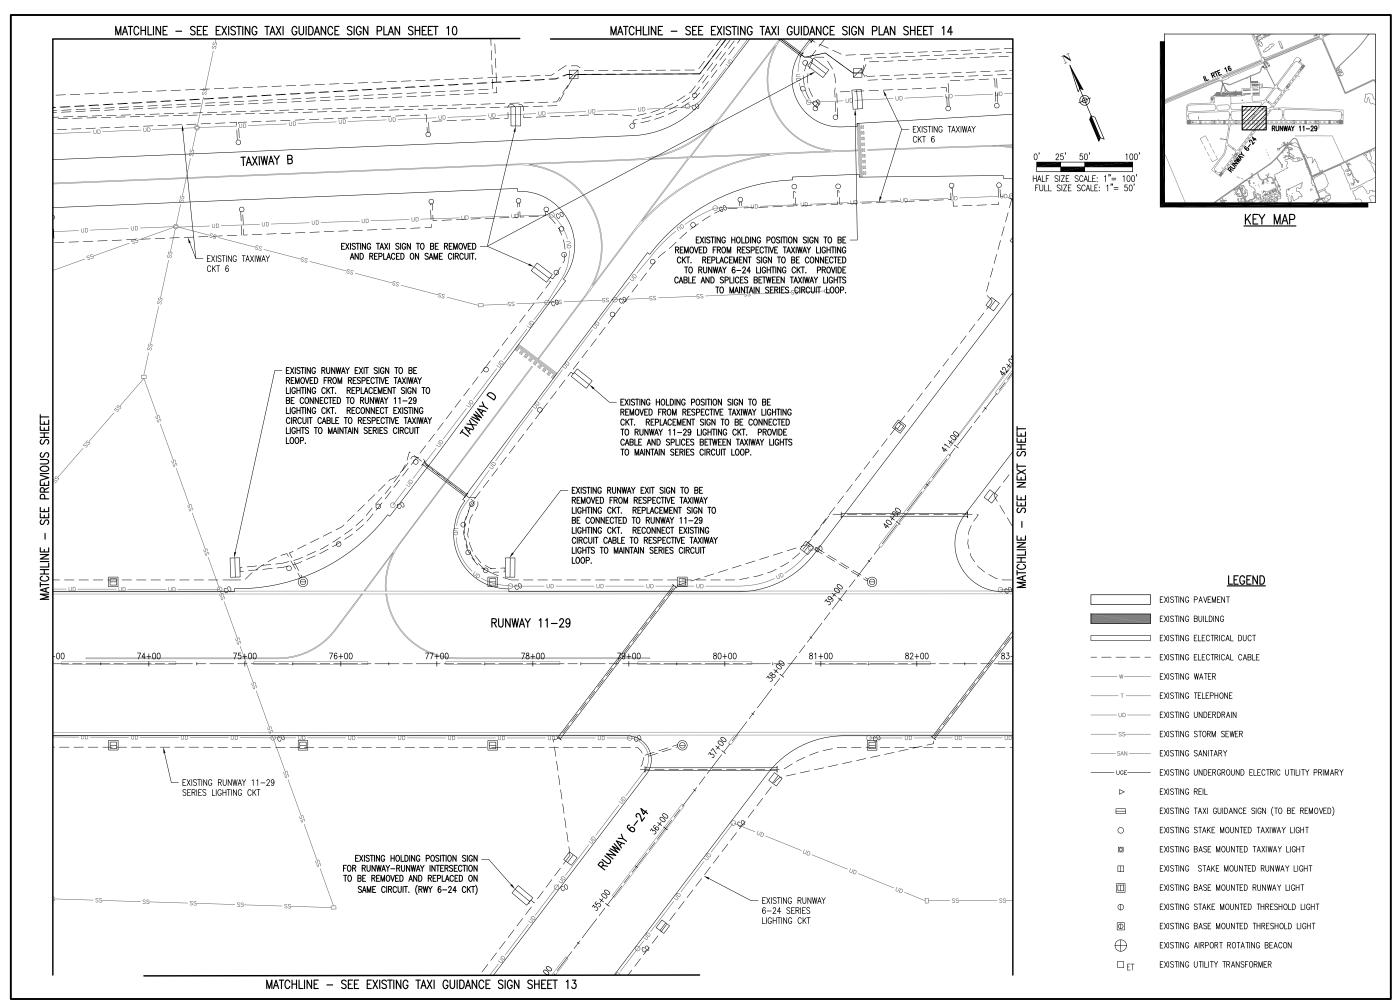
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REVIEWED BY: LDH 03/08/2016

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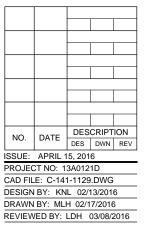
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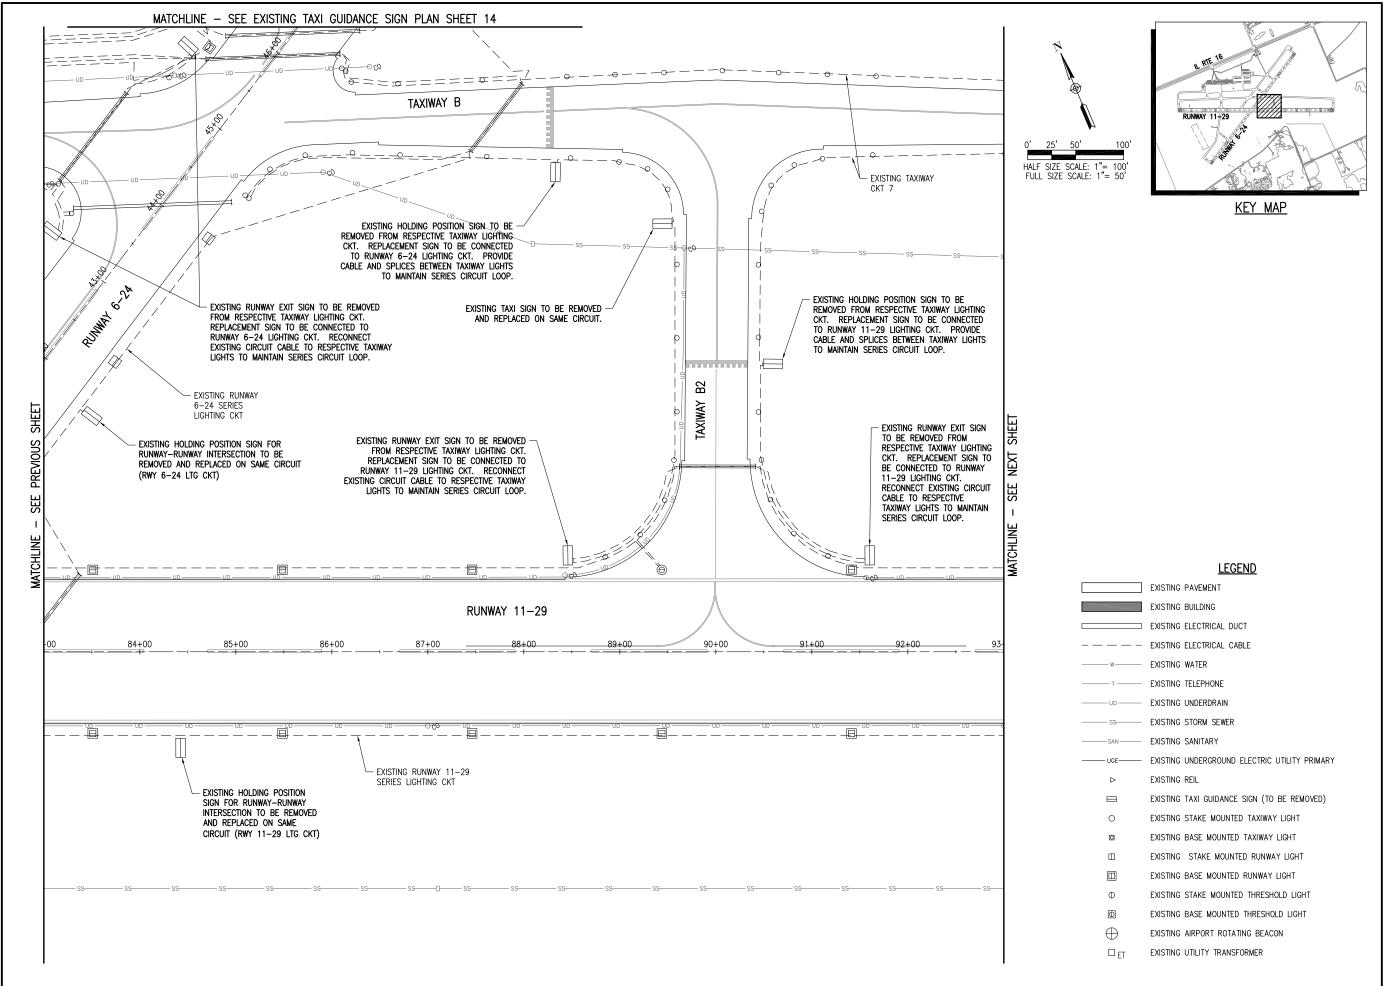
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EXISTING TAXI

SHEET TITLE

GUIDANCE SIGN PLAN SHEET 4



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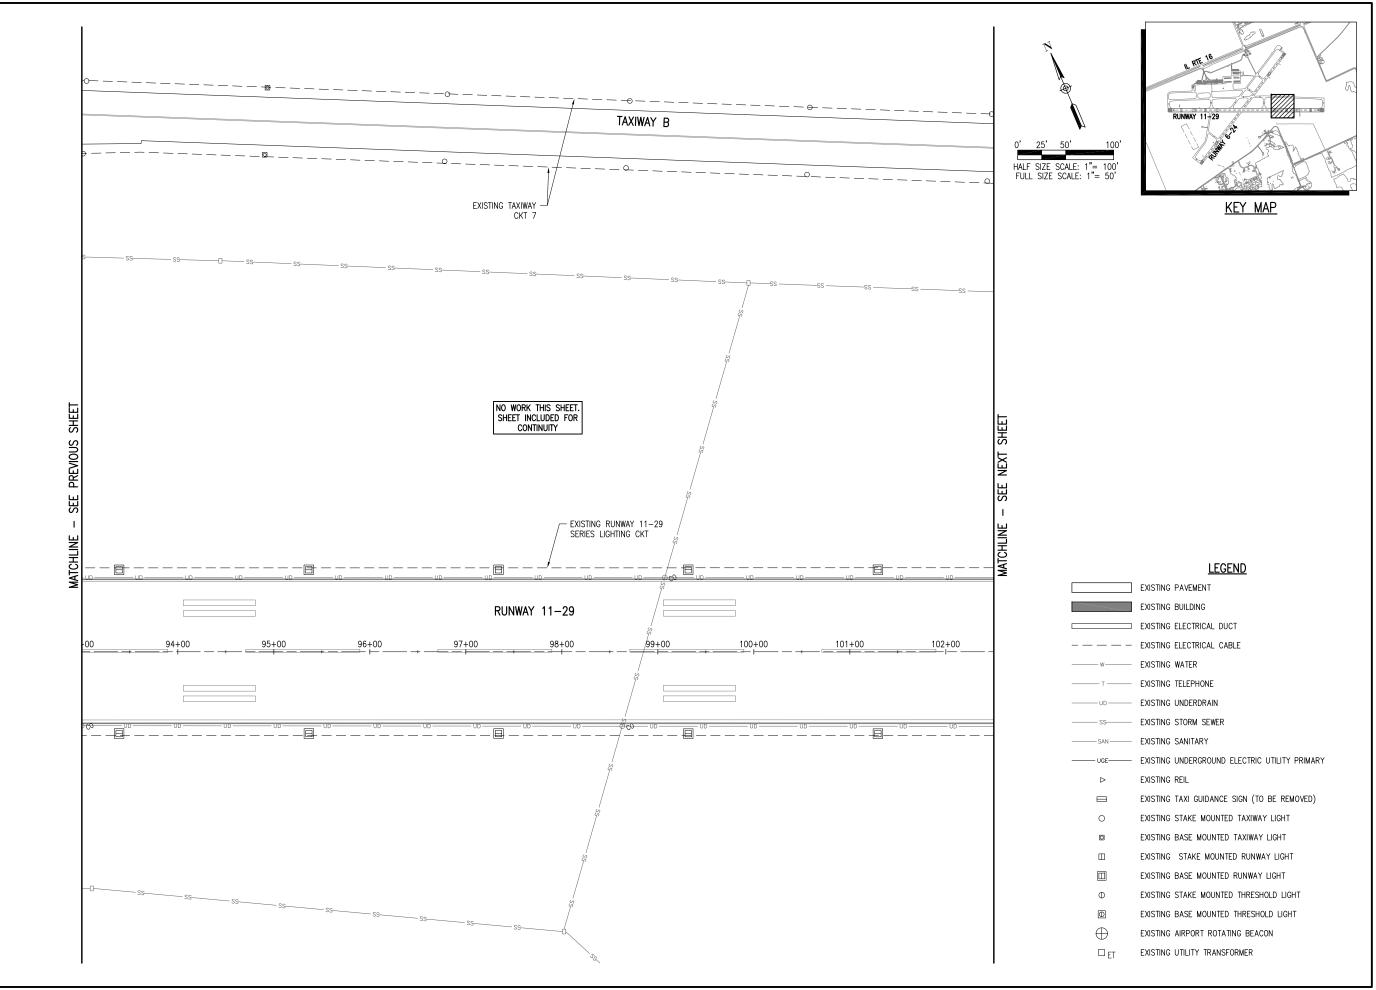
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Contract No. CO062

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DESIGN BY: KNL 02/13/2016					
DRAWN	DRAWN BY: MLH 02/17/2016				
REVIEW	/ED BY:	LDH	03/08/2	2016	

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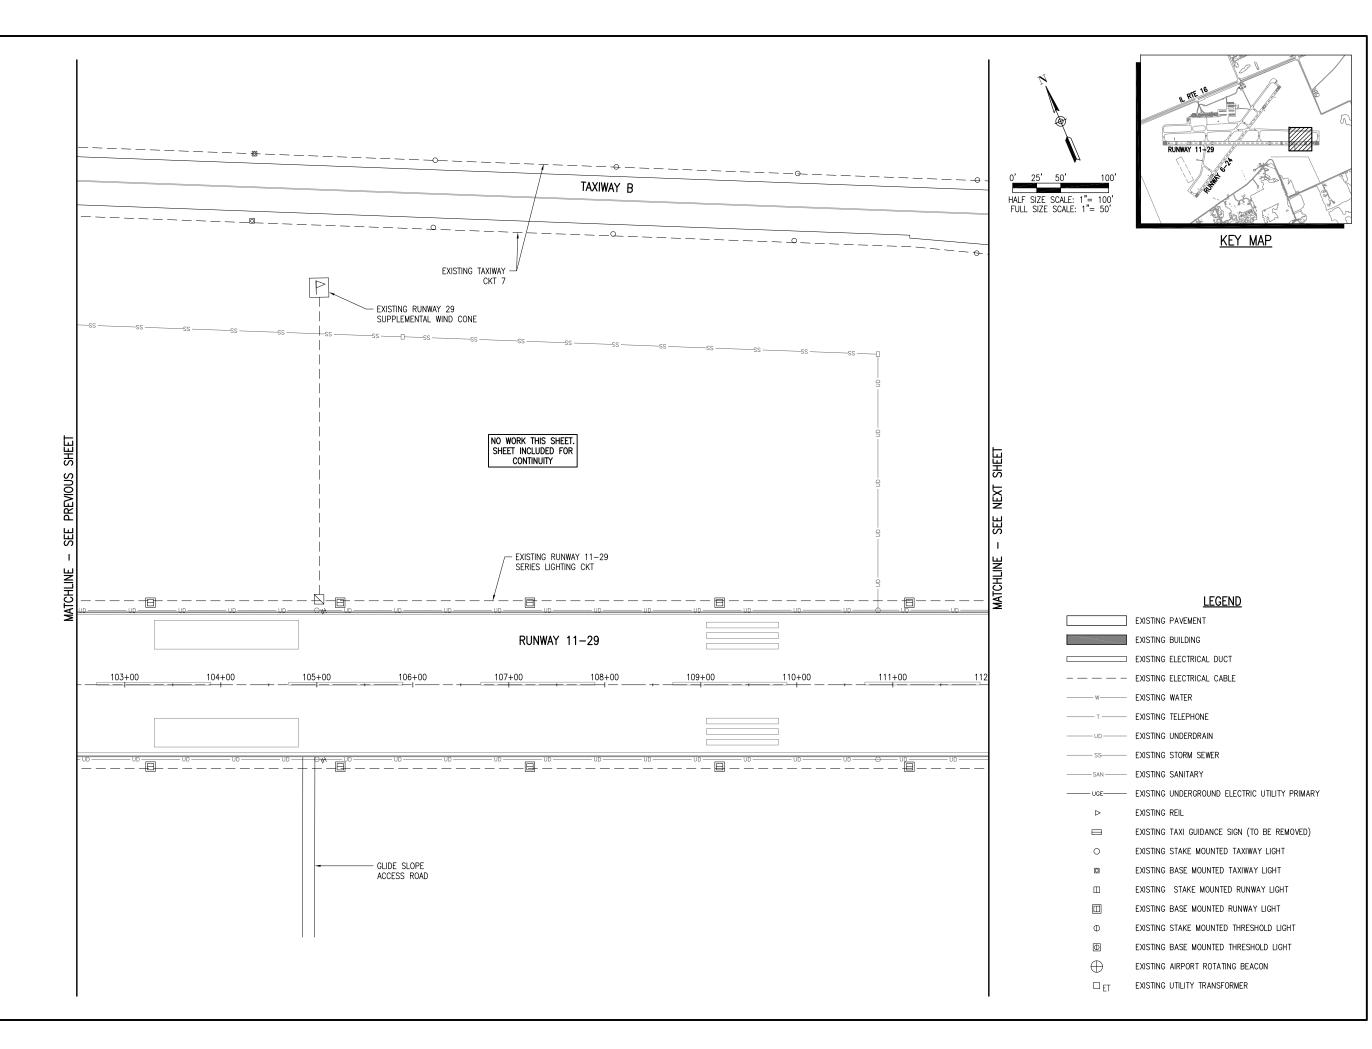
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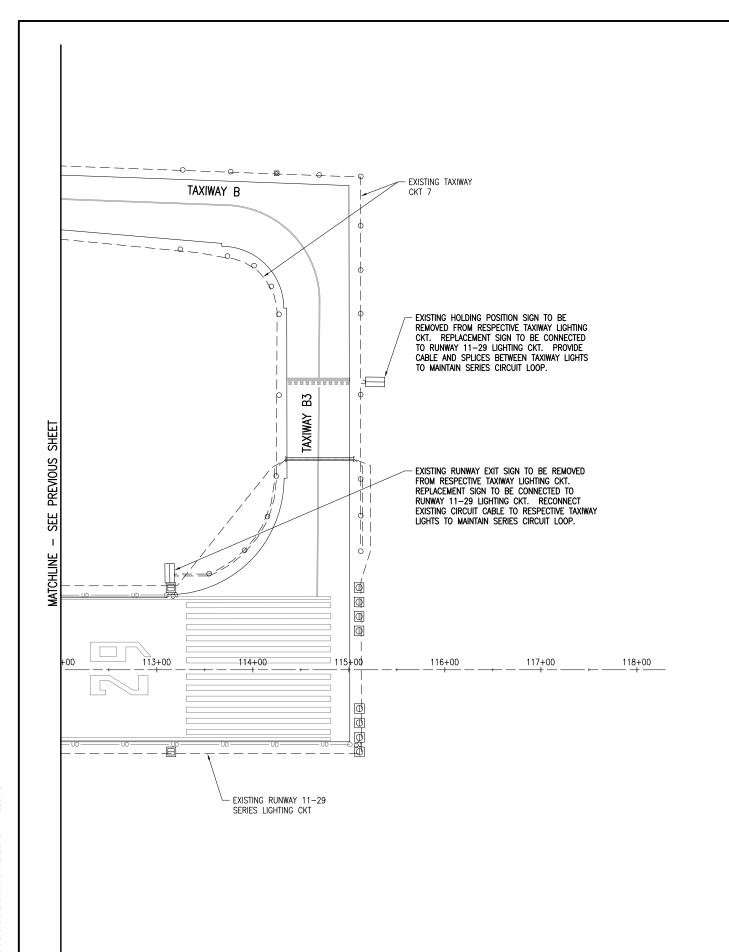
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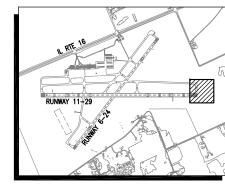
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REVIEW	/ED BY:	LDH	03/08/2	2016

SHEET TITLE







<u>KEY MAP</u>

#### **LEGEND**

	EXISTING PAVEMENT
	EXISTING BUILDING
	EXISTING ELECTRICAL DUCT
	EXISTING ELECTRICAL CABLE
W	EXISTING WATER
т	EXISTING TELEPHONE
UD	EXISTING UNDERDRAIN
——— SS———	EXISTING STORM SEWER
SAN	EXISTING SANITARY
UGE	EXISTING UNDERGROUND ELECTRIC UTILITY PRIMARY
$\triangleright$	EXISTING REIL
	EXISTING TAXI GUIDANCE SIGN (TO BE REMOVED)
0	EXISTING STAKE MOUNTED TAXIWAY LIGHT
O	EXISTING BASE MOUNTED TAXIWAY LIGHT
	EXISTING STAKE MOUNTED RUNWAY LIGHT
	EXISTING BASE MOUNTED RUNWAY LIGHT
Φ	EXISTING STAKE MOUNTED THRESHOLD LIGHT
Φ	EXISTING BASE MOUNTED THRESHOLD LIGHT
$\oplus$	EXISTING AIRPORT ROTATING BEACON

EXISTING UTILITY TRANSFORMER



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REMOVE AND REPLACE ALL TAXI GUIDANCE SIGNS ON THE AIRPORT


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Contract No. CO062

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ISSUE:	APRIL 1	5, 201	6	
PROJEC	CT NO: 1	3A012	1D	
CAD FIL	E: C-14	1-1129	.DWG	
DESIGN	BY: KN	L 02/	13/201	6
DRAWN	BY: MLI	H 02/1	7/2016	3

REVIEWED BY: LDH 03/08/2016

SHEET TITLE



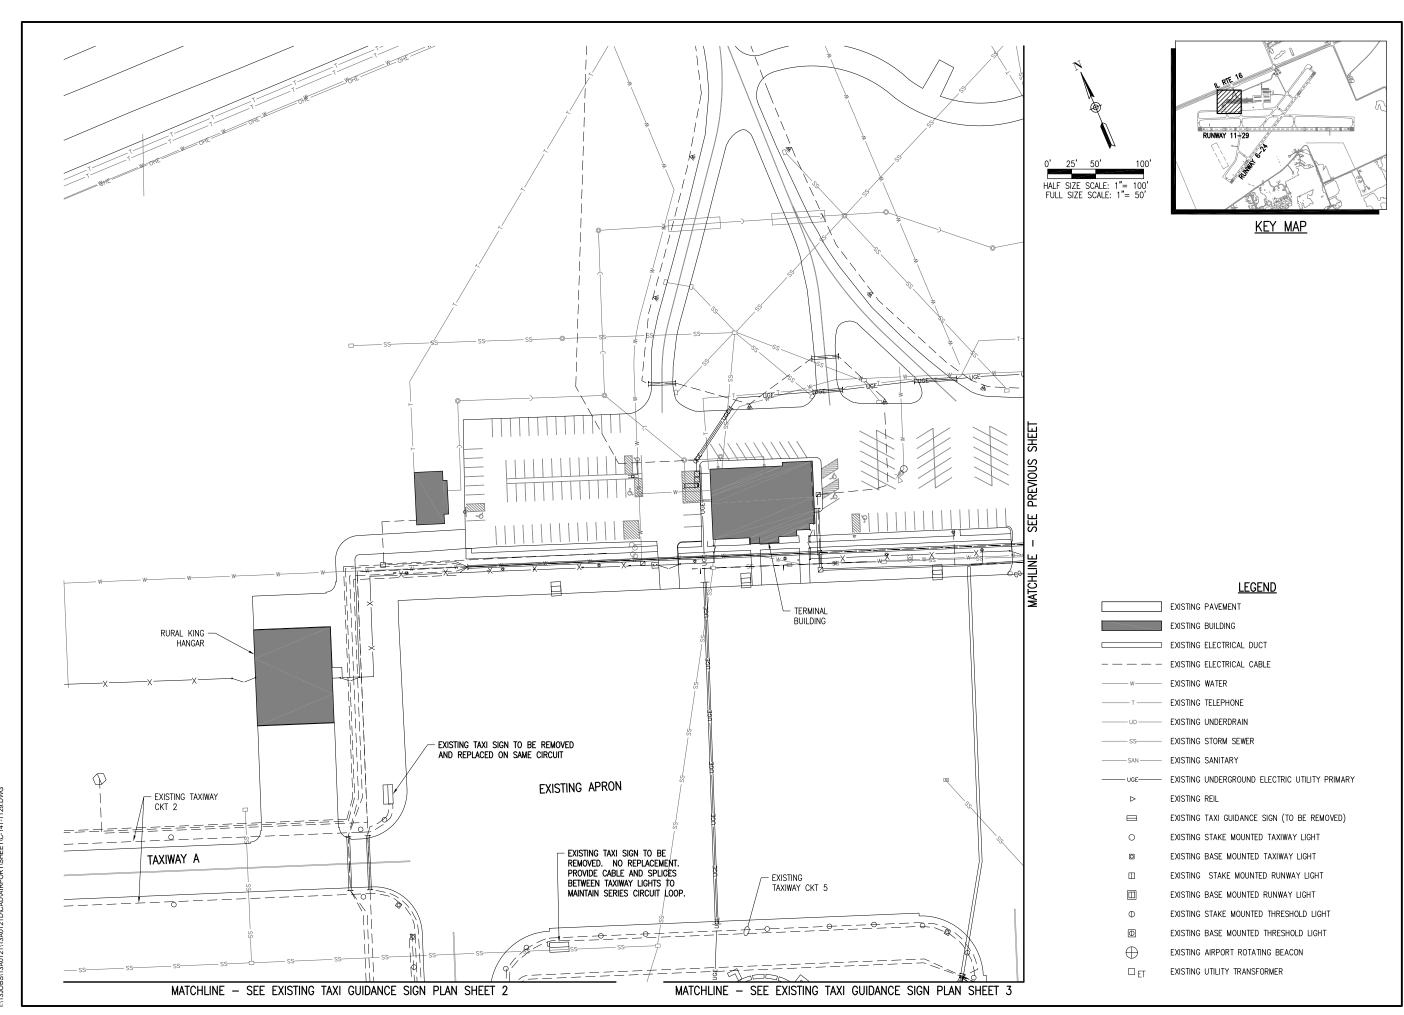

Hanson Professional Services Inc. 1525 S. 6th Street Springfield, IL 62568 phone: 217-788-2450 fax: 217-788-2503

Illinois Licensed Professional Service Corporation #184-001084

COLES COUNTY AIRPORT
AUTHORITY
COLES COUNTY MEMORIAL AIRPORT

REMOVE AND REPLACE ALL TAXI GUIDANCE SIGNS ON THE AIRPORT

IDA No: MTO-4511 SBG Project No: 3-17-SBGP-XX

Contract No. CO062

NO.	DATE	DES	CRIPT	ION	
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PROJEC	PROJECT NO: 13A0121D				
CAD FILE: C-141-1129.DWG					
DESIGN	BY: KN	L 02/	13/201	6	
DRAWN	DRAWN BY: MLH 02/18/2016				

REVIEWED BY: LDH 03/08/2016

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COLES COUNTY AIRPORT


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REMOVE AND REPLACE ALL TAXI GUIDANCE SIGNS ON THE AIRPORT


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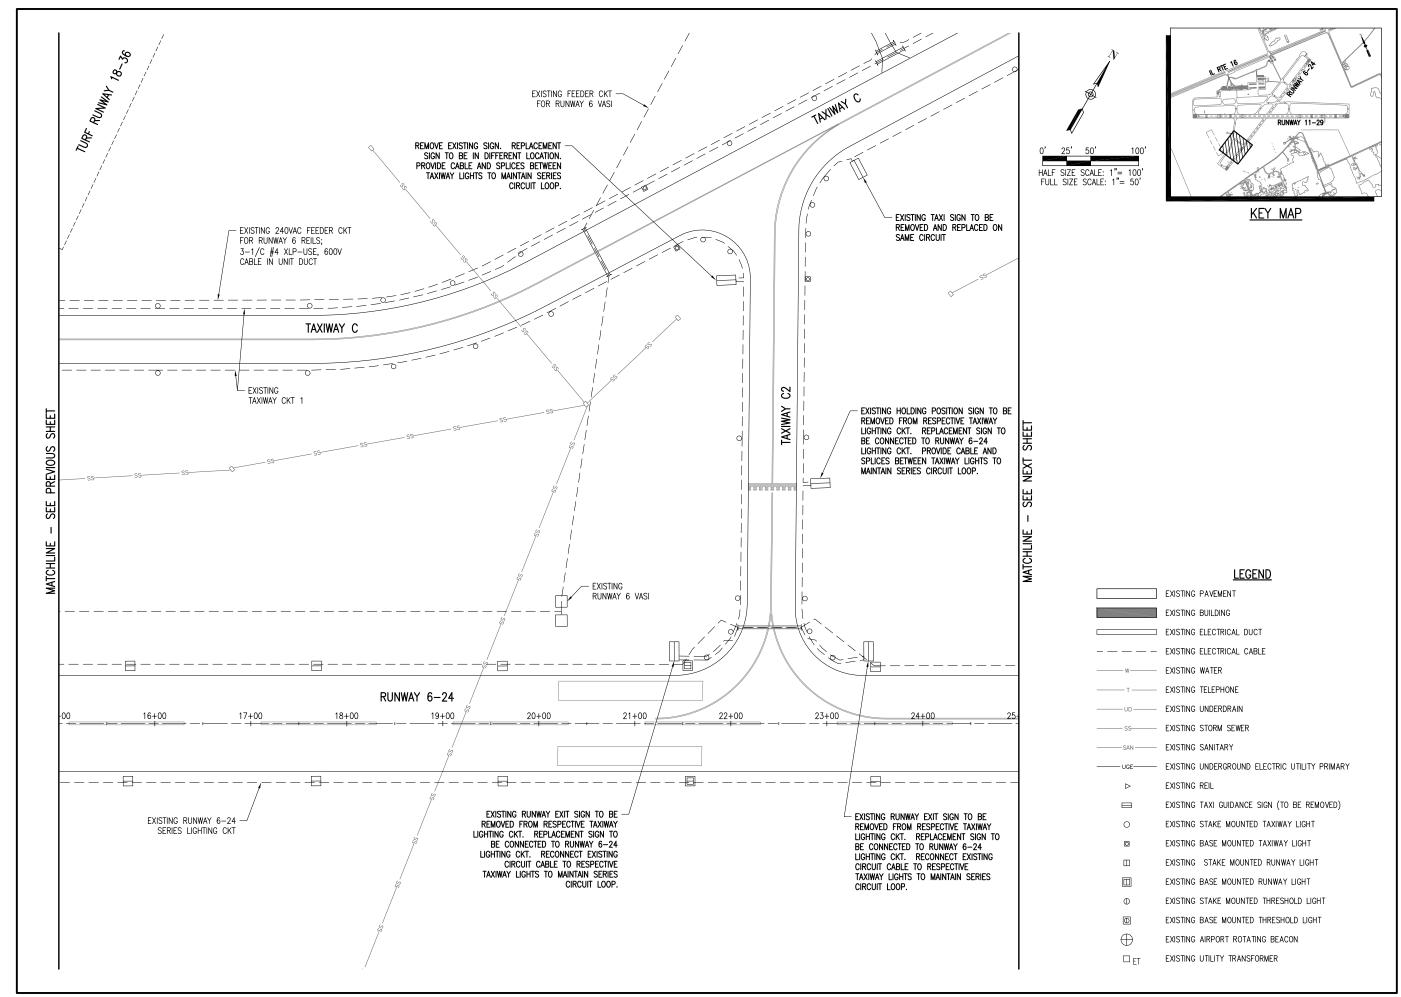
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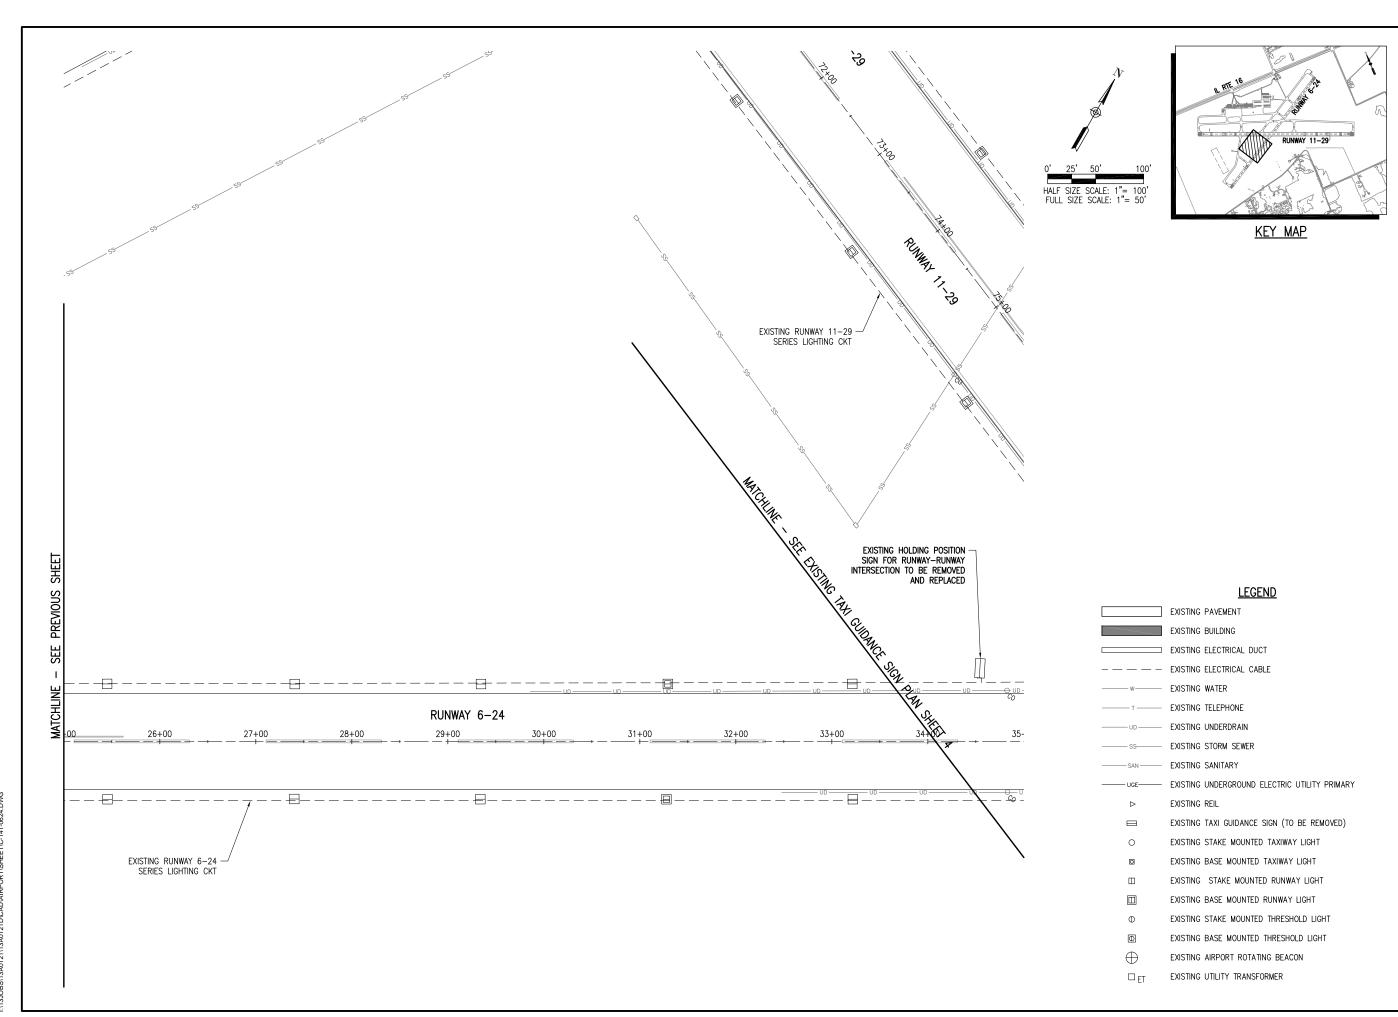
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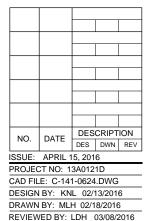
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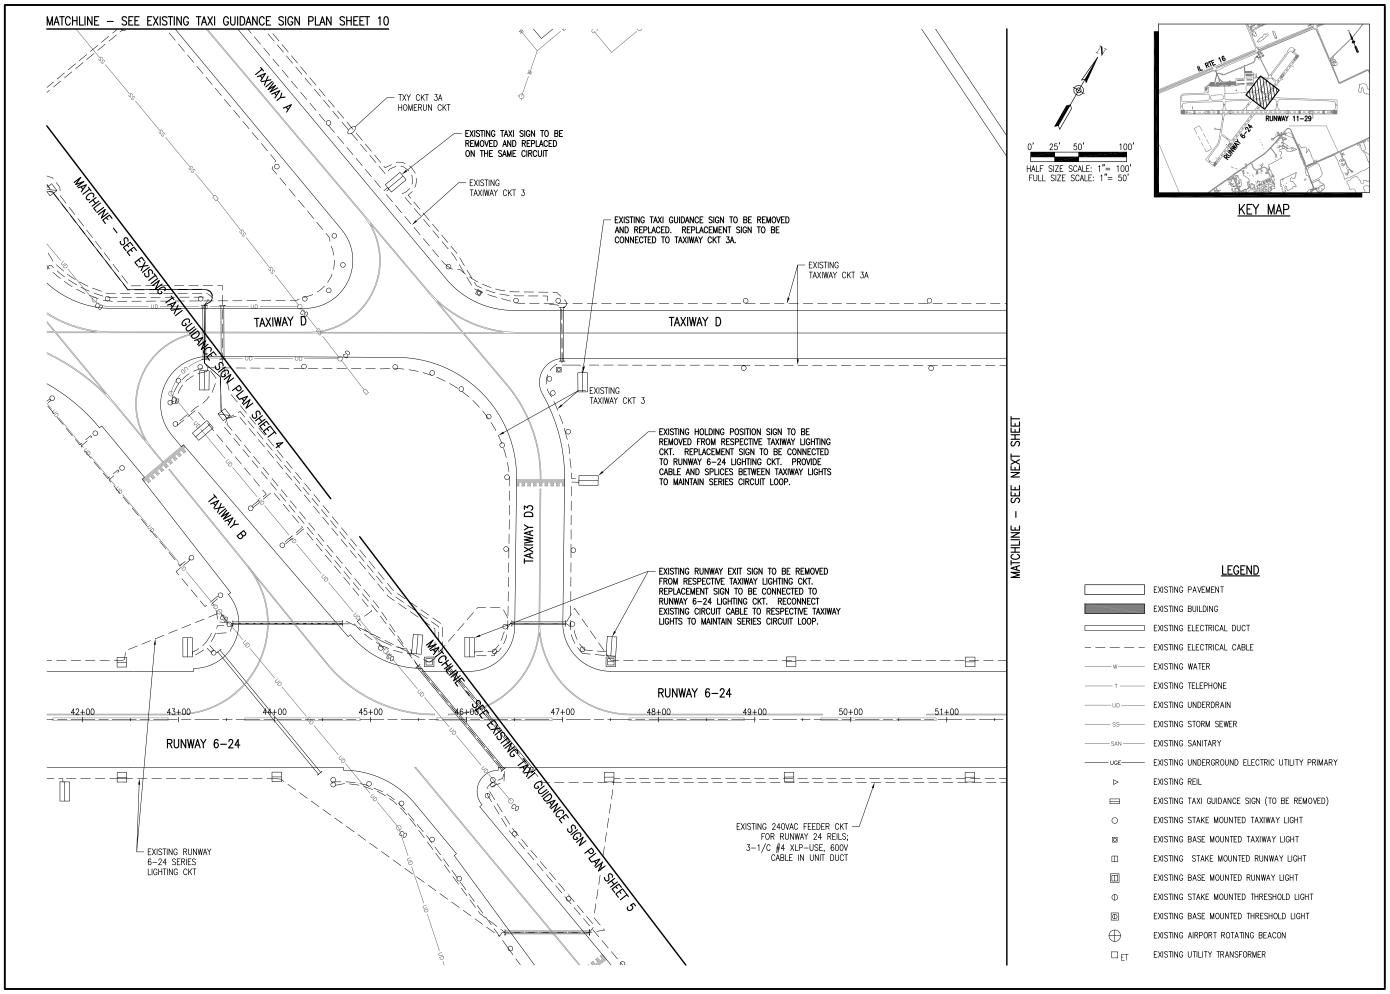
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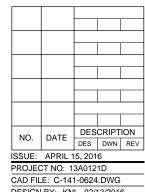
Illinois Licensed Professional Service Corporation #184-001084

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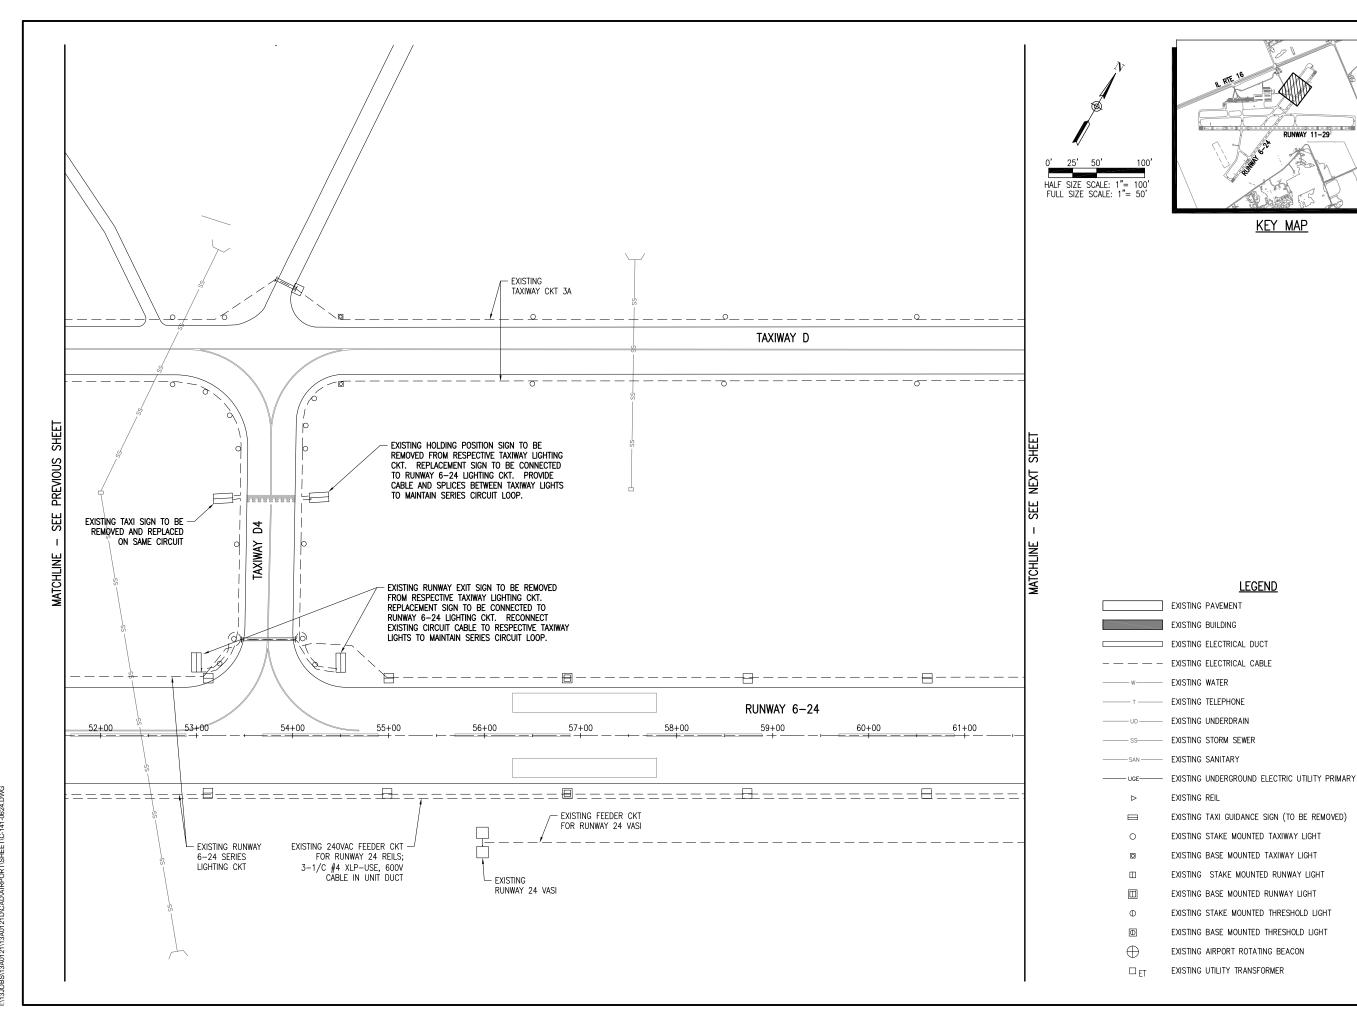
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DESIGN BY: KNL 02/13/2016

DRAWN BY: MLH 02/18/2016 REVIEWED BY: LDH 03/08/2016

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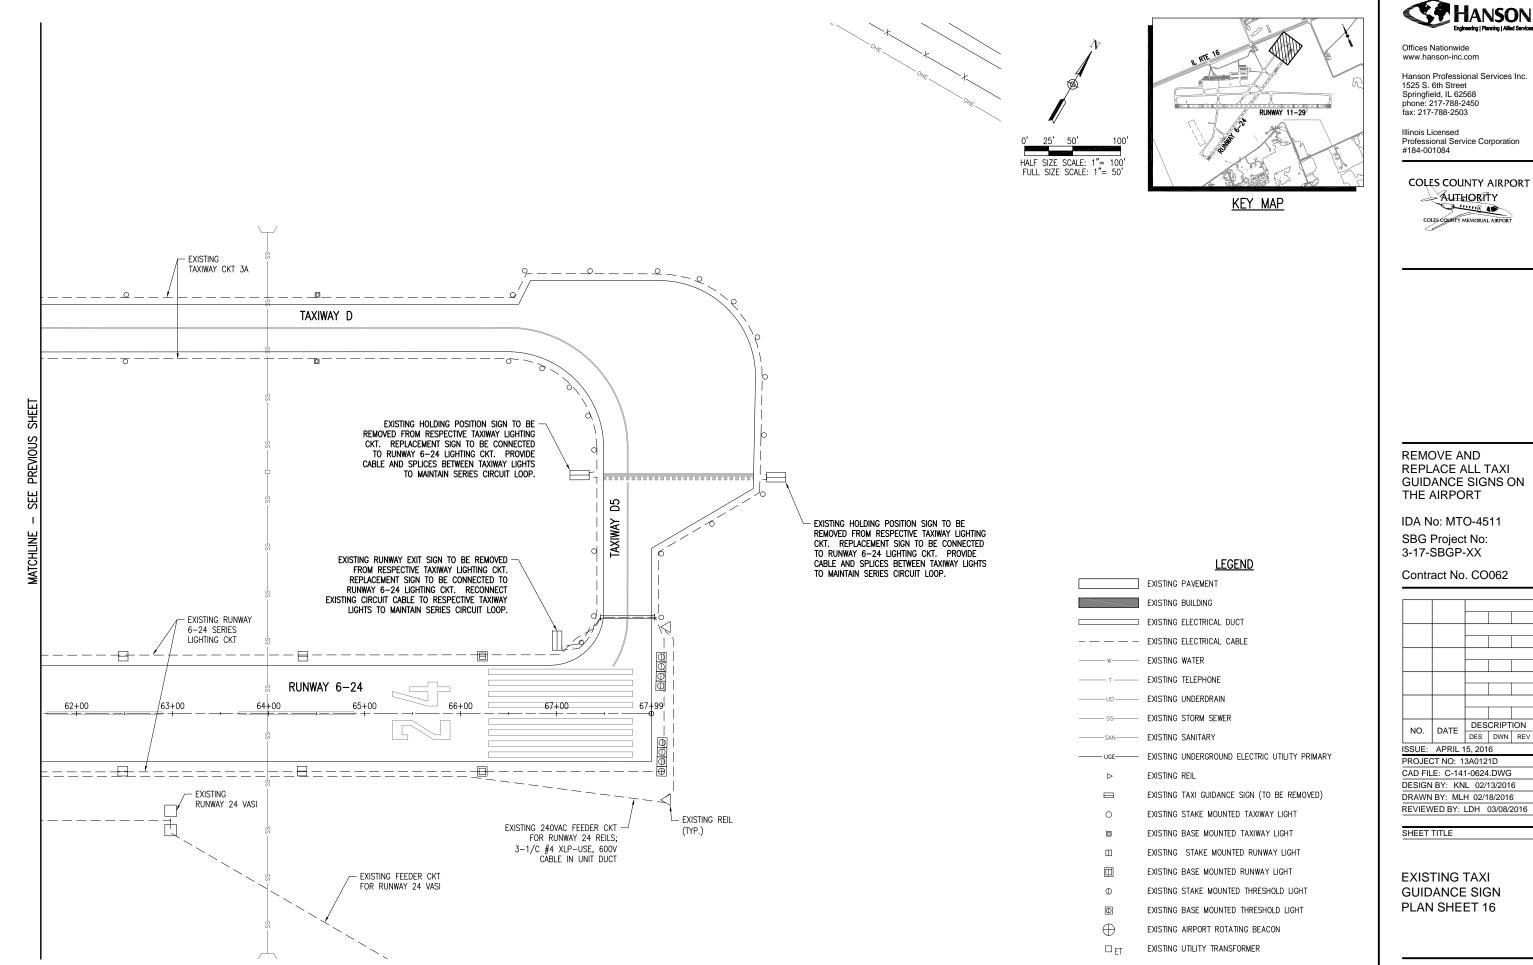
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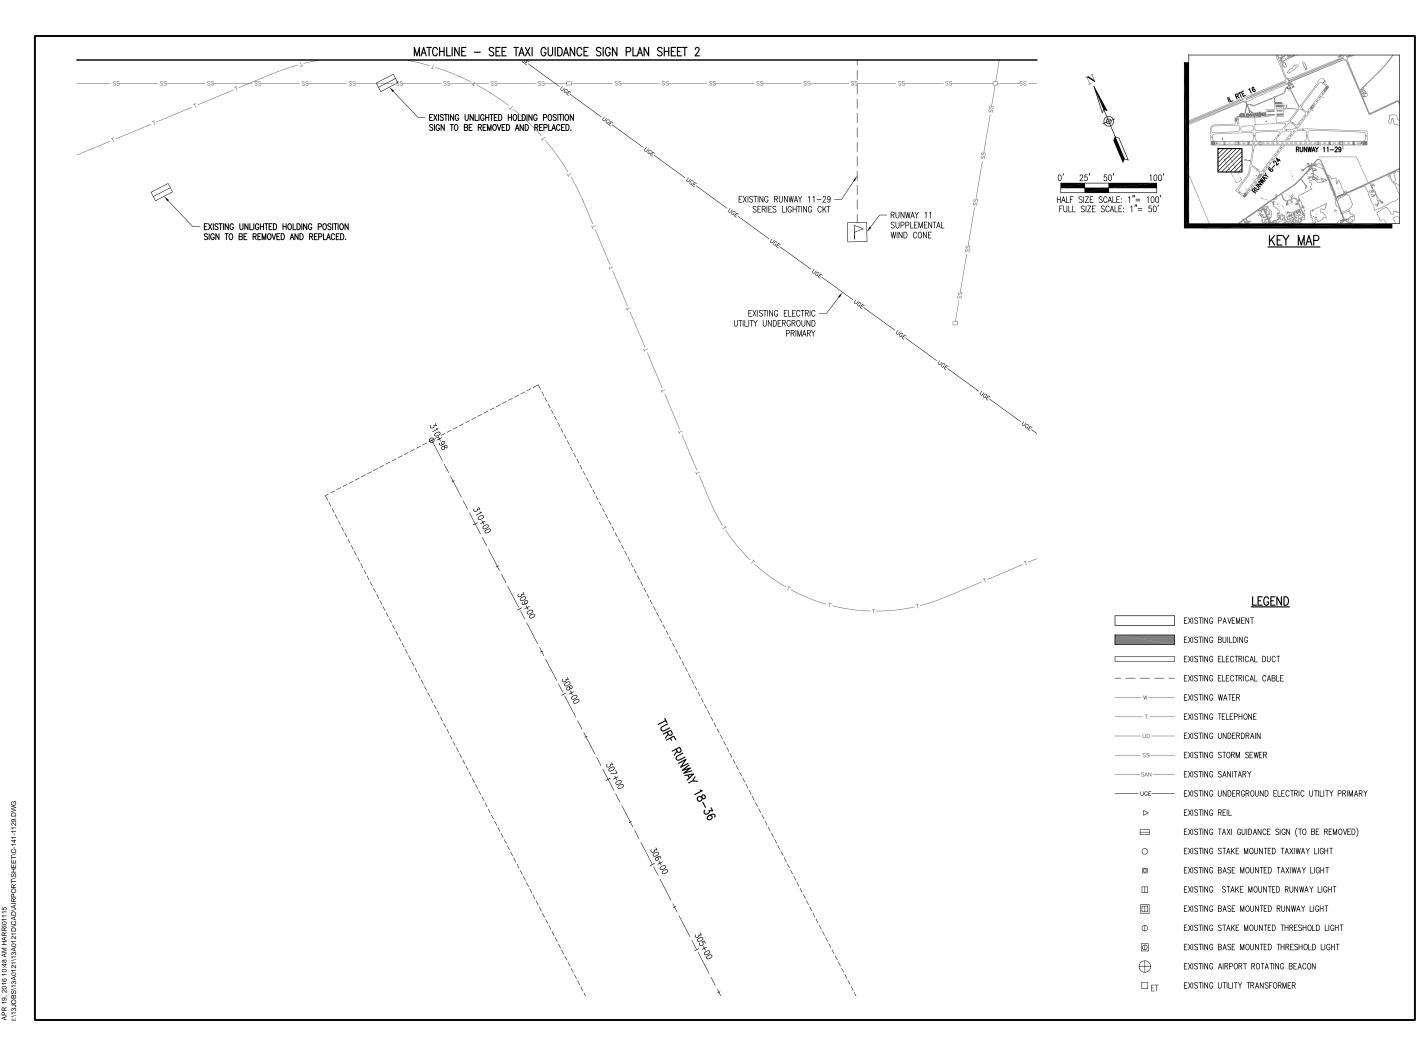
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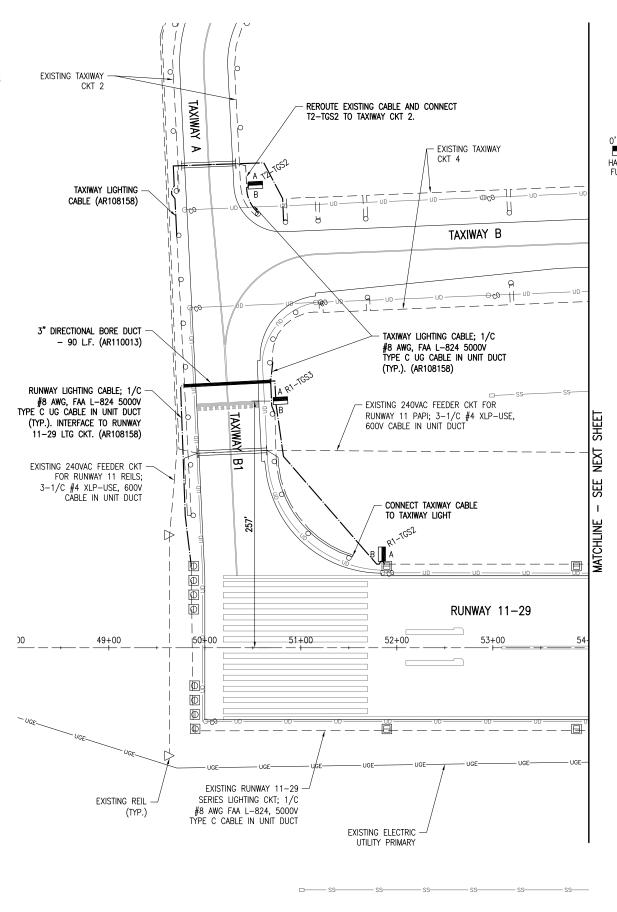
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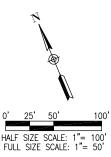
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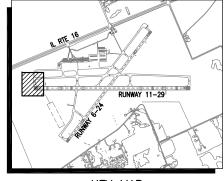
SHEET TITLE
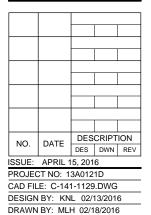
#### TAXI SIGN AND AIRFIELD LIGHTING NOTES

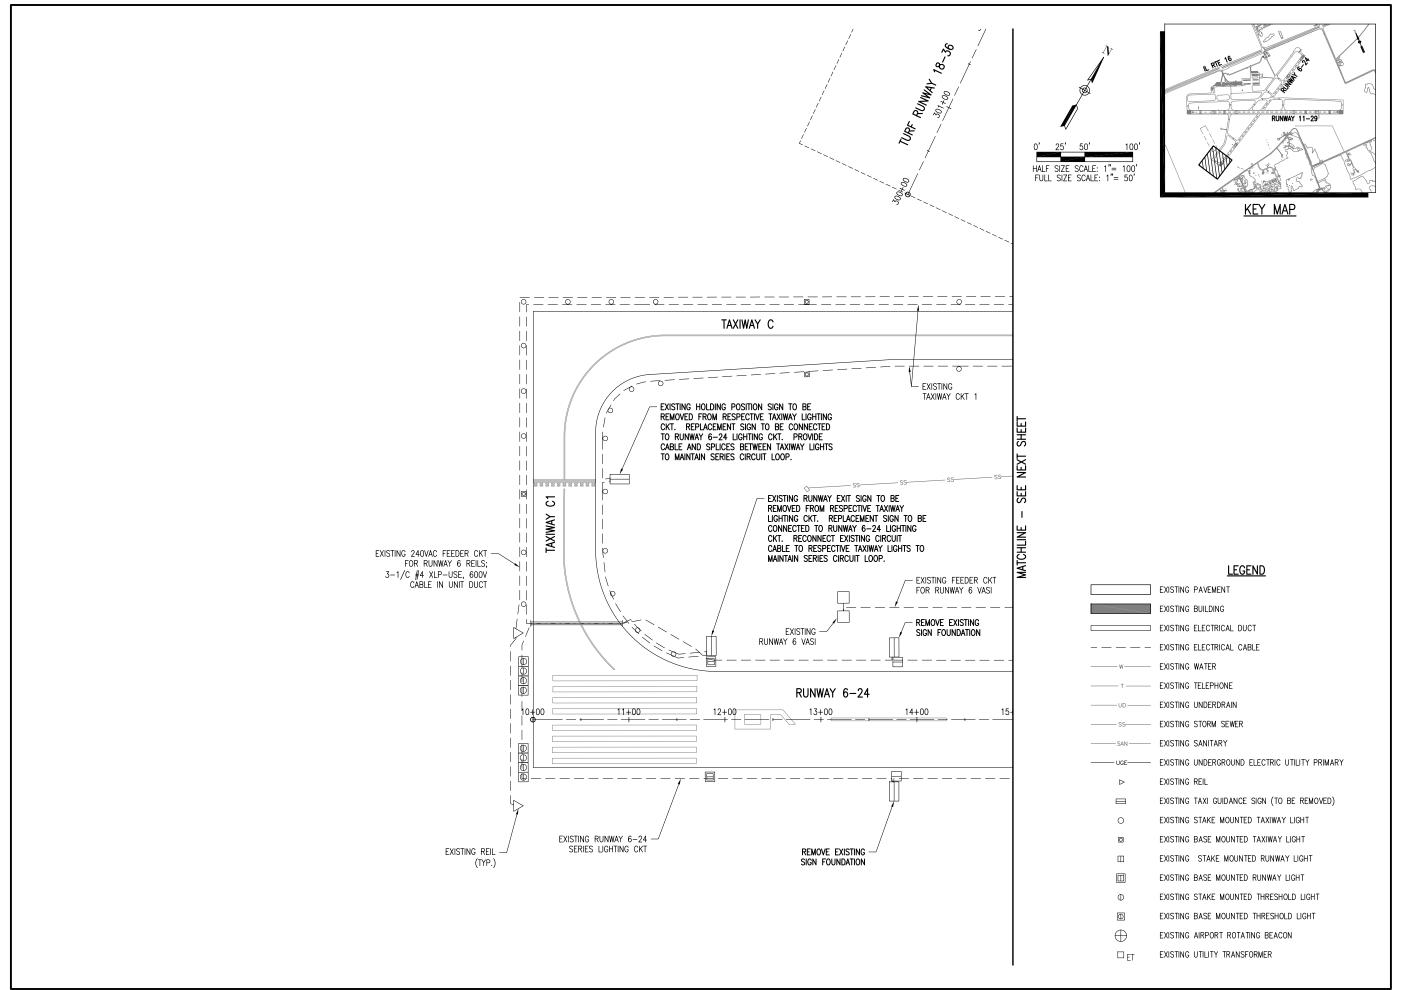- 1. ALL WORK, POWER OUTAGES, AND/OR SHUT DOWN OF EXISTING SYSTEMS SHALL BE COORDINATED WITH THE AIRPORT DIRECTOR/MANAGER. ONCE SHUT DOWN, THE CIRCUITS SHALL BE LABELED AS SUCH TO PREVENT ACCIDENTAL ENERGIZING OF THE RESPECTIVE CIRCUITS. ALL PERSONNEL SHALL FOLLOW U.S. DEPARTMENT OF LABOR OCCUPATIONAL SAFETY & HEALTH ADMINISTRATION (OSHA) 29 CFR PART 1910 OCCUPATIONAL SAFETY & HEALTH STANDARDS FOR ELECTRICAL SAFETY AND LOCKOUT/TAGOUT PROCEDURES INCLUDING, BUT NOT LIMITED TO 29 CFR SECTION 1910.147 THE CONTROL OF HAZARDOUS ENERGY (LOCKOUT/TAGOUT).
- CONTRACTOR SHALL FIELD VERIFY EXISTING SITE CONDITIONS. CONTRACTOR SHALL FIELD VERIFY
  RESPECTIVE CIRCUITS AND POWER SOURCES PRIOR TO REMOVING OR DISCONNECTING THE RESPECTIVE
  AIRFIELD LIGHTING, TAXI SIGN, NAVAID, OR OTHER DEVICE.
- PROPOSED AIRFIELD GUIDANCE SIGNS, OTHER AIRFIELD LIGHTING, SPLICE CANS, ELECTRICAL DUCTS, AND
  CABLE SHALL BE INSTALLED AT THE LOCATIONS SHOWN AND IN COMPLIANCE WITH THE SPECIFICATIONS,
  SPECIAL PROVISIONS, RESPECTIVE DETAILS, AND MANUFACTURER'S RECOMMENDATIONS.
- 4. PROPOSED TAXI GUIDANCE SIGNS SHALL BE LOCATED SUCH THAT THE CLOSEST SIDE OF THE SIGN IS 15' FROM THE PAVEMENT EDGE, UNLESS SHOWN OTHERWISE.
- PROPOSED CABLE FOR RUNWAY AND TAXIWAY LIGHTING SHALL BE INSTALLED TO AVOID INTERFERENCES WITH OTHER CABLES, UTILITIES, DRAINAGE, DUCTS, AND STRUCTURES. CABLES SHALL BE PLACED A MINIMUM OF 18" RELOW FINISHED GRADE.
- THE PROPOSED RUNWAY AND TAXIWAY LIGHTING CABLE SHALL BE 1/C, #8 AWG, FAA L-824, 5000 VOLT, TYPE C UNDERGROUND CARLE IN UNIT DUCT.
- 7. CONTRACTOR SHALL FURNISH AND INSTALL NEW ELECTRICAL CABLE FROM EACH PROPOSED TAXI GUIDANCE SIGN TO EACH RESPECTIVE RUNWAY/TAXIWAY LIGHT ON BOTH SIDES OF THE TAXI SIGN TO PLACE THE PROPOSED TAXI SIGN INTO THE SERIES CIRCUIT. WHERE EXISTING SIGNS ARE REMOVED FROM A RESPECTIVE CIRCUIT, CONTRACTOR SHALL FURNISH AND INSTALL CABLE, SPICES, AND/OR CONNECTIONS TO THE RESPECTIVE AIRFIELD LIGHTS TO MAINTAIN THE RESPECTIVE SERIES CIRCUIT LOOP.
- 8. In areas where there is a congestion of cables or where the proposed cable crosses an existing cable, the contractor is required to hand dig the trench necessary for the proposed cable. At other locations, the proposed cable may be trenched or plowed into place. Hand digging, trenching and/or plowing will be considered incidental to the proposed cables and no additional compensation will be allowed.
- ALL PROPOSED TAXI GUIDANCE SIGNS SHALL BE TAGGED BY THE CONTRACTOR IN ACCORDANCE WITH THE SIGN NUMBERS SHOWN ON THESE CONSTRUCTION DRAWINGS.
- 10. SEE "TAXI GUIDANCE SIGN SCHEDULE" FOR INFO ON SIGN LEGENDS.
- 11. RUNWAY EXIT/TAXIWAY ENTRANCE SIGNS (TAXIWAY GUIDANCE SIGNS TO DEFINE THE THROAT OR ENTRANCE INTO THE INTERSECTING TAXING ROUTE) SHALL BE CONNECTED TO THE RESPECTIVE RUNWAY SERIES CIRCUIT TO BE ILLUMINATED WHEN THE RUNWAY EDGE LIGHTS ARE ON TO COMPLY WITH FAA AC 150/5340-18F, CHAPTER 1, PART 15 "SIGN OPERATION".
- 12. HOLDING POSITION SIGNS ARE TO BE LOCATED IN-LINE WITH THE HOLDING POSITION MARKING. A TOLERANCE OF UP TO 10 FEET FARTHER AWAY FROM THE RUNWAY CENTERLINE THAN THE HOLDING POSITION MARKING IS ALLOWED PER AC 150/5340-18F. CONFIRM LOCATIONS WITH RESIDENT ENGINEER/RESIDENT TECHNICIAN.
- 13. HOLDING POSITION SIGNS FOR RUNWAYS SHALL BE CONNECTED TO THE RESPECTIVE RUNWAY SERIES CIRCUIT TO BE ILLUMINATED WHEN THE ASSOCIATED RUNWAY LIGHTS ARE ILLUMINATED TO COMPLY WITH FAA AC 150/5340-18F, CHAPTER 1, PART 15 "SIGN OPERATION".
- 14. THE CONTRACTOR SHALL SECURE, IDENTIFY AND PLACE ALL TEMPORARY EXPOSED WIRING IN CONDUIT, DUCT OR UNIT DUCT TO PREVENT ELECTROCUTION AND FIRE IGNITION SOURCES AS PER THE REQUIREMENTS OF FAA AC 150/5370-2F, PART 218, PARAGRAPH C. ALL LABOR, MATERIALS, AND TIME NECESSARY TO COMPLY WITH THIS REQUIREMENT SHALL BE CONSIDERED INCIDENTAL TO THE CONTRACT AND NO ADDITIONAL COMPENSATION WILL BE ALLOWED.
- 15. EXISTING AIRFIELD LIGHTING CABLES (SCHEDULED FOR REPLACEMENT) IN AREAS OF NEW WORK SHALL BE DISCONNECTED & REMOVED WHERE IN CONFLICT WITH NEW CONSTRUCTION. IN OTHER AREAS CABLES MAY BE ABANDONED IN PLACE.
- 16. THE CONTRACTOR IS REQUIRED TO FILL IN ALL HOLES AND DEPRESSIONS RESULTING FROM THE NEW WORK, WITH EARTH MATERIAL. THE AREAS SHALL BE COMPACTED TO PREVENT FUTURE SETTLEMENT AND FERTILIZED, SEEDED, AND MULCHED IN ACCORDANCE WITH ITEMS 901 AND 908 RESPECTIVELY.
- 17. IN THE EVENT THAT OTHER CONSTRUCTION PROJECTS ARE IN PROGRESS AT THE AIRPORT AT THE SAME TIME AS THIS PROJECT, THE CONTRACTOR WILL BE REQUIRED TO COOPERATE WITH ALL OTHER CONTRACTORS AND THE AIRPORT MANAGER IN THE COORDINATION OF THE WORK.
- 18. NO CONNECTION TO AN ACTIVE LIGHTING CIRCUIT WILL BE BROKEN UNTIL THE CIRCUIT HAS BEEN TURNED OFF IN ACCORDANCE WITH NOTE 1.








KEY MAP

THE LOCATION, SIZE, AND TYPE OF MATERIAL OF EXISTING UNDERGROUND AND/OR ABOVEGROUND UTILITIES INDICATED ON THE PLANS ARE NOT REPRESENTED AS BEING ACCURATE, SUFFICIENT OR COMPLETE. NEITHER THE OWNER NOR THE ENGINEER ASSUMES ANY RESPONSIBILITY WHATEVER IN RESPECT TO THE ACCURACY, COMPLETENESS, OR SUFFICIENCY OF THE INFORMATION. THERE IS NO GUARANTEE, EITHER EXPRESSED OR IMPLIED, THAT THE LOCATIONS, SIZE AND TYPE OF MATERIAL OF EXISTING UNDERGROUND UTILITIES INDICATED ARE REPRESENTATIVE OF THOSE TO BE ENCOUNTERED IN THE CONSTRUCTION IT SHALL BE THE CONTRACTOR'S RESPONSIBILITY TO DETERMINE THE ACTUAL LOCATION OF ALL SUCH FACILITIES, INCLUDING SERVICE CONNECTIONS TO UNDERGROUND UTILITIES. PRIOR TO CONSTRUCTION, THE CONTRACTOR SHALL NOTIFY THE UTILITY COMPANIES OF HIS OPERATIONAL PLANS AND SHALL OBTAIN FROM THE RESPECTIVE UTILITY COMPANIES DETAILED INFORMATION AND ASSISTANCE RELATIVE TO THE LOCATION O THEIR FACILITIES AND THE WORKING SCHEDULE OF THE COMPANIES FOR REMOVAL OR ADJUSTMENT WHERE REQUIRED. IN THE EVENT AN LINEXPECTED LITHLY INTERFERENCE IS ENCOUNTERED DURING CONSTRUCTION, THE CONTRACTOR SHALL IMMEDIATELY NOTIFY THE UTILITY COMPANY OF JURISDICTION. THE OWNER'S REPRESENTATIVE AND/OR THE RESIDEN ENGINEER SHALL ALSO BE IMMEDIATELY NOTIFIED. ANY DAMAGE TO SUCH MAINS AND SERVICES SHALL BE RESTORED TO SERVICE AT ONCE AND PAID FOR BY THE CONTRACTOR AT NO ADDITIONAL COST TO THE CONTRACT.

ALL UTILITY CABLES AND LINES SHALL BE LOCATED BY THE RESPECTIVE UTILITY. CONTACT JULIE (JOINT UTILITY LOCATION INFORMATION FOR EXCAVATORS) FOR UTILITY INFORMATION, PHONE: 1-800-892-0123. CONTACT THE FAA (FEDERAL AVIATION ADMINISTRATION) FOR ASSISTANCE IN LOCATING FAA CABLES AND UTILITIES. LOCATION OF FAA POWER, CONTROL, AND COMMUNICATION CABLES SHALL BE COORDINATED WITH AND/OR LOCATED BY THE FAA. ALSO CONTACT AIRPORT DIRECTOR/MANAGER AND AIRPORT PERSONNEL FOR ASSISTANCE IN LOCATING UNDERGROUND AIRPORT CABLES AND/OR UTILITIES. ALSO COORDINATE WORK WITH ALL ABOVEGROUND UTILITIES.

#### **LEGEND**

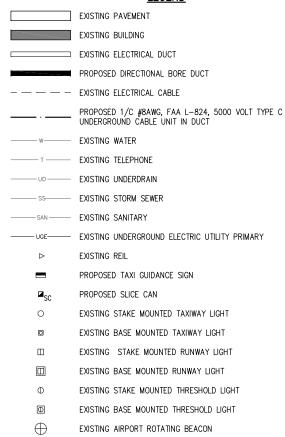

EXISTING UTILITY TRANSFORMER

□ <sub>ET</sub>



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REMOVE AND REPLACE ALL TAXI GUIDANCE SIGNS ON THE AIRPORT


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Contract No. CO062

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CAD FILE: C-142-1129.DWG					
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DRAWN BY: MLH 02/17/2016					

REVIEWED BY: LDH 03/08/2016

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COLES COUNTY AIRPORT


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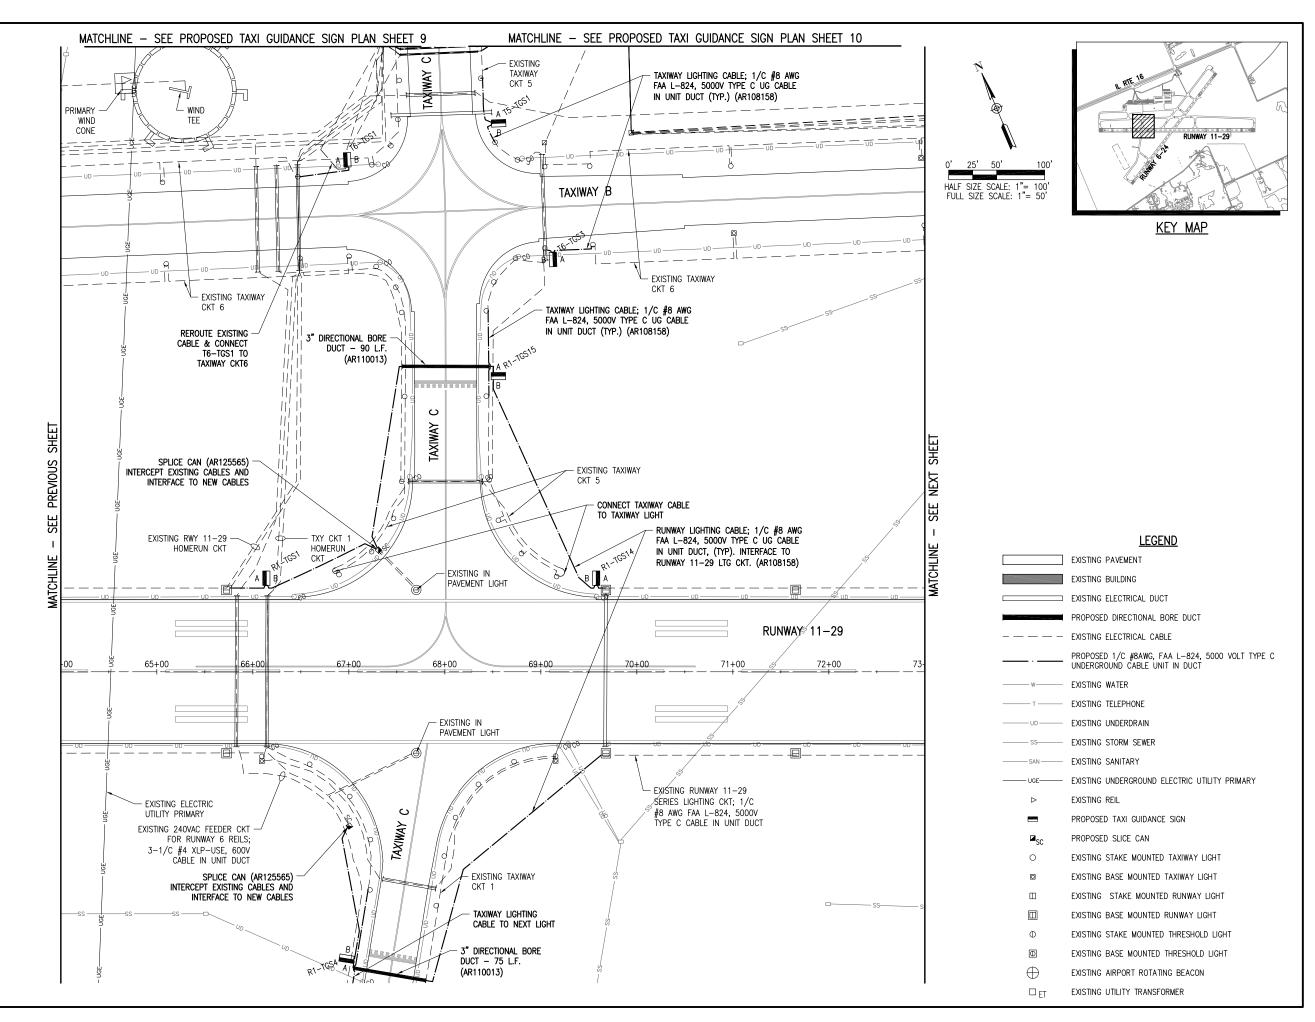
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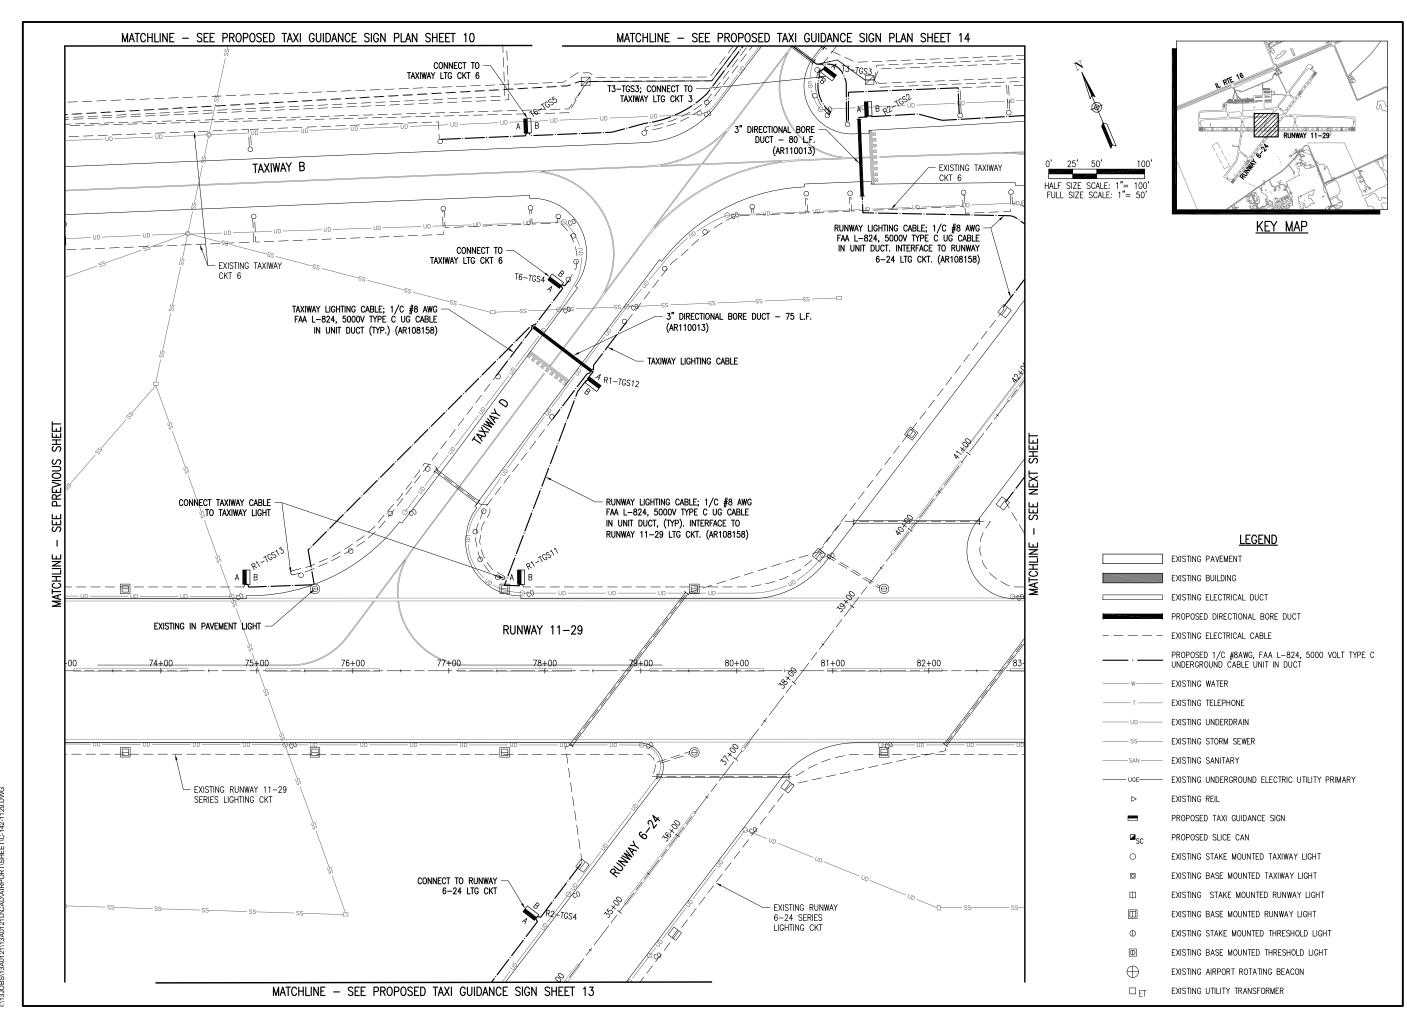
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SHEET TITLE

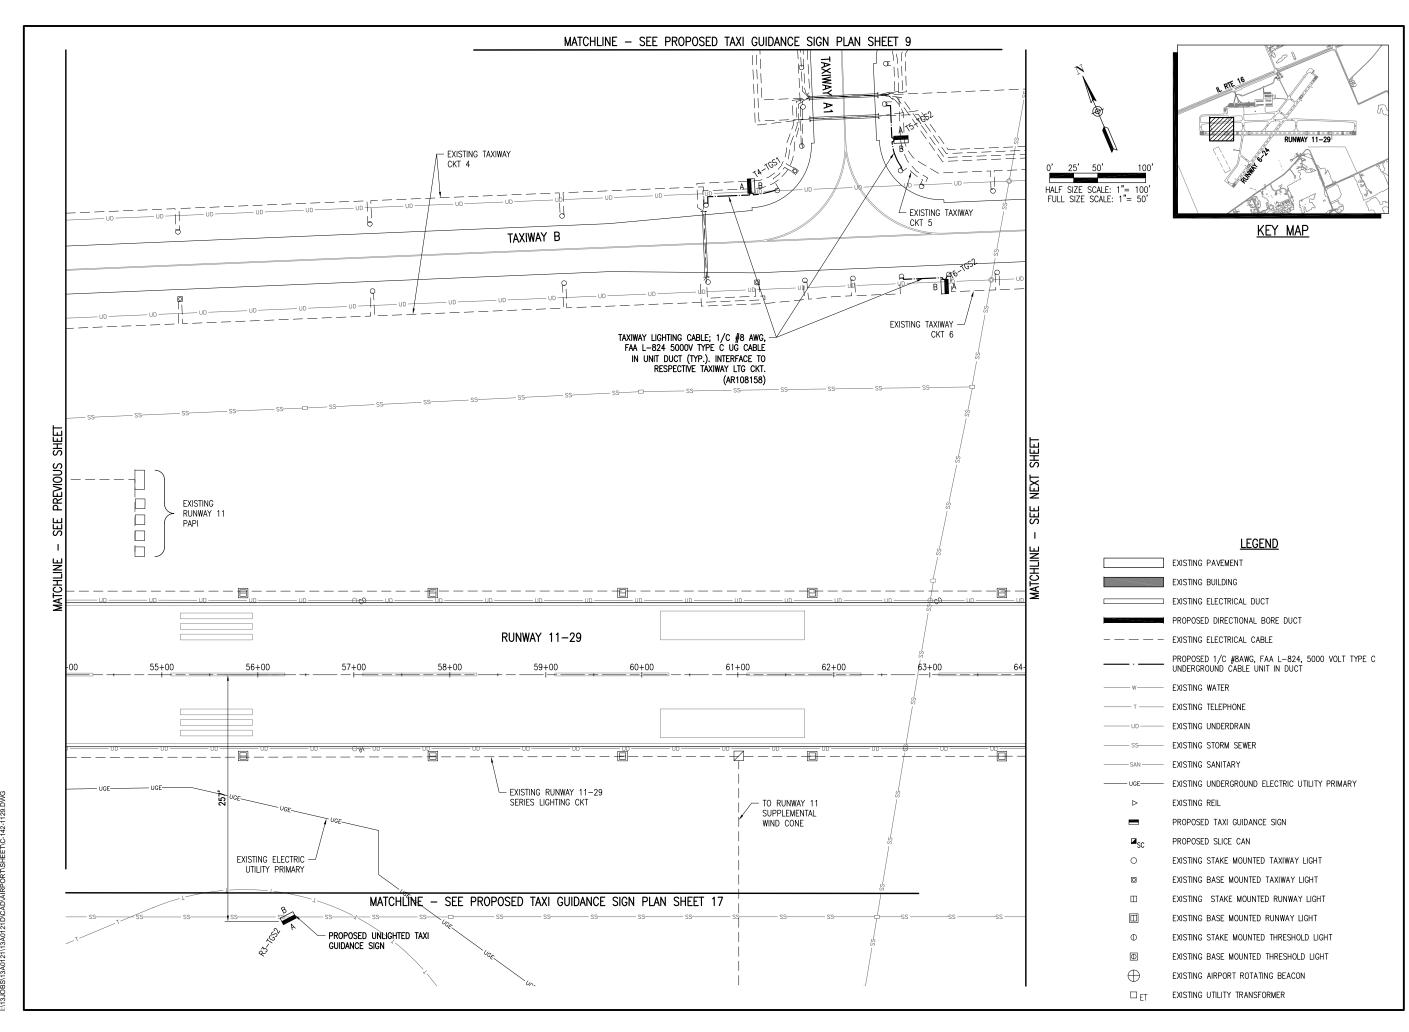PROPOSED TAXI GUIDANCE SIGN PLAN SHEET 3

REVIEWED BY: LDH 03/08/2016



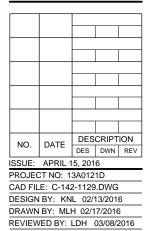

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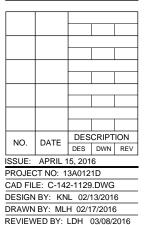
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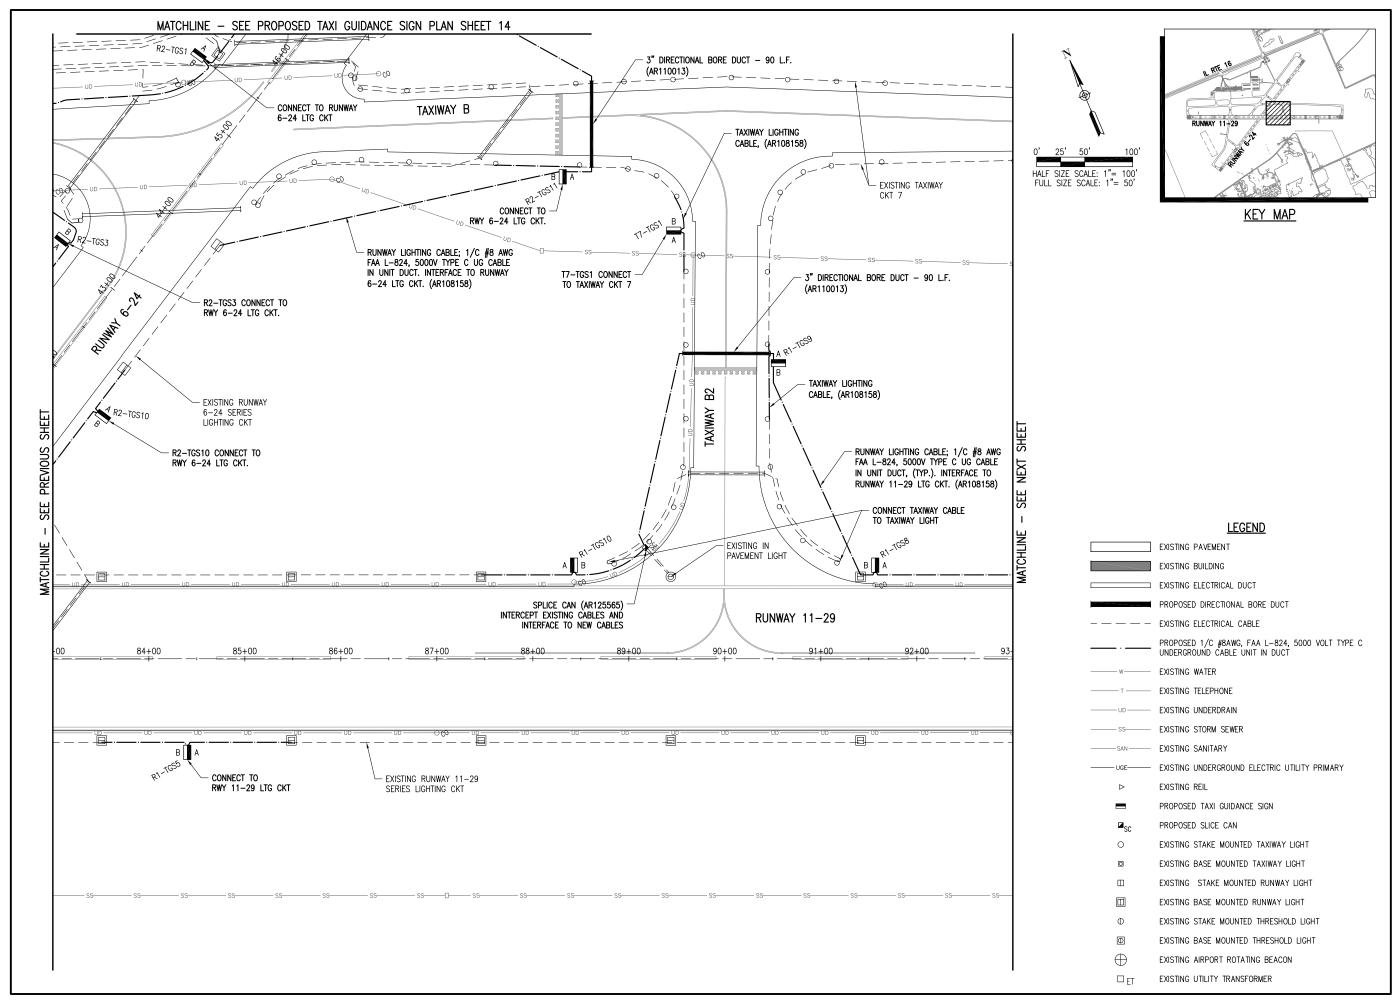
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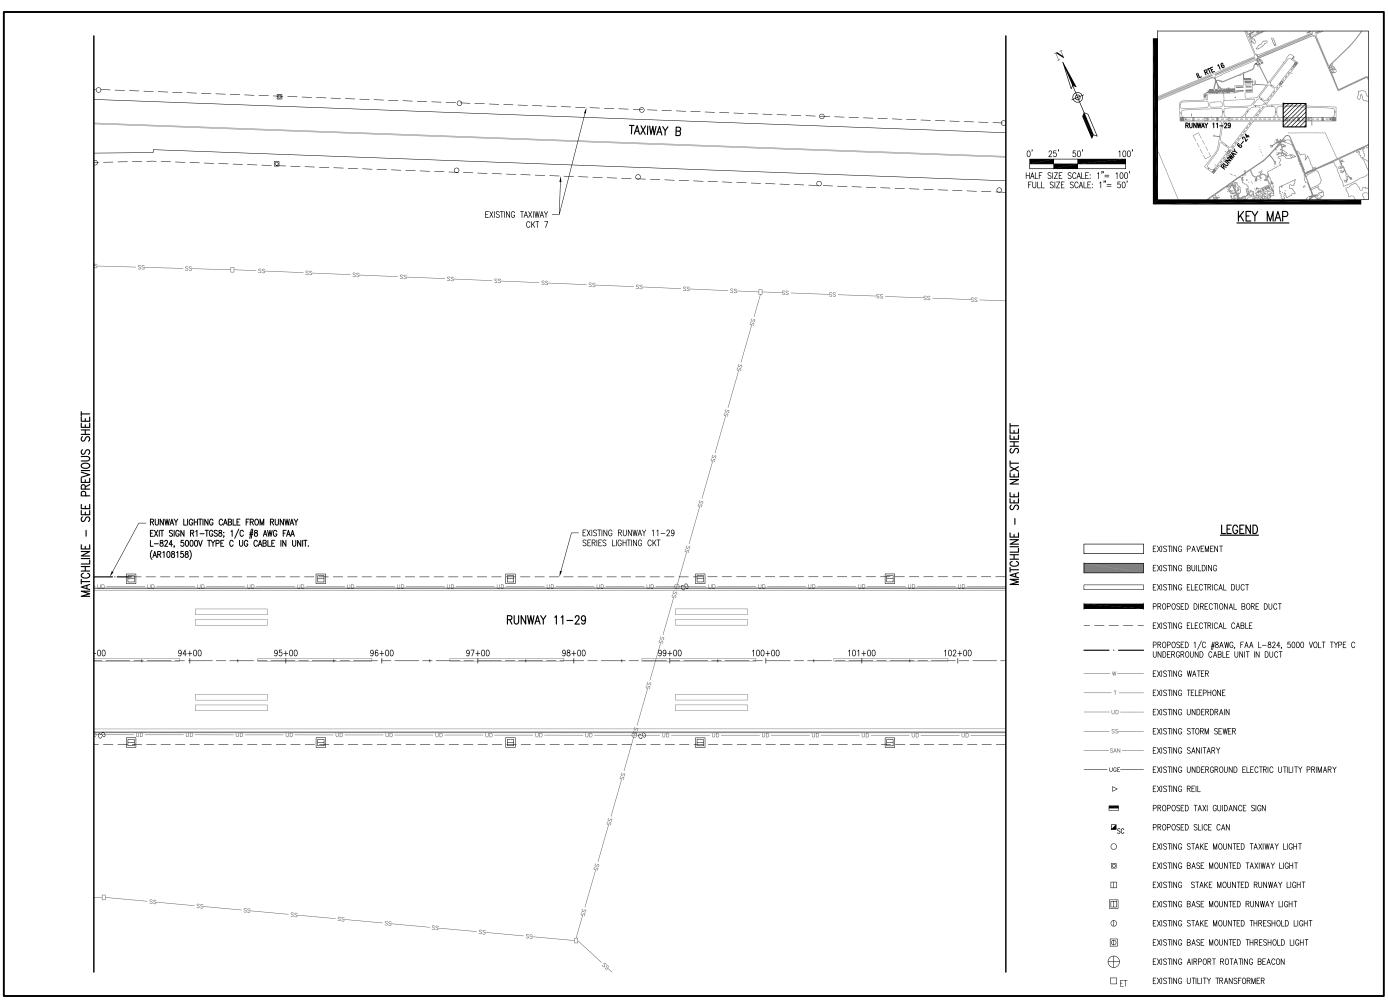
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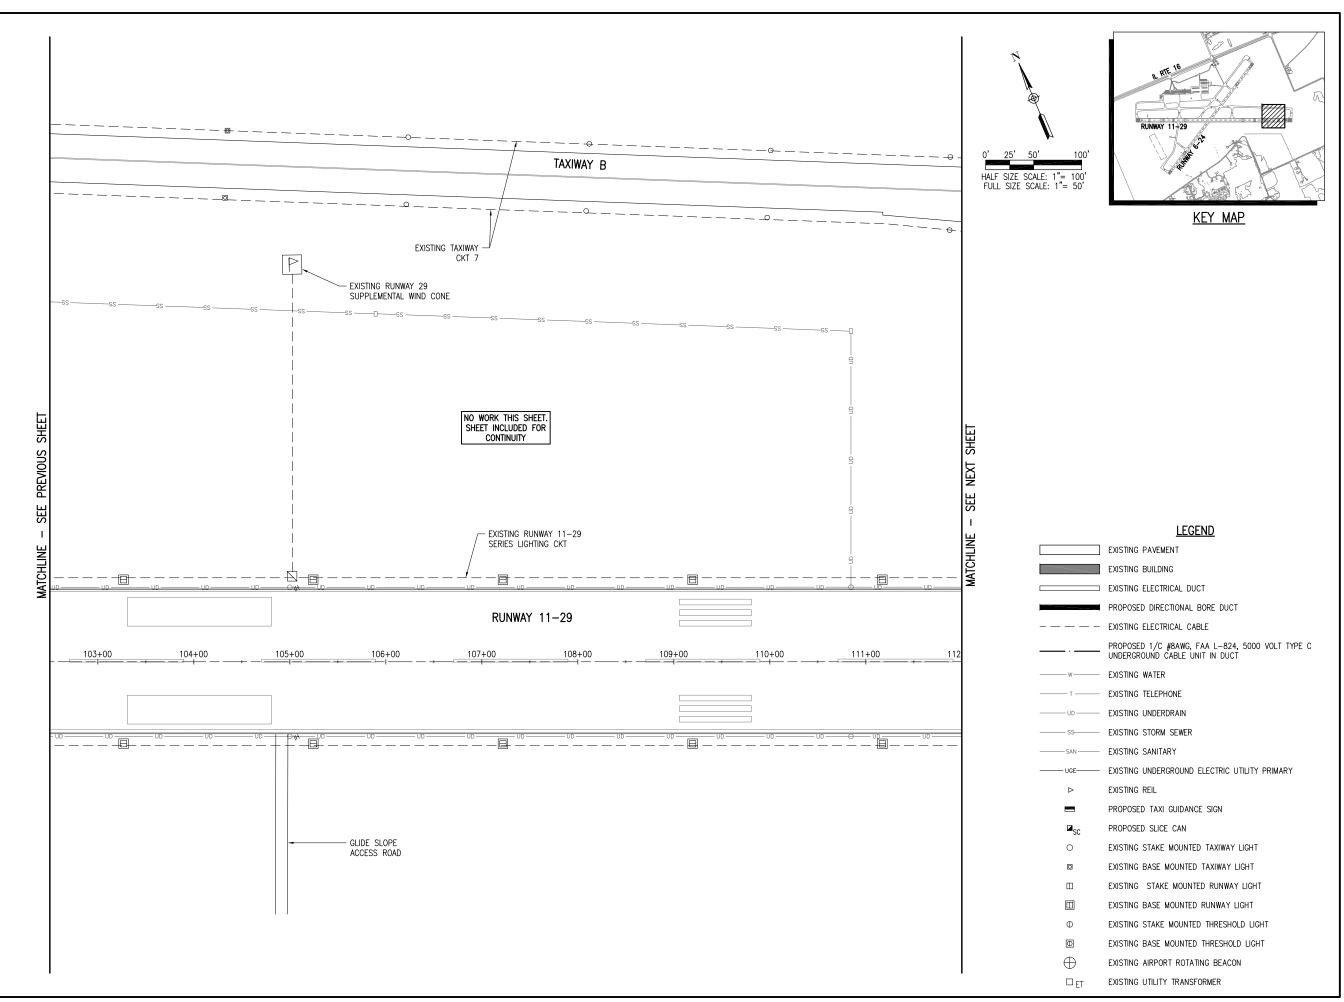
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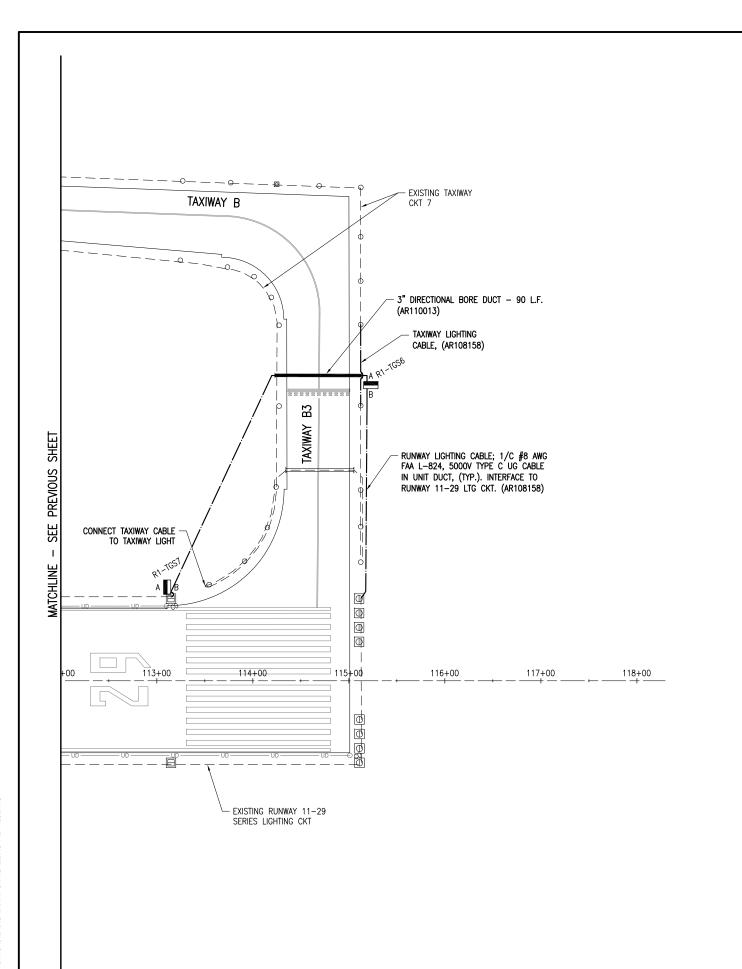
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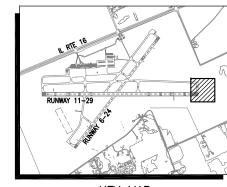
SHEET TITLE

PROPOSED TAXI GUIDANCE SIGN PLAN SHEET 7

REVIEWED BY: LDH 03/08/2016







<u>KEY MAP</u>

#### <u>LEGEND</u>

EXISTING PAVEMENT

EXISTING BUILDING

EXISTING ELECTRICAL DUCT

PROPOSED DIRECTIONAL BORE DUCT

EXISTING ELECTRICAL CABLE

PROPOSED 1/C #8AWG, FAA L-824, 5000 VOLT TYPE C UNDERGROUND CABLE UNIT IN DUCT

EXISTING WATER

EXISTING TELEPHONE

EXISTING UNDERDRAIN
SS EXISTING STORM SEWER

— SAN — EXISTING SANITARY

▷ EXISTING REIL

PROPOSED TAXI GUIDANCE SIGN

PROPOSED SLICE CAN

EXISTING STAKE MOUNTED TAXIWAY LIGHT

EXISTING BASE MOUNTED TAXIWAY LIGHT

□ EXISTING STAKE MOUNTED RUNWAY LIGHT

EXISTING BASE MOUNTED RUNWAY LIGHT

D EXISTING STAKE MOUNTED THRESHOLD LIGHT

EXISTING BASE MOUNTED THRESHOLD LIGHT

EXISTING AIRPORT ROTATING BEACON

□ ET EXISTING UTILITY TRANSFORMER

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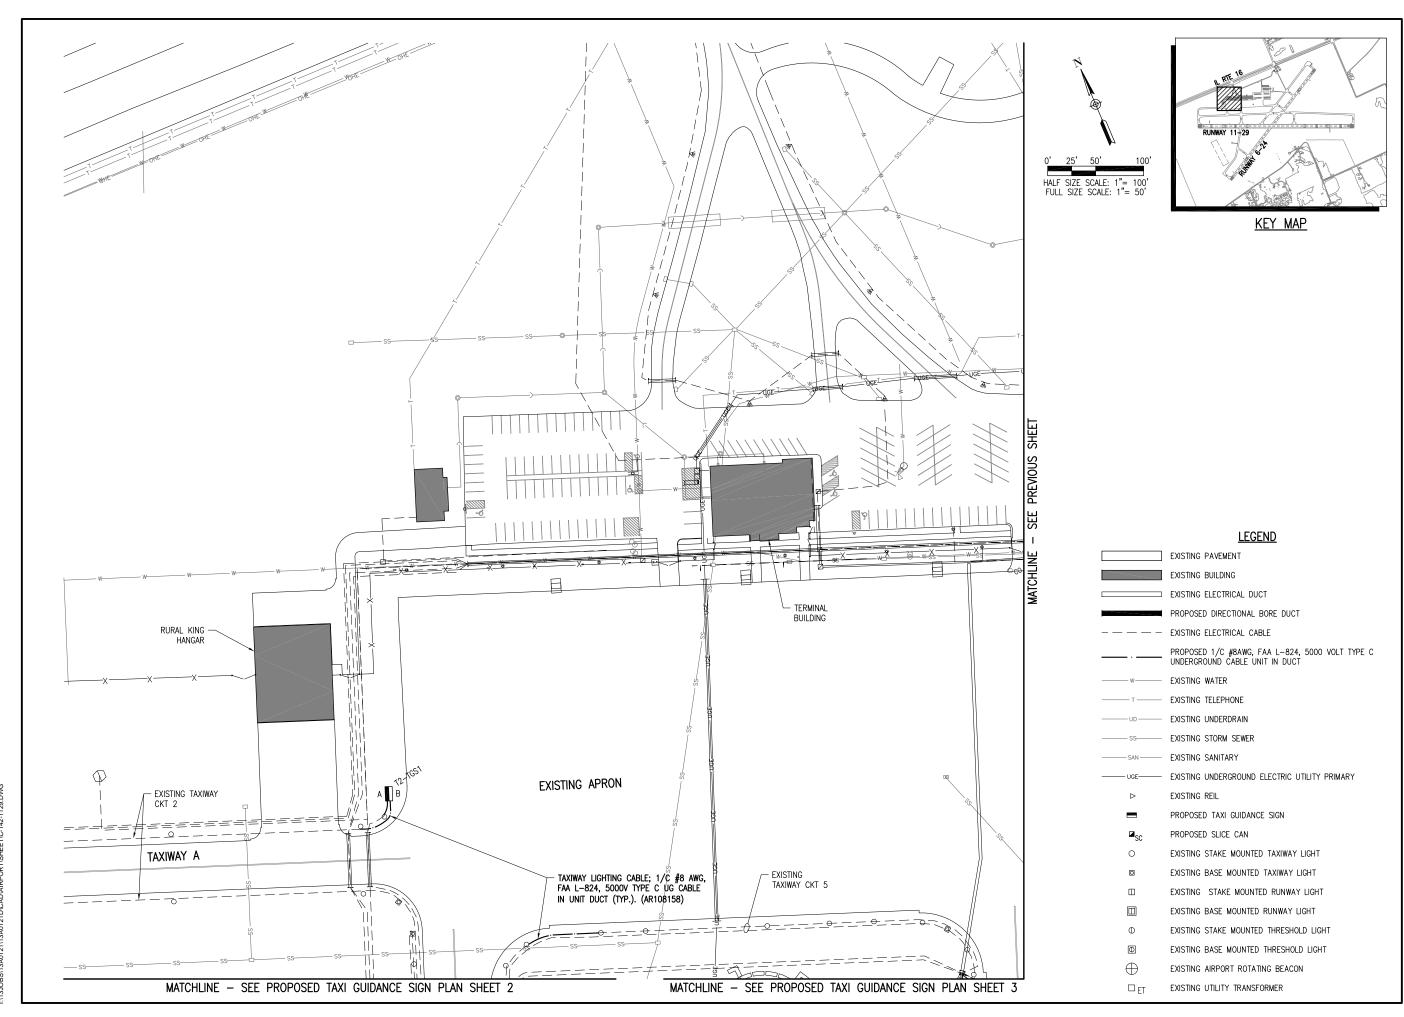
Contract No. CO062

NO.	DATE	DESCRIPTION		
		DES	DWN	REV
SSUE: APRIL 15, 2016				
PROJECT NO: 13A0121D				
CAD FILE: C-142-1129 DWG				

DESIGN BY: KNL 02/13/2016

DRAWN BY: MLH 02/17/2016 REVIEWED BY: LDH 03/08/2016

SHEET TITLE





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COLES COUNTY AIRPORT


AUTHORITY

COLES COUNTY MEMORIAL AIRPORT

REMOVE AND REPLACE ALL TAXI GUIDANCE SIGNS ON THE AIRPORT

IDA No: MTO-4511 SBG Project No: 3-17-SBGP-XX

Contract No. CO062

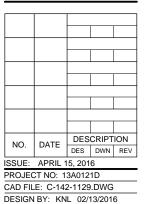

SHEET TITLE

PROPOSED TAXI GUIDANCE SIGN PLAN SHEET 9

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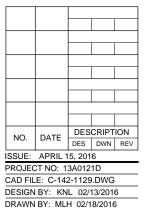
AUTHORITY

COLES COUNTY MEMORIAL AIRPORT

REMOVE AND REPLACE ALL TAXI GUIDANCE SIGNS ON THE AIRPORT

IDA No: MTO-4511 SBG Project No: 3-17-SBGP-XX


Contract No. CO062



REVIEWED BY: LDH 03/08/2016

SHEET TITLE

PROPOSED TAXI GUIDANCE SIGN PLAN SHEET 10

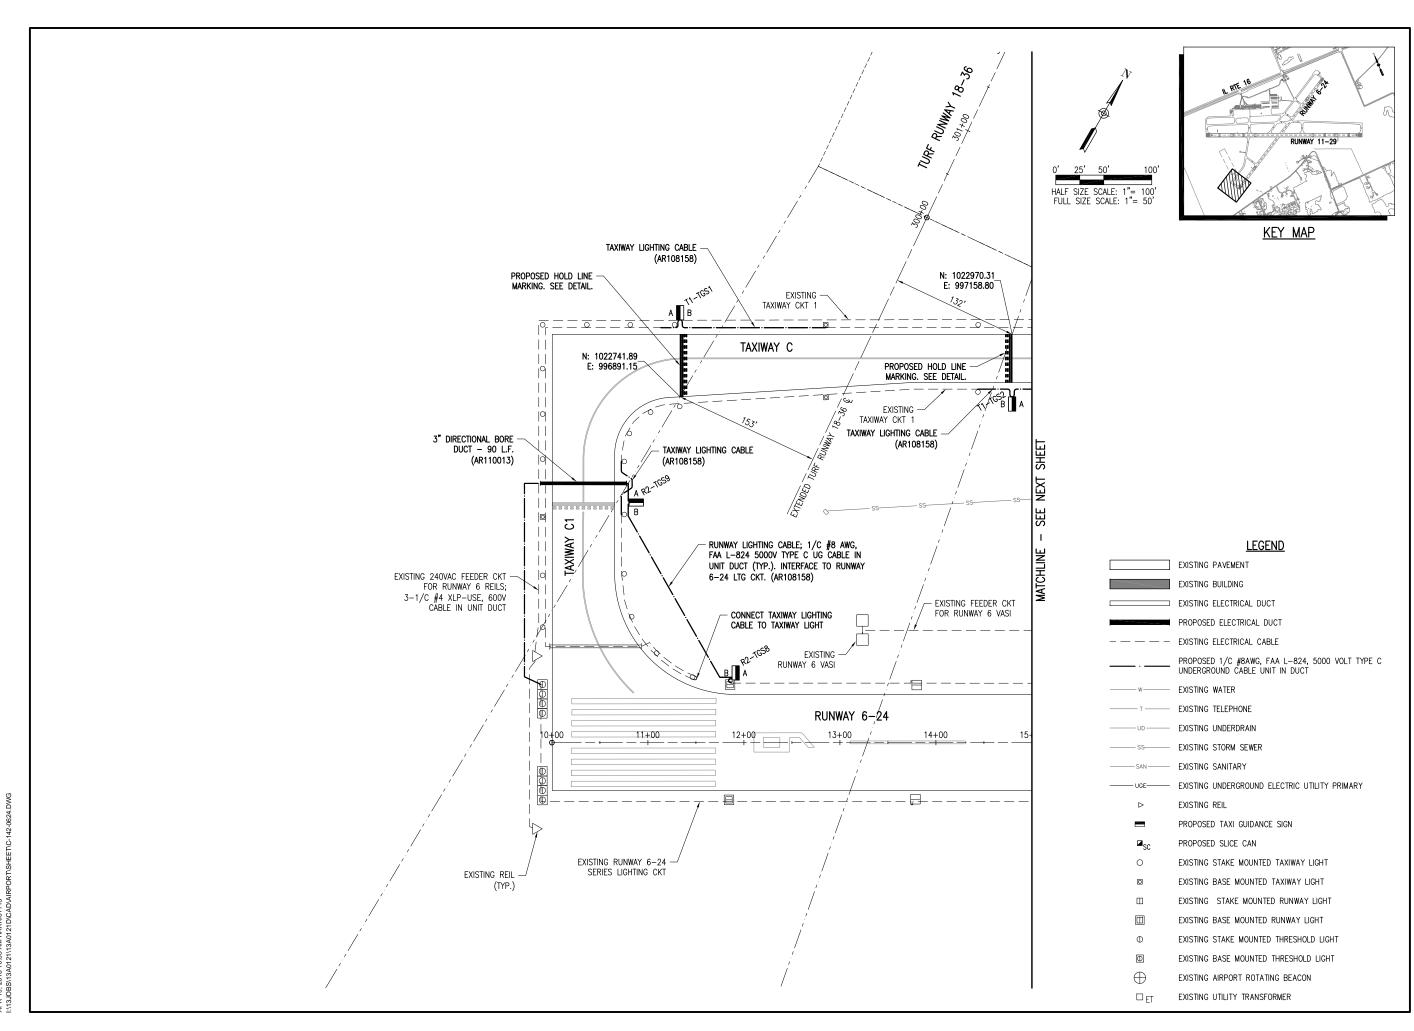



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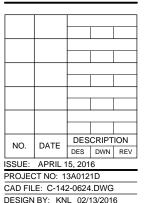
AUTHORITY

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IDA No: MTO-4511 SBG Project No: 3-17-SBGP-XX


Contract No. CO062



SHEET TITLE

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PROPOSED TAXI GUIDANCE SIGN PLAN SHEET 11



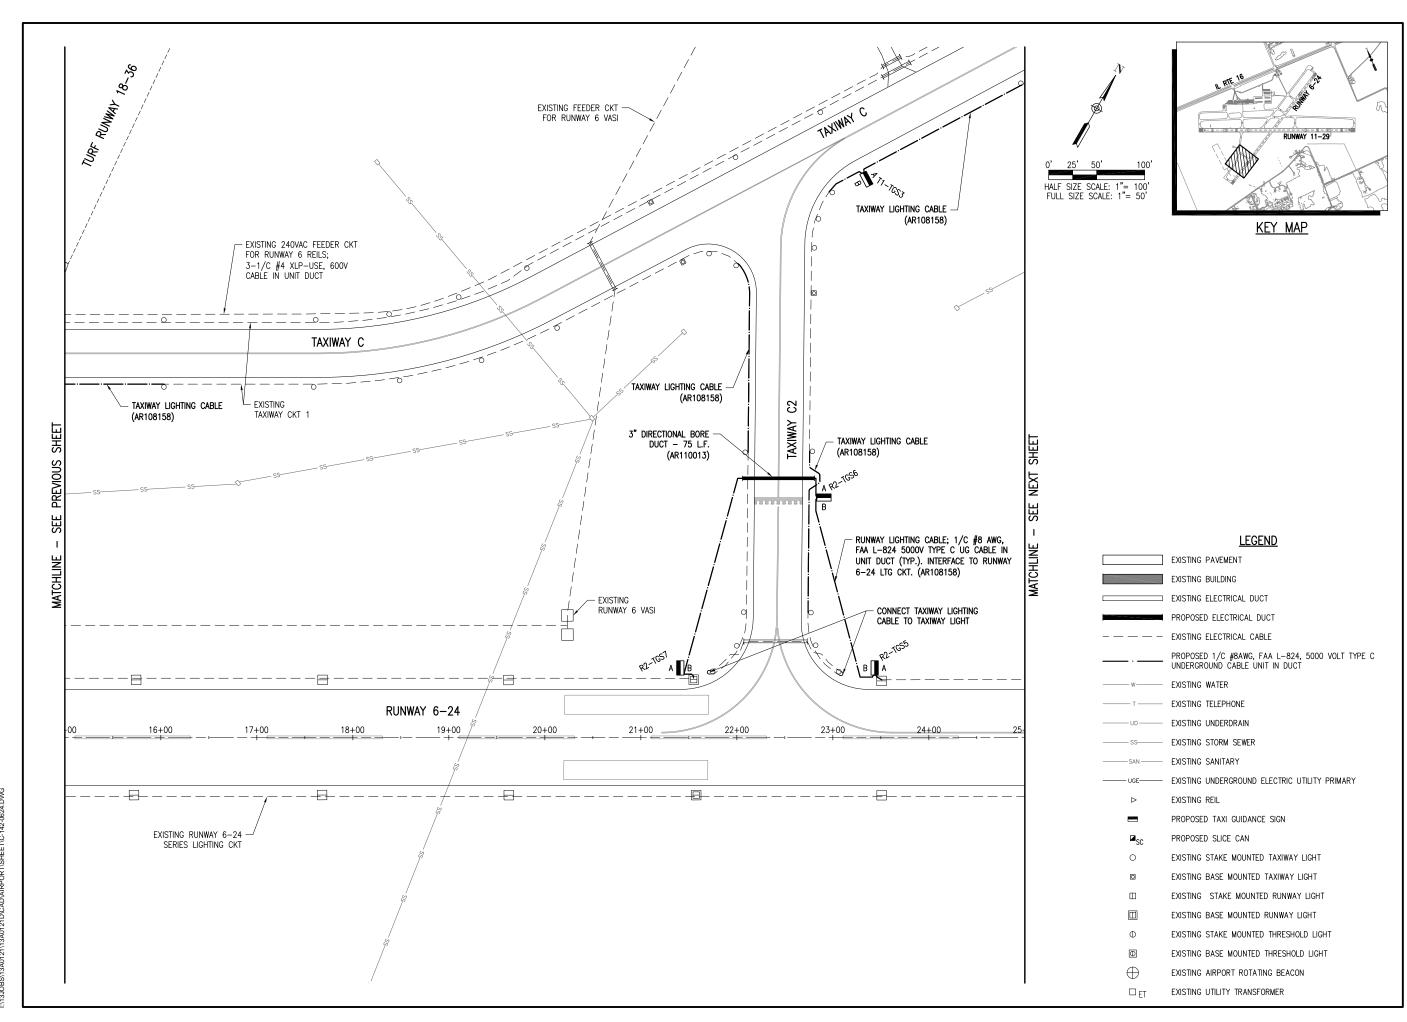

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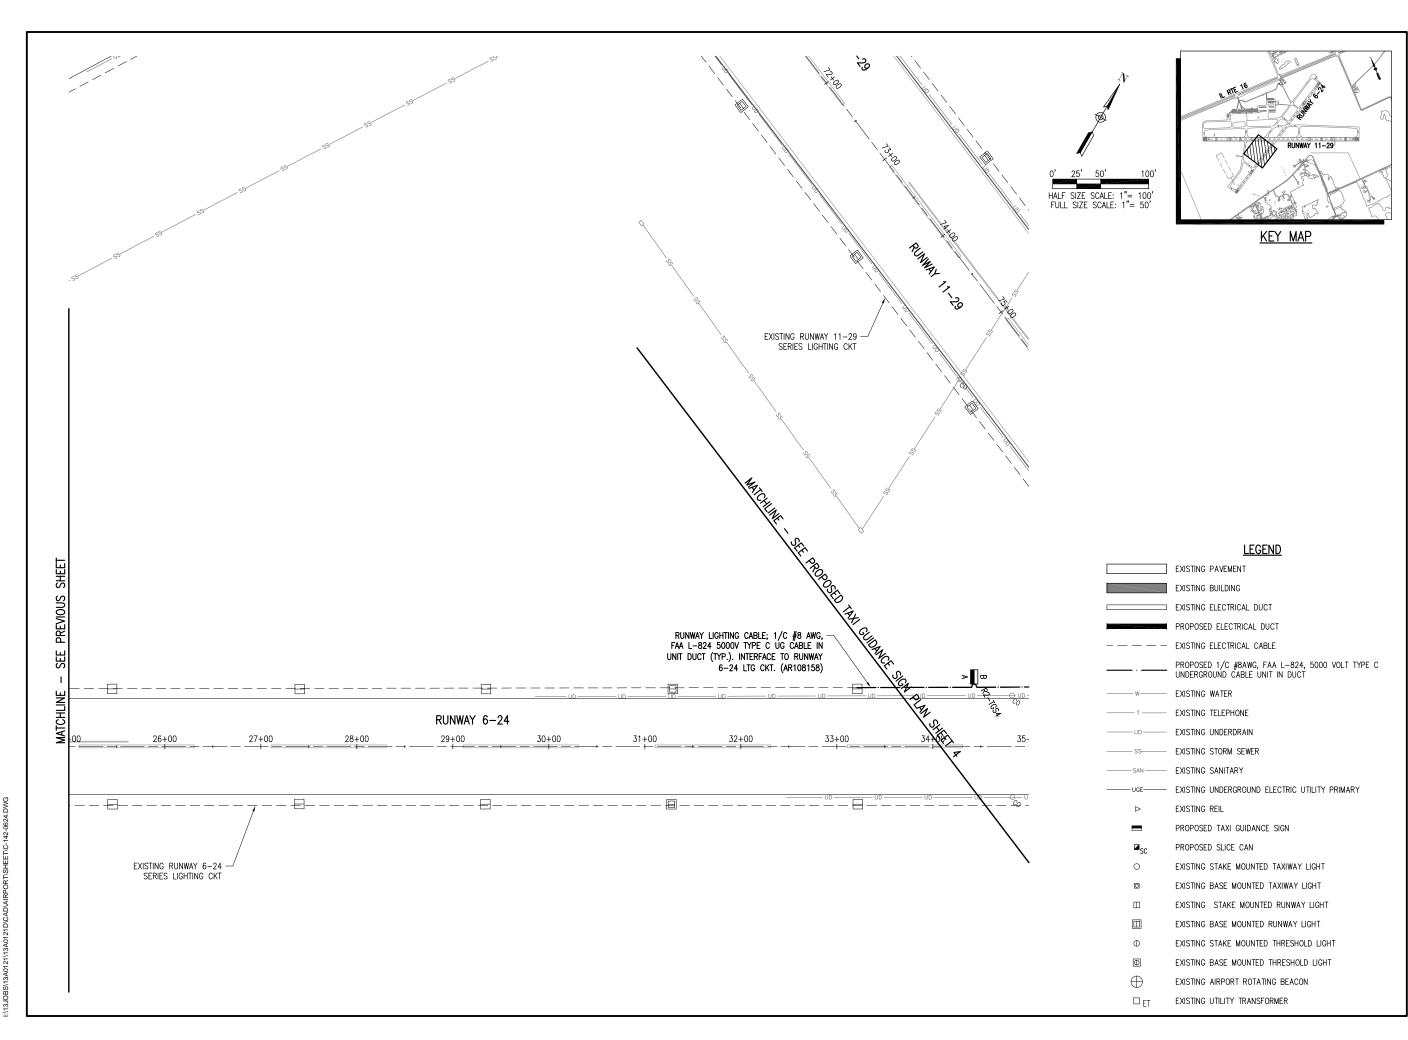
Contract No. CO062

NO.	DATE	DES	CRIPT	ION			
NO.	DATE	DES	DWN	REV			
SUE: APRIL 15, 2016							
OJECT NO: 13A0121D							
D FILE: C-142-0624.DWG							
SIGN BY: KNL 02/13/2016							
ΑΜΝ	AWN BY: MLH 02/18/2016						

SHEET TITLE

PROPOSED TAXI GUIDANCE SIGN PLAN SHEET 12

REVIEWED BY: LDH 03/08/2016





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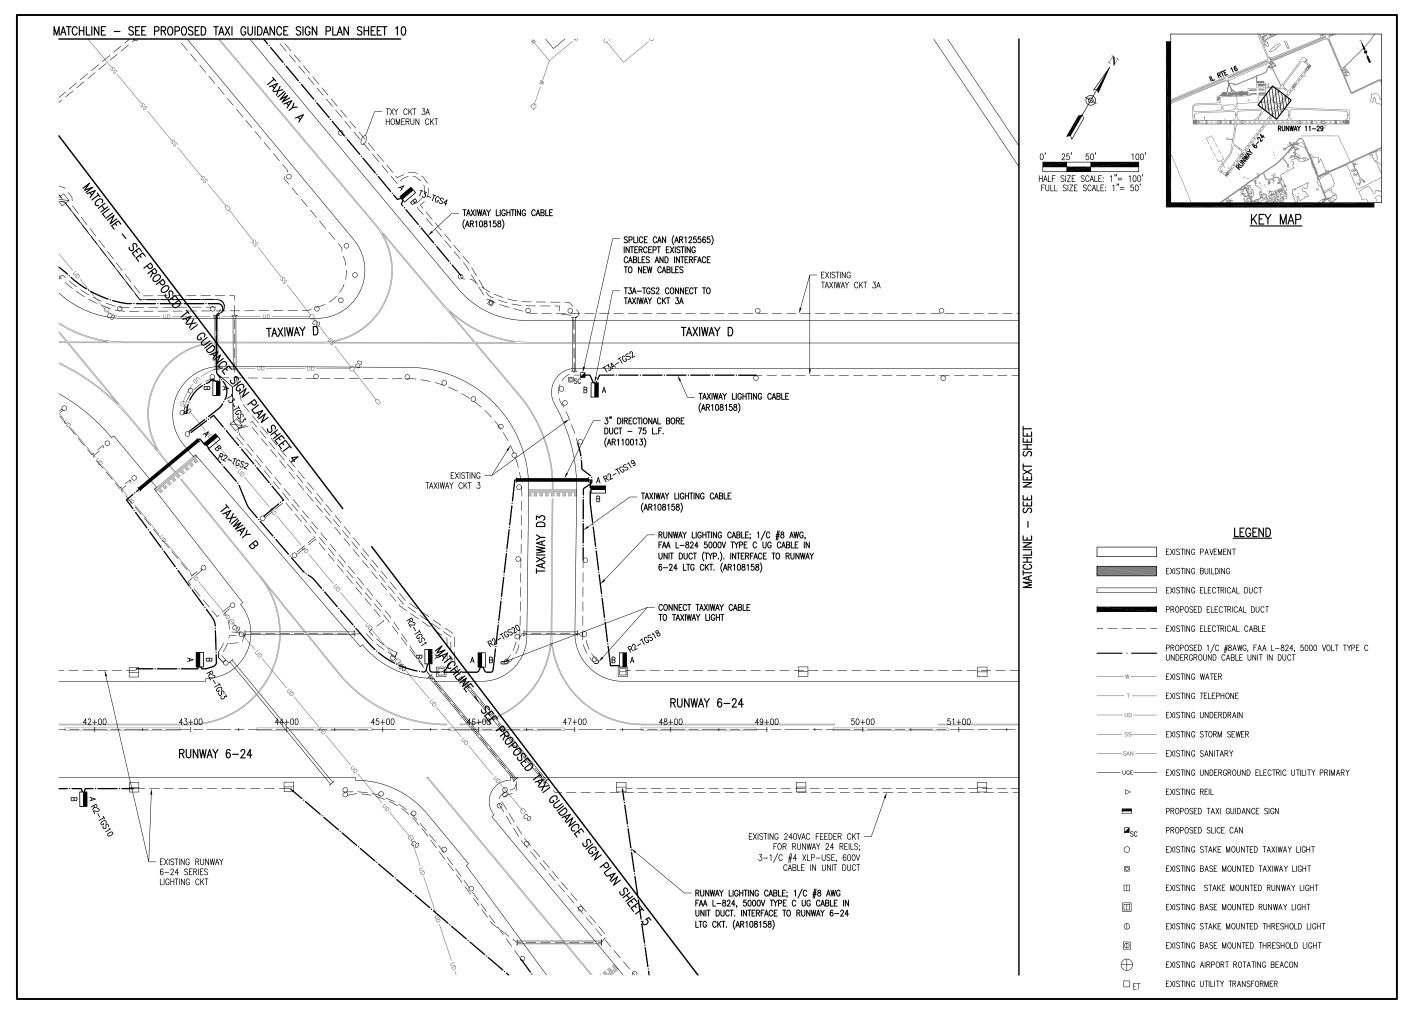
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Contract No. CO062

NO.	DATE	DES	CRIPT	ION			
INO.	DAIL	DES	DWN	REV			
ISSUE:	APRIL 1	5, 201	6				
PROJEC	CT NO: 1	3A012	1D				
CAD FIL	E: C-142	2-0624	.DWG				
DESIGN	BY: KN	L 02/	13/201	6			
DRAWN BY: MLH 02/18/2016							
REVIEW	REVIEWED BY: LDH 03/08/2016						

SHEET TITLE

PROPOSED TAXI GUIDANCE SIGN PLAN SHEET 13



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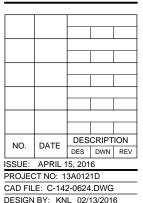
AUTHORITY

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IDA No: MTO-4511 SBG Project No: 3-17-SBGP-XX


Contract No. CO062



SHEET TITLE

PROPOSED TAXI GUIDANCE SIGN PLAN SHEET 14

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IDA No: MTO-4511 SBG Project No: 3-17-SBGP-XX

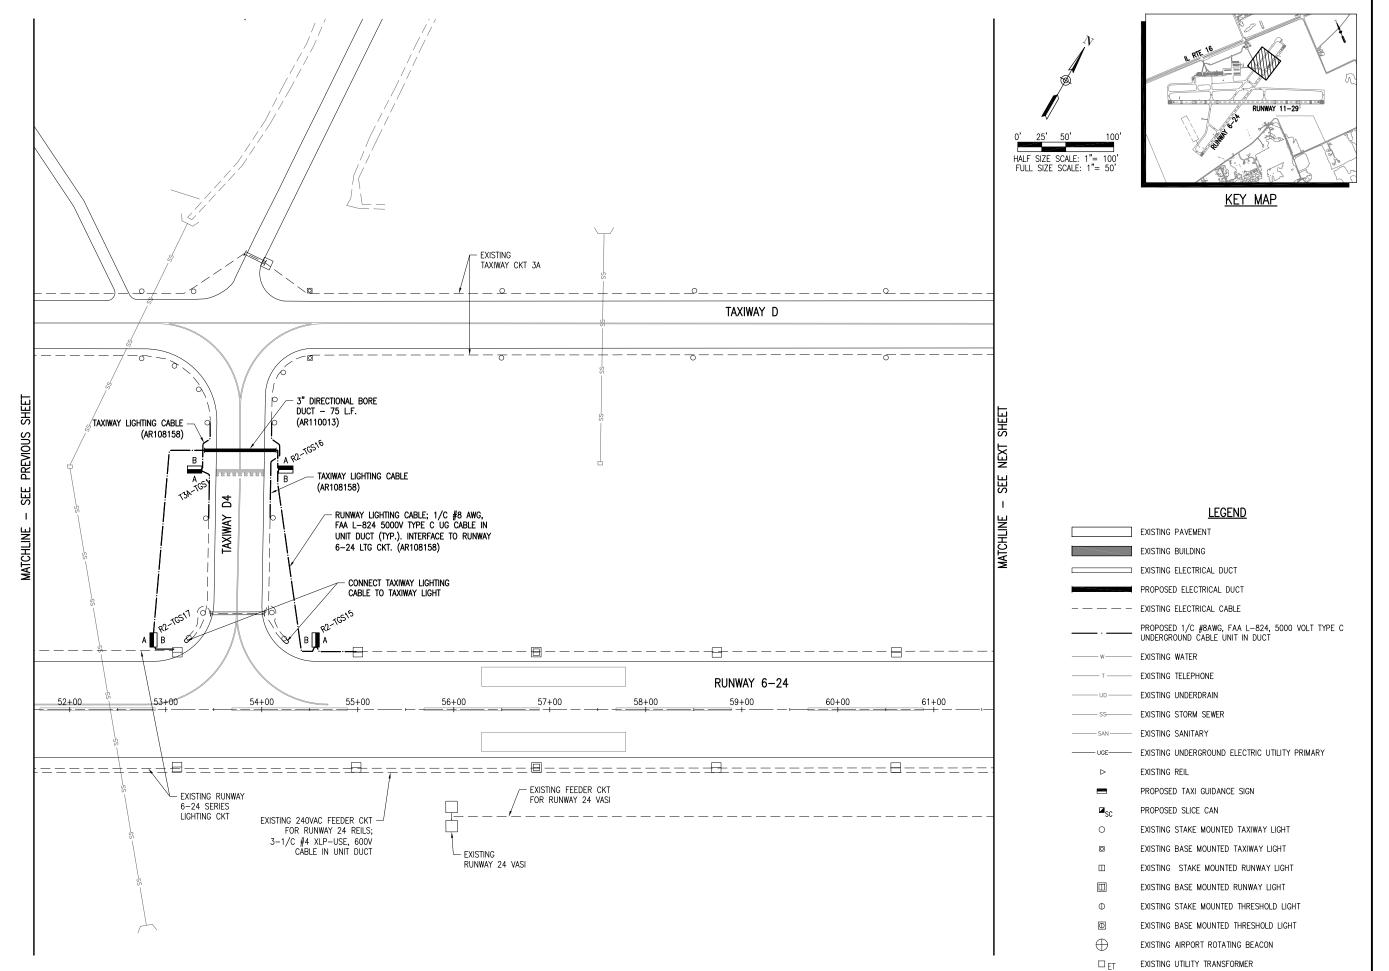
Contract No. CO062

NO.	DATE	DES	CRIPT	ION		
INO.	DATE	DES	DWN	REV		
ISSUE:	APRIL 1	5, 201	6			
PROJEC	CT NO: 1	3A012	1D			
CAD FILE: C-142-0624.DWG						
DESIGN BY: KNL 02/13/2016						
DRAWN BY: MLH 02/18/2016						

SHEET TITLE

PROPOSED TAXI GUIDANCE SIGN PLAN SHEET 15

REVIEWED BY: LDH 03/08/2016

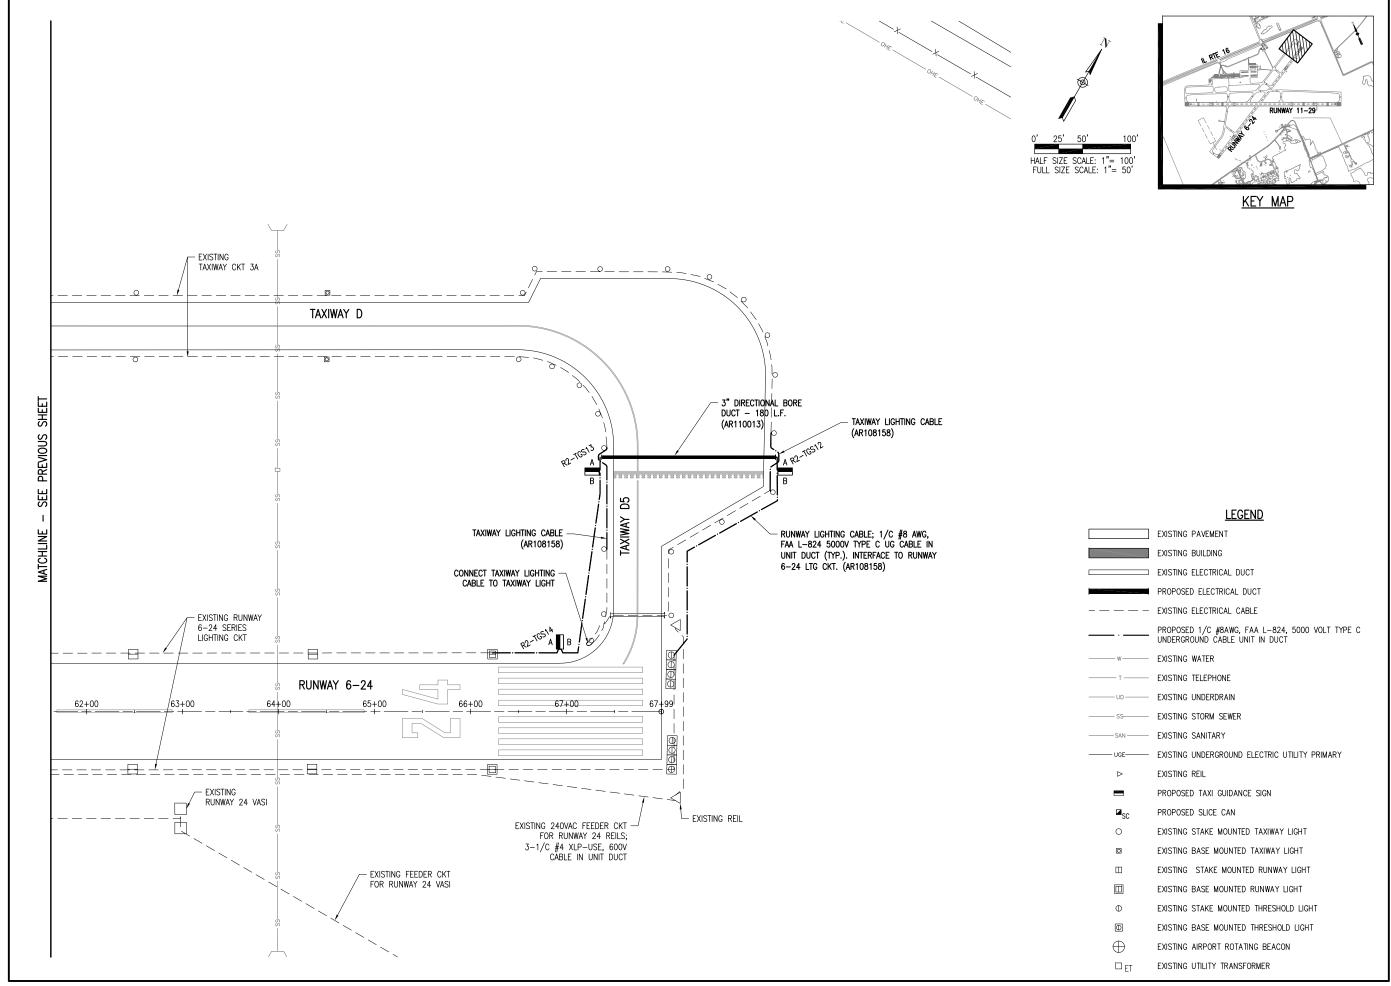



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IDA No: MTO-4511 SBG Project No: 3-17-SBGP-XX

Contract No. CO062


NO.	DATE	DES	CRIPT	ION		
NO.	DAIL	DES	DWN	REV		
SSUE: APRIL 15, 2016						
ROJECT NO: 13A0121D						
CAD FILE: C-142-0624.DWG						
DESIGN BY: KNL 02/13/2016						

SHEET TITLE

PROPOSED TAXI GUIDANCE SIGN PLAN SHEET 16

DRAWN BY: MLH 02/18/2016

REVIEWED BY: LDH 03/08/2016

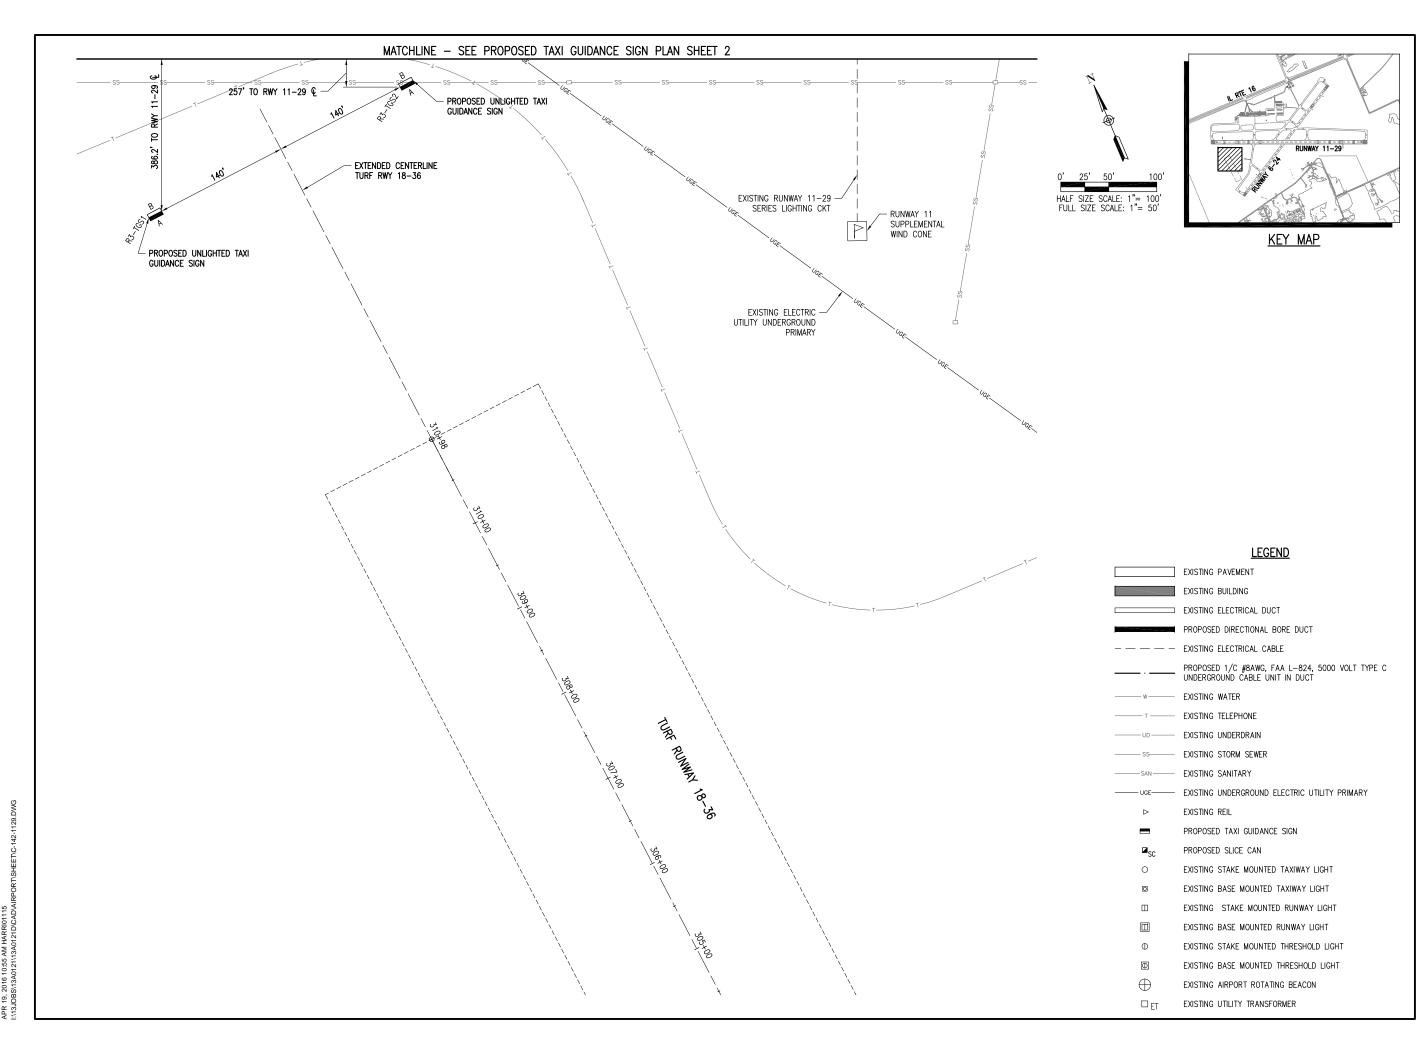



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IDA No: MTO-4511 SBG Project No: 3-17-SBGP-XX

Contract No. CO062

NO.	DATE	DES	CRIPT	ION		
INO.	DATE	DES	DWN	REV		
ISSUE:	APRIL 1	5, 201	6			
PROJEC	CT NO: 1	3A012	1D			
CAD FIL	E: C-142	2-1129	.DWG			
DESIGN	DESIGN BY: KNL 02/13/2016					
DRAWN	DRAWN BY: MLH 02/18/2016					

REVIEWED BY: LDH 03/08/2016

SHEET TITLE

PROPOSED TAXI GUIDANCE SIGN PLAN SHEET 17

B1-INST    RUMBY 11 INTERCETION WITH TAXIBAY 01   B1-7   B1-1   10/2462.6681   99677.5484   PROPERTY   FROM TUNNED   B1-7   B1	SIGN NUMBER	LOCATION	SIDE A	SIDE B	NORTHING	EASTING	REMARKS
18-202   Aller of Service   19-20   Aller of S		RUNWAY 11 INTERSECTION WITH TAXIWAY C	←C.		1024412 1668	998091 7115	
1-955   1-956   1-95							
All Cold   Marker   Per Procedure   Marker   All Cold   Marker							
MARKED   MARKED DESIGNATION OF TRANSPORT AND AND CONTRINUED   1999   1		, , ,	_		<b>+</b>		
19-105    AMAY I RETEREDON MIT DAYS 02   122955.9715   102467.200   102955.9715   10	R1-TGS5		6-24		1023536.3120	999704.0752	
Ministry	R1-TGS6	TAXIWAY B3 INTERSECTION WITH RUNWAY 29 AT HOLD LINE (308 FEET FROM RUNWAY CENTERLINE).	BS 29	B	1022707.2333	1002692.1203	
PATESTED   PATESTED   THE STATEMENT   THE ST	R1-TGS7	RUNWAY 11 INTERSECTION WITH TAXIWAY B3	← B3	29	1022585.9715	1002418.7860	
H-1001   Marker 11 INTESCENCIN 191 HOURS 20 - 157 TO   102316-11	R1-TGS8	RUNWAY 29 INTERSECTION WITH TAXIWAY B2	B2 →		1023423.5342	1000434.2248	
H-10012    Dames of Introduction with Flavor 2-e-fe for 3	R1-TGS9	TAXIWAY B2 INTERSECTION WITH RUNWAY 29-11 AT HOLD LINE (308 FEET FROM RUNWAY CENTERLINE).	<b>B2</b> 29-11	<b>B2</b>	1023666.5014	1000419.1846	
PLINESS   CHANNEY INTERCEDOR WIT - CHANNEY 20-11 AT -000 LINE (DC) FEDT FROM FORMOW CONTROLLE)   DISCUSSION   DISCUSSION WIT - CHANNEY CONTROLLED   DISCUSSION   DISCUSSION WIT - CHANNEY CONTROLLED   DISCUSSION WITH - CHANNE	R1-TGS10	RUNWAY 11 INTERSECTION WITH TAXIWAY B2	<b>← B2</b>		1023545.5414	1000145.1352	
H-10514   MARROW 1   MITESCEND WITH FARMOR 2   50	R1-TGS11	RUNWAY 11 INTERSECTION WITH RUNWAY 24-6 & TXY D		DA	1023960.6629	999161.5264	
Hersiss   Same or antiferror with rower or common or c	R1-TGS12	TAXIWAY D INTERSECTION WITH RUNWAY 29-11 AT HOLD LINE (303 FEET FROM RUNWAY CENTERLINE).	<b>D</b> 29-11	D	1024130.0408	999307.9930	
H-1951   SAMONY C INTERSECTION AND PRIMARY 24-11 AT HIGH DIRE (1987 ETC) FROM RANDOY CENTRALINE)   STEEL   1024-12-18-12   986-29-21-13   1224-12-18-12   986-29-21-13   1224-12-18-12   986-29-21-13   1224-12-18-12   986-29-21-13   1224-12-18-12   1224-	R1-TGS13	RUNWAY 11 INTERSECTION WITH TAXIWAY D	⊼ D		1024071.9418	998897.8570	
Remote   Memory or Intersection with Follows 4 and 1 fold of Rumany 24   A PRODUCT   100289-1979	R1-TGS14				1024278.5761	998408.2478	
Section   Interestion with Remove 24-of Hold UNE				APRON1	-		
Ref		· ·			<b>+</b>		
			_	B	<b>+</b>		
R2-P055   ANAMY 24   NEPSECTION WITH TAXWAY C2   P052-0000   REAL		·					
Ref							
Re-1055   ALMANY 6 INTERSECTION WITH TAXABAY 2-1 AT HOLD LINE					+		
Ref   Figs   Mumber 2   MURRESCRION WITH LAWARY C   MURRESCRION WITH LAWARY C   MURRESCRION WITH LAWARY C   MURRESCRION WITH LAWARY C   MURRESCRION WITH RUNNAY C   MURR				<u>,2</u>			
R2-1031   TANIBUT C1 INTERSECTION WITH RUNNAY 6 AT HOLD LINE   R2-1031   RANIBUT 24 INTERSECTION WITH RUNNAY 23-11   R2-1031   RANIBUT 24 INTERSECTION WITH RUNNAY 23-11   R2-1031   RANIBUT 24 INTERSECTION WITH RUNNAY 24 AT HOLD LINE EAST SIDE OF TAXIBUT D5   R2-1031   RANIBUT 25 INTERSECTION WITH RUNNAY 24 AT HOLD LINE EAST SIDE OF TAXIBUT D5   R2-1031   RANIBUT 25 INTERSECTION WITH RUNNAY 24 AT HOLD LINE EAST SIDE OF TAXIBUT D5   R2-1031   RANIBUT 25 INTERSECTION WITH RUNNAY 24 AT HOLD LINE EAST SIDE OF TAXIBUT D5   R2-1031   RANIBUT 25 INTERSECTION WITH RUNNAY 24 AT HOLD LINE EAST SIDE OF TAXIBUT D5   R2-1031   RANIBUT 25 INTERSECTION WITH RUNNAY 24 AT HOLD LINE EAST SIDE OF TAXIBUT D5   R2-1031   RANIBUT 25 INTERSECTION WITH RUNNAY 24 AT HOLD LINE EAST SIDE OF TAXIBUT D5   R2-1031   RANIBUT 25 INTERSECTION WITH RUNNAY 24 AT HOLD LINE EAST SIDE OF TAXIBUT D5   R2-1031   RANIBUT 25 INTERSECTION WITH RUNNAY 24-6 AT HOLD LINE EAST SIDE OF TAXIBUT D5   R2-1031   RANIBUT 25 INTERSECTION WITH RUNNAY 24-6 AT HOLD LINE EAST SIDE OF TAXIBUT D5   R2-1031   RANIBUT 25 INTERSECTION WITH RUNNAY 24-6 AT HOLD LINE EAST SIDE OF TAXIBUT D5   R2-1031   RANIBUT 25 INTERSECTION WITH RUNNAY 24-6 AT HOLD LINE EAST SIDE OF TAXIBUT D5   R2-1031   RANIBUT 25 INTERSECTION WITH RUNNAY 24-6 AT HOLD LINE EAST SIDE OF TAXIBUT D5   RANIBUT 25 INTERSECTION WITH RUNNAY 24-6 AT HOLD LINE EAST SIDE OF TAXIBUT 25 INTERSECTION WITH RUNNAY 24-6 AT HOLD LINE EAST SIDE OF TAXIBUT 25 INTERSECTION WITH RUNNAY 24-6 AT HOLD LINE EAST SIDE OF TAXIBUT 25 INTERSECTION WITH RUNNAY 24-6 AT HOLD LINE EAST SIDE OF TAXIBUT 25 INTERSECTION WITH RUNNAY 24-6 AT HOLD LINE EAST SIDE OF TAXIBUT 25 INTERSECTION WITH RUNNAY 24-6 AT HOLD LINE EAST SIDE OF TAXIBUT 25 INTERSECTION WITH RUNNAY 24-6 AT HOLD LINE EAST SIDE OF TAXIBUT 25 INTERSECTION WITH RUNNAY 24-6 AT HOLD LINE EAST SIDE OF TAXIBUT 25 INTERSECTION WITH RUNNAY 24-6 AT HOLD LINE EAST SIDE OF TAXIBUT 25 INTERSECTION WITH RUNNAY 24-6 AT HOLD LINE EAST SIDE OF TAXIBUT 25 INTERSECTION WITH RUNNAY 24-6 AT HOLD					<b>+</b>		
Re-Motion   Reviews 24 INTERSECTION WITH RUMANY 29-11   1022936-6332   1022936-6332   1022936-6332   1022936-6332   1022936-6332   1022936-6332   1022936-6332   1022936-6332   1022936-6332   1022936-6332   1022936-6332   1022936-6332   1022936-6332   1022936-6332   1022936-7332   1022936-					_		
R2-TISST   TAXWAY B INTERSECTION WITH RUNNAY 6-24 AT HOLD LINE   BUSINESS   BUSINESS   1002935.4532   1002937.532							
R2-10513   TAXWAY DS MITERSECTION WITH FUNNAY 24 AT HOLD LINE WEST SIDE OF TAXWAY DS					+		
R2-F051   TANIMAY DS INTERSECTION WITH TANIMAY DS   1005462,1439   1001804.2152   1001804.2152   1001804.2152   1001804.2152   1001804.2152   1001804.2152   1001804.2152   1001806.2755   1001804.2152   1001806.2755							
R2-10516   RUMWAY 24 INTERSECTION WITH TAXWAY 05   1004582.5798   1004582.51344   1001880.5799   1004582.51344   1001880.5799   1004582.51344   100787.8857   1004582.51344   100787.8857   1004582.51384   1006682.2589   1006682.25					<b>+</b>		
R2-TIGS15   RUNNAY 24 INTERSECTION WITH TAXWAY D4   1000787.8557					-		
R2-TGS16   RAWWAY 6 INTERSECTION WITH RUNWAY 24-6 AT HOLD LINE   D21-81-81-81   1024777.3823   1000662.2599   R2-TGS17   RUNWAY 6 INTERSECTION WITH RUNWAY 14-6 AT HOLD LINE   D23-81-81-81   1024264.4796   1000175.3205   R2-TGS18   RAWWAY 6 INTERSECTION WITH RUNWAY 24-6 AT HOLD LINE   D23-81-81-81   1024264.8847   1000054.5512   R2-TGS18   RAWWAY 6 INTERSECTION WITH RUNWAY 24-6 AT HOLD LINE   D23-81-81-81   102445.8847   1000054.5512   R2-TGS19   RAWWAY 6 INTERSECTION WITH RUNWAY 24-6 AT HOLD LINE   D23-81-81   102445.8847   1000054.5512   R2-TGS19   RAWWAY 6 INTERSECTION WITH RUNWAY 11-29, WEST SIDE OF RUNWAY 36   RESERVED   RUNWAY 56 INTERSECTION WITH RUNWAY 11-29, WEST SIDE OF RUNWAY 36   RUNWAY 56 INTERSECTION WITH RUNWAY 11-29, WEST SIDE OF RUNWAY 36   RUNWAY 56 INTERSECTION WITH RUNWAY 11-29, WEST SIDE OF RUNWAY 36   RUNWAY 56 INTERSECTION WITH RUNWAY 36 APPROACH   RUNWAY 36 INTERSECTION WITH RUNWAY 37 INTERSECTION WITH R				2 to 2			
R2-TGS17 RUNWAY 6 INTERSECTION WITH TAXIMAY D4  R2-TGS18 RUNWAY 24 INTERSECTION WITH TAXIMAY D3  R2-TGS18 RUNWAY D3 INTERSECTION WITH TAXIMAY D3  R2-TGS18 RUNWAY D3 INTERSECTION WITH TAXIMAY D3  R2-TGS18 RUNWAY D3 INTERSECTION WITH RUNWAY D4-6 AT HOLD LINE  R2-TGS20 RUNWAY D3 INTERSECTION WITH RUNWAY 11-29, WEST SIDE OF RUNWAY 36  R3-TGS1** S00 RUNWAY 36 INTERSECTION WITH RUNWAY 11-29, WEST SIDE OF RUNWAY 36  R3-TGS1** S00 RUNWAY 36 INTERSECTION WITH RUNWAY 11-29, WEST SIDE OF RUNWAY 36  R3-TGS1** S00 RUNWAY 36 INTERSECTION WITH RUNWAY 11-29, EAST SIDE OF RUNWAY 36  R3-TGS1** S00 RUNWAY 36 INTERSECTION WITH RUNWAY 36 APPROACH AT WEST SIDE OF RUNWAY 36  R1-TGS2 TAXIMAY C INTERSECTION WITH RUNWAY 36 APPROACH AT WEST SIDE OF RUNWAY 36 APPROACH  R2-TGS1 TAXIMAY C RITERSECTION WITH RUNWAY 36 APPROACH AT WEST SIDE OF RUNWAY 36 APPROACH  R2-TGS1 TAXIMAY C LEST OF INTERSECTION WITH TAXIMAY C2  R3-TGS1 TAXIMAY C LEST OF INTERSECTION WITH TAXIMAY C2  R3-TGS1 TAXIMAY A TAXIMERSCENON WITH TAXIMAY C3  R4-RON 1  R2-TGS2 TAXIMAY A TAXIMERSCENON WITH TAXIMAY C3  R3-TGS1 SOUTH SIDE OF APRON NEAR TAXI SOUT T3-TGS1  R3-TGS1 SOUTH SIDE OF APRON NEAR TAXI SOUT T3-TGS1  R3-TGS1 SOUTH SIDE OF APRON NEAR TAXI SOUT T3-TGS1  R3-TGS1 TAXIMAY A TAXIMERSCENON WITH TAXIMAY C3  R3-TGS1 TAXIMAY C4 TAXIMERSCENON WITH TAXIMAY C4  R3-TGS1 TAXIMAY C5 TAXIMAY C6 TAXIMAY C7 T							
R2-TGS18 RUNWAY 24 INTERSECTION WITH TAXIMAY D3  R2-TGS19 TAXIMAY D3 INTERSECTION WITH RUNWAY 24-6 AT HOLD LINE  D3 22-22-22 RUNWAY 6 INTERSECTION WITH RUNWAY 24-6 AT HOLD LINE  R3-TGS19 TAXIMAY C6 INTERSECTION WITH RUNWAY 11-29, WEST SIDE OF RUNWAY 36  R3-TGS29 SON RUNWAY 36 INTERSECTION WITH RUNWAY 11-29, WEST SIDE OF RUNWAY 36  R3-TGS29 SON RUNWAY 36 INTERSECTION WITH RUNWAY 11-29, WEST SIDE OF RUNWAY 36  R3-TGS29 SON RUNWAY 36 INTERSECTION WITH RUNWAY 11-29, WEST SIDE OF RUNWAY 36  R3-TGS29 SON RUNWAY 36 INTERSECTION WITH RUNWAY 11-29, WEST SIDE OF RUNWAY 36  R3-TGS29 SON RUNWAY 36 INTERSECTION WITH RUNWAY 11-29, WEST SIDE OF RUNWAY 36 APPROACH  R3-TGS29 TAXIMAY C INTERSECTION WITH RUNWAY 36 APPROACH AT WEST SIDE OF RUNWAY 36 APPROACH  R3-TGS29 TAXIMAY C INTERSECTION WITH RUNWAY 36 APPROACH AT WEST SIDE OF RUNWAY 36 APPROACH  R3-TGS29 TAXIMAY C LAST OF INTERSECTION WITH TAXIMAY C2  R3-TGS3 TAXIMAY C LAST OF INTERSECTION WITH TAXIMAY C2  R3-TGS3 TAXIMAY C LAST OF INTERSECTION WITH TAXIMAY C3  R3-TGS3 TAXIMAY C LAST OF INTERSECTION WITH TAXIMAY C3  R3-TGS3 TAXIMAY C LAST OF INTERSECTION WITH TAXIMAY C4  R3-TGS3 TAXIMAY C LAST OF APPRON NEAR INTERSECTION WITH TAXIMAY C5  R3-TGS3 TAXIMAY C LAST OF APPROACH NEAR INTERSECTION WITH TAXIMAY C6  R3-TGS3 TAXIMAY C LAST OF APPROACH NEAR INTERSECTION WITH TAXIMAY C7  R3-TGS3 TAXIMAY C LAST OF APPROACH NEAR INTERSECTION WITH TAXIMAY C7  R3-TGS3 TAXIMAY C LAST OF APPROACH NEAR INTERSECTION WITH TAXIMAY C6  R3-TGS3 TAXIMAY C LAST INTERSECTION WITH TAXIMAY C7  R3-TGS3 TAXIMAY C LAST INTERSECTION WITH TAX							
R2-TGS20 RUNWAY 6 INTERSECTION WITH TAXIWAY D3 100047.7511 100047.	R2-TGS18	RUNWAY 24 INTERSECTION WITH TAXIWAY D3			<b>+</b>	1000175.3205	
R3—TGS1** SDD RUNWAY 36 INTERSECTION WITH RUNWAY 11—29, WEST SIDE OF RUNWAY 36 R3—TGS2** SDD RUNWAY 36 INTERSECTION WITH RUNWAY 11—29, EAST SIDE OF RUNWAY 36 R3—TGS2** SDD RUNWAY 36 INTERSECTION WITH RUNWAY 11—29, EAST SIDE OF RUNWAY 36 APPROACH  1022811.2946 996851.5853  11—TGS2 12AWAY C INTERSECTION WITH RUNWAY 36 APPROACH AT WEST SIDE OF RUNWAY 36 APPROACH  1022913.2914 997911.1303  11—TGS2 12AWAY C INTERSECTION WITH RUNWAY 36 APPROACH AT EAST SIDE OF RUNWAY 36 APPROACH  1022913.2914 997911.1303  11—TGS3 12AWAY C EAST OF INTERSECTION WITH TAXWAY C  1022913.2914 997911.1303  11—TGS3 12AWAY A AT INTERSECTION WITH TAXWAY B  1025328.55814 997816.7746  1023535.5814 997816.7746  1023535.5814 997816.7746  1025328.6354.347 997941.0594  1024931.0030 99698.9355  13—TGS1 14—TGS1 14—TGS1 14—TGS1 15—TGS1	R2-TGS19	TAXIWAY D3 INTERSECTION WITH RUNWAY 24-6 AT HOLD LINE	<b>DS</b> 24-6	DE	1024428.8847	1000054.5512	
R3—TGS1** SDD RUNWAY 36 INTERSECTION WITH RUNWAY 11—29, WEST SIDE OF RUNWAY 36 R3—TGS2** SDD RUNWAY 36 INTERSECTION WITH RUNWAY 11—29, EAST SIDE OF RUNWAY 36 R3—TGS2** SDD RUNWAY 36 INTERSECTION WITH RUNWAY 11—29, EAST SIDE OF RUNWAY 36 APPROACH  1022811.2946 996851.5853  11—TGS2 12AWAY C INTERSECTION WITH RUNWAY 36 APPROACH AT WEST SIDE OF RUNWAY 36 APPROACH  1022913.2914 997911.1303  11—TGS2 12AWAY C INTERSECTION WITH RUNWAY 36 APPROACH AT EAST SIDE OF RUNWAY 36 APPROACH  1022913.2914 997911.1303  11—TGS3 12AWAY C EAST OF INTERSECTION WITH TAXWAY C  1022913.2914 997911.1303  11—TGS3 12AWAY A AT INTERSECTION WITH TAXWAY B  1025328.55814 997816.7746  1023535.5814 997816.7746  1023535.5814 997816.7746  1025328.6354.347 997941.0594  1024931.0030 99698.9355  13—TGS1 14—TGS1 14—TGS1 14—TGS1 15—TGS1	R2-TGS20	RUNWAY 6 INTERSECTION WITH TAXIWAY D3	← D3		1024211.7275	1000047.7511	
T1-TGS1 TAXIWAY C INTERSECTION WITH RUNWAY 36 APPROACH AT WEST SIDE OF RUNWAY 36 APPROACH  T1-TGS2 TAXIWAY C INTERSECTION WITH RUNWAY 36 APPROACH AT EAST SIDE OF RUNWAY 36 APPROACH  T1-TGS3 TAXIWAY C BAST OF INTERSECTION WITH TAXIWAY C  T1-TGS3 TAXIWAY C BAST OF INTERSECTION WITH TAXIWAY C  T2-TGS1 TAXIWAY A AT INTERSECTION WITH TAXIWAY C  T2-TGS2 TAXIWAY A AT INTERSECTION WITH TAXIWAY C  T3-TGS1 SOUTH SIDE OF APRON NEAR INTERSECTION WITH TAXIWAY C  T3-TGS1 SOUTH SIDE OF APRON NEAR INTERSECTION WITH TAXIWAY C  T3-TGS1 TAXIWAY DAT INTERSECTION WITH TAXIWAY B  T3-TGS3 TAXIWAY DAT INTERSECTION WITH TAXIWAY B  T3-TGS3 TAXIWAY A AT INTERSECTION WITH TAXIWAY B  T3-TGS4 TAXIWAY DAT INTERSECTION WITH TAXIWAY D  T3-TGS5 TAXIWAY DAT INTERSECTION WITH TAXIWAY D  T3-TGS6 TAXIWAY DAT INTERSECTION WITH TAXIWAY D  T3-TGS7 T					1024454.6403	996766.4035	**UNLIGHTED SIGN
T1-TGS2 TAXIWAY C INTERSECTION WITH RUNWAY 36 APPROACH AT EAST SIDE OF RUNWAY 36 APPROACH  T1-TGS3 TAXIWAY C EAST OF INTERSECTION WITH TAXIWAY C2  61 APRON 1  T2-TGS1 TAXIWAY A AT INTERSECTION OF WEST SIDE OF APRON  APRON 1  T2-TGS1 TAXIWAY A AT INTERSECTION WITH TAXIWAY B  T2-TGS2 TAXIWAY AN INTERSECTION WITH TAXIWAY B  T3-TGS1 SOUTH SIDE OF APRON NEAR RINTERSECTION WITH TAXIWAY C  T3-TGS2 SOUTH SIDE OF APRON NEAR RINTERSECTION WITH TAXIWAY C  T3-TGS3 TAXIWAY D AT INTERSECTION WITH TAXIWAY D  T3-TGS4 TAXIWAY A AT INTERSECTION WITH TAXIWAY D  T3-TGS5 TAXIWAY A AT INTERSECTION WITH TAXIWAY D  T3-TGS5 TAXIWAY A AT INTERSECTION WITH TAXIWAY D  T3-TGS5 TAXIWAY D AT INTERSECTION WITH TAXIWAY D  T3-TGS6 TAXIWAY D AT INTERSECTION WITH TAXIWAY D  T3-TGS6 TAXIWAY D AT INTERSECTION WITH TAXIWAY D  T3-TGS6 TAXIWAY D AT INTERSECTION WITH TAXIWAY D  T3-TGS7 TAXIWAY D AT INTERSECTION WITH TAXIWAY D  T3-TGS8 TAXIWAY D AT INTERSECTION WITH TAXIWAY D  T3-TGS8 TAXIWAY D AT INTERSECTION WITH TAXIWAY D  T3-TGS9 TAXIWAY D AT INTERSECTION WITH TAXIWAY	R3-TGS2**	SOD RUNWAY 36 INTERSECTION WITH RUNWAY 11-29, EAST SIDE OF RUNWAY 36	11-29		1024477.0700	997045.5037	**UNLIGHTED SIGN
T1-IGS3   TAXIWAY C EAST OF INTERSECTION WITH TAXIWAY C2   STATIWAY A AT INTERSECTION OF WEST SIDE OF APRON   APRON 1   1025355.5814   997816.7746     T2-IGS2   TAXIWAY A AT INTERSECTION OF WEST SIDE OF APRON   APRON 1   1025284.5347   997944.0594     T2-IGS2   TAXIWAY A INTERSECTION WITH TAXIWAY B   HEB BIT   APRON 1   1025284.5347   997944.0594     T3-IGS2   TAXIWAY A INTERSECTION WITH TAXIWAY B   HEB BIT   APRON 1   1025382.8905   996798.5455     T3-IGS2   TAXIWAY DAT INTERSECTION WITH TAXIWAY B   HEB BIT   APRON 1   1024931.0030   998588.9352     T3-IGS3   TAXIWAY DAT INTERSECTION WITH TAXIWAY B   HEB BIT   1024931.0030   99859.90219     T3-IGS3   TAXIWAY DAT INTERSECTION WITH TAXIWAY B   HEB BIT   1024932.7742   999659.7903     T3-IGS4   TAXIWAY A AT INTERSECTION WITH TAXIWAY D   HEB BIT   1024593.3727   999733.5140     T3-IGS5   TAXIWAY A AT INTERSECTION WITH TAXIWAY D   HEB BIT   1024593.3727   999733.5140     T3-IGS5   TAXIWAY A AT INTERSECTION WITH TAXIWAY D   HEB BIT   1024593.3727   999733.5140     T3-IGS5   TAXIWAY A AT INTERSECTION WITH TAXIWAY D   HEB BIT   1024593.3727   999733.5140     T3-IGS5   TAXIWAY A AT INTERSECTION WITH TAXIWAY D   HEA BIT   1024590.0556   999459.0086     T3-IGS5   TAXIWAY A AT INTERSECTION WITH TAXIWAY D   HEA BIT   1024597.5664   1000592.8520     T3-IGS7   TAXIWAY B AT INTERSECTION WITH TAXIWAY D   HEA BIT   1024985.7678   997791.1330     T3-IGS7   TAXIWAY B AT WEST SIDE OF ACCESS TAXIWAY AT 10 WEST SIDE OF APRON   HEA BIT   1024979.3959   99794.4420     T5-IGS1   TAXIWAY B AT INTERSECTION WITH TAXIWAY C AT WEST SIDE OF APRON   HEA BIT   1024979.3959   99794.4420     T6-IGS2   TAXIWAY B AT INTERSECTION WITH TAXIWAY C AT WEST SIDE OF APRON   HEA BIT   1024982.8810   99931.45951     T6-IGS5   TAXIWAY B AT INTERSECTION WITH TAXIWAY C AT EAST SIDE OF TAXIWAY C   APRON   HEA BIT   1024981.1200   999321.3591     T6-IGS5   TAXIWAY B AT INTERSECTION WITH TAXIWAY D   P99321.3591   102431.1200   999321.3591     T6-IGS5   TAXIWAY B AT INTERSECTION WITH TAXIWAY D   HEAD BIT   102	T1-TGS1	TAXIWAY C INTERSECTION WITH RUNWAY 36 APPROACH AT WEST SIDE OF RUNWAY 36 APPROACH	36-APCH		1022811.2946	996851.3583	
T2-TGS1   TAXIWAY A AT INTERSECTION OF WEST SIDE OF APRON   APRON   APRON   APRON   1025284.5347   997944.0594     T2-TGS2   TAXIWAY A INTERSECTION WITH TAXIWAY B   ←B A BIT   APRON   1025382.8905   996798.5455     T3-TGS1   SOUTH SIDE OF APRON NEAR INTERSECTION WITH TAXIWAY C   6-29 ↑ 11→   1024931.0030   998589.8352     T3-TGS2   SOUTH SIDE OF APRON NEAR TAXI SIGN T3-TGS1   ← 24   1024865.5978   998769.0219     T3-TGS3   TAXIWAY DA AT INTERSECTION WITH TAXIWAY B   ← 29 ↑ 11→   1024332.7942   999659.7903     T3-TGS4   TAXIWAY A AT INTERSECTION WITH TAXIWAY D   ↑ 24 ↑ ↑ APRON   1024695.0556   999459.0086     T3-TGS5   TAXIWAY A AT INTERSECTION WITH TAXIWAY D   ← APRON   1024695.0556   999459.0086     T3-TGS5   TAXIWAY DA AT INTERSECTION WITH TAXIWAY D   ←APRON   1024737.5624   1000592.8520     T3-TGS5   TAXIWAY DA AT INTERSECTION WITH TAXIWAY D   ←APRON   1024737.5624   1000592.8520     T3-TGS5   TAXIWAY DA AT INTERSECTION WITH TAXIWAY D   ←APRON   1024737.5624   1000002.5034     T4-TGS1   TAXIWAY DA AT INTERSECTION WITH TAXIWAY D   ←APRON   1024985.7678   997791.1330     T5-TGS1   TAXIWAY DA AT INTERSECTION WITH TAXIWAY B   ←29 ↑ 61 ↑ APRON   1024764.1517   998494.7484     T5-TGS2   ACCESS TAXIWAY A I TO WEST SIDE OF APRON   11↑   1024997.9399   997941.4906     T5-TGS2   TAXIWAY DA AT INTERSECTION WITH TAXIWAY C AT WEST SIDE OF TAXIWAY C   ←APRON   1024780.7796   998339.0668     T6-TGS2   TAXIWAY B AT INTERSECTION WITH TAXIWAY C   AT EAST SIDE OF ACCESS TAXIWAY C   APRON   1024780.7796   998339.0668     T6-TGS3   TAXIWAY B AT INTERSECTION WITH TAXIWAY C   AT EAST SIDE OF ACCESS TAXIWAY C   AT EAST SIDE OF TAXIWAY C   APRON   1024615.8413   998501.4050     T6-TGS5   TAXIWAY B AT INTERSECTION WITH TAXIWAY C   AT EAST SIDE OF TAXIWAY C   APRON   1024615.8413   998501.4050     T6-TGS5   TAXIWAY B AT INTERSECTION WITH TAXIWAY C   AT EAST SIDE OF TAXIWAY C   APRON   1024615.8413   998501.4050     T6-TGS5   TAXIWAY B AT INTERSECTION WITH TAXIWAY C   AT EAST SIDE OF TAXIWAY C   APRON   1024391.0700   999321.3591	T1-TGS2	TAXIWAY C INTERSECTION WITH RUNWAY 36 APPROACH AT EAST SIDE OF RUNWAY 36 APPROACH	36- A P C H		1022913.9214	997191.1303	
T2-TGS2	T1-TGS3	TAXIWAY C EAST OF INTERSECTION WITH TAXIWAY C2	61	APRONT	1023535.5814	997816.7746	
T3-TGS1   SOUTH SIDE OF APRON NEAR INTERSECTION WITH TAXIWAY C   G-29↑ II→   1024931.0030   998589.8352     T3-TGS2   SOUTH SIDE OF APRON NEAR TAXI SIGN T3-TGS1   ← 24   1024865.5978   998769.0219     T3-TGS3   TAXIWAY D AT INTERSECTION WITH TAXIWAY B   1024332.7942   999659.7903     T3-TGS4   TAXIWAY A AT INTERSECTION WITH TAXIWAY D   ← 29   II	T2-TGS1	TAXIWAY A AT INTERSECTION OF WEST SIDE OF APRON	APRONT	A	1025284.5347	997944.0594	
T3—TGS2 SOUTH SIDE OF APRON NEAR TAXI SIGN T3—TGS1	T2-TGS2	TAXIWAY A INTERSECTION WITH TAXIWAY B	←B A Bi↑	<b>APRON</b>	1025382.8905	996798.5455	
T3-TGS3 TAXIWAY D AT INTERSECTION WITH TAXIWAY B    C29  17	T3-TGS1	SOUTH SIDE OF APRON NEAR INTERSECTION WITH TAXIWAY C	6.29↑ 11→		1024931.0030	998589.8352	
T3-TGS4       TAXIWAY A AT INTERSECTION WITH TAXIWAY D       C24       1024593.3727       999733.5140         T3-TGS5       TAXIWAY A AT INTERSECTION OF EAST SIDE OF APRON       24 ↑       APRON ↑       1024695.0556       999459.0086         T3A-TGS1       TAXIWAY D4 AT INTERSECTION WITH TAXIWAY D       ←APRON       1024737.5624       1000592.8520         T3A-TGS2       TAXIWAY D AT INTERSECTION WITH TAXIWAY A AND TAXIWAY D3       APRON 2       1024527.2835       1000002.5034         T4-TGS1       TAXIWAY B AT WEST SIDE OF ACCESS TAXIWAY A1 TO WEST SIDE OF APRON       ←APRON       111 1024764.1517       998494.7484         T5-TGS2       ACCESS TAXIWAY A1 TO WEST SIDE OF APRON AT INTERSECTION WITH TAXIWAY B       11 →       1024764.1517       998494.7484         T6-TGS1       TAXIWAY B AT INTERSECTION WITH TAXIWAY C AT WEST SIDE OF TAXIWAY C       ←APRON       1024799.3959       997949.4420         T6-TGS2       TAXIWAY B AT INTERSECTION WITH TAXIWAY C AT EAST SIDE OF APRON       APRON →       1024780.7796       998339.0668         T6-TGS3       TAXIWAY B AT INTERSECTION WITH TAXIWAY C AT EAST SIDE OF TAXIWAY C       APRON →       1024615.8413       998501.4050         T6-TGS4       TAXIWAY D AT INTERSECTION WITH TAXIWAY D       ♠B       1024391.0700       999321.3591         T6-TGS5       TAXIWAY B AT INTERSECTION WITH TAXIWAY D       ♠C24[291 </td <td>T3-TGS2</td> <td>SOUTH SIDE OF APRON NEAR TAXI SIGN T3-TGS1</td> <td>← 24</td> <td></td> <td>1024865.5978</td> <td>998769.0219</td> <td></td>	T3-TGS2	SOUTH SIDE OF APRON NEAR TAXI SIGN T3-TGS1	← 24		1024865.5978	998769.0219	
T3—TGS5 TAXIWAY A AT INTERSECTION OF EAST SIDE OF APRON  T3A—TGS1 TAXIWAY D4 AT INTERSECTION WITH TAXIWAY D  GAPRON  T3A—TGS2 TAXIWAY D4 AT INTERSECTION WITH TAXIWAY D3  T4—TGS1 TAXIWAY B AT WEST SIDE OF ACCESS TAXIWAY A1 TO WEST SIDE OF APRON  T5—TGS1 TAXIWAY B AT WEST SIDE OF ACCESS TAXIWAY A1 TO WEST SIDE OF APRON  T5—TGS1 TAXIWAY C AT INTERSECTION WITH TAXIWAY B  T5—TGS2 ACCESS TAXIWAY A1 TO WEST SIDE OF APRON AT INTERSECTION WITH TAXIWAY B  T6—TGS1 TAXIWAY B AT INTERSECTION WITH TAXIWAY C AT WEST SIDE OF TAXIWAY C  T6—TGS1 TAXIWAY B AT INTERSECTION WITH TAXIWAY C  T6—TGS2 TAXIWAY B AT INTERSECTION WITH TAXIWAY C  T6—TGS3 TAXIWAY B AT INTERSECTION WITH TAXIWAY C  T6—TGS3 TAXIWAY B AT INTERSECTION WITH TAXIWAY C  T6—TGS4 TAXIWAY B AT INTERSECTION WITH TAXIWAY C  T6—TGS5 TAXIWAY D AT INTERSECTION WITH TAXIWAY C  T6—TGS5 TAXIWAY B AT INTERSECTION WITH TAXIWAY C  T6—TGS5 TAXIWAY D AT INTERSECTION WITH TAXIWAY C  T6—TGS5 TAXIWAY D AT INTERSECTION WITH TAXIWAY C  T6—TGS5 TAXIWAY B AT INTERSECTION WITH TAXIWAY C  T6—TGS5 TAXIWAY D AT INTERSECTION WITH TAXIWAY C  T6—TGS6 TAXIWAY D AT INTERSECTION WITH TAXIWAY C  T6—TGS6 TAXIWAY B AT INTERSECTION WITH TAXIWAY C  T6—TGS6 TAXIWAY D AT INTERSECTION WITH TAXIWAY C  T6—TGS6 TAXIWAY B AT INTERSECTION WITH TAXIWAY C  T6—TGS6 TAXIWAY C	T3-TGS3	TAXIWAY D AT INTERSECTION WITH TAXIWAY B	∠ 29 11 ≥	ND .	1024332.7942	999659.7903	
T3A-TGS1       TAXIWAY D4 AT INTERSECTION WITH TAXIWAY D       ←A PRON       1024737.5624       1000592.8520         T3A-TGS2       TAXIWAY D AT INTERSECTION WITH TAXIWAY A AND TAXIWAY D3       1024527.2835       1000002.5034         T4-TGS1       TAXIWAY B AT WEST SIDE OF ACCESS TAXIWAY A1 TO WEST SIDE OF APRON       ←A PRON       111 11 11 11 11 11 11 11 11 11 11 11 11	T3-TGS4	TAXIWAY A AT INTERSECTION WITH TAXIWAY D	₹ 24	A	1024593.3727	999733.5140	
T3A-TGS2       TAXIWAY D AT INTERSECTION WITH TAXIWAY A AND TAXIWAY D3       APRON 7       1024527.2835       1000002.5034         T4-TGS1       TAXIWAY B AT WEST SIDE OF ACCESS TAXIWAY A1 TO WEST SIDE OF APRON       ←A PRON 1       1024985.7678       997791.1330         T5-TGS1       TAXIWAY C AT INTERSECTION WITH TAXIWAY B       ← 29 6 f APRON 1       1024764.1517       998494.7484         T5-TGS2       ACCESS TAXIWAY A1 TO WEST SIDE OF APRON AT INTERSECTION WITH TAXIWAY B       11→ 1024979.3959       997949.4420         T6-TGS1       TAXIWAY B AT INTERSECTION WITH TAXIWAY C AT WEST SIDE OF TAXIWAY C       ←A PRON 1024780.7796       998339.0668         T6-TGS2       TAXIWAY B AT EAST SIDE OF ACCESS TAXIWAY A1 TO WEST SIDE OF APRON APRON APRON APRON 1024824.8810       997941.4906         T6-TGS3       TAXIWAY B AT INTERSECTION WITH TAXIWAY C AT EAST SIDE OF APRON APRON APRON 1024231.1200       APRON 1024231.1200       998501.4050         T6-TGS4       TAXIWAY D AT INTERSECTION WITH TAXIWAY B       ✓ B       1024615.8413       998501.4050         T6-TGS5       TAXIWAY B AT INTERSECTION WITH TAXIWAY B       ✓ B       1024231.1200       999321.3591         T6-TGS5       TAXIWAY B AT INTERSECTION WITH TAXIWAY D       ♠ PRON ↑       1024391.0700       999350.7936	T3-TGS5	TAXIWAY A AT INTERSECTION OF EAST SIDE OF APRON	24 ↑	APRON1	1024695.0556	999459.0086	
T4-TGS1       TAXIWAY B AT WEST SIDE OF ACCESS TAXIWAY A1 TO WEST SIDE OF APRON       ←A PRON       11↑       1024985.7678       997791.1330         T5-TGS1       TAXIWAY C AT INTERSECTION WITH TAXIWAY B       ←29 6↑       A PRON↑       1024764.1517       998494.7484         T5-TGS2       ACCESS TAXIWAY A1 TO WEST SIDE OF APRON AT INTERSECTION WITH TAXIWAY B       11→       1024979.3959       997949.4420         T6-TGS1       TAXIWAY B AT INTERSECTION WITH TAXIWAY C AT WEST SIDE OF TAXIWAY C       ←A PRON       1024780.7796       998339.0668         T6-TGS2       TAXIWAY B AT EAST SIDE OF ACCESS TAXIWAY A1 TO WEST SIDE OF APRON       A PRON→       1024824.8810       997941.4906         T6-TGS3       TAXIWAY B AT INTERSECTION WITH TAXIWAY C AT EAST SIDE OF TAXIWAY C       A PRON→       1024615.8413       998501.4050         T6-TGS4       TAXIWAY D AT INTERSECTION WITH TAXIWAY B       ✓ B       1024231.1200       999321.3591         T6-TGS5       TAXIWAY B AT INTERSECTION WITH TAXIWAY D       ♠24   29↑       A PRON ↑       1024391.0700       999350.7936					-		
T5-TGS1       TAXIWAY C AT INTERSECTION WITH TAXIWAY B       ← 29 6 ↑       APRON ↑       1024764.1517       998494.7484         T5-TGS2       ACCESS TAXIWAY A1 TO WEST SIDE OF APRON AT INTERSECTION WITH TAXIWAY B       II→       1024979.3959       997949.4420         T6-TGS1       TAXIWAY B AT INTERSECTION WITH TAXIWAY C AT WEST SIDE OF TAXIWAY C       ← APRON       B       1024780.7796       998339.0668         T6-TGS2       TAXIWAY B AT EAST SIDE OF ACCESS TAXIWAY A1 TO WEST SIDE OF APRON       APRON→       B       1024824.8810       997941.4906         T6-TGS3       TAXIWAY B AT INTERSECTION WITH TAXIWAY C AT EAST SIDE OF TAXIWAY C       APRON→       B       1024615.8413       998501.4050         T6-TGS4       TAXIWAY D AT INTERSECTION WITH TAXIWAY B       ✓ B       1024231.1200       999321.3591         T6-TGS5       TAXIWAY B AT INTERSECTION WITH TAXIWAY D       ♠ PRON ↑       1024391.0700       999350.7936					+		
T5-TGS2       ACCESS TAXIWAY A1 TO WEST SIDE OF APRON AT INTERSECTION WITH TAXIWAY B       II→       1024979.3959       997949.4420         T6-TGS1       TAXIWAY B AT INTERSECTION WITH TAXIWAY C AT WEST SIDE OF TAXIWAY C       ←A PRON       III→       1024780.7796       998339.0668         T6-TGS2       TAXIWAY B AT EAST SIDE OF ACCESS TAXIWAY A1 TO WEST SIDE OF APRON       A PRON→       III→       1024824.8810       997941.4906         T6-TGS3       TAXIWAY B AT INTERSECTION WITH TAXIWAY C AT EAST SIDE OF TAXIWAY C       A PRON→       III→       1024615.8413       998501.4050         T6-TGS4       TAXIWAY D AT INTERSECTION WITH TAXIWAY B       ✓ B       1024231.1200       999321.3591         T6-TGS5       TAXIWAY B AT INTERSECTION WITH TAXIWAY D       ★24 29↑       A PRON↑       1024391.0700       999350.7936					+		
T6-TGS1       TAXIWAY B AT INTERSECTION WITH TAXIWAY C AT WEST SIDE OF TAXIWAY C       ←A PRON       ■ 1024780.7796       998339.0668         T6-TGS2       TAXIWAY B AT EAST SIDE OF ACCESS TAXIWAY A1 TO WEST SIDE OF APRON       A PRON→       ■ 1024824.8810       997941.4906         T6-TGS3       TAXIWAY B AT INTERSECTION WITH TAXIWAY C AT EAST SIDE OF TAXIWAY C       A PRON→       ■ 1024615.8413       998501.4050         T6-TGS4       TAXIWAY D AT INTERSECTION WITH TAXIWAY B       ✓ B       1024231.1200       999321.3591         T6-TGS5       TAXIWAY B AT INTERSECTION WITH TAXIWAY D       ★24 29↑       A PRON↑       1024391.0700       999350.7936				APRON1	-		
T6-TGS2       TAXIWAY B AT EAST SIDE OF ACCESS TAXIWAY A1 TO WEST SIDE OF APRON       APRON→       B       1024824.8810       997941.4906         T6-TGS3       TAXIWAY B AT INTERSECTION WITH TAXIWAY C AT EAST SIDE OF TAXIWAY C       APRON→       B       1024615.8413       998501.4050         T6-TGS4       TAXIWAY D AT INTERSECTION WITH TAXIWAY B       ✓ B       1024231.1200       999321.3591         T6-TGS5       TAXIWAY B AT INTERSECTION WITH TAXIWAY D       ★24 29↑       APRON↑       1024391.0700       999350.7936					+		ļ
T6-TGS3       TAXIWAY B AT INTERSECTION WITH TAXIWAY C AT EAST SIDE OF TAXIWAY C       APRON→       B       1024615.8413       998501.4050         T6-TGS4       TAXIWAY D AT INTERSECTION WITH TAXIWAY B       C       B       1024231.1200       999321.3591         T6-TGS5       TAXIWAY B AT INTERSECTION WITH TAXIWAY D       C       24 29↑       APRON↑       1024391.0700       999350.7936					-		
T6-TGS4       TAXIWAY D AT INTERSECTION WITH TAXIWAY B       ✓ B       1024231.1200       999321.3591         T6-TGS5       TAXIWAY B AT INTERSECTION WITH TAXIWAY D       ★24 29↑       APRON↑       1024391.0700       999350.7936							<del>                                     </del>
T6-TGS5         TAXIWAY B AT INTERSECTION WITH TAXIWAY D         ►24 29↑         APRON↑         1024391.0700         999350.7936					<b>+</b>		<del>                                     </del>
					<b>+</b>		
				APRONT	+		<del>                                     </del>

# TAXI GUIDANCE SIGN LEGEND

TYPE L-858L(L) LOCATION SIGN - YELLOW LEGEND AND BORDER ON A BLACK BACKGROUND

24 TYPE L-858R(L) MANDATORY INSTRUCTION SIGN - BLACK OUTLINE ON OUTSIDE EDGE OF WHITE LEGEND ON A RED BACKGROUND

A→ TYPE L-858Y(L) DIRECTION, DESTINATION, AND BOUNDARY SIGN - BLACK LEGEND ON A YELLOW BACKGROUND

BLANK - BLACK BACKGROUND

# TAXI GUIDANCE SIGN NOTES

- 1. THE PROPOSED TAXI GUIDANCE SIGNS SHALL CONFORM TO ADVISORY CIRCULAR 150/5345 44K (OR LATEST ISSUE IN FORCE) AND BE FAA-APPROVED FOR TYPE L-858(L) TAXIWAY AND RUNWAY SIGNS WITH LED (LIGHT EMITTING DIODE) ILLUMINATION. THE SIGNS SHALL READ AS DESCRIBED ON THE CONSTRUCTION PLANS. THE PROPOSED TAXI GUIDANCE SIGNS SHALL BE TYPE L-858Y(L) DIRECTION, DESTINATION, AND BOUNDARY SIGNS (BLACK LEGEND ON YELLOW BACKGROUND); L-858R(L) MANDATORY INSTRUCTION SIGN (BLACK OUTLINE ON OUTSIDE EDGE OF WHITE LEGEND ON RED BACKGROUND); AND L-858L(L) LOCATION SIGN (YELLOW LEGEND AND BORDER ON BLACK BACKGROUND).
- THE TAXI GUIDANCE SIGNS CONNECTED TO THE RUNWAY 11-29 LIGHTING CIRCUIT SHALL BE SIZE 1, 18-IN. SIGN FACE WITH A 12-IN. LEGEND; STYLE 3, POWERED FROM A 2.8 TO 6.6 AMP SERIES LIGHTING CIRCUIT; CLASS 2, FOR OPERATION FROM -40°F TO 131°F; MODE 2, TO WITHSTAND WIND LOADS OF 200 M.P.H., BASE-MOUNTED, DOUBLE-SIDED, AS SPECIFIED ON THE PLANS.
- 3. THE TAXI GUIDANCE SIGNS CONNECTED TO THE RUNWAY 6-24 LIGHTING CIRCUIT AND THE TAXIWAY LIGHTING CIRCUITS SHALL BE SIZE 1, 18-IN. SIGN FACE WITH A 12-IN. LEGEND; STYLE 2, POWERED FROM A 4.8 TO 6.6 AMP SERIES LIGHTING CIRCUIT; CLASS 2, FOR OPERATION FROM -40°F TO 131°F; MODE 2, TO WITHSTAND WIND LOADS OF 200 M.P.H., BASE-MOUNTED, DOUBLE-SIDED, AS SPECIFIED ON THE PLANS.
- 4. TAXI GUIDANCE SIGNS WITH LED (LIGHT EMITTING DIODE) ILLUMINATION SHALL CONFORM TO THE APPLICABLE REQUIREMENTS OF FAA ENGINEERING BRIEF NO. 67D LIGHT SOURCES OTHER THAN INCANDESCENT AND XENON FOR AIRPORT AND OBSTRUCTION LIGHTING FIXTURES.
- 5. THE PROPOSED UNLIGHTED TAXI GUIDANCE SIGNS SHALL CONFORM TO ADVISORY CIRCULAR 150/5345 44K (OR LATEST ISSUE IN FORCE) AND BE FAA—APPROVED FOR TYPE L—858 TAXIWAY AND RUNWAY SIGNS. THE SIGNS SHALL BE SIZE 1, 18—IN. SIGN FACE WITH A 12—IN. LEGEND; STYLE 4, UNLIGHTED SIGNS; MODE 2, TO WITHSTAND WIND LOADS OF 200 M.P.H., BASE—MOUNTED, AS SPECIFIED ON THE PLANS.
- TAXI GUIDANCE SIGNS WITH R1 PREFIX SHALL BE CONNECTED TO THE RUNWAY 11-29 LIGHTING SERIES CIRCUIT.
- 7. TAXI GUIDANCE SIGNS WITH R2 PREFIX SHALL BE CONNECTED TO THE RUNWAY 6-24 LIGHTING SERIES CIRCUIT
- 8. TAXI GUIDANCE SIGNS WITH R3 PREFIX ARE UNLIGHTED SIGNS TO BE LOCATED ON THE SHORT TAKE-OFF AND LANDING TURF RUNWAY 18-36.
- 9. TAXI GUIDANCE SIGNS WITH T1 PREFIX SHALL BE CONNECTED TO TAXIWAY LIGHTING SERIES CIRCUIT NUMBER 1. CIRCUIT 1 IS FOR TAXIWAY C SOUTH OF RUNWAY 11-29.
- 10. TAXI GUIDANCE SIGNS WITH T2 PREFIX SHALL BE CONNECTED TO TAXIWAY LIGHTING SERIES CIRCUIT NUMBER 2. CIRCUIT 2 IS FOR TAXIWAY A WEST OF THE APRON.
- 11. TAXI GUIDANCE SIGNS WITH T3 PREFIX SHALL BE CONNECTED TO TAXIWAY LIGHTING SERIES CIRCUIT NUMBER 3. CIRCUIT 3 IS FOR EAST HALF OF APRON, TAXIWAY A, TAXIWAY D3, AND PART OF TAXIWAY D.
- 12. TAXI GUIDANCE SIGNS WITH T3A PREFIX SHALL BE CONNECTED TO TAXIWAY LIGHTING SERIES CIRCUIT NUMBER 3A. CIRCUIT 3A IS FOR TAXIWAY D EAST OF TAXIWAY D3.
- 13. TAXI GUIDANCE SIGNS WITH T4 PREFIX SHALL BE CONNECTED TO TAXIWAY LIGHTING SERIES CIRCUIT NUMBER 4. CIRCUIT 4 IS FOR TAXIWAY B WEST OF APRON.
- 14. TAXI GUIDANCE SIGNS WITH T5 PREFIX SHALL BE CONNECTED TO TAXIWAY LIGHTING SERIES CIRCUIT NUMBER 5. CIRCUIT 5 IS FOR TAXIWAY C NORTH OF RUNWAY 11-29, AND AREA BY WEST HALF OF APRON.
- 15. TAXI GUIDANCE SIGNS WITH T6 PREFIX SHALL BE CONNECTED TO TAXIWAY LIGHTING SERIES CIRCUIT NUMBER 6. CIRCUIT 6 IS FOR TAXIWAY B WEST OF RUNWAY 6-24 TO WEST SIDE OF APRON.
- 16. TAXI GUIDANCE SIGNS WITH T7 PREFIX SHALL BE CONNECTED TO TAXIWAY LIGHTING SERIES CIRCUIT NUMBER 7. CIRCUIT 7 IS FOR TAXIWAY B EAST OF RUNWAY 6-24.
- 17. RUNWAY EXIT/TAXIWAY ENTRANCE SIGNS (TAXIWAY GUIDANCE SIGNS TO DEFINE THE THROAT OR ENTRANCE INTO THE INTERSECTING TAXIING ROUTE) SHALL BE CONNECTED TO THE RESPECTIVE RUNWAY SERIES CIRCUIT TO BE ILLUMINATED WHEN THE RUNWAY EDGE LIGHTS ARE ON TO COMPLY WITH FAA AC 150/5340-18F, CHAPTER 1, PART 15 "SIGN OPERATION"
- 18. HOLDING POSITION SIGNS FOR RUNWAYS SHALL BE CONNECTED TO THE RESPECTIVE RUNWAY SERIES CIRCUIT TO BE ILLUMINATED WHEN THE ASSOCIATED RUNWAY LIGHTS ARE ILLUMINATED TO COMPLY WITH FAA AC 150/5340-18F, CHAPTER 1, PART 15 "SIGN OPERATION".



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COLES COUNTY AIRPORT
AUTHORITY
COLES COMPTY MEMORIAL AIRPORT

REMOVE AND REPLACE ALL TAXI GUIDANCE SIGNS ON THE AIRPORT

IDA No: MTO-4511 SBG Project No: 3-17-SBGP-XX

Contract No. CO062


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PRO IFO	T NO: 1	34012	1D	

ISSUE: APRIL 15, 2016
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REVIEWED BY: LDH 03/08/2016

SHEET TITLE

TAXI GUIDANCE SIGN SCHEDULE

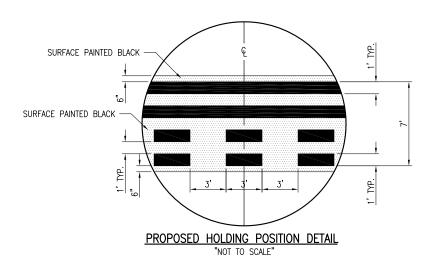

MARKING QUANTITIES				
DESCRIPTION	UNIT AREA	NO. REQUIRED	TOTAL AREA	
HOLDING LINE (TAXIWAY "C" WEST OF RUNWAY 36 APPROACH)	195	1	195	
HOLDING LINE (TAXIWAY "C" EAST OF RUNWAY 36 APPROACH)	150	1	150	
		TOTAL YELLOW MARK	KING = 345	
BLACK BORDER (TAXIWAY "C" WEST OF RUNWAY 36 APPROACH)	325	1	325	
BLACK BORDER (TAXIWAY "C" EAST OF RUNWAY 36 APPROACH)	250	1	250	
		TOTAL BLACK MARK	KING = 575	

# 620-PAVEMENT MARKING-WATERBORNE NOTES

- THE PAVEMENT MARKING-WATERBORNE (620) SHALL BE PLACED IN ACCORDANCE WITH ITEM 620 "PAVEMENT MARKING" AS STATED ON PAGE 277 OF THE STANDARD SPECIFICATIONS FOR CONSTRUCTION OF AIRPORTS, ADOPTED APRIL 1, 2012.
- THIS ITEM SHALL CONSIST OF HOLDING MARKING IN ACCORDANCE WITH THESE SPECIFICATIONS AND AT THE LOCATIONS SHOWN ON THE CONSTRUCTION PLANS. MARKING SHALL BE YELLOW IN COLOR. THE PROPOSED PAVEMENT MARKING SHALL BE APPLIED IN TWO APPLICATIONS.
- ANY MATERIAL DELIVERED THAT FAILS TO MEET THE SPECIFICATIONS SHALL BE DISPOSED OF BY THE VENDOR AND IMMEDIATELY REPLACED WITH ACCEPTABLE MATERIAL ENTIRELY AT THE VENDOR'S EXPENSE, INCLUDING HANDLING AND TRANSPORTATION CHARGES.
- 4. ALL PROPOSED MARKING WILL BE COMPLETED IN ACCORDANCE WITH THE DETAILS SHOWN ON THE CONSTRUCTION PLANS.
- GLASS BEADS SHALL BE REQUIRED ONLY ON THE SECOND APPLICATION OF YELLOW MARKING.
- 6. CUT-OFF SHEETS WILL BE REQUIRED TO INSURE STRAIGHT EDGES.
- THE TAXIWAY HOLDING LINES WILL BE OUTLINED IN A BLACK BORDER. REFLECTIVE MEDIA WILL NOT BE REQUIRED FOR THE BLACK BORDER.
- THE PROPOSED TAXIWAY HOLDING LINE MARKING WILL BE PAID FOR UNDER ITEM: AR620520 "PAVEMENT MARKING—WATERBORNE"\_\_\_\_ PER SQ. FT.



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COLES COUNTY AIRPORT
AUTHORITY
COLES COUNTY MEMORIAL AIRPORT

REMOVE AND REPLACE ALL TAXI GUIDANCE SIGNS ON THE AIRPORT

IDA No: MTO-4511 SBG Project No: 3-17-SBGP-XX

Contract No. CO062


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PAVEMENT MARKING AND DETAILS





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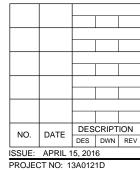
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**COLES COUNTY AIRPORT** - AUTHORITY

REMOVE AND REPLACE ALL TAXI **GUIDANCE SIGNS ON** THE AIRPORT
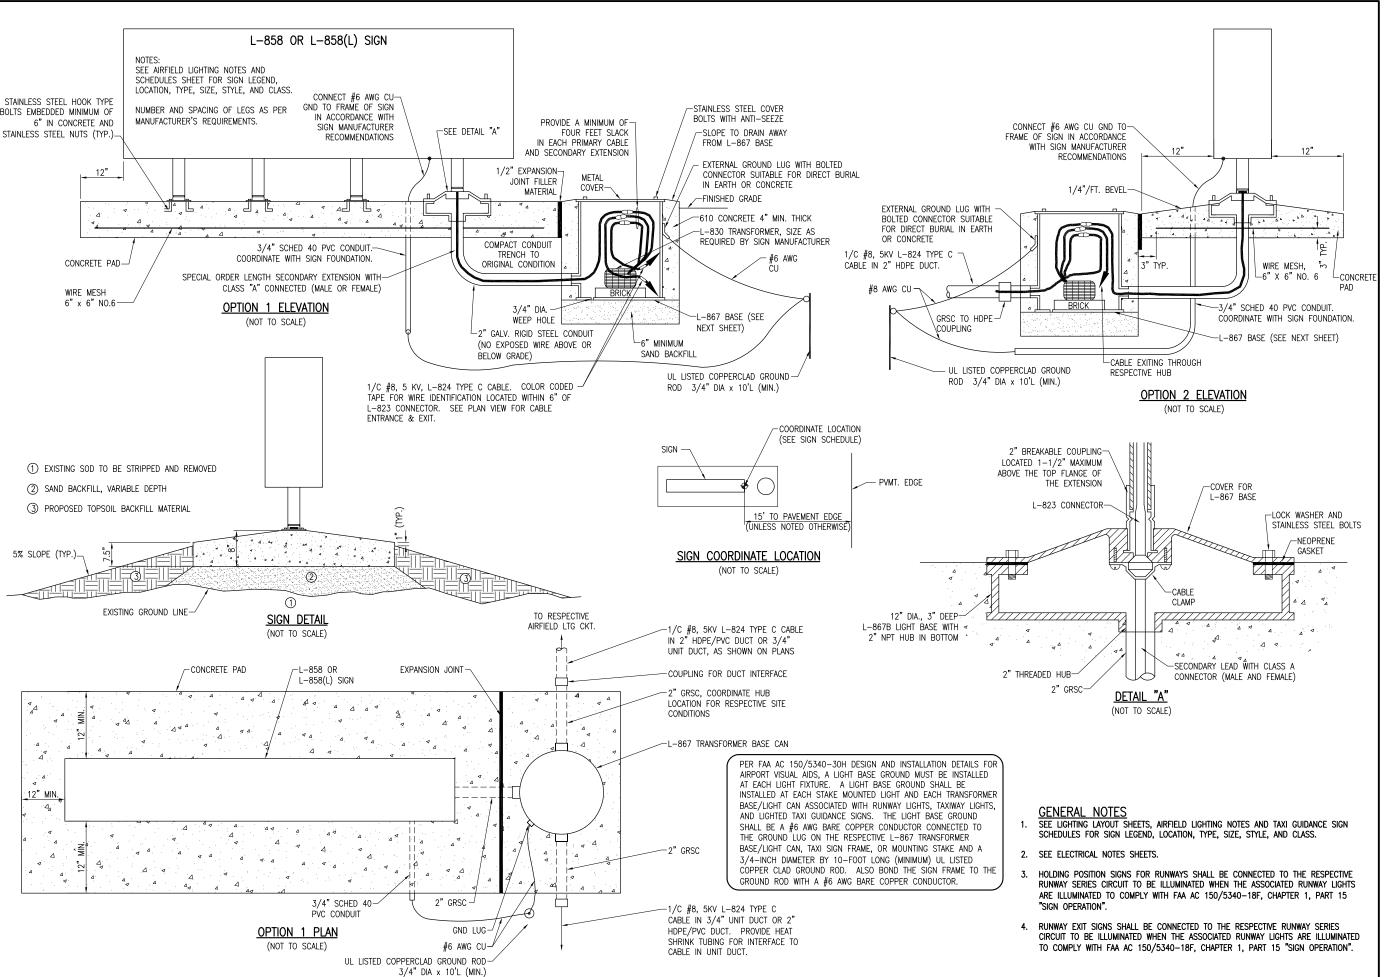
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Contract No. CO062



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DRAWN BY: RAD 02/19/2016 REVIEWED BY: KNL 03/08/2016

SHEET TITLE

TAXI GUIDANCE SIGN **DETAILS** 

- 3/16"x1.5"x1.5" ANGLE

2" ALUM. PIPE COUPLING

2" SCHED. 40 X 6" FRANGIBLE COUPLING

GALVANIZED BASEPLATE

**BACK ELEVATION** 

PIPE CAP -

MOUNTING BRACKET

2" SCHED 40 ALUM. PIPE

CONCRETE PAD -

WIRE MESH -

6"x6" NO. 6

AND STAINLESS STEEL HARDWARE

AIRCRAFT CABLE TETHER

(TYP. OF 2 PER SIGN)

# 5% SLOPE (TYP.)-

# 2" SCHED 40 ALUM. PIPE 3/16"x1.5"x1.5" ANGLE 2" ALUM. PIPE COUPLING 2" SCHED. 40 X 6" FRANGIBLE COUPLING GALVANIZED BASEPLATE 30" MIN. PIPE CAP 1 EXISTING SOD TO BE STRIPPED AND REMOVED 2 SAND BACKFILL, VARIABLE DEPTH 3 PROPOSED TOPSOIL BACKFILL MATERIAL

SIDE ELEVATION

GROUND LINE-

UNLIGHTED TAXI GUIDANCE SIGN NOTES

WITHSTAND WIND LOADS OF 200 M.P.H., BASE-MOUNTED.

(YELLOW LEGEND AND BORDER ON BLACK BACKGROUND).

THE PROPOSED UNLIGHTED TAXI GUIDANCE SIGNS SHALL CONFORM TO ADVISORY CIRCULAR 150/5345—44J (OR LATEST ISSUE IN FORCE) AND BE FAA—APPROVED FOR TYPE L—858 TAXIWAY AND RUNWAY SIGNS. THE SIGNS SHALL BE SIZE 1, 18—IN. SIGN FACE WITH A 12—IN. LEGEND; STYLE 4, UNLIGHTED SIGNS; MODE 2, TO

2. THE SIGNS SHALL READ AS DESCRIBED ON THE TAXI GUIDANCE SIGN SCHEDULE. THE PROPOSED TAXI GUIDANCE SIGNS WILL BE TYPE L-858-Y DIRECTION, DESTINATION, AND BOUNDARY SIGNS (BLACK LEGEND ON YELLOW BACKGROUND); TYPE L-858-R MANDATORY INSTRUCTION SIGN (BLACK OUTLINE ON OUTSIDE EDGE

OF WHITE LEGEND ON RED BACKGROUND); AND TYPE L-858-L LOCATION SIGN

3. THE CONCRETE USED IN THE CONSTRUCTION OF THESE ITEMS SHALL BE IN

ACCORDANCE WITH ITEM 610 STRUCTURAL PORTLAND CEMENT CONCRETE.

UNLIGHTED SIGN DETAILS
(NOT TO SCALE)



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COLES COUNTY AIRPORT
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SHEET TITLE

UNLIGHTED SIGN DETAILS

EXISTING LOW VOLTAGE CABLES ONLY.

TYPE A SPLICES SHALL BE MADE IN SPLICE

CANS, HANDHOLES, MANHOLES, OR

JUNCTIONS BOXES

CONTINUOUS HEAT SHRINK TUBING PLACED - OVER THE ENTIRE L-823 CONNECTOR(S) BOTH MALE AND FEMALE AT ALL 5KV JUNCTIONS. THE HEAT SHRINK TUBING SHALL BE APPROXIMATELY 18" IN LENGTH WITH 6 INCHES OF MASTIC ON BOTH ENDS AND VOID OF MASTIC IN MIDDLE OF TUBE RATED FOR 5KV.

MATELY 18" IN LENGTH
MASTIC ON BOTH
MASTIC IN MIDDLE OF
SIKV.

WRAP WITH AT LEAST ONE LAYER OF RUBBER OR
SYNTHETIC RUBBER TAPE AND ONE LAYER OF
PLASTIC TAPE, ONE—HALF LAPPED, EXTENDED AT
LEAST 1—1/2 INCHES ON EACH SIDE OF JOINT

ADDITIONAL ADHESIVE
COMPOUND FILLER

UNDERGROUND CABLE
SPEC. L—824, TYPICAL

TYPE B


FOR SPLICES AT JUNCTION OF HOMERUN WITH LOOP CIRCUIT AND FOR SPLICES IN HOMERUNS TO EXISTING CABLES

HEAT SHRINKABLE TUBING WITH INTERNAL ADHESIVE. HEAT SHRINKABLE TUBING SHALL EXTEND FROM THE CABLE TO AT LEAST AN INCH PAST THE COMPLETED CONNECTION. -ADDITIONAL ADHESIVE L-823 RECEPTACLE END-COMPOUND FILLER === 2" (TYP.) AFTÈR SHRINKING -L-823 PLUG END WRAP WITH AT LEAST ONE LAYER OF RUBBER OR FACTORY MOLDED SYNTHETIC RUBBER TAPE AND ONE LAYER OF TRANSFORMER LEADS-PLASTIC TAPE, ONE-HALF LAPPED, EXTENDED AT LEAST 1-1/2 INCHES ON EACH SIDE OF JOINT HEAT SHRINKABLE TUBING WITH INTERNAL ADHESIVE. HEAT SHRINKABLE TUBING SHALL EXTEND FROM THE CABLE TO AT LEAST AN INCH PAST THE COMPLETED CONNECTION. \_\_ 2" (TYP.) AFTÈR SHRINKING L-823 PLUG END-ADDITIONAL ADHESIVE FOR SPLICES AT RUNWAY COMPOUND FILLER AND TAXIWAY LIGHTS AND L-823 RECEPTACLE END

CABLE SPLICES
(NOT TO SCALE)

INSIDE DIAMETER OF CONNECTOR SHALL PROPERLY

MATCH THE OUTSIDE DIAMETER OF CABLE.

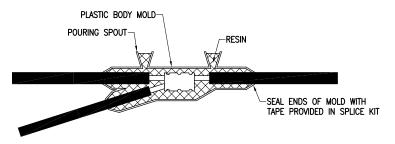


# LOW VOLTAGE UNDERGROUND TAP SPLICE

FOR TAP SPLICES IN LOW VOLTAGE (600V) CABLE. SPLICES SHALL BE RATED AND LISTED SUITABLE FOR DIRECT BURIAL LOCATIONS. FOR SPLICES UP TO #2 AWG CONDUCTOR, SPLICES SHALL BE 3M SCOTCHCAST 82-B1 POWER CABLE TAP SPLICE KIT OR APPROVED EQUAL.

## NOTE:

- 1. SPLICE DETAILS ARE PROVIDED FOR NEW WORK AND TO ASSIST IN REPAIRS OF ACCIDENTAL OR UNEXPECTED INTERRUPTIONS AND/OR CUTS TO AIRFIELD LIGHTING CABLES.
- CONTRACTOR SHALL KEEP ON HAND A MINIMUM OF 10 SETS OF SPLICE KITS FOR L-823 CONNECTORS AND A MINIMUM OF 10 SETS OF TYPE A LOW VOLTAGE SPLICE KITS TO ACCOMMODATE REPAIRS.
- EVERY AIRFIELD LIGHTING CABLE SPLICER SHALL BE QUALIFIED IN MAKING CABLE SPLICES AND TERMINATIONS ON CABLES RATED AT AND/OR ABOVE 5.000 VOLTS AC.
- 4. WHEN PREPARING CABLE FOR SPLICES, THE CONTRACTOR SHALL USE A CABLE STRIPPER/PENCILLER WHENEVER CABLE CONNECTIONS ARE MADE.
- INSIDE DIAMETER OF RESPECTIVE CABLE CONNECTOR SHALL PROPERLY MATCH OUTSIDE DIAMETER OF CABLE.
- 6. WRAP ALL PRIMARY AND SECONDARY POWER CONNECTIONS WITH SUFFICIENT LAYERS OF INSULATING TAPE (3M SCOTCH 23 ALL-VOLTAGE SPLICING TAPE, 3M SCOTCH 130C LINERLESS RUBBER SPLICEING TAPE, OR APPROVED EQUAL) AND COVER WITH VINYL ELECTRICAL TAPE (3M SCOTCH 88 VINYL ELECTRICAL TAPE OR APPROVED EQUAL) FOR FULL VALUE OF CABLE INSULATION VOLTAGE.
- PROVIDE CABLE TAGS TO IDENTIFY THE RESPECTIVE CIRCUITS ALL POINTS OF ACCESS INCLUDING L-867 BASES, L-868 BASES, HANDHOLES, MANHOLES, JUNCTION BOXES, AND WIREWAYS.

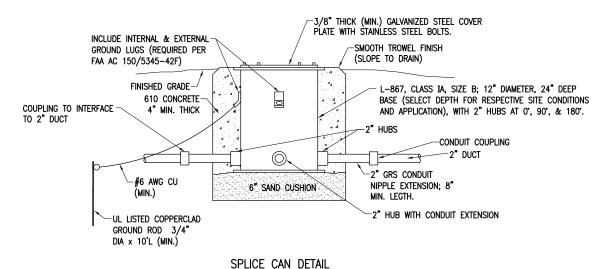

# NOTES FOR SPLICE CAN DETAIL:

(NOT TO SCALE)

- SPLICE CANS SHALL CONFORM TO THE REQUIREMENTS OF FAA AC 150/5345-42F, OR MOST CURRENT ISSUE IN FORCE, FOR TYPE L-867, CLASS IA, SIZE B, (12 IN. NOMINAL DIAMETER), AND 24 IN. DEEP AND/OR AS DETAILED ON THE PLANS. EACH SPLICE CAN SHALL INCLUDE INTERNAL AND EXTERNAL GROUND LUGS TO ACCOMMODATE THE RESPECTIVE APPLICATIONS. SPLICE CANS AND/OR JUNCTION CANS SHALL HAVE GALVANIZED STEEL COVERS, 3/8-INCH THICK (MINIMUM), WITH STAINLESS STEEL BOLTS.
- FOR THE PURPOSE OF ENHANCING SAFETY, EACH BASE MUST HAVE INSTALLED, BY THE MANUFACTURER, AN
  INTERNAL AND EXTERNAL GROUND STRAP THAT IS AVAILABLE FOR THE PURPOSE OF ATTACHING A GROUND
  LUG THAT IS CONNECTED TO AN EARTH GROUND OR A SAFETY GROUND CONDUCTOR INSTALLED WITH THE
  RESPECTIVE CIRCUIT. FOR AIRPORT PROJECTS RECEIVING FEDERAL FUNDS THIS REQUIREMENT IS
  MANDATORY PER FAA AC 150/5345-426.
- 3. APPLY AN OXIDE-INHIBITING, ANTI-SEIZING COMPOUND TO ALL SCREWS, NUTS, AND ALL PLACES WHERE METAL COMES INTO CONTACT WITH METAL.
- 4. THE CONCRETE USED IN THE CONSTRUCTION OF THE BASES FOR THE AIRFIELD LIGHTING CANS SHALL BE IN ACCORDANCE WITH ITEM 610 STRUCTURAL PORTLAND CEMENT CONCRETE.

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COLES COUNTY AIRPORT
AUTHORITY
COLES COUNTY MEMORIAL AIRPORT

REMOVE AND REPLACE ALL TAXI GUIDANCE SIGNS ON THE AIRPORT

IDA No: MTO-4511 SBG Project No: 3-17-SBGP-XX

Contract No. CO062

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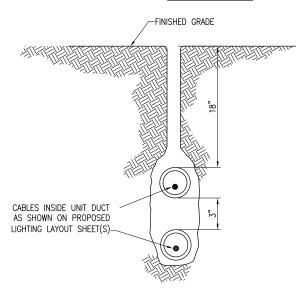
AIRFIELD LIGHTING CABLE SPLICE DETAILS

# CONDUIT IN TRENCH - NON-PAVEMENT AREAS

"NOT TO SCALE"

# NOTES:

- 1. DIMENSIONS FOR COVERAGE AND SEPARATION BETWEEN DUCTS ARE MINIMUM.
- TRENCHES WITH MORE THAN TWO DUCTS OR CABLE IN UNIT DUCTS SHALL BE INCREASED 3" IN WIDTH PLUS DIAMETER OF RESPECTIVE DUCT FOR EACH ADDITIONAL CONDUIT, DUCT, OR CABLE IN UNIT DUCT; IF SPECIFIED ON PLANS TWO PARALLEL TRENCHES MAY BE CONSTRUCTED.
- 3. DEPTH OF TRENCHES SHALL BE AS SHOWN ABOVE UNLESS OTHERWISE SPECIFIED ON THE PLANS. MINIMUM COVER REQUIREMENTS FOR CABLES AND DUCTS AT AIRPORT RUNWAYS AND ADJACENT AREAS WHERE TRESPASSING IS PROHIBITED IS 18 INCHES PER NEC 300.5 AND 300.50. COVER IS DEFINED AS THE SHORTEST DISTANCE IN INCHES MEASURED BETWEEN A POINT ON THE TOP SURFACE OF ANY DIRECT—BURIED CONDUCTOR, CABLE, CONDUIT, OR OTHER RACEWAY AND THE TOP SURFACE OF FINISHED GRADE, CONCRETE OR SIMILAR COVER.
- 4. HIGH VOLTAGE CIRCUITS (AIRFIELD LIGHTING 5000 VOLT SERIES CIRCUITS AND/OR OTHER CIRCUITS RATED ABOVE 600 VOLTS) AND LOW VOLTAGE CIRCUITS (RATED 600 VOLTS AND BELOW) SHALL NOT BE INSTALLED IN THE SAME RACEWAY, CONDUIT, DUCT, HANDHOLE. OR MANHOLE.
- CONDUITS, DUCT, CABLE, AND/OR CABLE IN UNIT DUCT INTERFACE TO HANDHOLES, MANHOLES, SPLICE CANS, OR OTHER JUNCTION STRUCTURES WILL BE CONSIDERED INCIDENTAL TO THE RESPECTIVE CABLE PAY ITEM OR RESPECTIVE DUCT PAY ITEM.
- ALL DISTURBED SURFACES SHALL BE RESTORED TO THEIR ORIGINAL CONDITION. <u>COST IS</u> INCIDENTAL TO TRENCH.



PLOWED CABLE

(NOT TO SCALE)

PRESTAMPED OR CHISELED ON THE JOB
(%" HIGH LETTERING MIN.)

18" R.

3/16" R.

1NDICATES NUMBER AND SIZE OF DUCT BANK

SIZE OF DUCT BANK


RITHMINOUS PAVEMENT DUCT MARKERS

TOP VIEW

# BITUMINOUS PAVEMENT DUCT MARKERS

# NOTES:


- TOP OF MARKER SHALL BE FLUSH WITH FINISHED PAVEMENT SURFACE. MARKER MAY BE INSTALLED IN A DRILLED HOLE AND SECURED WITH EPOXY GLUE.
- BRASS DUCT MARKERS ARE AVAILABLE FROM G&S FOUNDRY & MANUFACTURING CO., INC., 210 KASKASKIA DRIVE, RED BUD, IL 62278, PHONE: (618)–282–4114

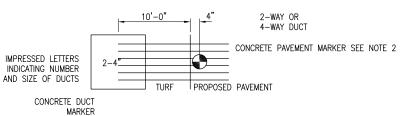

# DUCT MARKER DETAIL "NOT TO SCALE"

# CABLE & DUCT MARKER NOTES:


- THE COST OF ALL TURF AND PAVEMENT DUCT MARKERS SHALL BE INCIDENTAL TO THE DUCT. THE COST OF ALL CABLE MARKERS SHALL BE INCIDENTAL TO THE CABLE.
- 2. BITUMINOUS PAVEMENT DUCT MARKER AND CONCRETE DUCT MARKER TO BE PROVIDED AT EACH END OF EACH DUCT AS SHOWN ON THE LOCATION PLAN. FOR CONCRETE PAVEMENT, THE LETTER "D" SHALL BE IMPRESSED IN THE PAVEMENT INSTEAD OF THE MARKER. THE LETTER SHALL BE FORMED AS DESCRIBED IN NOTE 4.
- 3. CABLE MARKERS SHALL BE PLACED AT CHANGES OF DIRECTION AND APPROXIMATELY EVERY 200' ALONG CABLE RUNS
- 4. CONCRETE CABLE MARKERS AND DUCT MARKERS SHALL HAVE LETTERS 4" HIGH, 3" WIDE WITH WIDTH OF STROKE ½" AND ½" DEEP. ALL LETTERS, NUMBERS AND ARROWS TO BE IMPRESSED.
- 5. EMPLOY THE FOLLOWING METHODS WERE ADDITIONAL SPACE TO FIT LEGEND IS REQUIRED:
  - A. REDUCE LETTER SIZE TO 3" HIGH, 2" WIDE.
  - B. INCREASE THE MARKER SIZE TO 30" X 30".
  - C. PROVIDE ADDITIONAL MARKERS PLACED SIDE BY SIDE.

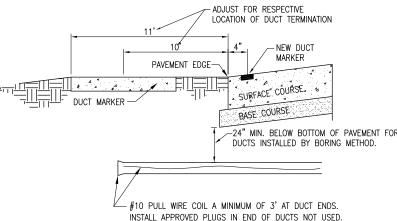


# UNDERGROUND ELECTRICAL DUCT

(NOT TO SCALE)

NOTE: DUCTS INSTALLED BY BORING METHOD SHALL NOT DISTURB THE RESPECTIVE PAVEMENT SURFACE.

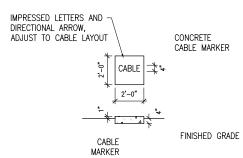

# TURF CABLE MARKERS "NOT TO SCALE"

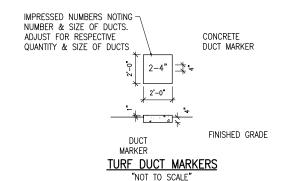

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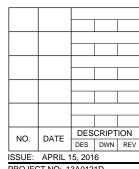
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AUTHORITY
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REMOVE AND REPLACE ALL TAXI GUIDANCE SIGNS ON THE AIRPORT

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SHEET TITLE

CONDUIT TRENCH DETAILS

# GENERAL NOTES

- 1. ALL ELECTRICAL EQUIPMENT SHALL BE INSTALLED IN CONFORMANCE WITH NFPA 70 - NATIONAL ELECTRICAL CODE (NEC) MOST CURRENT ISSUE IN FORCE, THE RESPECTIVE EQUIPMENT MANUFACTURER'S DIRECTIONS AND ALL OTHER APPLICABLE LOCAL CODES, LAWS, ORDINANCES, AND REQUIREMENTS IN FORCE. ANY INSTALLATIONS WHICH VOID THE U.L. LISTING, ETL/INTERTEK TESTING SERVICES VERIFICATION/LISTING (OR OTHER THIRD PARTY LISTING) AND/OR THE MANUFACTURER'S WARRANTY OF A DEVICE WILL NOT BE PERMITTED.
- CONTRACTOR SHALL KEEP A COPY OF THE LATEST NEC IN FORCE ON SITE AT ALL TIMES DURING CONSTRUCTION FOR USE AS A REFERENCE.
- 3. CONTRACTOR SHALL COORDINATE WORK AND ANY POWER OUTAGES AND/OR SHUT DOWN OF SYSTEMS WITH THE RESPECTIVE FACILITY OWNER PERSONNEL AND THE AIRPORT MANAGER/DIRECTOR. ONCE SHUT DOWN, THE CIRCUITS SHALL BE LABELED AS SUCH TO PREVENT ACCIDENTAL ENERGIZING OF THE RESPECTIVE CIRCUITS. ALL PERSONNEL SHALL FOLLOW U.S. DEPARTMENT OF LABOR OCCUPATIONAL SAFETY & HEALTH ADMINISTRATION (OSHA) 29 CFR PART 1910 OCCUPATIONAL SAFETY & HEALTH STANDARDS FOR ELECTRICAL SAFETY AND LOCKOUT/TAGOUT PROCEDURES INCLUDING, BUT NOT LIMITED TO, 29 CFR SECTION 1910.147 THE CONTROL OF HAZARDOUS ENERGY (LOCKOUT/TAGOUT).
- 4. THE CONTRACTOR SHALL ASCERTAIN THAT ALL LIGHTING SYSTEM COMPONENTS FURNISHED BY HIM, INCLUDING FAA APPROVED EQUIPMENT, ARE COMPATIBLE IN ALL RESPECTS WITH EACH OTHER AND THE REMAINDER OF THE NEW/EXISTING SYSTEM. ANY NONCOMPATIBLE COMPONENTS FURNISHED BY THIS CONTRACTOR SHALL BE REPLACED BY HIM AT NO ADDITIONAL COST TO THE AIRPORT SPONSOR WITH A SIMILAR UNIT, APPROVED BY THE ENGINEER (DIFFERENT MODEL OR DIFFERENT MANUFACTURER) THAT IS COMPATIBLE WITH THE REMAINDER OF THE AIRPORT LIGHTING SYSTEM.
- IN CASE THE CONTRACTOR ELECTS TO FURNISH AND INSTALL AIRPORT LIGHTING EQUIPMENT REQUIRING ADDITIONAL WIRING, TRANSFORMERS, ADAPTORS, MOUNTINGS, ETC., TO THOSE SHOWN ON THE DRAWINGS AND/OR LISTED IN THE SPECIFICATION, <u>ANY COST FOR THESE ITEMS SHALL BE INCIDENTAL TO THE</u> EQUIPMENT COST.
- 6. THE CONTRACTOR INSTALLED EQUIPMENT (INCLUDING FAA APPROVED) SHALL NOT GENERATE ANY ELECTROMAGNETIC INTERFERENCE IN THE EXISTING AND/OR NEW COMMUNICATIONS, WEATHER, AIR NAVIGATION, AND AIR TRAFFIC CONTROL EQUIPMENT. ANY EQUIPMENT GENERATING SUCH INTERFERENCE SHALL BE REPLACED BY THE CONTRACTOR AT NO ADDITIONAL COST WITH THE EQUIPMENT MEETING THE APPLICABLE SPECIFICATIONS AND NOT GENERATING ANY INTERFERENCE.
- WHEN A SPECIFIC TYPE, STYLE, CLASS, ETC. OF FAA APPROVED EQUIPMENT IS SPECIFIED ONLY THAT TYPE, STYLE, CLASS, WILL BE ACCEPTABLE, EVEN THOUGH EQUIPMENT OF OTHER TYPES STYLES, CLASSES, ETC. MAY BE APPROVED.
- 8. ANY AND ALL INSTRUCTIONS FROM THE RESIDENT ENGINEER/RESIDENT TECHNICIAN TO THE CONTRACTOR REGARDING CHANGES IN OR DEVIATIONS FROM THE PLANS AND SPECIFICATIONS SHALL BE IN WRITING WITH COPIES SENT TO THE AIRPORT SPONSOR AND THE ILLINOIS DEPARTMENT OF TRANSPORTATION DIVISION OF AERONAUTICS. THE CONTRACTOR SHALL NOT ACCEPT ANY VERBAL INSTRUCTIONS FROM THE RESIDENT ENGINEER/RESIDENT TECHNICIAN REGARDING ANY CHANGES FROM THE PLANS AND SPECIFICATIONS.
- 9. A MINIMUM OF THREE COPIES OF THE INSTRUCTION BOOK SHALL BE SUPPLIED WITH EACH DIFFERENT TYPE OF EQUIPMENT. THE BOOKS DESCRIBING A MORE SOPHISTICATED TYPE OF EQUIPMENT, SUCH AS REGULATORS, PAPI, REIL, ETC. AS A MINIMUM SHALL CONTAIN THE FOLLOWING:
  - A. A DETAILED DESCRIPTION OF THE OVERALL EQUIPMENT AND ITS INDIVIDUAL COMPONENTS
  - B. THEORY OF OPERATION INCLUDING THE FUNCTION OF EACH COMPONENT.
  - C. INSTALLATION INSTRUCTION.
  - D. START-UP INSTRUCTIONS.
  - E. PREVENTATIVE MAINTENANCE REQUIREMENTS.
  - F. CHART FOR TROUBLE-SHOOTING.
  - G. COMPLETE POWER AND CONTROL DETAILED WIRING DIAGRAM(S), SHOWING EACH CONDUCTOR/CONNECTION/COMPONENT "BLACK" BOXES ARE NOT ACCEPTABLE. THE DIAGRAM OF THE NARRATIVE SHALL SHOW VOLTAGE/CURRENTS/WAVE SHAPES AT STRATEGIC LOCATIONS TO BE USED WHEN CHECKING AND/OR TROUBLE—SHOOTING THE EQUIPMENT. WHEN THE EQUIPMENT HAS SEVERAL MODES OF OPERATION, SUCH AS SEVERAL BRIGHTINESS STEPS, THESE PARAMETERS SHALL BE INDICATED FOR ALL DIFFERENT MODES
  - H. PARTS LIST WHICH WILL INCLUDE ALL MAJOR AND MINOR COMPONENTS SUCH AS RESISTORS, DIODES, ETC. IT SHALL INCLUDE A COMPLETE NOMENCLATURE OF EACH COMPONENT AND, IF APPLICABLE, THE NAME OF ITS MANUFACTURER AND THE CATALOG NUMBER.
- SAFETY INSTRUCTIONS.

# POWER AND CONTROL NOTES

- 1. PROVIDE LEGEND PLATES FOR ALL ELECTRICAL EQUIPMENT TO IDENTIFY FUNCTION, CIRCUIT VOLTAGE AND PHASE. WHERE THE EQUIPMENT CONTAINS FUSES, ALSO IDENTIFY THE FUSE OR FUSE LINK AMPERE RATING. WHERE THE EQUIPMENT DOES NOT HAVE SUFFICIENT AREA TO INSTALL LEGEND PLATES, THE LEGEND PLATES SHALL BE INSTALLED ON THE WALL NEXT TO THE UNIT. LEGEND PLATES SHALL BE WEATHERPROOF ENGRAVED PLASTIC OR PHENOLIC MATERIAL, 1/4" HIGH BLACK LETTERS ON A WHITE BACKGROUND UNLESS NOTED OTHERWISE. SECURE WITH WEATHERPROOF ADHESIVE AND MACHINE SCREWS. FURNISH ADDITIONAL LEGEND PLATES WHERE REQUIRED BY CODE, FOR ADDITIONAL EQUIPMENT, AS DETAILED HEREIN ON THE PLANS, AND AS NOTED IN THE SPECIAL PROVISION SPECIFICATIONS.
- COLOR CODE ALL PHASE WIRING BY THE USE OF COLORED WIRE INSULATION AND/OR COLORED TAPE. WHERE TAPE IS USED, THE WIRE INSULATION SHALL BE BLACK. BLACK AND RED SHALL BE USED FOR PHASE CONDUCTORS ON 120/240VAC SINGLE-PHASE, THREE WIRE SYSTEMS AND BLACK, ORANGE (FOR HIGH LEG) AND BLUE SHALL BE USED FOR PHASE CONDUCTORS ON 240/120VAC THREE-PHASE, FOUR WIRE SYSTEMS. NEUTRAL CONDUCTORS, SIZE NO. 6 AWG OR SMALLER, SHALL BE IDENTIFIED BY A CONTINUOUS WHITE OR NATURAL GRAY OUTER FINISH ALONG ITS ENTIRE LENGTH. NEUTRAL CONDUCTORS LARGER THAN NO. 6 AWG SHALL BE IDENTIFIED EITHER BY A CONTINUOUS WHITE OR NATURAL GRAY OUTER FINISH ALONG ITS ENTIRE LENGTH OR BY THE USE OF WHITE TAPE AT ITS TERMINATIONS AND INSIDE ACCESSIBLE WIREWAYS. INSULATED GROUND CONDUCTORS SHALL HAVE GREEN COLORED INSULATION FOR ALL CONDUCTOR SIZES (AWG OR KCMII).
- 3. ALL BRANCH CIRCUIT CONDUCTORS CONNECTED TO A PARTICULAR PHASE SHALL BE IDENTIFIED WITH THE SAME COLOR. THE COLOR CODING SHALL BE EXTENDED TO THE POINT OF LITHICATION.
- IN CONTROL WIRING THE SAME COLOR SHALL BE USED THROUGHOUT THE SYSTEM FOR THE SAME FUNCTION, SUCH AS 10%, 30%, 100% BRIGHTNESS CONTROL, FTC.
- LOW VOLTAGE (600 V.) AND HIGH VOLTAGE (5000 V.) CONDUCTORS SHALL BE INSTALLED IN SEPARATE WIREWAYS.
- NEATLY LACE WIRING IN DISTRIBUTION PANELS, WIREWAYS, SWITCHES AND JUNCTION/PULL BOXES.
- THE MINIMUM SIZE OF PULL/JUNCTION BOXES, REGARDLESS OF THE QUANTITY AND SIZE OF THE CONDUCTORS SHOWN, SHALL BE AS FOLLOWS:
  - IN STRAIGHT PULLS THE LENGTH OF THE BOX SHALL NOT BE LESS THAN EIGHT TIMES THE TRADE DIAMETER OF THE LARGER CONDUIT. THE TOTAL AREA (INCLUDING THE CONDUIT CROSS—SECTIONAL AREA) OF A BOX END SHALL BE AT LEAST 3 TIMES GREATER THAN THE TOTAL TRADE CROSS—SECTIONAL AREA OF THE CONDUITS TERMINATING AT THE END.
  - B. IN ANGLE PULLS OR 'U' PULLS THE DISTANCE BETWEEN EACH CONDUIT ENTRY INSIDE THE BOX AND THE OPPOSITE WALL OF THE BOX SHALL NOT BE LESS THAN SIX (6) TIMES THE TRADE DIAMETER OF THE LARGEST CONDUIT. THIS DISTANCE SHALL BE INCREASED FOR ADDITIONAL ENTRIES BY THE AMOUNT OF THE SUM OF THE DIAMETERS OF ALL OTHER CONDUIT ENTRIES ON THE SAME WALL AS THE BOX. THE DISTANCE BETWEEN CONDUIT ENTRIES ENCLOSING THE SAME CONDUCTOR SHALL NOT BE LESS THAN SIX TIMES THE TRADE DIAMETER OF THE LARGEST CONDUIT.
- 8. A RUN OF CONDUIT BETWEEN TERMINATIONS AT EQUIPMENT ENCLOSURES, SQUARE DUCTS AND PULL/JUNCTION BOXES, SHALL NOT CONTAIN MORE THAN THE EQUIVALENT OF FOUR QUARTER BENDS (360 DEGREES TOTAL), INCLUDING THOSE BENDS LOCATED IMMEDIATELY AT THE TERMINATIONS, CAST, CONDUIT TYPE OUTLETS SHALL NOT BE TREATED AS PULL/JUNCTION BOXES.
- EQUIPMENT CABINETS SHALL NOT BE USED AS PULL/JUNCTION BOXES. ONLY WIRING TERMINATING AT THE EQUIPMENT SHALL BE BROUGHT INTO THESE ENCLOSURES.
- SPLICES AND JUNCTION POINTS SHALL BE PERMITTED ONLY IN JUNCTION BOXES, DUCTS EQUIPPED WITH REMOVABLE COVERS, AND AT EASILY ACCESSIBLE LOCATIONS.
- CIRCUIT BREAKERS IN POWER DISTRIBUTION PANEL(S) SHALL BE THERMAL-MAGNETIC MOLDED CASE, PERMANENT TRIP WITH 100 AMPERE, MINIMUM FRAME.
- DUAL LUGS SHALL BE USED WHERE TWO (2) WIRES, SIZE NO. 6 OR LARGER, ARE TO BE CONNECTED TO THE SAME TERMINAL.
- ALL INTERIOR WALL MOUNTED EQUIPMENT ENCLOSURES SHALL BE MOUNTED ON HOT DIPPED GALVANIZED STEEL STRUT SUPPORT, OR STAINLESS STEEL STRUT SUPPORT, WITH CORROSION RESISTANT HARDWARE.
- 14. SUPPORT FOR EXTERIOR MOUNTED EQUIPMENT SHALL USE HOT DIPPED GALVANIZED STEEL STRUT SUPPORT OR STAINLESS STEEL STRUT SUPPORT WITH STAINLESS STEEL HARDWARE. PROVIDE ZINC RICH PAINT APPLIED TO FIELD CUTS OF GALVANIZED STEEL SUPPORT TO MINIMIZE THE POTENTIAL FOR CORROSION PER THE RESPECTIVE STRUT SUPPORT MANUFACTURER'S RECOMMENDATIONS.

- 15. CONDUITS FOR ELECTRIC SERVICE ENTRANCE AND FEEDERS SHALL BE AS DETAILED HEREIN ON THE PLANS. WHERE GALVANIZED RIGID STEEL CONDUIT IS SPECIFIED IT SHALL HAVE THREADED FITTINGS. SET SCREW TYPE FITTINGS WILL NOT BE ACCEPTABLE. CONDUITS FOR UNDERGROUND APPLICATIONS SHALL BE AS DETAILED HEREIN. CONDUITS FOR GROUNDING ELECTRODE CONDUCTORS OR INDIVIDUAL GROUNDING CONDUCTORS SHALL BE SCHEDULE 40 OR SCHEDULE 80 PVC.
- 16. PROVIDE LIQUID TIGHT FLEXIBLE METAL CONDUIT AT CONNECTIONS TO EQUIPMENT SUBJECT TO VIBRATION OR WHERE FLEXIBILITY IS REQUIRED. LIQUID TIGHT FLEXIBLE METAL CONDUIT AND ASSOCIATED FITTINGS SHALL BE U.L. LISTED TO MEET THE REQUIREMENTS OF NEC 350.6, SUITABLE FOR GROUNDING, SUNLIGHT RESISTANT, AND RESISTANT TO OIL, GASOLINE, AND GREASE. LIQUID TIGHT FLEXIBLE METAL CONDUIT THAT IS USED FOR FLEXIBILITY (INCLUDING CONNECTIONS TO MOTORS, TRANSFORMERS, & CONSTANT CURRENT REGULATORS) SHALL REQUIRE AN EXTERNAL BONDING JUMPER OR INTERNAL EQUIPMENT GROUNDING CONDUCTOR PER NEC 350.60. DO NOT INSTALL LIQUID TIGHT FLEXIBLE METAL CONDUIT THAT IS NOT UIL LISTED. CONFIRM LIQUID—TIGHT FLEXIBLE METAL CONDUIT BEARS THE UIL LABEL PRIOR TO INSTALLING IT.
- UNLESS OTHERWISE SHOWN, ALL EXPOSED CONDUITS SHALL BE RUN PARALLEL TO OR AT RIGHT ANGLES WITH THE LINES OF THE STRUCTURE.
- 18. ALL STEEL CONDUITS, FITTINGS, NUTS, BOLTS, ETC. SHALL BE GALVANIZED.
- USE CONDUIT BUSHINGS AT EACH CONDUIT TERMINATION. WHERE NO. 4 AWG OR LARGER UNDERGROUND WIRE IS INSTALLED, USE INSULATED BUSHINGS.
- 20. USE DOUBLE LOCK NUTS AT EACH CONDUIT TERMINATION.
- 21. WRAP ALL PRIMARY AND SECONDARY POWER TRANSFORMER CONNECTIONS WITH SUFFICIENT LAYERS OF INSULATING TAPE (3M SCOTCH 23 ALL—VOLTAGE SPLICING TAPE, 3M SCOTCH 13OC LINERLESS RUBBER SPLICING TAPE, OR APPROVED EQUAL) AND COVER WITH VINYL ELECTRICAL TAPE (3M SCOTCH 88 VINYL ELECTRICAL TAPE OR APPROVED EQUAL) FOR FULL VALUE OF CABLE INSULATION VOLTAGE.
- UNLESS OTHERWISE NOTED, ALL SINGLE CONDUCTOR CONTROL WIRING SHALL BE NO. 12 AWG. COPPER MINUMUM.
- 23. THE FOLLOWING SHALL APPLY TO RELAY/CONTACTOR PANELS/ENCLOSURES:
  - A. FOR INTERIOR LOCATIONS ALL COMPONENTS SHALL BE MOUNTED IN NEMA 12 (DUST TIGHT) ENCLOSURE(S) WITH VERTICALLY HINGED COVERS. FOR EXTERIOR/OUTDOOR LOCATIONS ALL COMPONENTS SHALL BE MOUNTED IN NEMA 4X STAINLESS STEEL ENCLOSURE(S) WITH VERTICALLY HINGED COVERS. ALL CONDUIT ENTRIES INTO NEMA 4, 4X ENCLOSURES SHALL HAVE NEMA 4 HUBS LISTED SUITABLE FOR THE RESPECTIVE ENCLOSURE TO MAINTAIN THE NEMA 4, 4X RATING OF THE ENCLOSURE.
  - THE ENCLOSURE(S) SHALL HAVE AMPLE SPACE FOR THE CIRCUIT COMPONENTS, TERMINAL BLOCKS AND INCOMING AND INTERNAL WIRING.
  - ALL CONTROL CONDUCTOR TERMINATIONS SHALL BE OF THE OPEN-EYE CONNECTOR/SCREW TYPE. SOLDERED CLOSED-EYE TERMINATIONS, OR TERMINATIONS WITHOUT CONNECTORS ARE NOT ACCEPTABLE.
  - . WHEN THE ENCLOSURE COVER IS OPENED, ALL CIRCUIT COMPONENTS, WIRING AND TERMINALS SHALL BE EXPOSED AND ACCESSIBLE WITHOUT REMOVAL OF ANY PANELS, COVERS, ETC., EXCEPT THOSE COVERING HIGH VOI TAGE COMPONENTS.
  - E. ACCESS TO, OR REMOVAL OF A CIRCUIT COMPONENT OR TERMINAL BLOCK
    WILL NOT REQUIRE THE REMOVAL OF ANY OTHER CIRCUIT COMPONENT OR
    TERMINAL PLOCE.
  - F. EACH CIRCUIT COMPONENT SHALL BE CLEARLY IDENTIFIED INDICATING ITS CORRESPONDING NUMBER SHOWN ON THE DRAWINGS AND ITS FUNCTION.
  - G. A COMPLETE WIRING DIAGRAM SHALL BE MOUNTED ON THE INSIDE OF THE COVER. THE DIAGRAM SHALL REPRESENT EACH CONDUCTOR BY A SEPARATE LINE.
  - H. THE DIAGRAM SHALL IDENTIFY EACH CIRCUIT COMPONENT AN NUMBERING AND COLOR OF EACH TERMINAL CONDUCTOR AND TERMINAL.
  - I. ALL WIRING SHALL BE NEATLY TRAINED AND LACED.
  - J. MINIMUM WIRE SIZE SHALL BE NO. 12 AWG.
- 24. FURNISH & INSTALL A WEATHERPROOF WARNING LABEL FOR EACH METER SOCKET, SERVICE DISCONNECT, SAFETY SWITCH, CUTOUT, PANELBOARD, & CONTROL PANEL TO WARN PERSONS OF POTENTIAL ELECTRIC ARC FLASH HAZARDS, PER THE REQUIREMENTS OF NEC 110.16 "ARC FLASH HAZARD WARNING".

Offices Nationwide www.hanson-inc.com

Hanson Professional Services Inc. 1525 S. 6th Street Springfield, IL 62568 phone: 217-788-2450 fax: 217-788-2503

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SHEET TITLE

ELECTRICAL NOTES SHEET 1

# AIRFIELD LIGHTING NOTES

- UNLESS OTHERWISE NOTED, ALL UNDERGROUND AIRFIELD LIGHTING SERIES CIRCUIT CONDUCTORS WHETHER DEB OR IN DUCT/CONDUIT SHALL BE FAA APPROVED 5000 VOLT L-824 TYPE. ALL UNDERGROUND FIELD POWER LOW VOLTAGE (600 VOLT & BELOW) CIRCUIT CONDUCTORS WHETHER DEB OR IN DUCT/CONDUIT SHALL BE UL LISTED 600 VOLT, TYPE XLP-USE-2 COPPER CONDUCTORS. CONDUCTOR SIZES SHALL
- NO COMPONENTS OF PRIMARY CIRCUIT SUCH AS CABLE, CONNECTORS AND TRANSFORMERS SHALL BE BROUGHT ABOVE GROUND AT EDGE LIGHTS, SIGNS, REIL,
- THERE SHALL BE NO EXPOSED POWER/CONTROL CABLES BETWEEN THE POINT WHERE THEY LEAVE THE UNDERGROUND (DEB OR L-867 BASES) AND WHERE THEY ENTER THE EQUIPMENT (SUCH AS TAXIWAY SIGNS, PAPI, REIL, ETC.) ENCLOSURES. THESE CABLES SHALL BE ENCLOSED IN RIGID CONDUIT OR IN FLEXIBLE, WATERTIGHT CONDUIT WITH BREAKABLE COUPLING(S) AT THE GRADE OR THE HOUSING COVER, AS SHOWN IN APPLICABLE DETAILS.
- THE JOINTS OF THE L-823 PRIMARY CONNECTORS SHALL BE WRAPPED WITH AT LEAST ONE LAYER OF RUBBER OR SYNTHETIC RUBBER TAPE AND ONE LAYER OF PLASTIC TAPE, ONE-HALF LAPPED, EXTENDING AT LEAST 1-1/2 INCHES ON EACH SIDE OF THE JOINT, AS SHOWN ON ELECTRICAL DETAILS SHEET 1.
- THE CABLE ENTRANCE INTO THE FIELD-ATTACHED L-823 CONNECTORS SHALL BE ENCLOSED BY A HEAT-SHRINKABLE TUBING WITH CONTINUOUS INTERNAL ADHESIVE, AS SHOWN ON ELECTRICAL DETAILS SHEET 1.
- L-823 TYPE II, TWO-CONDUCTOR SECONDARY CONNECTORS SHALL BE CLASS 'A' (FACTORY MOLDED).
- THERE SHALL BE NO SPLICES IN THE SECONDARY CABLE(S) WITHIN THE STEMS OF A RUNWAY/TAXIWAY EDGE/THRESHOLD LIGHTING FIXTURE AND THE WIREWAYS LEADING TO TAXIWAY SIGNS AND PAPI/REIL EQUIPMENT.
- ELECTRICAL INSULATING GREASE SHALL BE APPLIED WITHIN THE L-823, SECONDARY, TWO CONDUCTOR CONNECTORS TO PREVENT WATER ENTRANCE. THESE CONNECTORS SHALL NOT BE TAPED.
- DEB ISOLATION TRANSFORMERS SHALL BE BURIED AT A DEPTH OF TEN (10") INCHES ON A LINE CROSSING THE LIGHT AND PERPENDICULAR TO THE RUNWAY/TAXIWAY CENTERLINE AT A LOCATION TWELVE (12") INCHES FROM THE LIGHT OPPOSITE FROM THE RUNWAY/TAXIWAY.
- 10. A SLACK OF THREE (3') FEET, MINIMUM, PLUS DEPTH OF BASE CAN (IF APPLICABLE), SHALL BE PROVIDED IN THE PRIMARY CABLE AT EACH TRANSFORMER/CONNECTOR TERMINATION. AT STAKE-MOUNTED LIGHTS, THE SLACK SHALL BE LOOSELY COILED IMMEDIATELY BELOW THE ISOLATION TRANSFORMER. THERE SHALL BE NO ADDITIONAL PAYMENT FOR CABLE SLACK AND THEREFORE THE QUANTITY OF PROPOSED CABLE SLACK HAS NOT BEEN INCLUDED IN THE RESPECTIVE CABLE PAY ITEMS.
- 11. DIRECTION OF PRIMARY CABLES SHALL BE IDENTIFIED BY COLOR CODING AS FOLLOWS: WHEN FACING LIGHT WITH BACK TO PAVEMENT, CABLE TO THE LEFT IS CODED RED AND CABLE TO RIGHT IS CODED BLUE. THIS APPLIES TO STAKE MOUNTED LIGHTS AND BASE MOUNTED LIGHTS WHERE THE BASE HAS ONLY ONE ENTRANCE.
- 12. L-867 BASES SHALL BE SIZE B, 24" DEEP, CLASS I, UNLESS OTHERWISE NOTED.
- 13. BASE MOUNTED BREAKABLE COUPLINGS SHALL NOT HAVE WEEP HOLES TO THE OUTSIDE. PLUGGED UP HOLES SHALL NOT BE ACCEPTABLE. IT SHALL BE A 1/4" DIAMETER, MINIMUM, OR EQUIVALENT OPENING FOR DRAINAGE FROM THE SPACE AROUND THE SECONDARY CONNECTOR INTO THE L-867 BASE.
- 14. THE ELEVATION OF THE BREAKABLE COUPLING GROOVE SHALL NOT EXCEED 1-1/2 ABOVE THE EDGE OF THE COVER IN CASE OF BASE MOUNTED COUPLINGS, OR THE TOP OF THE STAKE IN CASE OF STAKE MOUNTED COUPLINGS.
- WHERE THE BREAKABLE COUPLING IS NOT AN INTEGRAL PART OF THE LIGHT FIXTURE STEM OR MOUNTING LEG, A BEAD OF SILICON SEAL SHALL BE APPLIED COMPLETELY AROUND LIGHT STEM OR WIREWAY AT BREAKABLE COUPLING TO PROVIDE A WATERTIGHT
- 16. TOPS OF THE STAKES SUPPORTING LIGHT FIXTURES SHALL BE FLUSH WITH THE SURROUNDING GRADE.
- 17. PLASTIC LIGHTING FIXTURE COMPONENTS, SUCH AS LAMP HEADS, STEMS, BREAKABLE COUPLINGS, BASE COVERS, BRACKETS, STAKES, SHALL NOT BE ACCEPTABLE.
- 18. THE TOLERANCE FOR THE HEIGHT OF RUNWAY/TAXIWAY EDGE LIGHTS SHALL BE: ONE (1) INCH. IN CASE OF STAKE MOUNTED LIGHTS. THE SPECIFIED LIGHTING FIXTURE HEIGHT SHALL BE MEASURED BETWEEN THE TOP OF THE STAKE AND THE TOP OF THE LENS. IN CASE OF BASE MOUNTED LIGHTS, THE SPECIFIED LIGHTING FIXTURE HEIGHT SHALL BE MEASURED BETWEEN THE TOP OF THE BASE FLANGE AND THE TOP OF THE LENS, THUS INCLUDING THE BASE COVER, THE FRANGIBLE COUPLING, THE STEM, THE LAMP HOUSING AND THE LENS
- 19. THE TOLERANCE FOR THE LATERAL SPACING (LIGHT LANE TO RUNWAY/TAXIWAY CENTERLINE) OF RUNWAY/TAXIWAY EDGE LIGHTS SHALL BE ONE (1) INCH. THIS ALSO APPLIES AT INTERSECTIONS TO LATERAL SPACING BETWEEN LIGHTS OF A RUNWAY/TAXIWAY AND THE INTERSECTING RUNWAY/TAXIWAY.

- ENTRANCES INTO L-867 BASES SHALL HAVE CONDUIT COUPLINGS OR REDUCERS TO INTERFACE UNIT DUCT/CONDUIT TO L-867 BASE HUBS, OR SHALL BE SEALED WITH heat shrink as shown in detail "B" on electrical details sheet 1.
- GALVANIZED/PAINTED EQUIPMENT/COMPONENT SURFACES SHALL NOT BE DAMAGED BY DRILLING, FÍLING, ETC. DRAIN HOLES IN METAL TRANSFORMER HOUSINGS SHALL BE MADE BEFORE GALVANIZING.
- 22. FDGE LIGHT NUMBERING TAGS SHALL BE FACING THE PAVEMENT.
- CABLE/SPLICE/DUCT MARKERS SHALL BE PRECAST CONCRETE OF THE SIZE SHOWN. LETTERS/NUMBERS/ARROWS FOR THE LEGEND TO BE IMPRESSED INTO THE TOPS OF THE MARKERS SHALL BE PRE—ASSEMBLED AND SECURED IN THE MOLD BEFORE THE CONCRETE IS POURED. LEGEND INSCRIBED BY HAND IN WET CONCRETE SHALL NOT BE
- ALL UNDERGROUND CABLE RUNS SHALL BE IDENTIFIED BY CABLE MARKERS AT 200 FEET MAXIMUM SPACING, WITH AN ADDITIONAL MARKER AT EACH CHANGE OF DIRECTION OF THE CABLE RUN. CABLE MARKERS SHALL BE INSTALLED IMMEDIATELY ABOVE THE
- THERE SHALL BE NO SPLICES BETWEEN THE ISOLATION TRANSFORMERS. L-823 CONNECTORS ARE ALLOWED AT TRANSFORMER CONNECTIONS ONLY, UNLESS OTHERWISE
- APPLY AN OXIDE INHIBITING, ANTI-SEIZING COMPOUND TO ALL SCREWS, NUTS AND BREAKAGE COUPLING THREADS.
- LOCATIONS OF ENDS OF ALL UNDERGROUND DUCTS SHALL BE IDENTIFIED BY DUCT
- WHERE A PARALLEL, CONSTANT VOLTAGE PAPI SYSTEM IS PROVIDED, THE "T" SPLICES SHALL BE OF THE CAST TYPE.
- CONCRETE USED FOR SLABS, FOOTINGS, BACKFILL AROUND TRANSFORMER HOUSINGS. Markings, etc. shall be 3500 psi, air—entrained.
- ALL POWER AND CONTROL CABLES IN MAN/HAND HOLES SHALL BE TAGGED. USE EMBOSSED COPPER STRIPS TO BE ATTACHED AT BOTH ENDS TO THE CABLE BY THE USE OF PLASTIC STRAPS. MINIMUM OF TWO TAGS SHALL BE PROVIDED ON EACH CABLE IN A MAN/HAND HOLE-ONE AT THE CABLE ENTRANCE AND ONE AT THE CABLE
- THE LOCATION, SIZE AND TYPE OF MATERIAL OF EXISTING UNDERGROUND AND/OR ABOVEGROUND UTILITIES INDICATED ON THE PLANS IS NOT REPRESENTED AS BEING ACCURATE, SUFFICIENT OR COMPLETE. NEITHER THE OWNER NOR THE ENGINEER ASSUMES ANY RESPONSIBILITY WHATEVER IN RESPECT TO ACCURACY, COMPLETENESS, OR SUFFICIENCY OF THE INFORMATION. THERE IS NO GUARANTEE EITHER EXPRESSED OR IMPLIED, THAT THE LOCATIONS, SIZE AND TYPE OF MATERIAL OF EXISTING UNDERGROUND UTILITIES INDICATED ARE REPRESENTATIVE OF THOSE TO BE ENCOUNTERED IN THE CONSTRUCTION. IT SHALL BE THE CONTRACTOR'S RESPONSIBILITY TO DETERMINE THE ACTUAL LOCATION OF ALL SUCH FACILITIES, INCLUDING SERVICE CONNECTIONS TO UNDERGROUND UTILITIES. PRIOR TO CONSTRUCTION, THE CONTRACTOR SHALL NOTIFY THE UTILITY COMPANIES OF HIS OPERATIONAL PLANS AND SHALL OBTAIN FROM THE RESPECTIVE UTILITY COMPANIES DETAILED INFORMATION AND ASSISTANCE RELATIVE TO THE LOCATION OF THEIR FACILITIES. AND THE WORKING SCHEDULE OF THE COMPANIES FOR REMOVAL OR ADJUSTMENT WHERE REQUIRED. IN THE EVENT AN UNEXPECTED UTILITY INTERFERENCE IS ENCOUNTERED DURING CONSTRUCTION, THE CONTRACTOR SHALL IMMEDIATELY NOTIFY THE UTILITY COMPANY OF JURISDICTION. THE OWNER'S REPRESENTATIVE AND/OR THE RESIDENT ENGINEER SHALL ALSO BE IMMEDIATELY NOTIFIED. ANY DAMAGE TO SUCH MAINS AND SERVICES SHALL BE RESTORED TO SERVICE AT ONCE AND PAID FOR BY THE CONTRACTOR AT NO ADDITIONAL COST TO THE CONTRACT. ALL UTILITY CABLES AND LINES SHALL BE LOCATED BY THE RESPECTIVE UTILITY. CONTACT JULIE (JOINT UTILITY LOCATION INFORMATION FOR EXCAVATORS) FOR UTILITY INFORMATION, PHONE: 1-800-892-0123. CONTACT THE FAA (FEDERAL AVIATION ADMINISTRATION) FOR ASSISTANCE IN LOCATING FAA CABLES AND UTILITIES. LOCATION OF FAA POWER, CONTROL AND COMMUNICATION CABLES SHALL BE COORDINATED WITH AND/OR LOCATED BY THE FAA. ALSO CONTACT AIRPORT DIRECTOR/MANAGER AND AIRPORT PERSONNEL FOR ASSISTANCE IN LOCATING UNDERGROUND AIRPORT CABLES AND/OR UTILITIES. ALSO COORDINATE WORK WITH ALL ABOVE GROUND UTILITIES.
- WHEN PREPARING CABLE FOR SPLICES, THE CONTRACTOR SHALL USE A CABLE STRIPPER/PENCILLER WHENEVER CABLE CONNECTIONS ARE MADE.

# GROUNDING NOTES FOR AIRFIELD LIGHTING

- GROUNDING FOR RUNWAY LIGHTS, TAXIWAY LIGHTS, AND LIGHTED TAXI GUIDANCE SIGNS SHALL BE AS DETAILED ON THE PLANS AND AS SPECIFIED HEREIN. PER FAA AC 150/5340-30H DESIGN AND INSTALLATION DETAILS FOR AIRPORT VISUAL AIDS, CHAPTER 12, PART 12.6; A GROUND MUST BE INSTALLED AT EACH LIGHT FIXTURE. THE PURPOSE OF THE LIGHT BASE GROUND IS TO PROVIDE A DEGREE OF PROTECTION FOR MAINTENANCE PERSONNEL FROM POSSIBLE CONTACT WITH AN ENERGIZED LIGHT BASE OR MOUNTING STAKE THAT MAY RESULT FROM A SHORTED POWER CABLE OR ISOLATION TRANSFORMER. A LIGHT BASE GROUND SHALL BE INSTALLED AT EACH TRANSFORMER BASE/LIGHT CAN ASSOCIATED WITH RUNWAY LIGHTS, TAXIWAY LIGHTS, AND LIGHTED TAXI GUIDANCE SIGNS. A LIGHT BASE GROUND SHALL ALSO BE INSTALLED AT EACH STAKE MOUNTED LIGHT FIXTURE. A LIGHT BASE GROUND SHALL BE INSTALLED AND CONNECTED TO THE METAL FRAME OF EACH TAXI GUIDANCE SIGN AS DETAILED ON THE PLANS AND IN ACCORDANCE WITH THE RESPECTIVE TAXI GUIDANCE SIGN MANUFACTURER RECOMMENDATIONS. THE LIGHT BASE GROUND SHALL BE A #6 AWG BARE COPPER CONDUCTOR CONNECTED TO THE GROUND LUG ON THE RESPECTIVE L-867 TRANSFORMER BASE/LIGHT CAN OR MOUNTING STAKE AND A 3/4-INCH DIAMETER BY 10-FEET LONG (MINIMUM) UL LISTED COPPER CLAD GROUND ROD. CONNECTIONS TO GROUND LUGS ON THE L-867 TRANSFORMER BASE/LIGHT CAN OR MOUNTING STAKE SHALL BE WITH A UL LISTED GROUNDING CONNECTOR SUITABLE FOR DIRECT BURY IN EARTH OR CONCRETE. CONNECTIONS TO GROUND RODS SHALL BE MADE WITH EXOTHERMIC WELD TYPE CONNECTORS, CADWELD BY ERICO PRODUCTS, INC., SOLON, OHIO, (PHONE: 800-248-9353), THERMOWELD BY CONTINENTAL INDUSTRIES, INC., TULSA, OKLAHOMA (PHONE: 918-663-1440), ULTRAWELD BY HARGER, GRAYSLAKE, ILLINOIS (PHONE: 800-842-7437), OR APPROVED EQUAL. EXOTHERMIC WELD CONNECTIONS SHALL BE INSTALLED IN CONFORMANCE WITH THE RESPECTIVE MANUFACTURER'S DIRECTIONS USING MOLDS AS REQUIRED FOR EACH RESPECTIVE APPLICATION. BOLTED CONNECTIONS WILL NOT BE PERMITTED AT GROUND RODS. TOP OF GROUND RODS SHALL BE BURIED 12 INCHES MINIMUM BELOW GRADE, UNLESS SPECIFIED OTHERWISE HEREIN, FOR RESPECTIVE APPLICATIONS.
- 2. FOR BASE MOUNTED LIGHT FIXTURES THE LIGHT FIXTURE MUST BE BONDED TO THE LIGHT BASE INTERNAL GROUND LUG VIA A #6 AWG STRANDED COPPER WIRE RATED FOR 600 VOLTS WITH GREEN XHHW OR USE INSULATION. THE GROUND WIRE LENGTH MUST BE SUFFICIENT TO ALLOW THE REMOVAL OF THE LIGHT FIXTURE FROM THE LIGHT BASE FOR ROUTING MAINTENANCE. SEE THE LIGHT FIXTURE MANUFACTURER'S INSTRUCTIONS FOR PROPER METHODS OF ATTACHING BONDING WIRE
- CLEAN ALL METAL SURFACES BEFORE MAKING GROUND CONNECTIONS. METALLIC SURFACES TO BE JOINED SHALL BE PREPARED BY THE REMOVAL OF ALL NON-CONDUCTIVE MATERIAL PER 2014 NATIONAL ELECTRICAL CODE ARTICLE 250-12.
- 4. PER FAA 150/5340-30H THE RESISTANCE TO GROUND OF THE RESPECTIVE MOUNTING STAKE OR LIGHT BASE (WITH GROUND ROD CONNECTED) MUST BE 25 OHMS OR LESS.
- FOR TAXIWAY LIGHTS THAT ARE SPACED WITH LESS THAN 10 FEET OF SEPARATION BETWEEN THEM. PROVIDE ONE 3/4-INCH DIAMETER BY 10 FEET LONG GROUND ROD PER TWO ADJACENT TAXIWAY LIGHTS. LOCATE GROUND ROD MIDWAY BETWEEN THE TWO TAXIWAY LIGHTS.
- STEEL USED TO MANUFACTURE GROUND RODS SHALL BE 100% DOMESTIC STEEL.
- FOR EACH AIRFIELD LIGHT FIXTURE, TAXI GUIDANCE SIGN, AND NAVAID THE CONTRACTOR SHALL TEST THE MADE ELECTRODE GROUND SYSTEM WITH AN INSTRUMENT SPECIFICALLY DESIGNED FOR TESTING GROUND SYSTEMS. TEST RESULTS SHALL BE RECORDED FOR FACH AIRFIFLD LIGHT FIXTURE, TAXI GUIDANCE SIGN, AND NAVAIDS INSTALLATION, IF GROUND RESISTANCE EXCEEDS 25 OHMS, CONTACT THE PROJECT ENGINEER FOR FURTHER DIRECTION. COPIES OF THE GROUND SYSTEM TEST RESULTS SHALL BE FURNISHED TO THE RESIDENT ENGINEER/RESIDENT TECHNICIAN



Offices Nationwide

Hanson Professional Services Inc. 1525 S. 6th Street Springfield, IL 62568 phone: 217-788-2450 fax: 217-788-2503

Illinois Licensed Professional Service Corporation #184-001084

**COLES COUNTY AIRPORT** AUTHORITY

REMOVE AND REPLACE ALL TAXI **GUIDANCE SIGNS ON** THE AIRPORT

IDA No: MTO-4511 SBG Project No: 3-17-SBGP-XX

Contract No. CO062

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SHEET TITLE

**ELECTRICAL NOTES** SHEET 2

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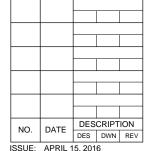
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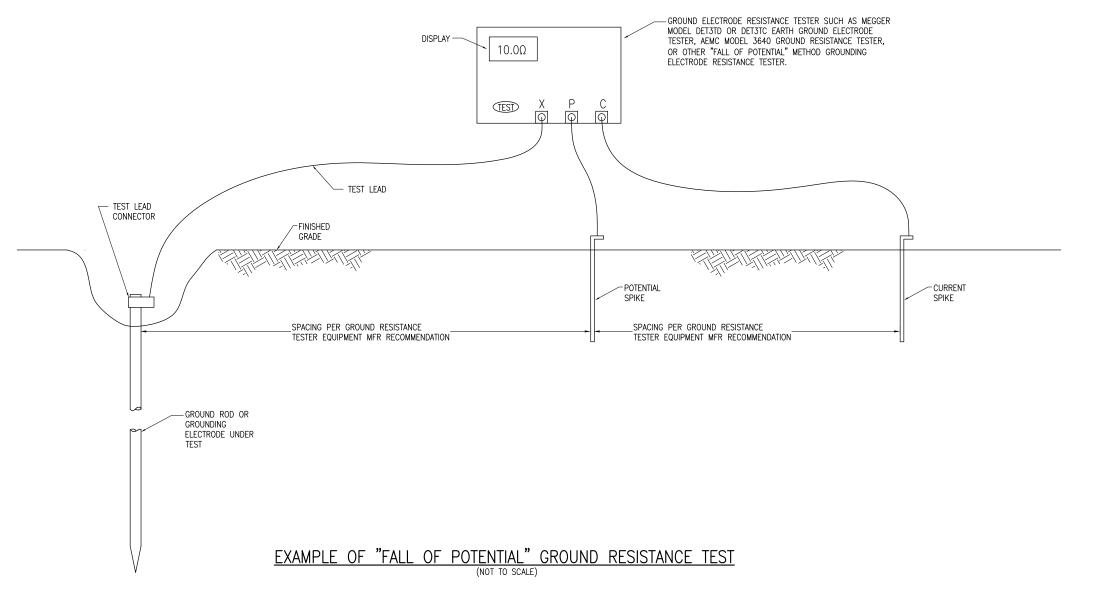


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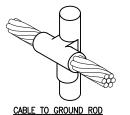
SHEET TITLE

GROUND RESISTANCE TESTING DETAILS





# <u>NOTES</u>

- CONTRACTOR SHALL TEST AND RECORD THE RESISTANCE FOR EACH MADE ELECTRODE GROUND ROD/GROUND FIELD/GROUND RING WITH AN INSTRUMENT SPECIFICALLY DESIGNED FOR TESTING GROUNDING ELECTRODE SYSTEMS. IF GROUND RESISTANCE EXCEEDS 25 OHMS, CONTACT THE PROJECT ENGINEER FOR FURTHER DIRECTION. COPIES OF GROUND ROD TEST RESULTS SHALL BE FURNISHED TO THE RESIDENT ENGINEER/RESIDENT TECHNICIAN.
- 2. FOR EACH AIRFIELD LIGHT FIXTURE, TAXI GUIDANCE SIGN, AND NAVAID THE CONTRACTOR SHALL TEST THE MADE ELECTRODE GROUND SYSTEM WITH AN INSTRUMENT SPECIFICALLY DESIGNED FOR TESTING GROUND SYSTEMS. TEST RESULTS SHALL BE RECORDED FOR EACH AIRFIELD LIGHT FIXTURE, TAXI GUIDANCE SIGN, AND NAVAIDS INSTALLATION. IF GROUND RESISTANCE EXCEEDS 25 OHMS, CONTACT THE PROJECT ENGINEER FOR FURTHER DIRECTION. COPIES OF THE GROUND SYSTEM TEST RESULTS SHALL BE FURNISHED TO THE RESIDENT ENGINEER / RESIDENT TECHNICIAN.
- 3. GROUND RESISTANCE TEST SHALL BE CONDUCTED IN ACCORDANCE WITH THE RESPECTIVE GROUND ELECTRODE RESISTANCE TESTING EQUIPMENT MANUFACTURER'S INSTRUCTIONS
- 4. RECORD SITE CONDITIONS DURING TESTS.
- . "FALL OF POTENTIAL" TYPE GROUND ELECTRODE RESISTANCE TESTER IS RECOMMENDED FOR TESTING INDIVIDUAL STAND ALONE GROUND RODS.



CABLE TO GROUND ROD

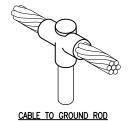

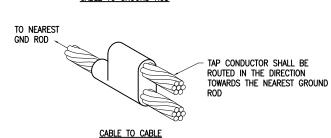


CABLES TO GROUND ROD

# DETAIL NOTES

- ALL BELOW GRADE CONNECTIONS TO GROUND RODS & GROUND RING CONDUCTORS SHALL BE EXOTHERMIC WELD TYPE CONNECTIONS. EXOTHERMIC WELDS SHALL BE CADWELD AS MANUFACTURED BY ERICO PRODUCTS, SOLON, OHIO, ULTRAWELD AS MANUFACTURED BY HARGER LIGHTNING PROTECTION & GROUNDING EQUIPMENT, GRAYSLAKE, IL, THERMOWELD AS MANUFACTURED BY CONTINENTAL INDUSTRIES, TULSA, OKLAHOMA, OR APPROVED EQUAL. VERIFY PROPER SIZES, MOLDS, TYPES, AND REQUIREMENTS FOR THE RESPECTIVE APPLICATION WITH THE MANUFACTURER, AND INSTALL PER THEIR DIRECTIONS.
- FOR APPLICATIONS TO GALVANIZED STEEL OR PAINTED STEEL, REMOVE GALVANIZING AND/OR PAINT & CLEAN THE SURFACE TO EXPOSE BARE STEEL BEFORE MAKING EXOTHERMIC WELD CONNECTION.
- INDIVIDUAL GROUNDING ELECTRODE CONDUCTORS SHALL NOT BE INSTALLED IN METAL CONDUIT. INSTALL GROUNDING ELECTRODE CONDUCTORS IN SCHED 40 PVC CONDUIT AS REQUIRED IN FOUNDATIONS, FOR PROTECTION, WHERE ENTERING ENCLOSURES, ETC. WHERE PLASTIC CONDUIT IS USED FOR INDIVIDUAL GROUND WIRES, DO NOT COMPLETELY ENCIRCLE THE CONDUIT WITH FERROUS AND/OR MAGNETIC MATERIALS. WHERE METAL CLAMPS ARE INSTALLED USE NYLON BOLTS, NUTS, WASHERS, & SPACERS TO INTERRUPT A COMPLETE METALLIC PATH FROM ENCIRCLING THE CONDUIT.


# EXOTHERMIC WELD DETAILS

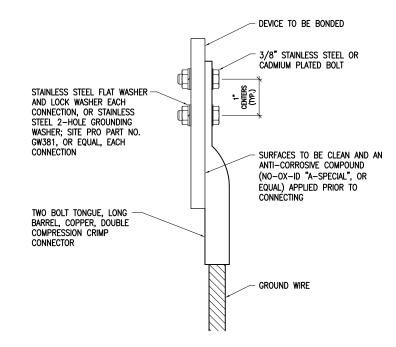


2 HOLE LONG BARREL COMPRESSION LUG TABLE					
WIRE SIZE	BURNDY CAT. NO.	THOMAS & BETTS CAT. NO.	PENN-UNION CAT. NO.		
#8 AWG STRANDED	YA8C-2TC38	256-30695-1157	BBLU-8D-2TC38		
#6 AWG SOLID	YA8C-2TC38 OR YGA6C-2TC38E2G1				
#6 AWG STRANDED	YA6C-2TC38	256-30695-1158	BBLU-6D-2TC38		
#4 AWG STRANDED	YA4C-2TC38	256-30695-1159	BBLU-4D-2TC38		
#2 AWG STRANDED	YA2C-2TC38	256-30695-1160	BBLU-2D-2TC38		
#2 AWG SOLID	YA3C-2TC38	256-30695-1160	BBLU-3D-2TC38		
#1/0 AWG STRANDED	YA25-2TC38	256-30695-1162	BBLU-1/0D-2TC38		
#2/0 AWG STRANDED	YA26-2TC38	256-30695-1116	BBLU-2/0D-2TC38		
#3/0 AWG STRANDED	YA27-2TC38	54816BE	BBLU-3/0D-2TC38		
#4/0 AWG STRANDED	YA28-2TC38	256-30695-1117	BBLU-4/0D-2TC38		

- ALL CONNECTIONS TO GROUND BUS BAR SHALL BE WITH 2 HOLE TONGUE LONG BARREL COMPRESSION LUGS BOLTED TO THE BUS BAR.
- GROUND WIRE CONNECTIONS TO EQUIPMENT SHALL BE WITH 2 HOLE TONGUE LONG BARREL COMPRESSION LUGS BOLTED TO THE DEVICE OR WITH THE RESPECTIVE EQUIPT MANUFACTURER'S LUG OR TERMINAL WHERE
- GROUNDING ELECTRODE CONDUCTORS, BONDING JUMPERS, & INDIVIDUAL GROUND WIRES SHALL NOT BE INSTALLED IN METAL CONDUIT. WHERE PLASTIC CONDUIT IS USED FOR INDIVIDUAL GROUND WIRES, DO NOT COMPLETELY ENCIRCLE THE CONDUIT WITH FERROUS AND/OR MAGNETIC MATERIALS. WHERE METAL CLAMPS ARE INSTALLED USE NYLON BOLTS, NUTS, WASHERS, & SPACERS TO INTERRUPT A COMPLETE METALLIC APTH FROM ENCIRCLING THE CONDUIT.
- ALL CONNECTIONS SHALL BE COATED WITH A CORROSION PREVENTATIVE COMPOUND (SANCHEM INC. NO-OX-ID "A-SPECIAL", BURNDY PENETROX E. OR EQUAL) BEFORE JOINING. ALL COPPER BUS BARS SHALL BE CLEANED PRIOR TO MAKING CONNECTIONS TO REMOVE SURFACE OXIDATION. CLEAN SURFACES, OF RESPECTIVE DEVICES TO BE BONDED, TO BARE METAL, PER NEC 250-12.

GROUNDING LUG CONNECTION DETAIL

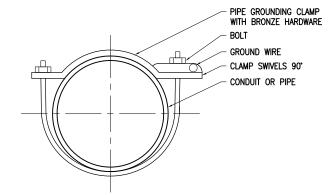

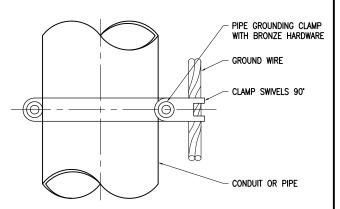

PIPE GROUNDING CLAMP TABLE			
BURNDY CAT. NO.	PIPE SIZE		
GAR3902-BU	1/2" - 1"		
GAR3903-BU	1 1/4" - 2"		
GAR3904-BU	2 1/2" – 3 1/2"		
GAR3905-BU	4" - 5"		
GAR3906-BU	6"		

# **NOTES**

PIPE GROUNDING CLAMPS SHALL HAVE BRONZE HARDWARE, BE CORROSION RESISTANT, SUITABLE FOR DIRECT BURIAL IN EARTH OR CONCRETE, & UL467 LISTED.

PIPE/CONDUIT GROUNDING CLAMP DETAIL



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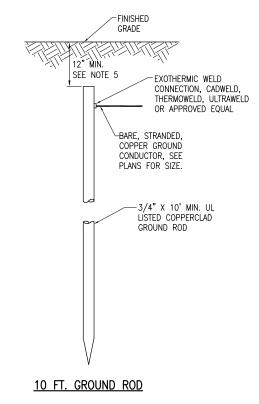
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**GROUNDING DETAILS** 

- 1. THE CONTRACTOR SHALL FURNISH AND INSTALL ALL GROUNDING AS MAY BE NECESSARY OR REQUIRED TO MAKE A COMPLETE GROUNDING SYSTEM AS REQUIRED BY THE LATEST NATIONAL ELECTRICAL CODE (NFPA 70) IN FORCE AND FAA-STD-019e (LIGHTNING AND SURGE PROTECTION, GROUNDING, BONDING, AND SHIELDING REQUIREMENTS FOR FACILITIES AND ELECTRONIC EQUIPMENT). THE RELIABILITY OF THE GROUNDING SYSTEM IS DEPENDENT ON CAREFUL, PROPER INSTALLATION AND CHOICE OF MATERIALS. IMPROPER PREPARATION OF SURFACES TO BE JOINED TO MAKE AN ELECTRICAL PATH, LOOSE JOINTS OR CORROSION CAN INTRODUCE IMPEDANCE THAT WILL SERIOUSLY IMPAIR THE ABILITY OF THE GROUND PATH TO PROTECT PERSONNEL AND EQUIPMENT AND TO ABSORB TRANSIENTS THAT CAN CAUSE NOISE IN COMMUNICATIONS CIRCUITS. THE FOLLOWING FUNCTIONS ARE PARTICULARLY IMPORTANT TO ENSURE A RELIABLE GROUND SYSTEM:
- FURNISH AND INSTALL GROUND RODS AS DETAILED HEREIN. GROUND RODS FOR AIRFIELD LIGHTING (RUNWAY LIGHTING, TAXIWAY LIGHTING, TAXI GUIDANCE SIGNS, AND SPLICE CANS SHALL BE MINIMUM 3/4-IN. DIAMETER BY 10-FT LONG, UL-LISTED COPPER CLAD WITH 10-MIL MINIMUM COPPER COATING. GROUND RODS FOR OTHER APPLICATIONS SHALL BE MINIMUM 3/4-IN. DIAMETER BY 10-FT LONG, UL-LISTED, COPPER CLAD WITH 10-MIL MINIMUM COPPER COATING. GROUND RODS SHALL BE SPACED OR AS DETAILED ON THE RESPECTIVE PLANS, AND IN NO CASE SPACED LESS THAN ONE ROD LENGTH APART. ALL CONNECTIONS TO GROUND RODS AND THE GROUND RING SHALL BE MADE WITH EXOTHERMIC WELD TYPE CONNECTORS, CADWELD BY ERICO PRODUCTS, INC., SOLON, OHIO, (PHONE 1-800-248-9353), THERMOWELD BY CONTINENTAL INDUSTRIES, INC., TULSA, OKLAHOMA (PHONE 918-663-1440) OR ULTRAWELD BY HARGER, GRAYSLAKE, ILLINOIS (PHONE 1-800-842-7437) OR APPROVED EQUAL. EXOTHERMIC WELD CONNECTIONS SHALL BE INSTALLED IN CONFORMANCE WITH THE RESPECTIVE MANUFACTURER'S DIRECTIONS USING MOLDS AS REQUIRED FOR EACH RESPECTIVE APPLICATION. BOLTED CONNECTIONS WILL NOT BE PERMITTED AT GROUND RODS OR AT BURIED GROUNDING ELECTRODE CONDUCTORS.
- 3. CONTRACTOR SHALL TEST EACH MADE ELECTRODE GROUND ROD/GROUND FIELD/GROUND RING WITH AN INSTRUMENT SPECIFICALLY DESIGNED FOR TESTING GROUND FIELD SYSTEMS. IF GROUND RESISTANCE EXCEEDS 25 OHMS, CONTACT THE PROJECT ENGINEER FOR FURTHER DIRECTION. COPIES OF GROUND ROD TEST RESULTS SHALL BE FURNISHED TO THE RESIDENT ENGINEER/RESIDENT TECHNICIAN REPRESENTATIVE.
- ALL PRODUCTS ASSOCIATED WITH THE GROUNDING SYSTEM SHALL BE UL-LISTED AND LABELED.
- ALL BOLTED OR MECHANICAL CONNECTIONS SHALL BE COATED WITH A CORROSION PREVENTATIVE COMPOUND BEFORE JOINING, SANCHEM INC. "NO-OX-ID "A-SPECIAL" COMPOUND, BURNDY PENETROX E, OR APPROVED EQUAL.
- METALLIC SURFACES TO BE JOINED SHALL BE PREPARED BY THE REMOVAL OF ALL NON-CONDUCTIVE MATERIAL, PER 2014 NATIONAL ELECTRICAL CODE ARTICLE 250-12. ALL COPPER BUS BARS MUST BE CLEANED PRIOR TO MAKING CONNECTIONS TO REMOVE SURFACE OXIDATION.
- 7. METALLIC RACEWAY FITTINGS SHALL BE MADE UP TIGHT TO PROVIDE A PERMANENT LOW IMPEDANCE PATH FOR ALL CIRCUITS. METAL CONDUIT TERMINATIONS IN ENCLOSURES SHALL BE BONDED TO THE ENCLOSURE WITH UL—LISTED FITTINGS SUITABLE FOR GROUNDING. PROVIDE GROUNDING BUSHINGS WITH BONDING JUMPERS FOR ALL METAL CONDUITS ENTERING SERVICE EQUIPMENT (METER BASE, CT CABINET, MAIN SERVICE BREAKER ENCLOSURE, ETC.). PROVIDE GROUNDING BUSHINGS WITH BONDING JUMPERS FOR ALL METAL CONDUITS ENTERING AN ENCLOSURE THROUGH CONCENTRIC OR ECCENTRIC KNOCKOUTS THAT ARE PUNCHED OR OTHERWISE FORMED SO AS TO IMPAIR THE ELECTRICAL CONNECTION TO GROUND. STANDARD LOCKNUTS OR BUSHINGS SHALL NOT BE THE SOLE MEANS FOR BONDING WHERE A CONDUIT ENTERS AN ENCLOSURE THROUGH A CONCENTRIC OR ECCENTRIC KNOCKOUT
- 8. ALL CONNECTIONS, LOCATED ABOVE GRADE, BETWEEN THE DIFFERENT TYPES OF GROUNDING CONDUCTORS SHALL BE MADE USING UL—LISTED DOUBLE COMPRESSION CRIMP TYPE CONNECTORS OR UL—LISTED BOLTED GROUND CONNECTORS. FOR GROUND CONNECTIONS TO ENCLOSURES, CASES AND FRAMES OF ELECTRICAL EQUIPMENT NOT SUPPLIED WITH GROUND LUGS THE CONTRACTOR SHALL DRILL REQUIRED HOLES FOR MOUNTING A BOLTED GROUND CONNECTOR. ALL BOLTED GROUND CONNECTORS SHALL BE BURNDY, THOMAS AND BETTS, OR EQUAL. TIGHTEN CONNECTIONS TO COMPLY WITH TIGHTENING TORQUES IN UL STANDARD 486A TO ASSURE PERMANENT AND EFFECTIVE GROUNDING.
- ALL METAL EQUIPMENT ENCLOSURES, CONDUITS, CABINETS, BOXES, RECEPTACLES, MOTORS, ETC. SHALL BE BONDED TO THE RESPECTIVE GROUNDING SYSTEM.
- 10. PROVIDE ALL BOXES FOR PROPOSED OUTLETS, SWITCHES, CIRCUIT BREAKERS, ETC.
  WITH GROUNDING SCREWS. PROVIDE ALL PANELBOARD, SWITCHGEAR, ETC., ENCLOSURES
  WITH GROUNDING BARS WITH INDIVIDUAL SCREWS, LUGS, CLAMPS, ETC., FOR EACH OF
  THE GROUNDING CONDUCTORS THAT ENTER THEIR RESPECTIVE ENCLOSURES.
- 11. EACH NEW FEEDER CIRCUIT AND/OR BRANCH CIRCUIT SHALL INCLUDE AN EQUIPMENT GROUND WIRE. METAL RACEWAY OR CONDUIT SHALL NOT MEET THIS REQUIPMENT. THE EQUIPMENT GROUND WIRE FROM EQUIPMENT SHALL NOT BE SMALLER THAN ALLOWED BY 2014 NEC TABLE 250-122 "MINIMUM SIZE CONDUCTORS OR GROUNDING RACEWAY AND EQUIPMENT." WHEN CONDUCTORS ARE ADJUSTED IN SIZE TO COMPENSATE FOR VOLTAGE DROP, EQUIPMENT-GROUNDING CONDUCTORS SHALL BE ADJUSTED PROPORTIONATELY ACCORDING TO CIRCULAR MIL AREA. ALL EQUIPMENT GROUND WIRES SHALL BE COPPER, EITHER BARE OR INSULATED GREEN IN COLOR. WHERE THE EQUIPMENT GROUNDING CONDUCTORS ARE INSULATED, THEY SHALL BE IDENTIFIED BY THE COLOR GREEN, AND SHALL BE THE SAME INSULATION TYPE AS THE PHASE CONDUCTORS.

- 12. ALL EXTERIOR METAL CONDUIT, WHERE NOT ELECTRICALLY CONTINUOUS BECAUSE OF MANHOLES, HANDHOLES, NON-METALLIC JUNCTION BOXES, ETC., SHALL BE BONDED TO ALL OTHER METAL CONDUIT IN THE RESPECTIVE DUCT RUN, AND AT EACH END, WITH A COPPER-BONDING JUMPER SIZED IN CONFORMANCE WITH 2014 NEC 250-102. WHERE METAL CONDUITS TERMINATE IN AN ENCLOSURE (SUCH AS A MOTOR CONTROL CENTER, SWITCHBOARD, ETC) WHERE THERE IS NOT ELECTRICAL CONTINUITY WITH THE CONDUIT AND THE RESPECTIVE ENCLOSURE, PROVIDE A BONDING JUMPER FROM THE RESPECTIVE ENCLOSURE GROUND BUS TO THE CONDUIT SIZED PER 2014 NEC 250-102.
- 13. IT IS THE INTENT OF THIS SPECIFICATION THAT ALL MOTOR FRAMES, PUMP BASES ELECTRICAL EQUIPMENT ENCLOSURES, PANEL HOUSINGS, CONDUITS, BOXES, ETC. HAVE A CONTINUOUS COPPER WIRE GROUND CONNECTION AND SHALL BE POSITIVELY BONDED TO THE RESPECTIVE GROUNDING SYSTEM. CONDUIT CONNECTORS <u>WILL NOT</u> BE CONSIDERED AS ADEQUATE GROUNDING.
- 14. PROVIDE A POSITIVE GROUND BOND FOR ALL OUTLET BOXES, ELECTRICAL EQUIPMENT ENCLOSURES, GROUNDING RECEPTACLES, TOGGLE SWITCHES, ETC. INSTALL A GROUNDING CONDUCTOR IN ALL WIRE AND CABLE RACEWAYS. GROUND CONDUCTOR TO HAVE 600-VOLT INSULATION AND BE IDENTIFIED BY A CONTINUOUS GREEN COLOR COATING. THEY SHALL BE USED SOLELY FOR GROUNDING PURPOSES AND BE ENTIRELY SEPARATE FROM WHITE GROUNDED NEUTRAL CONDUCTOR, EXCEPT AT SUPPLY SIDE OF SERVICE DISCONNECTING MEANS, WHERE GROUNDING AND NEUTRAL SYSTEMS ARE TO BE CONNECTED TO SERVICE GROUND.
- 15. EACH AND ALL GROUNDED CASED AND METAL PARTS ASSOCIATED WITH ELECTRICAL EQUIPMENT SHALL BE TESTED FOR CONTINUITY OF CONNECTION WITH GROUND BUS SYSTEM BY CONTRACTOR IN PRESENCE OF OWNER'S REPRESENTATIVE.
- 16. ALL CONNECTIONS BETWEEN THE DIFFERENT TYPES OF GROUNDING CONDUCTORS ABOVE GRADE SHALL BE MADE USING BOLTED GROUND CONNECTORS. GROUND LUGS SHALL BE PROVIDED IN ALL ENCLOSURES AND WIRING TERMINATION JUNCTION BOXES. EQUIPMENT GROUNDS AND GROUNDING CONDUCTOR SHALL BE CONNECTED TO THESE GROUND LUGS. FOR GROUND CONNECTIONS TO ENCLOSURES, CASES AND FRAMES OF ELECTRICAL EQUIPMENT NOT SUPPLIED WITH GROUND LUGS THE CONTRACTOR SHALL DRILL REQUIRED HOLES FOR MOUNTING A BOLTED GROUND CONNECTOR. ALL BOLTED GROUND CONNECTORS SHALL BE BURNDY, OR APPROVED EQUAL.
- 17. BOND ALL NONCURRENT-CARRYING PARTS OF METAL EQUIPMENT TO GROUND SYSTEM.
- BUILDING STRUCTURAL STEEL SYSTEM SHALL BE BONDED TO ELECTRICAL GROUND SYSTEM.
- INSTALL GROUNDING ELECTRODE CONDUCTORS, LIGHTNING PROTECTION DOWN CONDUCTORS AND SEPARATE GROUND CONDUCTORS IN SCHEDULE 40 OR SCHEDULE 80 PVC CONDUIT OR EXPOSED WHERE ACCEPTABLE TO LOCAL CODES. WHERE GROUNDING ELECTRODE CONDUCTORS, LIGHTNING PROTECTION DOWN CONDUCTORS OR INDIVIDUAL GROUND CONDUCTORS ARE RUN IN PVC CONDUIT, DO NOT COMPLETELY ENCIRCLE CONDUIT WITH FERROUS AND/OR MAGNETIC MATERIALS. USE NON-METALLIC REINFORCED FIBERGLASS STRUT SUPPORT. WHERE METAL CONDUIT CLAMPS ARE INSTALLED, USE NYLON BOLTS, NUTS, WASHERS AND SPACERS TO INTERRUPT A COMPLETE METALLIC PATH FROM ENCIRCLING THE CONDUIT. THIS IS REQUIRED TO AVOID GIRDLING OF GROUND CONDUCTORS. GIRDLING OF A GROUND CONDUCTOR IS THE RESULT OF PLACING THE CONDUCTOR IN A RING OF MAGNETIC MATERIAL. THIS RING COULD BE A METALLIC CONDUIT, U-BOLT OR STRUT SUPPORT PIPE CLAMP, OR OTHER SUPPORT HARDWARE. THE RESULT OF GIRDLING GROUND CONDUCTORS SIGNIFICANTLY INCREASES THE INDUCTIVE IMPEDANCE OF THE GROUND CONDUCTOR. INDUCTIVE AND CAPACITIVE IMPEDANCE IS A TYPE OF RESISTANCE THAT OPPOSES THE FLOW OF ALTERNATING CURRENT. ANY INCREASE IN THE IMPEDANCE OF A GROUND CONDUCTOR REDUCES ITS ABILITY TO EFFECTIVELY MITIGATE RADIO FREQUENCY NOISE IN THE GROUND SYSTEM. THE CONDITION WHERE A GROUND CONDUCTOR IS GIRDLED DURING A LIGHTNING STRIKE RESULTS IN PHENOMENA KNOWN AS SURGE IMPEDANCE LOADING. SURGE IMPEDANCE LOADING IS A RESULT OF VOLTAGE AND CURRENT REACHING 500,000 VOLTS AND 10,000 AMPS FOR A SHORT DURATION. GIRDLING FURTHER INCREASES THE IMPEDANCE AT LIGHTNING FREQUENCIES OF 100 KILOHERTZ TO 100 MEGAHERTZ AT THESE POWER AND FREQUENCY LEVELS ANY INCREASE IN THE IMPEDANCE OF THE GROUND CONDUCTOR MUST BE CONTROLLED. DURING LIGHTNING DISCHARGE CONDITIONS A LOW INDUCTIVE IMPEDANCE PATH IS MORE IMPORTANT THAN A LOW DC RESISTANCE PATH.
- 20. IF LOCAL CODES DICTATE THAT INDIVIDUAL GROUNDING CONDUCTORS MUST BE RUN IN METAL CONDUIT OR RACEWAY, THEN THE CONDUIT OR RACEWAY MUST BE BONDED AT EACH END OF THE RUN WITH A BONDING JUMPER SIZED EQUAL TO THE INDIVIDUAL GROUNDING CONDUCTOR OR AS REQUIRED BY 2014 NEC 250-102. NOTE THIS DOES NOT APPLY TO AC FOUIPMENT GROUNDING CONDUCTORS RUN WITH AC CIRCUITS.
- 21. WHERE A CONFLICT IS DETERMINED WITH RESPECT TO GROUNDING REQUIREMENTS PER MANUFACTURER INSTALLATION INSTRUCTIONS, NEC, AND/OR THE CONTRACT DOCUMENTS, CONTACT THE RESIDENT ENGINEER OR PROJECT ENGINEER FOR FURTHER DIRECTIONS.
- 22. GROUND RODS SHALL BE MANUFACTURED IN THE UNITED STATES OF AMERICA FROM 100 PERCENT DOMESTIC STEEL TO COMPLY WITH THE AIRPORT IMPROVEMENT PROGRAM BUY AMERICAN REQUIREMENTS AND THE STEEL PRODUCTS PROCUREMENT ACT.



- 1. TYPE AND MINIMUM NUMBER OF GROUND RODS SHALL BE AS SPECIFIED ON THE PLAN.
- 2. THE RESISTANCE TO GROUND OF THE GROUNDING SYSTEM SHALL NOT EXCEED 25 OHMS.
- COST OF GROUND RODS IS INCIDENTAL TO THE ASSOCIATED ITEMS REQUIRING GROUNDING UNLESS OTHERWISE SPECIFIED.
- GROUND RODS SHALL BE SPACED AS DETAILED ON THE PLANS AND SHALL NOT BE SPACED LESS THAN ONE ROD LENGTH APART.
- 5. TOP OF GROUND RODS SHALL BE 12" MINIMUM BELOW GRADE UNLESS DETAILED OTHERWISE HEREIN.
- GROUND RODS FOR SPLICE CANS AND AIRFIELD LIGHTING SHALL BE A MINIMUM 3/4-INCH DIAMETER BY 10-FT LONG UL LISTED COPPER CLAD.

GROUND RODS (NOT TO SCALE)



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Hanson Professional Services Inc. 1525 S. 6th Street Springfield, IL 62568 phone: 217-788-2450 fax: 217-788-2503

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AUTHORITY

COLES COUNTY MEMORIAL AIRPORT

REMOVE AND REPLACE ALL TAXI GUIDANCE SIGNS ON THE AIRPORT

IDA No: MTO-4511 SBG Project No: 3-17-SBGP-XX

Contract No. CO062

	NO.	DATE	DES	CRIPT	ION
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i	DESIGN	BY: KN	L 02/0	05/201	6
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SHEET TITLE

**GROUNDING NOTES** 

REVIEWED BY: KNL 03/08/2016

ELEC	CTRICAL LEGEND — ONE—LINE DIAGRAM
<b>-</b>	CABLE TERMINATOR/LUG
***	TRANSFORMER
_\_	DISCONNECT SWITCH
-\=	FUSIBLE DISCONNECT SWITCH
_^_	CIRCUIT BREAKER
<u></u> -∕	THERMAL MAGNETIC CIRCUIT BREAKER
	FUSE
<b>↓</b>	TRANSIENT VOLTAGE SURGE SUPPRESSOR OR SURGE PROTECTOR DEVICE
<b>#</b>	GROUND — GROUND ROD, GROUNDING ELECTRODE, OR AT EARTH POTENTIAL
a	INDICATING LIGHT
M	MOTOR
#	LOAD, MOTOR, # = HORSEPOWER
	ELECTRIC UTILITY METER BASE
•	JUNCTION BOX WITH SPLICE
xxx	EQUIPMENT, XXX = DEVICE DESCRIPTION
GND	GROUND BUS OR TERMINAL
S/N	NEUTRAL BUS
#	PANELBOARD WITH MAIN LUGS
	PANELBOARD WITH MAIN BREAKER
<b>♣□≫</b> #	Fuse panel with main fuse pullout
<b>+</b>	DUPLEX RECEPTACLE 120V SINGLE PHASE GROUNDING TYPE
8	CONTROL STATION
N EM	TRANSFER SWITCH
	ENGINE GENERATOR SET

	ELECTRICAL LEGEND - SCHEMATIC		
	NORMALLY OPEN (N.O.) CONTACT		
-Jr-	NORMALLY CLOSED (N.C.) CONTACT		
(5*)	STARTER COIL, * = STARTER NUMBER		
OL OL	OVERLOAD RELAY CONTACT		
(CR*)	CONTROL RELAY, * = CONTROL RELAY NUMBER		
R*	RELAY, * = RELAY NUMBER		
	TOGGLE SWITCH / 2 POSITION SWITCH		
OFF_ AUTO	TOOGLE SHITCH / 2 FOSHION SHITCH		
OFF AUTO	2-POSITION SELECTOR SWITCH		
ox			
OFF HAND ↑ AUTO			
xoo			
•   •	3-POSITION SELECTOR SWITCH (H-O-A SHOWN)		
00X			
=	2 POLE DISCONNECT SWITCH		
	3 POLE DISCONNECT SWITCH		
	PHOTOCELL		
<del>-®-</del>  -⊡-			
	TERMINAL BLOCK, * = TERMINAL NUMBER		
DEVICE TERMINAL, * = DEVICE TERMINAL NUMBER			
INTERNAL PANEL WIRING			
	FIELD WIRING		
	FUSE		
GND			
LOND	GROUND BUS OR TERMINAL		
S/N	GROUND BUS OR TERMINAL NEUTRAL BUS		
S/N ====================================	NEUTRAL BUS		
S/N	NEUTRAL BUS GROUND, GROUND ROD, GROUND BUS		
\$\limits \square \text{S/N} \\ \frac{1}{2} \\ \text{O} \text{O} \\	NEUTRAL BUS		
S/N	NEUTRAL BUS GROUND, GROUND ROD, GROUND BUS		
\$\limits \square \text{S/N} \\ \frac{1}{2} \\ \text{O} \text{O} \\	NEUTRAL BUS GROUND, GROUND ROD, GROUND BUS		
\$\limits \square \text{S/N} \\ \frac{1}{2} \\ \text{O} \text{O} \\	NEUTRAL BUS  GROUND, GROUND ROD, GROUND BUS  INDUSTRIAL CONTROL RELAY OR LIGHTING CONTACTOR		
\$\limits \square \text{S/N} \\ \frac{1}{2} \\ \text{O} \text{O} \\	NEUTRAL BUS GROUND, GROUND ROD, GROUND BUS		
\$\limits \square \text{S/N} \\ \frac{1}{2} \\ \text{O} \text{O} \\	NEUTRAL BUS  GROUND, GROUND ROD, GROUND BUS  INDUSTRIAL CONTROL RELAY OR LIGHTING CONTACTOR		
\$\limits \square \text{S/N} \\ \frac{1}{2} \\ \text{O} \text{O} \\	NEUTRAL BUS  GROUND, GROUND ROD, GROUND BUS  INDUSTRIAL CONTROL RELAY OR LIGHTING CONTACTOR		
\$\limits \square \text{S/N} \\ \frac{1}{2} \\ \text{O} \text{O} \\	NEUTRAL BUS GROUND, GROUND ROD, GROUND BUS INDUSTRIAL CONTROL RELAY OR LIGHTING CONTACTOR S1 CUTOUT HANDLE REMOVED		
\$\limits \square \text{S/N} \\ \displaystyle \begin{align*}	NEUTRAL BUS  GROUND, GROUND ROD, GROUND BUS  INDUSTRIAL CONTROL RELAY OR LIGHTING CONTACTOR		
\$\limits \square \text{S/N} \\ \displaystyle \begin{align*}	NEUTRAL BUS GROUND, GROUND ROD, GROUND BUS INDUSTRIAL CONTROL RELAY OR LIGHTING CONTACTOR S1 CUTOUT HANDLE REMOVED		
\$\limits \square \text{S/N} \\ \displaystyle \begin{align*}	NEUTRAL BUS GROUND, GROUND ROD, GROUND BUS INDUSTRIAL CONTROL RELAY OR LIGHTING CONTACTOR S1 CUTOUT HANDLE REMOVED		
\$\limits \square \text{S/N} \\ \displaystyle \begin{align*}	NEUTRAL BUS GROUND, GROUND ROD, GROUND BUS INDUSTRIAL CONTROL RELAY OR LIGHTING CONTACTOR  S1 CUTOUT HANDLE REMOVED  S1 CUTOUT HANDLE INSERTED		
\$\limits \square \text{S/N} \\ \displaystyle \begin{align*}	NEUTRAL BUS GROUND, GROUND ROD, GROUND BUS INDUSTRIAL CONTROL RELAY OR LIGHTING CONTACTOR  S1 CUTOUT HANDLE REMOVED  S1 CUTOUT HANDLE INSERTED		
\$\limits \square \text{S/N} \\ \displaystyle \begin{align*}	NEUTRAL BUS GROUND, GROUND ROD, GROUND BUS INDUSTRIAL CONTROL RELAY OR LIGHTING CONTACTOR  S1 CUTOUT HANDLE REMOVED  N.O. THERMAL SWITCH		
\$\limits \square \text{S/N} \\ \displaystyle \begin{align*}	NEUTRAL BUS GROUND, GROUND ROD, GROUND BUS INDUSTRIAL CONTROL RELAY OR LIGHTING CONTACTOR  S1 CUTOUT HANDLE REMOVED  N.O. THERMAL SWITCH		
\$\limits \square \text{S/N} \\ \displaystyle \begin{align*}	NEUTRAL BUS GROUND, GROUND ROD, GROUND BUS INDUSTRIAL CONTROL RELAY OR LIGHTING CONTACTOR  S1 CUTOUT HANDLE REMOVED  N.O. THERMAL SWITCH		

	ELECTRICAL ABBREVIATIONS			
A.F.F.	ABOVE FINISHED FLOOR			
A, AMP	AMPERES			
ATS	AUTOMATIC TRANSFER SWITCH			
AWG	AMERICAN WIRE GAUGE			
BKR	BREAKER			
С	CONDUIT			
СВ	CIRCUIT BREAKER			
СКТ	CIRCUIT			
CR	CONTROL RELAY			
CU	COPPER			
DPDT	DOUBLE POLE DOUBLE THROW			
DPST	DOUBLE POLE SINGLE THROW			
EM	EMERGENCY			
EMT	ELECTRICAL METALLIC TUBING			
ENCL	ENCLOSURE			
EP	EXPLOSION PROOF			
ES	EMERGENCY STOP			
ETL	INTERTEK - ELECTRICAL TESTING LABS			
ЕТМ	ELAPSE TIME METER			
GFCI	GROUND FAULT CIRCUIT INTERRUPTER			
GFI	GROUND FAULT INTERRUPTER			
GND	GROUND			
GRSC	GALVANIZED RIGID STEEL CONDUIT			
HID	HIGH INTENSITY DISCHARGE			
НОА	HAND OFF AUTOMATIC			
HP	HORSEPOWER			
HPS	HIGH PRESSURE SODIUM			
J	JUNCTION BOX			
KVA	KILOVOLT AMPERE(S)			
KW	KILOWATTS			
LC	LIGHTING CONTACTOR			
LTFMC	LIQUID TIGHT FLEXIBLE METAL CONDUIT (UL LISTED)			
LTG	LIGHTING			
LP	LIGHTING PANEL			
MAX	MAXIMUM			
MCB	MAIN CIRCUIT BREAKER			
MCM	THOUSAND CIRCULAR MIL			
MDP	MAIN DISTRIBUTION PANEL  MANUFACTURER			
MFR				
MH	METAL HALIDE			
MIN	MINIMUM  MAIN LUGS ONLY			
NEC	NATIONAL ELECTRICAL CODE (NFPA 70)			
NEC NC	NORMALLY CLOSED			
NO NO	NORMALLY OPEN			
NTS	NOT TO SCALE			
OHE	OVERHEAD ELECTRIC			
OHE OL	OVERLOAD  OVERLOAD			
UL	OYENLOAD			

El	ECTRICAL ABBREVIATIONS (CONTINUED)
РВ	PULL BOX
PC	PHOTO CELL
PDB	POWER DISTRIBUTION BLOCK
PNL	PANEL
RCPT	RECEPTACLE
R	RELAY
S	STARTER
SPD	SURGE PROTECTION DEVICE
SPST	SINGLE POLE SINGLE THROW
TVSS	TRANSIENT VOLTAGE SURGE SUPPRESSOR
TYP	TYPICAL
UG	UNDERGROUND
UGE	UNDERGROUND ELECTRIC
UL	UNDERWRITER'S LABORATORIES
٧	VOLTS
W/	WITH
<b>W</b> /0	WITHOUT
WP	WEATHER PROOF
XFER	TRANSFER
XFMR	TRANSFORMER

AIRP	ORT EQUIPMENT/FACILITY ABBREVIATIONS
ASOS	AUTOMATED SURFACE OBSERVING SYSTEM
ATCT	AIR TRAFFIC CONTROL TOWER
AWOS	AUTOMATED WEATHER OBSERVING SYSTEM
CCR	CONSTANT CURRENT REGULATOR
DME	DISTANCE MEASURING EQUIPMENT
FAR	FEDERAL AVIATION REGULATION
GS	GLIDE SLOPE FACILITY
HIRL	HIGH INTENSITY RUNWAY LIGHT
ILS	INSTRUMENT LANDING SYSTEM
IM	INNER MARKER
LIR	LOW IMPACT-RESISTANT
LOC	LOCALIZER FACILITY
MALS	MEDIUM INTENSITY APPROACH LIGHTING SYSTEM
MALSR	MEDIUM INTENSITY APPROACH LIGHTING SYSTEM WITH RUNWAY ALIGNMENT INDICATING LIGHTS
MIRL	MEDIUM INTENSITY RUNWAY LIGHT
MITL	MEDIUM INTENSITY TAXIWAY LIGHT
NDB	NON-DIRECTIONAL BEACON
PAPI	PRECISION APPROACH PATH INDICATOR
PLASI	PULSE LIGHT APPROACH SLOPE INDICATOR
RAIL	RUNWAY ALIGNMENT INDICATING LIGHTS
REIL	RUNWAY END IDENTIFIER LIGHT
RVR	RUNWAY VISUAL RANGE
VADI	VISUAL APPROACH DESCENT INDICATOR
VASI	VISUAL APPROACH SLOPE INDICATOR
VOR	VERY HIGH FREQUENCY OMNIDIRECTIONAL RANGE FACILITY
WC	WIND CONE

- 1. ALL ELECTRICAL EQUIPMENT SHALL BE INSTALLED IN CONFORMANCE WITH NFPA 70 NATIONAL ELECTRICAL CODE (NEC) MOST CURRENT ISSUE IN FORCE, THE RESPECTIVE EQUIPMENT MANUFACTURER'S DIRECTIONS AND ALL OTHER APPLICABLE LOCAL CODES, LAWS, ORDINANCES, AND REQUIREMENTS IN FORCE. ANY INSTALLATIONS WHICH VOID THE U.L. LISTING, ETL/INTERTEK TESTING SERVICES VERIFICATION/LISTING (OR OTHER THIRD PARTY LISTING) AND/OR THE MANUFACTURER'S WARRANTY OF A DEVICE WILL NOT BE PERMITTED.
- ALL VAULT WORK, POWER OUTAGES, AND/OR SHUT DOWN OF EXISTING SYSTEMS SHALL BE COORDINATED WITH THE AIRPORT MANAGER. ONCE SHUT DOWN, THE CIRCUITS SHALL BE LABELED AS SUCH TO PREVENT ACCIDENTAL ENERGIZING OF THE RESPECTIVE CIRCUITS. ALL PERSONNEL SHALL FOLLOW U.S. DEPARTMENT OF LABOR OCCUPATIONAL SAFETY & HEALTH ADMINISTRATION (OSHA) 29 CFR PART 1910 OCCUPATIONAL SAFETY & HEALTH STANDARDS FOR ELECTRICAL SAFETY AND LOCKOUT/TAGOUT PROCEDURES INCLUDING, BUT NOT LIMITED TO, 29 CFR SECTION 1910.147 THE CONTROL OF HAZARDOUS ENERGY (LOCKOUT/TAGOUT).
- G. COLOR CODE PHASE AND NEUTRAL CONDUCTOR INSULATION FOR NO. 6 AWG OR SMALLER. PROVIDE COLORED INSULATION OR COLORED MARKING TAPE FOR PHASE AND NEUTRAL CONDUCTORS FOR NO. 4 AWG AND LARGER. INSULATED GROUND CONDUCTORS SHALL HAVE GREEN COLORED INSULATION FOR ALL CONDUCTOR AWG AND/OR KCMIL TO COMPLY WITH NEC 250.119. NEUTRAL CONDUCTORS SHALL HAVE WHITE COLORED INSULATION FOR NO. 6 AWG AND SMALLER TO MEET THE REQUIREMENTS OF NEC 200.6. STANDARD COLORS FOR POWER WIRING AND BRANCH CIRCUITS SHALL BE AS FOLLOWS:

 120/240
 VAC.
 1
 PHASE.
 3
 WIRE

 PHASE A
 BLACK

 PHASE B
 RED

 NEUTRAL
 WHITE

 GROUND
 GREEN

- 4. SEE RESPECTIVE SITE PLANS FOR SITE LEGEND INFORMATION.
- LIFMC DENOTES LIQUID TIGHT FLEXIBLE METAL CONDUIT UL LISTED, SUNLIGHT RESISTANT, & SUITABLE FOR GROUNDING. LIQUID TIGHT FLEXIBLE METAL CONDUIT AND ASSOCIATED FITTINGS SHALL BE U.L. LISTED TO MEET THE REQUIREMENTS OF NEC 350.6. LIQUID TIGHT FLEXIBLE METAL CONDUIT THAT IS USED FOR FLEXIBILITY (INCLUDING CONNECTIONS TO CCR'S & TRANSFORMERS) SHALL REQUIRE AN EXTERNAL BONDING JUMPER OR INTERNAL EQUIPMENT GROUNDING CONDUCTOR PER NEC 350.60. EXTERNAL BONDING JUMPERS USED WITH CCR INSTALLATIONS SHALL BE #6 AWG COPPER (MINIMUM). DO NOT INSTALL LIFMC THAT IS NOT UL LISTED. CONFIRM LIFMC BEARS THE UL LABEL PRIOR TO INSTALLATION.
- ALL ENCLOSURES RATED NEMA 4, 4X SHALL HAVE WATERTIGHT HUBS AT CONDUIT ENTRANCES UL LISTED NEMA 4, 4X FOR THE RESPECTIVE ENCLOSURE, TO MAINTAIN THE NEMA 4, 4X RATING.
- HIGH VOLTAGE CIRCUITS (AIRFIELD LIGHTING 5000 VOLT SERIES CIRCUITS AND/OR OTHER CIRCUITS RATED ABOVE 600 VOLTS) AND LOW VOLTAGE CIRCUITS (RATED 600 VOLTS AND BELOW) SHALL NOT BE INSTALLED IN THE SAME WIREWAY, CONDUIT. DUCT. OR HANDHOLE.
- 8. CONTRACTOR SHALL EXAMINE THE SITE AND VAULT TO DETERMINE EXISTING SITE CONDITIONS.



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COLES COUNTY AIRPORT
AUTHORITY
COLESCORTY MEMORIAL AIRPORT

REMOVE AND REPLACE ALL TAXI GUIDANCE SIGNS ON THE AIRPORT

IDA No: MTO-4511 SBG Project No: 3-17-SBGP-XX

Contract No. CO062

NO. DATE DESCRIPTION
DES DWN REV

ISSUE: APRIL 15, 2016

PROJECT NO: 13401210

PROJECT NO: 13A0121D
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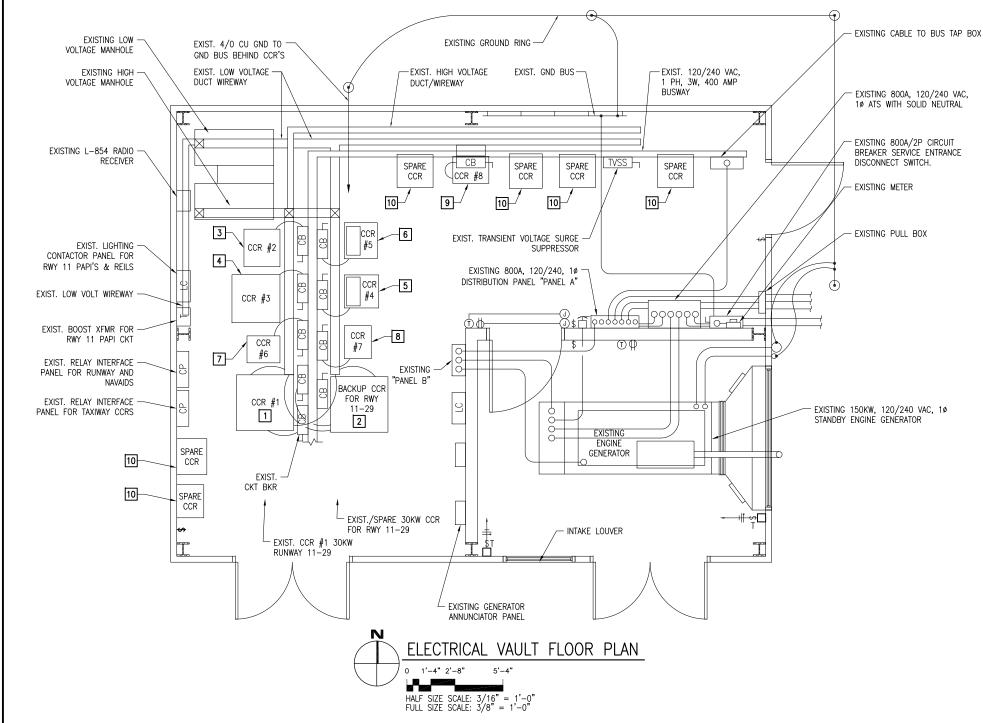
DESIGN BY: KNL 02/05/2016

DRAWN BY: RAD 02/18/2016

REVIEWED BY: KNL 03/08/2016

SHEET TITLE

ELECTRICAL LEGEND AND ABBREVATIONS



# **KEYED NOTES:**

- 1 EXISTING CCR NO. 1 FOR RUNWAY 11-29 TO REMAIN.
- 2 EXISTING BACKUP CCR FOR RUNWAY 11-29 TO REMAIN.
- 3 EXISTING CCR NO. 2 FOR RUNWAY 6-24, CUTOUT, AND ASSOCIATED WIRING TO BE REMOVED AND REPLACED WITH A NEW 10 KW UNIT. EXISTING RUNWAY 6-24 CCR TO BE TURNED OVER TO THE AIRPORT.
- 5 EXISTING CCR NO. 4 FOR TAXIWAY CIRCUITS 1 AND 4, CUTOUTS, AND ASSOCIATED WIRING TO BE REMOVED AND REPLACED WITH A NEW 10 KW UNIT. EXISTING CCR #4 TO BE TURNED OVER TO THE AIRPORT
- 6 EXISTING CCR NO. 5 FOR TAXIWAY CIRCUITS 3 AND 3A, CUTOUTS, AND ASSOCIATED WIRING TO BE REMOVED AND REPLACED WITH A NEW 10 KW UNIT. EXISTING CCR NO. 5 TO BE DISPOSED OF OFF THE AIRPORT SITE.
- TEXISTING CCR NO. 6 FOR TAXIWAY CIRCUIT 5, CUTOUT, AND ASSOCIATED WIRING TO BE REMOVED AND REPLACED WITH A NEW 4 KW UNIT. EXISTING CCR NO. 6 TO BE DISPOSED OF OFF THE AIRPORT SITE.

- 8 EXISTING CCR NO. 7 FOR TAXIWAY CIRCUIT 6, CUTOUT, AND ASSOCIATED WIRING TO BE REMOVED AND REPLACED WITH A NEW 7.5 KW UNIT. EXISTING CCR NO. 7 TO BE DISPOSED OF OFF THE AIRPORT SITE.
- 9 EXISTING CCR NO. 8 FOR TAXIWAY CIRCUIT 2, CUTOUT, AND ASSOCIATED WIRING TO BE REMOVED AND REPLACED WITH A NEW 4 KW UNIT. EXISTING CCR NO. 8 TO BE DISPOSED OF OFF THE AIRPORT SITE.
- 10 THERE ARE SIX EXISTING SPARE JUNK CONSTANT CURRENT REGULATORS IN THE VAULT. THESE REGULATORS SHALL BE REMOVED AND DISPOSED OF OFF THE AIRPORT SITE. CONFIRM THE RESPECTIVE REGULATORS FOR REMOVAL AND DISPOSAL WITH THE AIRPORT MANAGER.

# **GENERAL NOTES:**

- 1. CONTRACTOR SHALL COORDINATE WORK, POWER OUTAGES, AND/OR SHUT DOWN OF EXISTING SYSTEMS WITH THE AIRPORT MANAGER AND THE RESIDENT ENGINEER/RESIDENT PROJECT REPRESENTATIVE. ANY SHUTDOWN OF EXISTING SYSTEMS SHALL BE SCHEDULED WITH AND APPROVED BY THE AIRPORT MANAGER PRIOR TO SHUTDOWN, ONCE SHUT DOWN, THE CIRCUITS SHALL BE LABELED AS SUCH TO PREVENT ACCIDENTAL ENERGIZING OF THE RESPECTIVE CIRCUITS. ALL PERSONNEL SHALL FOLLOW U.S. DEPARTMENT OF LABOR OCCUPATIONAL SAFETY & HEALTH ADMINISTRATION (OSHA) 29 CFR PART 1910 OCCUPATIONAL SAFETY AND HEALTH STANDARDS FOR ELECTRICAL SAFETY AND LOCKOUT/TAGOUT PROCEDURES INCLUDING, BUT NOT LIMITED TO, 29 CFR SECTION 1910.147 THE CONTROL OF HAZARDOUS ENERGY (LOCKOUT/TAGOUT).
- 2. CONTRACTOR SHALL EXAMINE THE SITE TO CONFIRM AND FIELD VERIFY EXISTING SITE CONDITIONS.
- 3. THE RESPECTIVE PERSONNEL PERFORMING AIRFIELD LIGHTING WORK, VAULT WORK, AND/OR TESTS SHALL BE FAMILIAR WITH AND QUALIFIED TO WORK ON 5000 VOLT AIRFIELD LIGHTING SERIES CIRCUITS, CONSTANT CURRENT REGULATORS, AND ASSOCIATED AIRPORT ELECTRICAL VAULT EQUIPMENT.
- . CONTRACTOR SHALL COMPLY WITH THE APPLICABLE REQUIREMENTS OF NFPA 70E STANDARD FOR ELECTRICAL SAFETY IN THE WORKPLACE.
- 5. EACH ACTIVE CCR SHALL BE TESTED FOR PROPER OPERATION BEFORE REMOVAL WORK, MODIFICATIONS AND/OR ADDITIONS AND AFTER THE TAXI GUIDANCE SIGN REPLACEMENTS AND VAULT ADDITIONS HAVE BEEN COMPLETED. CONTRACTOR SHALL TEST AND RECORD THE INPUT CURRENT AND OUTPUT CURRENT FOR EACH CONSTANT CURRENT REGULATOR IN THE AUTOMATIC AND MANUAL MODES OF OPERATION. CONTRACTOR SHALL REPORT CONCERNS AND/OR DEFICIENCIES TO THE PROJECT ENGINEER.
- 6. REMOVAL AND DISPOSAL OF EXISTING DESIGNATED EQUIPMENT WILL BE PAID FOR UNDER ITEM AR109902 REMOVE ELECTRICAL EQUIPMENT, PER LUMP SUM.



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COLES COUNTY AIRPORT
AUTHORITY
COLES COMPTY MEMORIAL AIRPORT

REMOVE AND REPLACE ALL TAXI GUIDANCE SIGNS ON THE AIRPORT

IDA No: MTO-4511 SBG Project No: 3-17-SBGP-XX

Contract No. CO062

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PROJECT NO: 13A0121D

CAD FILE: E-101-VLT.DWG

DESIGN BY: KNL 02/11/2016

DRAWN BY: MLH 02/22/2016

REVIEWED BY: KNL 03/08/2016

SHEET TITLE

EXISTING FLOOR PLAN FOR VAULT



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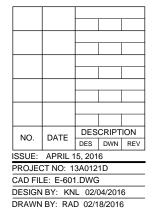
Illinois Licensed Professional Service Corporation #184-001084

**COLES COUNTY AIRPORT** AUTHORITY 111111

REMOVE AND REPLACE ALL TAXI **GUIDANCE SIGNS ON** THE AIRPORT

IDA No: MTO-4511 SBG Project No: 3-17-SBGP-XX

Contract No. CO062



SHEET TITLE

SAFETY ON AIRPORTS DURING CONSTRUCTION".

CONTRACTOR SHALL COMPLY WITH THE APPLICABLE REQUIREMENTS

OF NFPA 70E - STANDARD FOR ELECTRICAL SAFETY IN THE

5. WHEN A RUNWAY IS SHUT DOWN THE RUNWAY LIGHTING AND ASSOCIATED AIRFIELD NAVAIDS FOR THAT RUNWAY SHALL BE SHUT **EXISTING** ELECTRICAL ONE LINE DIAGRAM FOR **VAULT** 

REVIEWED BY: KNL 03/08/2016


REMOVED AND

OFF SITE.

REPLACED WITH A

4KW UNIT. EXISTING

CCR TO BE DISPOSED

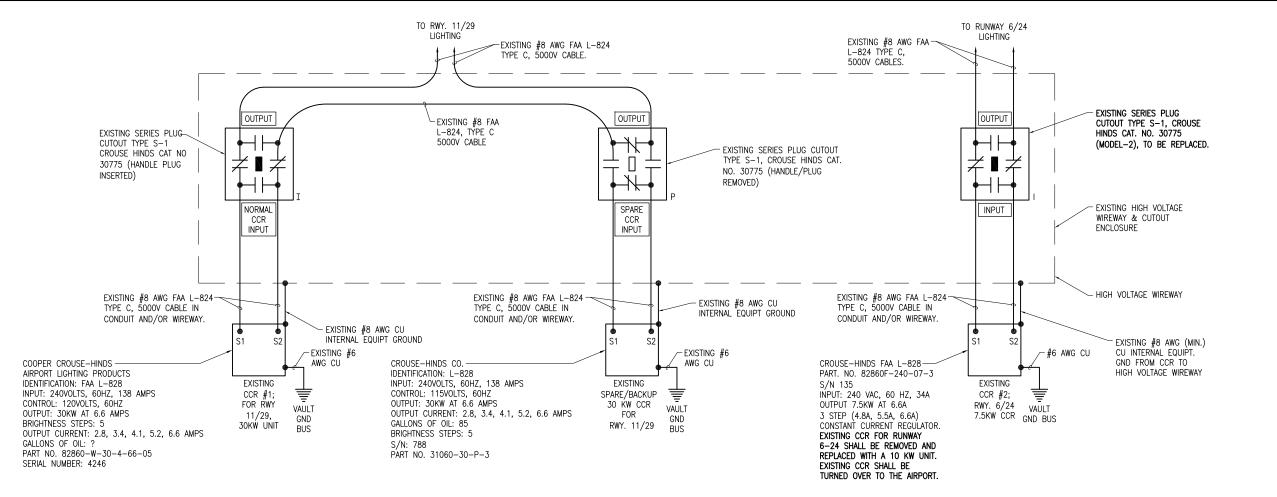

# EXISTING HIGH VOLTAGE WIRING SCHEMATIC FOR RUNWAYS

# NOTES:

- ALL WORK, POWER OUTAGES, AND/OR SHUT DOWN OF EXISTING SYSTEMS SHALL BE COORDINATED WITH THE AIRPORT MANAGER/DIRECTOR AND RESIDENT ENGINEER/RESIDENT PROJECT REPRESENTATIVE. ONCE SHUT DOWN, THE CIRCUITS SHALL BE LABELED AS SUCH TO PREVENT ACCIDENTAL ENERGIZING OF THE RESPECTIVE CIRCUITS. ALL PERSONNEL SHALL FOLLOW U.S. DEPARTMENT OF LABOR OCCUPATIONAL SAFETY & HEALTH ADMINISTRATION (OSHA) 29 CFR PART 1910 OCCUPATIONAL SAFETY & HEALTH STANDARDS FOR ELECTRICAL SAFETY AND LOCKOUT/TAGOUT PROCEDURES INCLUDING, BUT NOT LIMITED TO, 29 CFR SECTION 1910.147 THE CONTROL OF HAZARDOUS ENERGY (LOCKOUT/TAGOUT).
- CONTRACTOR SHALL EXAMINE THE SITE TO CONFIRM AND FIELD VERIFY EXISTING SITE CONDITIONS.
- THE RESPECTIVE PERSONNEL PERFORMING AIRFIELD LIGHTING WORK, VAULT WORK, AND/OR TESTS SHALL BE FAMILIAR WITH, AND QUALIFIED TO WORK ON, 5000 VOLT AIRFIELD LIGHTING SERIES CIRCUITS, CONSTANT CURRENT REGULATORS, AND ASSOCIATED AIRPORT ELECTRICAL VAULT EQUIPMENT.
- CONTRACTOR SHALL EXERCISE CAUTION, PRACTICE SAFETY, AND DISCONNECT THE SERIES CIRCUITS FROM THE RESPECTIVE CONSTANT CURRENT REGULATORS, AS APPLICABLE WHEN PERFORMING WORK ON THE AIRFIELD LIGHTING OR WORK THAT MIGHT AFFECT THE AIRFIELD LIGHTING. CONTRACTOR SHALL MAKE NECESSARY ARRANGEMENTS TO DISCONNECT POWER AND LOCKOUT CIRCUITS FOR PROTECTION OF PERSONNEL.
- MEGGER TEST AND RECORD EXISTING SERIES CIRCUITS PRIOR TO CABLE WORK AND AGAIN AFTER AIRFIELD LIGHTING MODIFICATIONS, ADDITIONS, AND/OR UPGRADES HAVE BEEN COMPLETED. ALSO TEST AND RECORD
- ALL CCR'S SHALL BE TESTED FOR PROPER OPERATION BEFORE REMOVAL WORK, MODIFICATIONS, AND/OR ADDITIONS AND AFTER THE NEW CABLES AND TAXI GUIDANCE SIGN REPLACEMENTS AND ADDITIONS HAVE BEEN COMPLETED. CONTRACTOR SHALL TEST AND RECORD THE INPUT CURRENT AND OUTPUT CURRENT FOR EACH CONSTANT CURRENT REGULATOR IN THE AUTOMATIC AND MANUAL MODES OF OPERATIONS. CONTRACTOR SHALL REPORT CONCERNS AND/OR DEFICIENCIES TO THE RESIDENT ENGINEER/RESIDENT TECHNICIAN. TEST RESULTS SHALL BE PROVIDED TO THE PROJECT ENGINEER AND RESIDENT ENGINEER/RESIDENT TECHNICIAN.

**LEGEND** 

DENOTES PLUG CUTOUT WITH PLUG INSERTED

DENOTES PLUG CUTOUT WITH PLUG PULLED

"CCR" DENOTES CONSTANT CURRENT REGULATOR



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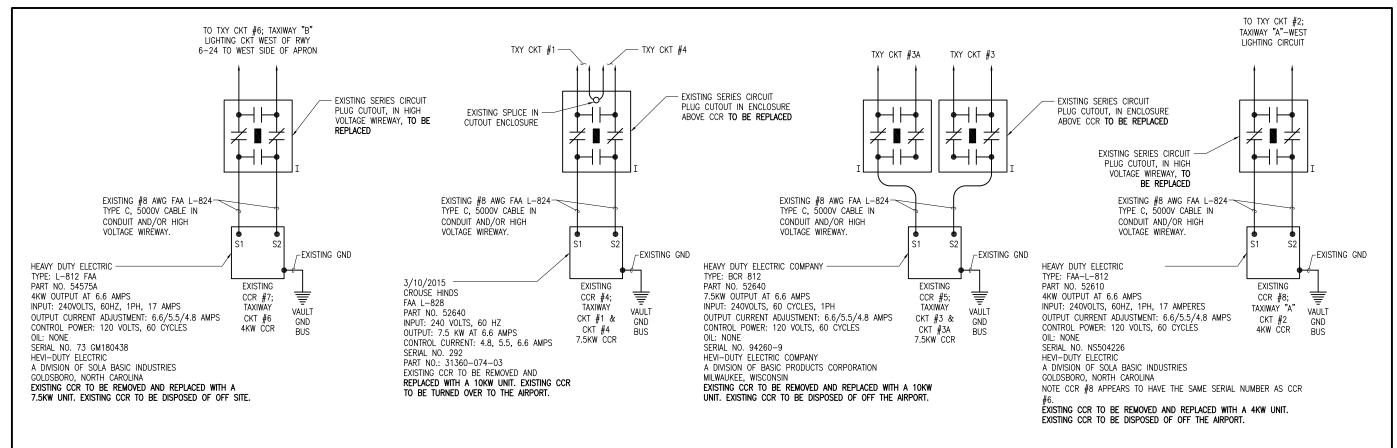
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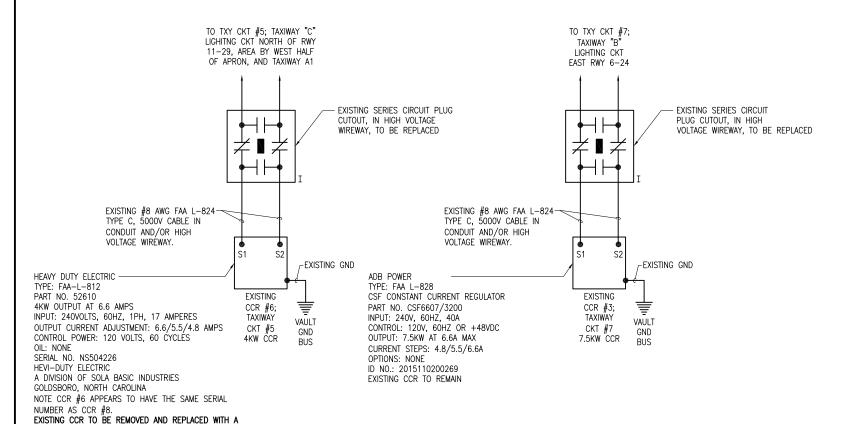
DESIGN BY: KNI 02/04/2016 DRAWN BY: RAD 02/18/2016 REVIEWED BY: KNL 03/08/2016

SHEET TITLE

**EXISTING HIGH VOLTAGE WIRING** SCHEMATIC FOR **RUNWAYS** 

4KW UNIT. EXISTING CCR TO BE DISPOSED OF OFF SITE.





# NOTES

- 1. ALL WORK, POWER OUTAGES, AND/OR SHUT DOWN OF EXISTING SYSTEMS SHALL BE COORDINATED WITH THE AIRPORT MANAGER/DIRECTOR AND THE RESPECTIVE FAA ATCT PERSONNEL. ONCE SHUT DOWN, THE CIRCUITS SHALL BE LABELED AS SUCH TO PREVENT ACCIDENTAL ENERGIZING OF THE RESPECTIVE CIRCUITS. ALL PERSONNEL SHALL FOLLOW U.S. DEPARTMENT OF LABOR OCCUPATIONAL SAFETY & HEALTH ADMINISTRATION (OSHA) 29 CFR PART 1910 OCCUPATIONAL SAFETY & HEALTH STANDARDS FOR ELECTRICAL SAFETY AND LOCKOUT/TAGOUT PROCEDURES INCLUDING, BUT NOT LIMITED TO, 29 CFR SECTION 1910.147 THE CONTROL OF HAZARDOUS ENERGY (LOCKOUT/TAGOUT).
- 2. CONTRACTOR SHALL EXAMINE THE SITE TO CONFIRM AND FIELD VERIFY EXISTING SITE CONDITIONS.
- THE RESPECTIVE PERSONNEL PERFORMING AIRFIELD LIGHTING WORK, VAULT WORK, AND/OR TESTS SHALL BE FAMILIAR
  WITH, AND QUALIFIED TO WORK ON, 5000 VOLT AIRFIELD LIGHTING SERIES CIRCUITS, CONSTANT CURRENT REGULATORS,
  AND ASSOCIATED AIRPORT ELECTRICAL VAULT EQUIPMENT.
- 4. NOTE THE EXISTING TAXIWAY CIRCUIT CUTOUTS ARE OLD AND SOME ARE IN POOR CONDITION. SOME CUTOUTS MIGHT NOT FUNCTION PROPERLY. CONTRACTOR SHALL EXERCISE CAUTION, PRACTICE SAFETY, AND DISCONNECT THE SERIES CIRCUITS FROM THE RESPECTIVE CONSTANT CURRENT REGULATORS, AS APPLICABLE WHEN PERFORMING WORK ON THE AIRFIELD LIGHTING OR WORK THAT MIGHT AFFECT THE AIRFIELD LIGHTING. CONTRACTOR SHALL MAKE NECESSARY ARRANGEMENTS TO DISCONNECT POWER AND LOCKOUT CIRCUITS FOR PROTECTION OF PERSONNEL.
- MEGGER TEST AND RECORD EXISTING SERIES CIRCUITS PRIOR TO CABLE WORK AND AGAIN AFTER AIRFIELD LIGHTING MODIFICATIONS, ADDITIONS, AND/OR UPGRADES HAVE BEEN COMPLETED. ALSO TEST AND RECORD SERIES CIRCUIT LOOP RESISTANCE
- 6. THE RESPECTIVE CCR'S SCHEDULED TO REMAIN SHALL BE TESTED FOR PROPER OPERATION BEFORE ANY AIRFIELD WORK THAT MIGHT AFFECT LIGHTING CIRCUITS, REMOVAL WORK, MODIFICATIONS, AND/OR ADDITIONS AND AFTER THE AIRFIELD WORK AND ADDITIONS HAVE BEEN COMPLETED. CONTRACTOR SHALL TEST AND RECORD THE INPUT CURRENT AND OUTPUT CURRENT FOR EACH CONSTANT CURRENT REGULATOR IN THE AUTOMATIC AND MANUAL MODES OF OPERATIONS. CONTRACTOR SHALL REPORT CONCERNS AND/OR DEFICIENCIES TO THE RESIDENT ENGINEER/RESIDENT TECHNICIAN.

LEGENI

"CCR" DENOTES CONSTANT CURRENT REGULATOR



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COLES COUNTY AIRPORT

AUTHORITY

COLES COMMY MEMORIAL AIRPORT

REMOVE AND REPLACE ALL TAXI GUIDANCE SIGNS ON THE AIRPORT

IDA No: MTO-4511 SBG Project No: 3-17-SBGP-XX

Contract No. CO062


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PROJEC	CT NO: 1	3A012	1D		
CAD FILE: E-604.DWG					
DESIGN BY: KNL 02/04/2016					

SHEET TITLE

EXISTING HIGH VOLTAGE WIRING SCHEMATIC FOR TAXIWAYS

DRAWN BY: RAD 02/18/2016

REVIEWED BY: KNL 03/08/2016

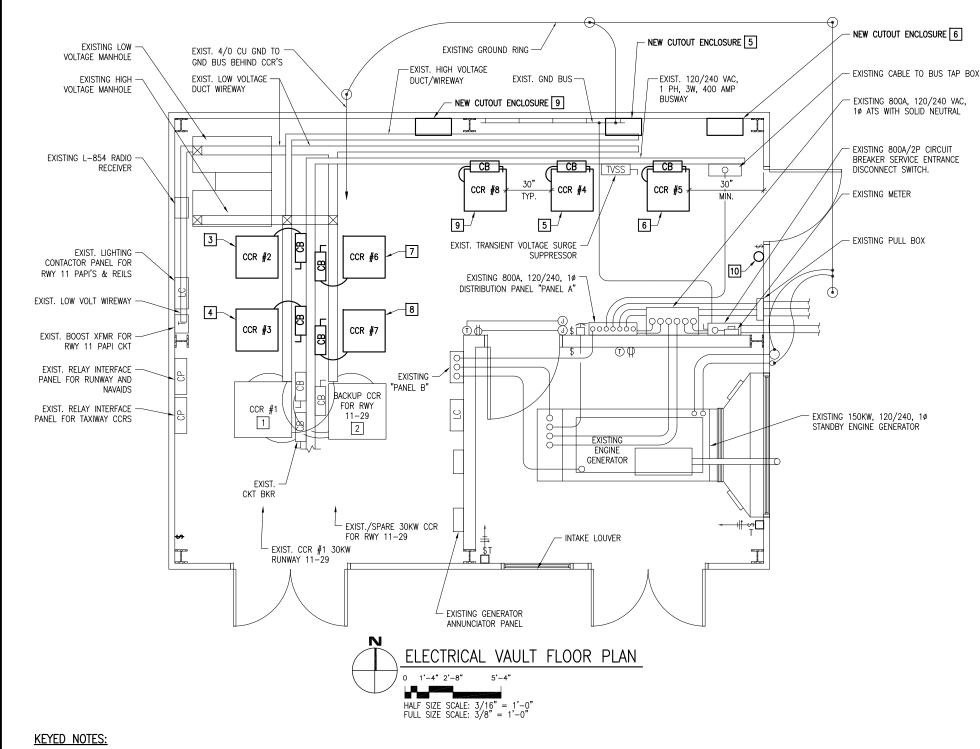

- 1 EXISTING CCR NO. 1 FOR RUNWAY 11-29 TO REMAIN.
- 2 EXISTING BACKUP CCR FOR RUNWAY 11-29 TO REMAIN.
- 3 NEW CCR NO. 2 FOR RUNWAY 6-24. FURNISH AND INSTALL NEW CIRCUIT BREAKER, CUTOUT, AND ASSOCIATED CONDUITS AND WIRING. SEE GENERAL NOTE 1.
- 4 EXISTING CCR NO. 3 FOR TAXIWAY CIRCUIT 7, TO REMAIN. FURNISH AND INSTALL NEW CUTOUT. SEE
- 5 NEW CCR NO. 4 FOR TAXIWAY CIRCUITS 1 AND 4. FURNISH AND INSTALL NEW CIRCUIT BREAKER. CUTOUTS, CUTOUT ENCLOSURE, AND ASSOCIATED CONDUITS AND WIRING. SEE GENERAL NOTE 1.
- 6 NEW CCR NO. 5 FOR TAXIWAY CIRCUITS 3 AND 3A. FURNISH AND INSTALL NEW CIRCUIT BREAKER, CUTOUTS, CUTOUT ENCLOSURE, AND ASSOCIATED CONDUITS AND WIRING. SEE GENERAL NOTE 1.
- 7 NEW CCR NO. 6 FOR TAXIWAY CIRCUIT 5. FURNISH AND INSTALL NEW CUTOUT AND ASSOCIATED CONDUITS AND WIRING. RELOCATE EXISTING CIRCUIT BREAKER AS APPLICABLE TO ACCOMMODATE LOCATION OF CCR. SEE GENERAL NOTE 1.
- NEW CCR NO. 7 FOR TAXIWAY CIRCUIT 6. FURNISH AND INSTALL NEW CIRCUIT BREAKER, CUTOUTS, AND ASSOCIATED CONDUITS AND WIRING. SEE GENERAL NOTE 1.

- 9 NEW CCR NO. 8 FOR TAXIWAY CIRCUIT 2. FURNISH AND INSTALL NEW CIRCUIT BREAKER, CUTOUTS, CUTOUT ENCLOSURE, AND ASSOCIATED CONDUITS AND WIRING. SEE GENERAL NOTE 1.
- FURNISH AND INSTALL ONE UL RATED, 10 POUND CARBON DIOXIDE FIRE EXTINGUISHER SUITABLE FOR USE ON CLASS C FIRES IN THE VAULT. PER NFPA 10 "PORTABLE FIRE EXTINGUISHERS" CLASS C ARE FOR FIRES THAT INVOLVE ENERGIZED ELECTRICAL EQUIPMENT. FIRE EXTINGUISHERS SHALL BE MADE IN THE UNITED STATES OF AMERICA TO COMPLY WITH THE AIRPORT IMPROVEMENT PROGRAM BUY AMERICAN REQUIREMENT. FIRE EXTINGUISHER TYPE CO2 SHALL BE AMEREX MODEL 330, OR APPROVED EQUAL.

# **GENERAL NOTES:**

- 1. SEE "PROPOSED ELECTRICAL ONE LINE DIAGRAM FOR VAULT" FOR LOW VOLTAGE INPUT POWER WIRING REQUIREMENTS TO CCR'S. SEE PROPOSED HIGH VOLTAGE WIRING SCHEMATICS FOR CCR OUTPUT WIRING REQUIREMENTS. SEE AIRFIELD LIGHTING CONTROL WIRING SCHEMATICS FOR RUNWAY AND TAXIWAYS FOR CCR CONTROL WIRING
- THE RESPECTIVE PERSONNEL PERFORMING AIRFIELD LIGHTING WORK, VAULT WORK, AND/OR TESTS SHALL BE FAMILIAR WITH AND QUALIFIED TO WORK ON 5000 VOLT AIRFIELD LIGHTING SERIES CIRCUITS, CONSTANT CURRENT REGULATORS, AND ASSOCIATED AIRPORT
- 3. ALL ELECTRICAL EQUIPMENT AND MATERIALS SHALL BE INSTALLED IN CONFORMANCE WITH NFPA 70 - NATIONAL ELECTRICAL CODE (NEC) MOST CURRENT ISSUE IN FORCE, THE RESPECTIVE EQUIPMENT MANUFACTURER'S DIRECTIONS AND ALL OTHER APPLICABLE LOCAL CODES, LAWS, ORDINANCE, AND REQUIREMENTS IN FORCE. ANY INSTALLATIONS WHICH VOID THE U.L. LISTING, INTERTEK TESTING SERVICES VERIFICATION/ETL LISTING, (OR OTHER THIRD PARTY LISTING) AND/OR THE MANUFACTURER'S WARRANTY OF A DEVICE WILL NOT
- CONTRACTOR SHALL COMPLY WITH THE APPLICABLE REQUIREMENTS OF NFPA 70E -STANDARD FOR ELECTRICAL SAFETY IN THE WORKPLACE.
- 5. EACH CCR SHALL BE TESTED FOR PROPER OPERATION. CONTRACTOR SHALL TEST AND RECORD THE INPUT CURRENT AND OUTPUT CURRENT FOR EACH CONSTANT CURRENT REGULATOR IN THE AUTOMATIC AND MANUAL MODES OF OPERATION. CONTRACTOR SHALL REPORT CONCERNS AND/OR DEFICIENCIES TO THE PROJECT ENGINEER.
- CONTRACTOR SHALL FURNISH AND INSTALL LEGEND PLATES, WARNING LABELS AND SIGNS FOR THE VAULT AND VAULT EQUIPMENT AS DETAILED HEREIN. SEE "LEGEND PLATE SCHEDULES" SHEET.
- 7. MAINTAIN SEPARATION OF HIGH VOLTAGE WIRING (AIRFIELD LIGHTING 5000 VOLT SERIES CIRCUITS AND/OR OTHER CIRCUITS RATED ABOVE 600 VOLTS) FROM LOW VOLTAGE WIRING (RATED 600 VOLTS AND BELOW) TO COMPLY WITH NEC 300.3(C)(2). HIGH VOLTAGE AND LOW VOLTAGE WIRING SHALL NOT BE INSTALLED IN THE SAME RACEWAY, CONDUIT, WIREWAY, PULL BOX, SPLICE CAN, HANDHOLE, OR MANHOLE.
- MAINTAIN SEPARATION OF HIGH VOLTAGE CIRCUIT WIRING (AIRFIELD LIGHTING 5000 VOLT SERIES CIRCUITS AND/OR OTHER CIRCUITS RATED ABOVE 600 VOLTS) AND LOW VOLTAGE CIRCUITS WIRING (RATED 600 VOLTS AND BELOW). LOW VOLTAGE WIRING SHALL ENTER THE RESPECTIVE CCR AT THE LOW VOLTAGE SECTION. HIGH VOLTAGE WIRING SHALL ENTER THE RESPECTIVE CCR AT THE HIGH VOLTAGE SECTION.
- BOND EACH CCR FRAME/HOUSING TO VAULT GROUND BUS WITH #6 AWG COPPER BONDING
- 10. LOCATIONS OF CCR'S MAY BE ADJUSTED TO ACCOMMODATE SITE CONDITIONS. COORDIANTE WITH AIRPORT MANAGER AND PROJECT ENGINEER.



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**COLES COUNTY AIRPORT** AUTHORITY

REMOVE AND REPLACE ALL TAXI **GUIDANCE SIGNS ON** THE AIRPORT

IDA No: MTO-4511 SBG Project No: 3-17-SBGP-XX

Contract No. CO062

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REVIEWED BY: KNL 03/08/2016

SHEET TITLE

**NEW FLOOR PLAN** FOR VAULT



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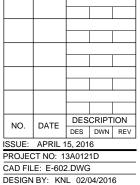
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**COLES COUNTY AIRPORT** - AUTHORITY

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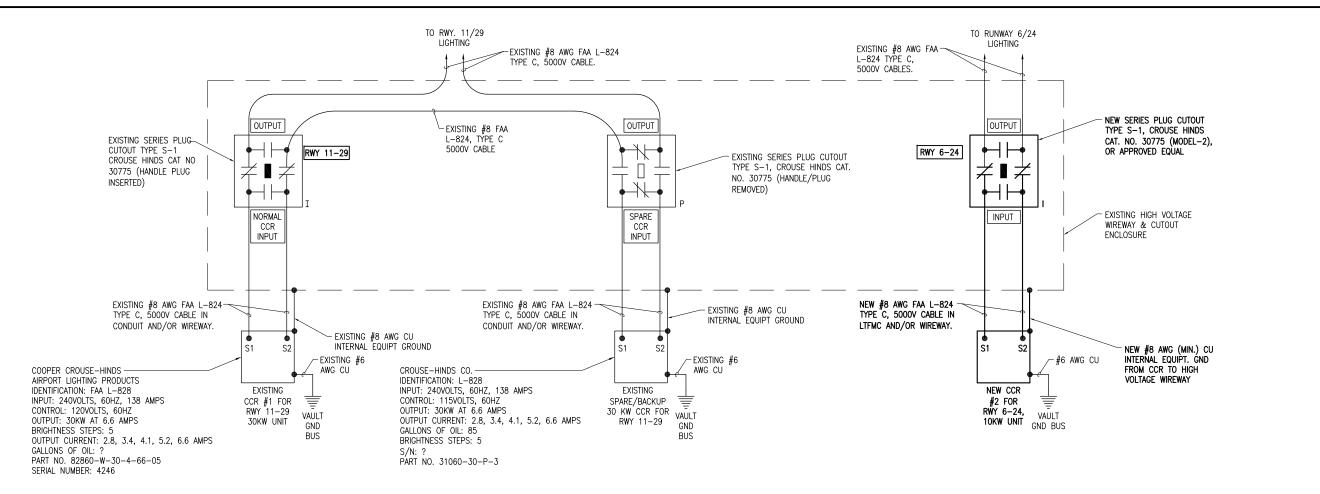
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Contract No. CO062



SHEET TITLE

**PROPOSED ELECTRICAL ONE** LINE DIAGRAM FOR **VAULT** 



# PROPOSED HIGH VOLTAGE WIRING SCHEMATIC FOR RUNWAYS

# **NOTES**

- PROVIDE PHENOLIC ENGRAVED LEGEND PLATES FOR EACH CONSTANT CURRENT REGULATOR (EXISTING & NEW) NOTING THE REGULATOR DESIGNATION AND THE RUNWAY AND/OR TAXIWAY SERVED.
- EACH PLUG CUTOUT CABINET SHALL BE FURNISHED WITH A PHENOLIC ENGRAVED LEGEND PLATE THAT IDENTIFIES THE RESPECTIVE RUNWAY OR TAXIWAY CIRCUIT OR REGULATOR. INCLUDE AN ADDITIONAL LEGEND PLATE LABELED "CAUTION OPERATE CUTOUTS WITH CCR SHUT OFF".
- PROVIDE PHENOLIC ENGRAVED LEGEND PLATES FOR THE CUTOUTS TO IDENTIFY THE RESPECTIVE REGULATOR OUTPUT CONNECTION AND THE RESPECTIVE CIRCUIT LOAD CONNECTION.
- BOND REGULATOR FRAME TO VAULT GROUND BUS WITH A DEDICATED #6 AWG BONDING JUMPER.
- PROVIDE ADEQUATE WORKING SPACE IN FRONT OF EACH CUTOUT ENCLOSURE TO MEET NEC CLEARANCE REQUIREMENTS.
- LIQUID TIGHT FLEXIBLE METAL CONDUIT AND ASSOCIATED FITTINGS SHALL BE U.L. LISTED TO MEET THE REQUIREMENTS OF NEC 350.6, SUITABLE FOR GROUNDING AND SUNLIGHT RESISTANT. LIQUID TIGHT FLEXIBLE METAL CONDUIT THAT IS USED FOR FLEXIBILITY (INCLUDING CONNECTIONS TO CCR'S & TRANSFORMERS) SHALL REQUIRE AN EXTERNAL BONDING JUMPER OR INTERNAL EQUIPMENT GROUNDING CONDUCTOR PER NEC 350.60. EXTERNAL BONDING JUMPERS USED WITH CCR INSTALLATIONS SHALL BE #6 AWG COPPER (MINIMUM). DO NOT INSTALL LIQUID TIGHT FLEXIBLE METAL CONDUIT THAT IS NOT UL LISTED. CONFIRM LIQUID TIGHT FLEXIBLE METAL CONDUIT BEARS THE UL LABEL PRIOR TO INSTALLING IT
- SERIES PLUG CUTOUTS SHALL BE TYPE S-1, RATED 5000 VOLTS, 20-AMP, AND SHALL COMPLY WITH FAA AC 150/5340-4C. SERIES PLUG CUTOUTS SHALL BE RATED SUITABLE FOR NORMAL OPERATION WITH HANDLE REMOVED OR HANDLE INSERTED. CUTOUTS SHALL DISCONNECT THE INPUT FROM THE FROM THE OUTPUT, SHORT THE INPUT TERMINALS, AND SHORT THE OUTPUT TERMINALS WHEN THE HANDLE/PLUG IS REMOVED. CUTOUTS SHALL BE SUITABLE FOR MANUAL TRANSFER OPERATION (ONE SERIES CIRCUIT LOOP WITH THE CAPABILITY OF BEING POWERED FROM EITHER OF TWO CONSTANT CURRENT REGULATOR POWER SOURCES). SERIES PLUG CUTOUTS SHALL BE CROUSE—HINDS CAT. NO. 30775, OR APPROVED EQUAL. THE RESPECTIVE MANUFACTURER SHALL CERTIFY IN WRITING THAT THEIR CUTOUT IS SUITABLE AND RATED FOR THE RESPECTIVE
- HIGH VOLTAGE WIRING SHALL ENTER EACH RESPECTIVE REGULATOR AT THE HIGH-VOLTAGE/SERIES CIRCUIT OUTPUT SECTION OF THE REGULATOR.
- DUE TO THE PHYSICAL DIMENSIONS OF THE NEW REGULATORS, SOME UNITS WILL REQUIRE RELOCATION IN THE VAULT TO AN AREA WITH ADEQUATE FLOOR SPACE

# **LEGEND**

- DENOTES PLUG CUTOUT WITH PLUG INSERTED
- DENOTES PLUG CUTOUT WITH PLUG PULLED

"CCR" DENOTES CONSTANT CURRENT REGULATOR



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REMOVE AND REPLACE ALL TAXI **GUIDANCE SIGNS ON** THE AIRPORT

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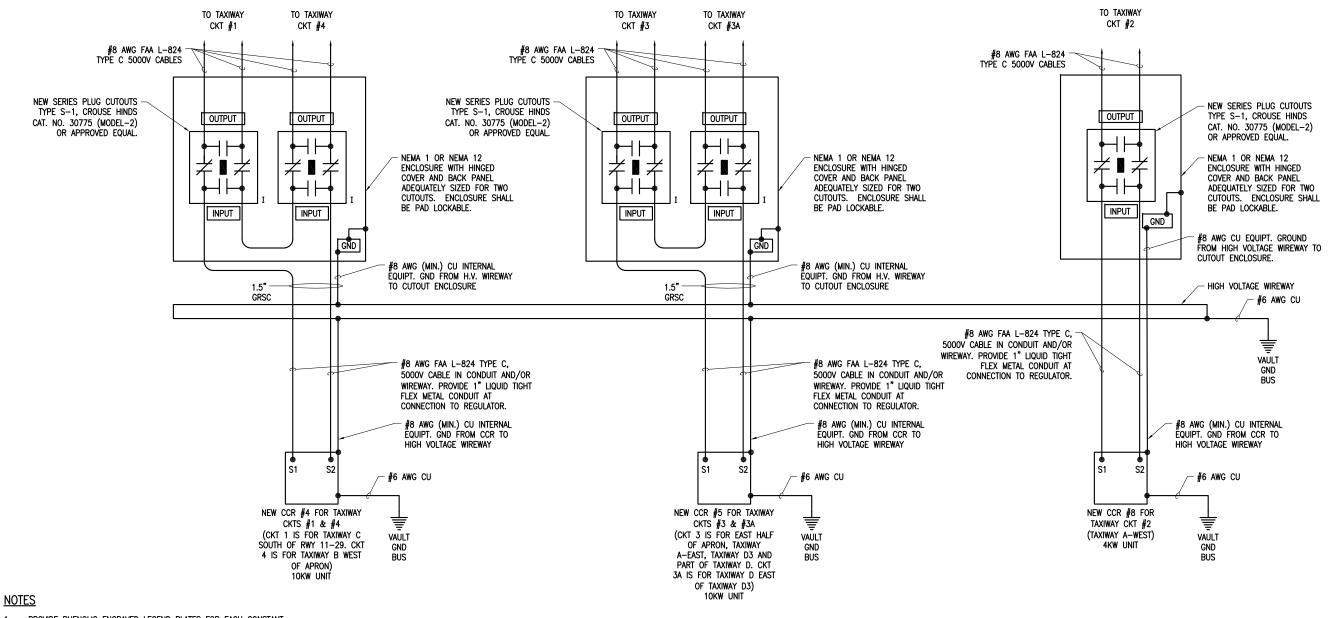
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REVIEWED BY: KNL 03/08/2016

SHEET TITLE

PROPOSED HIGH **VOLTAGE WIRING** SCHEMATIC FOR **RUNWAYS** 



- PROVIDE PHENOLIC ENGRAVED LEGEND PLATES FOR EACH CONSTANT CURRENT REGULATOR (EXISTING & NEW) NOTING THE REGULATOR DESIGNATION AND THE RUNWAY AND/OR TAXIWAY SERVED.
- EACH PLUG CUTOUT CABINET SHALL BE FURNISHED WITH A PHENOLIC ENGRAVED LEGEND PLATE THAT IDENTIFIES THE RESPECTIVE RUNWAY OR TAXIWAY CIRCUIT OR REGULATOR. INCLUDE AN ADDITIONAL LEGEND PLATE LABELED "CAUTION OPERATE CUTOUTS WITH CCR SHUT OFF".
- PROVIDE PHENOLIC ENGRAVED LEGEND PLATES FOR THE CUTOUTS TO IDENTIFY THE RESPECTIVE REGULATOR OUTPUT CONNECTION AND THE RESPECTIVE CIRCUIT LOAD CONNECTION.
- BOND REGULATOR FRAME TO VAULT GROUND BUS WITH A DEDICATED #6 AWG BONDING JUMPER.
- PROVIDE ADEQUATE WORKING SPACE IN FRONT OF EACH CUTOUT ENCLOSURE TO MEET NEC CLEARANCE REQUIREMENTS.
- LIQUID TIGHT FLEXIBLE METAL CONDUIT AND ASSOCIATED FITTINGS SHALL BE U.L. LISTED TO MEET THE REQUIREMENTS OF NEC 350.6. SUITABLE FOR GROUNDING AND SUNLIGHT RESISTANT. LIQUID TIGHT FLEXIBLE METAL CONDUIT THAT IS USED FOR FLEXIBILITY (INCLUDING CONNECTIONS TO CCR'S & TRANSFORMERS) SHALL REQUIRE AN EXTERNAL BONDING JUMPER OR INTERNAL EQUIPMENT GROUNDING CONDUCTOR PER NEC 350.60. EXTERNAL BONDING JUMPERS USED WITH CCR INSTALLATIONS SHALL BE #6 AWG COPPER (MINIMUM). DO NOT INSTALL LIQUID TIGHT FLEXIBLE METAL CONDUIT THAT IS NOT UL LISTED. CONFIRM LIQUID TIGHT FLEXIBLE METAL CONDUIT BEARS THE UL LABEL PRIOR TO
- SERIES PLUG CUTOUTS SHALL BE TYPE S-1, RATED 5000 VOLTS, 20-AMP, AND SHALL COMPLY WITH FAA AC 150/5340-4C. SERIES PLUG CUTOUTS SHALL BE RATED SUITABLE FOR NORMAL OPERATION WITH HANDLE REMOVED OR HANDLE INSERTED. CUTOUTS SHALL DISCONNECT THE INPUT FROM THE FROM THE OUTPUT, SHORT THE INPUT TERMINALS, AND SHORT THE OUTPUT TERMINALS WHEN THE HANDLE/PLUG IS REMOVED. CUTOUTS SHALL BE SUITABLE FOR WIRING IN A CONFIGURATION THAT CONNECTS TWO SERIES CIRCUIT LOOPS TO ONE CONSTANT CURRENT REGULATOR, SERIES PLUG CUTOUTS SHALL BE CROUSE-HINDS CAT. NO. 30775. OR APPROVED FOUAL THE RESPECTIVE MANUFACTURER SHALL CERTIFY IN WRITING THAT THEIR CUTOUT IS SUITABLE AND RATED FOR THE RESPECTIVE APPLICATION.
- HIGH VOLTAGE WIRING SHALL ENTER EACH RESPECTIVE REGULATOR AT THE HIGH-VOLTAGE/SERIES CIRCUIT OUTPUT SECTION OF THE REGULATOR.
- DUE TO THE PHYSICAL DIMENSIONS OF THE NEW REGULATORS, SOME UNITS WILL REQUIRE RELOCATION IN THE VAULT TO AN AREA WITH
- SPLICES FOR RUNWAY AND TAXIWAY SERIES CIRCUITS SHALL BE FAA APPROVED TYPE L-823 CONNECTORS AND SHALL BE INSTALLED IN HIGH VOLTAGE HANDHOLES, HIGH VOLTAGE MANHOLES, SPLICE CANS OR HIGH VOLTAGE ENCLOSURES.

# LEGEND

- DENOTES PLUG CUTOUT WITH PLUG INSERTED
- DENOTES PLUG CUTOUT WITH PLUG PULLED
- "CCR" DENOTES CONSTANT CURRENT REGULATOR

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Contract No. CO062


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DRAWN BY: RAD 02/19/2015 REVIEWED BY: KNL 03/08/2016

SHEET TITLE

PROPOSED HIGH **VOLTAGE WIRING** SCHEMATIC FOR TAXIWAY CKTS 1, 2, 3, 3A, & 4



- PROVIDE PHENOLIC ENGRAVED LEGEND PLATES FOR EACH CONSTANT CURRENT REGULATOR (EXISTING & NEW) NOTING THE REGULATOR DESIGNATION AND THE RUNWAY AND/OR TAXIWAY SERVED.
- EACH PLUG CUTOUT CABINET SHALL BE FURNISHED WITH A PHENOLIC ENGRAVED LEGEND PLATE THAT IDENTIFIES THE RESPECTIVE RUNWAY OR TAXIWAY CIRCUIT OR REGULATOR. INCLUDE AN ADDITIONAL LEGEND PLATE LABELED "CAUTION OPERATE CUTOUTS WITH CCR SHUT OFF".
- PROVIDE PHENOLIC ENGRAVED LEGEND PLATES FOR THE CUTOUTS TO IDENTIFY THE RESPECTIVE REGULATOR OUTPUT CONNECTION AND THE RESPECTIVE CIRCUIT LOAD CONNECTION.
- BOND REGULATOR FRAME TO VAULT GROUND BUS WITH A DEDICATED #6 AWG BONDING JUMPER.
- PROVIDE ADEQUATE WORKING SPACE IN FRONT OF EACH CUTOUT ENCLOSURE TO MEET NEC CLEARANCE REQUIREMENTS.
- LIQUID TIGHT FLEXIBLE METAL CONDUIT AND ASSOCIATED FITTINGS SHALL BE U.L. LISTED TO MEET THE REQUIREMENTS OF NEC 350.6, SUITABLE FOR GROUNDING AND SUNLIGHT RESISTANT. LIQUID TIGHT FLEXIBLE METAL CONDUIT THAT IS USED FOR FLEXIBILITY (INCLUDING CONNECTIONS TO CCR'S & TRANSFORMERS) SHALL REQUIRE AN EXTERNAL BONDING JUMPER OR INTERNAL EQUIPMENT GROUNDING CONDUCTOR PER NEC 350.60. EXTERNAL BONDING JUMPERS USED WITH CCR INSTALLATIONS SHALL BE #6 AWG COPPER (MINIMUM). DO NOT INSTALL LIQUID TIGHT FLEXIBLE METAL CONDUIT THAT IS NOT UL LISTED. CONFIRM LIQUID TIGHT FLEXIBLE METAL CONDUIT BEARS THE UL LABEL PRIOR TO
- SERIES PLUG CUTOUTS SHALL BE TYPE S-1, RATED 5000 VOLTS, 20-AMP, AND SHALL COMPLY WITH FAA AC 150/5340-4C. SERIES PLUG CUTOUTS SHALL BE RATED SUITABLE FOR NORMAL OPERATION WITH HANDLE REMOVED OR HANDLE INSERTED. CUTOUTS SHALL DISCONNECT THE INPUT FROM THE FROM THE OUTPUT, SHORT THE INPUT TERMINALS, AND SHORT THE OUTPUT TERMINALS WHEN THE HANDLE/PLUG IS REMOVED. SERIES PLUG CUTOUTS SHALL BE CROUSÉ-HINDS CAT. NO. 30775, OR APPROVED EQUAL. THE RESPECTIVE MANUFACTURER SHALL CERTIFY IN WRITING THAT THEIR CUTOUT IS SUITABLE AND RATED FOR THE RESPECTIVE APPLICATION.
- HIGH VOLTAGE WIRING SHALL ENTER EACH RESPECTIVE REGULATOR AT THE HIGH-VOLTAGE/SERIES CIRCUIT OUTPUT SECTION OF THE
- DUE TO THE PHYSICAL DIMENSIONS OF THE NEW REGULATORS, SOME UNITS WILL REQUIRE RELOCATION IN THE VAULT TO AN AREA WITH ADEQUATE FLOOR SPACE
- SPLICES FOR RUNWAY AND TAXIWAY SERIES CIRCUITS SHALL BE FAA APPROVED TYPE L-823 CONNECTORS AND SHALL BE INSTALLED IN HIGH VOLTAGE HANDHOLES, HIGH VOLTAGE MANHOLES, SPLICE CANS OR HIGH VOLTAGE ENCLOSURES.
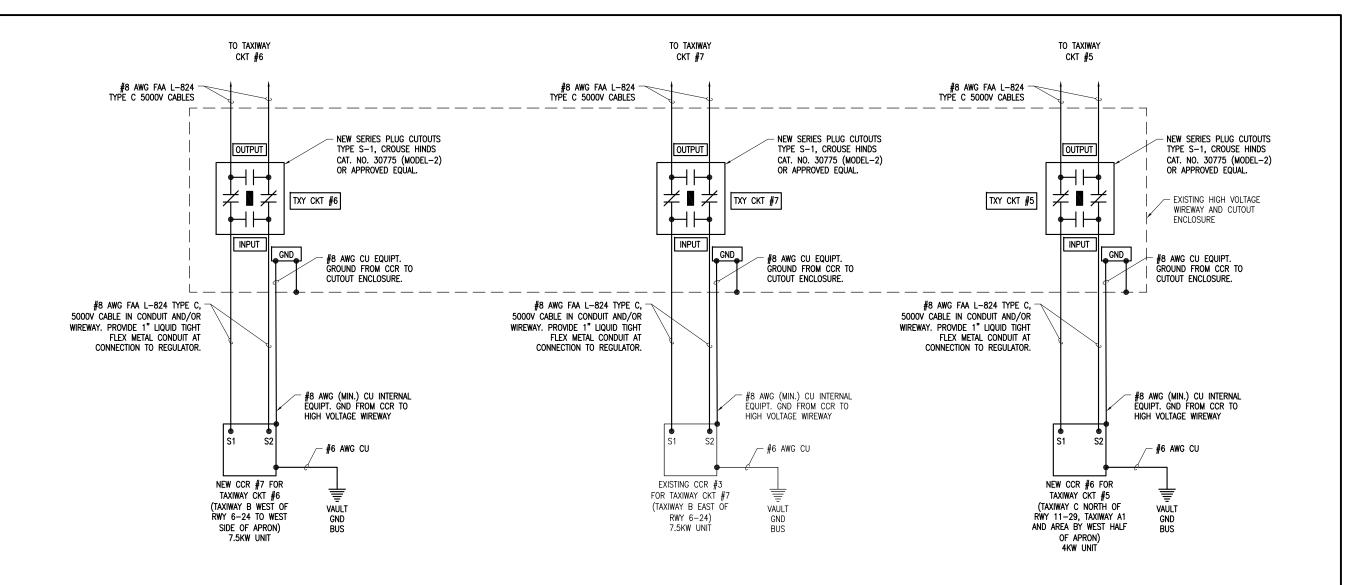
# LEGEND

- DENOTES PLUG CUTOUT WITH PLUG PULLED

"CCR" DENOTES CONSTANT CURRENT REGULATOR



DENOTES PLUG CUTOUT WITH PLUG INSERTED

DRAWN BY: RAD 02/19/2015 REVIEWED BY: KNL 03/08/2016

SHEET TITLE

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REMOVE AND

THE AIRPORT

IDA No: MTO-4511

SBG Project No: 3-17-SBGP-XX Contract No. CO062

REPLACE ALL TAXI

**GUIDANCE SIGNS ON** 

#184-001084

Hanson Professional Services Inc.

Professional Service Corporation

**COLES COUNTY AIRPORT** 

AUTHORITY

PROPOSED HIGH **VOLTAGE WIRING** 

SCHEMATIC FOR TAXIWAY CKTS

5, 6, & 7

PROPOSED HIGH VOLTAGE WIRING SCHEMATIC FOR TAXIWAY CKTS 5, 6, & 7

DESCRIPTION

DES DWN REV

1. THE EXISTING RELAY INTERFACE PANEL NAMEPLATE DATA IS AS FOLLOWS:

PRECISION CONTROL SYSTEMS OF INDIANAPOLIS 7225 GIRL SCHOOL AV. INDIANAPOLIS, IN 46241, RUNWAY RELAY INTERFACE PANEL MODEL: P15016, TAG: RRIP, 120 VOLTS, 60HZ, 1 PHASE.

 IN THE AUTOMATIC MODE OF OPERATION THE RUNWAY 11-29 CONSTANT CURRENT REGULATORS (PRIMARY UNIT & SPARE UNIT) IS CONTROLLED BY THE PHOTOCELL & THE L-854 RADIO CONTROL UNIT IN THE FOLLOWING MANNER:

PHOTOCELL - B3-5% BRIGHTNESS AND ACTIVATE RADIO CONTROL

3 CLICKS - B3-5% BRIGHTNESS
5 CLICKS - B4-20% BRIGHTNESS

7 CLICKS - B5-100% BRIGHTNESS

 IN THE AUTOMATIC MODE OF OPERATION THE RUNWAY 6-24 CIRCUIT IS CONTROLLED BY THE PHOTOCELL & THE L-854 RADIO CONTROL UNIT IN THE FOLLOWING MANNER:

PHOTOCELL -ACTIVATE RADIO CONTROL

3 CLICKS -10% BRIGHTNESS

5 CLICKS -30% BRIGHTNESS 7 CLICKS -100% BRIGHTNESS

7 CLICKS -100% BRIGHTNESS

4. THE RUNWAY 11 PAPI CIRCUIT IS CONTROLLED IN THE AUTOMATIC MODE BY THE L-854 RADIO CONTROL UNIT IN THE FOLLOWING MANNER.

3 CLICKS - ON

5 CLICKS - REMAIN ON

7 CLICKS - REMAIN ON

 THE RUNWAY 11, 6 AND 24 REIL CIRCUITS ARE CONTROLLED IN THE AUTOMATIC MODE BY THE PHOTOCELL & THE L-854 RADIO CONTROL UNIT IN THE FOLLOWING MANNER.

PHOTOCELL ACTIVATION ENABLES RADIO CONTROL

3 CLICKS - OFF 5 CLICKS - OFF

7 CLICKS - ON

 THE RADIO OVERRIDE SWITCH WILL ACTIVATE L-854 RADIO CONTROL 24 HOURS PER DAY IN THE "RADIO ON" POSITION. THE PHOTOCELL WILL ACTIVATE RADIO CONTROL IN THE "PHOTOCELL ACTIVATE RADIO" POSITION.

 IN THE AUTOMATIC MODE OF OPERATION THE AIRPORT ROTATING BEACON WIND TEE, WIND CONE, APRON LIGHTING, PARKING LOT LIGHTING, ENTRANCE ROAD LIGHTING, AND OBSTRUCTION LIGHTING ARE ACTIVATED BY THE PHOTOCELL OR PHOTOCELL BYPASS SWITCH.

 EXTERNAL CONTROL CABLE SHALL BE NO. 12 AWG COPPER 600 VOLT CONDUCTOR. EQUIPMENT GROUND WIRES SHALL BE INCLUDED WITH EACH BRANCH CIPCLIT & FACUL CONTROL CIPCLIT

9. COLOR CODING FOR THE CONTROL WIRING TO EACH CONSTANT CURRENT REGULATOR SHALL BE CONSISTENT FOR ALL REGULATORS. COLOR CODING SHALL BE AS FOLLOWS:

CC —RED
10% OR B3 —ORANGE
30% OR B4 —YELLOW

30% OR B4 — YELLOW 100% OR B5 — BLUE NEUTRAL — WHITE EQUIPT, GND — GREEN

ALSO TAG THE CONTROL WIRES WITH THE RESPECTIVE DESIGNATION (CC, 10%, 30%, 100%)

10. "N" DESIGNATES NEUTRAL CONNECTION OR NEUTRAL CONDUCTOR.

11. RUNWAY 6-24 CCR SHALL BE REPLACED WITH A NEW UNIT. FURNISH AND INSTALL CONTROL WIRING TO INTERFACE THE NEW CCR TO THE EXISTING RUNWAY BELAY INTERFACE PANEL.

HANSON Engineering | Plenning | Alled Services

Offices Nationwide

Hanson Professional Services Inc. 1525 S. 6th Street Springfield, IL 62568 phone: 217-788-2450 fax: 217-788-2503

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COLES COUNTY AIRPORT
AUTHORITY
COLES COURTY MEMORIAL AIRPORT

REMOVE AND REPLACE ALL TAXI GUIDANCE SIGNS ON THE AIRPORT

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DESIGN BY: KNL 02/05/2016

DRAWN BY: RAD 02/19/2016

REVIEWED BY: KNL 03/08/2016

SHEET TITLE

AIRFIELD LIGHTING CONTROL WIRING SCHEMATIC FOR RUNWAYS

AIRFIELD LIGHTING CONTROL WIRING SCHEMATIC FOR RUNWAYS & NAVAIDS

7 CLICKS

 THE EXISTING TAXIWAY RELAY INTERFACE PANEL NAMEPLATE DATA IS AS FOLLOWS: PRECISION CONTROL SYSTEMS OF INDIANAPOLIS, 7725 GIRL SCHOOL AV., INDIANAPOLIS IN 46241, TAXIWAY RELAY INTERFACE PANEL MODEL: P15016, TAG: TRIP, 120 VOLTS. 60HZ. 1 PHASE

2. IN THE AUTOMATIC MODE OF OPERATION THE TAXIWAY CCR'S ARE CONTROLLED BY THE PHOTOCELL & THE L-854 RADIO CONTROL UNIT IN THE FOLLOWING MANNER: PHOTOCELL -ACTIVATE RADIO CONTROL

PHOTOCELL -ACTIVATE RADIO CONTR
3 CLICKS -10% BRIGHTNESS
5 CLICKS -30% BRIGHTNESS

-100% BRIGHTNESS

 THE RADIO OVERRIDE SWITCH WILL ACTIVATE L-854 RADIO CONTROL 24 HOURS PER DAY IN THE "RADIO ON" POSITION. THE PHOTOCELL WILL ACTIVATE RADIO CONTROL IN THE "PHOTOCELL ACTIVATE RADIO" POSITION.

 EXTERNAL CONTROL CABLE SHALL BE NO. 12 AWG COPPER, 600 VOLT CABLE. EQUIPMENT GROUND WIRES SHALL BE INCLUDED WITH EACH BRANCH CIRCUIT & EACH CONTROL CIRCUIT.

 COLOR CODING FOR THE CONTROL WIRING TO EACH CONSTANT CURRENT REGULATOR SHALL BE CONSISTENT FOR ALL REGULATORS. COLOR CODING SHALL BE AS FOLLOWS:

CC -RED
10% -ORANGE
30% -YELLOW
100% -BLUE
NEUTRAL -WHITE
EQUIPT. GND -GREEN

ALSO TAG THE CONTROL WIRES WITH THE RESPECTIVE DESIGNATION (CC, 10%, 30%, 100%)

6. "N" DESIGNATES NEUTRAL CONNECTION OR NEUTRAL CONDUCTOR.

7. THE RESPECTIVE TAXIWAY CONSTANT CURRENT REGULATORS DESIGNATED FOR REPLACEMENT WILL REQUIRE NEW CONTROL WIRING AND/OR INTERFACE TO EXISTING CONTROL WIRING, FURNISH AND INSTALL CONTROL WIRING TO INTERFACE EACH TAXIWAY CCR TO THE EXISTING TAXIWAY RELAY INTERFACE CONTROL PANEL.

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Offices Nationwide www.hanson-inc.com

Hanson Professional Services Inc. 1525 S. 6th Street Springfield, IL 62568 phone: 217-788-2450 fax: 217-788-2503

Illinois Licensed Professional Service Corporation #184-001084

COLES COUNTY AIRPORT


AUTHORITY

COLES COMMY MEMORIAL AIRPORT

REMOVE AND REPLACE ALL TAXI GUIDANCE SIGNS ON THE AIRPORT

IDA No: MTO-4511 SBG Project No: 3-17-SBGP-XX

Contract No. CO062

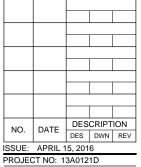

CAD FILE: E-609.DWG

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SHEET TITLE

AIRFIELD LIGHTING CONTROL WIRING SCHEMATIC FOR TAXIWAYS

LEGEND PLA	TE SCHEDULE
CCR #1 FOR RUNWAY 11-29	CCR #1 RUNWAY 11-29
CIRCUIT BREAKER FOR CCR #1 FOR RUNWAY 11-29	CCR #1 RUNWAY 11-29
CUTOUT FOR CCR #1 FOR RUNWAY 11-29	CCR #1 RUNWAY 11-29
BACKUP CCR FOR RUNWAY 11-29	BACKUP CCR FOR RUNWAY 11-29
CIRCUIT BREAKER FOR BACKUP CCR FOR RUNWAY 11-29	BACKUP CCR FOR RUNWAY 11-29
CUTOUT FOR BACKUP CCR FOR RUNWAY 11-29	BACKUP CCR FOR RUNWAY 11-29
CCR #2 FOR RUNWAY 6-24	CCR #2 RUNWAY 6-24
CCR #2 FOR RUNWAY 6-24	CCR #2 RUNWAY 6-24
CUTOUT FOR CCR #2 FOR RUNWAY 6-24	CCR #2 RUNWAY 6-24
CCR #3	CCR #3 TAXIWAY CKT 7 TXY B-EAST
CIRCUIT BREAKER FOR CCR #3	CCR #3 TAXIWAY CKT 7 TXY B-EAST
CUTOUT FOR CCR #3	CCR #3 TAXIWAY CKT 7 TXY B-EAST
CCR #4	CCR #4 TAXIWAY CKTS 1 AND 4 CKT 1;TXY C-SOUTH CKT 4; TXY B-WEST OF APRON
CIRCUIT BREAKER FOR CCR #4	CCR #4 TAXIWAY CKTS 1 AND 4 CKT 1;TXY C-SOUTH CKT 4; TXY B-WEST OF APRON
CUTOUT ENCLOSURE FOR CCR #4	CCR #4 TAXIWAY CKTS 1 AND 4 CKT 1;TXY C-SOUTH CKT 4; TXY B-WEST OF APRON
CUTOUT FOR TAXIWAY CKT 1	TXY CKT 1 TXY C-SOUTH
CUTOUT FOR TAXIWAY CKT 4	TXY CKT 4 TXY B-WEST OF APRON
CCR #5	CCR #5 TAXIWAY CKTS 3 AND 3A CKT 3; APRON, TXY A-EAST, D3, D CKT 3A; TAXIWAY D-EAST
CIRCUIT BREAKER FOR CCR #5	CCR #5 TAXIWAY CKTS 3 AND 3A CKT 3; APRON, TXY A-EAST, D3, D CKT 3A; TAXIWAY D-EAST
CUTOUT ENCLOSURE FOR CCR #5	CCR #5 TAXIWAY CKTS 3 AND 3A CKT 3; APRON, TXY A-EAST, D3, D CKT 3A; TAXIWAY D-EAST
CUTOUT FOR TAXIWAY CKT 3	TXY CKT 3 APRON, TXY A-EAST, D3, D
CUTOUT FOR TAXIWAY CKT 3A	TXY CKT 3A TAXIWAY D-EAST

CCR #6	CCR #6
SCR #0	TAXIWAY CKT 5 TXY C-NORTH, WEST APRON, TXY A1
CIRCUIT BREAKER FOR CCR #6	CCR #6 TAXIWAY CKT 5 TXY C-NORTH, WEST APRON, TXY A1
CUTOUT FOR CCR #6	CCR #6 TAXIWAY CKT 5 TXY C-NORTH, WEST APRON, TXY A1
CCR #7	CCR #7 TAXIWAY CKT 6 TXY B-WEST
CIRCUIT BREAKER CCR #7	CCR #7 TAXIWAY CKT 6 TXY B-WEST
CUTOUT FOR CCR #7	CCR #7 TAXIWAY CKT 6 TXY B-WEST
CCR #8	CCR #8 TAXIWAY CKT 2 TAXIWAY A-WEST
CIRCUIT BREAKER CCR #8	CCR #8 TAXIWAY CKT 2 TAXIWAY A-WEST
CUTOUT ENCLOSURE FOR CCR #8	CCR #8 TAXIWAY CKT 2 TAXIWAY A-WEST
CUTOUT FOR CCR #8	CCR #8 TAXIWAY CKT 2 TAXIWAY A-WEST
EACH CUTOUT ENCLOSURE (PROVIDE 6 LEGEND PLATES)	CAUTION OPERATE CUTOUTS WITH CCR SHUT OFF
EACH CUTOUT INPUT SIDE CONNECTION (PROVIDE 11 LEGEND PLATES)	INPUT
EACH CUTOUT OUTPUT SIDE CONNECTION PROVIDE 11 LEGEND PLATES)	OUTPUT

- 1. LEGEND PLATES SHALL BE WEATHERPROOF ENGRAVED PLASTIC OR PHENOLIC MATERIAL, 1/4" HIGH WHITE LETTERS ON A RED BACKGROUND UNLESS NOTED OTHERWISE. SECURE WITH WEATHERPROOF ADHESIVE AND MACHINE SCREWS. FURNISH ADDITIONAL LEGEND PLATES WHERE REQUIRED BY CODE, FOR ADDITIONAL EQUIPMENT, AS DETAILED HEREIN ON THE PLANS, AND AS NOTED IN THE SPECIAL PROVISION SPECIFICATIONS.
- FURNISH & INSTALL A WEATHERPROOF WARNING LABEL FOR EACH SAFETY SWITCH, PANELBOARD, LOAD CENTER, CUTOUT, & CONTROL PANEL TO WARN PERSONS OF POTENTIAL ELECTRIC ARC FLASH HAZARDS, PER THE REQUIREMENTS OF NEC 110.16 "ARC-FLASH HAZARD WARNING". LABELS SHALL BE HAZARD COMMUNICATION SYSTEMS, LLC (190 OLD MILFORD RD., BOX 1174, MILFORD, PA 18337, PHONE: 1-877-748-0244) PART NO. H6010-9VWHBJ OR APPROVED
- 3. ALL POWER AND CONTROL CABLES IN HANDHOLES, MANHOLES, AND JUNCTION BOXES SHALL BE TAGGED TO IDENTIFY THE RESPECTIVE CABLE. A MINIMUM OF TWO TAGS SHALL BE PROVIDED ON EACH CABLE IN A MANHOLE; ONE AT THE CABLE ENTRANCE AND ONE AT THE CABLE EXIT. CABLE TAGS SHALL BE STAMPED BRASS TAGS OR OTHER WEATHERPROOF/WATERPROOF CORROSION RESISTANT MATERIAL.



"DANGER - HIGH VOLTAGE KEEP OUT" LABEL

FURNISH AND INSTALL "DANGER - HIGH VOLTAGE KEEP OUT" LABELS/SIGNS FOR EACH CUTOUT ENCLOSURE, EACH CONSTANT CURRENT REGULATOR, AND THE HIGH VOLTAGE WIREWAY, TO COMPLY WITH FAA AC 150/5340-26B "MAINTENANCE OF AIRPORT VISUAL AID FACILITIES" AND 2014 NEC ARTICLE 300.45 "WARNING SIGNS". LABELS SHALL BE APPROXIMATELY 4" x 6"



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COLES COUNTY AIRPORT AUTHORITY

REMOVE AND REPLACE ALL TAXI **GUIDANCE SIGNS ON** THE AIRPORT

IDA No: MTO-4511 SBG Project No: 3-17-SBGP-XX

Contract No. CO062

NO.	DATE	DESCRIPTION		
INO.		DES	DWN	REV
ISSUE: APRIL 15, 2016				
DDO IECT NO: 13A0121D				

CAD FILE: E-610-SCHD.DWG

DESIGN BY: KNL 02/19/2016 DRAWN BY: RAD 02/22/2016 REVIEWED BY: KNL 03/08/2016

SHEET TITLE

LEGEND PLATES **SCHEDULES**