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STATE OF ILLINOIS

DEPARTMENT OF TRANSPORTATION

SECTION 2020-049-RS&SW COOK 27 1 ILLINOIS | CONTRACT NO. 62L21

D-91-432-20


PROPOSED HIGHWAY PLANS

F.A.U. ROUTE 3727: DEMPSTER ST. RIDGE AVE. TO CHICAGO AVE.

SECTION: 2020–049–RS&SW PROJECT: STP-K3FT(553)

STANDARD OVERLAY, ADA IMPROVEMENTS

COOK COUNTY C-91-239-20

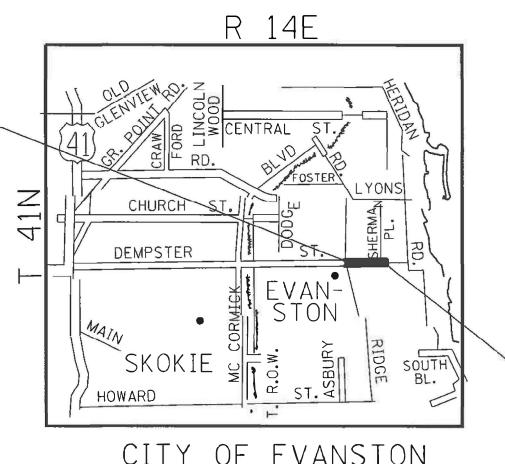

PROJECT ENDS:

STA. 39+88.20

PRINTED BY THE AUTHORITY OF THE STATE OF ILLINOIS

DEPARTMENT OF TRANSPORTATION

LOCATION OF SECTION INDICATED THUS:-

GROSS LENGTH = 2061.4 FT. = 0.39 MILE NET LENGTH = 2061.4 FT. = 0.39 MILE

FOR INDEX OF SHEETS, SEE SHEET NO. 2

PROJECT IS LOCATED IN THE CITY OF

POSTED SPEED LIMIT: 25 MPH

BEGIN PROJECT: STA. 19+26.82

ENGINEERING SCALES. REDUCED SIZED PLANS WILL NOT CONFORM TO STANDARD SCALES, IN MAKING MEASUREMENTS ON REDUCED PLANS, THE ABOVE SCALES MAY BE USED.

JOINT UTILITY LOCATION INFORMATION FOR EXCAVATION 1-800-892-0123

PROJECT ENGINEER: DANIEL WILGREEN (847)-705-4240 PROJECT MANAGER: FAWAD AQUEEL (847)-705-4247

CONTRACT NO. 62L21


REV-SEP


INDEX OF S	SHEETS	GENERAL	<u>NOTES</u>	GENERAL	NOTES (CONTINUED)
SHEET NO.	DESCRIPTION	NOTE NO.	DESCRIPTION	NOTE NO.	DESCRIPTION
1 2 3-5	COVER SHEET INDEX OF SHEETS, LIST OF STATE STANDARDS AND GENERAL NOTES SUMMARY OF QUANTITIES	1	BEFORE STARTING ANY EXCAVATION, THE CONTRACTOR SHALL CALL "JULIE" (JOINT UTILITY LOCATION INFORMATION FOR EXCAVATION AT 8-1-1 OR (800) 892-0123 FOR FIELD LOCATION OF BURIED ELECTRIC, TELEPHONE, AND GAS FACILITIES (48 HOUR NOTIFICATION IS REQUIRED).	18	THE LOCATION OF EXISTING DRAINAGE STRUCTURES, STORM SEWERS, WATER MAINS, SANITARY SEWERS, AND ANY OTHER PUBLIC OR PRIVATE UTILITIES AS SHOWN ON THE PLANS IS APPROXIMATE AND THEIR EXACT LOCATION IS TO BE DETERMINED IN THE FIELD BY THE CONTRACTOR.
6-10 11-12 13-16	TYPICAL SECTIONS PLAN AND PROFILE SHEETS SIDEWALK AND RAMP DETAILS	2	THE CONTRACTOR SHALL COORDINATE CONSTRUCTION ACTIVITIES WITH UTILITY COMPANIES ALL MUNICIPALITIES WITHIN THE PROJECT LIMITS	19	THE CONTRACTOR SHALL BE RESPONSIBLE FOR THE PROTECTION OF ALL UNDERGROUND AND SURFACE UTILITIES EVEN THOUGH THEY MIGHT NOT BE SHOWN ON THE PLANS IS APPROXIMATE AND THEIR EXACT LOCATION IS TO BE DETERMINED IN THE FIELD BY THE CONTRACTOR.
17 18 19	ADA RAMPS I PROJECT DETAIL FOR DOUBLE PERPENDICULAR CURB RAMPS (PD-03)] DETAILS FOR FRAMES AND LIDS ADJUSTMENT WITH MILLING (BD-8) PAVEMENT PATCHING FOR HMA SURFACE PAVEMENT (BD-22)	3	IN VARIOUS LOCATIONS THROUGHOUT THE PROJECT, EXISTING ASPHALT OVERLAYS THE EXISTING CONCRETE GUTTER FLAG. REMOVAL OF ASPHALT ON THE GUTTER FLAG SHALL BE INCLUDED IN THE UNIT COST OF HOT-MIX ASPHALT SURFACE REMOVAL, 2.5 INCH.	20	ANY LOOSE MATERIAL DEPOSITED IN THE FLOW LINE OF DRAINAGE STRUCTURES, WHICH OBSTRUCTS THE NATURAL FLOW OF WATER SHALL BE REMOVED AT THE CLOSE OF EACH WORKING DAY. PRIOR TO ACCEPTANCE OF THE IMPROVEMENT. ALL DRAINAGE STRUCTURES SHALL BE FREE OF DIRT AND DEBRIS. THIS WILL NOT BE PAID FOR SEPARATELY, BUT SHALL BE CONSIDERED AS INCLUDED IN THE UNIT BID PRICES OF THE
20 21	CURB OR CURB AND GUTTER REMOVAL AND REPLACEMENT (BD-24) BUTT JOINT AND HMA TAPER DETAILS (BD-32)	4 5	THE CONTRACTOR WILL NOT BE ALLOWED TO SET UP A YARD OR FIELD OFFICE ON STATE PROPERTY WITHOUT WRITTEN PERMISSION FROM THE DEPARTMENT.	21	CONTINUE
22	TRAFFIC CONTROL AND PROTECTION FOR SIDE ROADS, INTERSECTIONS, AND DRIVEWAYS (TC-10) TYPICAL APPLICATIONS RAISED REFLECTIVE PAVEMENT MARKERS (SNOW-PLOW RESISTANT) (TC-11)		SAW CUTTING OF PAVEMENTS, SIDEWALK, CURB & GUTTER, ETC. SHALL BE TO FULL DEPTH AND SHALL RESULT IN A CLEAN STRAIGHT EDGE ON THE PORTION REMAINING. ALL SAW CUTTING SHALL BE CONSIDERED INCLUDED IN THE COST OF THE ITEM REMOVED	21	EXISTING BROKEN FRAMES AND LIDS SHALL BE REMOVED AND DISPOSED OF BY THE CONTRACTOR AND SHALL BE REPLACED AS DIRECTED BY THE ENGINEER. REPLACEMENT FRAMES AND LIDS WILL BE PAID FOR ACCORDING TO ARTICLE 109.04 OF THE STANDARD SPECIFICATIONS UNLESS A SEPARATE PAY ITEM HAS BEEN PROVIDED.
24 25	DISTRICT ONE TYPICAL PAVEMENT MARKINGS (TC-13) TRAFFIC CONTROL AND PROTECTION AT TURN BAYS (TO REMAIN OPEN TO TRAFFIC) (TC-14)	6 7	DO NOT SCALE PLANS FOR CONSTRUCTION DIMENSIONS THE CONTRACTOR SHALL USE CARE IN REMOVING OR EXCAVATING NEAR ALL EXISTING ITEMS WHICH WILL REMAIN. ANY DAMAGE DONE TO EXISTING ITEMS BY THE CONTRACTOR SHALL BE REPAIRED AT THE	22	LOCATION OF COMBINATION CONCRETE CURB AND GUTTER REMOVAL AND REPLACEMENT OR COMBINATION CURB AND GUTTER (THE TYPE SPECIFIED IN THE PLANS), WILL BE DETERMINED IN THE FIELD BY THE ENGINEER
26 27	SHORT TERM PAVEMENT MARKING LETTER AND SYMBOLS (TC-16) ARTERIAL ROAD INFORMATION SIGN (TC-22)	8	THE CONTRACTOR SHALL BE REPAIRED AT THE CONTRACTOR'S EXPENSE. WHEN MILLED PAVEMENT IS OPEN TO TRAFFIC, THE MAXIMUM GRADE DIFFERENTIAL, BETWEEN PASSES OF THE MILLING MACHINE SHALL NOT EXCEED 1.5 INCHES WHERE THE SPEED LIMIT IS 40 MPH OR LESS. WITH WRITTEN APPROVAL FROM THE ENGINEER, A MAXIMUM GRAD DIFFERENTIAL OF 3 INCHES MAY BE ALLOWED IF THE EDGE OF MILLING IS SLOPED A MINIMUM OF 1:3 (V:H)	23 24	ALL PAVEMENT PATCHING LOCATIONS WILL BE DETERIMNED IN THE FIELD BY THE ENGINEER IT SHALL BE THE CONTRACTOR'S RESPONSIBILITY TO VERIFY ALL DIMENSIONS AND CONDITIONS EXISTING IN THE FIELD PRIOR TO CONSTRUCTION AND ORDERING OF MATERIALS
STATE STA	ANDARDS DESCRIPTION	9	UNLESS OTHER CONDITIONS WARRANT EXTENDED LANE CLOSURES AS DETERMINED AND APPROVED IN WRITING BY THE ENGINEER OR AS PROVIDED FOR IN THE CONTRACT SPECIFICATIONS, OVERNIGHT CLOSURES SHALL NOT BE ALLOWED FOR REHABILITATION PROJECTS INVOLVING DAYTIME MILLING AND RESURFACING OPERATIONS AND CLASS D PATCHING.	25 26 27	DRAINAGE ADJUSTMENT OR RECONSTRUCTION LOCATIONS WILL BE DETERMINED IN THE FIELD BY THE ENGINEER. FRAMES AND GRATES ADJUSTMENT OF PRIVATE UTILITIES WITHIN THE LIMITS OF THE IMPROVEMENTS SHALL BE DONE BY THEIR RESPECTIVE OWNERS AND ARE NOT PART OF THIS CONTRACT SIDEWALK REMOVAL AND PCC SIDEWALK 5" NAMED
000001-08 424001-11 442201-03 604001-05	STANDARD SYMBOLS, ABBREVIATIONS AND PATTERNS PERPENDICULAR CURB RAMPS CLASS C & D PATCHES FRAMES AND LIDS TYPE 1	10	BEFORE BEGINNING ANY WORK. THE CONTRACTOR SHALL RETAIN AND RECORD FOR FUTURE REFERENCE ALL EXISTING PAVEMENT MARKING LINES AND RAISED REFLECTIVE PAVEMENT MARKERS IN ORDER THAT THESE LOCATIONS CAN BE REESTABLISHED FOR STRIPING. EXACT LOCATIONS OF ALL PAVEMENT MARKING SHALL BE AS DIRECTED BY THE ENGINEER.	28	LOCATIONS SHALL BE DETERMINED BY THE ENGINEER ALL RAISED REFLECTIVE MAKERS SHALL BE INSTALLED ACCORDING TO IDOT DISTRICT ONE DETAIL TC-11 ALL PAYEMENT MARKINGS SHALL BE INSTALLED ACCORDING TO IDOT DISTRICT ONE DETAIL TC-13
606001-07 701006-05 701011-04	COMBINATION CURB AND GUTTER OFF ROAD OPERATIONS, 2L, 2W, 15' TO 24" FROM PAVEMENT EDGE OFF ROAD OPERATIONS, 2L, 2W, DAY ONLY	11	PAVEMENT MARKING TAPE, TYPE III SHALL BE USED FOR SHORT TERM PAVEMENT MARKINGS ON ALL FINAL SURFACES.	30	ACCORDING TO IDOT DISTRICT ONE DETAIL TC-13 ALL SIDEWALK RAMP SHALL CONFORM TO CURRENT ADA REQUIREMENTS AND APPLICABLE STATE HIGHWAY STANDARDS OR AS DETERMINED BY THE ENGINEER
701101-05 701301-04 701311-03	OFF ROAD OPERATIONS, MULTILANE, LESS THAN 15 FT TO EDGE OF PAVEMENT LANE CLOSURE, 2L, 2W, SHORT-TIME OPERATIONS LANE CLOSURE, 2L, 2W, MOVING OPERATIONS - DAY ONLY	12	THE CONTRACTOR SHALL CONTACT THE TRAFFIC CONTROL SUPERVISOR AT KALPANA, KANNAN-HOSADURGA@ILLINOIS.GOV. A MINIMUM OF 72 HOURS PRIOR TO BEGINNING WORK. THE RESIDENT ENGINEER SHALL CONTACT THE AREA TRAFFIC FIELD ENGINEER, MATTHEW THOMAS AT MATTHEW.THOMAS@ILLINOIS.GOV AT LEAST TWO (2) WEEKS	31	CONTRACTORS SHALL EXERCISE CAUTION WHEN MILLING AND RESURFACING UNDER THE VIADUCT DUE TO THE LOW STANDARD VERTICAL CLEARANCE.
701427-05 701501-06 701502-09 701606-10	LANE CLOSURE, MULTILANE, INTERMITTENT OR MOVING OPERATION FOR SPEED <=40 MPH. URBAN LANE CLOSURE, 2L, 2W, UNDIVIDED URBAN LANE CLOSURE, 2L, 2W, WITH BIDIRECTIONAL LEFT TURN LANE URBAN SINGLE LANE CLOSURE, MULTILANE, 2W, WITH MOUNTABLE MEDIAN	14	PRIOR TO THE PLACEMENT OF PERMANENT PAVEMENT MARKINGS. BUTT JOINTS WILL BE INSTALLED AT THE END OF ALL RESURFACING (WHERE RESURFACING MEETS EXISTING PAVEMENT), IN ACCORDANCE THE "BUTT JOINT AND HMA TAPER DETAILS" INCLUDED IN THE PLANS, UNLESS OTHERWISE SPECIFIED		
701611-01 701701-10 701801-06	URBAN HALF ROAD CLOSURE, MULTILANE, 2W, WITH MOUNTABLE MEDIAN URBAN LANE CLOSURE, MULTILANE INTERSECTION SIDEWALK CORNER OR CROSSWALK CLOSURE	15 16	MATCH EXISTING PAVEMENT AT THE PROJECT LIMITS. ALL DAMAGE TO EXISTING PAVEMENT MARKINGS OR RAISED REFLECTIVE MARKERS OUTSIDE THE REMOVAL LINE SHOWN ON THE PLANS SHALL BE REPLACED AT THE CONTRACTORS EXPE	NSE.	
701901-08 780001-05 781001-04	TRAFFIC CONTROL DEVICES TYPICAL PAVEMENT MARKINGS TYPICAL APPLICATION RAISED REFLECTIVE PAVEMENT MARKERS	17	THE CONTRACTOR SHALL BE RESPONSIBLE FOR CONTACTING OWNERS OF ALL UTILITIES PRIOR TO CONSTRUCTION TO DETERMINE THE LOCATION OF ALL UTILITY EQUIPMENT. THE CONTRACTOR SHALL COOPERATE WITH ALL UTILITY OWNERS IN ACCORDANCE WITH THE STANDARD SPECIFICATIONS IF UTILITY RELOCATION, ADJUSTMENT, OR PROTECTION IS NECESSARY		
					REV-SE
iLE NAME = v:\\planroom.dot.illinois.gov:PV afault	USER NAME		STATE OF ILLINOIS	DEX OF SHEETS, STATE S	F.A.U SECTION COUNTY TOTAL SHEET NO.

SUMMARY OF QU	IIANTITIES				CONSTRU	JCTION T	YPE CODE			STIMMA	ARY OF OUANTITIES				CONSTRU	JCTION TY	PE CODE	
301-11-11-11-11	OANTITIES .		TOTAL	0005	0005					3011111/	The state of the s		TOTAL	0005	0005			
CODE NO	ITEM	UNIT	QUANTITIES URBAN	80% FEDERAL 20% STATE	100% STATE				CODE NO		1 TEM	UNIT	QUANTITIES URBAN	80% FEDERAL 20% STATE	100% STATE			
20200100 EARTH EXCAVATION		CU YD	35	35					44201705	CLASS D PATCHES	S, TYPE II, 5 INCH	SQ YD	58	58				
21101615 TOPSOIL FURNISH AND PLACE,	4"	SQ YD	200	200					44201709	CLASS D PATCHES	S, TYPE III, 5 INCH	SQ YD	184	184				
25200110 SODDING, SALT TOLERANT		SQ YD	200	200					44201711	CLASS D PATCHES	S, TYPE IV, 5 INCH	SQ YD	407	407				
40600290 BITUMINOUS MATERIALS (TACK	(COAT)	POUND	6068	6068					60252800	CATCH BASINS TO	BE RECONSTRUCTED	EACH	4	4				
40600400 MIXTURE FOR CRACKS, JOINTS	S AND ELANGEWAYS	TON	13	13					60262700	INLETS TO BE REC	CONSTRUCTED	EACH	2	2				
WINTOIN TON CIMONS, JUINTS	,, , , , , , , , , , , , , , , , , , ,	1014	10	13					00202700	INCLIS TO BE REC	SOLOTION	LAGII						
40600982 HOT-MIX ASPHALT SURFACE RI	EMOVAL - BUTT JOINT	SQ YD	306	306					60266600	VALVE BOXES TO	BE ADJUSTED	EACH	9	9				
40603200 POLYMERIZED HOT-MIX APSHA	LT BINDER COURSE,	TON	378	378					60300105	FRAMES AND GRA	TES TO BE ADJUSTED	EACH	6	6				
IL-4.75, N50																		
40604062 HOT MIX ASPHALT SURFACE CO	OUDGE MIX IDII II 0.5	TON	881	881					60300305	FRAMES AND LIDS	S TO BE ADJUSTED	EACH	13	13				
N70	SURSE, WIX D , IL-9.9,	TON	001	001					60406000	FRAMES AND LIDS	S, TYPE 1, OPEN LID	EACH	6	6				
42001300 PROTECTIVE COAT		SQ YD	695	695					60406100	FRAMES AND LIDS	S, TYPE 1, CLOSED LID	EACH	8	8				
42400200 PORTLAND CEMENT CONCRETI	E SIDEWALK E INCH	SQ FT	3160	3160					* 66900200	NON-SPECIAL WAS	STE DISDOSAL	CU YD	35	35				
42400200 PORTLAND CEMENT CONCRETE	E SIDEWALK 5 INCH	SQFI	3160	3160					86900200	NON-SPECIAL WAS	STE DISPOSAL	COTD	35	35				
42400800 DETECTABLE WARNINGS		SQ FT	224	224					* 66900530	SOIL DISPOSAL AN	VALYSIS	EACH	2	2				
44000159 HOT-MIX ASPHALT SURFACE RI	EMOVAL, 2 1/2"	SQ YD	8989	8989					* 66901001	REGULATED SUBS	STANCES PRE-CONSTRUCTION PLAN	LSUM	1	1				
44000600 SIDEWALK REMOVAL		SQ FT	3160	3160					* 66901003	REGULATED SUBS	STANCES FINAL CONSTRUCTION REPORT	LSUM	1	1				
44201701 CLASS D PATCHES, TYPE I, 5	INCH	SQ YD	47	47					* 66901006	REGULATED SUBS	STANCES MONITORING	CAL DA	10	10				
																*	SPECIALTY	ITEMS
USER NAME = PLOT SCALE = PLOT DATE =	DRAWN CHECKED		REVISED REVISED REVISED REVISED	-		[S DEPARTM	TATE OF I	LLINOIS RANSPORTA	TION	SUMMARY OF QUAR F.A.U 3727 / DEMPSTER ST. (RIDGE SCALE: NONE SHEET 1 OF 3 SHEETS	AVE CHIC	CAGO AVE.) TO STA	F.A.U. RTE. 3727	2020-049		COUNTY S COOK CONTRACT I	TOTAL SHEET SHEETS NO. 27 3

	SUMMARY OF QUANTITIES				CONSTRU	UCTION T	YPE CODE			SHMMA	RY OF QUANTITIES				CONSTRU	JCTION TY	PE CODE	
	SOMEWAY! OI QUARTITIES		TOTAL	0005	0005					30MMA	W. O. GOWILLITES		TOTAL	0005	0005			
CODE NO	ITEM	UNIT	QUANTITIES URBAN	80% FEDERAL 20% STATE	100% STATE				CODE NO		ITEM	UNIT	QUANTITIES	80% FEDERAL 20% STATE	100% STATE			
67000400	ENGINEER'S FIELD OFFICE, TYPE A	CAL MO	6	6					70300520	PAVEMENT MARKIN	NG TAPE, TYPE III 4"	FOOT	1758	1758				
67100100	MOBILIZATION	L SUM	1	1					* 78000100	THERMOPLASTIC F	PAVEMENT MARKING - LETTERS AND	SQ FT	73	73				
										SYMBOLS								
70102620	TRAFFIC CONTROL AND PROTECTION, STANDARD 701501	L SUM	1	1														
									* 78000200	THERMOPLASTIC F	PAVEMENT MARKING - LINE 4"	FOOT	2804	2804				
70102622	TRAFFIC CONTROL AND PROTECTION, STANDARD 701502	L SUM	1	1														
									* 78000400	THERMOPLASTIC F	PAVEMENT MARKING - LINE 6"	FOOT	1575	1575				
70102625	TRAFFIC CONTROL AND PROTECTION, STANDARD 701606	L SUM	1	1														
									* 78000600	THERMOPLASTIC F	PAVEMENT MARKING - LINE 12"	FOOT	42	42				
70102634	TRAFFIC CONTROL AND PROTECTION, STANDARD 701611	L SUM	1	1														
									* 78000650	THERMOPLASTIC F	PAVEMENT MARKING - LINE 24"	FOOT	1321	1321				
70102635	TRAFFIC CONTROL AND PROTECTION, STANDARD 701701	L SUM	1	1														
									* 78100100	RAISED REFLECTIV	/E PAVEMENT MARKER	EACH	58	58				
70102640	TRAFFIC CONTROL AND PROTECTION, STANDARD 701801	L SUM	1	1														
									78300200	RAISED REFLECTIV	/E PAVEMENT MARKER REMOVAL	EACH	42	42				
70300100	SHORT TERM PAVEMENT MARKING	FOOT	7032	7032														
7,000,100			1002	7 002					X0320050	CONSTRUCTION LA	AYOUT (SPECIAL)	L SUM	1	1				
70300150	SHORT TERM PAVEMENT MARKING REMOVAL	SQ FT	2342	2342														
70000100	STORY TEXASTOR IN TAXABLE VEHICLE	0411	2512	2012					X4400501	COMBINATION CUE	RB AND GUTTER REMOVAL AND	FOOT	1156	1156				
70200240	TEMPODADY DAVEMENT MADIVING LETTERS AND SYMBOLS	60.57	72	72					X4400301		SS THAN OR EQUAL TO 10 FEET	1001	1130	1130				
70300210	TEMPORARY PAVEMENT MARKING LETTERS AND SYMBOLS	SQ FT	73	73						REPLACEMENT LE	SS THAN OR EQUAL TO TU FEET							
70300220	TEMPORARY PAVEMENT MARKING - LINE 4"	FOOT	2804	2804					X5537800	STORM SEWERS T	O BE CLEANED 12"	FOOT	300		300			
70300240	TEMPORARY PAVEMENT MARKING - LINE 6"	FOOT	1575	1575					X6030310	FRAMES AND LIDS	TO BE ADJUSTED (SPECIAL)	EACH	28	28				
70300260	TEMPORARY PAVEMENT MARKING - LINE 12"	FOOT	42	42					X7030005	TEMPORARY PAVE	MENT MARKING REMOVAL	SQ FT	4475	4475				
70300280	TEMPORARY PAVEMENT MARKING - LINE 24"	FOOT	1321	1321														
																*	SPECIALTY	REV-SE
	USER NAME = rostkowskir		REVISED REVISED REVISED	-		<u> </u>	S	TATE OF	 ILLINOIS RANSPORTA	TION	SUMMARY OF QU F.A.U 3727 / DEMPSTER ST. (RIDG		CAGO AVE.)	F.A.U. RTE. 3727		TION 9-RS&SW	COUNTY S	TOTAL SHEE NO. 27 4
	PLOT DATE = 3/19/2021 DATE -		REVISED				PEPAKIIVI	LIVI UT I	NANSPUKIA		SCALE: NONE SHEET 2 OF 3 SHEETS		TO STA			ILLINOIS FED. AID	CONTRACT I	NO. 62L21

	SUMMARY OF QUANTITIES			CONSTRUCTI	ON TYPE CODE	STIMM.	ARY OF QUANTITIES				CONSTR	JCTION TYF	PE CODE	
<u> </u>	SUPPLIED OF QUARTITIES		TOT * 1	0005 0005		30	MAN OF COMMITTEE	<u> </u>	TOTAL	0005	0005			1
CODE NO	ITEM	UNIT	TOTAL QUANTITIES URBAN	80% FEDERAL 20% STATE 100% STATE		CODE NO	ITEM	UNIT	TOTAL QUANTITIES URBAN	80% FEDERAL 20% STATE	100% STATE			
Z0004562	COMBINATION CONCRETE CURB AND GUTTER REMOVAL AND	FOOT	385	385										
	REPLACEMENT													
Z0018500	DRAINAGE STRUCTURES TO BE CLEANED	EACH	25	25										
Z0030850	TEMPORARY INFORMATION SIGNING	SQFT	51	51										
Z0033700	LONGITUDINAL JOINT SEALANT	FOOT	4532	4532										
												* S	SPECIALTY	ITEMS
	USER NAME = rostkowskir DESIGNED		REVISED				CHRANA DV OF	- QUANTITITES		F.A.U. RTE.	SEC			REV-SE
	PLOT SCALE = 100.0000 ' / in. CHECKED	 	REVISED REVISED REVISED	-	STATE OF I DEPARTMENT OF TI	LLINOIS RANSPORTATION	F.A.U 3727 / DEMPSTER ST. (SCALE: NONE SHEET 3 OF 3 S	RIDGE AVE CHIC	AGO AVE.)	3727	2020-04	9-RS&SW	COOK CONTRACT N	27 5

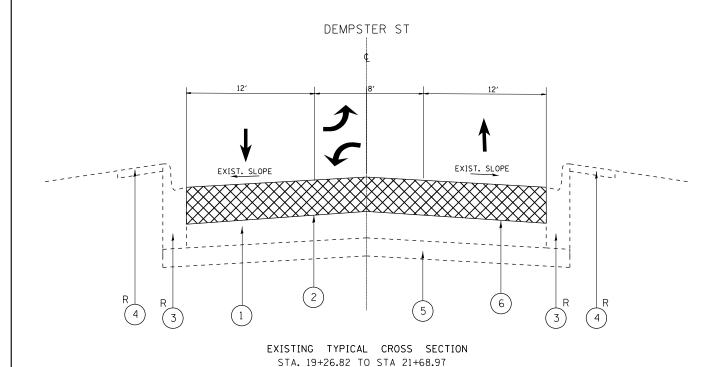

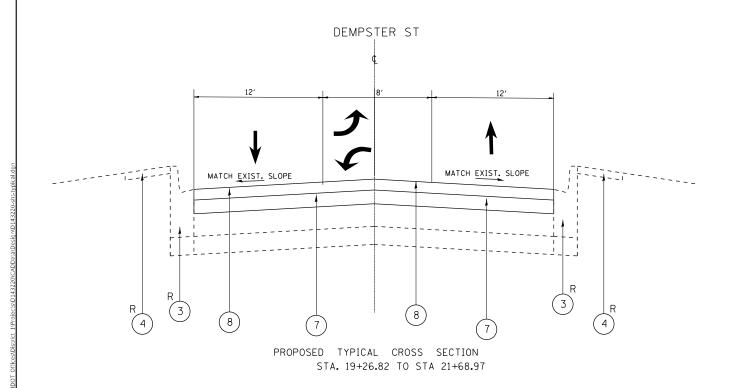

LEGEND:

- EXIST. BRICK, 4"
- EXIST. HOT-MIX ASPHALT PAVEMENT, 4" 6"
- EXIST. CONCRETE TYPE B CURB
- EXIST. SIDEWALK
- EXIST. STABILIZED SUB-BASE
- PROP. HOT-MIX ASPHALT SURFACE REMOVAL, 2.5"
- PROP. POLYMERIZED HOT-MIX ASPHALT BINDER COURSE, IL-4.75, N50, .75"
- PROP. HOT-MIX ASPHALT SURFACE COURSE, MIX "D", IL-9.5, N70, 1.75"
- R CURB AND GUTTER, SIDEWALK REMOVAL AND REPLACEMENT (LOCATION AS DIRECTED BY THE ENGINEER)
- * THE LONGITUDINAL SEALANT SHALL BE PLACED OVER THE HMA BINDER COURSE.
- ** 8 FOOT PARKING LANES

HOT-MIX ASPHALT MIXTURE REQUIREMENTS		QUALITY MANAGEMENT
MIXTURE TYPE	AIR VOIDS(%) © N _{DES.}	PROGRAM (QMP)
DESIGNED OVERLAY		
HOT-MIX ASPHALT SURFACE COURSE, MIX "D", IL-9.5, N70, 13/4"	4% @ 70 GY	R QC/QA
POLYMERIZED HOT-MIX ASPHALT BINDER COURSE, IL-4.75, N50	3.5% @ 50 G	/R QC/QA
PATCHING		
CLASS D PATCHES (HMA BINDER IL-19 mm)	4% © 70 GYR	QC/QA
QMP DESIGNATION: QUALITY CONTROL/QUALITY ASSURANCE(QA/QC); QUALITY CONTROL PAY FOR PERFORMANCE(PFP)	FOR PERFORMAN	CE(QCP);


THE UNIT WEIGHT USED TO CALCULATE ALL HMA SURFACE MIXTURE QUANTITIES IS 112 LBS/SQ YD/IN.

NOTE: CONTRACTOR SHALL MILL FIRST BEFORE PATCHING THE "AC TYPE" FOR POLYMERIZED HMA MIXES SHALL BE "SBS/SBR PG 76-22" AND FOR NON-POLYMERIZED HMA THE "AC TYPE" SHALL BE "PG 64-22" UNLESS MODIFIED BY DISTRICT ONE SPECIAL PROVISIONS. FOR USE OF RECYCLED MATERIALS SEE SPECIAL PROVISIONS. QUALITY MANAGEMENT PROGRAM (QMP) IDENTIFIES THE PARTICULAR QUALITY CONTROL SPECIFICATION THAT APPLIES TO THE HMA MIXTURE.

USER NAME = rostkowskir	DESIGNED -	REVISED -
	DRAWN -	REVISED -
PLOT SCALE = 100.0000 / in.	CHECKED -	REVISED -
PLOT DATE = 3/19/2021	DATE -	REVISED -

STATE OF ILLINOIS
DEPARTMENT OF TRANSPORTATION

EXISTING TYPICAL SECTION STA. 21+68.97 TO STA. 31+59.89

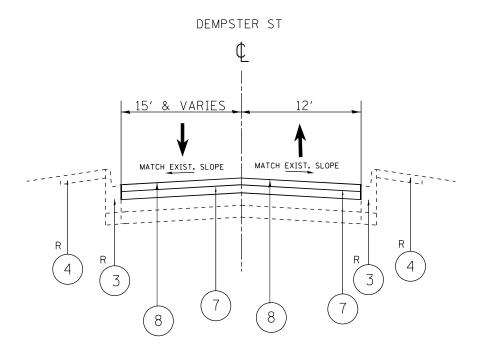

PROPOSED TYPICAL SECTION STA. 21+68.97 TO STA. 31+59.89

<u>LEGEND:</u>

- (1) EXIST. BRICK, 4"
- (2) EXIST. HOT-MIX ASPHALT PAVEMENT, 4" 6"
- (3) EXIST. CONCRETE TYPE B CURB
- (4) EXIST. SIDEWALK
- (5) EXIST. STABILIZED SUB-BASE
- (6) PROP. HOT-MIX ASPHALT SURFACE REMOVAL, 2.5"
- (7) PROP. POLYMERIZED HOT-MIX ASPHALT BINDER COURSE, IL-4.75, N50, .75"
- $\left(8\right)$ prop. Hot-mix asphalt surface course, mix "d", il-9.5, n70, 1.75"
- R CURB AND GUTTER, SIDEWALK REMOVAL AND REPLACEMENT (LOCATION AS DIRECTED BY THE ENGINEER)
- * THE LONGITUDINAL SEALANT SHALL BE PLACED OVER THE HMA BINDER COURSE.
- ** 8 FOOT PARKING LANES


USER NAME = rostkowskir	DESIGNED -	REVISED -		FY	ISTING A	ND PRO	POSED	TVDICA	L SECTIONS	F.A.U RTE	SECTION	COUNTY	TOTAL	SHEET
	DRAWN -	REVISED -	STATE OF ILLINOIS							3727/DEMPSTER	ST 2020-049-RS&SW	соок	27	7
PLOT SCALE = 100.0000 / in.	CHECKED -	REVISED -	DEPARTMENT OF TRANSPORTATION	DE	IMP21EK	21 (KID	JE AVE	IU CHI	ICAGO AVE)			CONTRAC	T NO. 6	2L21
PLOT DATE = 3/19/2021	DATE -	REVISED -		SCALE:	SHEET	OF	SHEETS	S STA.	TO STA.		ILLINOIS FED. AID	PROJECT		

8' 15' 8' PARKING LAME** EXIST. SLOPE EXIST. SLOPE EXIST. SLOPE A 1 1 2

EXISTING TYPICAL SECTION

STA. 31+59.89 TO STA. 35+24.28

DEMPSTER ST

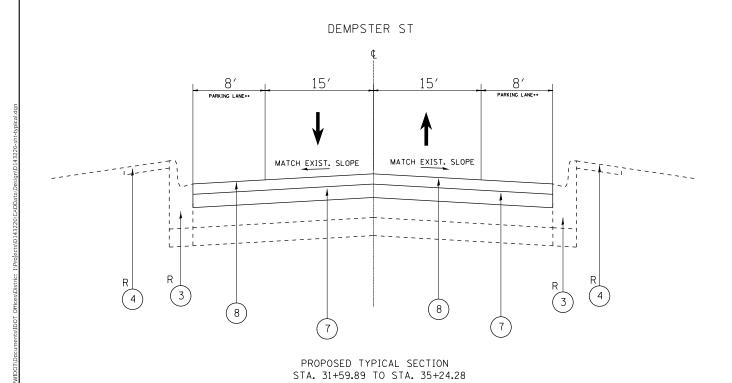

DESIGNED -

DRAWN

DATE

PLOT DATE = 3/19/2021

CHECKED

REVISED


REVISED


REVISED

LEGEND:

- (1) EXIST. BRICK, 4"
- (2) EXIST. HOT-MIX ASPHALT PAVEMENT, 4" 6"
- (3) EXIST. CONCRETE TYPE B CURB
- (4) EXIST. SIDEWALK
- (5) EXIST. STABILIZED SUB-BASE
- (6) prop. hot-mix asphalt surface removal, 2.5"
- (7) PROP. POLYMERIZED HOT-MIX ASPHALT BINDER COURSE, IL-4.75, N50, .75"
- (8) PROP. HOT-MIX ASPHALT SURFACE COURSE, MIX "D", IL-9.5, N70, 1.75"
- R CURB AND GUTTER, SIDEWALK REMOVAL AND REPLACEMENT (LOCATION AS DIRECTED BY THE ENGINEER)
- * THE LONGITUDINAL SEALANT SHALL BE PLACED OVER THE HMA BINDER COURSE.
- ** 8 FOOT PARKING LANES

	F	XISTING AI	UN PRO	DUSED .	TVPICAL SE	CTIONS	F.A.U RTE	SECTION	COUNTY	TOTAL	SHEET NO.
STATE OF ILLINOIS		EMPSTER :					3727/DEMPSTER ST	2020-049-RS&SW	соок	27	8
DEPARTMENT OF TRANSPORTATION	U	- CIVIFSIEN	יטוח) וכ	JE AVE	IO CHICAC	IU AVE)			CONTRAC	T NO. 62	L21
	SCALE:	SHEET	OF	SHEETS	STA.	TO STA.		ILLINOIS FED. AID	PROJECT		

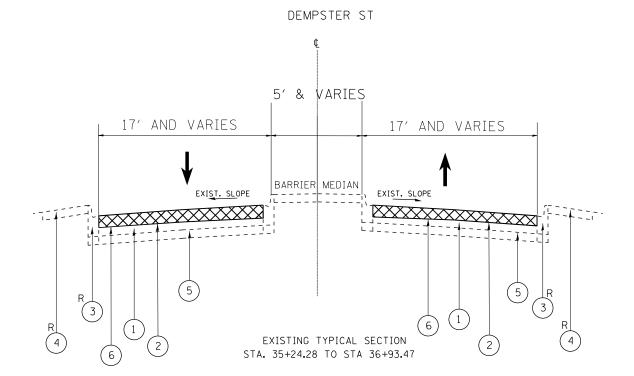

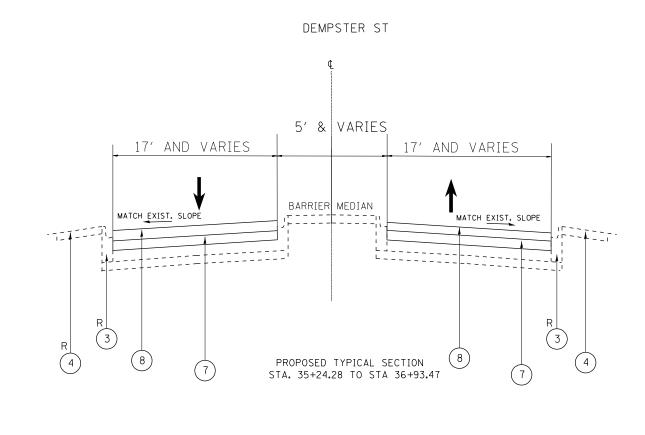

DESIGNED -

DRAWN

DATE

PLOT DATE = 3/19/2021

CHECKED

REVISED

REVISED


REVISED

LEGEND:

- EXIST. BRICK, 4"
- EXIST. HOT-MIX ASPHALT PAVEMENT, 4" 6"
- EXIST. CONCRETE TYPE B CURB
- EXIST. SIDEWALK
- EXIST. STABILIZED SUB-BASE
- PROP. HOT-MIX ASPHALT SURFACE REMOVAL, 2.5"
- PROP. POLYMERIZED HOT-MIX ASPHALT BINDER COURSE, IL-4.75, N50, .75"
- PROP. HOT-MIX ASPHALT SURFACE COURSE, MIX "D", IL-9.5, N70, 1.75"
- R CURB AND GUTTER, SIDEWALK REMOVAL AND REPLACEMENT (LOCATION AS DIRECTED BY THE ENGINEER)
- * THE LONGITUDINAL SEALANT SHALL BE PLACED OVER THE HMA BINDER COURSE.
- ** 8 FOOT PARKING LANES

CTATE OF HUMOIC		EXISTING A	AND P	ROPOSED	TYPIC	CAL SECTIONS	F.A.U RTE	SECTION	COUNTY	TOTAL SHEETS	SHEET NO.
STATE OF ILLINOIS DEPARTMENT OF TRANSPORTATION		DEMPSTER					3727/DEMPSTER ST	2020-049-RS&SW	COOK CONTRAC	27 F NO. 62	9
	SCALE:	SHEET	OF	SHEETS	STA.	TO STA.		ILLINOIS FED. AID		1 140. 02	


DEMPSTER ST 8' PARRING LANG. EXIST. SLOPE EXIST. SLOP

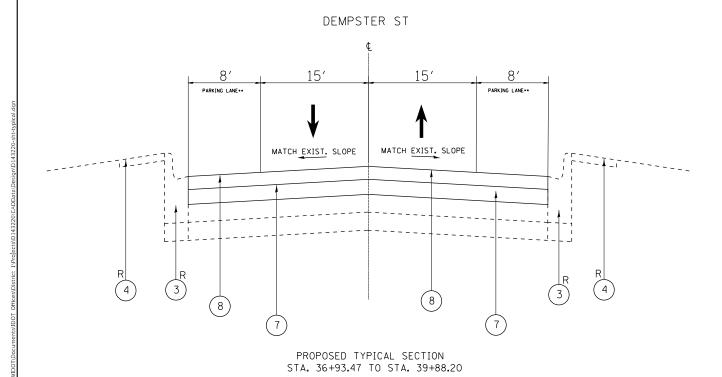


LEGEND:

- (1) EXIST. BRICK, 4"
- (2) EXIST. HOT-MIX ASPHALT PAVEMENT, 4" 6"
- (3) EXIST. CONCRETE TYPE B CURB
- (4) EXIST. SIDEWALK
- (5) EXIST. STABILIZED SUB-BASE
- (6) PROP. HOT-MIX ASPHALT SURFACE REMOVAL, 2.5"
- (7) PROP. POLYMERIZED HOT-MIX ASPHALT BINDER COURSE, IL-4.75, N50, .75 $^{\prime\prime}$
- $\left(8\right)$ prop. Hot-mix asphalt surface course, mix "d", il-9.5, n70, 1.75"
- R CURB AND GUTTER, SIDEWALK REMOVAL AND REPLACEMENT (LOCATION AS DIRECTED BY THE ENGINEER)
- * THE LONGITUDINAL SEALANT SHALL BE PLACED OVER THE HMA BINDER COURSE.
- ** 8 FOOT PARKING LANES

USER NAME = rostkowskir	DESIGNED -	REVISED -			EVICTING	AND DD	UDUCED	TVDICAL	SECTIONS	F.A.U	SECTION	COUNTY	TOTAL :	SHEET
	DRAWN -	REVISED -	STATE OF ILLINOIS DEPARTMENT OF TRANSPORTATION	EXISTING AND PROPOSED TYPICAL SECTIONS DEMPSTER ST (RIDGE AVE TO CHICAGO AVE)						3727/DEMPSTER ST	2020-049-RS&SW	COOK	27	10
PLOT SCALE = 100.0000 / in.	CHECKED -	REVISED -	DEPARTMENT OF TRANSPORTATION		DEMPSTER	ST (RIE	DGE AVE	: то сніс	AGO AVE)	5727/DEMI STER ST		CONTRAC	T NO. 621	L21
PLOT DATE = 3/19/2021	DATE -	REVISED -		SCALE:	SHEET	OF	SHEETS	STA.	TO STA.		ILLINOIS FED. AID	PROJECT		

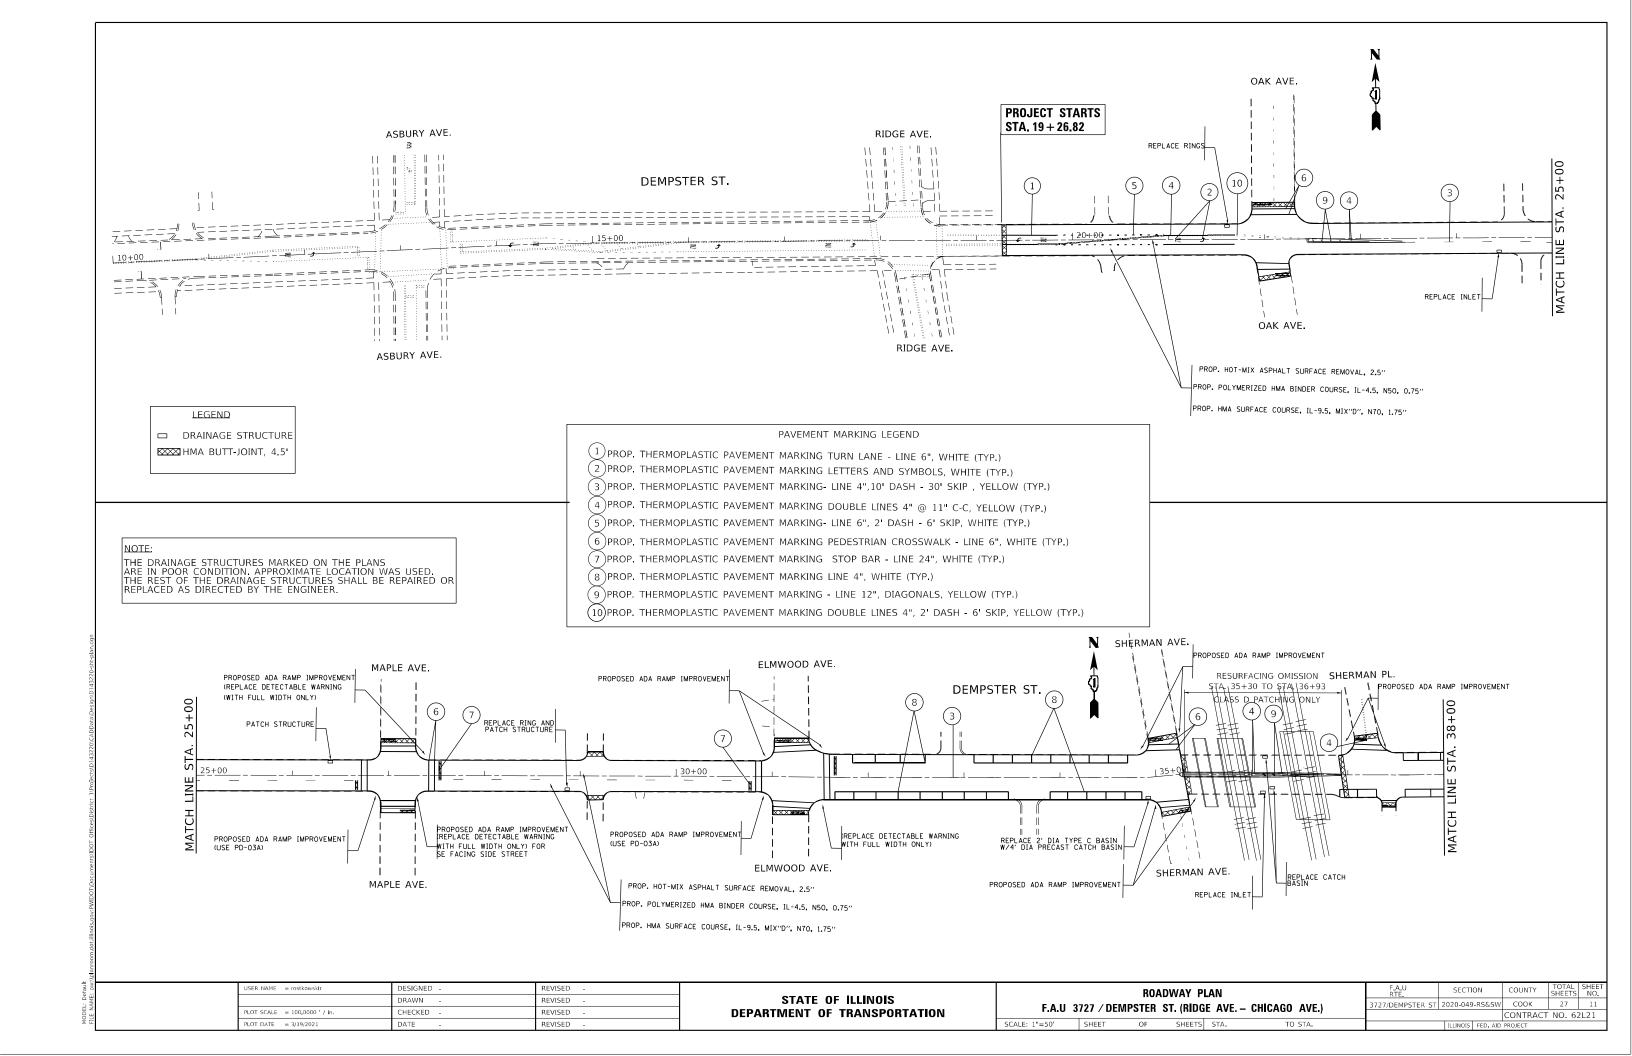

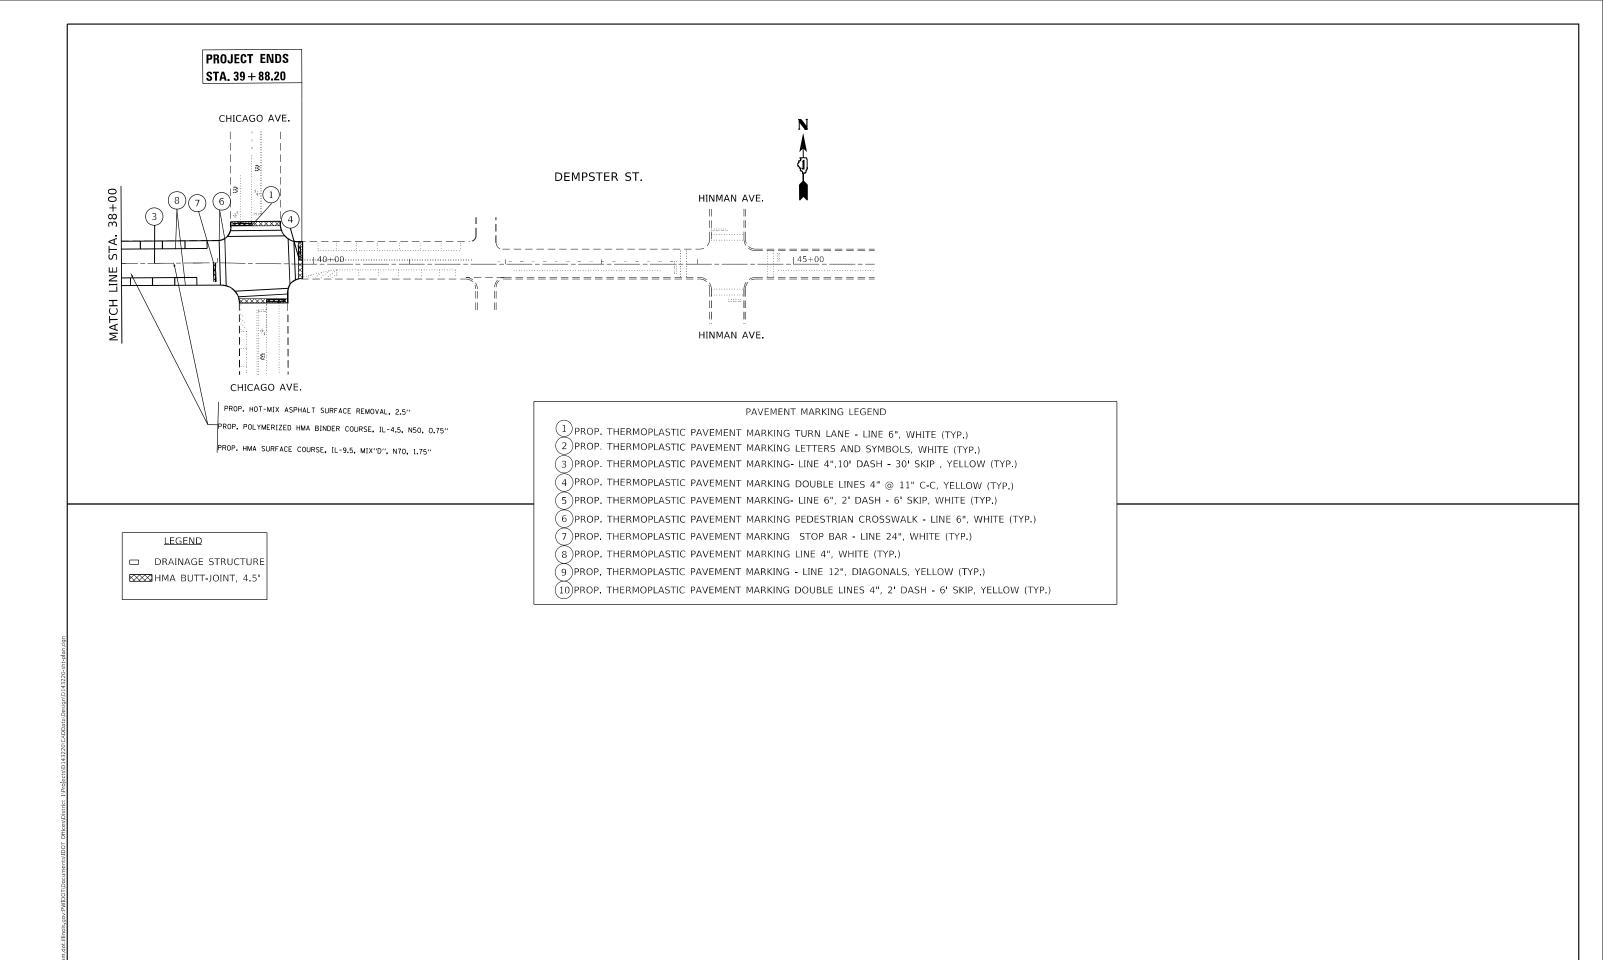

MODEL: Default

D

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DESIGNED -

DRAWN

DATE

CHECKED

LOT SCALE = 100.0000 ' / in.

PLOT DATE = 3/19/2021

STATE OF ILLINOIS
DEPARTMENT OF TRANSPORTATION

ROADWAY PLAN


F.A.U 3727 / DEMPSTER ST. (RIDGE AVE. - CHICAGO AVE.)


SCALE: 1"=50' SHEET OF SHEETS STA. TO STA.


F.A.U SECTION COUNTY TOTAL SHEETS NO.


3727/DEMPSTER ST 2020-049-RS&SW COOK 27 12

CONTRACT NO. 62L21

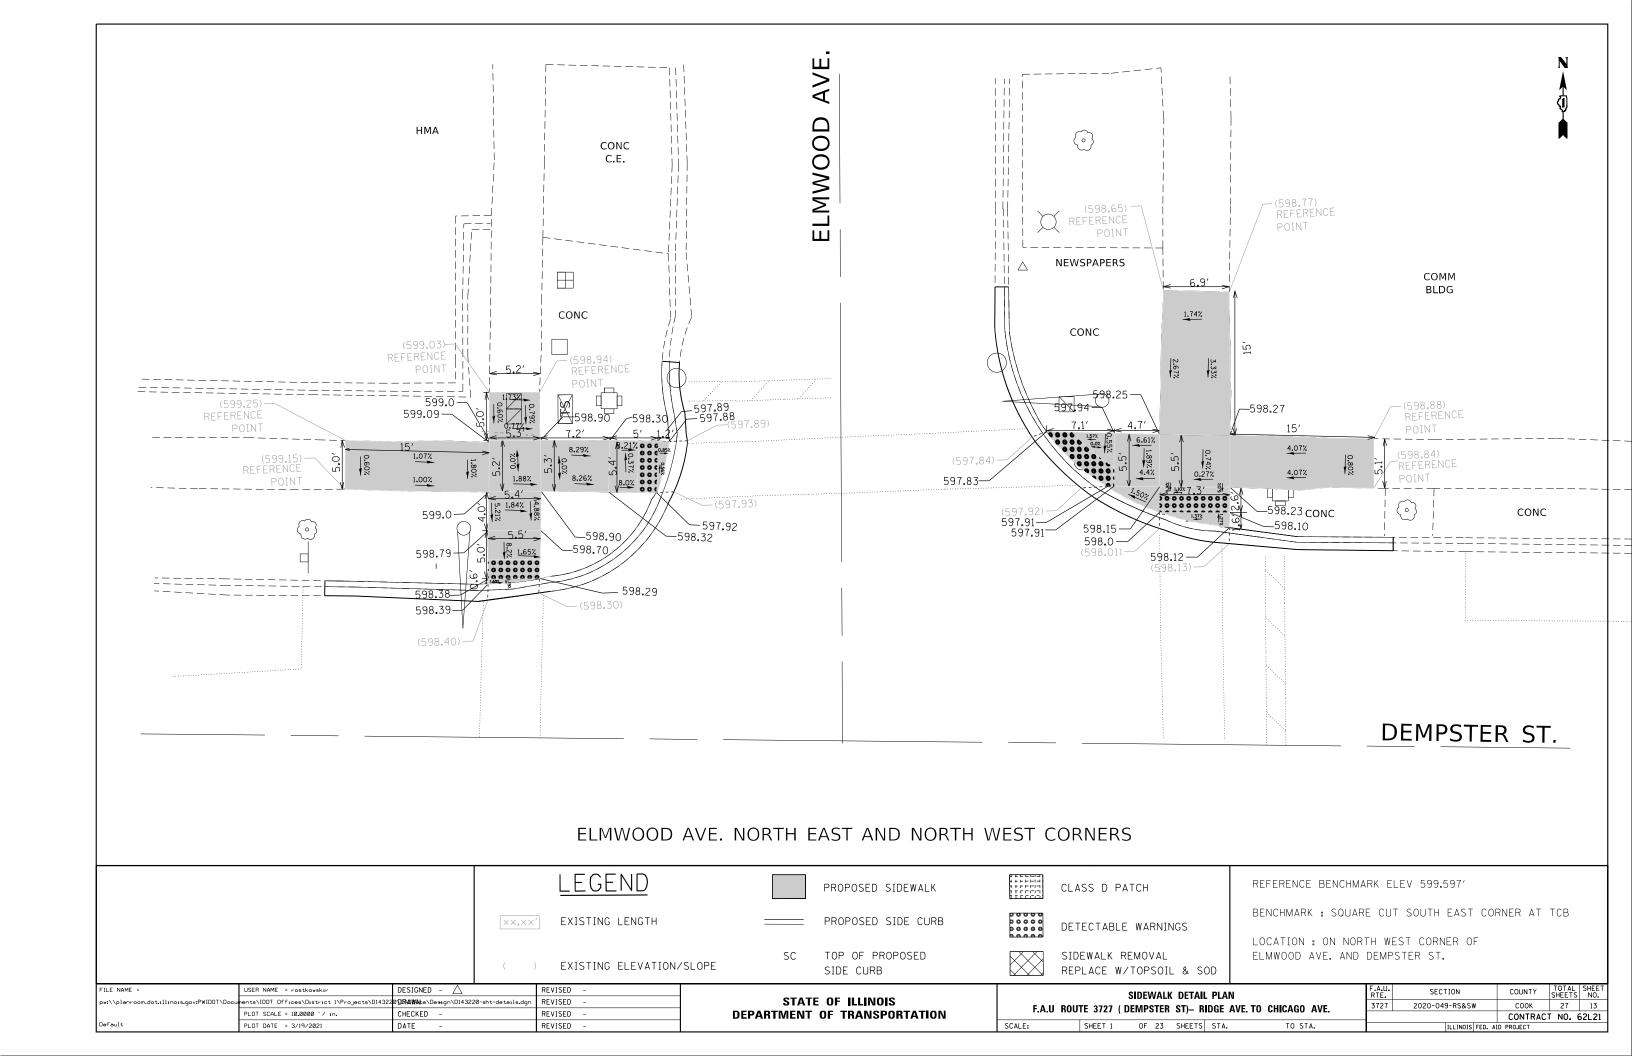


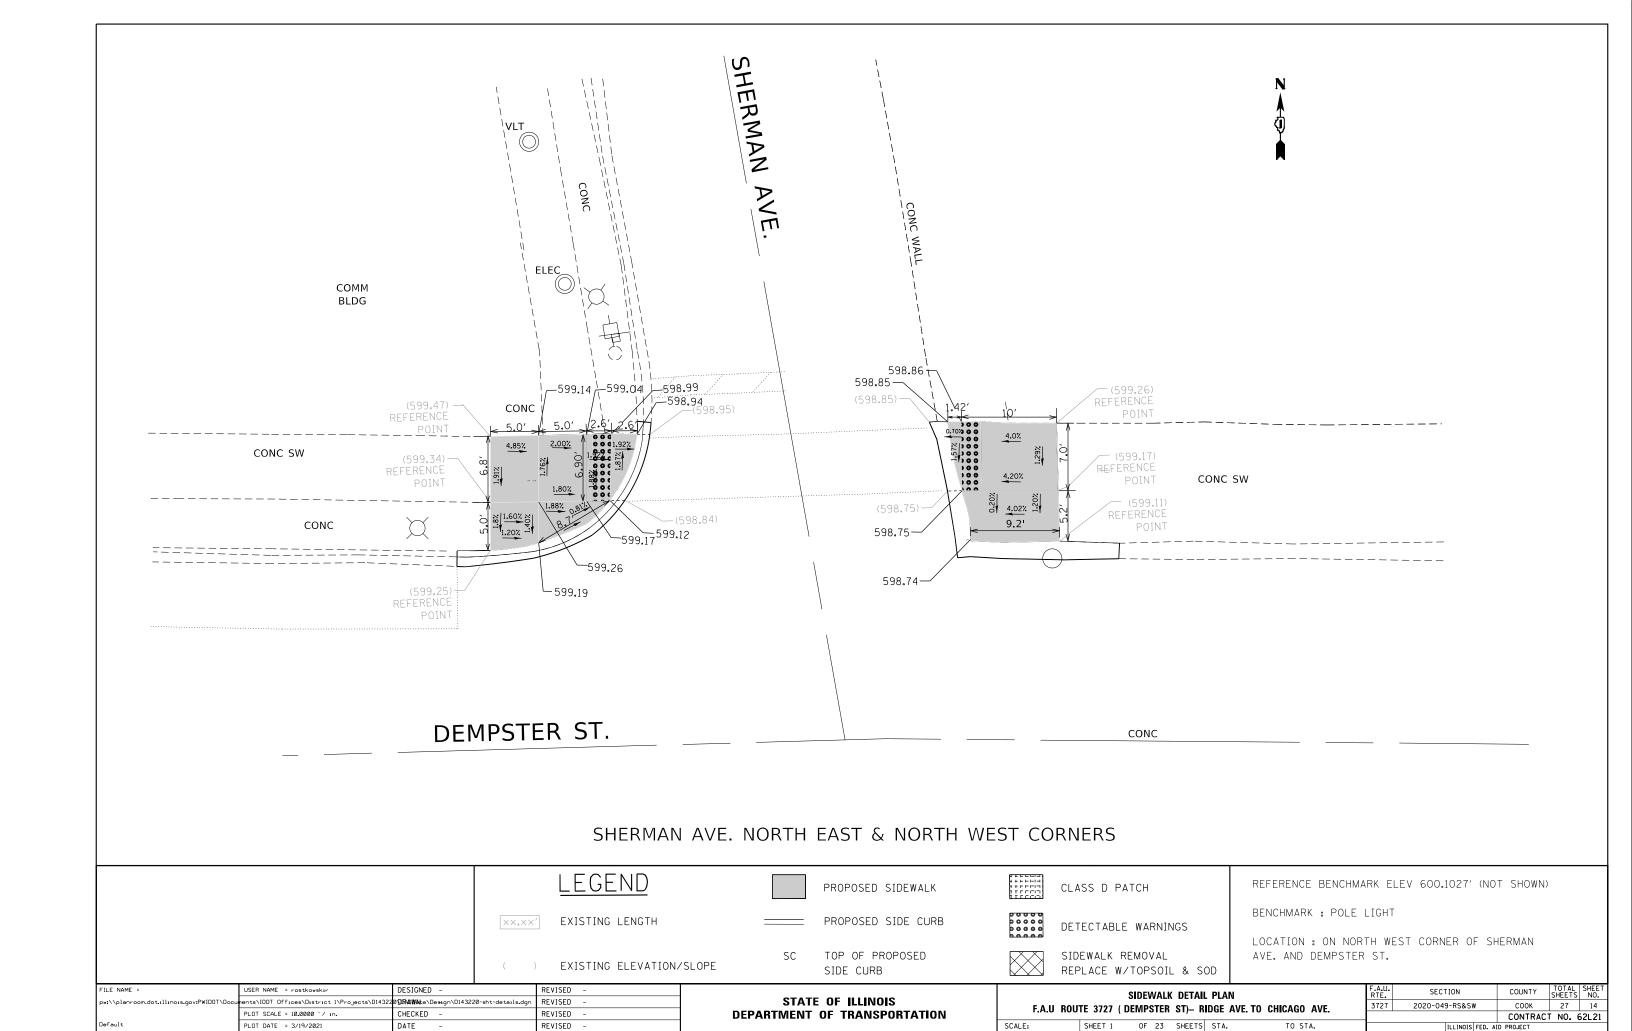


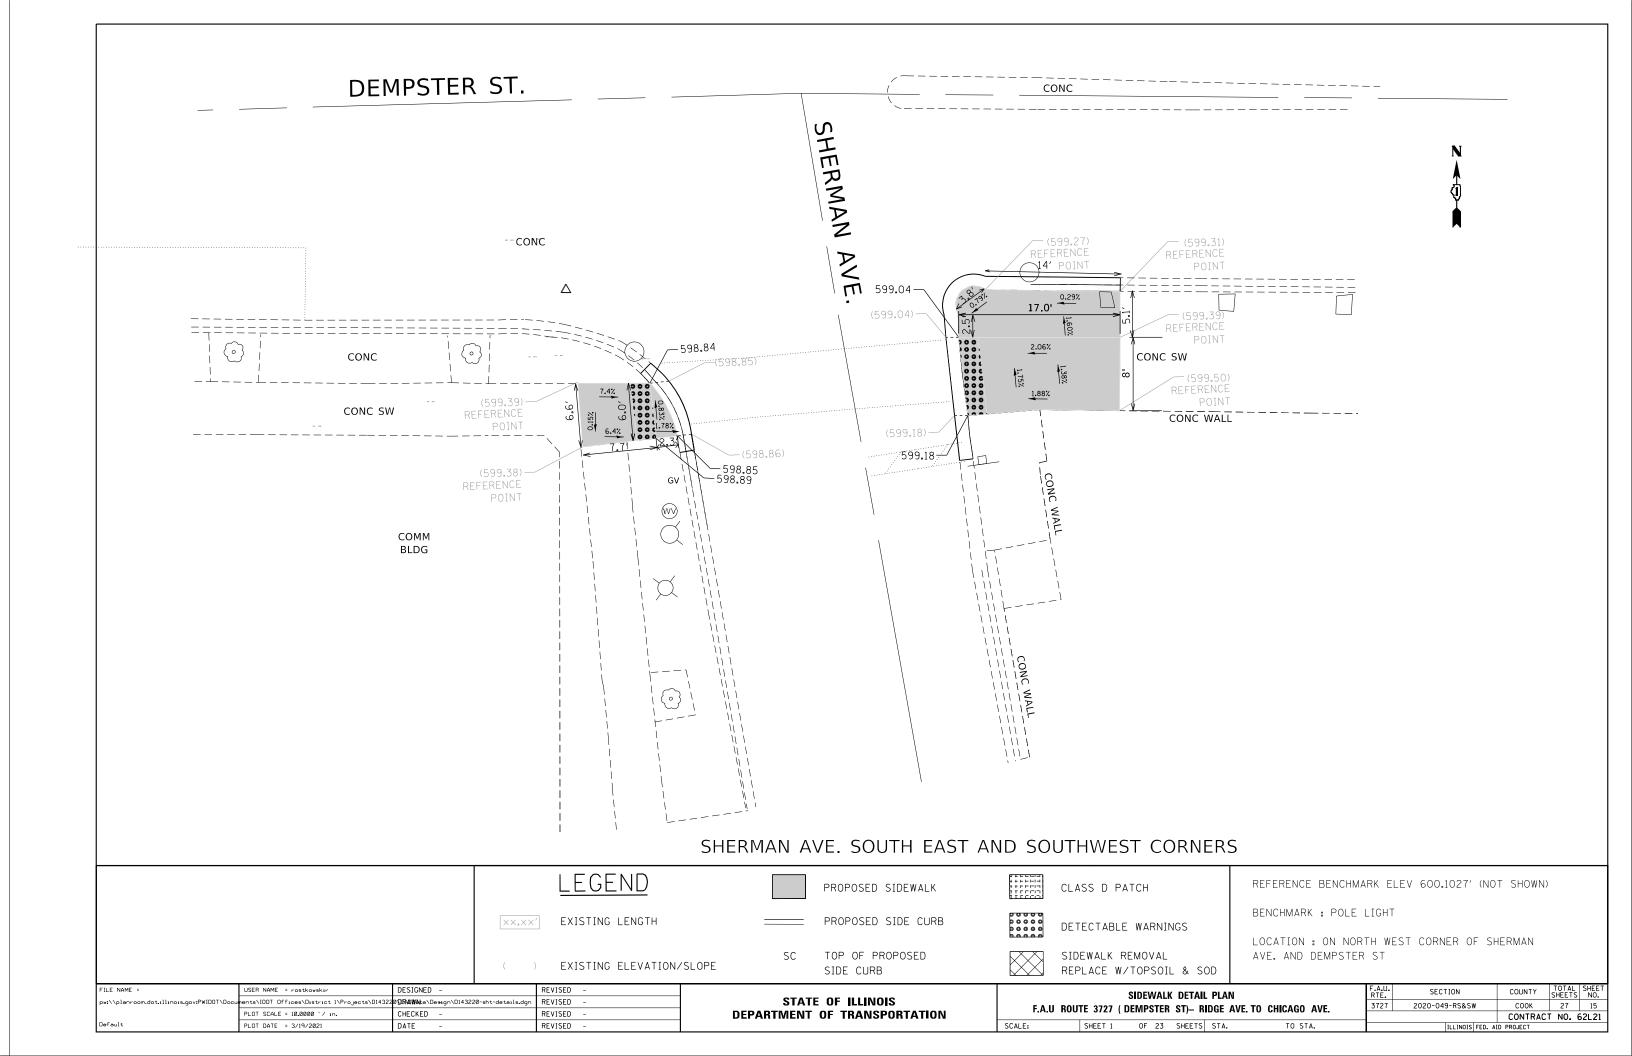

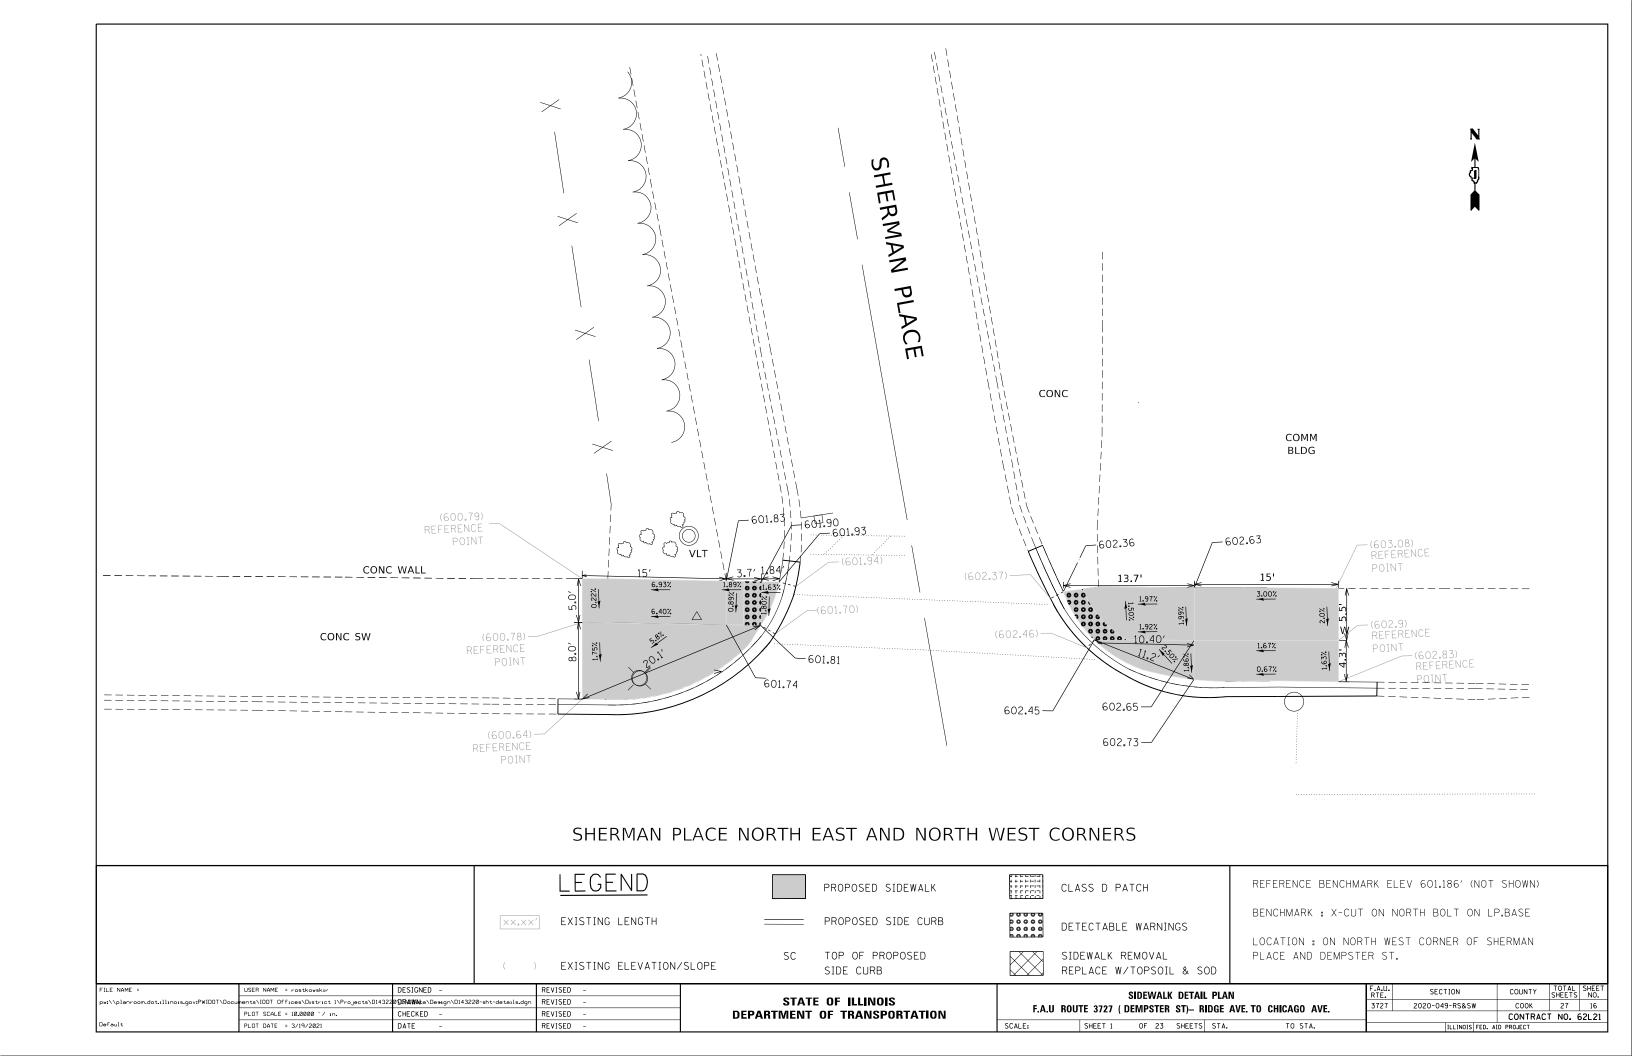

ADA DETAIL FOR DOUBLE PERPENDICULAR CURB RAMPS **PD-03A PD-03B** -LOWER LANDING LOWER LANDING CURB RAMP PREFERRED = 7.1% (1:14) LANDSCAPE OR PCC AREA -LANDSCAPE OR PCC AREA LOWER LANDING-LOWER LANDING A S MATCH EXIST PREF. 1.6% MAX. 2.0% MAX. 2.0% 42 22 11 1 22 22 22 TRANSITION **TRANSITION** EXIST SIDEWALK EXIST SIDEWALK PREFERRED < 8.3% PREFERRED < 8.3% MAX ANY SLOPE MAX. ANY SLOPE [™]MATCH EXIST ຶ 🗒 lpha MATCH EXIST $\mathring{\ \ }$ // CURB RAMP PREFERRED = 7.1% (1:14) MAX. = 8.3% (1:12) CURB RAMP^J PREFERRED = 7.1% (1:14) MAX. = 8.3% (1:12) 2' MIN GRASS BUFFER 4 2' MIN GRASS BUFFER MATCH EXIST-MATCH EXIST-⊱MATCH EXIST SIDEWALK ackslash MATCH EXIST SIDEWALK 44 44 EXIST MUST BE EXIST. LANDSCAPED MUST BE EXIST. LANDSCAPED SURFACE. EXIST. CONCRETE SURFACE SURFACE. EXIST. CONCRETE SURFACE WILL REQUIRE DETAILED DESIGN WILL REQUIRE DETAILED DESIGN **CONSTRUCTION NOTES:** a a EXIST. GRASS **LEGEND** 1) ALL CROSS SLOPES ARE PREFERRED 1.6% (1:64), MAXIMUM 2% (1:50) EXCEPT WHEN TRANSITIONING TO EXISTING SIDEWALK PROPOSED SIDEWALK * MATCH EXISTING SIDEWALK WIDTH ─ PROPOSED SIDE CURB DETECTABLE WARNINGS DESIGNED REVISED PROJECT DETAIL FOR DOUBLE PERPENDICULAR CURB RAMPS STATE OF ILLINOIS DRAWN R. LEDEZMA REVISED 727/DEMPSTER ST 2020-049-RS&SW COOK 27 17 HECKED REVISED **DEPARTMENT OF TRANSPORTATION** PD-03 CONTRACT NO. 62L21 SCALE: NONE LOT DATE = 3/19/2021 SHEETS STA. DATE

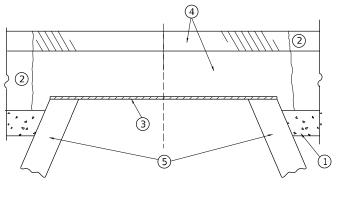

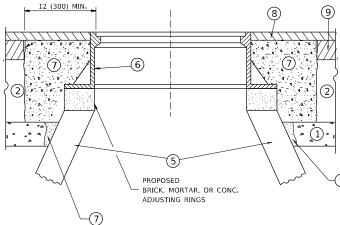

NOTES

EXISTING BROKEN FRAMES AND LIDS SHALL BE REMOVED AND DISPOSED OF BY THE CONTRACTOR AND SHALL BE REPLACED AS DIRECTED BY THE ENGINEER. REPLACEMENT FRAMES AND LIDS WILL BE PAID FOR IN ACCORDANCE WITH ARTICLE 109.04 OF THE STANDARD SPECIFICATIONS UNLESS A SEPARATE PAY ITEM HAS BEEN PROVIDED.

IF THE EXISTING LIDS ARE OPEN, THE FRAME WILL BE ADJUSTED TO THE ELEVATION OF THE MILLED PAVEMENT SURFACE PRIOR TO THE MILLING OPERATION. THE FRAME WILL NOT BE REMOVED AND COVERED BY THE METAL PLATE.

CITY OF CHICAGO CASTINGS ARE THE PROPERTY OF THE CITY AND THE CONTRACTOR SHALL NOTIFY THE CITY FOR REMOVAL AND DISPOSITION OF THE CASTINGS.

THE METAL PLATE USED TO COVER THE STRUCTURE SHALL REMAIN THE PROPERTY OF THE CONTRACTOR.

WHEN STRUCTURES ARE TO BE ADJUSTED OR RECONSTRUCTED, THE LOWERING AND RAISING OF THE FRAMES AND LIDS WILL NOT BE PAID FOR SEPARATELY BUT WILL BE INCLUDED IN THE COST OF THE CORRESPONDING PAY ITEM.

CONSTRUCTION PROCEDURES

STAGE 1 (BEFORE PAVEMENT MILLING)

- A) REMOVE A MINIMUM OF 12 (300) OF THE PAVEMENT FROM AROUND THE STRUCTURE.
- B) REMOVE THE EXISTING FRAME AND LID FROM THE STRUCTURE.
- C) COVER THE STRUCTURE OPENING WITH A 36 (900) DIAMETER METAL PLATE.
- D) BACKFILL WITH CRUSHED STONE AND A MINIMUM 1½ (40)
 THICK HMA SURFACE MIX APPROVED BY THE ENGINEER.

STAGE 2 (AFTER PAVEMENT MILLING)

- A) REMOVE THE HMA SURFACE MIX AND CRUSHED STONE.
- B) INSTALL THE FRAME AND LID; ADJUST THE FRAME TO ITS FINAL SURFACE ELEVATION.
- C) THE SURROUNDING SPACE SHALL BE FILLED WITH CLASS PP-1 *
 CONCRETE TO THE ELEVATION OF THE SURFACE OF THE EXISTING
 BASE COURSE OR THE BINDER COURSE.
- f * UNLESS OTHERWISE SPECIFIED IN THE PLANS.

THE PROCEDURE EXPLAINED ABOVE SHALL CONFORM TO THE APPLICABLE PORTIONS OF SECTIONS 353, 406, 602, AND 603 OF THE STANDARD SPECIFICATIONS EXCEPT THAT "THE CONTRACTOR SHALL ADJUST THE STRUCTURES TO THE FINISHED PAVEMENT ELEVATION NO MORE THAN 5 CALENDAR DAYS PRIOR TO PLACEMENT OF THE FINAL LIFT OF SURFACE UNLESS APPROVED BY THE FINGINFER "

LEGEND

- SUB-BASE GRANULAR MATERIAL
- 6) FRAME AND LID (SEE NOTES)
- 2 EXISTING PAVEMENT
- (7) CLASS PP-1 *CONCRETE
- 3 36 (900) DIAMETER METAL PLATE
 4 PROPOSED CRUSHED STONE AND HMA SURFACE MIX
- 8) PROPOSED HMA SURFACE COURSE
- 5 EXISTING STRUCTURE
- 9 PROPOSED HMA BINDER COURSE

LOCATION OF STRUCTURES

THE CONTRACTOR WILL BE REQUIRED TO KEEP A RECORD OF THE LOCATIONS OF THE BURIED STRUCTURES ACCORDING TO THE STATION AND DISTANCE LEFT OR RIGHT OF THE CENTERLINE OF PAVEMENT. UPON COMPLETION OF THE WORK, THE CONTRACTOR WILL DELIVER THE RECORD TO THE ENGINEER.

BASIS OF PAYMENT

REMOVING FRAMES AND LIDS ON DRAINAGE AND UTILITY STRUCTURES IN THE PAVEMENT PRIOR TO MILLING, AND ADJUSTING TO FINAL GRADE PRIOR TO PLACING THE SURFACE COURSE, WILL BE PAID FOR AT THE CONTRACT UNIT PRICE EACH FOR "FRAMES AND LIDS TO BE ADJUSTED (SPECIAL)."

THIS WORK WILL NOT BE PAID FOR WHEN DRAINAGE AND UTILITY STRUCTURES ARE SPECIFIED FOR PAYMENT AS STRUCTURE RECONSTRUCTION.

NEW FRAMES AND LIDS, WHEN SPECIFIED, WILL BE PAID FOR SEPARATELY.

DETAILS FOR FRAMES AND LIDS ADJUSTMENT WITH MILLING

ALL DIMENSIONS ARE IN INCHES (MILLIMETERS) UNLESS OTHERWISE SHOWN


STATE OF ILLINOIS
DEPARTMENT OF TRANSPORTATION

FRAMES AND LIDS ADJUSTMENT WITH MILLING

E SHEET 1 OF 1 SHEETS STA. TO STA.

F.A.U SECTION COUNTY TOTAL SHEETS NO. 727/DEMPSTER ST 2020-049-RS&SW COOK 27 18

| BD600-03 (BD-8) | CONTRACT NO. 62L21 | |

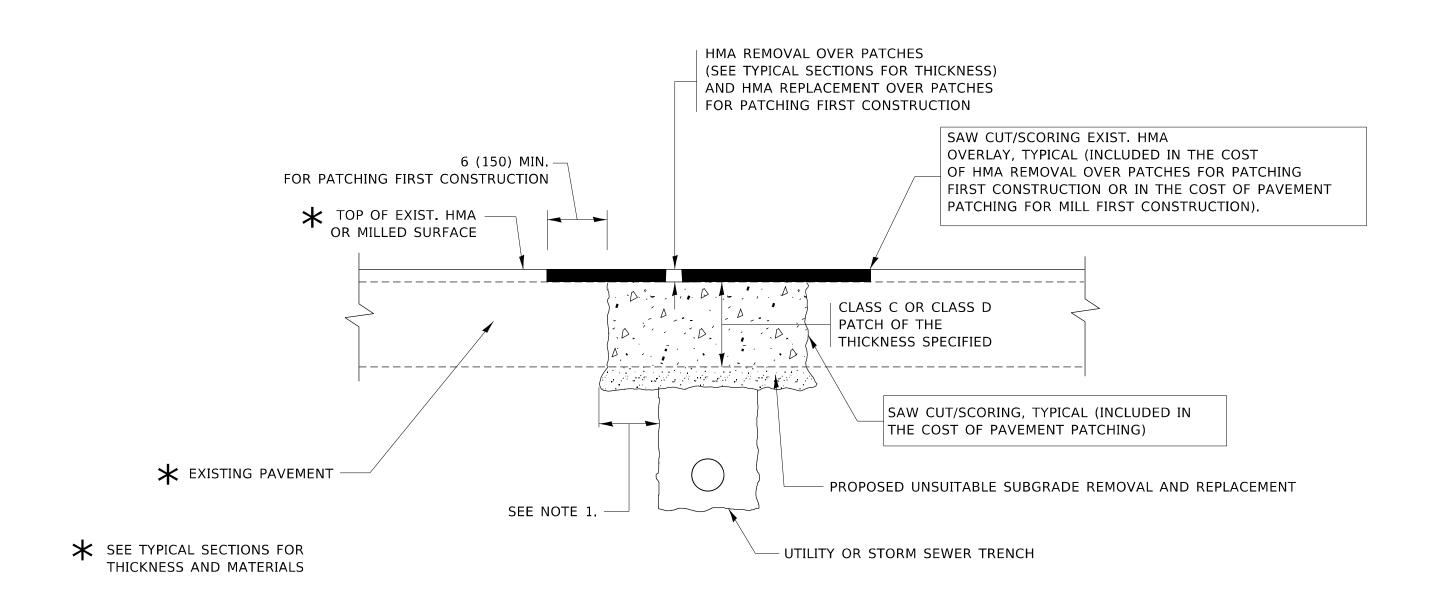

NOTES:

- 1. THE WIDTH OF THE FULL DEPTH PATCH OVER A TRENCH SHALL BE 12 (300) WIDER ON EACH SIDE OF THE TRENCH.
- 2. FOR METHOD OF MEASUREMENT AND BASIS OF PAYMENT, SEE RECURRING SPECIAL PROVISION "PATCHING WITH HOT-MIX ASPHALT OVERLAY REMOVAL".

SEQUENCE OF CONSTRUCTION (PATCHING FIRST)


- 1. REMOVE THE EXISTING HMA MATERIAL OVER THE AREA TO BE PATCHED.
- 2. REMOVE AND REPLACE WITH CLASS C OR D PATCH.
- 3. REPLACE HMA MATERIAL OVER THE AREA TO BE PATCHED.

SEQUENCE OF CONSTRUCTION (MILLING FIRST)

- 1. MILL HMA FIRST IF THERE IS AT LEAST $4\frac{1}{2}$ INCHES OR MORE OF HMA MATERIAL ON TOP OF THE EXISTING PAVEMENT OR IF THE PAVEMENT IS FULL DEPTH HMA. A MINIMUM OF 2 INCHES OF HMA MATERIAL SHALL BE IN PLACE AFTER MILLING.
- 2. REMOVE AND REPLACE WITH FULL DEPTH CLASS D PATCHES TO TOP OF MILLED SURFACE.

ALL DIMENSIONS ARE IN INCHES (MILLIMETERS) UNLESS OTHERWISE SHOWN.

USER NAME = rostkowskir	DESIGNED - R. SHAH	REVISED - A. ABBAS 04-27-98			PAVEMENT PATCHING FOR		F.A.U RTE	SECTION	COUNTY	TOTAL SHEET	П
	DRAWN -	REVISED - R. BORO 01-01-07	STATE OF ILLINOIS				3727/DEMPSTER ST	2020-049-RS&SW	COOK	27 19	┪
PLOT SCALE = 100.0000 / in.	CHECKED -	REVISED - R. BORO 09-04-07	DEPARTMENT OF TRANSPORTATION		HMA SURFACED PAVEMENT		BD400-04	(BD-22)	CONTRAC	T NO. 62L21	1
PLOT DATE = 3/19/2021	DATE - 10-25-94	REVISED - K. ENG 10-27-08		SCALE: NONE	SHEET 1 OF 1 SHEETS STA.	TO STA.		ILLINOIS FED. AID	PROJECT		1

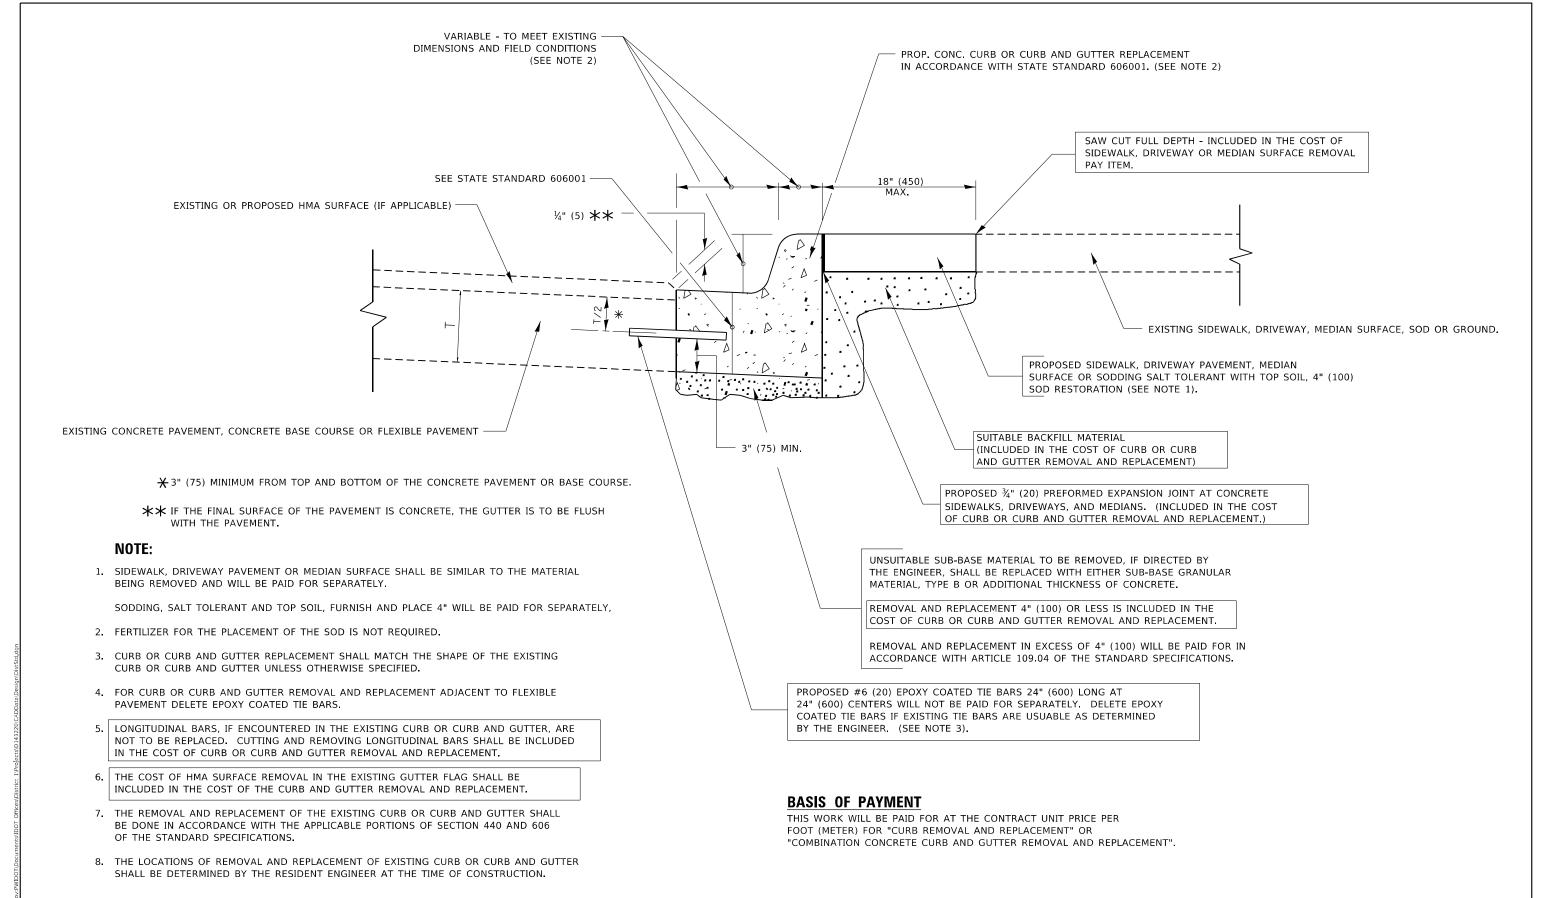


CURB OR CURB AND GUTTER REMOVAL AND REPLACEMENT

ALL DIMENSIONS ARE IN INCHES (MILLIMETERS) UNLESS OTHERWISE SHOWN.

CONTRACT NO. 62L21


USER NAME = rostkowskir	DESIGNED - A. HOUSEH	REVISED - R. SHAH 10-03-96			CURB OR CURB A	ND GUTTER	F.A.U RTF	SECTION	C
	DRAWN -	REVISED - A. ABBAS 03-21-97	STATE OF ILLINOIS				3727/DEMPSTER ST	2020-049-RS&S	śW.
PLOT SCALE = 100.0000 / in.	CHECKED -	REVISED - M. GOMEZ 01-22-01	DEPARTMENT OF TRANSPORTATION		REMOVAL AND RE	PLACEMENT	BD600-06	(BD-24)	CC
PLOT DATE = 3/19/2021	DATE - 03-11-94	REVISED - R. BORO 12-15-09		SCALE: NONE	SHEET 1 OF 1 SHEET	S STA. TO STA.		ILLINOIS FED.	AID PRC

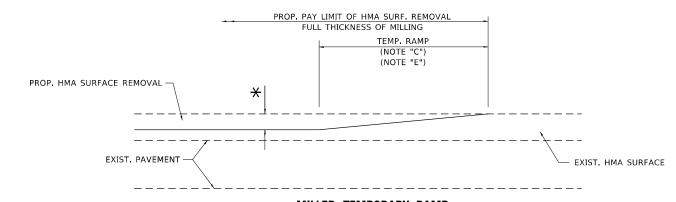

MILLED TEMPORARY RAMP

(FOR BUTT JOINT AND HMA TAPER SEE DETAIL BELOW)

OPTION 1

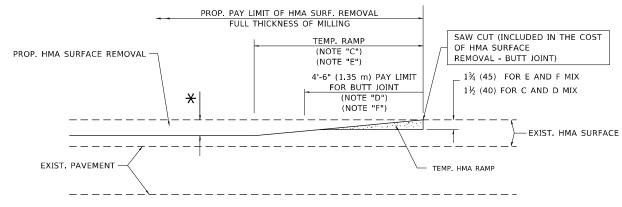


HMA CONSTRUCTED TEMPORARY RAMP

(FOR BUTT JOINT AND HMA TAPER SEE DETAIL BELOW)

OPTION 2

TYPICAL TEMPORARY RAMP

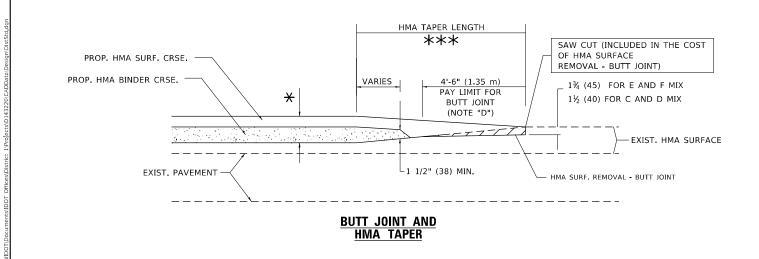

TYPICAL BUTT JOINT AND HMA TAPER FOR MILLING AND RESURFACING

USER NAME = rostkowskif DESIGNED M. DE YONG REVISED R. SHAH 10-25-94 DRAWN REVISED A. ABBAS 03-21-97 PLOT SCALE = 100,0000 ' / in. CHECKED REVISED M. GOMEZ 04-06-01 PLOT DATE = 3/19/2021 DATE 06-13-90 REVISED R.BORO 01-01-07

* * EXIST. PAVEMENT

BUTT JOINT DETAIL


PROP. HMA OR PCC

SURFACE REMOVAL - BUTT JOINT

30'-0" (9.0 m) (NOTE "A")

15'-0" (4.5 m) (NOTE "B")

(NOTE "D")

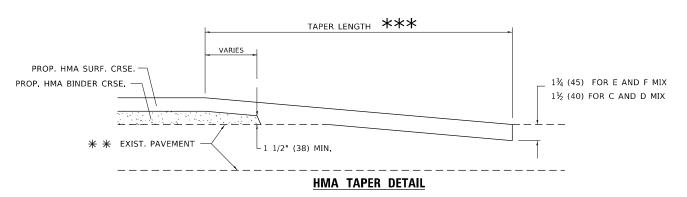

TYPICAL BUTT JOINT AND HMA TAPER FOR RESURFACING ONLY

** PC CONCRETE, HMA OR HMA RESURFACED PAVEMENT.

NOTES

A. MAINLINE ROADWAYS AND MAJOR SIDE ROADS.

EXIST, HMA OR PCC SURFACE -

- B. MINOR SIDE ROADS.
- C. THE TEMP. RAMP SHALL BE CONSTRUCTED IMMEDIATELY UPON REMOVAL OF THE EXISTING HMA SURFACE,
- D. THE BUTT JOINT SHALL BE CONSTRUCTED IMMEDIATELY PRIOR TO PLACING THE PROPOSED HMA COURSES.
- E. TAPER THE TEMP, RAMP AT A RATE OF 3'-0" (900 mm) PER 1 INCH (25 mm) OF MILLING THICKNESS.

SHEET 1

- F. INSTALLATION AND REMOVAL OF THE 4'-6" (1.35 m) TEMP. RAMP IS INCLUDED IN COST OF HMA SURFACE REMOVAL BUTT JOINT.

 ** SEE TYPICAL SECTIONS FOR MILLING THICKNESS.
- G. SEE ARTICLE 406.08 AND 406.14 OF THE STANDARD SPECIFICATIONS FOR "HMA AND/OR PCC SURFACE REMOVAL, BUTT JOINT".
- *** 20'-0" (6.1 m) PER 1 (25) RESURFACING (NOTE "A")
 10'-0" (3.0 m) PER 1 (25) RESURFACING (NOTE "B")

BASIS OF PAYMENT

THE BUTT JOINT WILL BE PAID FOR AT THE CONTRACT UNIT PRICE PER SQUARE YARD (SQUARE METER) FOR "HOT-MIX ASPHALT SURFACE REMOVAL - BUTT JOINT" OR FOR "PORTLAND CEMENT CONCRETE SURFACE REMOVAL-BUTT JOINT".

SCALE: NONE

ALL DIMENSIONS ARE IN INCHES (MILLIMETERS) UNLESS OTHERWISE SHOWN.

SAW CUT (INCLUDED IN THE COST


 $1\frac{3}{4}$ (45) FOR E AND F MIX

- BUTT JOINT)

OF HMA OR P.C.C. SURFACE REMOVAL

MODEL: Default FILE NAME: pw:\\p

STATE OF ILLINOIS
DEPARTMENT OF TRANSPORTATION

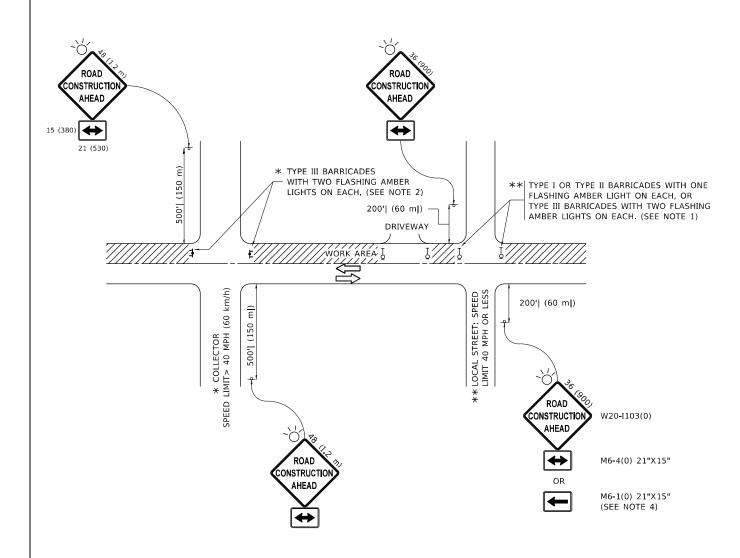

NOTES:

- 1. SIDE ROAD WITH A SPEED LIMIT OF 40 MPH (60 km/h) OR LESS AS SHOWN ON THE DRAWING AND AS DIRECTED BY THE ENGINEER:
- a) ONE "ROAD CONSTRUCTION AHEAD" SIGN 36 x 36 (900x900) WITH A FLASHER MOUNTED ON IT APPROXIMATELY 200' (60 m) IN ADVANCE OF THE MAIN ROUTE.
- b) THE CLOSED PORTION OF THE MAIN ROUTE SHALL BE PROTECTED BY BLOCKING WITH TYPE I, TYPE II OR TYPE III BARRICADES, 1/3 OF THE CROSS SECTION OF THE CLOSED PORTION.
- SIDE ROAD WITH A SPEED LIMIT GREATER THAN 40 MPH (60 km/h) AS SHOWN ON THE DRAWING AND AS DIRECTED BY THE ENGINEER:
- a) ONE "ROAD CONSTRUCTION AHEAD" SIGN 48 x 48 (1.2 m x 1.2 m) WITH A FLASHER MOUNTED ON IT APPROXIMATELY 500' (150 m) IN ADVANCE OF THE MAIN ROUTE.
- THE CLOSED PORTION OF THE MAIN ROUTE SHALL BE PROTECTED BY
 b) BLOCKING WITH TYPE III BARRICADES, 1/2 OF THE CROSS SECTION
 OF THE CLOSED PORTION.
- 3. CONES MAY BE SUBSTITUTED FOR BARRICADES OR DRUMS AT HALF THE SPACING DURING DAY OPERATIONS. CONES SHALL BE A MINIMUM OF 28 (710)
 IN HEIGHT
- WHEN THE SIDE ROAD LIES BETWEEN THE BEGINNING OF THE MAINLINE
 4. SIGNING AND THE WORK ZONE, A SINGLE HEADED ARROW (M6-1) SHALL
 BE USED IN LIEU OF THE DOUBLE HEADED ARROW (M6-4).

- 5. WHEN WORK IS BEING PERFORMED ON A SIDE ROAD OR DRIVEWAY, FOLLOW THE APPLICABLE STANDARD(S). THE DIRECTIONAL ARROW (M6-1 OR M6-4) SHALL BE COVERED OR REMOVED WHEN NO LONGER CONSISTENT WITH THE TRAFFIC CONTROL SET-UP.
- 6. ADVANCE WARNING SIGNS ARE TO BE OMITTED ON DRIVEWAYS UNLESS OTHERWISE SPECIFIED IN THE PLANS OR BY THE ENGINEER
- THE TRAFFIC CONTROL AND PROTECTION FOR SIDE ROADS, INTERSECTIONS, AND DRIVEWAYS SHALL BE INCLUDED IN THE COST OF SPECIFIED TRAFFIC CONTROL STANDARDS OR ITEMS.


All dimensions are in inches (millimeters) unless otherwise shown.

USER NAME = rostkowskir	DESIGNED - L.H.A.	REVISED - A. HOUSEH 10-15-96
	DRAWN -	REVISED - T. RAMMACHER 01-06-00
PLOT SCALE = 100.0000 / in.	CHECKED -	REVISED - A. SCHUETZE 07-01-13
PLOT DATE = 3/19/2021	DATE - 06-89	REVISED _ A. SCHUETZE 09-15-16

STATE OF ILLINOIS
DEPARTMENT OF TRANSPORTATION

•					TION FOR DRIVEWAYS
SCALE: NONE	SHEET 1	OF 1	SHEETS	STA.	TO STA.


	ILLINOIS	FED. AID	PROJECT		
TC-1	CONTRACT	NO. 62	2L2		
3727/DEMPSTER ST	2020-049-	RS&SW	COOK	27	2
F.A.U RTE	SECTION		COUNTY	TOTAL SHEETS	SHI

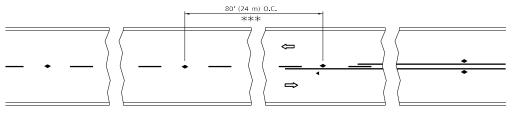


*** REDUCE TO 40' (12 m) O.C. ON CURVES WITH POSTED OR ADVISORY SPEED 45 M.P.H. (70 km/h) OR LESS.


3 @ 40' (12 m) O.C. — 🗢 \Rightarrow LANE REDUCTION TRANSITION

SEE FIGURE 3B-14 MUTCD

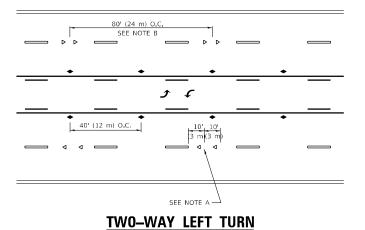

TW0-LANE/TW0-WAY

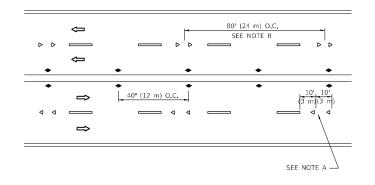


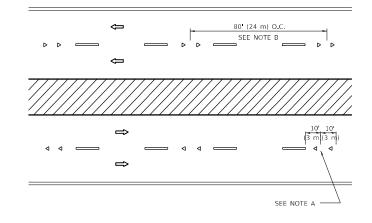


MULTI-LANE/DIVIDED

MULTI-LANE/UNDIVIDED



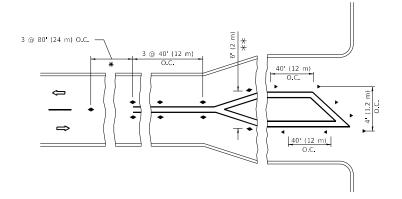

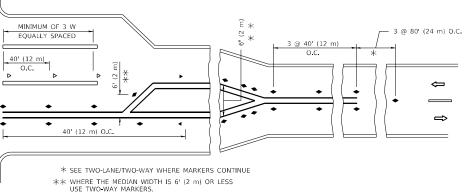

TURN LANES

GENERAL NOTES

- 1. MARKERS USED WITH DASHED LINES SHALL BE CENTERED IN THE GAP BETWEEN SEGMENTS.
- 2. MARKERS USED ADJACENT TO SOLID LINES SHALL BE OFFSET 2 TO 3 (50 TO 75) TOWARD TRAFFIC AS SHOWN.
- 3. MARKERS THROUGH TANGENTS LESS THAN 500' (150 m) IN LENGTH BETWEEN CURVES SHALL BE INSTALLED AT THE LESSER OF THE TWO CURVE SPACINGS.
- 4. MARKERS ARE TO BE USED ADJACENT TO BOTH SOLID WHITE LINES IN DUAL LEFT TURN LANES

LANE MARKER NOTES

- A. USE DOUBLE LANE LINE MARKERS SPACED AS SHOWN.
- B. REDUCE TO 40 (12 m) O.C. ON CURVES WHERE ADVISORY SPEEDS ARE 10 M.P.H (20 km/h) LOWER THAN POSTED SPEEDS.

DESIGN NOTES

- 1. DOUBLE LANE LINE MARKERS SHALL BE USED UNLESS SPECIFIED OTHERWISE.
- 2. EXCEPT AS SHOWN ON THE LANE REDUCTION TRANSITION AND FREEWAY EXIT RAMP DETAIL, MARKERS ARE NOT TO BE SPECIFIED ON RIGHT EDGE LINES.
- 3. THE EXACT MARKER LIMITS, SPACING, AND COLOR SHALL BE INCLUDED IN
- 4. MARKERS SHOULD NOT BE USED ALONGSIDE CURBS EXCEPT FOR EXTREMELY SHORT SECTIONS OF CURBS WHERE NOT MORE THAN TWO MARKERS WOULD BE INVOLVED.

All dimensions are in inches (millimeters) unless otherwise shown.

REVISED - T. RAMMACHER 03-12-99 DESIGNED TYPICAL APPLICATIONS STATE OF ILLINOIS REVISED - T. RAMMACHER 01-06-00 DRAWN RAISED REFLECTIVE PAVEMENT MARKERS (SNOW-PLOW RESISTANT) CHECKED REVISED C. JUCIUS 09-09-09 **DEPARTMENT OF TRANSPORTATION** SHEET 1 OF 1 SHEETS STA. PLOT DATE = 3/19/2021 C. JUCIUS 07-01-13 DATE REVISED -

727/DEMPSTER ST 2020-049-RS&SW COOK 27 23 TC-11 CONTRACT NO. 62L21

SYMBOLS


ONE-WAY AMBER MARKER

TWO-WAY AMBER MARKER

ONE-WAY CRYSTAL MARKER (W/O)

YELLOW STRIPE

■ WHITE STRIPE

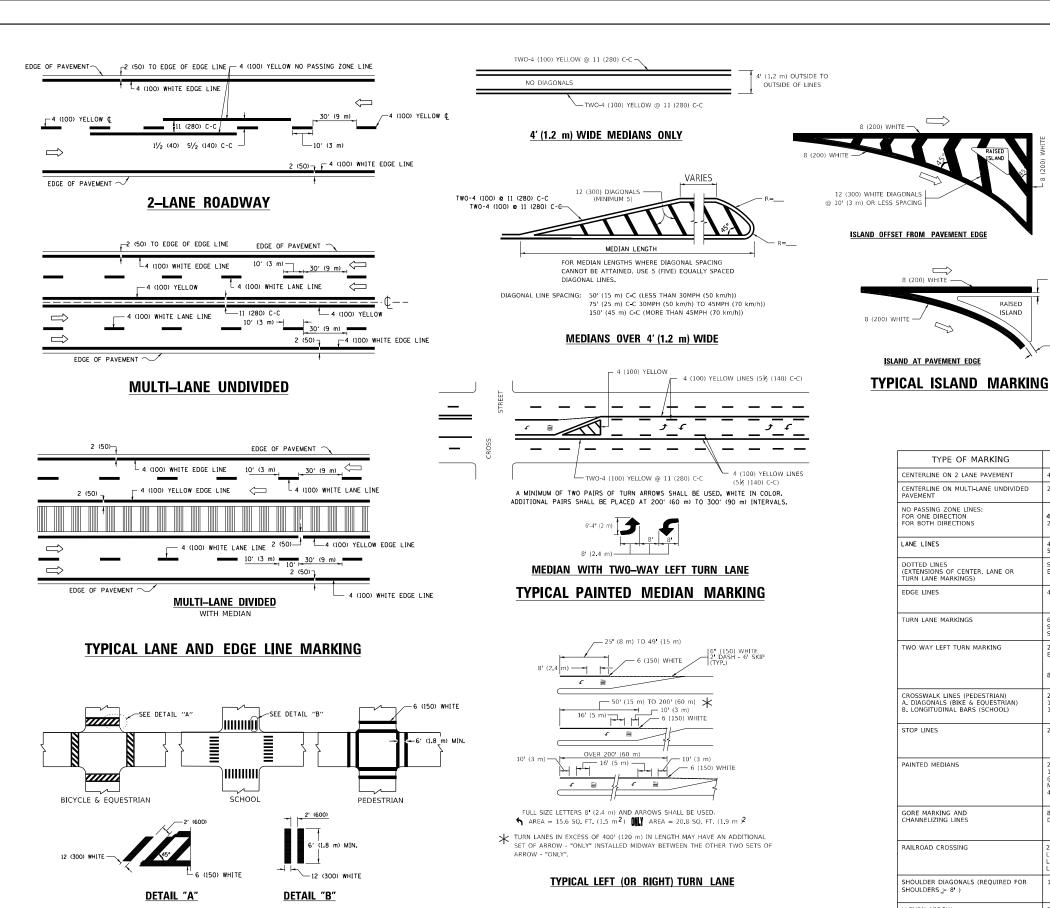

TYPICAL TURN LANE MARKING

D(FT) SPEED LIMIT 580 45 665 50 **COMBINATION** LEFT AND U-TURN 5'-4" (1620) √ 32 R (810) LANE REDUCTION TRANSITION * LANE REDUCTION ARROWS REQUIRED AT SPEEDS OF 45 MPH OR GREATER OR WHEN SPECIFIED IN PLANS. **U-TURN**

TYPE OF MARKING	WIDTH OF LINE	PATTERN	COLOR	SPACING / REMARKS
CENTERLINE ON 2 LANE PAVEMENT	4 (100)	SKIP-DASH	YELLOW	10' (3 m) LINE WITH 30' (9 m) SPACE
CENTERLINE ON MULTI-LANE UNDIVIDED PAVEMENT	2 @ 4 (100)	SOLID	YELLOW	11 (280) C-C
NO PASSING ZONE LINES: FOR ONE DIRECTION FOR BOTH DIRECTIONS	4 (100) 2 @ 4 (100)	SOLID SOLID	YELLOW YELLOW	5½ (140) C-C FROM SKIP-DASH CENTERLINE 11 (280) C-C OMIT SKIP-DASH CENTERLINE BETWEEN
LANE LINES	4 (100) 5 (125) ON FREEWAYS	SKIP-DASH SKIP-DASH	WHITE WHITE	10' (3 m) LINE WITH 30' (9 m) SPACE
DOTTED LINES (EXTENSIONS OF CENTER, LANE OR TURN LANE MARKINGS)	SAME AS LINE BEING EXTENDED	SKIP-DASH	SAME AS LINE BEING EXTENDED	2' (600) LINE WITH 6' (1.8 m) SPACE
EDGE LINES	4 (100)	SOLID	YELLOW-LEFT WHITE-RIGHT	OUTLINE MEDIANS IN YELLOW
TURN LANE MARKINGS	6 (150) LINE; FULL SIZE LETTERS & SYMBOLS (8' (2.4m))	SOLID	WHITE	SEE TYPICAL TURN LANE MARKING DETAIL
TWO WAY LEFT TURN MARKING	2 @ 4 (100) EACH DIRECTION 8' (2.4m) LEFT ARROW	SKIP-DASH AND SOLID IN PAIRS	YELLOW	10' (3 m) LINE WITH 30' (9 m) SPACE FOR SKIP-DASH; 5½ (140) C-C BETWEEN SOLID LINE AND SKIP-DASH LINE SEE TYPICAL TWO-WAY LEFT TURN MARKING DETAIL
CROSSWALK LINES (PEDESTRIAN) A. DIAGONALS (BIKE & EQUESTRIAN) B. LONGITUDINAL BARS (SCHOOL)	2 @ 6 (150) 12 (300) @ 45° 12 (300) @ 90°	SOLID SOLID SOLID	WHITE WHITE WHITE	NOT LESS THAN 6' (1.8 m) APART 2' (600) APART 2' (600) APART 5EE TYPICAL CROSSWALK MARKING DETAILS.
STOP LINES	24 (600)	SOLID	WHITE	PLACE 4' (1.2 m) IN ADVANCE OF AND PARALLEL TO CROSSWALK, IF PRESENT. OTHERWISE, PLACE AT DESIRED STOPPING POINT. PARALLEL TO CROSSROAD CENTERLINE, WHERE POSSIBLE
PAINTED MEDIANS	2 @ 4 (100) WITH 12 (300) DIAGONALS @ 45° NO DIAGONALS USED FOR 4' (1.2 m) WIDE MEDIANS	SOLID	YELLOW: TWO WAY TRAFFIC WHITE: ONE WAY TRAFFIC	11 (280) C-C FOR THE DOUBLE LINE SEE TYPICAL PAINTED MEDIAN MARKING.
GORE MARKING AND CHANNELIZING LINES	8 (200) WITH 12 (300) DIAGONALS @ 45°	SOLID	WHITE	DIAGONALS: 15' (4.5 m) C-C (LESS THAN 30MPH (50 km/h)) 20' (6 m) C-C 30MPH (50 km/h) TO 45MPH (70 km/h)) 30' (9 m) C-C (OVER 45MPH (70 km/h))
RAILROAD CROSSING	24 (600) TRANSVERSE LINES; "RR" IS 6 (1.8 m) LETTERS; 16 (400) LINE FOR "X"	SOLID	WHITE	SEE STATE STANDARD 780001 AREA OF: "R"=3.6 SQ, FT. (0.33 m PEACH "X"=54.0 SQ, FT. (5.0 m PE
SHOULDER DIAGONALS (REQUIRED FOR SHOULDERS > 8')	12 (300) @ 45°	SOLID	WHITE - RIGHT YELLOW - LEFT	50' (15 m) C-C (LESS THAN 30MPH (50 km/h)) 75' (25 m) C-C (30 MPH (50 km/h) TO 45MPH (70 km/h)) 150' (45 m) C-C (OVER 45MPH (70 km/h))
U TURN ARROW	SEE DETAIL	SOLID	WHITE	16.3 SF
2 ARROW COMBINATION LEFT AND U TURN	SEE DETAIL	SOLID	WHITE	30.4 SF

FOR FURTHER DETAILS ON PAVEMENT MARKING REFER TO STANDARD SPECIFICATIONS FOR ROAD AND BRIDGE CONSTRUCTION AND STATE STANDARD 780001.

8 (200) WHITE -

RAISED

All dimensions are in inches (millimeters) unless otherwise shown.

USER NAME = rostkowskir	DESIGNED - EVERS	REVISED - C. JUCIUS 09-09-09
	DRAWN -	REVISED - C. JUCIUS 07-01-13
PLOT SCALE = 100.0000 / in.	CHECKED -	REVISED - C. JUCIUS 12-21-15
PLOT DATE = 3/19/2021	DATE - 03-19-90	REVISED - C. JUCIUS 04-12-16


TYPICAL CROSSWALK MARKING

 $m{\star}$ MARKINGS SHALL BE INSTALLED PARALLEL TO THE CENTERLINE OF THE ROAD WHICH IT CROSSES

STATE OF ILLINOIS **DEPARTMENT OF TRANSPORTATION**

DISTRICT ONE TYPICAL PAVEMENT MARKINGS				F.A.U RTE	SECTION	COUNTY	TOTAL SHEETS	SHEET NO.	
				3727/DEMPSTER ST 2020-049-RS&SW		COOK	27	24	
11110	TYPICAL PAVEINENT INAKKINGS					TC-13 CONTR			2L21
CHEET 1	05 0	CHEETC	CTA	TO CTA					

TURN BAY ENTRANCE AT START OF LANE CLOSURE TAPER

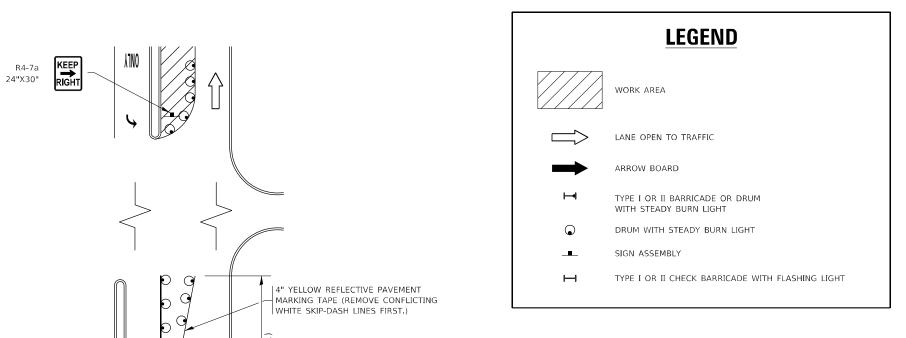

TURN BAY ENTRANCE WITHIN A LANE CLOSURE

PAVEMENT MARKING REMOVAL (TYP.)

CONFLICTING |

14" YELLOW REFLECTIVE PAVEMENT MARKING TAPE (REMOVE CONFLICTING WHITE SKIP-DASH LINES FIRST.)

SEE DETAIL "A"

6" WHITE REFLECTIVE

PAVEMENT MARKING TAPE

FIGURE 2

NOTES:

- 1. A) WHEN "L" IS ≤ THE STORAGE LENGTH OF THE TURN LANE (AS SHOWN IN FIG. 1), USE FIGURE 1.
 - B) WHEN "L" IS > THE STORAGE LENGTH OF THE TURN LANE OR THE TURN LANE IS WITHIN THE LANE CLOSURE, USE FIGURE 2.
- 2. CONES MAY BE SUBSTITUTED FOR BARRICADES OR DRUMS AT HALF THE SPACING DURING DAY OPERATIONS. CONES SHALL BE A MINIMUM OF 28 (710) IN HEIGHT.
- 3. LIGHTS WILL NOT BE REQUIRED ON BARRICADES OR DRUMS FOR DAY OPERATIONS. ALL LIGHTS SHALL BE MONODIRECTIONAL.
- 4. REFLECTIVE TEMPORARY PAVEMENT MARKINGS SHALL BE PLACED THROUGHOUT THE BARRICADED AREAS OF EACH TURN BAY AS SHOWN
- 5. THIS APPLICATION ALSO APPLIES WHEN WORK IS BEING PERFORMED IN THE RIGHT LANE(S) AND THE RIGHT TURN BAY IS TO REMAIN OPEN. UNDER THIS CONDITION, "RIGHT TURN LANE" R3-I100R 24 x 24 (600 x 600)
- 6. THESE CONTROLS SHALL SUPPLEMENT MAINLINE TRAFFIC CONTROL FOR LANE CLOSURES.
- 7. THE SIGNS SHALL BE MOUNTED ABOVE THE BARRICADES/DRUMS
- 8. TRAFFIC CONTROL AND PROTECTION AT TURN BAYS (TO REMAIN OPEN

- ARROW BOARD

WHERE THE CLOSURE TIME IS GREATER THAN FOURTEEN (14) DAYS.

- AND M6-2R 21 x 15 (530 x 380) SHALL BE USED.
- ON SEPARATE SIGN SUPPORTS THAT MEET NCHRP 350 OR MASH PREOUIREMENTS.
- TO TRAFFIC) SHALL BE INCLUDED IN THE COST OF SPECIFIED TRAFFIC CONTROL STANDARDS OR ITEMS.

DETAIL A

R3-I100L

M6-2L

24 x 24 (600 x 600)

21 x 15 (530 x 380)

STABILIZE SIGN SUPPORT WITH

SANDBAGS AS

TURN

All dimensions are in inches (millimeters) unless otherwise shown.

USER NAME = rostkowskir	DESIGNED	- T.	RAMMACHER	09-08-94	REVISED	-	R. BORO 09-14-09
	DRAWN	-	A. HOUSEH	11-07-95	REVISED	- A.	SCHUETZE 07-01-13
PLOT SCALE = 100.0000 / in.	CHECKED	-	A. HOUSEH	10-12-96	REVISED	- A.	SCHUETZE 09-15-16
PLOT DATE = 3/19/2021	DATE	- T	RAMMACHER	01-06-00	REVISED		


FIGURE 1

STATE OF ILLINOIS **DEPARTMENT OF TRANSPORTATION**

TRAF	FIC CON	TROL ANI	D PROTE	CTION AT	T TURN BAYS	F.A.U RTE
	/T0	REMAIN	I OPEN	TO TRAFI	FIC)	3727/DEMPSTER S
	, ,,,	ILLIVIALIN	OILIV	IU IIIAII	110/	TC
SCALE: NONE	SHEET 1	. OF 1	SHEETS	STA.	TO STA.	


ST 2020-049-RS&SW COOK 27 25 CONTRACT NO. 62L21

SEE DETAIL "A"

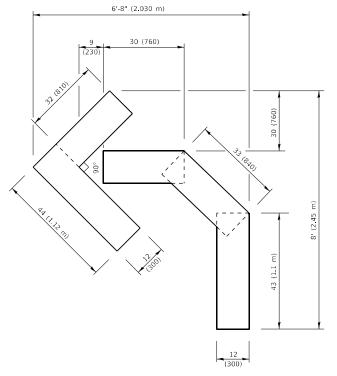


QUANTITY

4 (100) LINE = 45.5 ft. (13.9 m) 15.2 sq. ft. (1.41 sq. m)

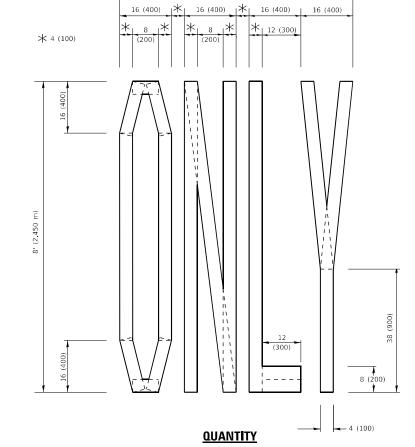

4 (100) LINE = 64.1 ft. (19.5 m) 21.4 sq. ft. (1.99 sq. m)

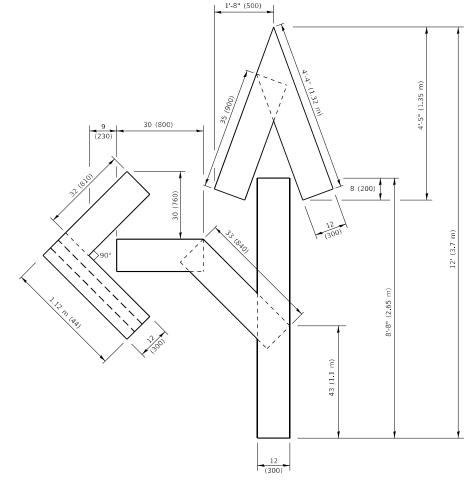


QUANTITY

4 (100) LINE = 82.5 ft. (25.1 m) 27.5 sq. ft. (2.53 sq. m)

NOTE:

ALL QUANTITIES OF PLACEMENT ARE REPRESENTED IN LINEAR FEET OF 4" LINES TO MATCH THE 4" TEMPORARY TAPE PAY ITEM AND REPRESENTS THE TOTAL QUANTITY OF 4" TAPE REQUIRED.

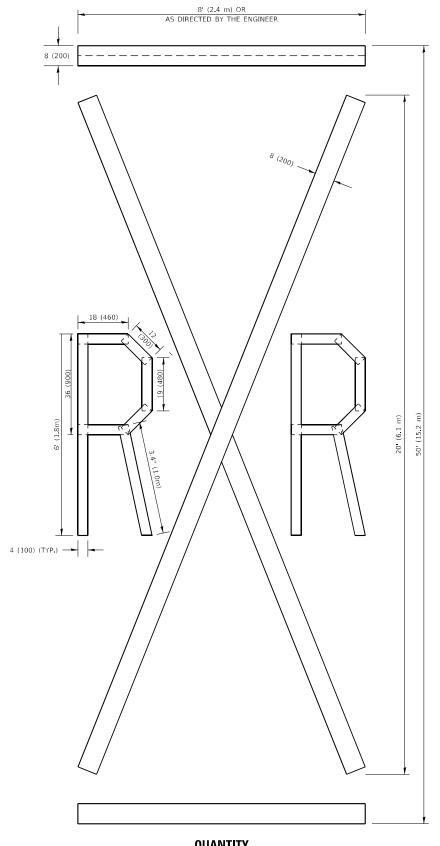

QUANTITY

4 (100) LINE = 225.9 ft. (68.9 m) 75.3 sq. ft. (6.99 sq. m)


> All dimensions are in inches (millimeters) unless otherwise shown.

DESIGNED REVISED - T. RAMMACHER 03-02-98 DRAWN REVISED - E. GOMEZ 08-28-00 CHECKED REVISED - E. GOMEZ 08-28-00 PLOT DATE = 3/19/2021 REVISED - A. SCHUETZE 09-15-16 DATE 09-18-94

STATE OF ILLINOIS **DEPARTMENT OF TRANSPORTATION**

SHORT TERM PAVEMENT MARKING LETTERS AND SYMBOLS SCALE: NONE SHEET 1 OF 1 SHEETS STA.

3727/DEMPSTER ST 2020-049-RS&SW COOK 27 26 TC-16 CONTRACT NO. 62L21

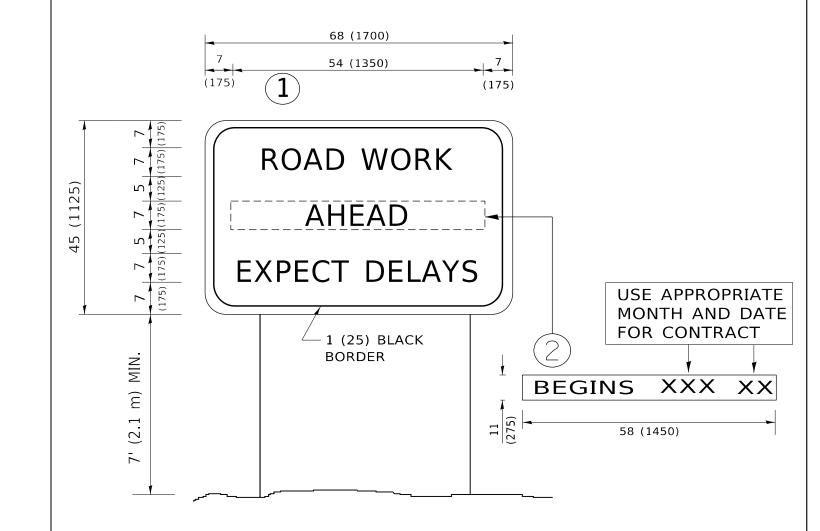

NOTES:

- 1. USE BLACK LETTERING ON ORANGE BACKGROUND.
- 2. ERECT SIGNS IN ADVANCE OF THE LOCATION FOR THE "ROAD CONSTRUCTION AHEAD" SIGN AT LOCATIONS AS DIRECTED BY THE ENGINEER.
- 3. ERECT SIGN 1 WITH INSTALLED PANEL 2 ONE WEEK PRIOR TO THE START OF CONSTRUCTION.
- 4. REMOVE PANEL(2)SOON AFTER THE START OF CONSTRUCTION.
- 5. SEE SPECIAL PROVISION FOR "TEMPORARY INFORMATION SIGNING" FOR ADDITIONAL INFORMATION.
- 6. ONE SIGN ASSEMBLY EQUALS 25.70 SQ. FT. (2.3 SQ. M.)

SCALE: NONE

7. SHALL BE PAID FOR AS TEMPORARY INFORMATION SIGNING.

ALL DIMENSIONS ARE IN INCHES (MILLIMETERS) UNLESS OTHERWISE SHOWN.

USER NAME = rostkowskir	DESIGNED -	REVISED	-	R. MIRS 09-15-97
	DRAWN -	REVISED	-	R. MIRS 12-11-97
PLOT SCALE = 100.0000 / in.	CHECKED -	REVISED	- T.	RAMMACHER 02-02-
PLOT DATE = 3/19/2021	DATE -	REVISED	-	C. JUCIUS 01-31-07

ARTERIAL ROAD				F.A.U RTE. SECTION			COUNTY	COUNTY TOTAL SHEETS		
INFORMATION SIGN		3727/DEMPSTER ST	2020-049	-RS&SW	COOK	27	27			
INFORMATION SIGN			TC-2	22		CONTRACT	NO. 62	2L21		
ET 1	OF 1	SHEETS	STA.	TO STA.		ILLINOIS	FED. AID	PROJECT		