06-11-2021 LETTING ITEM 181

STATE OF ILLINOIS **DEPARTMENT OF TRANSPORTATION** 50 RS-4 ST. CLAIR ILLINOIS CONTRACT NO. 76L14

D-98-022-18

PROPOSED HIGHWAY PLANS

FAP ROUTE 817 (IL 15) SECTION 50 RS-4 PROJECT STP-UEM3(116) **RESURFACING - DESIGNED OVERLAY** ST. CLAIR COUNTY

ADT = 2600 (2017)

FOR INDEX OF SHEETS, SEE SHEET NO. 2

C-98-162-18 **R 7W** R 6W T 1S **PROJECT ENDS** STA 250 + 60 T 2S SN 082-0295 SN 082-0106 ENGINEERING SCALES. REDUCED SIZED PLANS WILL NOT **PROJECT BEGINS** CONFORM TO STANDARD SCALES. IN MAKING MEASUREMENTS STA 126+15 **STATION EQUATION:** ON REDUCED PLANS, THE ABOVE SCALES MAY BE USED. STA 118 + 65.35 EAST =STA 0+00 WEST JOINT UTILITY LOCATION INFORMATION FOR EXCAVATION 1-800-892-0123

PROJECT ENGINEER: HERVE GELIN (618)-346-3179 PROJECT MANAGER: MICHAEL BERG (618)-346-3411 CHASTAIN

GROSS LENGTH = 25,836 FT. = 4.89 MILES NET LENGTH = 25,836 FT. = 4.89 MILES

JEREMY BUENING, P.E., S.E. EXPIRES 11/30/2021

STATE OF ILLINOIS

LOCATION OF SECTION INDICATED THUS: - -

PRINTED BY THE AUTHORITY OF THE STATE OF ILLINOIS

CONTRACT NO. 76L14

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INDEX OF SHEETS

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HIGHWAY STANDARDS

000001-08	STANDARD SYMBOLS, ABBREVIATIONS AND PATTERNS
001001-02	AREAS OF REINFORCEMENT BARS
001006	DECIMAL OF INCH AND OF A FOOT
424001-11	PERPENDICULAR CURB RAMPS
424006-05	DIAGONAL CURB RAMPS
424011-04	CORNER PARALLEL CURB RAMPS FOR SIDEWALKS
442101-09	CLASS B PATCHES
482011-03	HMA SHLD. STRIPS/SHLDS, WITH RESURFACING ON WIDENING AND RESURFACING PROJECTS
606001-07	CONCRETE CURB TYPE B & COMBINATION CONCRETE CURB AND GUTTER
630001-12	STEEL PLATE BEAM GUARDRAIL
630101-10	STRONG POST GUARDRAIL ATTACHED TO CULVERT
630301-09	SHOULDER WIDENING FOR TYPE 1 (SPECIAL) GUARDRAIL TERMINALS
701001-02	OFF-RD OPERATIONS, 2L, 2W, MORE THAN 15' (4.5M) AWAY
701006-05	OFF-RD OPERATIONS, 2L, 2W, 15' TO 24" FROM PAVEMENT EDGE
701201-05	LANE CLOSURE, 2L, 2W DAY ONLY, FOR SPEEDS \geq 45 MPH
701306-04	LANE CLOSURE, 2L, 2W SLOW MOVING OPERATIONS DAY ONLY, FOR SPEEDS \geq 45 MPH
701311-03	LANE CLOSURE, 2L, 2W MOVING OPERATIONS - DAY ONLY
701321-18	LANE CLOSURE, 2L, 2W, BRIDGE REPAIR WITH BARRIER
701336-07	LANE CLOSURE, 2L, 2W, WORK AREAS IN SERIES, FOR SPEEDS \geq 45 MPH
701501-06	URBAN LANE CLOSURE, 2L, 2W, UNDIVIDED
701801-06	SIDEWALK, CORNER OR CROSSWALK CLOSURE
701901-08	TRAFFIC CONTROL DEVICES
725001-01	OBJECT AND TERMINAL MARKERS
780001-05	TYPICAL PAVEMENT MARKINGS
781001-04	TYPICAL APPLICATIONS RAISED REFLECTIVE PAVEMENT MARKERS
782006-01	GUARDRRAIL AND BARRIER WALL REFLECTOR MOUNTING DETAILS

USER NAME = jbuening	DESIGNED	-	JKP	REVISED -
	DRAWN	-	DMW	REVISED -
PLOT SCALE = 40.0000 ' / in.	CHECKED	-	JMB	REVISED -
PLOT DATE = 3/15/2021	DATE	-	03/12/21	REVISED -

SCALE:

	INDEX C	F SHEE	TS AND	STAN	DARDS	F.A. RTE.	SECTION		COUNTY	TOTAL SHEETS	
FAP 817 (IL 15)			817	50RS-4		ST. CLAIR	37	2			
						CONTRACT	NO. 76	5L14			
	SHEET 1	OF 1	SHEETS	STA.	TO STA.		ILLINOIS	FED. A	ID PROJECT		

GENERAL NOTES

- ALL ELEVATIONS ARE BASED ON NAVD 88 DATUM. THE PROPOSED GRADE ELEVATIONS SHOWN ON THE PLANS ARE THE ELEVATIONS FOR THE FINISHED SURFACE AT THE LOCATIONS INDICATED.
- 2. LOCATION OF EXISTING UTILITIES HAVE NOT BEEN LOCATED. IT SHALL BE THE RESPONSIBILITY OF THE CONTRACTOR TO DETERMINE THEIR EXACT LOCATIONS FROM THE UTILITY COMPANY AND BY FIELD INSPECTION. THE CONTRACTOR IS REQUIRED TO CONTACT J.U.L.I.E. AT 1-800-892-0123 PRIOR TO PROCEEDING WITH ANY EXCAVATION AND WORK ON THE PROJECT.
- 3. ACCESS TO ALL ENTRANCES AND SIDE ROADS SHALL BE MAINTAINED AT ALL TIMES.
- 4. THE ILLINOIS DEPARTMENT OF TRANSPORTATION STRONGLY ENCOURAGES THE PRIME CONTRACTOR AND THEIR APPROVED SUB-CONTRACTORS TO HIRE MINORITY, WOMEN AND DISADVANTAGED INDIVIDUALS FROM ITS FEDERALLY FUNDED HIGHWAY CONSTRUCTION CAREERS TRAINING PROGRAM (HCCTP) TO HELP MEET WORKFORCE AND TRAINEE GOALS. THIS PROGRAM IS TRAINING MINORITIES, WOMEN AND DISADVANTAGED INDIVIDUALS IN HIGHWAY CONSTRUCTION-RELATED SKILLS, E.G. MATH FOR TRADES, JOB READINESS, TECHNICAL SKILLS COURSEWORK (CARPENTRY, CONCRETE FLATWORK, BLUEPRINT READING, SITE PLANS, SITE WORK, TOOLS USE, ETC.) AND OSHA 10 HOUR CERTIFICATION, TO PREPARE THEM FOR A CAREER IN HIGHWAY CONTRUCTION TRADES. GRADUATES ARE WELL-TRAINED AND READY TO BECOME PRODUCTIVE ENTRY-LEVEL CONTRUCTION WORKERS, CONTACT THE DISTRICT 8 EEO OFFICE AT 618-346-3360 OR THE HCCTP COORDINATOR AT 618-874-6528 TO LEARN MORE ABOUT THE PROGRAM AND FOR ASSISTANCE IN MEETING WORKFORCE AND TRAINEE GOALS.
- IF THE PROPOSED SURFACE REMOVAL ON THIS PROJECT PRODUCES A MILLED EDGE NEAR CENTERLINE GREATER
 THAN 1.5 INCHES OR IF THE PROPOSED RESURFACING RESULTS IN AN ELEVATION DIFFERENCE GREATER THAN
 2 INCHES NEAR THE CENTERLINE BETWEEN ADJACENT OPEN LANES OF TRAFFIC, ONE OF THE FOLLOWING SHALL APPLY:
 - -THE CONTRACTOR SHALL ORGANIZE THE WORK TO AVOID THE ELEVATION DIFFERENCES MENTIONED ABOVE.
 - -THE CONTRACTOR SHALL CONSTRUCT A TEMPORARY HOT MIX ASHALT WEDGE ALONG THE CENTERLINE TO AVOID THE ELEVATION DIFFERENCES MENTIONED ABOVE.
 - -THE CONTRACTOR SHALL CONSTRUCT A MILLED SLOPE EDGE (MINIMUM 1:3) ALONG THE CENTERLINE TO AVOID THE ELEVATION DIFFERENCES MENTIONED ABOVE.

THE COST OF THIS WORK SHALL BE INCLUDED IN THE COST PER SQUARE YARD FOR HOT-MIX ASPHALT SURFACE REMOVAL OF THE DEPTH SPECIFIED IN THE COST PER TON FOR THE HOT-MIX ASPHALT RESURFACING MIXES SPECIFIED IN THE PLANS.

- 6. THE CONTRACTOR SHALL ORGANIZE THE WORK ON THIS PROJECT TO AVOID A DROP OFF BETWEEN ADJACENT OPEN LANES OF TRAFFIC GREATER THAN 2 INCHES.
- 7. THE DEPARTMENT STRONGLY ENCOURAGES THE PRIME CONTRACTOR AND THEIR APPROVED SUB-CONTRACTORS TO HIRE MINORITY, WOMEN, AND DISADVANTAGED INDIVIDUALS FROM ITS FEDERALLY FUNDED HIGHWAY CONSTRUCTION CAREERS TRAINING PROGRAM (HCCTP) TO HELP MEET WORKFORCE AND TRAINEE GOALS. THIS PROGRAM IS TRAINING MINORITIES, WOMEN, AND DISADVANTAGED INDIVIDUALS IN HIGHWAY CONSTRUCTION-RELATED SKILLS, E.G., MATH FOR THE TRADES, JOB READINESS, TECHNICAL SKILLS COURSEWORK (CARPENTRY, CONCRETE FLATWORK, BLUEPRINT READING, SITE PLANS, SITE WORK, TOOLS USE, ETC.) AND OSHA 10 HOUR CERTIICATION, TO PREPARE THEM FOR A CAREER IN THE HIGHWAY CONSTRUCTION TRADES. GRADUATES ARE WELL-TRAINED AND READY TO BECOME PRODUCTIVE ENTRY-LEVEL CONSTRUCTION WORKERS. CONTACT THE DISTRICT 8 EEO OFFICE AT 618-346-3360 AND/OR THE HCCTP COORDINATOR AT 618-874-6528 TO LEARN MORE ABOUT THE PROGRAM AND FOR ASSISTANCE IN MEETING WORKFORCE AND TRAINEE GOALS.

- THE CONTRACTOR SHALL MILL THROUGH THE CONCRETE PATCHES IN ACCORDANCE WITH SECTION 440 OF THE SSRB. THIS WORK WILL BE INCLUDED IN THE COST FOR HOT-MIX ASPHALT SURFACE REMOVAL, 3 3/4".
- THE PAY ITEM TEMPORARY RAMP HAS BEEN INCLUDED FOR THE CONSTRUCTION OF TEMPORARY RAMPS IN ACCORDANCE WITH ARTICLE 406.08 OF THE SSRB. THE COST SHALL INCLUDE BOTH THE INSTALLATION AND THE REMOVAL OF THE TEMPORARY RAMPS.
- 10. A UNIFORMLY STRAIGHT SAW CUT SHALL BE MADE AT LOCATIONS WHERE PROPOSED NEW CONSTRUCTION WILL ABUT EXISTING HOT-MIX ASPHALT SURFACES. THE SAW CUT SHALL BE MADE THE SAME DEPTH AS THE HOT-MIX ASPHALT SURFACE REMOVAL. THIS WORK WILL BE CONSIDERED INCLUDED IN THE COST OF THE CONTRACT ITEMS INVOLVED AND NO EXTRA COMPENSATION WILL BE ALLOWED.
- 11. THE USE OF VIBRATORY ROLLERS IS PROHIBITED WITHIN THE CITY LIMITS OF FAYETTEVILLE. THIS DOES NOT RELIEVE THE CONTRACTOR OF DENSITY REQUIREMENTS FOR THE CONSTRUCTION OF THE BITUMINOUS PAVEMENTS AS SPECIFIED IN SECTIONS 406 & 407 OF THE STANDARD SPECIFICATIONS.
- 12. MTD CAN OPERATE IN AN UNLOADED CONDITION ON SN 082-0106 AND 082-0295
- 13. THE FOLLOWING MIXTURE REQUIREMENTS ARE APPLICABLE TO THIS PROJECT:

MIXTURE USE:	SURFACE COURSE	BINDER COURSE	SHOULDERS (lower)	SHOULDERS (surface)
AC/PG:	PG 64-22	PG 64-22	PG 64-22	PG 64-22
RAP % (MAX)	SEE SPECIAL PROVISIONS	SEE SPECIAL PROVISIONS	SEE SPECIAL PROVISIONS	SEE SPECIAL PROVISIONS
DESIGN AIR VOIDS:	4.0% @ Ndes=70	4.0% @ Ndes=70	4.0% @ Ndes=30	4.0% @ Ndes=30
MIXTURE COMPOSITION:	IL-9.5	IL-19.0	IL 19.0L	IL 9.5L
FRICTION AGGREGATE:	MIXTURE "C"	MIXTURE "B"		
QUALITY MANAGEMENT PROGRAM:	QCP	QCP	QC/QA	QC/QA

PLAN QUANTITIES FOR BITUMINOUS CONCRETE SURFACE COURSE ITEMS ARE CALCULATED USING A UNIT WEIGHT OF 112 LBS/SQ YD/INCH

COMMITMENTS

NONE

CHASTA	
& ASSOCIATES	S LLC

USER NAME = jbuening	DESIGNED -	JKP	REVISED -
	DRAWN -	DMW	REVISED -
PLOT SCALE = 40.0000 / in	CHECKED -	JMB	REVISED -
PLOT DATE = 3/15/2021	DATE -	03/12/21	REVISED -

GENERAL NOTES	F.A. RTE	SECTION		COUNTY	TOTAL SHEETS	SHEET NO.
FAP 817 (JL 15)	817	50RS-4		ST. CLAIR	37	3
1AI 017 (IL 13)				CONTRACT	NO. 76	5L14
SHEET 1 OF 1 SHEETS STA. TO STA.		ILLINOIS	FED. AID	PROJECT		

			_	CONSTRUCTION CODE		
				ROADWAY	BRIDGE	BRIDGE
CODE			TOTAL	0005	0059	0047
NO.	ITEM	UNIT	QUANTITY	0003	082-0106	082-0295
110.		- ONT	COANTITI		002 0100	
40600290	BITUMINOUS MATERIALS (TACK COAT)	POUND	52862	52543		319
40600990	TEMPORARY RAMP	SQ YD	75	75		
40603085	HOT-MIX ASPHALT BINDER COURSE, IL-19.0, N70	TON	8663	8650	13	
40603592	POLYMERIZED HOT-MIX ASPHALT SURFACE COURSE, IL-9.5FG, N70	TON	109		9	100
40604052	HOT-MIX ASPHALT SURFACE COURSE, IL-9.5, MIX "C", N70	TON	5767	5767		
42400200	PORTLAND CEMENT CONCRETE SIDEWALK 5 INCH	SQ FT	287	287		
						_
42400800	DETECTABLE WARNINGS	SQ FT	36	36		
44000164	HOT-MIX ASPHALT SURFACE REMOVAL, 3 3/4"	SQ YD	73343	73246	97	
44000500	COMBINATION CURB AND GUTTER REMOVAL	FOOT	82	82		
44000600	SIDEWALK REMOVAL	SO FT	385	385		
44201043	CLASS B PATCHES, TYPE II. 16 INCH	SQ YD	56	56		
44201047	CLASS B PATCHES, TYPE III, 16 INCH	SQ YD	33. 8	33. 8		
						_
44201048	CLASS B PATCHES, TYPE IV, 16 INCH	SQ YD	66. 7	66. 7		_
						_
48102100	AGGREGATE WEDGE SHOULDER, TYPE B	TON	955	955		

CHASTAIN & ASSOCIATES LLC CONSULTING ENGINEERS

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		DRAWN	-	DMW	REVISED	-
. [PLOT SCALE = 100.0000 ' / in-	CHECKED	-	JMB	REVISED	-
٠	PLOT DATE = 3/16/2021	DATE	-	03/12/21	REVISED	-

STATE OF ILLINOIS
DEPARTMENT OF TRANSPORTATION

SCALE:

SUMMARY OF QUANTITIES		F.A. RTE.	SECTION	COUNTY	TOTAL SHEETS	SHEET NO.
FAP 817 (IL 15)		817	50RS-4	ST. CLAIR	37	4
1 Al 017 (IL 13)				CONTRACT	NO. 76	5L14
SHEET 1 OF 5 SHEETS STA.	TO STA.		ILLINOIS FED. A	ID PROJECT		

CONSTRUCTION CODE

DT-MIX ASPHALT SHOULDERS DNCRETE REMOVAL DNCRETE SUPERSTRUCTURE	UNIT TON CU YD	TOTAL OUANTITY	ROADWAY 0005	BRIDGE 0059 082-0106	BRIDGE 0047 082-0295
DT-MIX ASPHALT SHOULDERS DNCRETE REMOVAL	TON CU YD	QUANTITY 1930	0005	0059	0047
DT-MIX ASPHALT SHOULDERS DNCRETE REMOVAL	TON CU YD	QUANTITY 1930			
DT-MIX ASPHALT SHOULDERS DNCRETE REMOVAL	TON CU YD	1930	1930	082-0106	082-0295
DNCRETE REMOVAL	CU YD		1930		
DNCRETE REMOVAL	CU YD		1930		
		17. 1			
DNCRETE SUPERSTRUCTURE	CU YD				17.1
ONCRETE SUPERSTRUCTURE	CU YD				
		19. 2			19. 2
INFORCEMENT BARS. EPOXY COATED	POUND	2430			2430
		2 700			
AR SPLICERS	EACH	32			32
REFORMED JOINT STRIP SEAL	FOOT	95.5			95.5
ATERPROOFING MEMBRANE SYSTEM	SQ YD	1417			1417
DMBINATION CONCRETE CURB AND GUTTER, TYPE B-6.18	FOOT	37	37		
TEEL PLATE BEAM GUARDRAIL, TYPE A, 6 FOOT POSTS	FOOT	150	150		
TRONG POST GUARDRAIL ATTACHED TO CULVERT	FOOT	75	75		
RAFFIC BARRIER TERMINAL, TYPE 1 (SPECIAL) TANGENT	EACH	4	4		
JARDRAIL REMOVAL	FOOT	344	344		
WOLNESDY C. ELELD. OFFICE. TYPE A	24				
NGINEER S FIELD UFFICE, ITPE A	CAL MO	ρ	ь		
DBILIZATION	L SUM	1	1		
ARRA ARRANGE	TERPROOFING MEMBRANE SYSTEM MBINATION CONCRETE CURB AND GUTTER, TYPE B-6.18 TEL PLATE BEAM GUARDRAIL, TYPE A, 6 FOOT POSTS RONG POST GUARDRAIL ATTACHED TO CULVERT AFFIC BARRIER TERMINAL, TYPE 1 (SPECIAL) TANGENT ARDRAIL REMOVAL GINEER'S FIELD OFFICE, TYPE A	R SPLICERS EACH FOOT FORMED JOINT STRIP SEAL FOOT FERPROOFING MEMBRANE SYSTEM SO YD ABINATION CONCRETE CURB AND GUTTER, TYPE B-6.18 FOOT FELL PLATE BEAM GUARDRAIL, TYPE A, 6 FOOT POSTS FOOT RONG POST GUARDRAIL ATTACHED TO CULVERT FOOT AFFIC BARRIER TERMINAL, TYPE 1 (SPECIAL) TANGENT EACH RODRAIL REMOVAL FOOT GINEER'S FIELD OFFICE, TYPE A CAL MO	R SPLICERS EACH 32 FOOT 95.5 ERPROOFING MEMBRANE SYSTEM SO YD 1417 ABINATION CONCRETE CURB AND GUTTER, TYPE B-6.18 FOOT 37 FEL PLATE BEAM GUARDRAIL, TYPE A, 6 FOOT POSTS FOOT 150 RONG POST GUARDRAIL ATTACHED TO CULVERT FOOT 75 AFFIC BARRIER TERMINAL, TYPE 1 (SPECIAL) TANGENT EACH 4 SINEER'S FIELD OFFICE, TYPE A CAL MO 6	EACH 32 FORT 95.5 FERPROOFING MEMBRANE SYSTEM SO YD 1417 MBINATION CONCRETE CURB AND GUTTER, TYPE B-6.18 FOOT 37 37 FEL PLATE BEAM GUARDRAIL, TYPE A, 6 FOOT POSTS FOOT 150 FOOT 75 75 AFFIC BARRIER TERMINAL, TYPE 1 (SPECIAL) TANGENT FOOT 344 A SINEER'S FIELD OFFICE, TYPE A CAL MO 6 6	EACH 32 FORMED JOINT STRIP SEAL FOOT 95.5 EERPROOFING MEMBRANE SYSTEM SO YD 1417 ABINATION CONCRETE CURB AND GUTTER, TYPE B-6.18 FOOT 37 37 FEL PLATE BEAM GUARDRAIL, TYPE A, 6 FOOT POSTS FOOT 150 RONG POST GUARDRAIL ATTACHED TO CULVERT FOOT 75 75 FOOT 344 4 GRORALL REMOVAL FOOT 344 SINEER'S FIELD OFFICE, TYPE A CAL MO 6 6

* SPECIALTY ITEM



USER NAME = jbuening	DESIGNED	-	JKP	REVISED -
	DRAWN	-	DMW	REVISED -
PLOT SCALE = 100.0000 ' / in.	CHECKED	-	JMB	REVISED -
PLOT DATE = 3/16/2021	DATE	-	03/12/21	REVISED -

	SUMMARY OF QUANTITIES FAP 817 (IL 15)							F.A. RTE.	SECTION	COUNTY	TOTAL	SHEET NO.
								817	50RS-4	ST. CLAIR	37	5
					017 (IL	13)				CONTRACT	NO. 76	5L14
	SHEET 2 OF 5 SHEETS STA.				SHEETS	STA.	TO STA.		ILLINOIS FED. A	ID PROJECT		

CONSTRUCTION CODE

				ROADWAY	BRIDGE	BRIDGE
CODE			TOTAL	0005	0059	0047
NO.	ITEM	UNIT	OUANTITY		082-0106	082-0295
70100405	TRAFFIC CONTROL AND PROTECTION, STANDARD 701321	EACH	1			1
70100450	TRAFFIC CONTROL AND PROTECTION, STANDARD 701201	L SUM	1		1	
70100460	TRAFFIC CONTROL AND PROTECTION, STANDARD 701306	L SUM	1	1		
70100600	TRAFFIC CONTROL AND PROTECTION, STANDARD 701336	L SUM	1	1		
70102620	TRAFFIC CONTROL AND PROTECTION, STANDARD 701501	L SUM	1	1		<u> </u>
.0102020			•	•		<u> </u>
70102640	TRAFFIC CONTROL AND PROTECTION, STANDARD 701801	L SUM	1	1		
70103815	TRAFFIC CONTROL SURVEILLANCE	CAL DA	40			40
70106500	TEMPORARY BRIDGE TRAFFIC SIGNALS	EACH	1			1
70106700	TEMPORARY RUMBLE STRIPS	EACH	12			12
70107025	CHANGEABLE MESSAGE SIGN	CAL DA	60	60		
70700100	SHORT TERM PAVEMENT MARKING	F00T	31060	21000		
70300100	SHOUT IFUM LAAEMENT MAUVING	FOOT	21060	21060		<u> </u>
70300150	SHORT TERM PAVEMENT MARKING REMOVAL	SQ FT	7020	7020		
						<u>, </u>
70300220	TEMPORARY PAVEMENT MARKING - LINE 4"	FOOT	70677	70677		
70300240	TEMPORARY PAVEMENT MARKING - LINE 6"	FOOT	1350			1350

CHASTAIN
& ASSOCIATES LLC
CONSULTING ENGINEERS

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SCALE:

SHEET

SU	MMA	RY	OF QU	ANTITIE	S	F.A. RTE.	SEC	TION		COUNTY	TOTAL SHEETS	SHEET NO.
	F/	۱D	917 /II	15\		817	50P	S-4		ST. CLAIR	37	6
	FAP 817 (IL 15)							CONTRACT	NO. 76	5L14		
3	OF	5	SHEETS	STA.	TO STA.			ILLINOIS	FED. AI	D PROJECT		

CONSTRUCTION CODE

E: I:\IDOT\7102 D8 Var Var\WO6 - IL15 3P Overlay\CADD\CADD

				-			
					ROADWAY	BRIDGE	BRIDGE
COL	DE			TOTAL	0005	0059	0047
NO		ITEM	UNIT	QUANTITY		082-0106	082-0295
	-	1.5					
70300	0280	TEMPORARY PAVEMENT MARKING - LINE 24"	FOOT	25	25		
70300	0904	PAVEMENT MARKING TAPE, TYPE IV 4"	FOOT	2980			2980
70300	0924	PAVEMENT MARKING TAPE, TYPE IV 24"	FOOT	48			48
70400	0100	TEMPORARY CONCRETE BARRIER	FOOT	675			675
70400	0200	RELOCATE TEMPORARY CONCRETE BARRIER	FOOT	675			675
70600	0260	IMPACT ATTENUATORS, TEMPORARY (FULLY REDIRECTIVE, NARROW), TEST LEV	^{/EL} EACH	2			2
70600	0332	IMPACT ATTENUATORS, RELOCATE (FULLY REDIRECTIVE, NARROW), TEST LEVE	L EACH	2			2
72501	1000	TERMINAL MARKER - DIRECT APPLIED	EACH	4	4		
78000	200	THERMOPLASTIC PAVEMENT MARKING - LINE 4"	F00T	70677	70677		
78000	0650	THERMOPLASTIC PAVEMENT MARKING - LINE 24"	FOOT	25	25		
78000	7630	INCRMOPLASTIC PAVEMENT MARKING - LINE 24	7001	25	25		
78100	0100	RAISED REFLECTIVE PAVEMENT MARKER	EACH	325	325		
78200	0005	GUARDRAIL REFLECTORS, TYPE A	EACH	8	8		
78200	0011	BARRIER WALL REFLECTORS, TYPE C	EACH	112			112
78300	0200	RAISED REFLECTIVE PAVEMENT MARKER REMOVAL	EACH	325	325		

* SPECIALTY ITEM



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SCALE:

SUMMARY OF QUANTITIES							SECTION	COUNTY	TOTAL	SHE
301			317 (IL			RTE. 817	50RS-4	ST. CLAIR	37	7
	- ' ^) \ \ \ \ \	13)				CONTRACT	NO. 76	5L14
HEET 4 OF 5 SHEETS STA. TO STA.				STA.	TO STA.		(ILLINOIS FED. A	ID PROJECT		

CONSTRUCTION CODE

				ROADWAY	BRIDGE	BRIDGE
CODE			TOTAL	0005	0059	0047
NO.	ITEM	UNIT	QUANTITY		082-0106	082-0295
78300202	PAVEMENT MARKING REMOVAL - WATER BLASTING	SO FT	23613	23613		
X2010505	CLEARING, SPECIAL	L SUM	1			1
X5870015	BRIDGE DECK CONCRETE SEALER	SO FT	3339		292	3047
X7030005	TEMPORARY PAVEMENT MARKING REMOVAL	SO FT	23613	23613		
Z0013798	CONSTRUCTION LAYOUT	L SUM	1	1		
Z0016002	DECK SLAB REPAIR (FULL DEPTH, TYPE II)	SQ YD	151.1		1. 1	150
Z0016200	DECK SLAB REPAIR (PARTIAL)	SO YD	200			200
Z0033700	LONGITUDINAL JOINT SEALANT	FOOT	26192	25837		355
Z0034105	MATERIAL TRANSFER DEVICE	TON	14539	14417	22	100
			4500	4500		
Z0076600	TRAINEES	HOUR	1500	1500		
Z0076604	TRAINEES TRAINING PROGRAM GRADUATE	HOUR	1500	1500		

Ø 0042

CHASTAIN & ASSOCIATES LLC CONSULTING ENGINEERS


USER NAME = jbuening	DESIGNED	-	JKP	REVISED -
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STATE OF ILLINOIS DEPARTMENT OF TRANSPORTATION

SCALE:

		SU	ММА	RY	OF QU	ANTITIE	S	F.A. RTE.	SECTION	COUNTY	TOTAL SHEETS	SHEET NO.
			F/	۱D	917 /II	15\		817	50RS-4	ST. CLAIR	37	8
		FAP 817 (IL 15)								CONTRACT	NO. 70	5L14
SHEET 5 OF 5 SHEETS STA. TO STA.						STA.	TO STA.		ILLINOIS FED. A	AID PROJECT		

CONSTRUCTION CODE

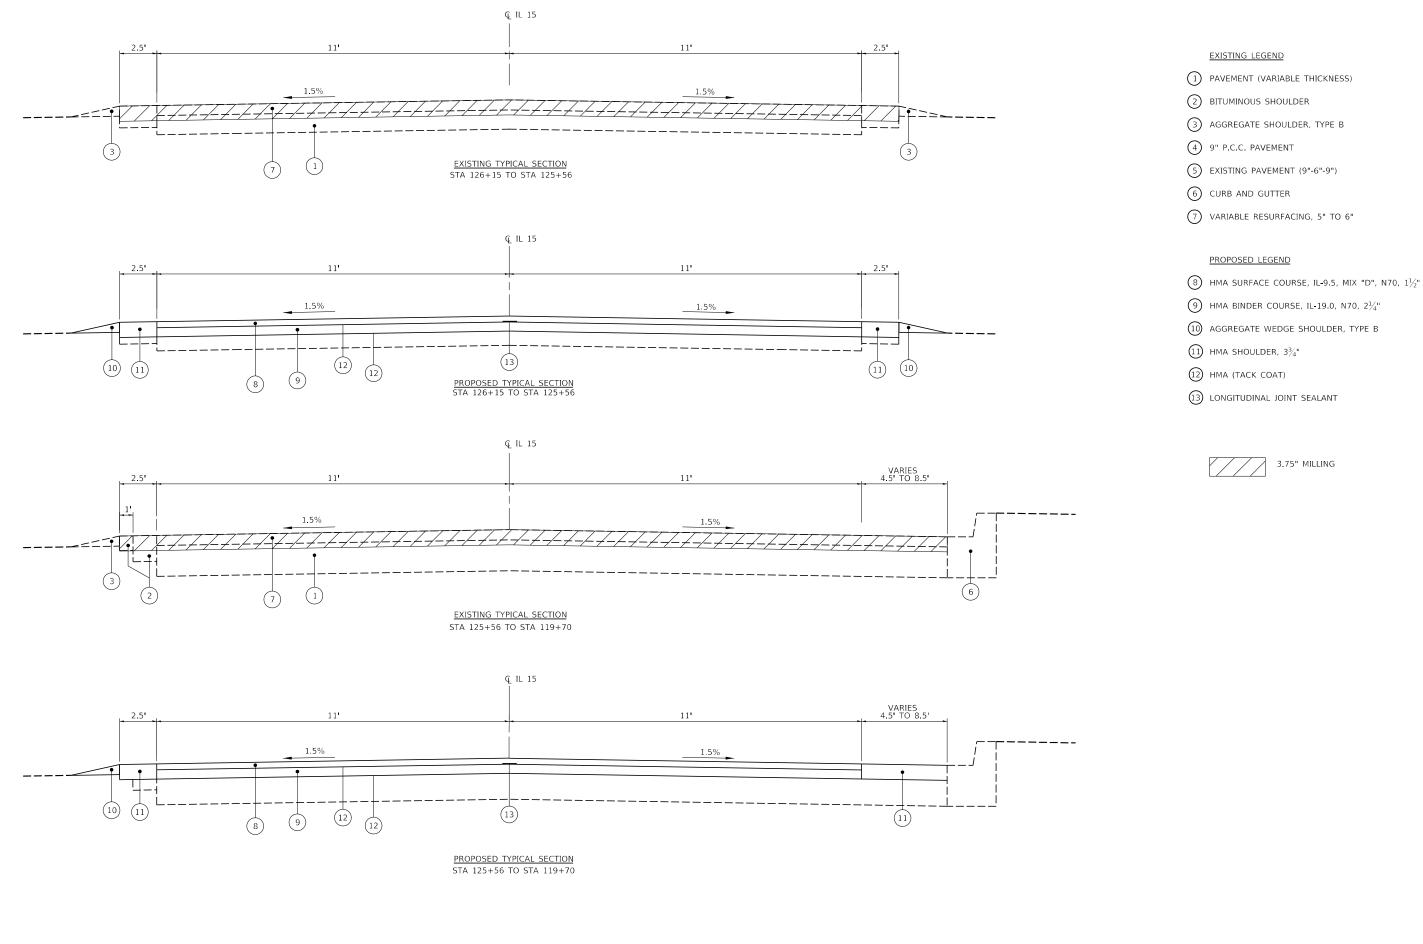

FILE NAME: EXIDOT/710

CHASTAIN & ASSOCIATES LLC

STATE OF ILLINOIS
DEPARTMENT OF TRANSPORTATION


TYPICAL SECTIONS
FAP 817 (IL 15)

SHEET 1 OF 2 SHEETS STA. TO STA.

F.A. SECTION COUNTY TOTAL SHEET'S NO.

817 50RS-4 ST. CLAIR 37 9

CONTRACT NO. 76L14

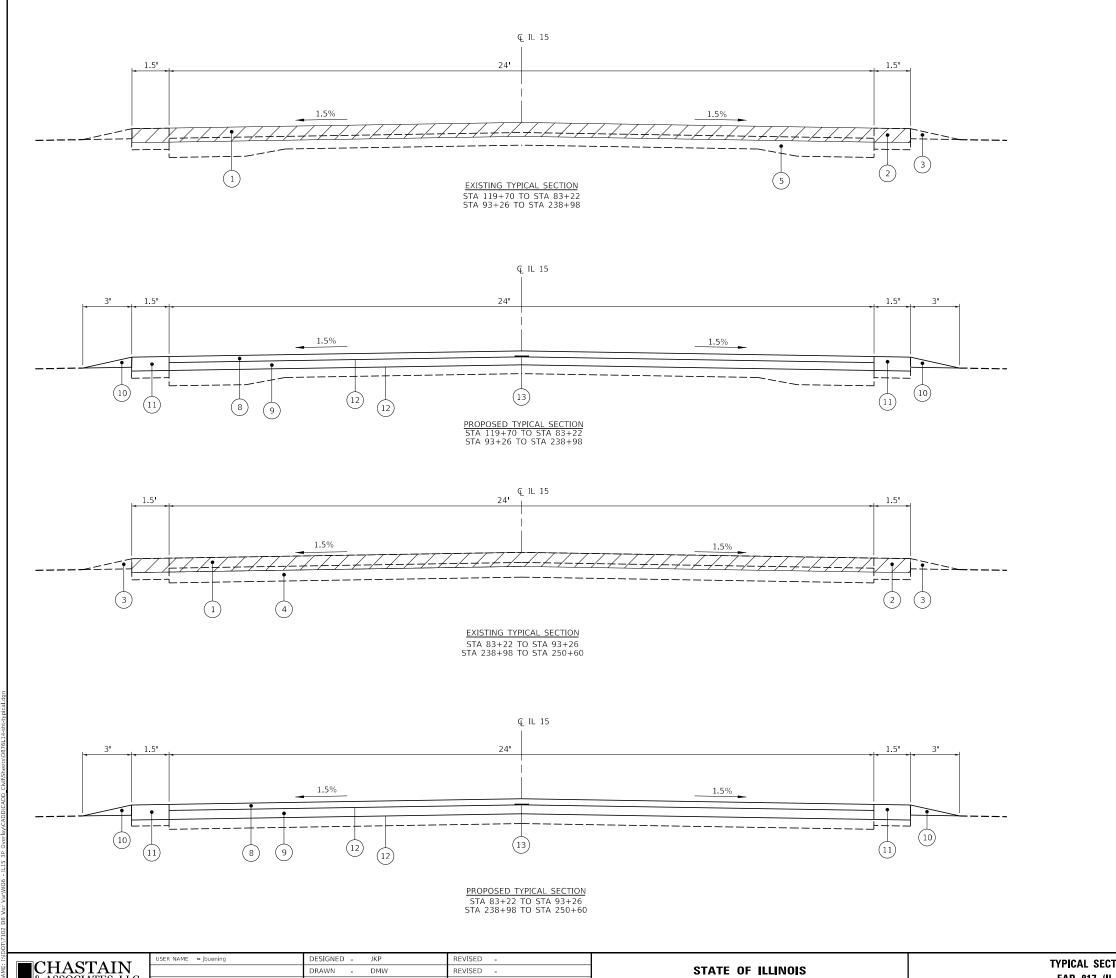

EXISTING LEGEND

1 PAVEMENT (VARIABLE THICKNESS)

2 BITUMINOUS SHOULDER

3 AGGREGATE SHOULDER, TYPE B

4 9" P.C.C. PAVEMENT

5 EXISTING PAVEMENT (9"-6"-9")

6 CURB AND GUTTER

7) VARIABLE RESURFACING, 5" TO 6"

PROPOSED LEGEND

8 HMA SURFACE COURSE, IL-9.5, MIX "D", N70, $1\frac{1}{2}$ "

9 HMA BINDER COURSE, IL-19.0, N70, $2\frac{1}{4}$ "

10 AGGREGATE WEDGE SHOULDER, TYPE B

11) HMA SHOULDER, 3¾"

12) HMA (TACK COAT)

(13) LONGITUDINAL JOINT SEALANT

3.75" MILLING

CHASTAIN & ASSOCIATES LLC

LOT SCALE = 2.0000 / in. CHECKED -REVISED -REVISED -03/12/21

DEPARTMENT OF TRANSPORTATION

TYPICAL SECTIONS FAP 817 (IL 15) SHEET 2 OF 2 SHEETS STA. TO STA. SECTION ST. CLAIR 37 10 50RS-4 CONTRACT NO. 76L14

PAVING SCHEDULE

LC	OCATIO	N	LENGTH	WIDTH	HMA SURFACE REMOVAL 3 3/4"	BITUMINOUS MATERIALS (TACK COAT) 2 APPLICATIONS	HMA BINDER COURSE, IL-19, N70	HMA SURFACE COURSE, IL-9.5, MIX C, N70	LONGITUDINAL JOINT SEALANT
STATION	ТО	STATION	(FT)	(FT)	(SQ YD)	(POUND)	(TON)	(TON)	(FT)
126+15.00	TO	118+65.40	749.6	22	1832	1237	231	154	750
0+00.00	TO	0+36.80	36.8	22	90	61	11	8	37
0+36.80	TO	20+00.00	1963.2	24	5235	3534	660	440	1963
20+00.00	ТО	50+00.00	3000	24	8000	5400	1008	672	3000
50+00.00	TO	80+00.00	3000	24	8000	5400	1008	672	3000
0+36.80	TO	110+00.00	3000	24	8000	5400	1008	672	3000
110+00.00	TO	140+00.00	3000	24	8000	5400	1008	672	3000
140+00.00	TO	170+00.00	3000	24	8000	5400	1008	672	3000
170+00.00	TO	200+00.00	3000	24	8000	5400	1008	672	3000
200+00.00	ТО	230+00.00	3000	24	8000	5400	1008	672	3000
230+00.00	TO	250+60.00	2060	24	5494	3708	692	461	2060
		•							
PROJECT TOTAL					68,651	46,340	8,650	5,767	25,810

SHOULDER SCHEDULE

LC	OCATIC	N		AGGREGATE WEDGE SHOULDERS, TYPE B	HMA SURFACE REMOVAL 3 3/4"	BITUMINOUS MATERIALS (TACK COAT) 2 APPLICATIONS	HOT-MIX ASPHALT SHOULDERS
STATION	ТО	STATION	LT/RT	(TON)	(SQ YD)	(POUND)	(TON)
126+15.00	TO	125+88.70	RT		3	4	1
126+15.00	TO	125+56.00	RT	1			
126+15.00	TO	118+65.00	LT	14	104	139	45
125+88.00	TO	123+09.00	RT		101	136	42
123+09.00	TO	118+65.40	RT		210	283	88
0+00.00	TO	0+36.80	LT		3	4	1
0+00.00	TO	20+00.00	LT	39			
0+00.00	ТО	20+00.00	RT	39	167	220	70
0+36.80	TO	20+00.00	LT		163	225	69
20+00.00	ТО	50+00.00	LT	56	250	338	105
20+00.00	ТО	50+00.00	RT	56	250	338	105
50+00.00	ТО	80+00.00	LT	56	250	338	105
50+00.00	TO	80+00.00	RT	56	250	338	105
80+00.00	TO	110+00.00	LT	56	250	338	105
80+00.00	TO	110+00.00	RT	56	250	338	105
110+00.00	TO	140+00.00	LT	56	250	338	105
110+00.00	TO	140+00.00	RT	56	250	338	105
140+00.00	TO	170+00.00	LT	56	250	338	105
140+00.00	TO	170+00.00	RT	56	250	338	105
170+00.00	TO	200+00.00	LT	56	250	338	105
170+00.00	TO	200+00.00	RT	56	250	338	105
200+00.00	TO	230+00.00	LT	56	250	338	105
200+00.00	TO	230+00.00	RT	56	250	338	105
230+00.00	TO	250+60.00	LT	39	172	230	72
230+00.00	TO	250+60.00	RT	39	172	230	72
PROJECT TOTA	٦L			955	4,595	6,203	1,930

PAVEMENT PATCHING SCHEDULE

LOCATION		LENGTH	WIDTH	CLASS B PATCHES TYPE II, 16"	CLASS B PATCHES TYPE III, 16"	CLASS B PATCHES TYPE IV, 16"
STATION	LT/RT	(FT)	(FT)	(SQ YD)	(SQ YD)	(SQ YD)
22+54.00	LT	12	6	8		
22+69.00	LT	12	6	8		
44+54.00	LT	12	6	8		
67+54.00	RT	12	6	8		
104+54.00	RT	12	6	8		
104+54.00	LT	12	6	8		
153+40.00	RT	12	12		16	
155+54.00	RT	40	4		17.8	
174+25.00	RT	12	6	8		
250+05.00	LT	100	6			66.7
PROJECT TOTA	AL			56	33.8	66.7

GUARDRAIL SCHEDULE

	LOC	CATION		STEEL PLATE BEAM GUARDRAIL TYPE A, 6 FT POSTS	TRAFFIC BARRIER TERMINAL, TYPE 1 TAN	STRONG POST GUARDRAIL ATTACHED TO CULVERT	TERMINAL MARKER - DIRECT APPLIED	GUARDRAIL REFLECTORS, TYPE A	GUARDRAIL REMOVAL
STATION	ТО	STATION	OFFSET	(FT)	(EACH)	(FT)	(EACH)	(EACH)	(FT)
88+69.25	TO	89+19.25	RT		1		1	1	
89+19.25	TO	89+94.25	RT	75.0				1	
89+94.25	TO	90+31.75	RT			37.5		1	
90+31.75	TO	90+81.75	RT		1		1	1	
89+44.25	TO	89+94.25	LT		1		1	1	
89+94.25	TO	90+31.75	LT			37.5		1	
90+31.75	TO	91+06.75	LT	75.0				1	
91+06.75	TO	91+56.75	LT		1		1	1	
89+44.70	TO	91+23.05	LT						179
89+13.80	TO	90+78.67	RT						165
PROJECT TOT	AL			150	4	75	4	8	344

TEMPORARY RAMP SCHEDULE

LOG	CATION		WIDTH	LENGTH	TEMPORARY RAMP
STATION	TO	STATION	(FT)	(FT)	(SQ YD)
126+15.00	TO	126+02.50	13.5	12.5	37.5
250+44.13	TO	250+56.63	13.5	12.5	37.5
PROJECT TOTAL					75

ADA RAMP SCHEDULE

LOCATION	SIDEWALK REMOVAL	CURB & GUTTER REMOVAL	DETECTABLE WARNINGS	PCC SIDEWALK, 5"	CCC&G TYPE B-6.18
STATION	(SQ FT)	(FT)	(SQ FT)	(SQ FT)	(FOOT)
S. 1st Street					
SW	14	0	0	0	0
2nd Street					
NE	33	0	8	35	0
SE	294	72	20	210	27
SW	44	10	8	42	10
PROJECT TOTAL	385.0	82.0	36.0	287.0	37.0

USER NAME = jbuening	DESIGNED - JKP	REVISED -
	DRAWN - DMW	REVISED -
PLOT SCALE = 100.0000 / in.	CHECKED - JMB	REVISED -
PLOT DATE = 3/15/2021	DATE - 03/12/21	REVISED -

SCALE:

	SCHEDULE	OF QUA	ANTITIES	S	F.A. RTE	SECT	ПОИ		COUNTY	TOTAL SHEETS	SHEET NO.
	FΔP	817 (JL	15)		817	817 50RS-4 ST. C				37	11
	יאי					CONTRACT	NO. 76	6L14			
SHEET	OF	SHEETS	STA.	TO STA.			ILLINOIS	FED. A	ID PROJECT		

PAVEMENT MARKING SCHEDULE

				MOPLASTIC PA		KING	RAISED		MPORARY PAVE		1G		RKING REMOVAL -	RAISED	TEMPORARY PAV		SHORT TERM	SHORT TERM
STATION T	O STATION	DIRECTION	4" WHITE - LINE	4" YELLO	DW - LINE	24" WHITE LINE	REFLECTIVE	4" WHITE - LINE	4" YELLO	W - LINE	24" WHITE LINE	WATER	BLASTING	REFLECTIVE PAVEMENT	REMO	DVAL	PAVEMENT	PAVEMENT
31ATION 1	O STATION	DIRECTION	SOLID	SKIP-DASH	SOLID	24 WHITE EINE	PAVEMENT MARKER	SOLID	SKIP-DASH	SOLID	Z T WITH E EINE	4" LINE	24" LINE	MARKER REMOVAL	4" LINE	24" LINE	MARKING	MARKING REMOVAL
				(FOC	OT)		(EACH)		(FOO ⁻	Γ)		(50	Q FT)	(EACH)	(SQ	FT)	(FOOT)	(SQ FT)
IL 4																		
118+65	126+15	EB & WB	1500	190			10	1500	190			564		10	564		612	204
IL 15																		
0+00	87+14	EB & WB	17428	2180			109	17428	2180			6536		109	6536		7128	2376
87+14	110+45	EB & WB	4664	590	2332		29	4664	590	2332		2529		29	2529		1908	636
110+45	132+50	EB & WB	4410	560			28	4410	560			1657		28	1657		1800	600
132+50	152+00	EB & WB	3900	490	1950		24	3900	490	1950		2114		24	2114		1584	528
152+00	154+25	EB & WB	450		450		3	450		450		300		3	300		180	60
154+25	172+25	EB & WB	3600	450	1800		23	3600	450	1800		1950		23	1950		1476	492
172+25	199+66	EB & WB	5482	690			34	5482	690			2058		34	2058		2232	744
199+66	210+44	EB & WB	2156	270	1078		13	2156	270	1078		1168		13	1168		900	300
210+44	224+75	EB & WB	2862		2862		18	2862		2862		1908		18	1908		1188	396
224+75	233+90	EB & WB	1830	230	915		11	1830	230	915		992		11	992		756	252
233+90	236+05	EB & WB	430		430		3	430		430		287		3	287		180	60
236+05	239+82	EB & WB	754	100			5	754	100			285		5	285		288	96
239+82	244+30	EB & WB	896	120	448		6	896	120	448		488		6	488		360	120
244+30	246+00	EB & WB	340		340		2	340		340		227		2	227		108	36
246+00	250+60	EB & WB	920	120	460		7	920	120	460		500		7	500		360	120
IL 4			•					•					•					
0+00		WB				12.5					12.5		25			25		
IL 15								•										•
1+00		EB				12.5					12.5		25			25		
TOT			51622	5990	13065	25	325	51622	5990	13065	25	23563	50	325	23563	50	21060	7020
US	SE			70677		25	325		70677		25	23	3613	325	236	13	21060	7020

MAINTENANCE OF TRAFFIC SCHEDULE

			PAVEMENT MARK	ING TAPE, TYPE IV					IMPACT	IMPACT	
STATION TO STATION		DIRECTION	4" WHITE - LINE	24" WHITE - LINE	TEMPORARY PAVEMENT MARKING, 6"	TEMPORARY CONCRETE BARRIER	RELOCATE TEMPORARY CONCRETE BARRIER	BARRIER WALL REFLECTOR, TYPE C	ATTENUATORS, TEMPORARY (FULLY REDIRECTIVE, NARROW), TEST LEVEL 3	ATTENUATORS, RELOCATE (FULLY REDIRECTIVE, NARROW), TEST LEVEL 3	TEMPORARY RUMBLE STRIP
			(FO	OT)	(FOOT)	(FOOT)	(FOOT)	(EACH)	(EACH)	(EACH)	(EACH)
Stage 1											
BEFORE WOR	RK ZONE	EB & WB									6
247+81		EB		12							
247+88	255+52	EB	764								
248+80	255+76	WB	696								
249+00		EB							1		
249+05	255+80	EB			675	675		56			
249+05	255+80										
255+81		EB							1		
257+12		WB		12							
Stage 2											
BEFORE WOR	RK ZONE	EB & WB									6
247+72		EB		12							
248+32	256+97	EB	865								
249+22	255+76	WB	654								
249+00		EB								1	
249+05	255+80	WB			675		675	56			
255+81		EB								1	
257+18		WB		12							
ТО	TAL		2979	48	1350	675	675	112	2	2	12
U	ISE		2979	48	1350	675	675	112	2	2	12


CITACTAIN
CHASTAIN
& ASSOCIATES LLC
CONSULTING ENGINEERS

USER NAME = jbuening	DESIGNED -	JKP	REVISED -
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PLOT SCALE = 100.0000 / in.	CHECKED -	JMB	REVISED -
PLOT DATE = 3/15/2021	DATE -	03/12/21	REVISED -

SCALE:

SHEET

SCHEDULE OF QUANTITIES		F.A. RTE	SECTION		COUNTY	TOTAL SHEETS	SHEET NO.		
FAP 817 (IL 15)			817	50RS-4			ST. CLAIR	37	12
							CONTRACT	NO. 76	5L14
OF SHEETS	STA.	TO STA.	ILLINOIS FED. AID			D PROJECT			

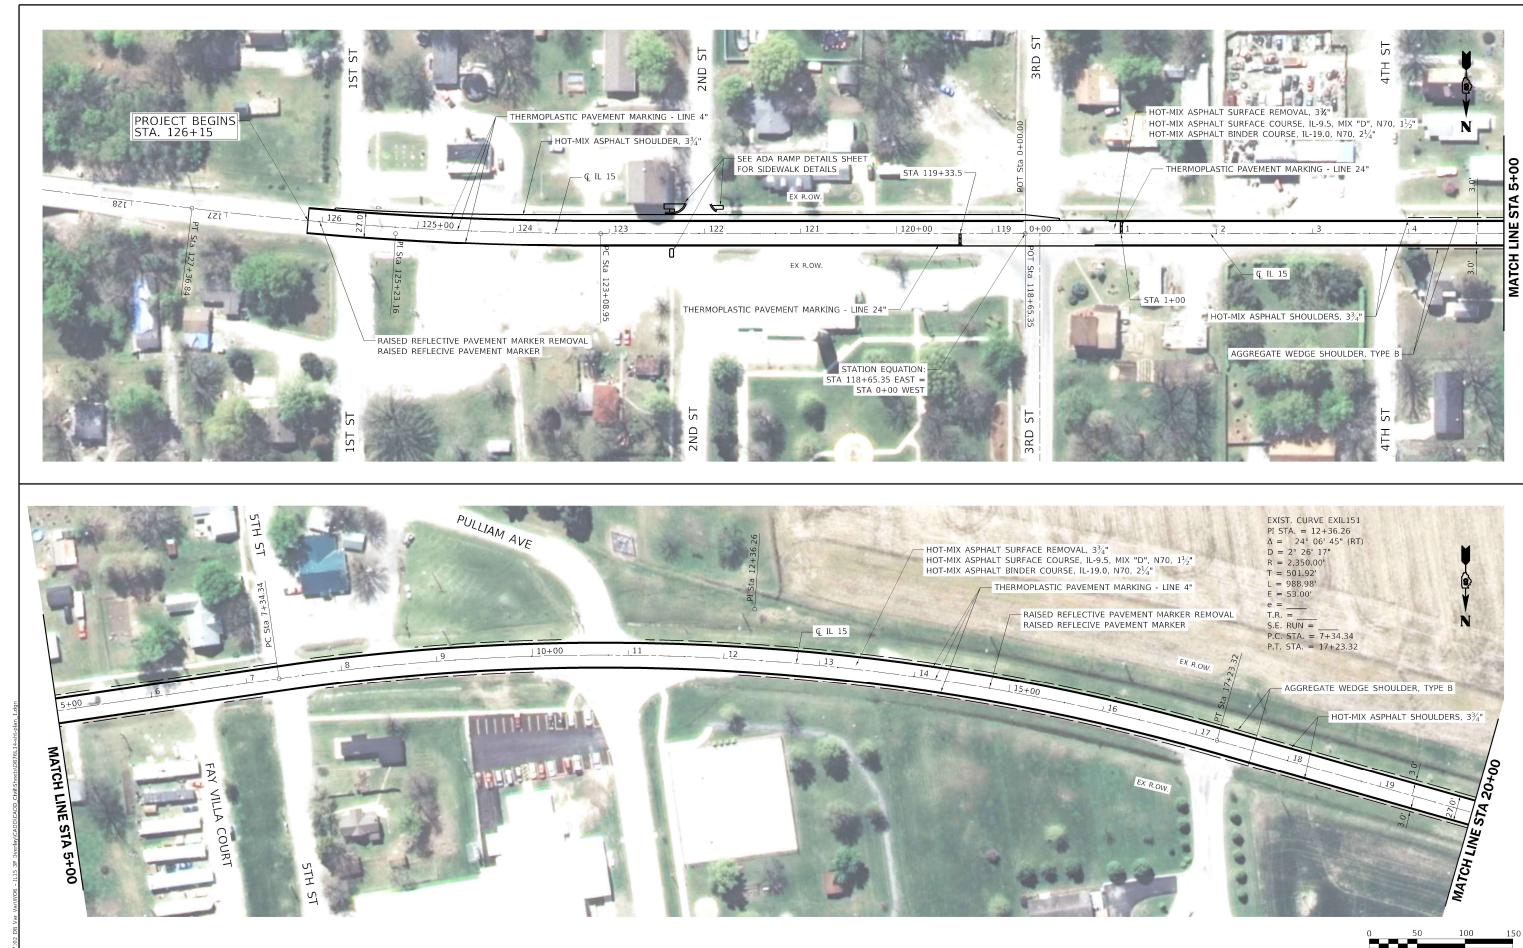

MODEL: Default

CHASTAIN
& ASSOCIATES LLC
CONSULTING ENGINEERS

 PLOT SCALE
 = 100.2680 ' / in.
 CHECKED
 REVISED

 PLOT DATE
 = 3/15/2021
 DATE
 REVISED

REVISED

DESIGNED -

STATE OF ILLINOIS
DEPARTMENT OF TRANSPORTATION

RESURFACING PLAN
FAP 817 (IL 15)

SHEET OF SHEETS STA.

TO STA.

SCALE:


P. SECTION COUNTY TOTAL SHEE SHEETS NO. 17 SORS-4 ST. CLAIR 37 13 CONTRACT NO. 76L14





SCALE IN FEET DESIGNED -REVISED -SECTION CHASTAIN & ASSOCIATES LLC RESURFACING PLAN STATE OF ILLINOIS DRAWN -REVISED . ST. CLAIR 37 15 817 50RS-4 FAP 817 (IL 15) LOT SCALE = 100.0000 ' / in. CHECKED -REVISED **DEPARTMENT OF TRANSPORTATION** CONTRACT NO. 76L14 DATE REVISED SHEET TO STA.



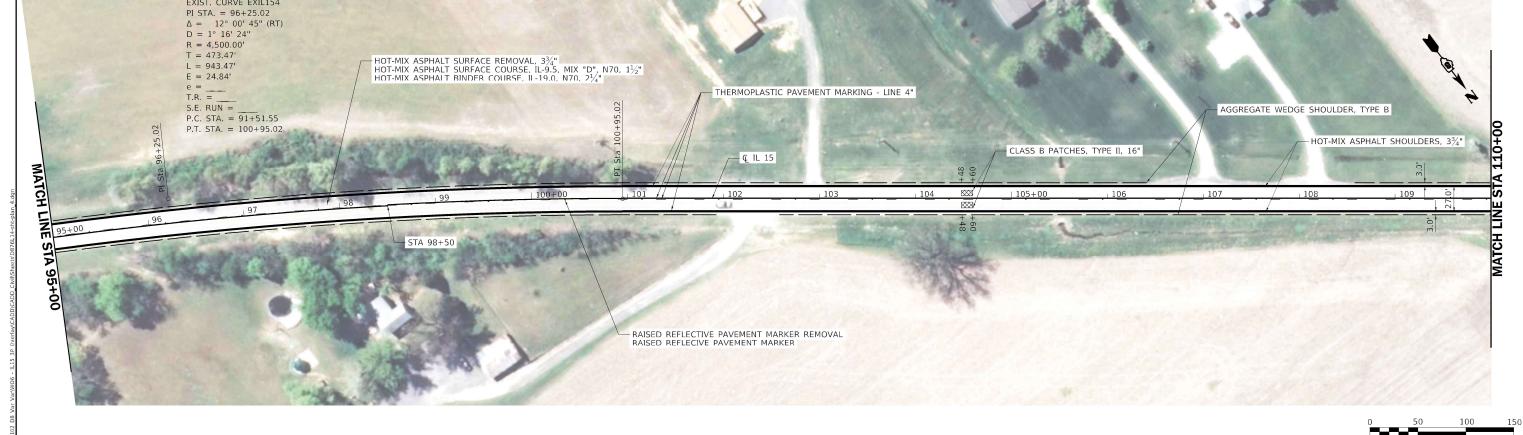

SCALE IN FEET

SECTION COUNTY TOTAL SHE

CHASTAIN & ASSOCIATES LLC CONSULTING ENGINEERS

	USER NAME = jbuening	DESIGNED -	REVISED -
		DRAWN -	REVISED -
_	PLOT SCALE = 100.0000 ' / in.	CHECKED -	REVISED -
2	PLOT DATE = 3/15/2021	DATE -	REVISED -

STATE OF ILLINOIS						
DEPARTMENT	OF	TRANSPORTATION				

RESURFACING PLAN FAP 817 (IL 15)						F.A.P RTE.	SECTION	COUNTY	TOTAL SHEETS	SHEET NO.
						817	50RS-4	ST. CLAIR	37	16
								CONTRACT	NO. 76	5L14
SCALE:	SHEET	OF	SHEETS	STA.	TO STA.	ILLINOIS FED. AID PROJECT				





0 50 100 SCALE IN FEET

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	CHASTAIN	ı
	& ASSOCIATES LLC	Г
1	CONSULTING ENGINEERS	H

	REVISED -	DESIGNED -	
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2	REVISED -	DATE -	
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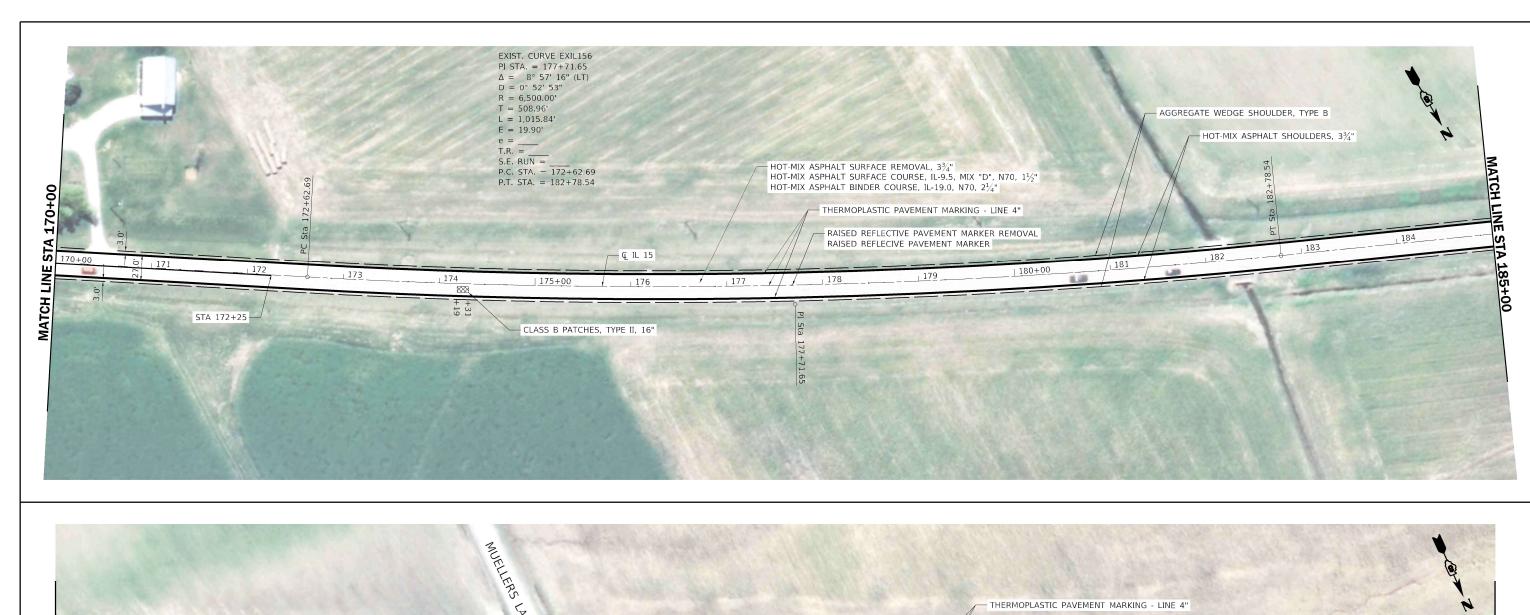
STATE OF ILLINOIS				
DEPARTMENT	OF	TRANSPORTATION		


RESURFACING PLAN FAP 817 (IL 15)				F.A.P RTE.	P SECTION		COUNTY	TOTAL SHEETS	SHEET NO.	
				817 50RS-4		ST. CLAIR	37	17		
							CONTRACT	NO. 76	5L14	
HEET	OF	SHEETS	STA.	TO STA.		ILLINOIS	FED. AI	D PROJECT		



SCALE IN FEET DESIGNED -REVISED -SECTION RESURFACING PLAN STATE OF ILLINOIS DRAWN REVISED ST. CLAIR 37 18 817 50RS-4 FAP 817 (IL 15) LOT SCALE = 100.0000 ' / in. CHECKED -REVISED **DEPARTMENT OF TRANSPORTATION** CONTRACT NO. 76L14 DATE REVISED SHEET TO STA.

CHASTAIN
& ASSOCIATES LLC
CONSULTING ENGINEERS



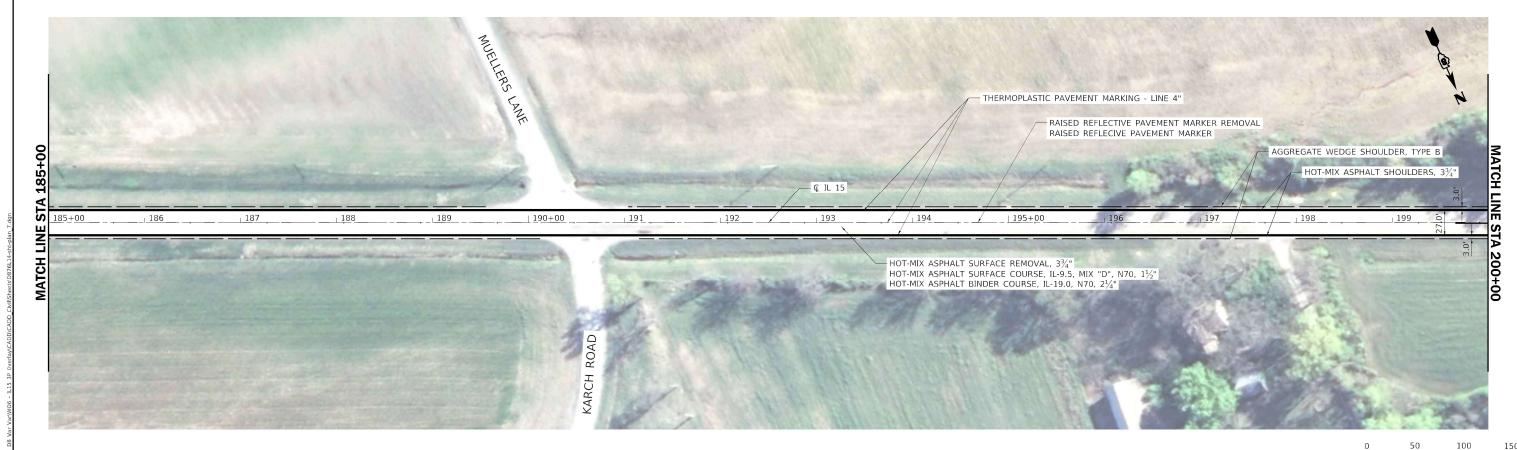

 SCALE IN FEET
 TOTAL SHEETS WO.

 SORS-4
 ST. CLAIR
 37
 19

CONTRACT NO. 76L14

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	& ASSOCIATES LLC	ŀ
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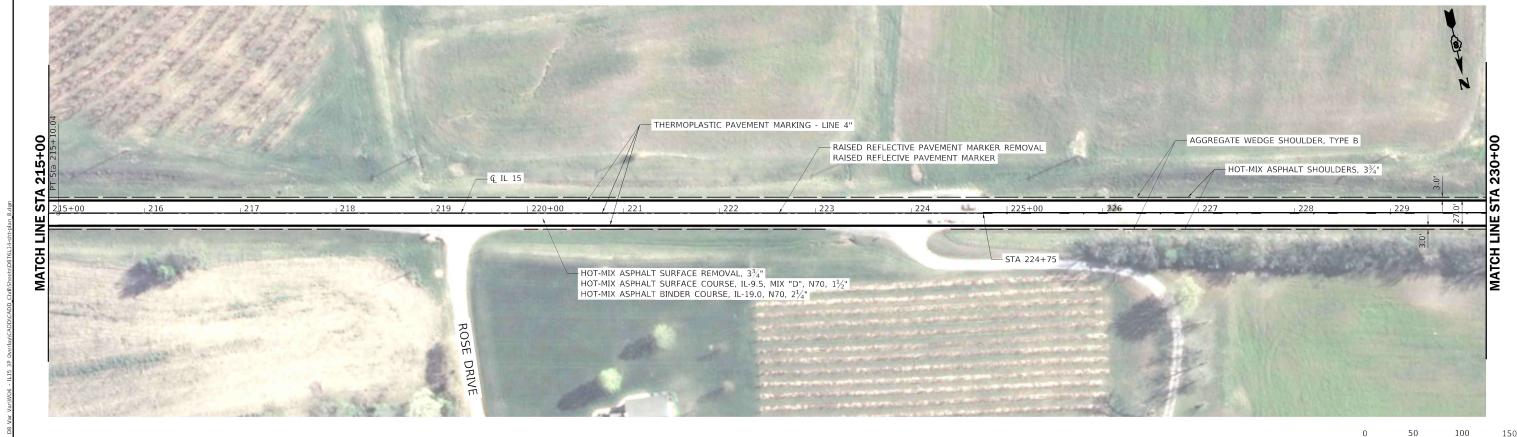
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2	PLOT DATE = 3/15/2021	DATE -	REVISED -

SIAIE	OF ILLINOIS	
DEPARTMENT	OF TRANSPORTA	TION

SCALE:

RESURFACING PLAN	E.	SECTION		
FAP 817 (IL 15)	17	50R	S-4	
TAI OIT (IE 10)				
SHEET OF SHEETS STA. TO STA.			ILLINOIS	FED.





0 50 100 19 SCALE IN FEET


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ı	& ASSOCIATES LLC	ŀ
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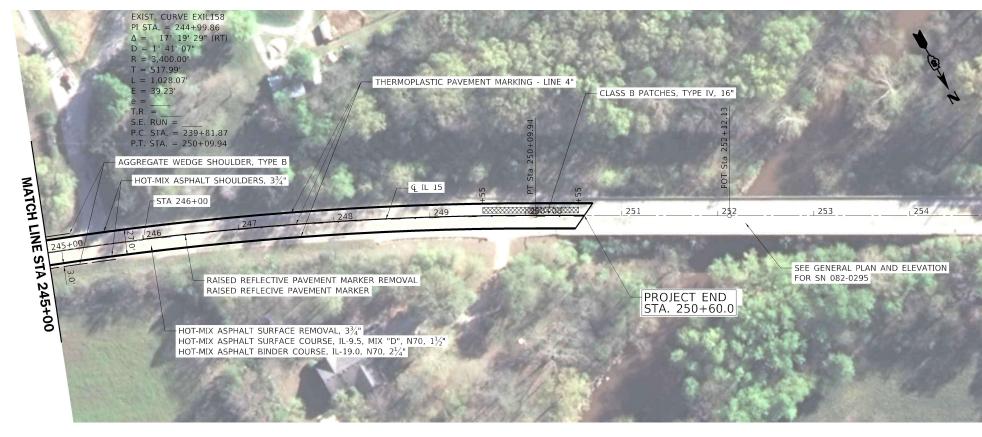
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RS	PLOT DATE = 3/15/2021	DATE -	REVISED -

STATE OF ILLINOIS						
DEPARTMENT OF	TRANSPORTATION					

SHEET

RESURFACING PLAN			F.A.P RTE.	SECTION	COUNTY	TOTAL SHEETS	SHEET NO.		
FAP 817 (IL 15)		817	50RS-4		ST. CLAIR	37	20		
TAI OIT (IL IS)					CONTRACT	NO. 76	5L14		
OF	SHEETS	STA.	TO STA.		ILLINOIS	FED. A	ID PROJECT		



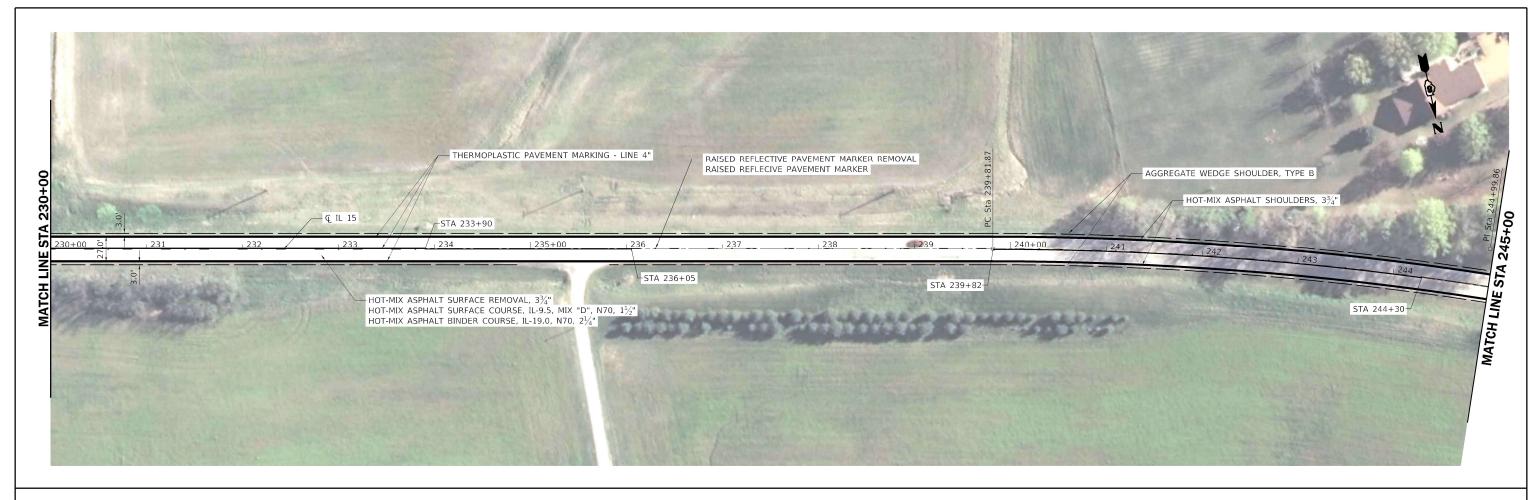


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CHASTAIN & ASSOCIATES LLC CONSULTING ENGINEERS

USER NAME = jbuening	DESIGNED -	REVISED -
	DRAWN -	REVISED -
PLOT SCALE = 100.0000 ' / in.	CHECKED -	REVISED -
PLOT DATE = 3/15/2021	DATE -	REVISED -

STATE OF ILLINOIS						
DEPARTMENT	OF	TRANSPORTATION				

							F.A.P SECTION			COUNTY	TOTAL SHEETS	SHEET NO.
		FΔP	817 (IL	15)		817	50R:	S-4		ST. CLAIR	37	21
		יחי	017 (IL	13)						CONTRACT	NO. 76	5L14
SCALE:	SHEET	OF	SHEETS	STA.	TO STA.			ILLINOIS	FED. AI	D PROJECT		

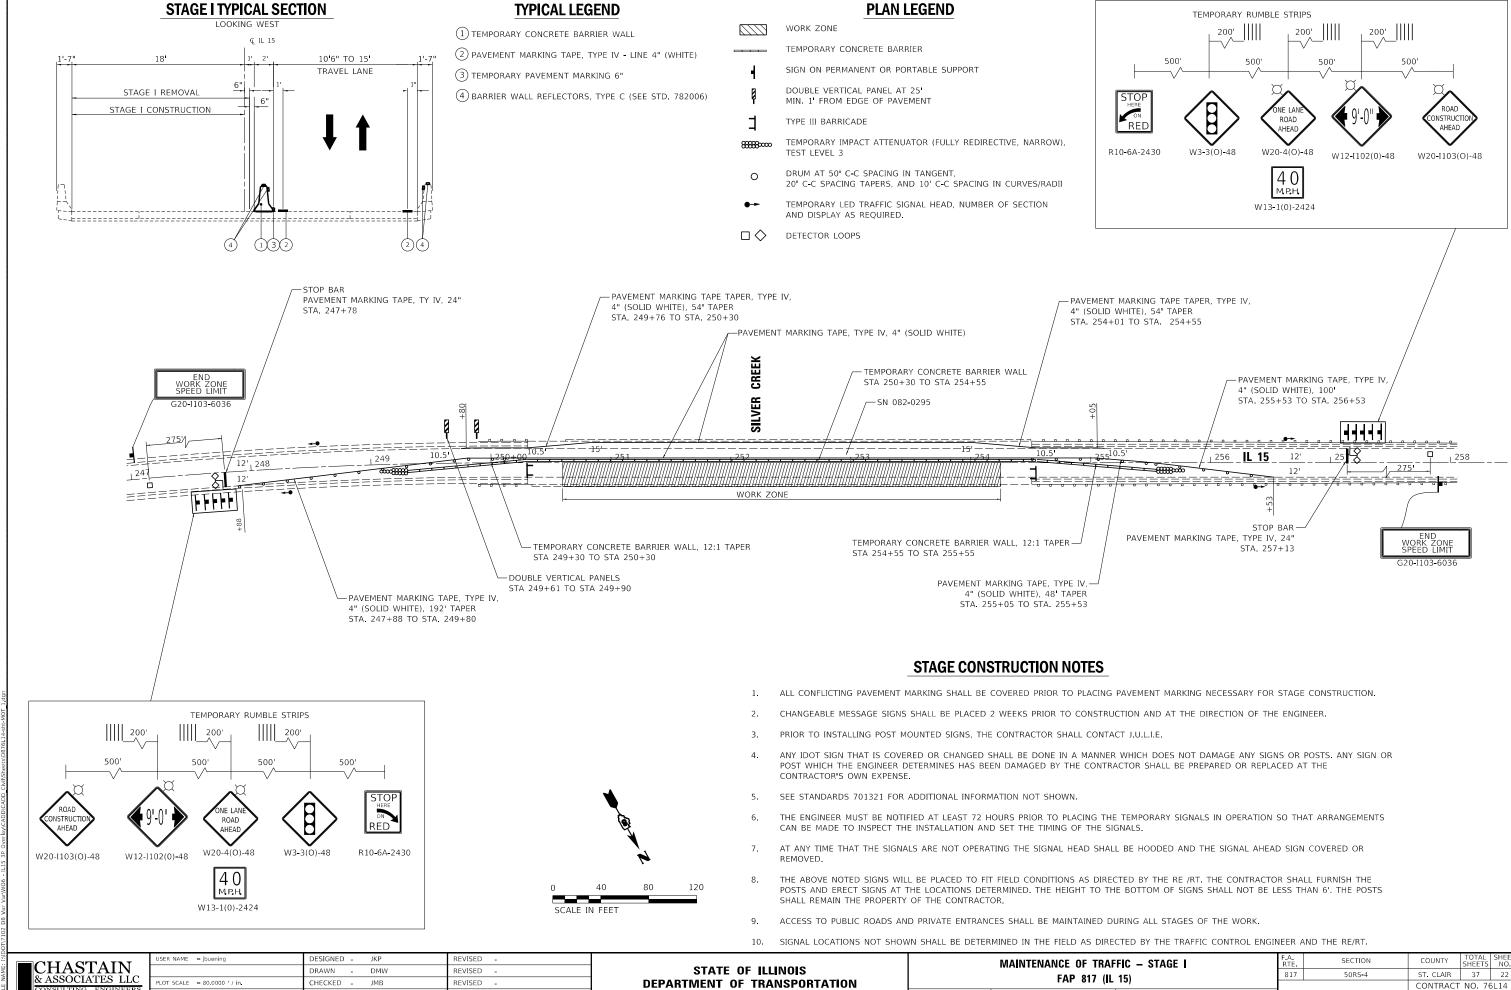

SHEET 1 OF 2 SHEETS STA

TO STA.


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OT DATE = 3/15/2021

DATE

03/12/21

REVISED

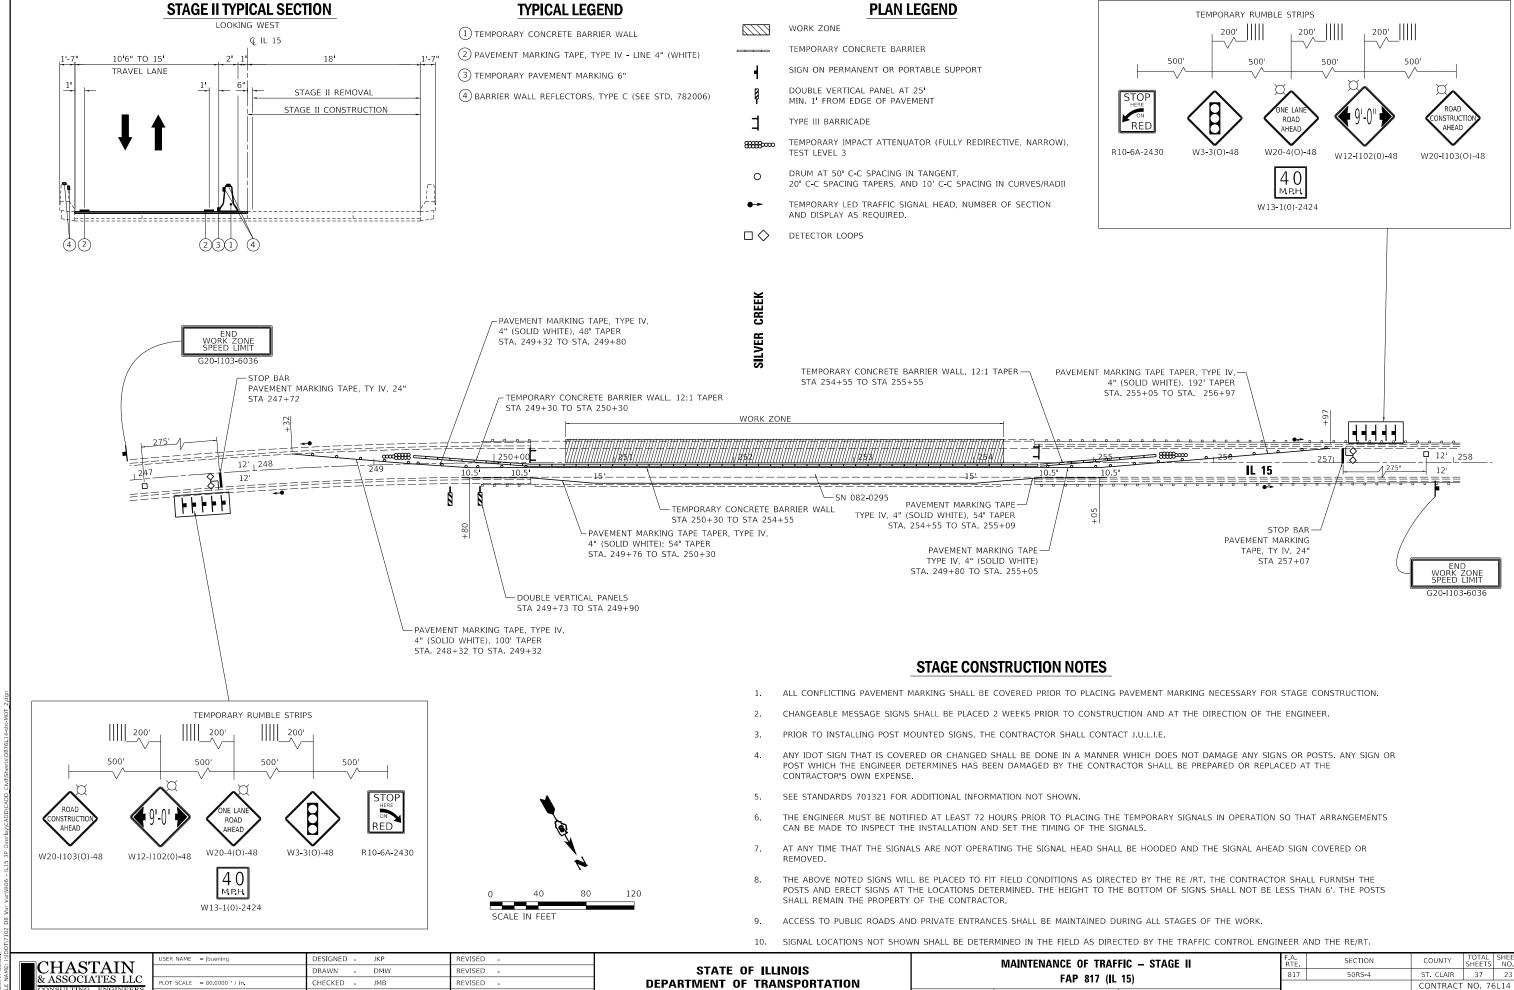

SHEET 2 OF 2 SHEETS STA

TO STA.

SCALE: 1:40


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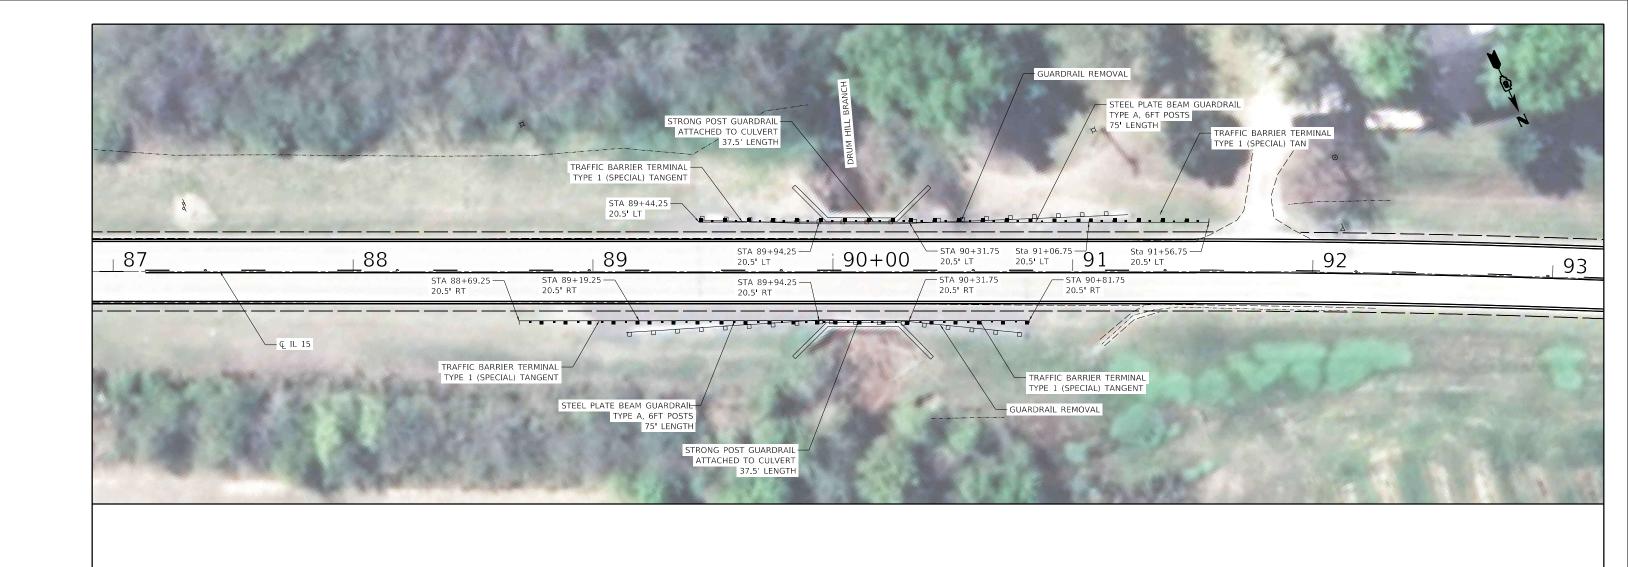
OT DATE = 3/15/2021

DATE

03/12/21

REVISED



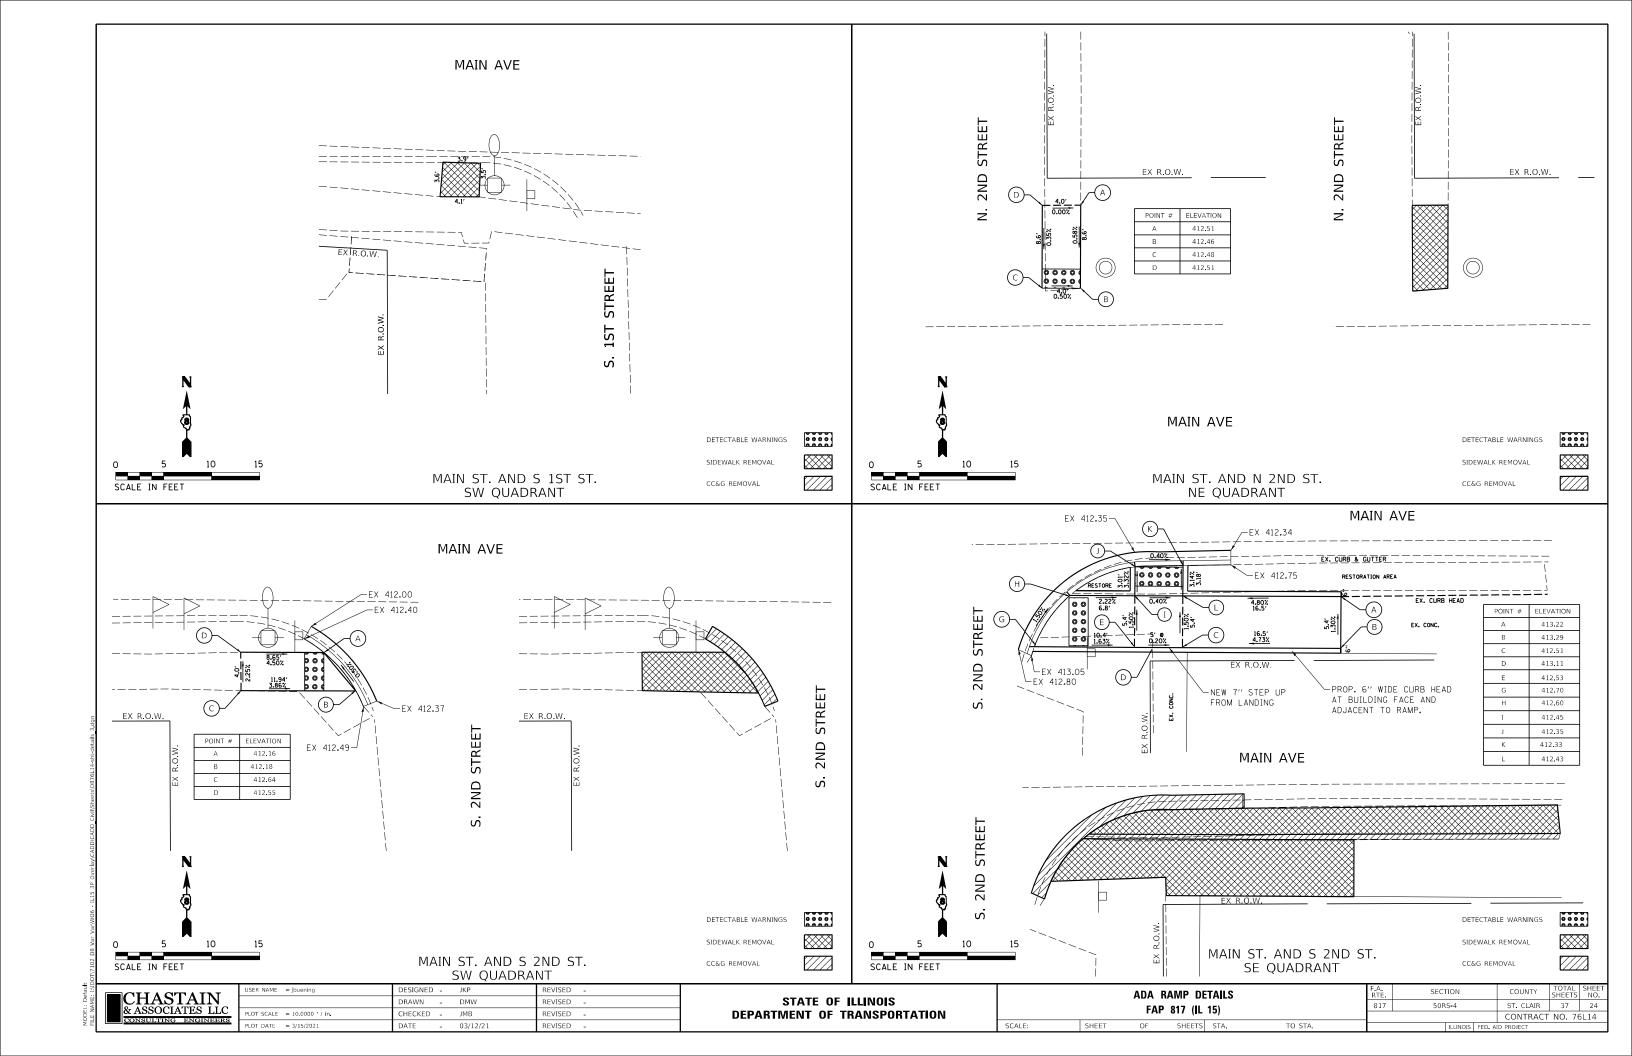

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SCALE IN FEET

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2	& ASSOCIATES LLC	ſ
i	CONSULTING ENGINEERS	ŀ

USER NAME = jbuening	DESIGNED -	REVISED -
	DRAWN -	REVISED -
PLOT SCALE = 40.0000 ' / in.	CHECKED -	REVISED -
PLOT DATE = 3/15/2021	DATE -	REVISED -


STATE	OF ILLINOIS
DEPARTMENT O	OF TRANSPORTATION

SCALE:

SHEET

						00,10				
GUAR	DRAIL DE		F.A.P RTE	SECTION			COUNTY	TOTAL SHEETS	SHEET NO.	
FAP 817 (JL 15)				817	50RS-4			ST. CLAIR	37	25
1A1 017 (IL 13)								CONTRACT	NO. 76	5L14
OF	SHEETS	STA.	TO STA.			ILLINOIS	FED. AI	D PROJECT		

DETAIL TEMPORARY RAMP

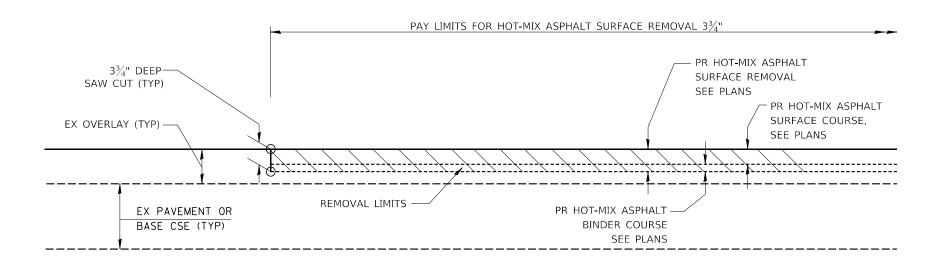

PAVING DETAIL

TABLE A (LENGTHS AND TAPER RATES)

SPECIAL NOTE NUMBER	ELEMENT	RATE/LENGTH
1	TEMPORARY RAMP TAPER RATE	1:40
2	TEMPORARY RAMP LENGTH	12.5'


GENERAL NOTES

- 1. THIS WORK SHALL BE DONE IN ACCORDANCE WITH ARTICLE 406.08, AND THE DETAILS IN THE PLANS.
- 2. THE PAVEMENT SURFACE TO BE REMOVED MAY BE EITHER HOT-MIX ASPHALT OR P.C. CONCRETE. THIS WORK SHALL BE PERFORMED IN ACCORDANCE WITH ARTICLE 440.04 AND THE DETAILS IN THE PLANS.
- 3. THE SAW CUT JOINTS SHALL BE PRIMED JUST PRIOR TO THE PLACING OF BITUMINOUS MATERIAL. THIS WORK WILL BE IN ACCORDANCE WITH THE APPLICABLE PORTIONS OF ARTICLE 406.05.

CHASTAIN & ASSOCIATES LLC
CONSULTING ENGINEERS

USER NAME = jbuening	DESIGNED - JKP	REVISED -
	DRAWN - DMW	REVISED -
PLOT SCALE = 40.0000 / in	CHECKED - JMB	REVISED -
PLOT DATE = 3/15/2021	DATE - 03/12/21	REVISED -

TE	MPORARY	RAMP	AND BU	JTT JOIN	NT DETAILS	F.A. RTE	SECTION	COUNTY	TOTAL SHEETS	SHEET NO.			
	FAP 817 (IL 15)					817	50RS-4	ST. CLAIR	37	26			
	TAP 017 (IL 13)						CONTRACT NO. 76L14						
SHEET OF SHEETS STA. TO STA.							ILLINOIS FED. A	ID PROJECT					

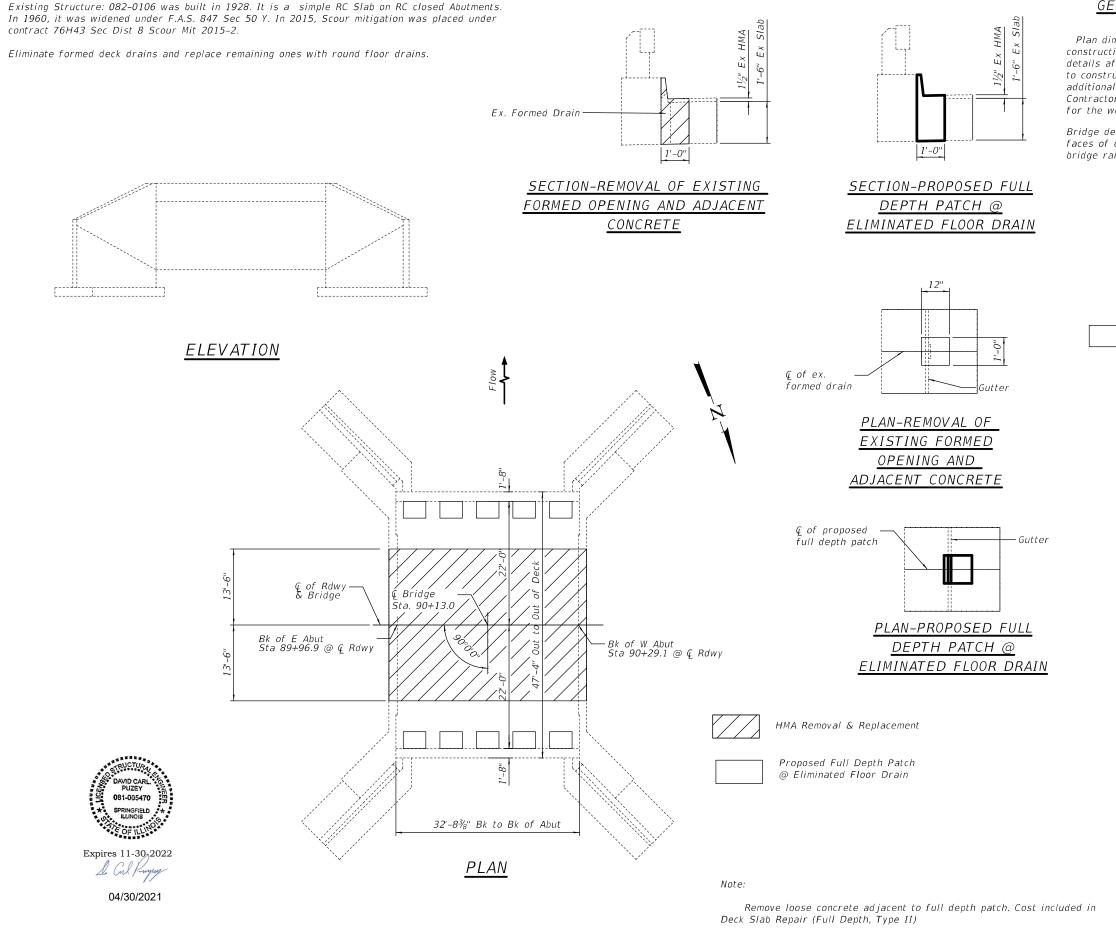


GENERAL NOTES

Plan dimensions and details relative to existing plans are subject to nominal construction variations. The Contractor shall field verify existing dimensions and details affecting new construction and make necessary approved adjustments prior to construction or ordering of materials. Such variations shall not be cause for additional compensation for a change in scope of the work, however, the Contractor will be paid for the quantity actually furnished at the unit price bid for the work.

Bridge deck concrete sealer shall be placed on existing concrete top/inside faces of curbs (full length) and the top/bottom/inside faces of the concrete bridge rail (full length)

FLOOR DRAIN ELIMINATION

(10 Req'd) Existing drains & adjacent concrete to be removal and replaced with full depth patch

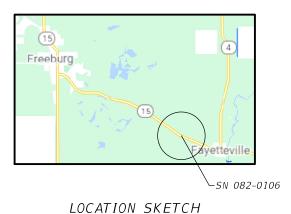


DESIGN STRESSES FIELD UNITS

f'c = 4,000 psi

TOTAL BILL OF MATERIAL

ITEM	UNIT	TOTAL
Deck Slab Repair (Full Depth, Type II)	Sq. Yd.	1.1
Bridge Deck Concrete Sealer	Sq. Ft.	292
Hot-Mix Asphalt Binder Course, IL - 19.0, N70	Ton	13
Polymerized HMA Surface Course, IL-9.5, Mix"D" N70	Ton	9
Hot-Mix Asphalt Surface Removal, 3¾"	Sq. Yd.	97

USER NAME = vinsonay	DESIGNED - Anthony Y. Vinson	REVISED -		GENERAL PLAN & ELEVATION (IL 15 over Drum Hill Branch)						F.A.P. RTF	SECTIO	v COUN	TY SHE	TAL SHEET	1
	DRAWN - Anthony Y. Vinson	REVISED -	STATE OF ILLINOIS	,						817	50RS-4	ST. CI	AIR 3	7 27	1
PLOT SCALE = 0:2.0000 ':" / in.	CHECKED -	REVISED -	DEPARTMENT OF TRANSPORTATION	SN 082-0106						CONTRACT			RACT NO	76L14	1
PLOT DATE = 3/15/2021	DATE -	REVISED -		SCALE: SHEE	T 1	OF 2	SHEETS	STA.	TO STA.		ILL	NOIS FED. AID PROJECT			1

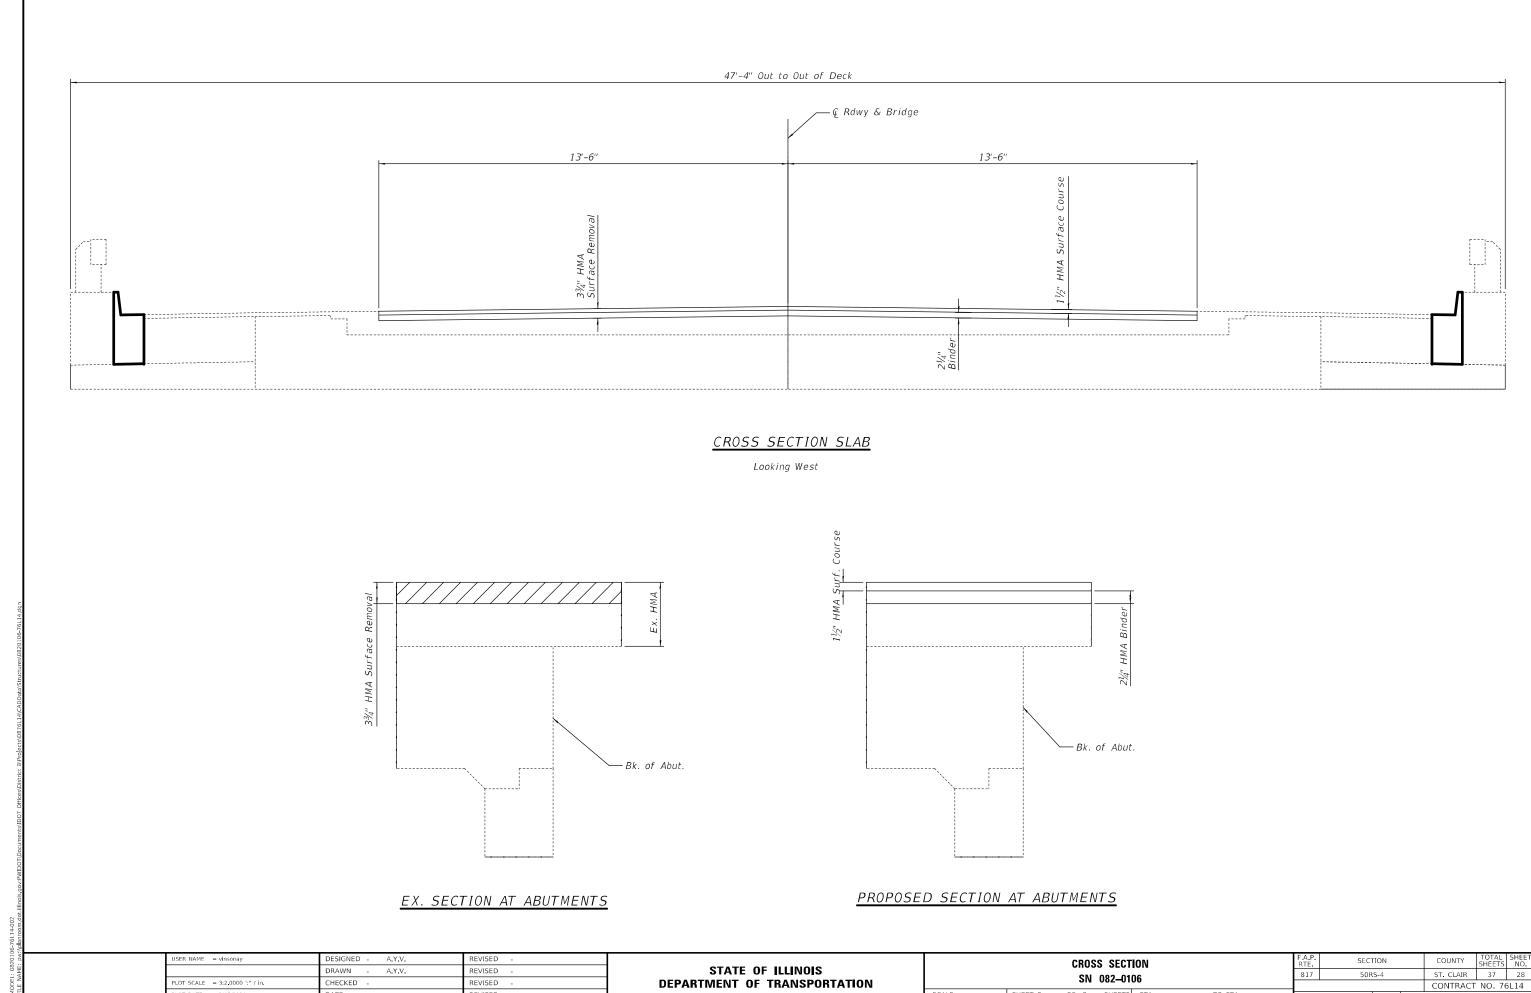


SHEET 2

OF 2 SHEETS STA.

TO STA.

Existing Structure: 082-0295 was built in 1993 under FAP Route 817 Sec 50-BR. It is a 3 span continuous plate girder supported on pile bent abutments and caisson shaft piers. In 2017 the bridge deck was sealed.

The deck ends and mudwalls shall be replaced with strip seal joints. The deck shall be patched, and overlayed with waterproofing membrane system and hot-mix asphalt.

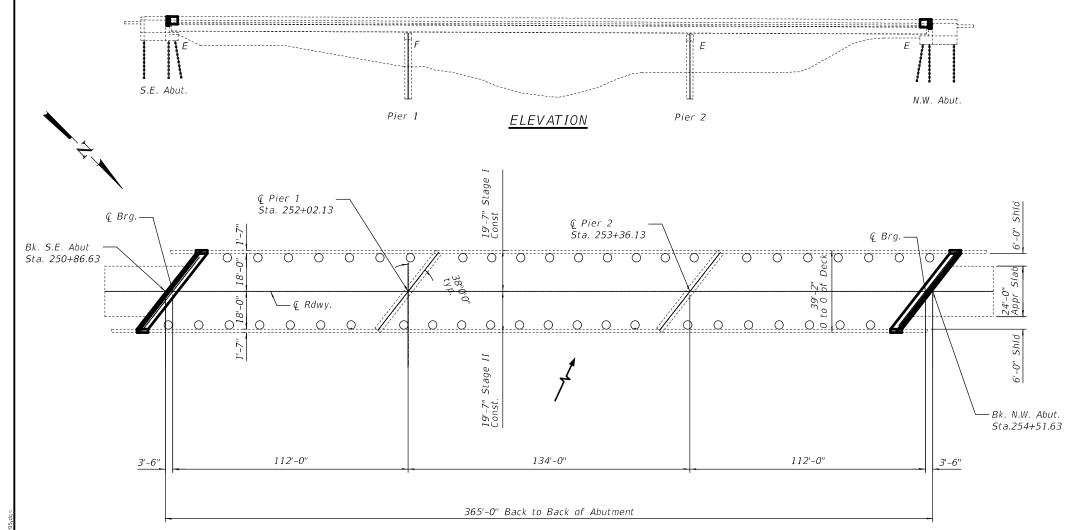

GENERAL NOTES

Reinforcement bars designated (E) shall be epoxy coated.

Prior to pouring the new concrete deck, all heavy or loose rust, loose mill scale, and other loose or potentially detrimental foreign material shall be removed from the surfaces in contact with concrete. Tightly adhered paint may remain unless otherwise noted. Removal shall be accomplished by methods that will not damage the steel and the cost will be included in the pay item covering removal of the existing concrete.

As directed by the Engineer, existing construction accessories welded to the top flange of beams and girders shall be removed. The weld areas shall be ground flush and inspected for cracks using magnetic particle testing (MT) or dye penetrant testing (PT) by qualified personnel approved by the Engineer.

Any cracks that cannot be removed by grinding $\frac{1}{4}$ inch deep shall be identified and reported to the Bureau of Bridges and Structures for further disposition. The cost of removing welded accessories, grinding and inspecting weld areas and grinding cracks will be paid for according to Article 109.04 of the Standard Specifications.

Plan dimensions and details relative to existing plans are subject to nominal construction variations. The Contractor shall field verify existing dimensions and details affecting new construction and make necessary approved adjustments prior to construction or ordering of materials. Such variations shall not be cause for additional compensation for a change in scope of the work, however, the Contractor will be paid for the quantity actually furnished at the unit price bid for the work

Existing reinforcement extending into removal area shall be cleaned, straightened and incorporated into the new construction. Any reinforcement bars that are damaged during concrete removal operations shall be repaired or replaced using an approved bar splicer or anchorage system. Cost included with "Concrete Removal".

No field welding is permitted except as specified in the contract documents.

Joint opening shall be adjusted according to Article 520.04 of the Standard Specs. when the deck is poured at an ambient temperature other than 50°F.

Bridge deck concrete sealer shall be placed on top/inside faces of parapets (full length) and wingwalls and on top of new concrete at joints.

The pay item "Clearing Special" is for removing all trees and brush taller than 3ft under the bridge from abutment to abutment, and 7ft wider than the bridge on each side. See special provisions.

PLAN

-Floor Drains to Remain



Expires 11-30-2022

04/30/2021

SHEET INDEX

- 1) General Plan and Elevation
- 2) Deck Section
- 3) Joint Removal
- 4) Joint Replacement (S.E. Abut.) 5) Joint Replacement (N.W. Abut.)
- 6) Joint & Drain Details
- 7) Preformed Joint Strip Seal
- 8) Bar Splicer
- 9) Temporary Concrete Barrier

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Google

Wilderman

LOCATION SKETCH

TOTAL BILL OF MATERIAL

ITEM	UNIT	TOTAL
Polymerized HMA Surface Course,IL-9.5,Mix "D"N70	Ton	100
Concrete Removal	Cu. Yd.	17.1
Concrete Superstructure	Cu. Yd.	19.2
Reinforcement Bars, Epoxy Coated	Pound	2430
Bar Splicers	Each	32
Preformed Joint Strip Seal	Foot	95.5
Waterproofing Membrane System	Sq. Yd.	1417
*Deck Slab Repair (Partial)	Sq. Yd.	200
*Deck Slab Repair (Full Depth, Type II)	Sq. Yd.	150
Bridge Deck Concrete Sealer	Sq. Ft.	3047
Longitudinal Joint Sealant	Foot	355
Bituminous Materials (Tack Coat)	Pound	319
Clearing, Special	L. Sum	1
	·	

*The quantitiy of deck slab repair is estimated. The engineer in the field shall determine the actual quantity and locations.

_	USER NAME = vinsonay	DESIGNED - Anthony Y. Vinson	REVISED -
		DRAWN - Anthony Y. Vinson	REVISED -
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	PLOT DATE = 3/15/2021	DATE -	REVISED -

STATE OF ILLINOIS
DEPARTMENT OF TRANSPORTATION

DESIGN STRESSES

FIELD UNITS


fy = 60,000 psi (Reinforcement)

fy = 36,000 psi (M270 Grade 36)

f'c = 4,000 psi

GENER	AL PLAN	&	ELEV	ATION (IL 15 ov	ver Silver Creek)	F.A.P. RTE	SEC ⁻
			CN.	082-029	95	·	817	50R
			OIV	002-02				
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-SN 082-0295

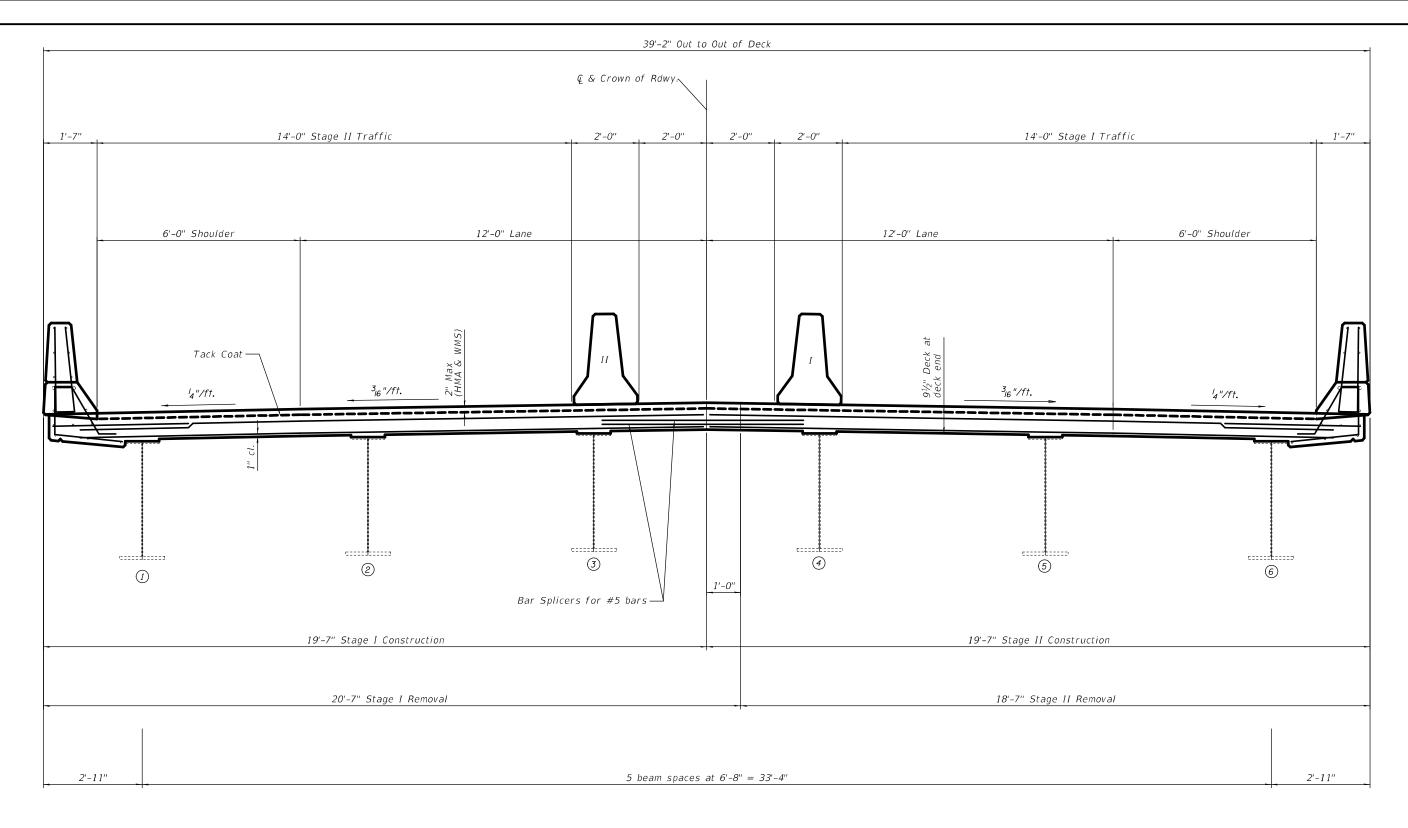

(Looking West)


Note:

A tack coat, per Section 406, with a residual asphalt rate of 0.025 lb/ sq ft should be placed on top of the $\frac{1}{2}$ " thick Asphalt Sand Seal Protection Layer of the Waterproofing Membrane System, before the HMA surfacing is placed.

USER NAME = VINSONAY	DESIGNED - ATV	KEVISED -	
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STATE (F ILLINOIS
DEPARTMENT OF	TRANSPORTATION


		DECK CF	ROSS SE	2–0295 817 50RS-4 ST. CLAIR 37 30 CONTRACT NO. 76L14							
	DECK CROSS SECTION SN 082-0295		50R	S-4		ST. CLAIR	37	30			
		314	002-023	,,,					CONTRACT	NO. 76	5L14
LE:	SHEET 2	OF 9	SHEETS	STA.	TO STA.	50RS-4		FED. A	ID PROJECT		

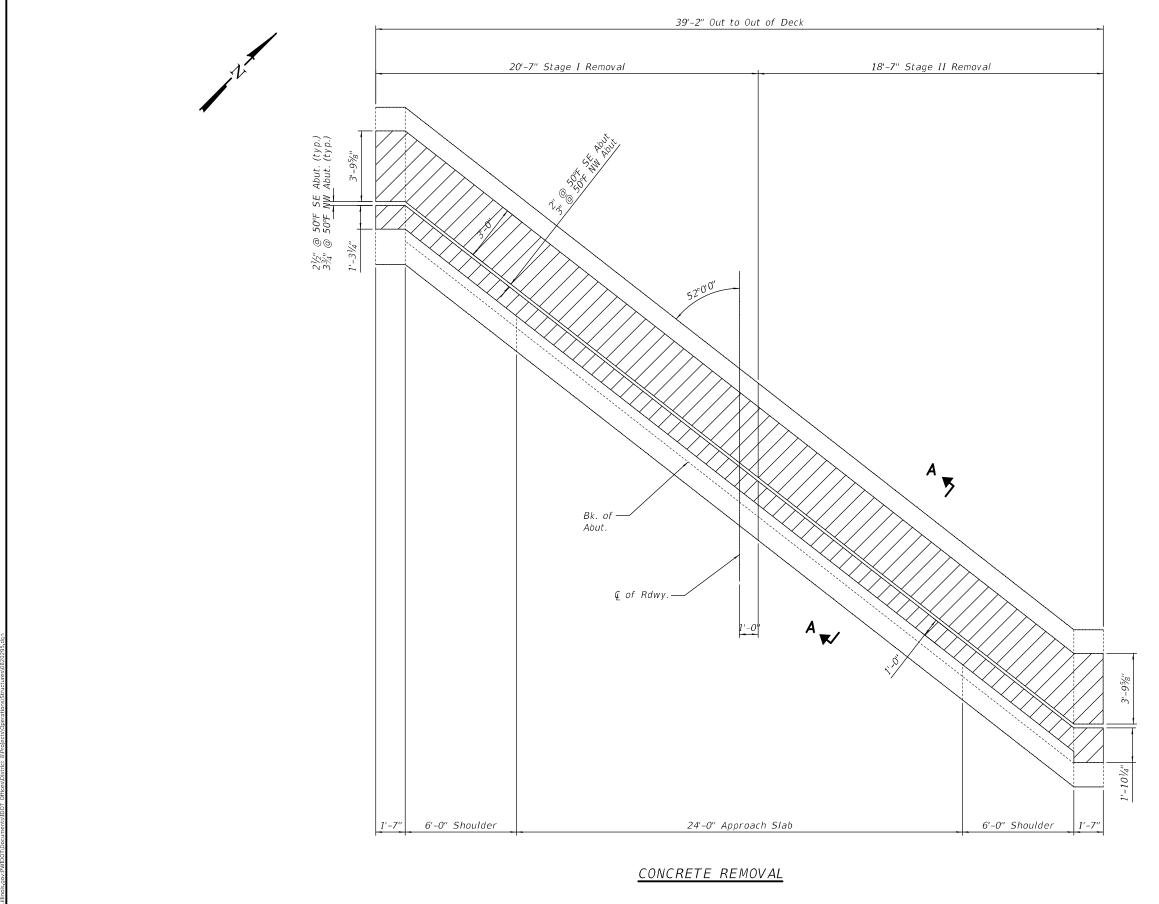

SE Abut shown (NW Abut similar except as noted)

USER NAME = vinsonay	DESIGNED - AYV	REVISED -			JOINT REMOVAL					F.A.P.	SECTION	COUNTY	TOTAL	SHEET	
	DRAWN - AYV	REVISED -	STATE OF ILLINOIS						817	50RS-4	ST. CLAIR	37	31		
PLOT SCALE = 5:2,0000 ':" / in.	CHECKED -	REVISED -	DEPARTMENT OF TRANSPORTATION	SN 082-0295								CONTRAC	T NO. 7	6L14	
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Note:


* Existing transverse bars extending from deck into removed area shall be cut allowing 2'-0" to extend into the removed area. In addition, these cut bars shall be cleaned, straighten, and incorporated into the new construction.

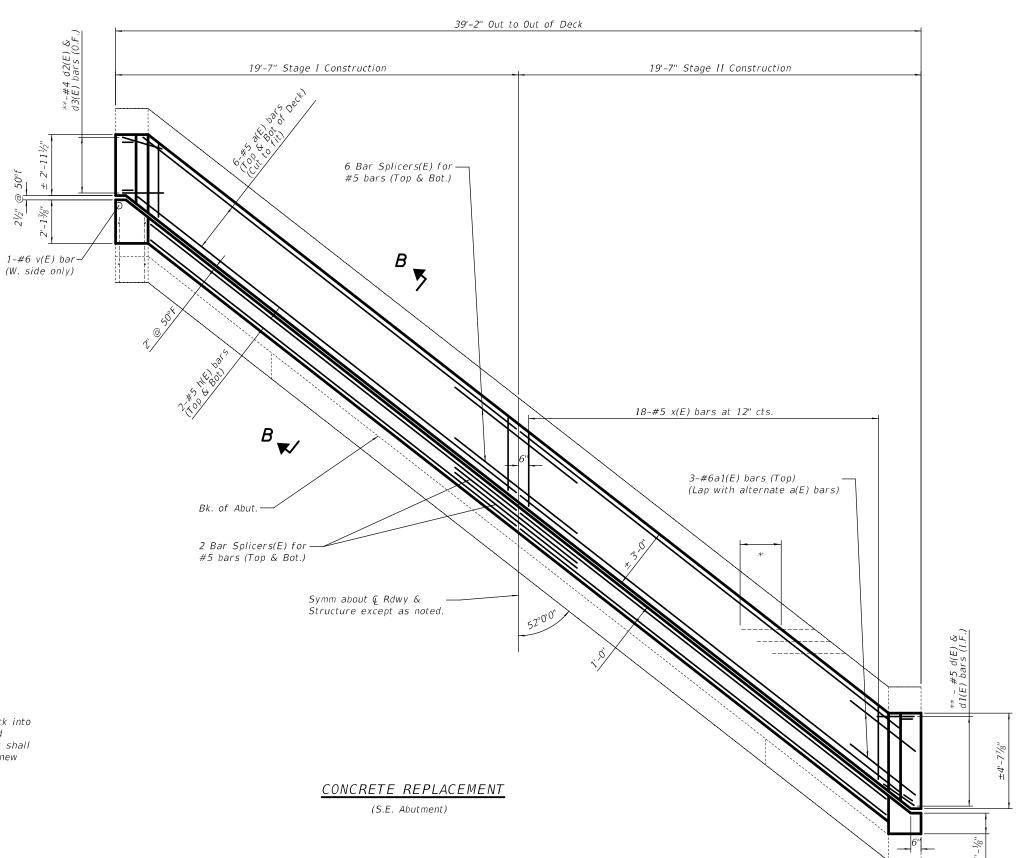** 4 (west side), 6 (east side)

USER NAME = vinsonay	DESIGNED -	REVISED -
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PLOT DATE = 3/15/2021	DATE -	REVISED -

STATE OF ILLINOIS
DEPARTMENT OF TRANSPORTATION

MODEL: 0820295-76L14-004

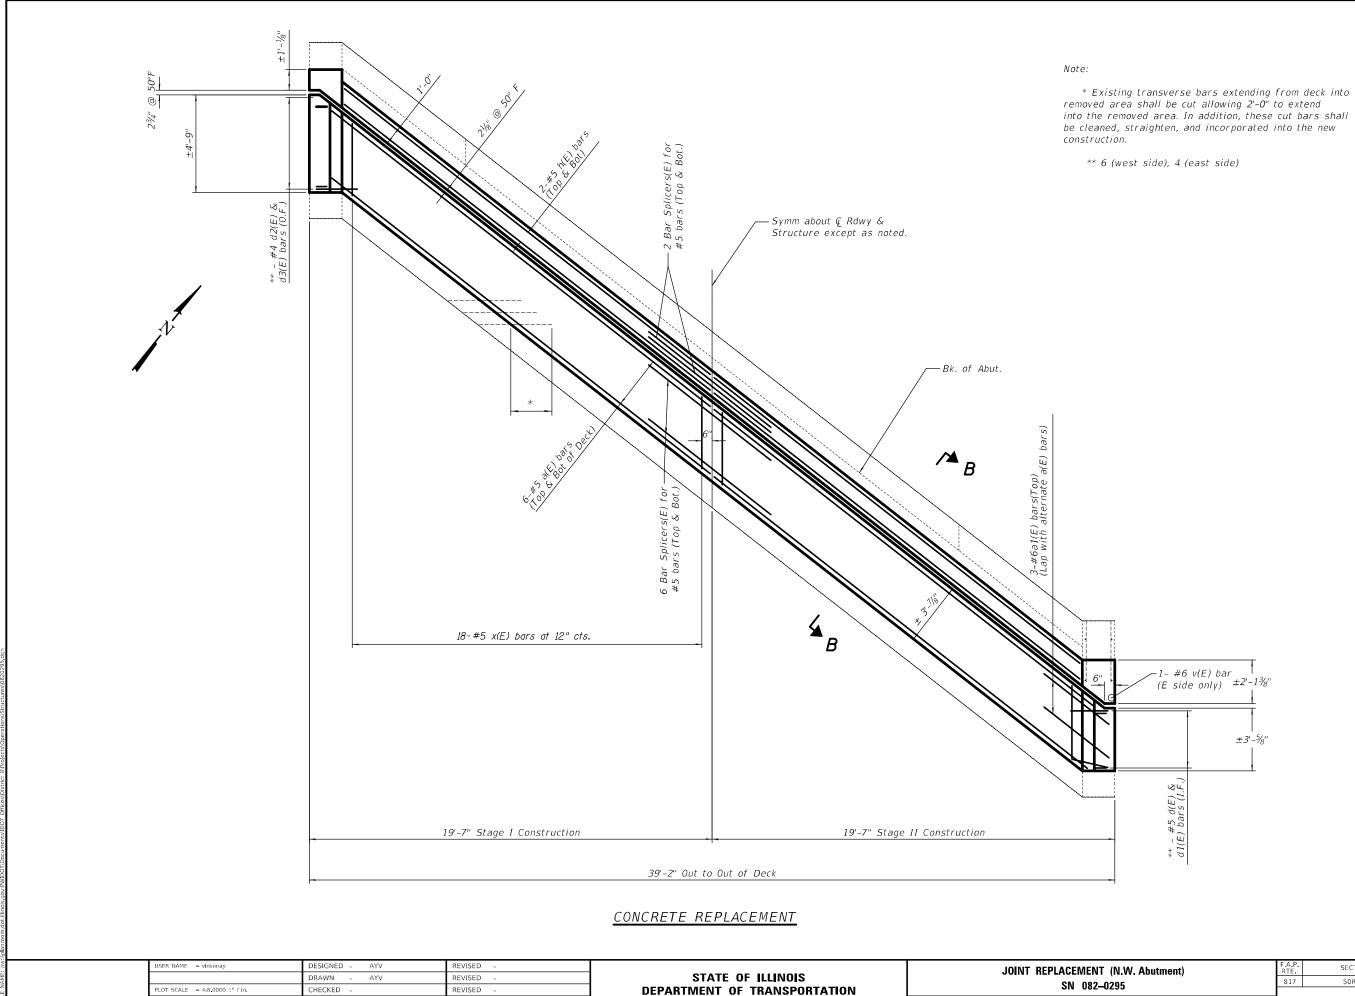

SECTION

50RS-4


SHEET 5


OF 9 SHEETS STA.

TO STA.

ST. CLAIR 37 33

CONTRACT NO. 76L14

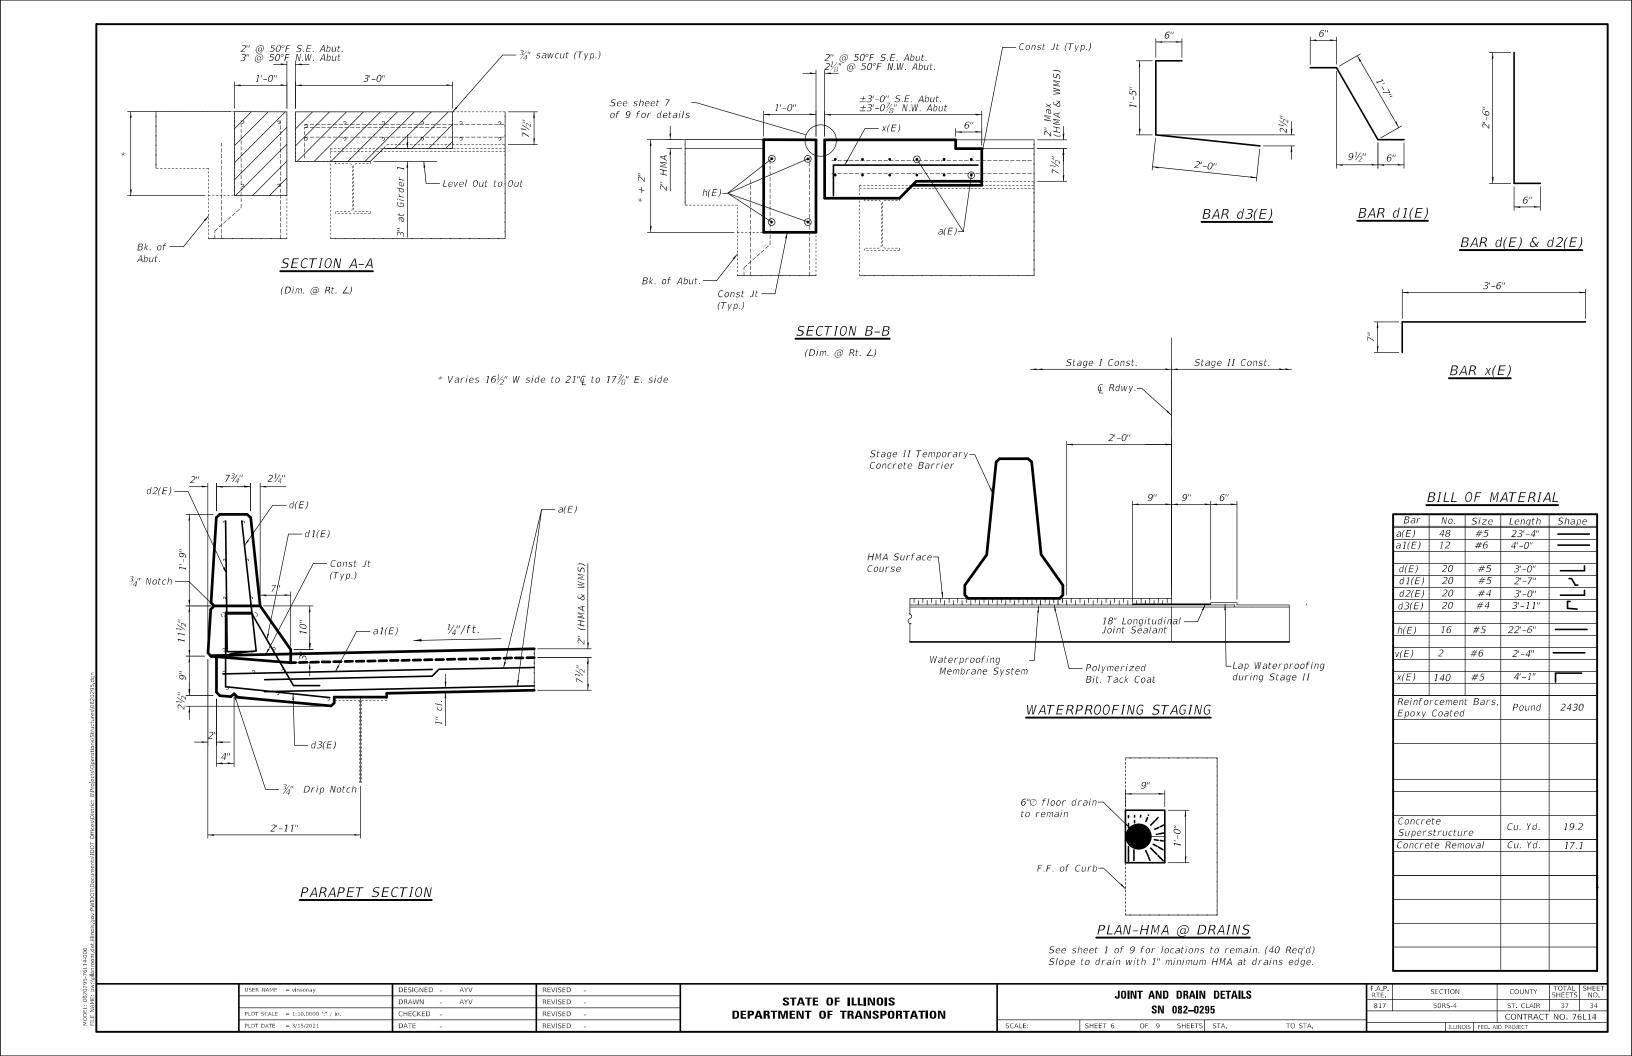

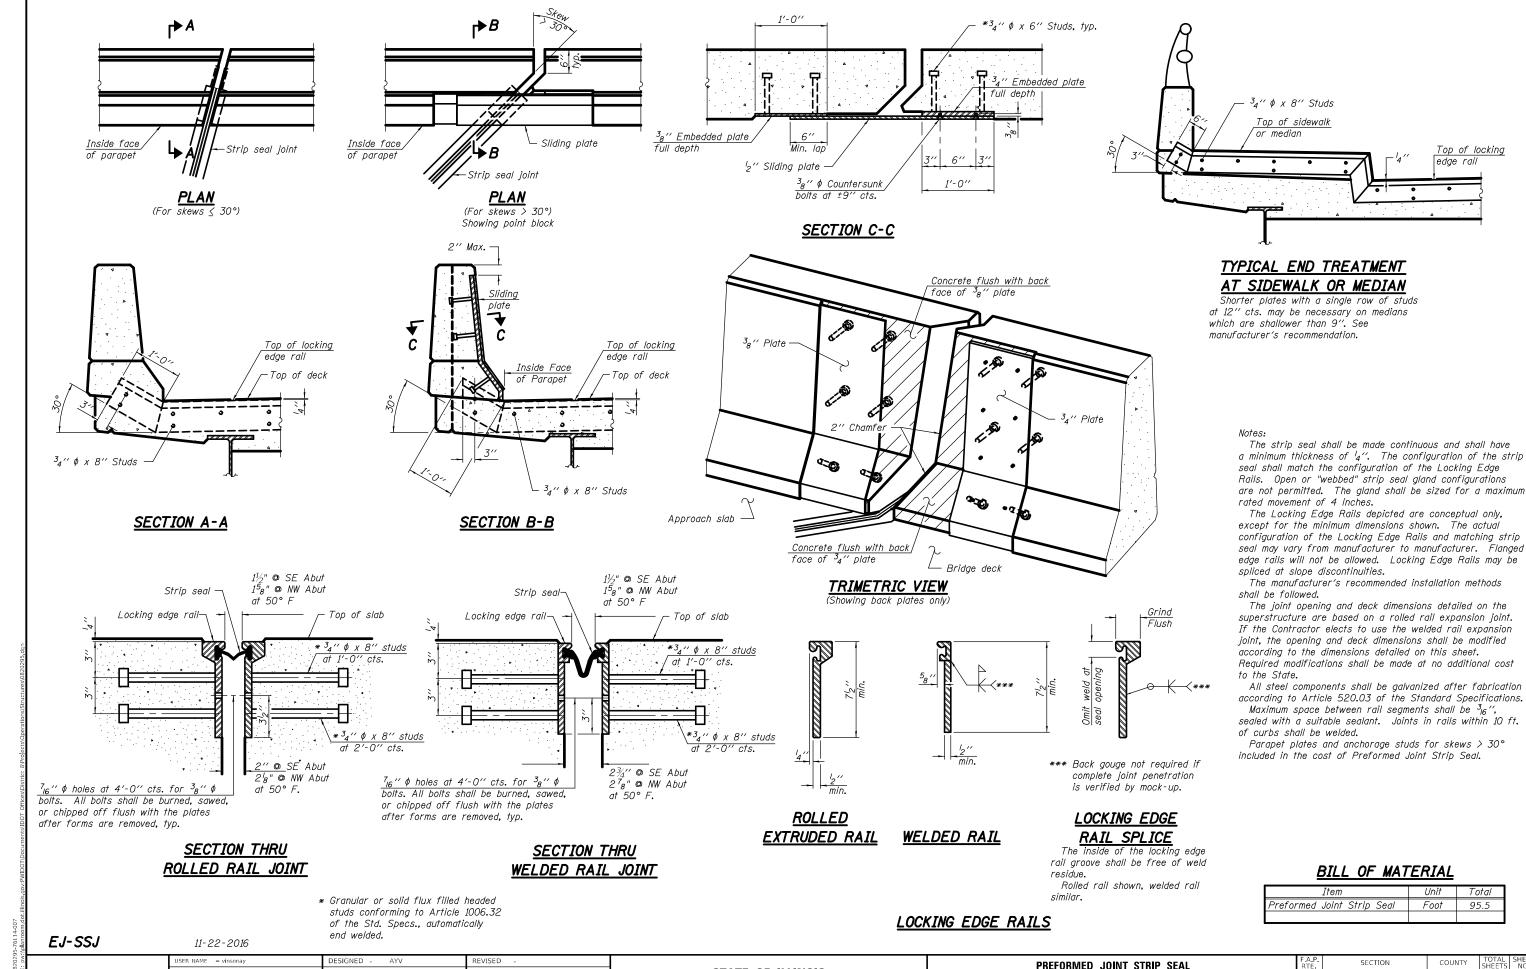


DRAWN -AYV REVISED CHECKED REVISED

STATE OF ILLINOIS **DEPARTMENT OF TRANSPORTATION** PREFORMED JOINT STRIP SEAL STRUCTURE NO. 082-0295 OF 9 SHEETS STA

TO STA.

50RS-4 ST CLAIR 37 35 CONTRACT NO. 76L14

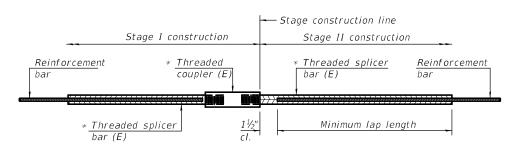


STANDARD BAR SPLICER ASSEMBLY

Threaded splicer bar length = min. lap length + $1\frac{1}{2}$ " + thread length


* Epoxy not required on Bar Splicer Assembly components used in conjunction with black bars.

Location	Bar size	No. assemblies required	Minimum lap length		
S.E. Hatchblock	#5	4	3'-6"		
S.E. Deck	#5	12	3'-6"		
N.W. Deck	#5	12	3'-6"		
N.W. Hatchblock	#5	4	3'-6"		

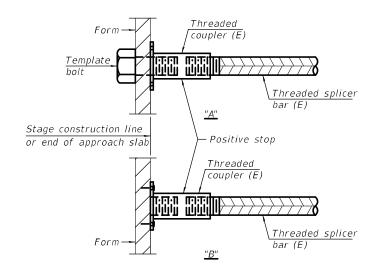


INSTALLATION AND SETTING METHODS

"A": Set bar splicer assembly by means of a template bolt.
"B": Set bar splicer assembly by nailing to wood forms or cementing to steel forms.
(E): Indicates epoxy coating.

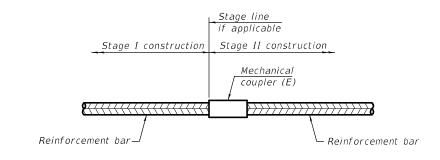

STANDARD MECHANICAL SPLICER

Location	Bar size	No. assemblies required

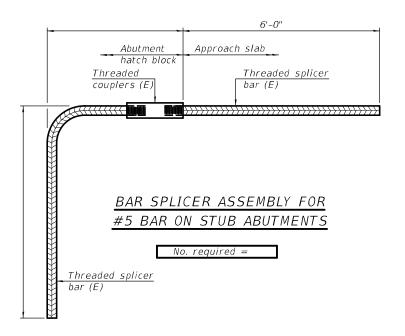

NOTES

Splicer bars shall be deformed with threaded ends and have a minimum 60 ksi yield strength.

All reinforcement shall be lapped and tied to the splicer bars.

Bar splicer assemblies shall be epoxy coated according to the requirements for reinforcement bars. See Section 508 of the Standard Specifications.

See approved list of bar splicer assemblies and mechanical splicers for alternatives.


BSD-1


2-17-2017

USER NAME = vinsonay	DESIGNED - AYV	REVISED -
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STATE OF ILLINOIS
DEPARTMENT OF TRANSPORTATION

BAR SPLICER ASSEMBLY AND MECHANICAL SPLICER DETAILS						F.A.P. RTE.			
STRUCTURE NO. 082-0295							817		
31110010HL NO. 002-0253									
	SHE	ET 8 ()F	9 S	HEETS	STA.	TO STA.		



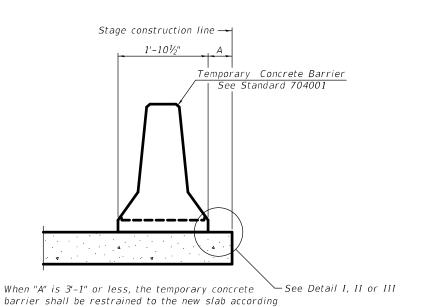

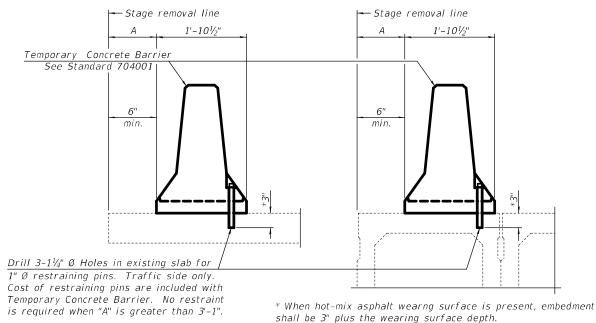1x8 UNC US Std. $1\frac{1}{16}$ " I.D. x $2\frac{1}{2}$ " O.D. x approx. 8 guage thick washer RESTRAINING PIN

NEW SLAB OR NEW DECK BEAM


to Detail I, II or III. No restraint is required

when "A" is greater than 3'-1".

EXISTING SLAB

EXISTING DECK BEAM

SECTIONS THRU SLAB OR DECK BEAM

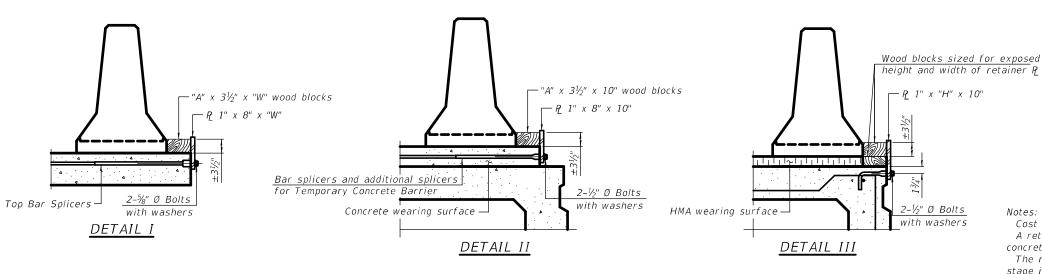



STEEL RETAINER P 1" x "H" x 10" (Detail III)

SCALE:

Notes:

Cost of retainer assembly is included with Temporary Concrete Barrier. A retainer assembly shall be located at the approximate Q of each temporary concrete barrier.

BAR SPLICER FOR #4 BAR - DETAIL III

The retainer plate shall not be removed until the concrete on the adjacent stage is ready to be poured. For Detail III applications the retainer plate shall not be removed until just prior to placing the adjacent beam.

When the 'A' dimension is less than $1\frac{1}{2}$ ", the wood block shall be omitted and the barrier shall be placed in direct contact with the steel retainer plate. For deck beam applications the minimum required 'A' distance is 6" to accommodate the shear key clamping device.

Detail I - Installation for a new bridge deck or bridge slab.

Detail II - Installation for a new deck beam with an initial concrete wearing surface. Additional bar splicers shall be provided at 6'-0" centers and paired with the bar splicers of the concrete wearing surface reinforcement to accommodate the installation of the retainer assemblies. The cost of the additional bar splicers is included with the concrete wearing surface.

Detail III - Installation for a new deck beam with no initial wearing surface or with an initial hot-mix asphalt (HMA) wearing surface present. The deck beam directly beneath the temporary concrete barrier shall be fabricated with bar splicer inserts in the side of the beam, as detailed, to accommodate the installation of the retainer assemblies. A pair of bar splicers, 6" apart, shall be placed at 6'-0" centers along the length of the beam. The cost of the bar splicers is included with the deck beam.

R-27

2-17-2017

USER NAME = vinsonay	DESIGNED - AYV	REVISED -
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STEEL RETAINER P 1" x 8" x "W"

(Detail I and II)

STATE OF ILLINOIS **DEPARTMENT OF TRANSPORTATION**

TEMPORARY CONCRETE BARRIER FOR STAGE CONSTRUCTION				F.A.P. RTE.	SECTION			
STRUCTURE NO. 082-0295						817	50RS-4	П
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ST. CLAIR 37 37 CONTRACT NO. 76L14