FOR INDEX OF SHEETS, SEE SHEET NO. 2

FOR LIST OF STATE AND LOCAL STANDARDS, SEE SHEET NO. 2

PROJECT LOCATED WITHIN THE VILLAGE OF BURR RIDGE

TRAFFIC DATA - GERMAN CHURCH ROAD POSTED SPEED: 40 MPH CURRENT ADT (2010): 4,400 VPD **FUNCTIONAL CLASS: MINOR ARTERIAL** 

**DESIGN DESIGNATION** SIDEWALK


STATE OF ILLINOIS DEPARTMENT OF TRANSPORTATION **DIVISION OF HIGHWAYS** 

# PLANS FOR PROPOSED FEDERAL AID PROJECT

**FAU ROUTE 1552 (GERMAN CHURCH ROAD)** S COUNTY LINE ROAD TO GREYSTONE COURT PEDESTRIAN IMPROVEMENTS PROJECT SECTION NO.: 14-00050-00-SW PROJECT NO.: M-4003 (422) VILLAGE OF BURR RIDGE COOK COUNTY

JOB NO.: C-91-139-15

#### R 12E 3RD PRINCIPAL MERIDIAN

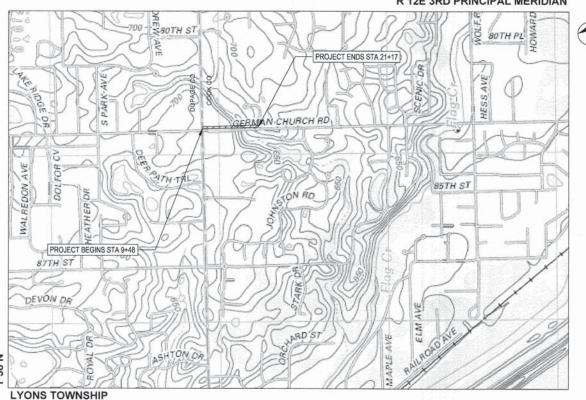


**LOCATION MAP** 

LYONS TOWNSHIP RANGE: 12E

GROSS LENGTH OF PROJECT = 1200 FEET (0.23 MILES) NET LENGTH OF PROJECT = 1200 FEET (0.23 MILES)

COOK

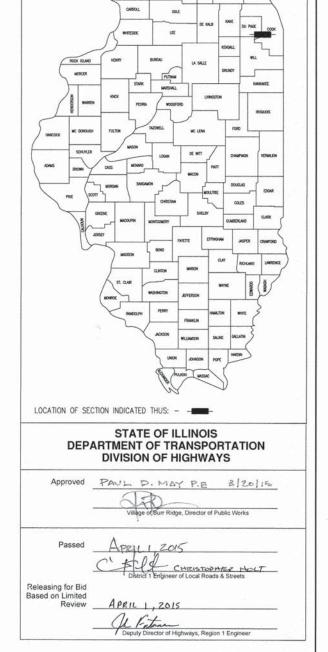




ANTHONY J. BRYANT, P.E.



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FULL SIZE PLANS HAVE BEEN PREPARED USING STANDARD ENGINEERING SCALES, REDUCED SIZED PLANS WILL NOT CONFORM TO STANDARD SCALES, IN MAKING MEASUREMENTS ON REDUCED PLANS. THE ABOVE SCALES MAY BE USED.

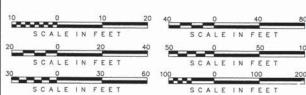JOINT UTILITY LOCATION INFORMATION FOR EXCAVATION

CONTRACT NO. 61B38

#### INDEX OF SHEETS

SHEET TYPE / TITLE COVER SHEET INDEX OF SHEETS, STANDARDS, AND GENERAL NOTES SUMMARY OF QUANTITIES TYPICAL SECTIONS SCHEDULE OF QUANTITIES ALIGNMENT, TIES AND BENCHMARKS TO REMOVAL PLAN TO PROPOSED PLAN AND PROFILE MAINTENANCE OF TRAFFIC PLANS EROSION AND SEDIMENT CONTROL PLAN 13 14 LANDSCAPING PLAN 15 TO 17 DETAILS DISTRICT 1 STANDARDS 18 TO 20

CROSS SECTIONS

#### DISTRICT 1 STANDARDS

DRAWING NUMBER TITLE

21 TO

TC-10 TRAFFIC CONTROL AND PROTECTION FOR SIDE ROADS, INTERSECTIONS, AND DRIVEWAYS

DISTRICT ONE TYPICAL PAVEMENT MARKINGS TC-13

TC-22 ARTERIAL ROAD INFORMATION SIGN

#### HIGHWAY STANDARDS

424001-08 PERPENDICULAR CURB RAMPS

701301-04 URBAN LANE CLOSURE, 2L, 2W, UNDIVIDED

701501-06 LANE CLOSURE 2L, 2W, SHORT TIME OPERATIONS

701701-09 URBAN LANE CLOSURE, MULTILANE INTERSECTION 701801-05 SIDEWALK, CORNER, OR CROSSWALK CLOSURE

701901-04 TRAFFIC CONTROL DEVICES

701006-05 OFF-ROAD OPERATIONS, 2L, 2W

701311-03 LANE CLOSURE 2L, 2W MOVING OPERATIONS - DAY ONLY

#### GENERAL NOTES:

- THE VILLAGE OF BURR RIDGE SHALL BE NOTIFIED AT LEAST SEVEN (7)
   WORKING DAYS PRIOR TO COMMENCEMENT OF CONSTRUCTION AND 72 HOURS PRIOR TO DEMOLITION WORK.
- 2. PRIOR TO COMMENCEMENT OF ANY EXCAVATION. THE CONTRACTOR SHALL CALL "JULIE" AT 1-800-892-0123 FOR FIELD LOCATIONS OF BURIED ELECTRIC, TELEPHONE, GAS, WATER, SEWER, AND CABLE TELEVISION FACILITIES (48 HOURS NOTIFICATION REQUIRED).
- THE CONTRACTOR IS RESPONSIBLE FOR CONTACTING ALL UTILITY OWNERS INCLUDING THE VILLAGE SO THAT THEIR FACILITIES MAY BE LOCATED AND ADJUSTED OR MOVED PRIOR TO COMMENCEMENT OF ANY SUBSURFACE WORK. THE CONTRACTOR SHALL BE RESPONSIBLE FOR DETERMINING THE EXACT LOCA ION OF THESE UTILITY LINES IN THE FIELD AND THE PROTECTION OF THEM FROM DAMAGE DUE TO CONSTRUCTION
- THE LOCATION OF PUBLIC OR PRIVATE UTILITIES SHOWN ON THE PLANS ARE APPROXIMATE AND THE VILLAGE AND ENGINEER DOES NOT GUARANTEE THEIR ACCURACY, THE CONTRACTOR SHALL BE RESPONSIBLE FOR THE PROTECTION OF ALL ABOVE AND BELOW GROUND UTILITIES EVEN THOUGH THEY MAY NOT BE SHOWN ON THE PLAN. ANY UTILITY THAT IS DAMAGED DURING CONSTRUCTION SHALL BE REPAIRED OR REPLACED TO THE SATISFACTION OF THE ENGINEER. THIS WORK SHALL BE AT THE EVENING OF THE CONTRACTOR EXPENSE OF THE CONTRACTOR
- 5. IF EXISTING UTILITY LINES OF ANY NATURE ARE ENCOUNTERED WHICH CONFLICT WITH NEW CONSTRUCTION, THE CONTRACTOR SHALL NOTIFY THE OWNER'S REPRESENTATIVE IMMEDIATELY SO THAT THE CONFLICT MAY BE RESOLVED.
- THE CONTRACTOR SHALL MAKE ARRANGEMENT FOR THE PROPER BRACING, SHORING, AND OTHER REQUIRED PROTECTION OF ALL
  UTILITIES PRIOR TO CONSTRUCTION. THE CONTRACTOR SHALL BE
  RESPONSIBLE FOR ANY DAMAGE TO THE UTILITIES AND ASSOCIATED STRUCTURES AND SHALL MAKE REPAIRS AS NECESSARY TO THE SATISFACTION OF THE UTILITY OWNER.
- EXCEPT WHERE MODIFIED BY THE CONTRACT DOCUMENTS, ALL WORK PROPOSED HEREIN SHALL BE IN ACCORDANCE WITH THE FOLLOWING SPECIFICATIONS, WHICH ARE HEREBY MADE A PART HEREOF:
  - (A) "STANDARD SPECIFICATIONS FOR ROAD AND BRIDGE CONSTRUCTION IN ILLINOIS." AS PREPARED BY IDOT, LATEST EDITION.
  - (B) "STANDARD SPECIFICATIONS FOR WATER AND SEWER MAIN CONSTRUCTION IN ILLINOIS," LATEST EDITION.
  - "ILLINOIS RECOMMENDED STANDARDS FOR SEWAGE WORKS," AS PUBLISHED BY THE IEPA, LATEST EDITION

THE STANDARD SPECIFICATIONS LISTED ON THESE CONSTRUCTION DRAWINGS AND SUBSEQUENT DETAILS ARE ALL TO BE CONSIDERED AS PART OF THE CONTRACT DOCUMENTS. INCIDENTAL ITEMS OR ACCESSORIES NECESSARY TO COMPLETE THIS WORK MAY NOT BE SPECIFICALLY NOTED BUT ARE TO BE CONSIDERED A PART OF THE CONTRACT.

- NO CONSTRUCTION DRAWINGS SHALL BE USED FOR CONSTRUCTION UNLESS SPECIFICALLY MARKED 'FOR CONSTRUCTION' PRIOR TO COMMENCEMENT OF SPECIFICALLY MARKED FOR CONSTRUCTION. PRIOR TO COMMENCEMENT OF CONSTRUCTION, THE CONTRACTOR SHALL VERIFY ALL DIMENSIONS AND CONDITIONS AFFECTING THEIR WORK WITH THE ACTUAL CONDITIONS AT THE JOB SITE. IF THERE ARE ANY DISCREPANCIES FROM WHAT IS SHOWN ON THE CONSTRUCTION DRAWINGS, CONTRACTOR MUST IMMEDIATELY REPORT SAME TO THE OWNER'S REPRESENTATIVE BEFORE DOING ANY WORK OTHERWISE THE CONTRACTOR ASSUMES FULL RESPONSIBILITY. IN TEVENT OF DISAGREEMENT BETWEEN THE CONSTRUCTION DRAWINGS, STANDARD SPECIFICATIONS AND/OR SPECIAL DETAILS, THE CONTRACTOR SHALL SECURE WRITTEN INSTRUCTIONS FROM THE ENGINEER PRIOR TO PROCEEDING WITH ANY PART OF THE WORK AFFECTED BY OMISSIONS OR DISCREPANCIES. FAILING TO SECURE SUCH INSTRUCTION, THE CONTRACTOR WILL BE CONSIDERED TO HAVE PROCEEDED AT ITS OWN RISK AND EXPENSE.
- THE ENGINEER AND OWNER ARE NOT RESPONSIBLE FOR THE CONSTRUCTION MEANS, METHODS, TECHNIQUES, SEQUENCES OR PROCEDURES, TIME OF PERFORMANCE, PROGRAMS OR FOR ANY SAFETY PRECAUTIONS USED BY THE CONTRACTOR. THE CONTRACTOR IS SOLELY RESPONSIBLE FOR EXECUTION OF THE WORK IN ACCORDANCE WITH THE CONTRACT DOCUMENTS AND SPECIFICATIONS.
- 10. CONSTRUCTION INGRESS/EGRESS SHALL BE RESTRICTED TO PUBLIC ROADWAYS. CONSTRUCTION ENTRANCES/EXITS SHALL BE CLEANED DAILY AS NEEDED OR AS DIRECTED BY THE ENGINEER.
- 11. EXISTING DRAINAGE ROUTES SHALL BE MAINTAINED THROUGHOUT THE DURATION OF CONSTRUCTION. LOOSE MATERIALS DEPOSITED IN THE FLOW LINE OF GUTTERS, DRAINAGE STRUCTURES, DIFCHES, ETC. SUCH THAT THE NATURAL FLOW LINE IS OBSTRUCTED, SHALL BE REMOVED BY THE CLOSE OF EACH WORKING
- 12. THE CONTRACTOR SHALL PROVIDE DUST CONTROL MEASURES AS DIRECTED
- 13. THE CONTRACTOR SHALL BE RESPONSIBLE FOR THE INSTALLATION AND MAINTENANCE OF ADEQUATE TRAFFIC CONTROLS SIGNS AND DEVICES. BARRICADES AND WARNING SIGNS SHALL BE PROVIDED IN ACCORDANCE WITH I.D.O.T. STANDARD SPECIFICATIONS AND "MANUAL ON UNIFORM TRAFFIC CONTROL DEVICES."
- 14. PRIOR TO CONSTRUCTION, ALL EXISTING TRAFFIC/STREET SIGNS SHALL BE REMOVED AND RETURNED TO THE VILLAGE OF BURR RIDGE. THE VILLAGE WILL REPLACE STREET SIGNS AT THE CONCLUSION OF THE PROJECT.
- 15. THE CONTRACTOR SHALL KEEP A SET OF "APPROVED" CONSTRUCTION DRAWINGS ON THE JOB SITE, AND SHALL MAINTAIN A RECORD ON SAID DRAWINGS OF ANY UNANTICIPATED UTILITIES ENCOUNTERED, ANY MODIFICATIONS/ALTERATIONS TO ALIGNMENT AND/OR TO DRAWINGS AND SPECIFICATIONS OF PROPOSED IMPROVEMENTS. UPON COMPLETION OF THE CONTRACTOR'S WORK, SAID DRAWINGS AND INFORMATION SHALL BE PROVIDED TO THE OWNER'S REPRESENTATIVE.
- 16. THE CONTRACTOR SHALL BE RESPONSIBLE FOR CONSTRUCTION SURVEY
- 17. THE CONTRACTOR SHALL PERFORM A PRE—CONSTRUCTION VIDEO TAPING OF THE PROJECT SITE AND SURROUNDING AREA. THE VIDEO TAPE(S) MUST BE APPROVED BY THE ENGINEER PRIOR TO COMMENCEMENT
- 18. THE CONTRACTOR SHALL USE INLET FILTER BASKETS, SILT FENCE AND ANY OTHER EROSION CONTROL MEASURES AS DIRECTED BY THE ENGINEER.
- THE CONTRACTOR SHALL BE RESPONSIBLE FOR MAKING ALL ARRANGEMENTS AND PAYING FOR ALL COSTS ASSOCIATED WITH ANY TEMPORARY UTILITIES THAT MAY BE NECESSARY FOR THE PROJECT.
- 20. WATER REQUIRED FOR CONSTRUCTION OPERATIONS MAY BE OBTAINED FROM VILLAGE FIRE HYDRANTS IN THE AREA. THE CONTRACTOR IS RESPONSIBLE FOR OBTAINING A WATER METER AND BACKFLOW PREVENTER FROM THE VILLAGE AND PURCHASING WATER AT THE APPLICABLE RATE
- 21. THE CONTRACTOR SHALL PROVIDE PORTABLE SANITARY FACILITIES FOR HEIR USE THROUGHOUT THE DURATION OF THE PROJECT
- 22. ALL DISTURBED GRASS AREAS SHALL BE RESTORED WITH SOD. SUPPLEMENTAL WATERING SHALL BE APPLIED AS DIRECTED BY THE ENGINEER, IN ACCORDANCE WITH IDOT STANDARD SPECIFICATIONS AND SPECIAL PROVISIONS.
- 23. THE CONTRACTOR SHALL TEMPORARILY RELOCATE AND PERMANENTLY RESET MAILBOXES AS DIRECTED BY THE LOCAL POSTMASTER. PER IDOT SPECIFICATION, SECTION 107.20, THIS WORK SHALL BE CONSIDERED INCLUDED IN THE COST OF THE CONTRACT.

- 24. THE CONTRACTOR SHALL USE FLAT TOP SLABS IN LIFT OF CONICALLY TAPERED TOPS FOR MANHOLES AND CATCH BASINS WHEREVER NECESSARY TO AVOID CONFLICTS WITH EXISTING UTILITIES. FLAT SLAB TOPS WILL NOT BE MEASURED FOR PAYMENT, BUT INCLUDED IN THE UNIT COST OF THE ASSOCIATED DRAINAGE STRUCTURE(S).
- 25. THE CONTRACTOR IS RESPONSIBLE FOR SECURING AND POSTING A BOND WITH THE COOK COUNTY DEPARTMENT OF TRANSPORTATION AND HIGHWAYS BEFORE COMMENCING WORK
- 26. THE CONTRACTOR IS RESPONSIBLE FOR PROVIDING TRAFFIC CONTROL IN ACCORDANCE WITH ALL IDOT STANDARDS. WORK IN THE NORTH LANE OF GERMAN CHURCH ROAD SHALL BE DONE UNDER FLAGGERS BETWEEN 9:00AM AND 3:00PM.
- 27. NO TRAFFIC SIGNAL APPARATUS SHALL BE IMPACTED BY THE PROPOSED WORK. THE TRAFFIC SIGNAL APPARATUS NEAR THE CORNER OF COUNTY LINE ROAD AND GERMAN CHURCH ROAD SHALL IN NO WAY BE IMPACTED. ANY DAMAGE TO TRAFFIC SIGNAL EQUIPMENT SHALL BE REPAIRED TO THE SATISFACTION OF THE COOK COUNTY DEPARTMENT OF TRANSPORTATION AND HIGHWAYS, AT THE CONTRACTOR'S EXPENSE.
- 28. SPECIAL ATTENTION IS CALLED TO ARTICLE 107.30 OF THE STANDARD SPECIFICATIONS. ANY DEFACED WORK SHALL BE CORRECTED OR REPLACED BY THE CONTRACTOR AT HIS SOLE EXPENSE PRIOR TO FINAL PAYMENT.

#### COOK COUNTY DEPARTMENT OF TRANSPORTATION AND HIGHWAYS NOTES:

- CARE IS TO BE TAKEN AS NOT TO DAMAGE ANY OF THE EXISTING TRAFFIC SIGNAL CONDUITS, AND EQUIPMENT. IF ANY OF THE TRAFFIC SIGNAL CONDUITS, CABLES AND/OR EQUIPMENT IS DAMAGED, THE CONTRACTOR SHALL REPAIR AND/OR REPLACE THE CONDUITS, CABLES AND/OR EQUIPMENT AT NO COST TO THE COUNTY.
- 2. THE COUNTY IS NOT PART OF JULIE FOR LOCATION OF TRAFFIC SIGNAL EQUIPMENT, CONTACT THE MECHANICAL, ELECTRICAL, ARCHITECTURAL AND LANDSCAPING DIVISION AT 312-603-1730.
- FOR THE LOCATION OF UNDERGROUND COUNTY MAINTAINED FACILITIES, SEE COUNTY SPECIAL RPOVISION "TRAFFIC SIGNAL WORK GENERAL".

#### COMMITMENTS:

NONE, 01-22-2015

	LEGEND
EXISTING	
o <sup>GV</sup>	GAS VALVE
Ÿ	DECORATIVE LIGHT
DISTONE	BOULDER
.n.T	TEMPORARY SIGN
.m.	SIGN
tart .	TELEPHONE CABINET
1227	TELEPHONE PEDESTAL
A	CONTROL POINT
8	CONTROL POINT (CHIS "X")
⊠ <sup>CTV</sup>	CATV PEDESTAL
o <sup>BB</sup>	BUFFALO BOX
⊗ <sup>WV</sup>	WATER VALVE
08	CATCH BASIN
- CATV	CATV LINE
OH	OVERHEAD LINE
	SANITARY SEWER
-st	STORM SEWER
59	COMBINED SEWER

to hall by	SEP BARE 4	DESIGNED AJB	REVISED -		F.A.U RTF	SECTION	COUNTY	TOTAL SHEET
	7-14-17-2	DRAWN - TRD	REVISED	INDEX OF SHEETS, STANDARDS, AND GENERAL NOTES	1552	14-00050-00-SW	COOK	23 2
	LANCE OF THE PERSON OF THE PER	DRAWN TRD REVISED STATE OF ILLINOIS INDEX OF SHEETS, STANDARDS, AND GENERAL NOTES  CHECKED MAP REVISED DEPARTMENT OF TRANSPORTATION  DATE 01/28/2015 REVISED CERMAN CHURCH ROAD PED IMPROVEMENT CONTRACT  CONT	CT NO. 61B38					
	ECOL DATE: =	DATE - 01/28/2	2015 REVISED	SCALE: NONE SHEET 1 OF 1 SHEETS STA. TO STA.	FED. RC	AD DIST, NO. 1 ILLINOIS FED. A	ID PROJECT	


75F UMB #	DESIGNED - AJB	REVISED	
	DRAWN - TRD	REVISED	
FIRST SHALL N	CHECKED - MAP	REVISED -	
Roy1 (ATE III	DATE 01/28/2015	REVISED	


STATE OF ILLINOIS
DEPARTMENT OF TRANSPORTATION

				SUMM	ARY	OF QUAI	ITITIES			
SCALE: N	NONE	SHEET	1	OF	1	SHEETS	STA.	то	STA.	

					CONSTRUCTION CO
	CODE NO.	ITEM	UNIT	TOTAL QUANTITY	75% FED, 25% LOC (BURR RIDGE)
	20100110	TREE REMOVAL (6 TO 15 UNITS DIAMETER)	UNIT	380	380
L	20100210	TREE REMOVAL (OVER 15 UNITS DIAMETER)	UNIT	182	182
Δ	20101200	TREE ROOT PRUNING	EACH	15	15
Ļ	20101300	TREE PRUNING (1 TO 10 INCH DIAMETER)	EACH	9	9
_	20101300		EACH	9	9
4	20101350	TREE PRUNING (OVER 10 INCH DIAMETER)	EACH	6	6
F	20200100	EARTH EXCAVATION	CU YD	1258	1258
İ	20201200	REMOVAL AND DISPOSAL OF UNSUITABLE MATERIAL	CU YD	197	197
E	20400800	FURNISHED EXCAVATION	CU YD	318	318
-	20900110	POROUS GRANULAR BACKFILL	CU YD	165	165
F					
	21101615	TOPSOIL FURNISH AND PLACE, 4"	SQ YD	2278	2278
4	25000400	NITROGEN FERTILIZER NUTRIENT	POUND	42	42
4	25000500	PHOSPHORUS FERTILIZER NUTRIENT	POUND	42	42
4	25000600	POTASSIUM FERTILIZER NUTRIENT	POUND	42	42
1	25100630	EBOSION CONTROL BLANKET	20.10	2044	
-	20100000	EROSION CONTROL BLANKET	SQ YD	2014	2014
4	25200110	SODDING, SALT TOLERANT	SQ YD	2278	2278
-	28000400	PERIMETER EROSION BARRIER	FOOT	342	342
F	28000510	INLET FILTERS	EACH	6	6
F					
	28100127	STONE RIPRAP, CLASS B4	SQ YD	40	40
ŀ	35101600	AGGREGATE BASE COURSE, TYPE 8 4*	SQ YD	590	590
F	42400200	PORTLAND CEMENT CONCRETE SIDEWALK 5 INCH	SQ FT	5310	5310
	42400800	DETECTABLE WARNING	SQ FT	32	32
	44000100	PAVEMENT REMOVAL	SQ YD	37	37
-	44000200	DRIVEWAY PAVEMENT REMOVAL	SQ YD	41	41
F	44000700				
t	44000500	COMBINATION CURB & GUTTER REMOVAL	FOOT	20	20
H	44000600	SIDEWALK REMOVAL	SQ FT	50	50
F	44201765	CLASS D PATCHES, TYPE II, 10 INCH	SQ YD	37	37
F	50200100	STRUCTURE EXCAVATION	CU YD	414	414
E	50300225	CONCRETE STRUCTURES	CU YD	108	108
E	50800205	REINFORCEMENT BARS, EPOXY COATED	POUND	13700	13700
F	54213657	PRECAST REINFORCED CONCRETE FLARED END SECTIONS 12*	EACH	2	2
F					
E	550A0340	STORM SEWERS, CLASS A, TYPE 2, 12"	FOOT	497	497
	5910G100	GEOCOMPOSITE WALL DRAIN	SQ YD	200	200

					CONSTRUCTION CODE
		132			STP FUNDS
	CODE NO.	пем	UNIT	TOTAL QUANTITY	75% FED, 25% LOCAL (BURR RIDGE)
	60200105	CATCH BASINS, TYPE A, 4' DIAMETER, TYPE 1 FRAME, OPEN LID	EACH	2	2
	60234200	INLETS, TYPE A, TYPE 1 FRAME, OPEN LID	EACH	2	2
	60600605	CONCRETE CURB, TYPE B	FOOT	125	125
-	60603800	COMBINATION CONCRETE CURB AND GUTTER, TYPE 8-6.12	FOOT	20	20
_	63200310	GUARDRAIL REMOVAL	FOOT	137	137
	67100100	MOBILIZATION	L SUM	1	1
_	78001110	PAINT PAVEMENT MARKING - LINE 4*	FOOT	18	18
	70001100				
	78001130	PAINT PAVEMENT MARKING - LINE 6"	FOOT	90	90
	78001150	PAINT PAVEMENT MARKING - LINE 12"	FOOT	96	96
	78001180	PAINT PAVEMENT MARKING - LINE 24"	FOOT	15	16
	85000200	MAINTENANCE OF EXISTING TRAFFIC SIGNAL INSTALLATION	EACH	1	1
_	89502376	REBUILD EXISTING HANDHOLE	EACH	1	1
	A2C02501	TREE, CERCIS CANADENSIS (REDBUD), 1° CALIPER, CONTAINER GROWN	EACH	7	7
	B2002222	TREE, CRATAEGUS VIRDIS WINTER KING (WINTER KING GREEN HAWTHORN), 3° CALIPER, BALLED AND BURLAPPED	EACH	4	4
	C2005815	SHRUB, RHUS AROMATICA GRO-LOW (GRO-LOW FRAGRANT SUMAC). 15° WIDTH, BALLED AND BURLAPPED	EACH	100	100
	F30098Y2	SEEDLING-OSTRYA VIRGINIANA (AMERICANHOPHORNBEAM), 2-YEAR OLD, BARE ROOT	uni+ ·	0.01	0.01
_	F30130G3	SEEDLING-QUERCUS BICOLOR (SWAMP WHITE OAK), 3-GALLON CONTAINER	EACH	4	4
	F30160Y2	SEEDLING-QUERCUS RUBRA (RED OAK), 2-YEAR OLD, BARE ROOT	Unit	0.04	0.04
	X0324450	SEGMENTAL CONCRETE BLOCK WALL, SPECIAL	SQ FT	1059	1059
_					
	X5090810	PEDESTRIAN RAIL (SPECIAL)	FOOT	195	195
	X7010216	TRAFFIC CONTROL AND PROTECTION, (SPECIAL)	L SUM	1	1
_	XX006858	RAILING	FOOT	118	118
	Z0013798	CONSTRUCTION LAYOUT	L SUM	1	1
	Z0046304	PIPE UNDERDRAINS FOR STRUCTURES 4*	FOOT	200	200
	Z0073002	TEMPORARY SOIL RETENTION SYSTEM	SQ FT	1755	1755
_					
1	899K00XX	PRECONSTRUCTION VIDEOTAPING # *	L SUM	1	

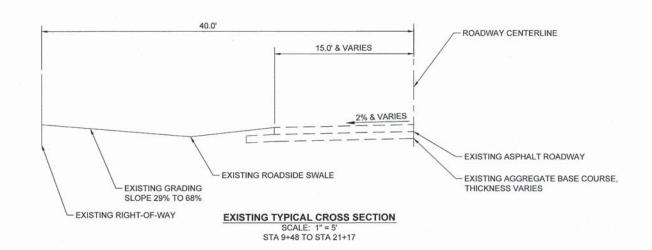

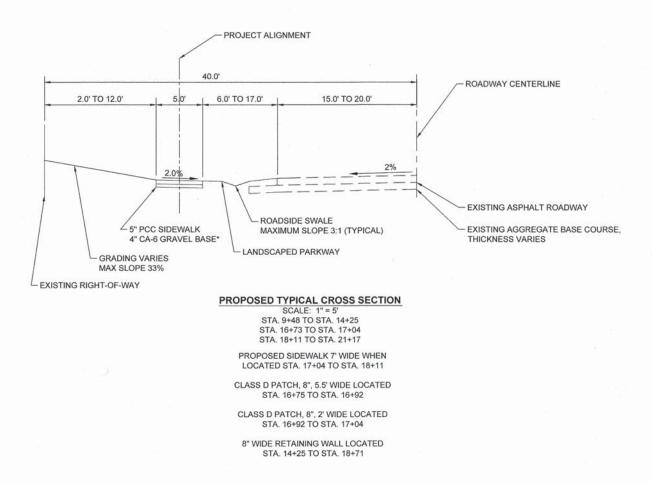

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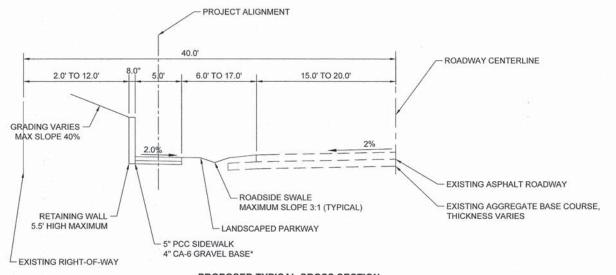
TRD

MAP

REVISED


REVISED

\*AGGREGATE BASE COURSE, TY. B, 4" THICK, (CA-6) (INCLUDED IN THE COST OF PCC SIDEWALK, 5 INCH)



PROPOSED TYPICAL CROSS SECTION
SCALE: 1" = 5'
STA 14+25 TO STA. 16+73

8" WIDE RETAINING WALL LOCATED STA. 14+25 TO STA. 18+71

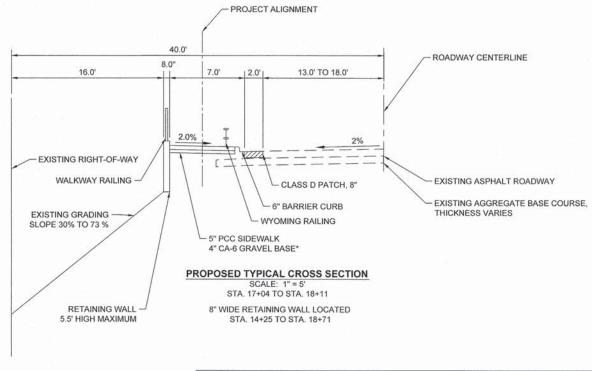

HOT-MIX ASPHALT MIXTURE REQUIREMENTS				
MIXTURE TYPE	AIR VOIDS @Ndes			
PATCHING CLASS D PATCHES (HMA BINDER IL-19 MM)	4% @ 70 Gyr.			

THE "AC TYPE" FOR POLYMERIZED HMA MIXES SHALL BE "SBS/SBR PG 76-22" AND FOR NON-POLYMERIZED HMA THE "AC TYPE" SHALL BE "PG 64-22" UNLESS MODIFIED BY DISTRICT ONE SPECIAL PROVISIONS. FOR HMA FULL DEPTH "AC TYPE" SEE SPECIAL PROVISIONS. FOR USE OF RECYCLED MATERIALS SEE SPECIAL PROVISIONS.

STATE OF ILLINOIS
DEPARTMENT OF TRANSPORTATION

PLOT SCALE =

DIAMETER (INCHES)	STATION	OFFSET	TREE REMOVAL
24	11+57	3.21 R	Y
10	11+69	3.06 L	Y
10	12+63	0.31 L	Y
9	12+89	0	Y
6	12+91	2.09 L	Y
9	13+48	3.65 L	Y
8	13+57	2.83 L	Y
8	13+64	5.58 L	Y
8	13+78	5.83 L	Y
6	13+81	4.46 L	Y
9	13+87	5.48 L	Y
8	13+91	10.44 L	Y
15	14+20	7.64 L	Y
12	14+29	7.40 L	Y
18	14+32	10.37 L	Y
18	14+42	5.30 L	Y
7	14+68	2.31 L	Y
7	14+78	3.33 L	Y
7	14+87	0.14 R	Υ
9	14+89	5.25 L	Y
9	14+96	3.82 L	Y
8	14+95	1.53 L	Y


GERMAN CF	HURCH ROAL	J STA 15+00	10 18+50
DIAMETER (INCHES)	STATION	OFFSET	TREE REMOVAL
6	15+08	0.92 L	Y
6	15+09	3.08 L	Y
7	15+23	1.74 R	Y
7	15+39	1.03 L	Y
7	15+51	0.67 L	Y
9	15+51	9.28 L	Y
6	15+66	0.62 L	Y
14	15+68	8.42 L	Y
6	15+82	2.69 L	Y
7	15+86	7.48 L	Y
6	15+86	0.81 R	Y
6	16+04	1.48 R	Y
6	16+16	1.02 R	Y
6	16+19	1.81 L	Y
6	16+23	3.60 L	Y
18	16+36	4.57 L	Y
8	16+39	2.33 L	Y
10	16+50	9.24 L	Y
7	16+54	2.47 L	Y
7	16+57	1.21 L	Y
7	16+58	3.28 L	Y
6	16+62	6.02 L	Y


EARTHWORK SCHEDULE						
LOCATION (GERMAN CHURCH RO	AD)	EARTH EXCAVATION (CU. YD.) 20200100	FURNISHED EXCAVATION (CU. YD.) 20400800	TOPSOIL FURNISH AND PLACE, 4" (SQ. YD.) 21101615		
9+48 to 14+00		158	6	737		
14+00 to 18+50		938	31	1026		
18+50 to 21+17		162	135	515		
	TOTAL	1258	172	2278		

DIAMETER (INCHES)	STATION	OFFSET	TREE REMOVAL
24	18+68	6.13 R	Y
9	18+84	16.64 R	Y
6	18+86	12.20 R	Y
9	18+91	15.33 R	Y
6	19+06	16.74 R	Y
18	19+06	8.18 R	Y
6	19+14	12.14 R	Y
6	19+21	10.62 R	Y
7	19+37	5.03 R	Y
6	19+47	10.94 R	Y
30	19+53	12.77 R	Y
16	19+84	1.95 L	Y
16	19+99	1.30 R	Y
10	20+03	3.67 R	Y
6	20+10	3.88 R	Y

	GERMAN CHURCH ROAD TREE SCHEDULE						
NO.	CODED PAY ITEM	DESCRIPTION	STATION	OFFSET			
1	F30130G3	SEEDLING-QUERCUS BICOLOR (SWAMP WHITE OAK), 3-GALLON CONTAINER	11+80	5L			
2	F30130G3	SEEDLING-QUERCUS BICOLOR (SWAMP WHITE OAK), 3-GALLON CONTAINER	12+18	5R			
3	F30130G3	SEEDLING-QUERCUS BICOLOR (SWAMP WHITE OAK), 3-GALLON CONTAINER	12+68	5R			
4	F30098Y2	SEEDLING-OSTRYA VIRGINIANA (AMERICANHOPHORNBEAM), 2-YEAR OLD, BARE ROOT	13+26	5R			
5	A2C02501	TREE, CERCIS CANADENSIS (REDBUD), 1" CALIPER, CONTAINER GROWN	13+65	5L			
6	A2C02501	TREE, CERCIS CANADENSIS (REDBUD), 1" CALIPER, CONTAINER GROWN	13+75	6L			
7	A2C02501	TREE, CERCIS CANADENSIS (REDBUD), 1" CALIPER, CONTAINER GROWN	13+80	7L			
8	A2C02501	TREE, CERCIS CANADENSIS (REDBUD), 1" CALIPER, CONTAINER GROWN	13+88	8L			
9	F30130G3	SEEDLING-QUERCUS BICOLOR (SWAMP WHITE OAK), 3-GALLON CONTAINER	14+30	8L			
10	A2C02501	TREE, CERCIS CANADENSIS (REDBUD), 1" CALIPER, CONTAINER GROWN	14+67	8L			
11	A2C02501	TREE, CERCIS CANADENSIS (REDBUD), 1" CALIPER, CONTAINER GROWN	14+82	8L			
12	A2C02501	TREE, CERCIS CANADENSIS (REDBUD), 1" CALIPER, CONTAINER GROWN	14+94	8L			
13	B2002222	TREE, CRATAEGUS VIRDIS WINTER KING (WINTER KING GREEN HAWTHORN), 3" CALIPER, BALLED AND BURLAPPED	16+20	10L			
14	B2002222	TREE, CRATAEGUS VIRDIS WINTER KING (WINTER KING GREEN HAWTHORN), 3" CALIPER, BALLED AND BURLAPPED	16+32	10L			
15	B2002222	TREE, CRATAEGUS VIRDIS WINTER KING (WINTER KING GREEN HAWTHORN), 3" CALIPER, BALLED AND BURLAPPED	16+43	10L			
16	F30160Y2	SEEDLING-QUERCUS RUBRA (RED OAK), 2-YEAR OLD, BARE ROOT	18+35	5L			
17	B2002222	TREE, CRATAEGUS VIRDIS WINTER KING (WINTER KING GREEN HAWTHORN), 3" CALIPER, BALLED AND BURLAPPED	18+63	10R			
18	F30160Y2	SEEDLING-QUERCUS RUBRA (RED OAK), 2-YEAR OLD, BARE ROOT	19+17	10R			
19	F30160Y2	SEEDLING-QUERCUS RUBRA (RED OAK), 2-YEAR OLD, BARE ROOT	19+46	10R			
20	F30160Y2	SEEDLING-QUERCUS RUBRA (RED OAK), 2-YEAR OLD, BARE ROOT	19+85	8R			

FILE NAME=	USER NAME =	DESIGNED — AJB	REVISED —			F.A.U RTE.	SECTION	COUNTY	TOTAL	SHEET NO.
	DRAWN — TRD REVISED —		STATE OF ILLINOIS	SCHEDULE OF QUANTITIES	1552	14-00050-00-SW	COOK	23	5	
	PLOT SCALE =	CHECKED - MAP	REVISED —	DEPARTMENT OF TRANSPORTATION		GERMAN	CHURCH ROAD PED IMPROVEMENT	CONTRA	CT NO. 6	1B38
	PLOT DATE ==	DATE - 01/28/2015	REVISED —	707 - Maria Ma	SCALE: NONE SHEET 1 OF 1 SHEETS STA. TO STA.	FED. R	OAD DIST. NO. 1 ILLINOIS FED.	AID PROJECT		

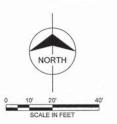

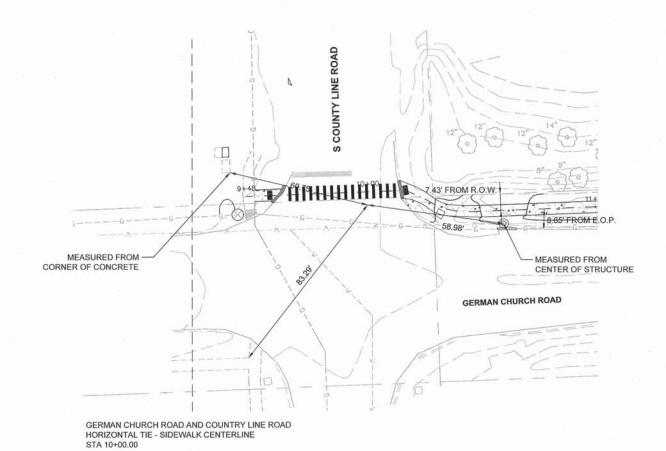

MEASURED FROM
CENTER OF STRUCTURE


MEASURED FROM
CENTER OF STRUCTURE

19.58\* FROM E.O.P.

34,73\* FROM C.L.

GERMAN CHURCH ROAD


GERMAN CHURCH ROAD AND GREYSTONE COURT HORIZONTAL TIE - SIDEWALK CENTERLINE STA 20+50.00

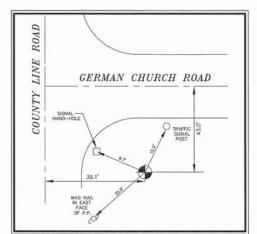



## BENCHMARK

VILLAGE BENCHMARK #107
LOCATED AT THE SOUTHEAST CORNER OF COUNTY
LINE ROAD AND GERMAN CHURCH ROAD
BERNTSEN MONUMENT, 9/16" DIA. STEEL ROD INSIDE
1" DIA. GRESE FILLED PVC
ELEVATION: 696.35
NORTHING: 1847514.62
EASTING: 1098431.16

FILE NAME=	USER NAME =	DESIGNED — AJB	REVISED			F.A.U RTE.	SECTION	COUNTY	TOTAL	SHEE
		DRAWN - TRD	REVISED —	STATE OF ILLINOIS	ALIGNMENT, TIES AND BENCHMARK	1552	14-00050-00-SW	соок	23	6
	PLOT SCALE =	CHECKED — MAP	REVISED	DEPARTMENT OF TRANSPORTATION		GERMAN	CHURCH ROAD PED IMPROVEMENT	CONTRAC	CT NO. 6	61B38
	PLOT DATE =	DATE - 01/28/2015	REVISED -		SCALE: 1"=20' SHEET 1 OF 1 SHEETS STA. TO STA.	FED. RO	DAD DIST. NO. 1 ILLINOIS FED.	ND PROJECT		

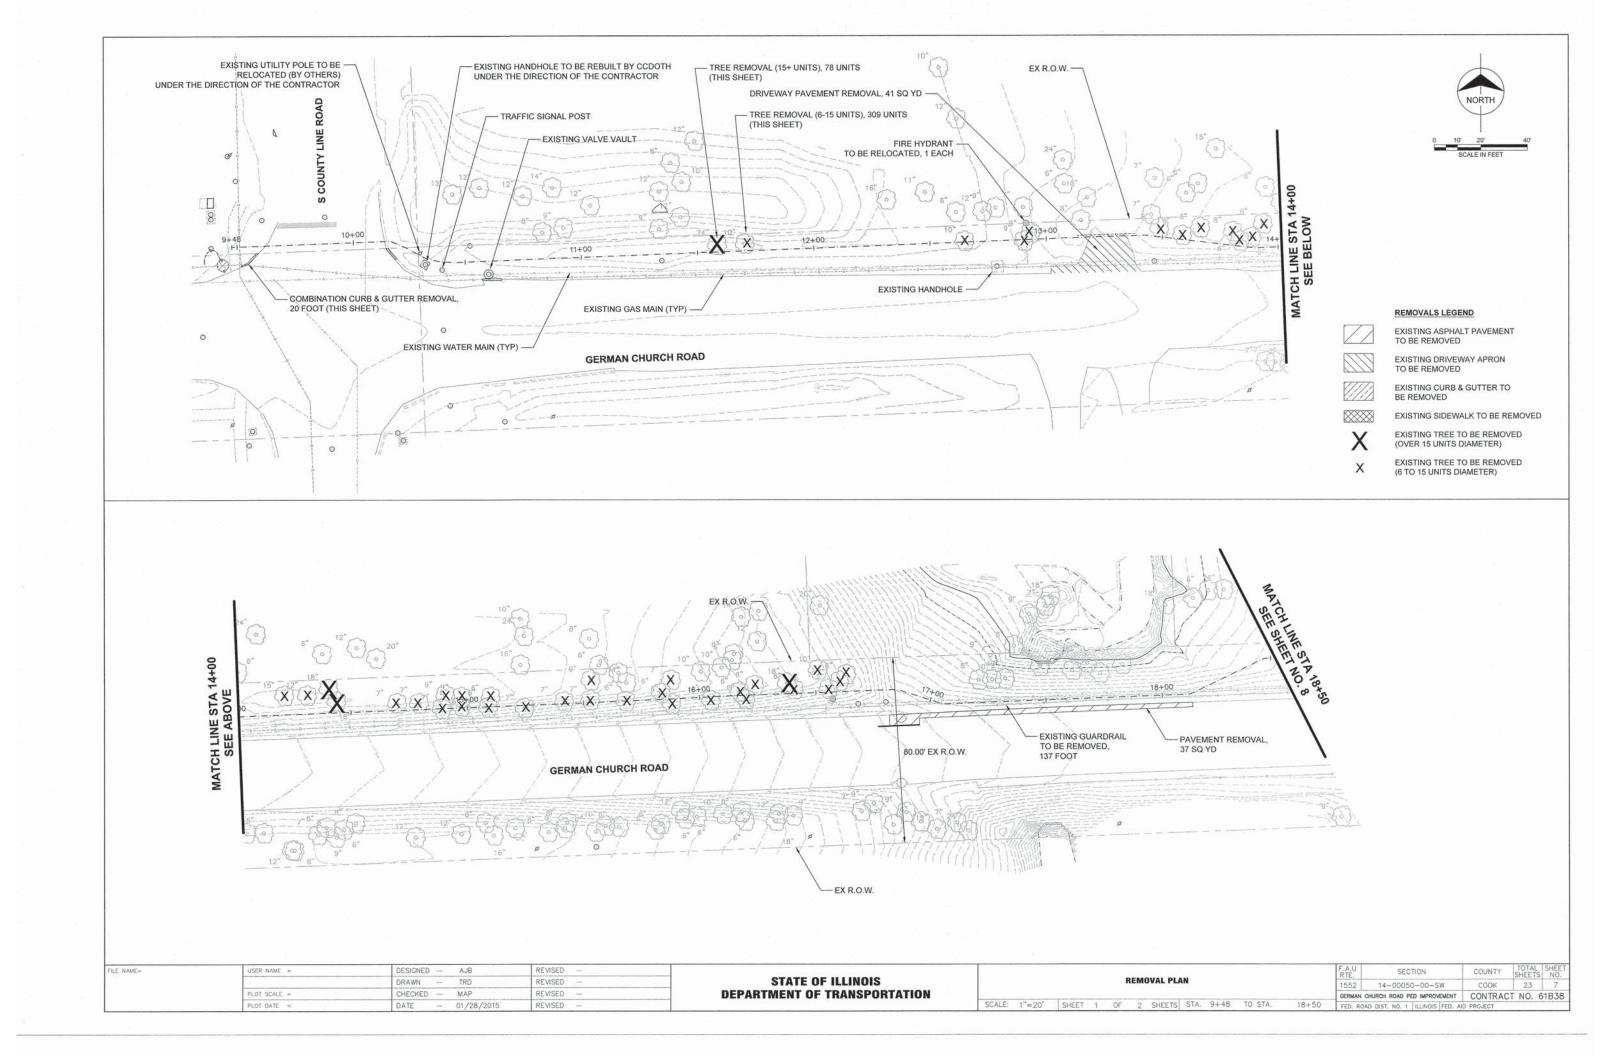

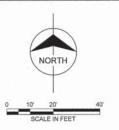

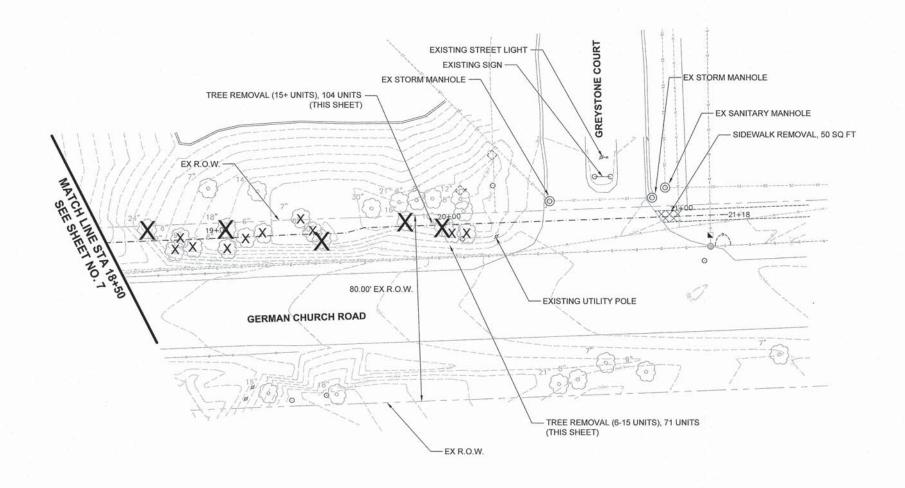

#### REMOVALS LEGEND

EXISTING ASPHALT PAVEMENT TO BE REMOVED

EXISTING DRIVEWAY APRON TO BE REMOVED



EXISTING ASPHALT/GRAVEL SHOULDER TO BE REMOVED



EXISTING SIDEWALK TO BE REMOVED


FED. ROAD DIST. NO. 1 ILLINOIS FED. AID PROJECT





EXISTING TREE TO BE REMOVED (OVER 15 UNITS DIAMETER)




EXISTING TREE TO BE REMOVED (6 TO 15 UNITS DIAMETER)

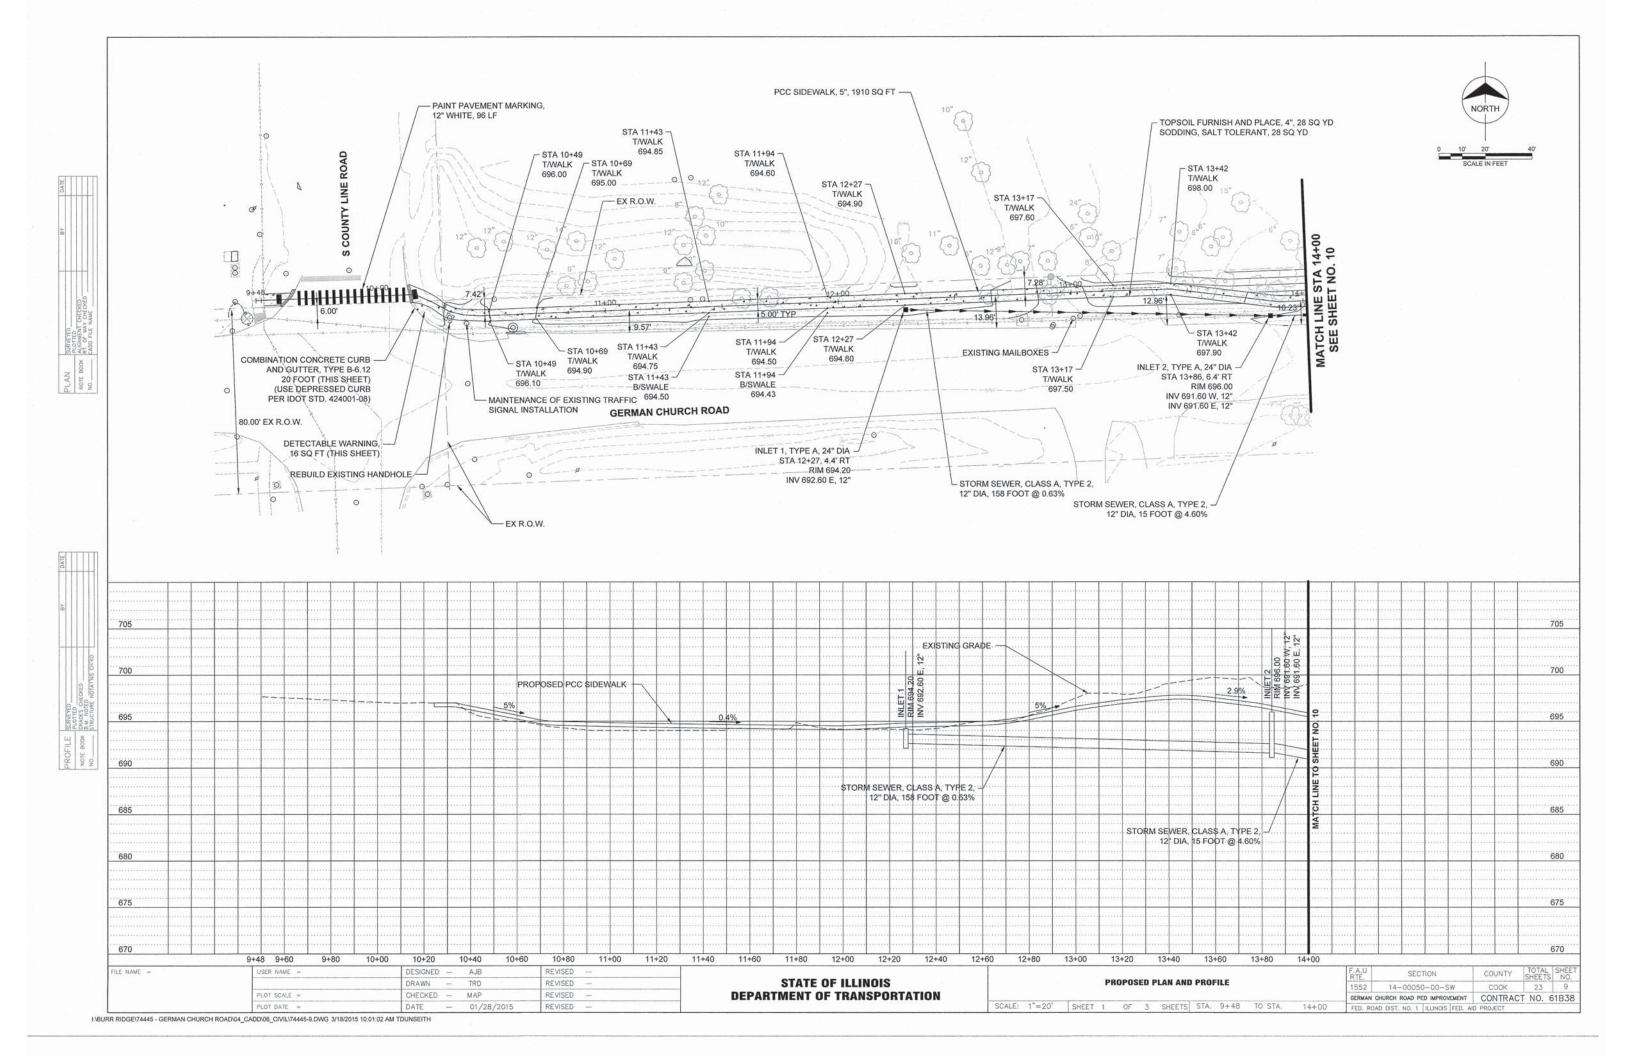

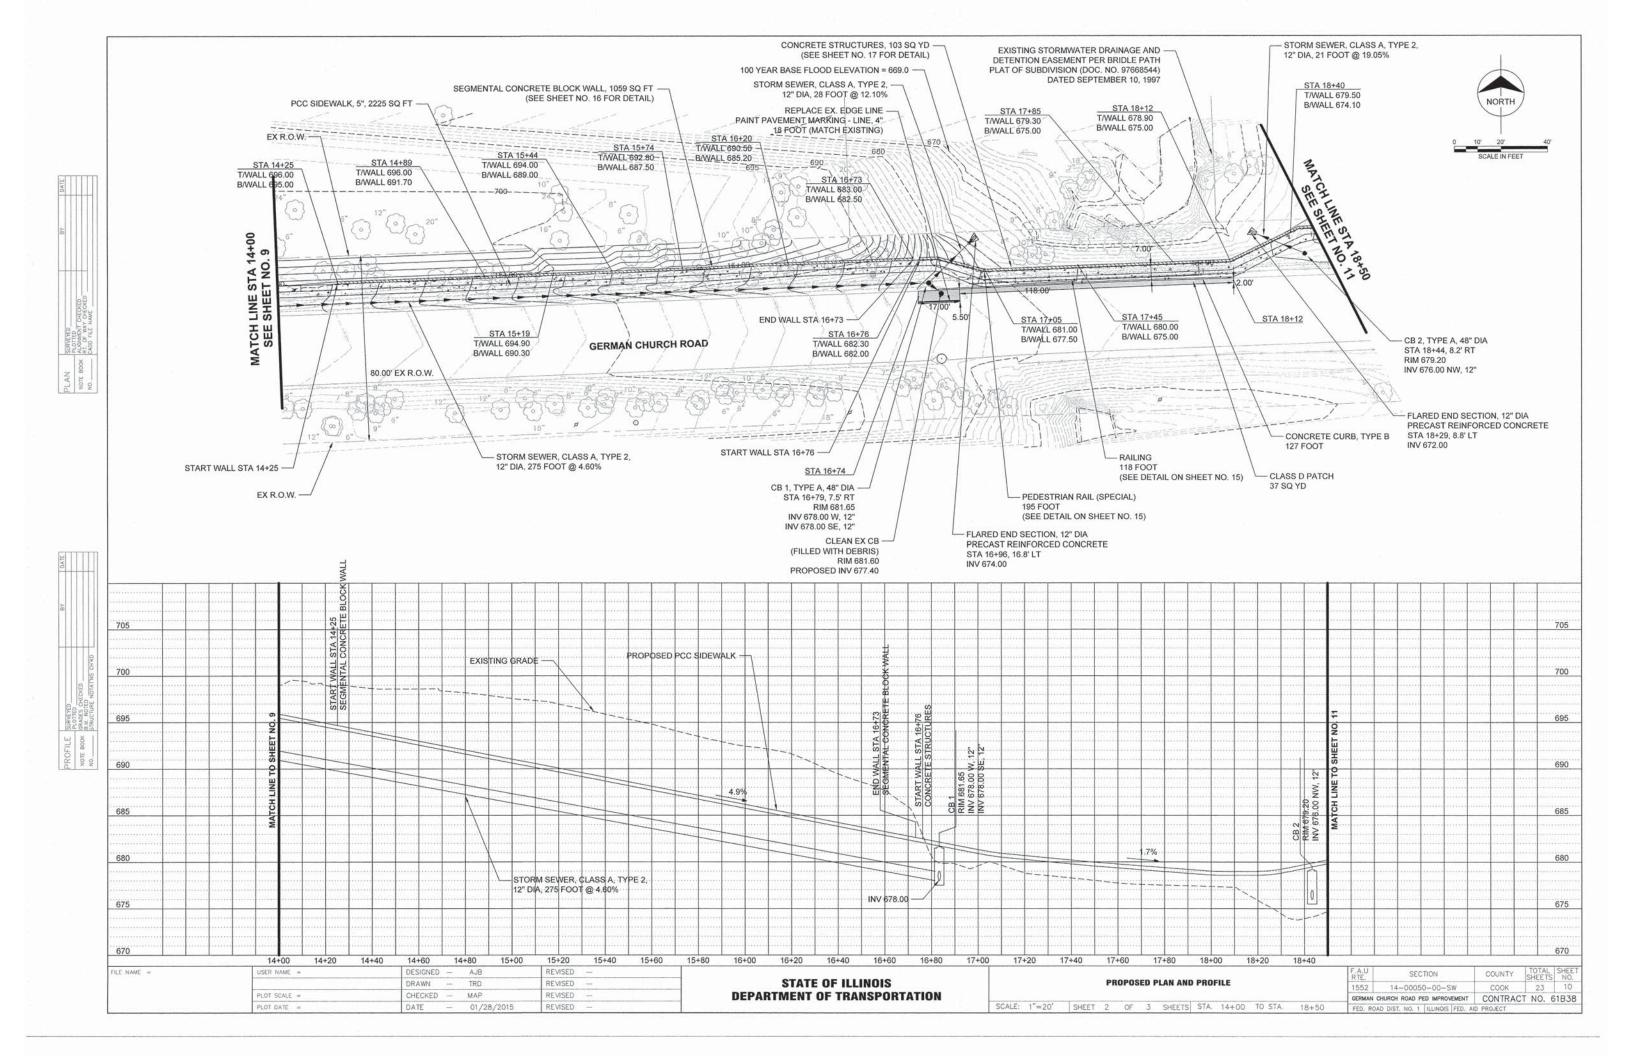

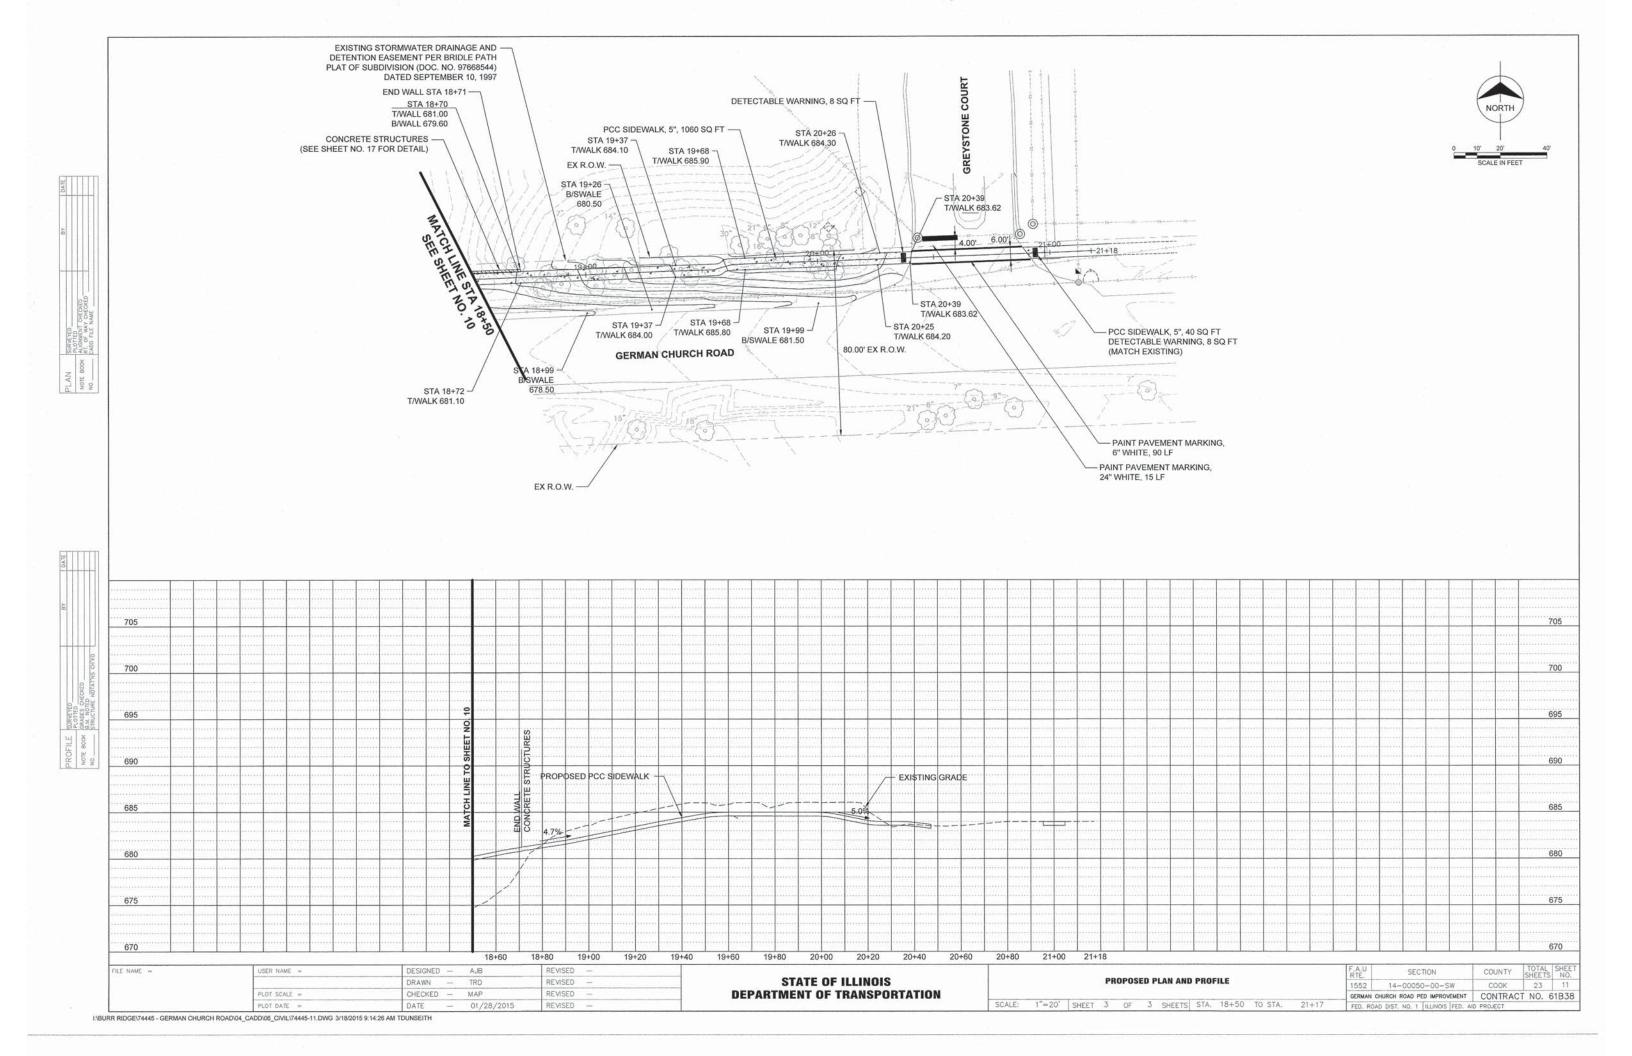

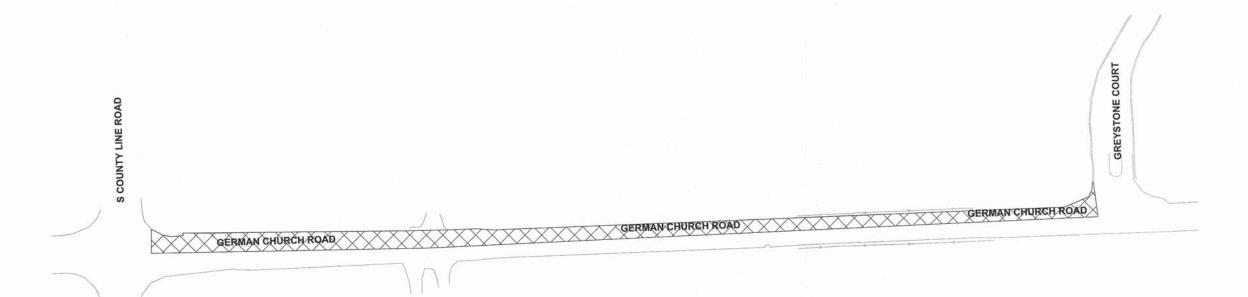



## MAINTENANCE OF TRAFFIC GENERAL NOTES

ALL TRAFFIC CONTROL AND PROTECTION MEASURES SHALL BE IN ACCORDANCE WITH SECTION 701 OF THE STANDARD SPECIFICATIONS, THE TRAFFIC PLAN AND THE LATEST EDITION OF THE MUTCD.

THE CONTRACTOR SHALL OBTAIN WRITTEN APPROVAL OF THE ENGINEER FOR ANY METHODS OF TRAFFIC CONTROL AND PROTECTION DIFFERENT THAN THAT SHOWN ON THE PLANS. NO ADDITIONAL COMPENSATION WILL BE ALLOWED TO THE

THE CONTRACTOR SHALL NOT CHANGE THE CONSTRUCTION STAGING PLANS WITHOUT WRITTEN APPROVAL OF THE ENGINEER AND ANY ADDITIONAL COSTS RESULTING FROM AN APPROVED CHANGE SHALL BE THE RESPONSIBILITY OF THE CONTRACTOR.

THE CONTRACTOR SHALL PROVIDE ALL SIGNS, BARRICADES AND TEMPORARY BARRIER WALLS AND PROTECTION NECESSARY FOR THE MAINTENANCE OF TRAFFIC AS NOTED IN THE CONTRACT DOCUMENTS, OR AS DIRECTED BY THE ENGINEER.

THE CONTRACTOR MUST NOTIFY ALL EMERGENCY SERVICES (POLICE, FIRE, ETC.), LOCAL SCHOOL DISTRICTS, AND LOCAL MUNICIPALITIES (VILLAGES, COUNTIES, TOWNSHIPS) AND POST OFFICE A MINIMUM OF 72 HOURS IN ADVANCE OF ANY SIDE ROAD CLOSURES OR DETOURS.

BURR RIDGE POLICE DEPARTMENT (NON-EMERGENCY): 630-654-8181 BURR RIDGE FIRE DEPARTMENT (NON-EMERGENCY): 708-352-9229 BURR RIDGE PUBLIC WORKS DEPARTMENT: 630-323-4733

SOLID WHITE LINES SHALL BE USED TO DEFINE OUTSIDE LANE LINES DURING MAINTENANCE OF TRAFFIC WHERE CURB AND GUTTER DOES NOT SERVE AS THE EDGE OF THE TRAFFIC LANE.

THE CONTRACTOR IS RESPONSIBLE FOR PROVIDING TEMPORARY DRAINAGE AND DE-WATERING ACTIVITIES TO ENSURE NO FLOODING OF ADJACENT PROPERTIES OR STANDING WATER IN THE CONSTRUCTION SITE.

ALL WARNING SIGNS SHALL BE BLACK LEGEND AND BORDER ON ORANGE REFLECTORIZED BACKGROUND UNLESS OTHERWISE SPECIFIED. ALL WARNING SIGNS TO BE 48" X 48".

THE CONTRACTOR SHALL MAINTAIN ACCESS TO ALL DRIVEWAYS AND SIDE STREETS DURING CONSTRUCTION. TEMPORARY ACCESS CLOSURES WILL BE ALLOWED ONLY AT THE DIRECTION OF THE ENGINEER.

ALL ADVANCE WARNING SIGNS FOR THE PROJECT SHALL BE INSTALLED PRIOR TO THE START OF CONSTRUCTION.

ALL TEMPORARY OR PERMANENT PAVEMENT MARKING PROPOSED WITHIN THE WORK AREA SHALL BE COMPLETED PRIOR TO THE CONSTRUCTION PHASE CHANGE.

THE COST OF FLAGGER SIGNING SHALL BE INCLUDED IN THE COST OF TRAFFIC CONTROL AND PROTECTION (SPECIAL).

CONTRACTOR SHALL COORDINATE ALL DETOUR SIGNS WITH ADJACENT CONSTRUCTION CONTRACTS (DO NOT KNOW OF ANY ADJACENT CONSTRUCTION CONTRACTS AT THIS TIME).

FLAGGER SIGNAGE SHALL BE COORDINATED WITH IDOT, COOK COUNTY, AND VILLAGE OF BURR RIDGE

#### CONSTRUCTION STAGING NOTES

THE NORTH LANE OF GERMAN CHURCH ROAD SHALL BE CLOSED ON WORKING DAYS BETWEEN 9:00AM AND 3:00PM. TWO FLAGGERS WILL MAINTAIN TRAFFIC ON THE SOUTH LANE OF GERMAN CHURCH ROAD.

PERFORM NECESSARY TREE REMOVAL AND CLEARING.

INSTALL FLAGGER ROAD SIGNS. INSTALL TEMPORARY TRAFFIC CONTROL MEASURES AS REQUIRED.

INSTALL TEMPORARY FENCING FOR TREE PROTECTION AND INLET FILTERS ON ALL EXISTING OPEN GRATE STRUCTURES.

REMOVE PAVEMENT AND ANCILLARY ITEMS AS REQUIRED WITHIN THE STAGE 1 CONSTRUCTION ZONE.

CONSTRUCT STORM SEWERS AND ASSOCIATED STRUCTURES IN STAGE 1 CONSTRUCTION ZONE.

CONSTRUCT THE NEW PAVEMENT WITHIN THE STAGE 1 CONSTRUCTION ZONE.

CONSTRUCT ASSOCIATED CURB AND GUTTER, SIDEWALK AND ANCILLARY ITEMS WITHIN THE STAGE 1 CONSTRUCTION ZONE.

USE HIGHWAY STANDARDS AS NEEDED TO COMPLETE OTHER MINOR ITEMS AND CLEAN UP.


INSTALL LANDSCAPING.


REMOVE ALL TEMPORARY SIGNING AND TRAFFIC STAGING.


INSTALL PAVEMENT MARKINGS.

UNCOVER PERMANENT SIGNS.

FILE NAME=	USER NAME =	DESIGNED — AJB	REVISED —			F.A.U RTE.	SECTION	COUNTY	TOTAL S	HEET NO.
		DRAWN — TRD	REVISED —	STATE OF ILLINOIS	MAINTENANCE OF TRAFFIC PLAN	1552	14-00050-00-SW	COOK	23	12
	PLOT SCALE =	CHECKED - MAP	REVISED	DEPARTMENT OF TRANSPORTATION		GERMAN	CHURCH ROAD PED IMPROVEMENT	CONTRAC	T NO. 61	B38
	PLOT DATE =	DATE - 01/28/2015	REVISED —		SCALE: 1"=50' SHEET 1 OF 1 SHEETS STA. TO STA.	FED. RO	AD DIST. NO. 1 ILLINOIS FED. AI	D PROJECT		-

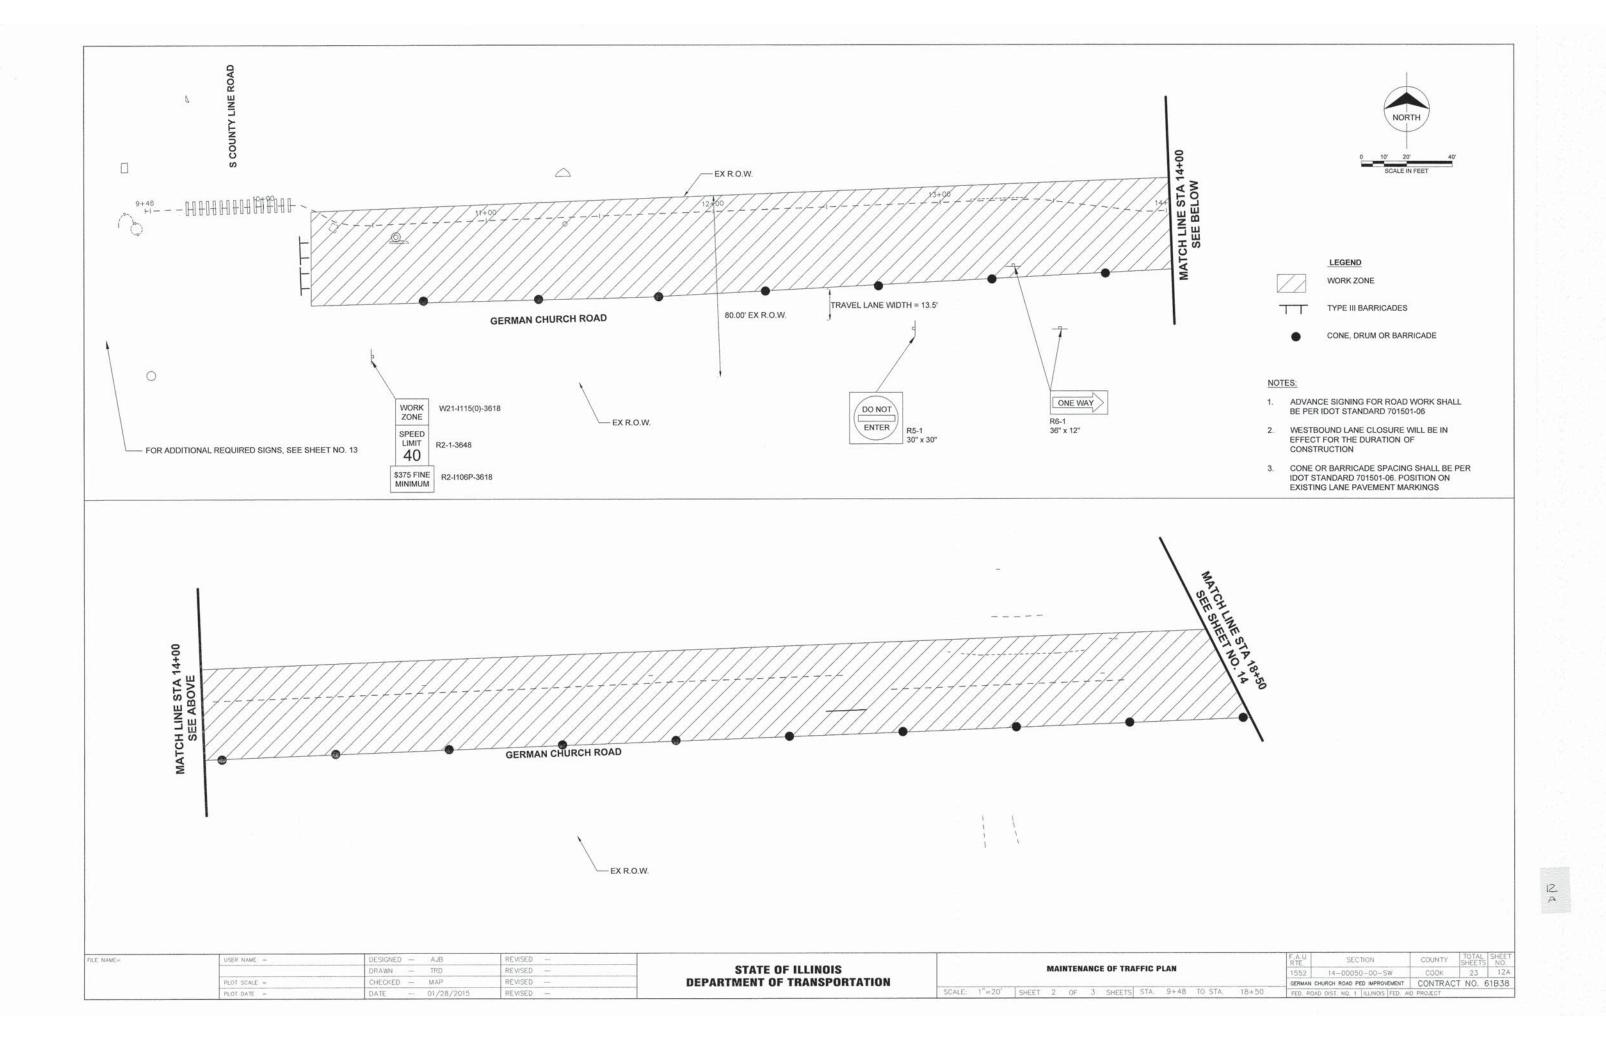

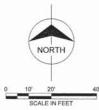


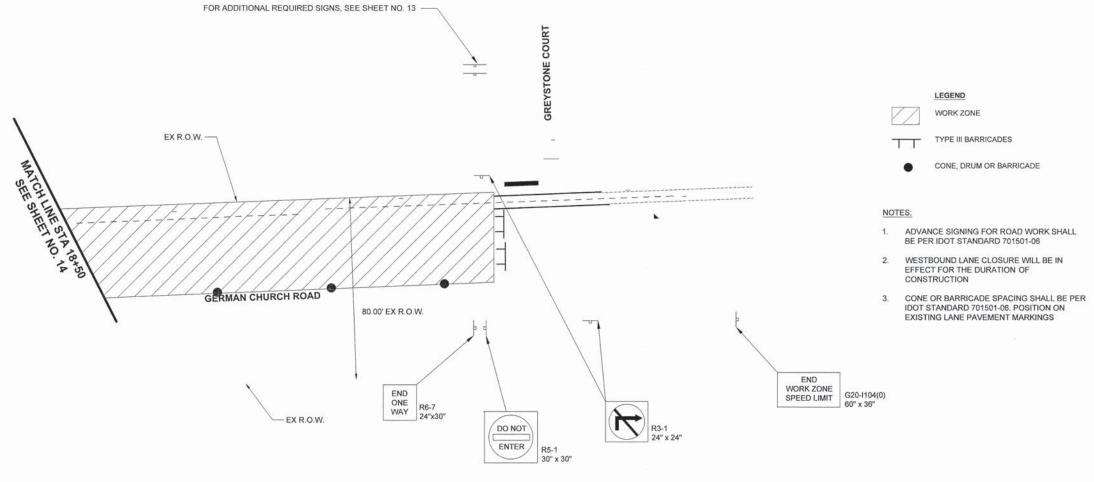



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	PLOT SCALE =	CHECKED — MAP	REVISED -
	PLOT DATE =	DATE - 01/28/2015	REVISED -


STATI	E OF ILLINOIS
DEPARTMENT	OF TRANSPORTATION

											RTE.	SECTION	COUNTY	SHEETS	NO.
			MAI	NIEN	ANG	E OF TRA	FFIC I	LAN			1552	14-00050-00-SW	COOK	23	12B
											GERMAN (	CHURCH ROAD PED IMPROVEMENT	CONTRAC	T NO. 6	1B38
SCALE:	1"=20	SHEET	3	OF	3	SHEETS	STA.	18+50	TO STA.	21+17	FED. ROA	AD DIST. NO. 1 ILLINOIS FED. A	ID PROJECT		

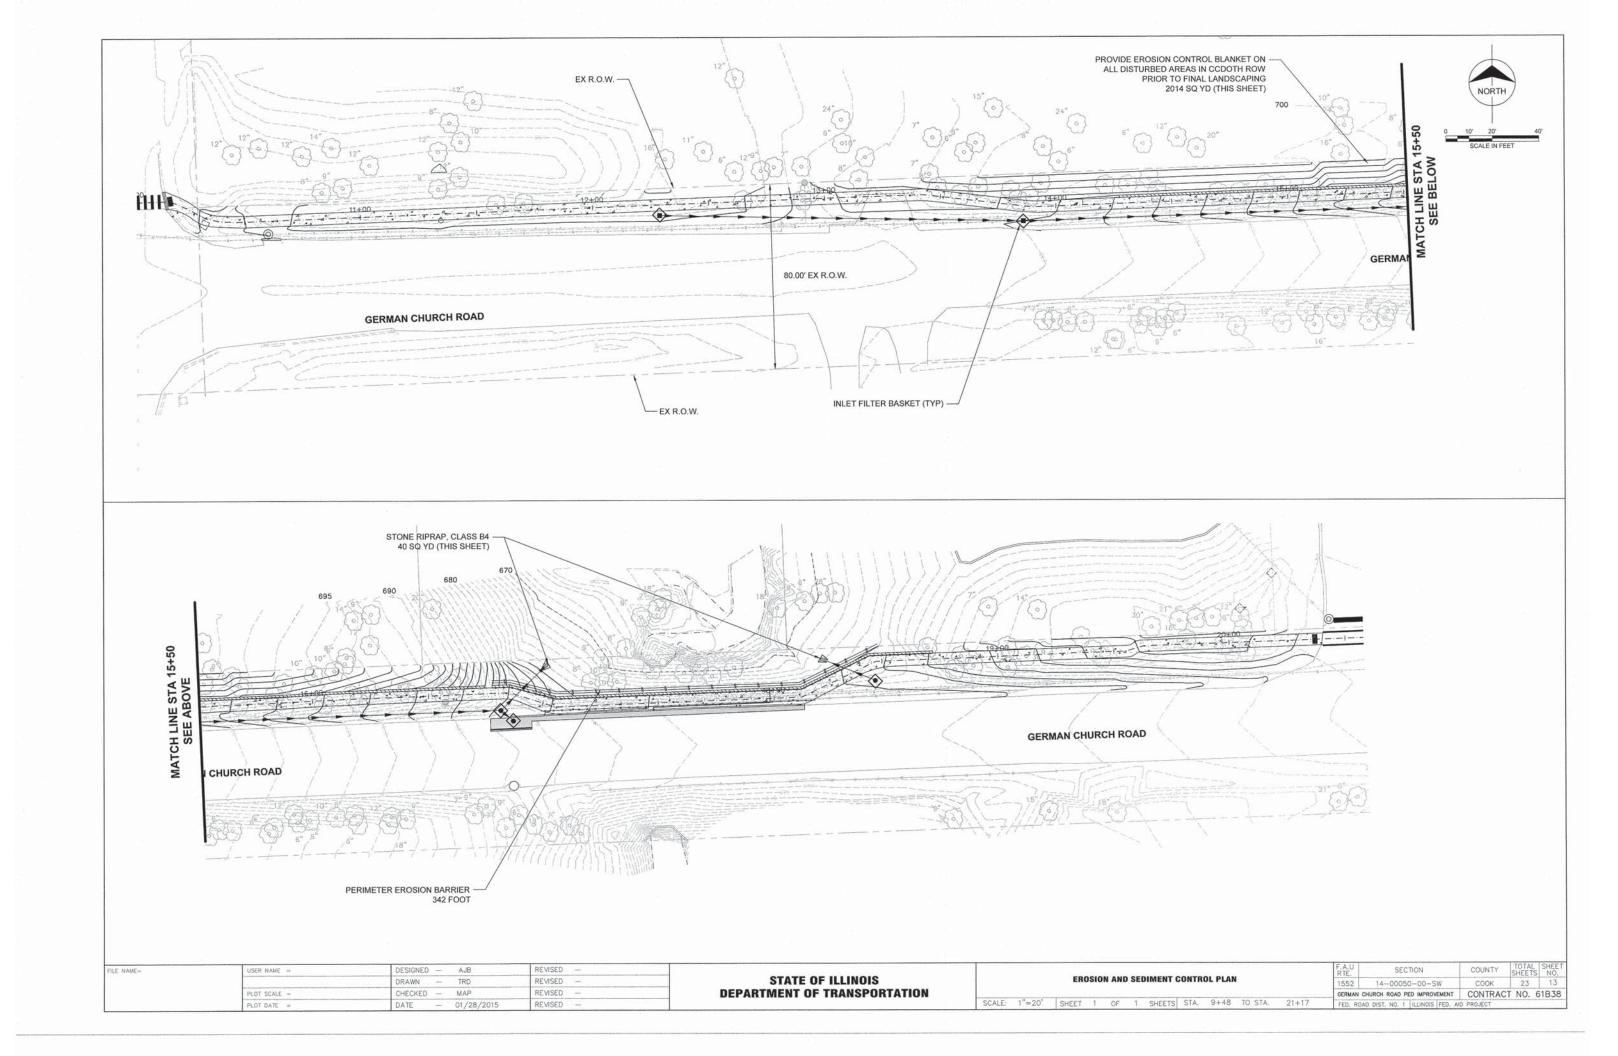


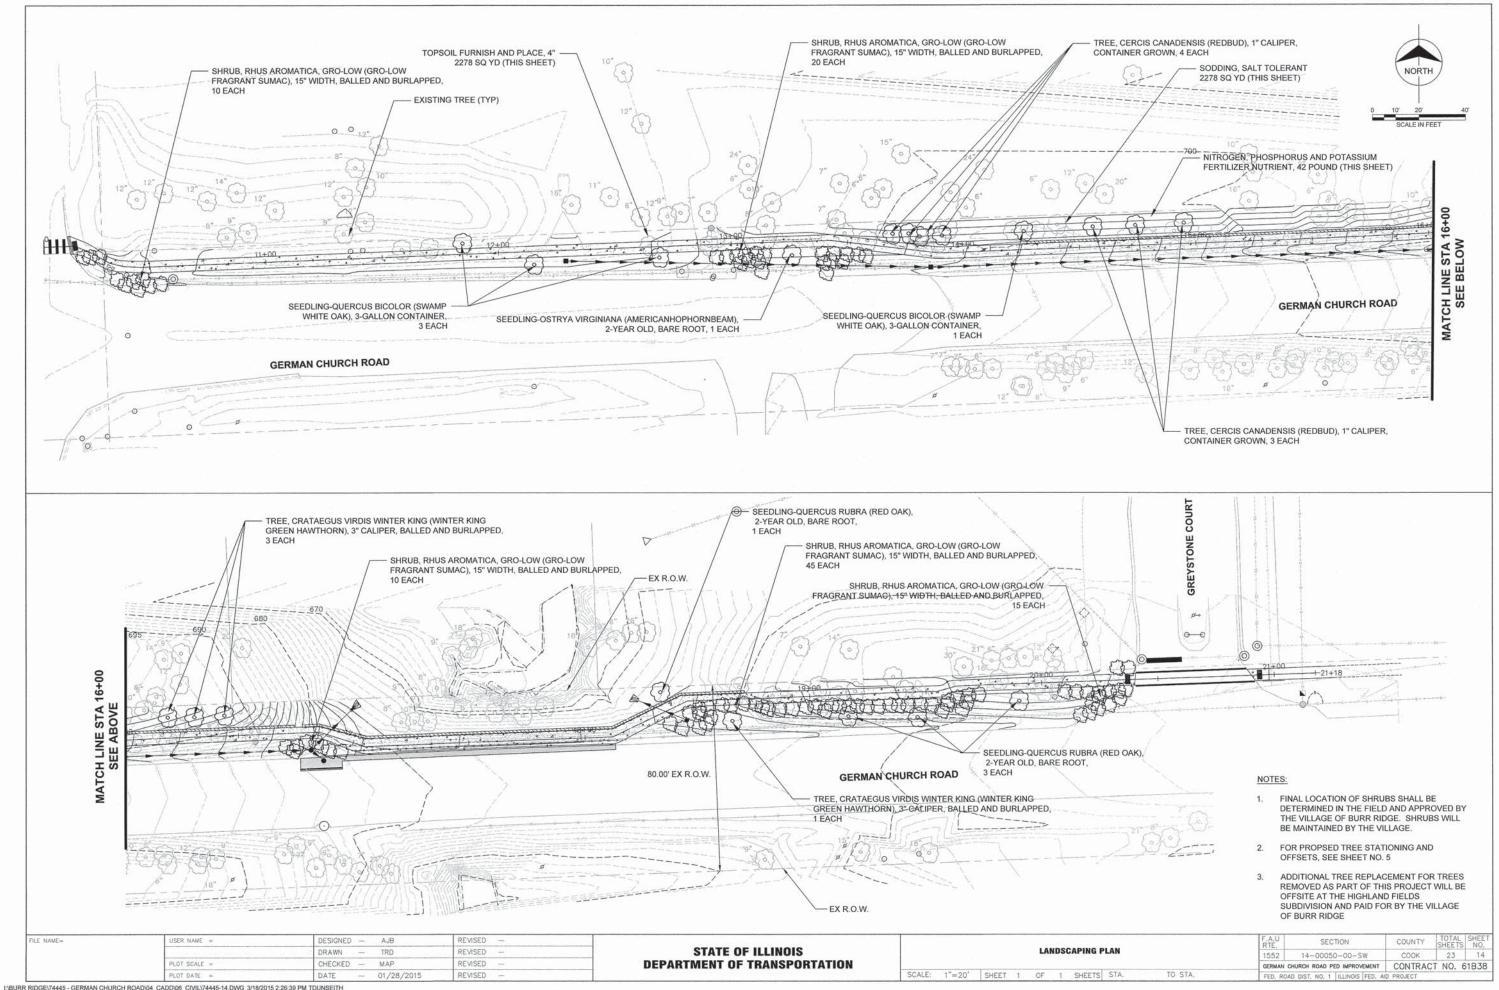

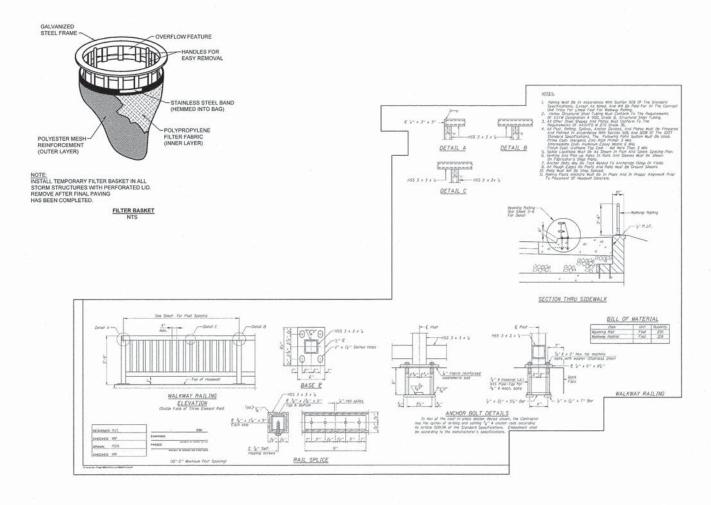

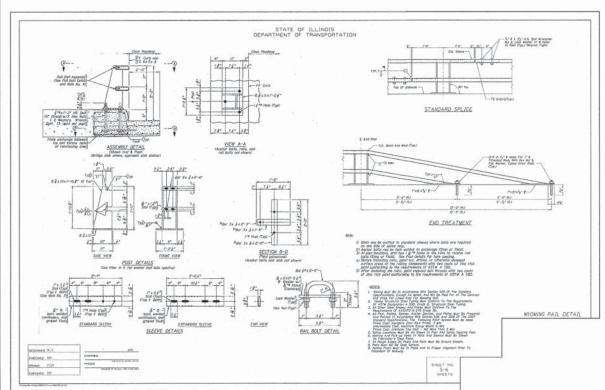

PLOT SCALE

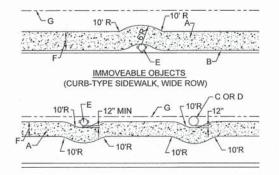

# IMMOVEABLE OBJECTS

#### SIDEWALK OBSTRUCTIONS

NOT TO SCALE

PLAN

SIDEWALK DETAIL

P.C.C. SIDEWALK 5" NOT TO SCALE

#### CONSTRUCTION NOTE:

- A. SIDEWALK
- B. CURB
  C. SERVICE POLE, SEE NOTES 1 AND 2.
- D. TREE TRUNK, SEE NOTE 1 E. FIRE HYDRANT, SEE NOTES 1 AND 2.
- F. SIDEWALK WIDTH. G. RIGHT-OF-WAY (ROW)

#### GENERAL NOTES:

- 1. A FIRE HYDRANT, SERVICE POLE OR TREE TRUNK SHALL BE CONSIDERED IMMOVEABLE ONLY WHEN DIRECTED BY THE VILLAGE ENGINEER.
- 2. WHEN A SERVICE POLE OR FIRE HYDRANT IS LOCATED WITHIN THE SIDEWALK AREA, AND IS CONSIDERED IMMOVEABLE, A 1/2" EXPANSION JOINT SHALL BE INSTALLED ENCIRCLING THE OBJECT. THIS WORK SHALL BE INCIDENTAL TO THE SIDEWALK COST.

- A. 5' NORMAL WIDTH OR AS INDICATED ON PLANS
- B. AGGREGATE BASE COURSE, TY. B, 4" THICK, (CA-6)
- C. P.C.C. SIDEWALK

LEGEND

- D. SLOPE 1/4" PER FOOT MAXIMUM TO STREET SIDE, OR AS NOTED ON PLAN
- E. JOINTS, SEE NOTES 3 AND 4
- F. SLOPE 2% TO 8% TOWARDS STREET, OR AS NOTED ON PLAN
- G. CONCRETE THICKNESS, SEE NOTE 1
- H. COMPACTED SUBGRADE TO 95% OF THE STANDARD LABORATORY DENSITY


#### **GENERAL NOTES**

- 1. STANDARD THICKNESS OF PCC SIDEWALK SHALL BE A MINIMUM OF 5 INCHES. THICKNESS SHALL BE 8 INCHES ACROSS DRIVEWAY ENTRANCE.
- 2. WHERE WOODEN FORMS ARE USED, 2x4's ARE NOT ALLOWED. ONLY 2x6's SHALL BE USED.
- PREFORMED ¾" EXPANSION JOINTS SHALL BE CONSTRUCTED AT MAX. SPACING OF 40'.
- 4. FORMED OR SAW-CUT CONTRACTION JOINTS SHALL BE SPACED GENERALLY 5' APART, BUT NO LESS THAN 4' AND NO MORE THAN 6'.
- 5. ½" FOAM EXPANSION JOINTS SHALL BE INSTALLED WHERE SIDEWALK ABUTS BUILDINGS, TRAFFIC SIGNAL FOUNDATIONS, SERVICE POLES, AND OTHER IMMOVABLE STRUCTURES.

6. CONCRETE TO BE MINIMUM 6-BAG MIX.

ME =	DESIGNED — AJB	REVISED —								F.A.U	SECTION	COUNTY	TOTAL SHE	ET
	DRAWN - TRD	REVISED	STATE OF ILLINOIS				DETA	ILS		1552	14-00050-00-SW	COOK	23 1	5
ALE =	CHECKED - MAP	REVISED —	DEPARTMENT OF TRANSPORTATION							GERMAI	CHURCH ROAD PED IMPROVEMENT	CONTRAC	CT NO. 61B3	8
IE	DATE01/28/2015	PEVISED _		SCALE: NONE	SHEET 1	OF	3 SH	EETS STA	TO STA	rro r	OAD DICT HO A THUMON FED I	A CONTRACTOR OF THE PARTY OF TH	-	-

WOVEN WIRE FENCE (MIN 14 GA. W/MAX

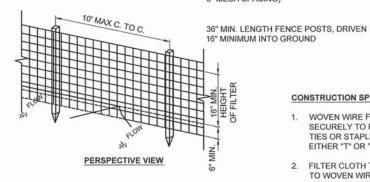

W, FLOW

SECTION VIEW

STANDARD SYMBOL

COMPACTED SOIL


36" MIN FENCE POST

- UNDISTURBED GROUND


#### CONSTRUCTION SPECIFICATIONS


- WOVEN WIRE FENCE TO BE FASTENED SECURELY TO FENCE POSTS WITH WIRE TIES OR STAPLES. POSTS SHALL BE STEEL EITHER "T" OR "U" TYPE OR HARDWOOD.
- 2. FILTER CLOTH TO BE FASTENED SECURELY TO WOVEN WIRE FENCE WITH TIES SPACED EVERY 24" AT TOP AND MID SECTION. FENCE SHALL BE WOVEN WIRE, 6" MAXIMUM MESH OPENING.
- 3. WHEN TWO SECTIONS OF FILTER CLOTH ADJOIN EACH OTHER THEY SHALL BE OVERLAPPED BY SIX INCHES AND FOLDED. FILTER CLOTH SHALL BE EITHER FILTER X, MIRAFI 100X, STABILINKA T140N, OR APPROVED EQUIVALENT.
- 4. PREFABRICATED UNITS SHALL BE GEOFAB. ENVIROFENCE, OR APPROVED EQUIVALENT.
- MAINTENANCE SHALL BE PERFORMED AS NEEDED AND MATERIAL REMOVED WHEN "BULGES" DEVELOP IN THE SILT FENCE.

**EROSION CONTROL SILT FENCE DETAIL** 

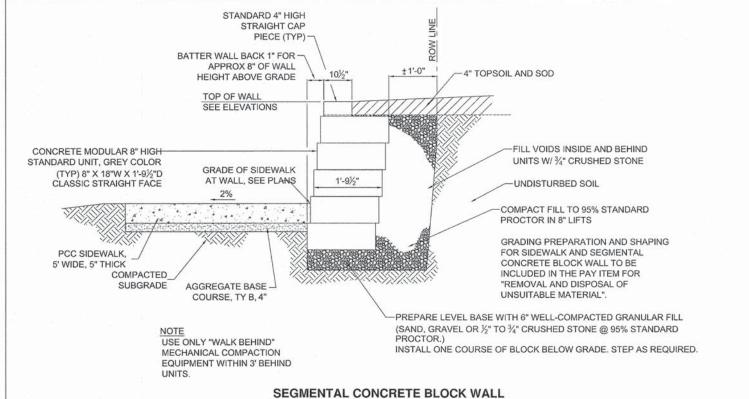

TYPICAL SECTION NOT TO SCALE

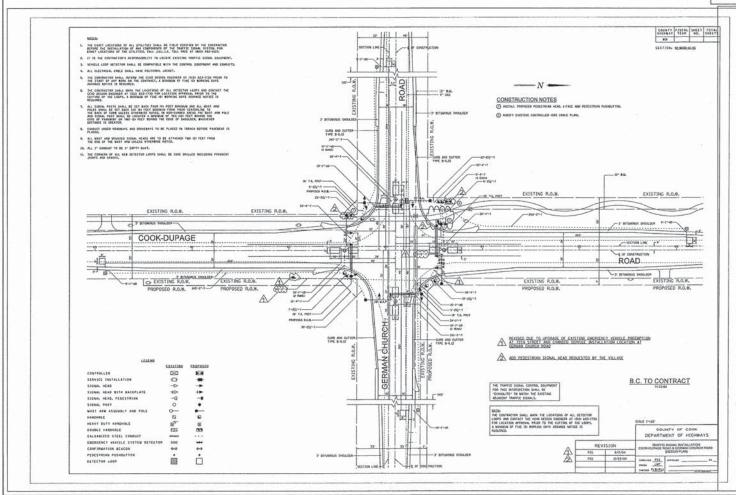

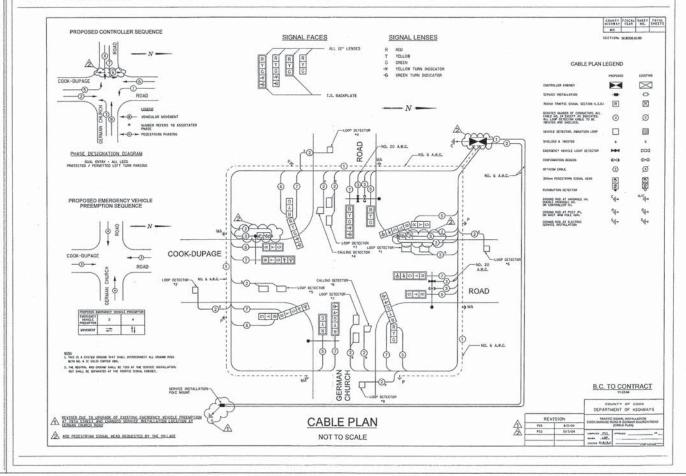


DRAWN REVISED PLOT SCALE = CHECKED -MAP REVISED DATE

STATE OF ILLINOIS **DEPARTMENT OF TRANSPORTATION** 

TOTAL SHEE SHEETS NO. SECTION COUNTY DETAILS COOK 14-00050-00-SW GERMAN CHURCH ROAD PED IMPROVEMENT | CONTRACT NO. 61B38 SCALE: NONE SHEET 2 OF 3 SHEETS STA. FED. ROAD DIST. NO. 1 ILLINOIS FED. AID PROJECT

BILL OF	MATERIAL	
ITEM	UNIT	TOTAL
STRUCTURE EXCAVATION	CU YD	414
CONCRETE STRUCTURES	CU YD	108
REINFORCEMENT BARS, EPOXY COATED	POUND	13700
POROUS GRANULAR BACKFILL	CU YD	165
GEOCOMPOSITE WALL DRAIN	SQ YD	200
PIPE UNDERDRAINS FOR STRUCTURES 4"	FOOT	200
FURNISHED EXCAVATION	CU YD	146
TEMPORARY SOIL RETENTION SYSTEM	SQ FT	1755

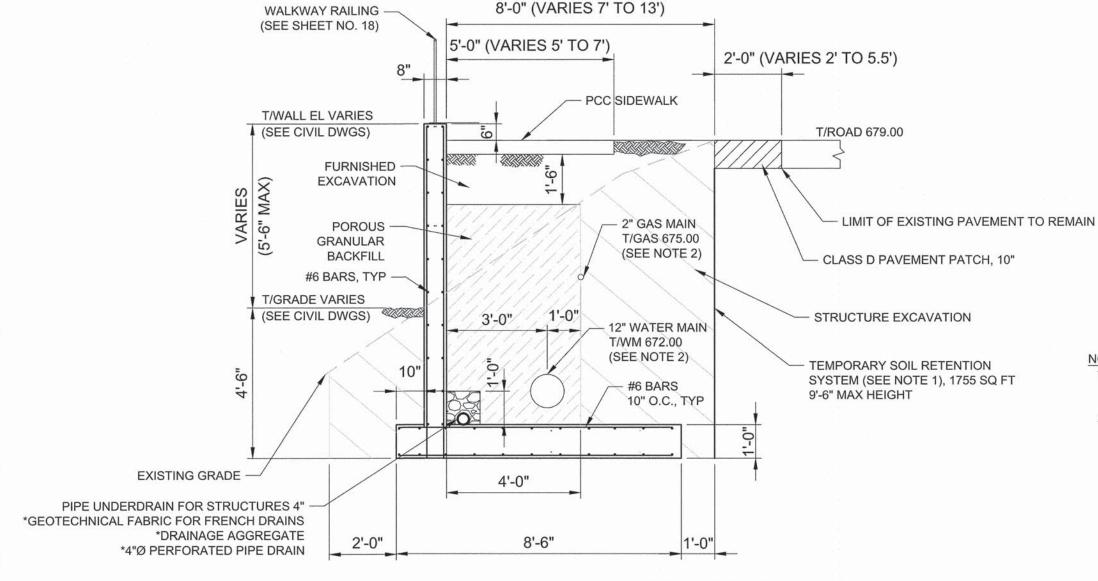


## NOTES:

- CONTRACTOR SHALL DESIGN AND PROVIDE THIS SYSTEM. REFER TO IDOT GUIDE BRIDGE SPECIAL PROVISIONS (GBSP 44) INSTRUCTIONS.
- 2. CONTRACTOR SHALL PROVIDE TEMPORARY PROTECTION FOR ALL UNDERGROUND UTILITIES LOCATED WITHIN EXCAVATION LIMITS.

\* INCLUDED IN THE COST OF "PIPE UNDERDRAINS FOR STRUCTURES 4"

## RETAINING WALL DETAIL

FILE NAME=	USER NAME =	DESIGNED — AJB	REVISED			F.A.U SE	CTION	COUNTY	TOTAL SHEET
1		DRAWN — TRD	REVISED —	STATE OF ILLINOIS	DETAILS	1552 14-000	50-00-SW	COOK	23 17
	PLOT SCALE =	CHECKED - MAP	REVISED -	DEPARTMENT OF TRANSPORTATION		GERMAN CHURCH ROAD	PED IMPROVEMENT	CONTRAC	CT NO. 61B38
	PLOT DATE =	DATE - 01/28/2015	REVISED —		SCALE: NONE SHEET 3 OF 3 SHEETS STA. TO STA.	FED. ROAD DIST. NO. 1	1 ILLINOIS FED. A	ID PROJECT	71 1101 01000

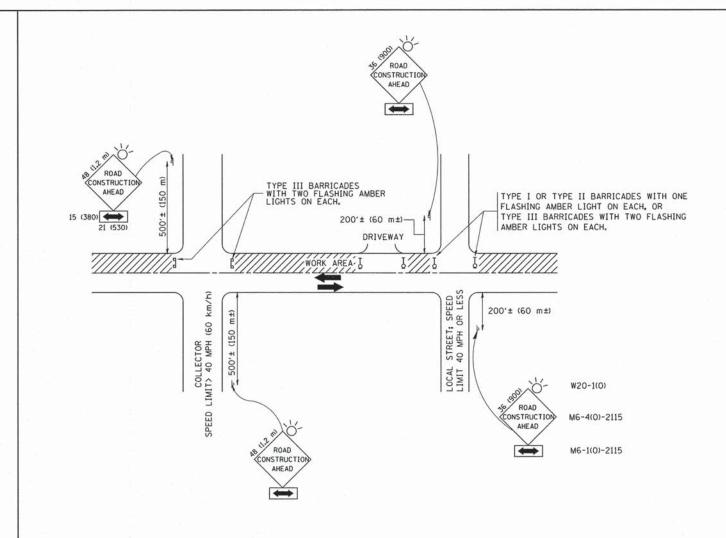

TRAFFIC CONTROL AND PROTECTION FOR SIDE ROADS, INTERSECTIONS, AND DRIVEWAYS

## NOTES:

- A. FOR NO LANE RESTRICTION ON THE SIDE ROAD OR DRIVEWAYS
- 1. SIDE ROAD WITH A SPEED LIMIT OF 40 MPH (60 km/h) OR LESS AS SHOWN ON THE DRAWING AND AS DIRECTED BY THE ENGINEER:
- O) ONE ROAD CONSTRUCTION AHEAD SIGN 36 x 36 (900x900) WITH A FLASHER AND FLAG MOUNTED ON IT APPROXIMATELY 200' (60 m) IN ADVANCE
- b) THE CLOSED PORTION OF THE MAIN ROUTE SHALL BE PROTECTED BY BLOCKING WITH TYPE I, TYPE II OR TYPE III BARRICADES, 1/3 OF THE CROSS SECTION OF THE CLOSED PORTION.
- 2. SIDE ROAD WITH A SPEED LIMIT GREATER THAN 40 MPH (60 km/h) AS SHOWN ON THE DRAWING AND AS DIRECTED BY THE ENGINEER:
- a) ONE road construction ahead SIGN 48  $\times$  48 (1.2 m  $\times$  1.2 m) WITH A FLASHER MOUNTED ON IT APPROXIMATELY 500' (150 m) IN ADVANCE OF THE MAIN ROUTE.
- b) THE CLOSED PORTION OF THE MAIN ROUTE SHALL BE PROTECTED BY BLOCKING WITH TYPE III BARRICADES, 1/2 OF THE CROSS SECTION OF THE CLOSED PORTION.
- 3. WHEN THE SIDE ROAD LIES BETWEEN THE BEGINNING OF THE MAINLINE SIGNING AND THE WORK ZONE, A SINGLE HEADED ARROW (M6-1) SHALL BE USED IN LIEU OF THE DOUBLE HEADED ARROW (M6-4).

#### B. FOR A LANE CLOSURE ON A SIDE ROAD OR DRIVEWAY:

USE APPLICABLE PORTIONS OF THE TYPICAL APPLICATION OF TRAFFIC CONTROL DEVICES (STD. 701501, STD. 701606 OR THE APPROPRIATE STANDARD). THE SPACING OF SIGNS AND BARRICADES SHALL BE ADJUSTED FOR FIELD CONDITIONS AS DIRECTED BY THE ENGINEER. THE DIRECTIONAL ARROW SHALL BE COVERED OR REMOVED WHEN NO LONGER CONSISTENT WITH THE SIDE ROAD LANE CLOSURE.

- C. ADVANCE WARNING SIGNS ARE TO BE OMITTED ON DRIVEWAY UNLESS
- D. THE TRAFFIC CONTROL AND PROTECTION FOR SIDE ROADS, INTERSECTIONS. AND DRIVEWAYS SHALL BE INCIDENTAL TO THE COST OF SPECIFIED TRAFFIC CONTROL STANDARDS OR ITEMS.


All dimensions are in millimeters (inches) unless otherwise shown.


FILE NAME = DESIGNED - LHA REVISED - J. OBERLE 10-18-95 USER NAME = gaglianobt DRAWN REVISED - A, HOUSEH 03-06-96 \diststd\22x34\tcl0.dgn PLOT SCALE = 50.000 ' / IN. CHECKED -REVISED - A. HOUSEH 10-15-96 PLOT DATE = 1/4/2008 DATE - 06-89 REVISED -T. RAMMACHER 01-06-00

STATE OF ILLINOIS **DEPARTMENT OF TRANSPORTATION** 


TRAFFIC CONTROL AND PROTECTION FOR SIDE ROADS, INTERSECTIONS, AND DRIVEWAYS SCALE: NONE SHEET NO. 1 OF 1 SHEETS STA. FED. ROAD DIST. NO. 1 | ILLINOIS FED. AID PROJECT

COUNTY TOTAL SHEET NO. SECTION 1552 14-00500-00-SW COOK 23 18 CONTRACT NO. 61B38 TC-10

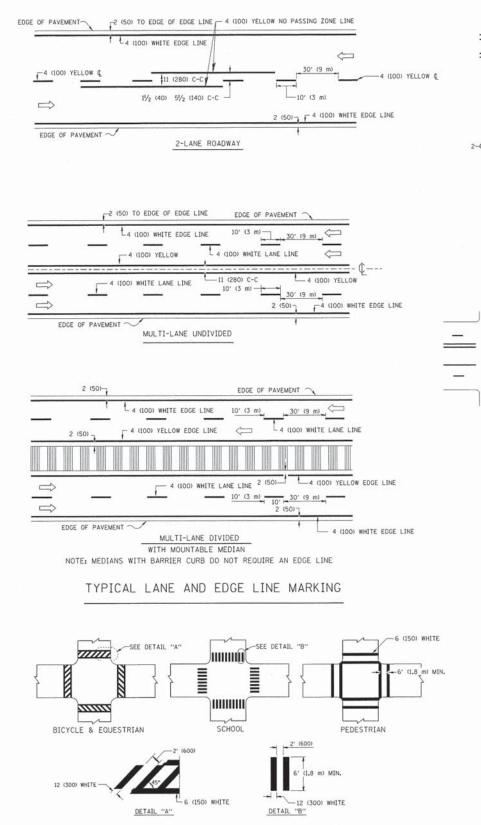

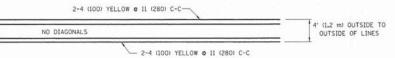


#### 4' (1.2 m) WIDE MEDIANS ONLY

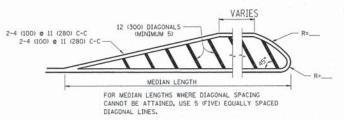

DIAGONAL LINE SPACING: 50' (15 m) C-C (LESS THAN 30MPH (50 km/h))
75' (25 m) C-C 30MPH (50 km/h) TO 45MPH (70 km/h))
150' (45 m) C-C (MORE THAN 45MPH (70 km/h))

#### MEDIANS OVER 4' (1.2 m) WIDE

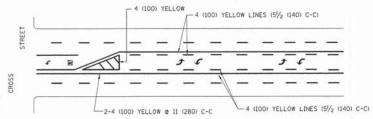


A MINIMUM OF TWO PAIRS OF TURN ARROWS SHALL BE USED, WHITE IN COLOR, ADDITIONAL PAIRS SHALL BE PLACED AT 200' (60 m) TO 300' (90 m) INTERVALS.



MEDIAN WITH TWO-WAY LEFT TURN LANE

#### TYPICAL PAINTED MEDIAN MARKING

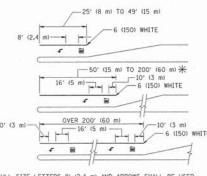



FULL SIZE LETTERS 8' (2.4 m) AND ARROWS SHALL BE USED.  $\P$  AREA = 15.6 SO. FT. (1.5 m² ) ONLY AREA = 20.8 SO. FT. (1.9 m²)

\* TURN LANES IN EXCESS OF 400' (120 m) IN LENGTH MAY HAVE AN ADDITIONAL SET OF ARROW - "ONLY" INSTALLED MIDWAY BETWEEN THE OTHER TWO SETS OF ARROW - "ONLY".

TYPICAL LEFT (OR RIGHT) TURN LANE

#### TYPICAL TURN LANE MARKING

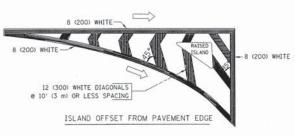

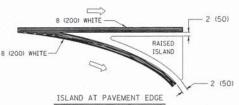

## TYPICAL ISLAND MARKING

TYPE OF MARKING	WIDTH OF LINE	PATTERN	COLOR	SPACING / REMARKS
CENTERLINE ON 2 LANE PAVEMENT	4 (100)	SKIP-DASH	YELLOW	10' (3 m) LINE WITH 30' (9 m) SPACE
CENTERLINE ON MULTI-LANE UNDIVIDED PAVEMENT	2 @ 4 (100)	SOLID	YELLOW	11 (280) C-C
NO PASSING ZONE LINES: FOR ONE DIRECTION FOR BOTH DIRECTIONS	4 (100) 2 e 4 (100)	SOLID SOLID	YELLOW YELLOW	SV <sub>2</sub> (140) C-C FROM SKIP-DASH CENTERLINE 11 (280) C-C OMIT SKIP-DASH CENTERLINE BETWEEN
LANE LINES	4 (100) 5 (125) ON FREEWAYS	SKIP-DASH SKIP-DASH	WHITE WHITE	10' (3 m) LINE WITH 30' (9 m) SPACE
DOTTED LINES (EXTENSIONS OF CENTER, LANE OR TURN LANE MARKINGS)	SAME AS LINE BEING EXTENDED	SKIP-DASH	SAME AS LINE BEING EXTENDED	2' (600) LINE WITH 6' (L8 m) SPACE
EDGE LINES	4 (100)	SOLID	YELLOW-LEFT WHITE-RIGHT	OUTLINE MOUNTABLE MEDIANS IN YELLOW: EDGE LINES ARE NOT USED NEXT TO BARRIER CURB
TURN LANE MARKINGS	6 (150) LINE: FULL SIZE LETTERS & SYMBOLS (8' (2.4m))	SOLID	WHITE	SEE TYPICAL TURN LANE MARKING DETAIL
TWO WAY LEFT TURN MARKING	2 @ 4 (100) EACH DIRECTION	SKIP-DASH AND SOLID	YELLOW	10' (3 m) LINE WITH 30' (9 m) SPACE FOR SKIP-DASH; 5½ (140) C-C BETWEEN SOLID LINE AND SKIP-DASH LINE
	8' (2.4m) LEFT ARROW	IN PAIRS	WHITE	SEE TYPICAL TWO-WAY LEFT TURN MARKING DETAIL
CROSSWALK LINES (PEDESTRIAN) A. DIAGONALS (BIKE & EQUESTRIAN) B. LONGITUDINAL BARS (SCHOOL)	2 © 6 (150) 12 (300) © 45° 12 (300) © 90°	SOLID SOLID SOLID	WHITE WHITE WHITE	NOT LESS THAN 6' (1.8 m) APART 2' (600) APART 2' (600) APART SEE TYPICAL CROSSWALK MARKING DETAILS.
STOP LINES	24 (600)	SOLID	WHITE	PLACE 4' (1.2 m) IN ADVANCE OF AND PARALLEL TO CROSSMALK, IF PRESENT. OTHERWISE, PLACE AT DESIRED STOPPING POINT. PARALLEL TO CROSSROAD CENTERLINE, WHERE POSSIBLE
PAINTED MEDIANS	2 & 4 (100) WITH 12 (300) DIAGONALS & 45° NO DIAGONALS USED FOR	SOLID	YELLOW: TWO WAY TRAFFIC WHITE: ONE WAY TRAFFIC	II (280) C-C FOR THE DOUBLE LINE SEE TYPICAL PAINTED MEDIAN MARKING.
GORE MARKING AND CHANNELIZING LINES	4' (1.2 m) WIDE MEDIANS 8 (200) WITH 12 (300) DIAGONALS @ 45°	SOLID	WHITE	DIACONALS: 15' (4.5 m) C-C (LESS THAN 30MPH (50 km/h)) 20' (6 m) C-C 30MPH (50 km/h) TO 45MPH (70 km/h)) 30' (9 m) C-C (0VER 45MPH (70 km/h))
RAILROAD CROSSING	24 (600) TRANSVERSE LINES: "RR" IS 6' (1.8 m) LETTERS: 16 (400) LINE FOR "X"	SOLID	WHITE	SEE STATE STANDARD 780001 AREA OF: "R":3.6 SO. FT. (0.33 m <sup>2</sup> ) EACH "%":540 SO. FT. (5.0 m <sup>2</sup> )
SHOULDER DIAGONALS	12 (300) © 45°	SOLID	WHITE - RIGHT YELLOW - LEFT	50' (15 m) C-C (LESS THAN 30MPH (50 km/h)) 75' (25 m) C-C (30 MPH (50 km/h) T0 45MPH (70 km/h) 150' (45 m) C-C (0VER 45MPH (70 km/h))

FOR FURTHER DETAILS ON PAVEMENT MARKING REFER TO STANDARD SPECIFICATIONS FOR ROAD AND BRIDGE CONSTRUCTION AND STATE STANDARD 780001.


All dimensions are in inches (millimeters) unless otherwise shown.

FILE NAME =	USER NAME = drivakosgn	DESIGNED - EVERS	REVISED -T. RAMMACHER 10-27-94
ci\pw_work\pwidot\drivakosgn\d0108315\to	3.dgn	DRAWN -	REVISED -C. JUCIUS 09-09-09
	PLOT SCALE = 50.000 ' / IN.	CHECKED -	REVISED -
	PLOT DATE = 9/9/2009	DATE - 03-19-90	REVISED -

TYPICAL CROSSWALK MARKING

STATE	E 01	ILLINOIS
DEPARTMENT	<b>OF</b>	TRANSPORTATION

DISTRICT ONE							F.A RTE.	SECTION	COUNTY	TOTAL	SHEET NO.		
TYPICAL PAVEMENT MARKINGS						1552	14-00500-00-SW	COOK	23	19			
							TC-13	CONTRACT	NO.	61B38			
SCALE: NO	SHEE	T NO. 1 C	)F 1	SHEETS	STA.	TO STA.	FED. R	FED. ROAD DIST. NO. 1   ILLINOIS   FED. AID PROJECT					

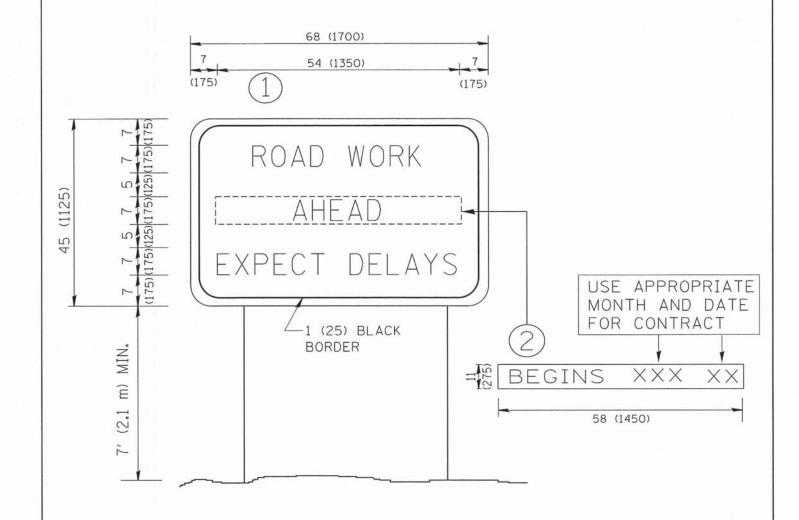



## NOTES:


- 1. USE BLACK LETTERING ON ORANGE BACKGROUND.
- 2. ERECT SIGNS IN ADVANCE OF THE LOCATION FOR THE "ROAD CONSTRUCTION AHEAD" SIGN AT LOCATIONS AS DIRECTED BY THE ENGINEER.
- 3. ERECT SIGN () WITH INSTALLED PANEL (2) ONE WEEK PRIOR TO THE START OF CONSTRUCTION.
- 4. REMOVE PANEL 2 SOON AFTER THE START OF CONSTRUCTION.
- 5. SEE SPECIAL PROVISION FOR "TEMPORARY INFORMATION SIGNING" FOR ADDITIONAL INFORMATION.
- 6. ONE SIGN ASSEMBLY EQUALS 25.70 SQ. FT. (2.3 SQ. M.)
- 7. SHALL BE PAID FOR AS TEMPORARY INFORMATION SIGNING.


ALL DIMENSIONS ARE IN INCHES (MILLIMETERS)
UNLESS OTHERWISE SHOWN.

FILE NAME =	USER NAME = gaglianobt	DESIGNED -	REVISED - R. MIRS 09-15-97		ARTERIAL ROAD INFORMATION SIGN				F.A.	SECTION	COUNTY	TOTAL	SHEET S NO.		
W:\diststd\22x34\tc22.dgn		DRAWN -	REVISED - R. MIRS 12-11-97	STATE OF ILLINOIS					1552	14-00500-00-SW	соок	23	20		
	PLOT SCALE = 50.000 ' / IN.	CHECKED -	REVISED -T. RAMMACHER 02-02-99	DEPARTMENT OF TRANSPORTATION						TC-22	CONTRAC	T NO.	61B38		
	PLOT DATE = 1/4/2008	DATE -	REVISED - C. JUCIUS 01-31-07		SCALE: NONE	SHEET NO. 1	1 OF 1	SHEETS	STA.	TO STA.	FED.				

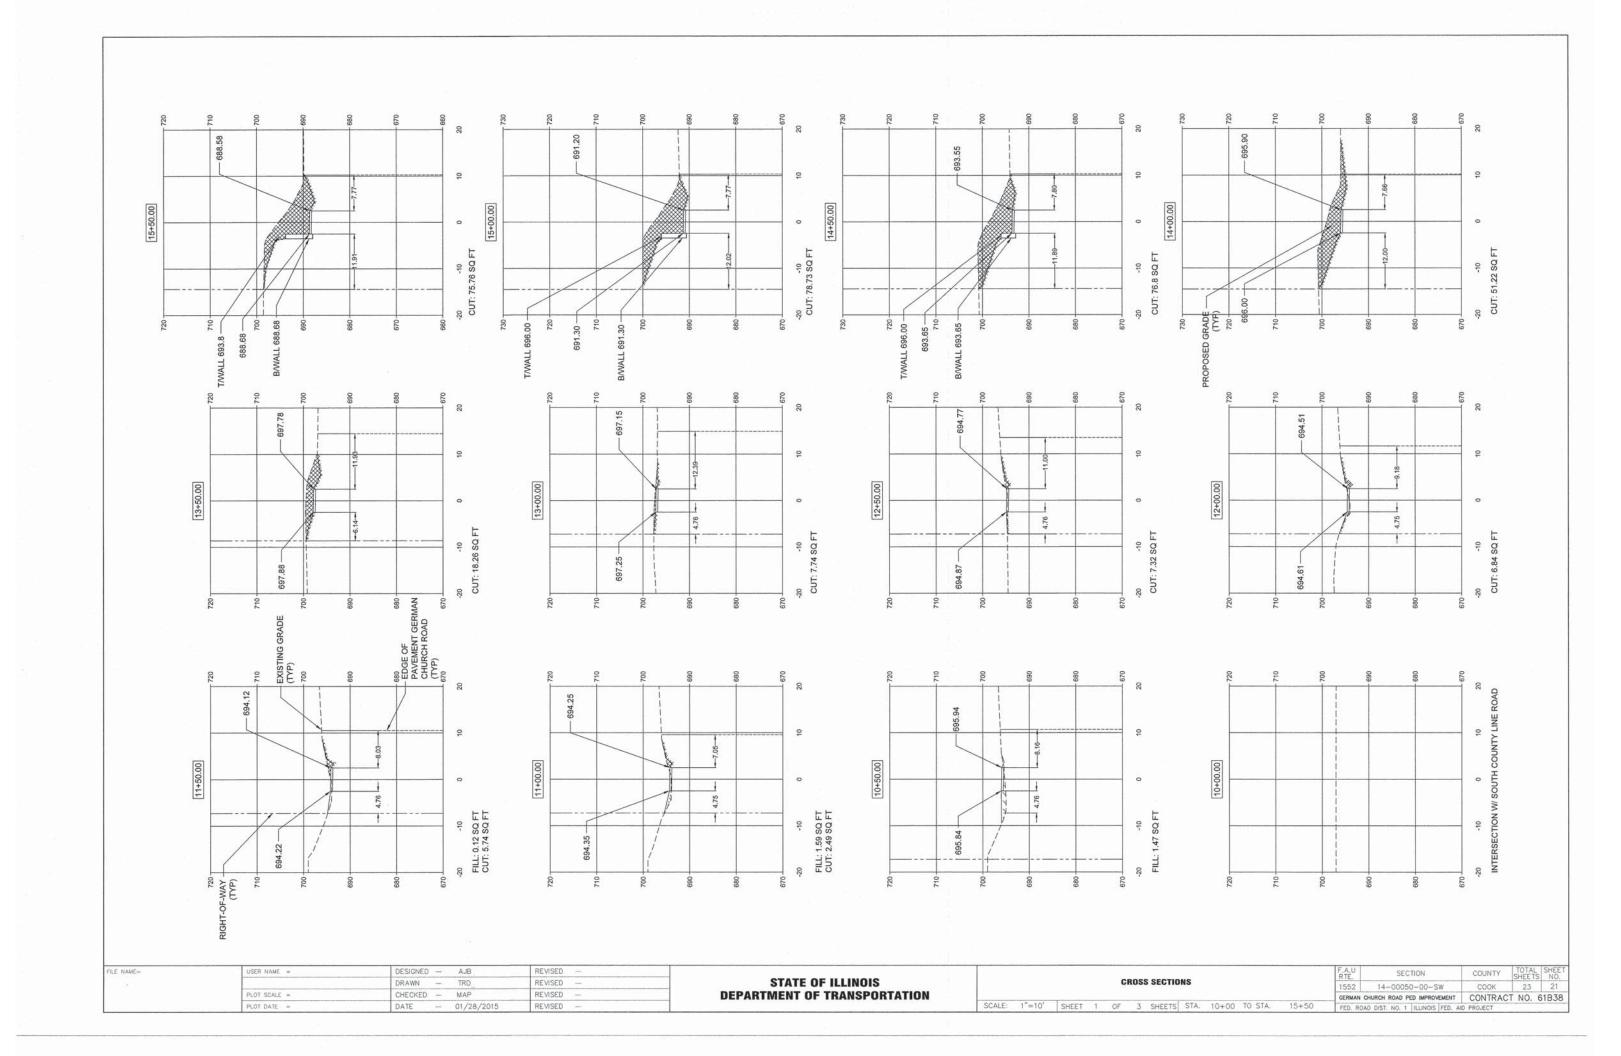

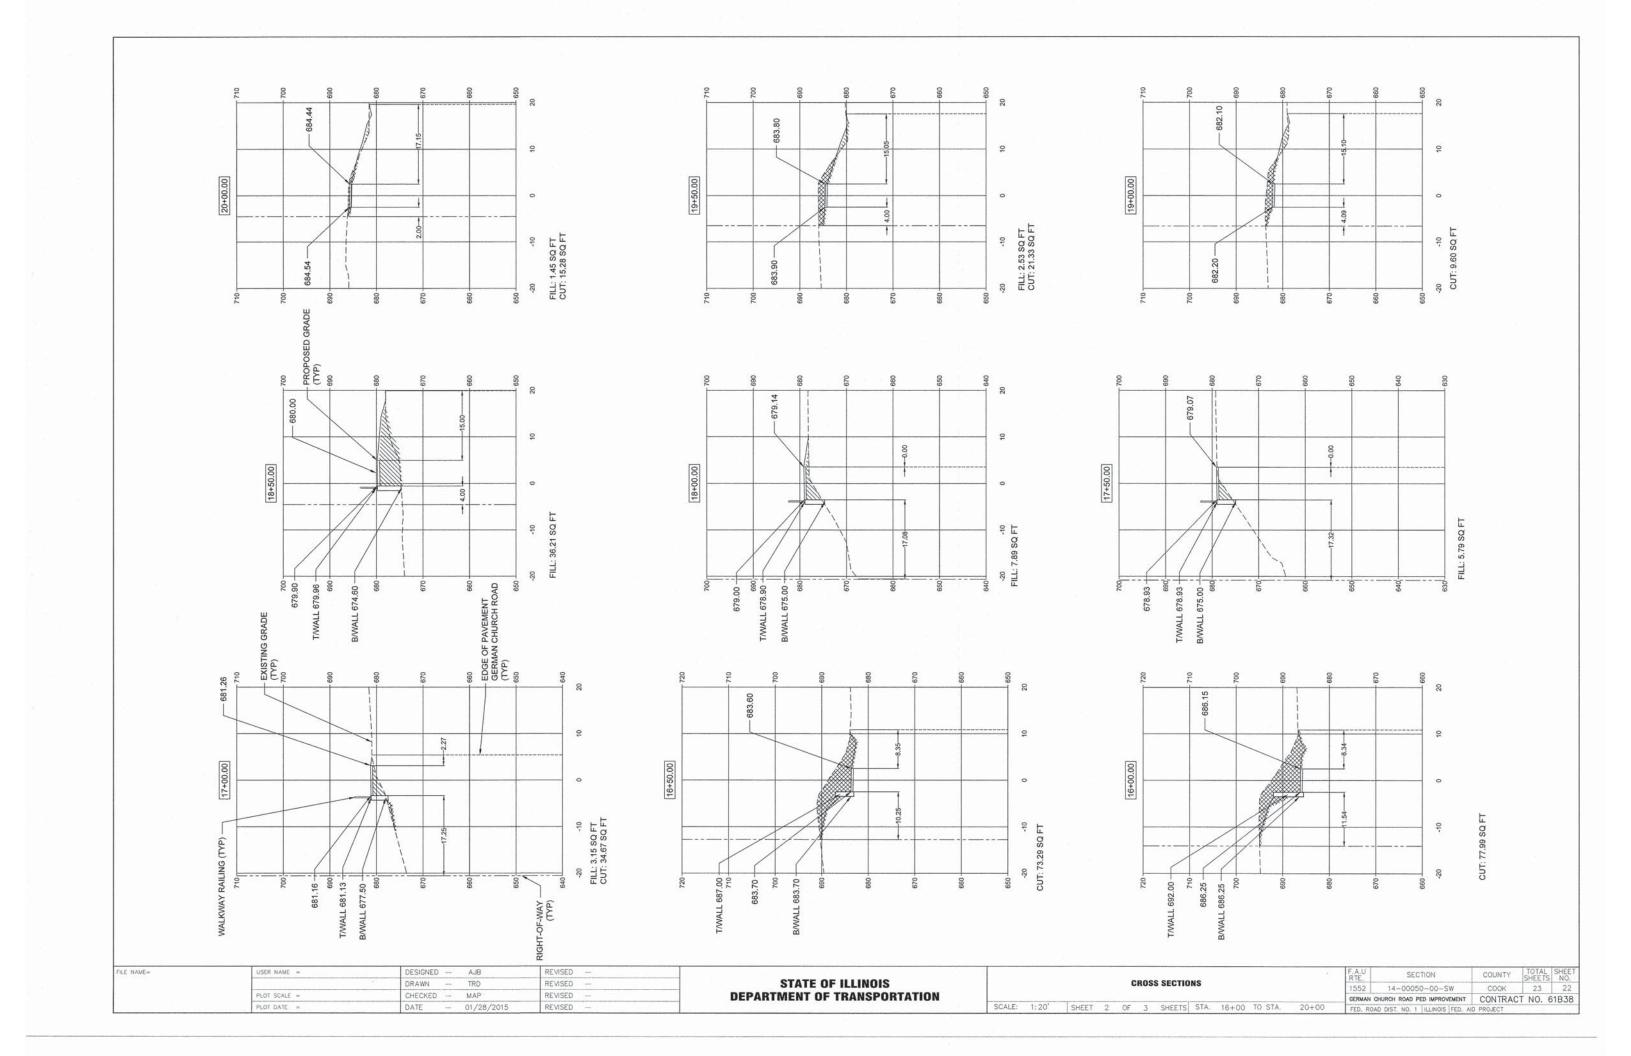

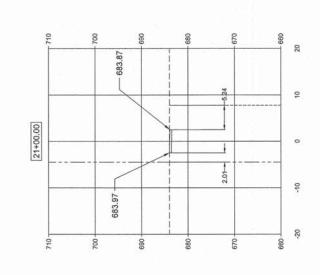

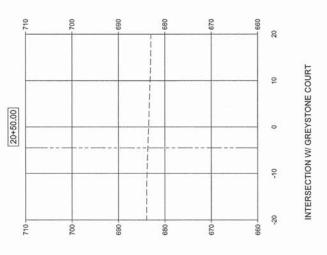

FILE NAME=	USER NAME =	DESIGNED — AJB	REVISED			F.A.U SECTION		COUNTY	TOTAL SI SHEETS	EET
		DRAWN — TRD	REVISED —	STATE OF ILLINOIS	CROSS SECTIONS	1552	14-00050-00-SW	COOK	23	23
	PLOT SCALE =	CHECKED MAP	REVISED -	DEPARTMENT OF TRANSPORTATION		GERMAN	CHURCH ROAD PED IMPROVEMENT	CONTRAC	CT NO. 61B	38
	PLOT DATE =	DATE 01/28/2015	REVISED -		SCALE: 1:20' SHEET 3 OF 3 SHEETS STA. 20+50 TO STA. 21+00	FED. RO.	AD DIST. NO. 1 ILLINOIS FED. A	D PROJECT		-