
#### 06-12-2020 LETTING ITEM 115

STATE OF ILLINOIS DEPARTMENT OF TRANSPORTATION

# PROPOSED HIGHWAY PLANS

F.A.U. ROUTE 3562: JOLIET ROAD. AT 55TH STREET. SECTION: (430V-X)N PROJECT: STP-39DJ(389) INTERSECTION RECONSTRUCTION/ ROADWAY RE-ALIGNMENT COOK COUNTY

C-91-174-14

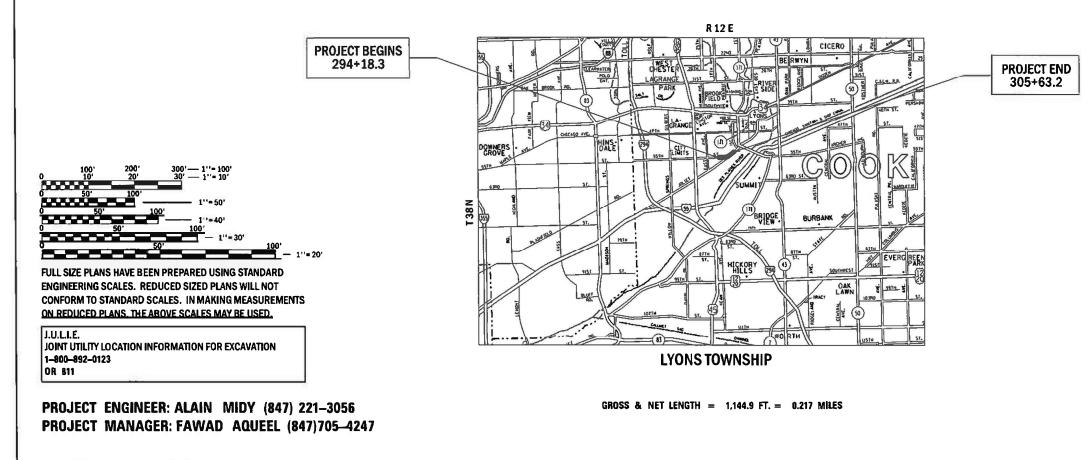

FOR INDEX OF SHEETS, SEE SHEET NO. 2

## THIS IMPROVEMENT IS LOCATED IN THE VILLAGE OF MCCOOK

#### TRAFFIC DATA

2018 ADT = 19800 SPEED LIMIT = 45 MPH

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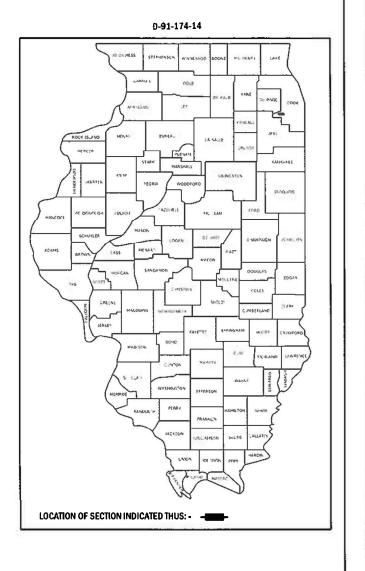
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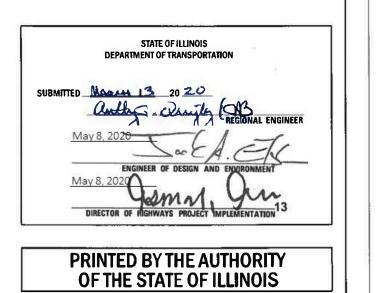
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# CONTRACT NO. 60X71

F.A.U. RTE.	SECTION		COUNTY	TOTAL SHEETS	SHEET NO.
3562	(430-X)N		C00K	99	1
		ILLINOIS	CONTRAC	T NO. 60	0X71





**REV-SEP** 

### **INDEX OF SHEETS**

### **STATE STANDARDS**

1	COVER SHEET	STANDARD NO.	DESC
2 & 3	INDEX OF SHEETS, STATE STANDARDS & GENERAL NOTES	000001-07	STANDARD SYMBOLS
4 - 9	SUMMARY OF QUANTITIES	280001-07	TEMPORARY EROSIC
10 & 11	EXISTING AND PROPOSED TYPICAL SECTIONS	424016-05	MID-BLOCK CURB R
12	SCHEDULES OF QUANTITIES	601001-05	PIPE UNDERDRAINS
13	ALIGNMENT, TIES, BENCHMARKS	602001-02	CATCH BASIN, TYPI
		602011-02	CATCH BASIN, TYPI
14 - 16	ROADWAY PLAN AND PROFILE SHEETS	602406-10	PRECAST MANHOLE
17 - 27	SUGGESTED STAGES OF CONSTRUCTION AND TRAFFIC CONTROL	604001-05	FRAME AND LIDS,
28	EROSION AND SEDIMENT CONTROL DETAILS	604036-03	GRATE TYPE 8
29 - 31	DRAINAGE PLAN AND PROFILE SHEETS	604091-03	FRAME AND GRATE
32	PROPOSED STRUCTURE AND PIPE LEGEND	606001-07	COMBINATION CONC
33	SUE INVESTIGATION OF UNDERGROUND UTILITIES	606201-04	TYPE B GUTTER (I
		630001-12	STEEL PLATE BEAN
34 - 36	RIGHT-OF-WAY SHEETS	630301-09	SHOULDER WIDENIN
37 - 39	PAVEMENT MARKING & SIGNAGE PLAN	631011-10	TRAFFIC BARRIER
40	LANDSCAPING PLAN	664001-02	CHAIN LINK FENCE
41 - 60	TRAFFIC SIGNAL PLANS	701101-05	OFF-ROAD OPERATI
61 - 73	LIGHTING PLAN	701106-02	OFF-ROAD OPERATI
74 - 76	SIDEWALK PLAN	701426-09	LANE CLOSURE, MU
			SPEEDS ± 45 MPH
77 & 78	SOIL BORING LOGS	701606-10	URBAN SINGLE LAN
79	DRIVEWAY DETAILS DISTANCE BETWEEN ROW AND FACE OF CURB > 15′ (4.5 m) (BD-O1)	701701-10	URBAN LANE CLOSU
80	DRIVEWAY DETAILS DISTANCE BETWEEN ROW AND FACE OF	701801-06	SIDEWALK, CORNER
00	CURB $< 15'$ (4.5 m) (BD-02)	701901-08	TRAFFIC CONTROL
81	BUTT JOINT AND HMA TAPER DETAILS (BD-32)	704001-08	SIGN PANEL MOUNT
82	DETAILS FOR DEPRESSED CURB & GUTTER AND SHOULDER	720001-01	SIGN PANEL ERECT
	TREATMENT AT TBT TY 1. SPL. (BD-34)	720006-04 720011-01	METAL POSTS FOR
83	FIRE HYDRANT TO BE MOVED (BD-36)	725001-01	OBJECT AND TERM
84	TRAFFIC CONTROL AND PROTECTION FOR SIDE ROADS,	782006-01	GUARDRAIL AND BA
	INTERSECTIONS, AND DRIVEWAYS (TC-10)	814001-03	HANDHOLES
85	TYPICAL APPLICATIONS RAISED REFLECTIVE PAVEMENT MARKERS (SNOW PLOW RESISTANT) (TC-11)	814006-02	DOUBLE HANDHOLES
		836001-04	LIGHT POLE FOUND
86	DISTRICT ONE TYPICAL PAVEMENT MARKINGS (TC-13)	857001-01	STANDARD PHASE [
87	TRAFFIC CONTROL AND PROTECTION AT TURN BAYS (TO REMAIN OPEN TO TRAFFIC) (TC-14)	873001-02	TRAFFIC SIGNAL G
0.0		877011-10	STEEL COMBINATIO
88	PAVEMENT MARKING LETTERS AND SYMBOLS FOR TRAFFIC STAGING (TC-16)	878001-10	CONCRETE FOUNDA
89	ARTERIAL ROAD INFORMATION SIGN (TC-22)	880001-01	SPAN WIRE MOUNTE
90	DRIVEWAY ENTRANCE SIGNING (TC-26)	880006-01	TRAFFIC SIGNAL M
		886001-01	DETECTOR LOOP IN
91 - 99	CROSS SECTIONS	886006-01	TYPICAL LAYOUTS

USER NAME = hassann		REVISED -			INDEX 0	F SHEETS	S & HIGHWAY STAND	ARDS	F.A.U. RTE.	SECTION	COUNTY	TOTAL SHEET SHEETS NO.
	DRAWN -	REVISED -	STATE OF ILLINOIS				ROAD AT 55TH ST.		3562	(430V-X)N	СООК	99 2
PLOT SCALE = 100.0000 ' / in.	CHECKED -	REVISED -	DEPARTMENT OF TRANSPORTATION			JULIEI	IOAD AT SSTH ST.		<u> </u>		CONTRAC	T NO. 60X71
PLOT DATE = 3/23/2020	DATE -	REVISED -		SCALE:	SHEET	OF	SHEETS STA.	TO STA.		ILLINOIS FE	D. AID PROJECT	

#### ESCRIPTION

OLS, ABBREVIATIONS AND PATTERNS SION CONTROL SYSTEM RAMPS FOR SIDEWALKS ٧S YPE A YPE C LE TYPE A 6' (1.83 M) DIAMETER TYPE 1 TE TYPE 24 NCRETE CURB AND GUTTER (INLET, OUTLET & ENTRANCE) EAM GUARDRAIL ING FOR TYPE 1 (SPECIAL) GUARDRAIL TERMINALS TERMINAL, TYPE 2 CE ATIONS, MULTILANE, 15' TO 24" FROM PAVEMENT EDGE ATIONS, MULTILANE, MORE THAN 15' AWAY MULTILANE, INTERMITTEN OR MOVING OPERATION FOR ч ANE CLOSURE, MULTILANE, 2W WITH MOUNTABLE MEDIAN OSURE, MULTILANE INTERSECTION ER OR CROSSWALK CLOSURE DL DEVICES CRETE BARRIER JNT DETAILS ECT DETAILS OR SIGNS MARKERS AND DELINEATORS RMINAL MARKERS BARRIER WALL REFLECTOR MOUNTING DETAILS LES NDATION DESIGNATION DIAGRAMS AND PHASE SEQUENCES GROUNDING AND BONDING ION MAST ARM ASSEMBLY AND POLE 16' THROUGH 55' DATION DETAILS NTED SIGNALS AND FLASHING BEACON INSTALLATION MOUNTING DETAILS INSTALLATIONS TS FOR DETECTION LOOPS

**REV-SEP** 

#### **GENERAL NOTES**

THE CONTRACTOR SHALL COORDINATE CONSTRUCTION ACTIVITIES WITH UTILITY COMPANIES, AND THE VILLAGE OF MCCOOK, IL

BEFORE STARTING ANY EXCAVATION, THE CONTRACTOR SHALL CALL "JULIE" AT 800-892-0123 OR 811 FOR FIELD LOCATIONS OF BURIED ELECTRIC, TELEPHONE AND GAS FACILITIES. (48 HOURS NOTIFICATION IS REQUIRED)

THE CONTRACTOR WILL NOT BE ABLE TO SET UP A YARD OR FIELD OFFICE ON STATE PROPERTY WITHOUT THE WRITTEN PERMISSION OF THE DEPARTMENT.

ALL DAMAGE TO EXISTING PAVEMENT MARKINGS OR RAISED REFLECTIVE PAVEMENT MARKERS OUTSIDE THE REMOVAL LINE SHOWN ON THE PLANS SHALL BE REPLACED AT THE CONTRACTOR'S EXPENSE.

IT SHALL BE THE CONTRACTOR'S RESPONSIBILITY TO VERIFY ALL DIMENSIONS AND CONDITIONS EXISTING IN THE FIELD PRIOR TO CONSTRUCTION AND ORDERING OF MATERIALS.

FRAMES AND GRATES ADJUSTMENT OF PRIVATE UTILITIES WITHIN THE LIMITS OF THE IMPROVEMENTS SHALL BE DONE BY THEIR RESPECTIVE OWNERS AND ARE NOT PART OF THIS CONTRACT.

THE CONTRACTOR SHALL CONTACT THE IDOT ARTERIAL DISTRICT ONE TRAFFIC CONTROL SUPERVISOR AT KALPANA,KANNAN-HOSADURGA@ILLINOIS.GOV A MINIMUM OF 72 HOURS IN ADVANCE OF BEGINNING WORK.

THE RESIDENT ENGINEER SHALL CONTACT KYLIE VOGRIN, TRAFFIC FIELD ENGINEER, AT KYLIE.VOGRIN@ILLINOIS.GOV A MINIMUM OF TWO (2) WEEKS PRIOR TO THE PLACEMENT OF PERMANENT PAVEMENT MARKINGS.

DO NOT SCALE PLANS FOR CONSTRUCTION DIMENSIONS.

THE CONTRACTOR SHALL BE REQUIRED TO PROVIDE ACCESS TO ABUTTING PROPERTY AT ALL TIMES DURING THE CONSTRUCTION OF THIS PROJECT.

EXISTING BROKEN FRAMES AND LIDS SHALL BE REMOVED AND DISPOSED OF BY THE CONTRACTOR AND SHALL BE REPLACED AS DIRECTED BY THE ENGINEER. REPLACEMENT FRAMES AND LIDS WILL BE PAID FOR ACCORDING TO ARTICLE 109.04 OF THE STANDARD SPECIFICATIONS UNLESS A SEPARATE PAY ITEM HAS BEEN PROVIDED.

PAVEMENT MARKING TAPE, TYPE IV SHALL BE USED FOR SHORT TERM PAVEMENT MARKINGS ON ALL FINAL SURFACES.

THE REMOVAL OF GUARDRAIL TERMINAL SECTIONS SHALL BE INCLUDED IN THE UNIT PRICE PER FOOT FOR "GUARDRAIL REMOVAL".

THE SUBGRADE STABILITY SHALL BE VERIFIED BY PROOF ROLLING WITH A FULLY LOADED TANDEM-AXLE TRUCK.

AGGREGATE SUBGRADE IMPROVEMENT (CU YD) HAS BEEN PROVIDED FOR USE AT THE LOCATIONS INDICATED FOR SOILS THAT TEND TO BE UNSTABLE AND/OR UNSUITABLE. THE ACTUAL NEED FOR REMOVAL AND REPLACEMENT WITH ASI WILL BE DETERMINED IN THE FIELD AT THE TIME OF CONSTRUCTION BY THE GEOTECHNICAL ENGINEER. ALL POTENTIALLY UNSTABLE SOILS SHOULD BE TESTED WITH A STATIC OR DYNAMIC CONE PENETROMETER AND TREATED IN ACCORDANCE WITH ARTICLE 301.04 OF THE SSRBC AND IDOT SUBGRADE STABILITY MANUAL. IF UNSTABLE AND/OR UNSUITABLE SOILS ARE NOT ENCOUNTERED, THEN THE QUANTITY SHALL BE DEDUCTED, AND NO ADDITIONAL COMPENSATION WILL BE DUE TO THE CONTRACTOR.

ANY AGGREGATE SUBGRADE IMPROVEMENT CONTAMINATED AND/OR DAMAGED BY THE CONTRACTOR'S VEHICLES AND/OR EQUIPMENTS IS TO BE REMOVED AND REPLACED AS DIRECT BY THE ENGINEER AT CONTRACTOR EXPENSE.

PIPE UNDERDRAINS SHALL BE INSTALLED ACCORDING TO SECTION 601 OF THE SSRBC AND STANDARD 601001-05. TOP OF PIPE UNDERDRAINS SHALL BE PLACED MINIMUM 6" BELOW THE AGGREGATE SUBGRADE IMPROVEMENT LAYER. THE COST OF MAKING PIPE UNDERDRAINS CONNECTIONS TO DRAINAGE STRUCTURES SHALL BE INCLUDED IN THE COST OF THE PIPE UNDERDRAINS.

BACKFILLING STORM SEWER CONSTRUCTED UNDER THE ROADWAY SPECIFIED UNDER ART. 550.07(b, c) OF THE SSRBC WILL NOT BE ALLOWED.

THE DEPARTMENT HAS NOT OBTAINED ANY PERMITS FOR OFFSITE BORROW, WASTE, USE (BWU) AREAS. PRIOR TO WORKING IN BWU AREAS, IF THE CONTRACTOR CHOOSES TO USE ACTIVITIES REQUIRING PERMITS IT IS THE CONTRACTOR 5/32 S RESPONSIBILITY TO SECURE THE PROPER PERMITS. IN ADDITION TO THE BORROW REVIEW (BDE 2289) and USE/WASTE REVIEW(BDE 2290) SUBMITTALS, THE CONTRACTOR SHALL SUBMIT AN EROSION AND SEDIMENT CONTROL (ESC) PLAN FOR EVERY BWU SITE TO THE DEPARTMENT FOR ACCEPTANCE. GUIDELINES FOR ACCEPTABLE BWU PRACTICES CAN BE FOUND IN SECTION II.G.I AND 2 of the SWPPP. THE COST OF ALL MATERIALS AND LABOR NECESSARY TO COMPLY WITH THE ABOVE PROVISIONS TO PREPARE AND IMPLEMENT ESC PLANS WILL NOT BE PAID FOR SEPARATELY, BUT SHALL BE CONSIDERED AS INCLUDED IN THE UNIT BID PRICES OF THE CONTRACT AND NO ADDITIONAL COMPENSATION WILL BE ALLOWED.

THE CONTRACTOR SHALL NOTIFY MR. RICHARD WILLMAN FROM PACE, THE SUBURBAN BUS DIVISION OF THE RTA, AT (847) 228-3584 A MINIMUM OF 14 DAYS IN ADVANCE FOR THE REMOVAL OF THE IMPACTED BUS SHELTERS.

USER NAME = hassann	DESIGNED -	REVISED -				GEN	ERAL NO	TES		F.A.U. RTE	SECTION	COUNTY	TOTAL SHEET SHEETS NO.
	DRAWN -	REVISED -	STATE OF ILLINOIS		14			55TH ST.		3562	(430V-X)N	соок	99 3
PLOT SCALE = 100.0000 ' / in.	CHECKED -	REVISED -	DEPARTMENT OF TRANSPORTATION		J			5511 51.				CONTRAC	CT NO. 60X71
PLOT DATE = 3/23/2020	DATE -	REVISED -		SCALE:	SHEET	OF	SHEETS	STA.	TO STA.		ILLINOIS FEI	D. AID PROJECT	

	SUMMARY OF QUANTITIES		URBAN				ON TYPE CODE		SUMMAF	RY OF QUANTITIES		URBAN				ON TYPE CODE	$\top$
CODE NO	ITEM	UNIT	TOTAL QUANTITIES	ROADWAY 80% FED 20% STATE 0004	SIGNAL 80% FED 20% STATE 0021	80% FED 20% STATE 0021 (INTERCONNECT)	LIGHTING & FIRE EVP HYDRANT 100% VILLAGE 100% VILLAGE 0021 0043	CODE NO		ITEM	UNIT	TOTAL	ROADWAY 80% FED 20% STATE 0004	SIGNAL 80% FED 20% STATE 0021	80% FED 20% STATE 0021 (Interconnect)	LIGHTING & FIRE EVP HYDRANT 100% VILLAGE 100% VILLAG 0021 0043	
20200100	EARTH EXCAVATION	CU YD	937	937													
								40600275	BITUMINOUS M	ATERIALS (PRIME COAT)	POUND	28480	28480				
20200200	ROCK EXCAVATION	CU YD	24.5	24.5													
	REMOVAL AND DISPOSAL OF UNSUITABLE							40600290	BITUMINOUS M	ATERIALS (TACK COAT)	POUND	4272	4272				
20201200	MATERIAL	CU YD	400	400				40603335	HOT-MIX ASPHA	LT SURFACE COURSE, MIX	TON	9	9				
20400800	FURNISHED EXCAVATION	CU YD	1712	1712					"D", N50								
								40701911	HOT-MIX ASPH 11 1/2"	ALT PAVEMENT (FULL-DEPTH),	SQ YD	6330	6330				-
20800150	TRENCH BACKFILL	CU YD	49	49													
								42300600	PORTLAND CEME PAVEMENT, 10	NT CONCRETE DRIVEWAY INCH	SQ YD	475	475				
21001000	GEOTECHNICAL FABRIC FOR GROUND STABILIZATION	SQ YD	1100	1100				4242222				2400	2400				
21101505	TOPSOIL EXCAVATION AND PLACEMENT	CU YD	900	900				42400200	INCH	NT CONCRETE SIDEWALK 5	SO FT	2400	2400				
								42400800	DETECTABLE W	ARNINGS	SQ FT	24	24				_
21101645	TOPSOIL FURNISH AND PLACE, 12"	SO YD	507	507													-
								44000100	PAVEMENT REMO	DVAL	SO YD	8812	8812				
<b>k</b> 25100115	MULCH, METHOD 2	ACRE	0.1	0.1													
								44000200	DRIVEWAY PAVE	EMENT REMOVAL	SQ YD	261	261				
<b>k</b> 25200110	SODDING, SALT TOLERANT	SQ YD	6600	6600													_
k 28000400	PERIMETER EROSION BARRIER	FOOT	1290	1290				44000300	CURB REMOVAL		FOOT	64	64				
								44000500	COMBINATION (	CURB AND GUTTER REMOVAL	FOOT	2550	2550				_
28000510	INLET FILTERS	EACH	22	22													_
								44000600	SIDEWALK REMO	LAVG	SO FT	2250	2250				_
30300001	AGGREGATE SUBGRADE IMPROVEMENT	CU YD	400	400													
			7010					44003100	MEDIAN REMOV	AL	SO FT	380	380				
30300112	AGGREGATE SUBGRADE IMPROVEMENT 12"	SQ YD	7212	7212				48101620	ACCRECATE SU	OULDERS, TYPE B 10"	SQ YD	1 7 5	1 35				_
31101200	SUBBASE GRANULAR MATERIAL, TYPE B 4"	SO YD	100	100				40101620	AUUREUAIE SHU	UULDENS, HIFE D 10"		1 35	1.72				_
								50200400	ROCK EXCAVAT	ION FOR STRUCTURES	CU YD	2				2	
35501316	HOT-MIX ASPHALT BASE COURSE. 8"	SO YD	35	35												* SPECIALT	
FILE NAME =	USER NAME = hassann	DESIGNED -	1	REVISED						JOLIET ROAD AND	55TH STREFT	INTERSECTI	ON	F.A.U. RTE.	SEC.		
pw:\\planroom.dot.jiiinois.	.gov:PWID0T\Documents\ID0T_Offices\District_NProjects\PI22II2\CADDatd\Design\PI22II2\st PL0T_SCALE = 100.0000 ' / In.	rs@DRAMWN - CHECKED -		REVISED REVISED			STATE DEPARTMENT C	OF ILLINOIS			OF QUANT			3562			
1	PLOT DATE = 3/23/2020	DATE -		REVISED				I INANSFURIA		SCALE: SHEET NO. 1 OF 6			O STA.			ILLINOIS FED. AID PROJECT	<u>_'</u>

	SUMMARY OF QUANTITIES				C	CONSTRUCT	ION TYPE	CODE				SUMMAR	Y OF QUANTITIES				C	ONSTRUCT	ION TYPE CODE
CODE NO	ITEM	UNIT	URBAN TOTAL QUANTITIES	ROADWAY 80% FED 20% STATE 0004	80% FED	80% FED 20% STATE 0021	LIGHTING & EVP 100% VILLAGE 0021	HYDRANT			CODE NO		ITEM	UNIT	URBAN TOTAL QUANTITIES	ROADWAY 80% FED 20% STATE 0004	80% FED	80% FED 20% STATE 0021	LIGHTING & FIRE EVP HYDRANT 100% VILLAGE 100% VILLAGE 0021 0043
				0004		(INTERCONNECT)				┥┝						0004		(INTERCONNECT)	
550A0340	STORM SEWERS, CLASS A, TYPE 2 12"	FOOT	80	80						-	63000001		BEAM GUARDRAIL, TYPE A. 6	FOOT	350	350			
										-	8500001	FOOT POSTS	SEAM GUARDRAIL, TIFE A, G		550	550			
55100500	STORM SEWER REMOVAL 12"	FOOT	19	19															
										*	63100045	TRAFFIC BARR	IER TERMINAL, TYPE 2	EACH	1	1			
56101400	CAST IRON WATER MAIN 6"	FOOT	45	45															
										*	63100167	TRAFFIC BARRI (SPECIAL) TAN	ER TERMINAL, TYPE 1 GENT	EACH	3	3			
56400100	FIRE HYDRANTS TO BE MOVED	EACH	2					2											
											63200310	GUARDRAIL REM	IOVAL	FOOT	323	323			
60108204	PIPE UNDERDRAINS, TYPE 2, 4"	FOOT	4580	4580															
											66400305	CHAIN LINK FE	NCE, 6'	FOOT	50	50			
60200105	CATCH BASINS, TYPE A, 4'-DIAMETER, TYPE 1 FRAME, OPEN LID	EACH	5	5															
											66407500	CHAIN LINK GA	TES, 6' X 10' DOUBLE	EACH	1	1			
60206905	CATCH BASINS, TYPE C, TYPE 1 FRAME, OPEN LID	EACH	2	2															
										*	66900200	NON-SPECIAL W	ASTE DISPOSAL	CU YD	335	335			
60218400	MANHOLES, TYPE A, 4'-DIAMETER, TYPE 1 FRAME, CLOSED LID	EACH	1	1															
										*	66900530	SOIL DISPOSAL	ANALYSIS	EACH	3	3			
60250200	CATCH BASINS TO BE ADJUSTED	ЕАСН	6	6															
										*	66901001	REGULATED SUB	STANCES PRE-CONSTRUCTION	LSUM	1	1			
60255500	MANHOLES TO BE ADJUSTED	EACH	3	3															
										*	66901003		STANCES FINAL CONSTRUCTION	LSUM	1	1			
60260100	INLETS TO BE ADJUSTED	ЕАСН	7	7								REPORT							
										*	66901006	REGULATED SUB	STANCES MONITORING	CAL DA	40	40			
60261000	INLETS TO BE ADJUSTED WITH NEW TYPE 8	EACH	1	1															
	GRATE									+	67000400	ENGINEER'S F	ELD OFFICE, TYPE A	CAL MO	12	12			
60500050	REMOVING CATCH BASINS	ЕАСН	3	3						+									
00300030										+	67100100	MOBILIZATION		L SUM	1	1			
60500000		E A CU								+					•				
60500060	REMOVING INLETS	EACH								+	70107025	CHANGEABLE ME	SSACE SICN	CAL DA	210	210			
										+	10101020	CHANGEADLE ME	STAT STON		210	210			
60600605	CONCRETE CURB, TYPE B	FOOT	65	65						+	70300210		EMENT MARKING LETTERS AND	50 57	75	75			
										+	70300210	SYMBOLS	LMENT MARKING LETTERS AND	SO FT	C	C1			REV-SEP
60605000	COMBINATION CONCRETE CURB AND GUTTER, TYPE B-6.24	FOOT	2475	2475															* SPECIALTY ITEM
FILE NAME = pw:\\planroom.dotJillnol	sgov#WIDOT\Documents\DOT_Offices\District_NProjects\PI22II2\CADData\Design\PI22II2-sht_S@E			REVISED REVISED	-		_		TATE OF				JOLIET ROAD AND 5 SUMMARY	5TH STREE		ION	F.A.U. RTE. 3562	SEC (430	CTION COUNTY TOTAL SHEE SHEETS NO. 0-XIN COOK 99 5
		HECKED - ATE -		REVISED REVISED				* SPECIA		IKA	NSPORTA		SCALE: SHEET NO. 2 OF 6			O STA.	FED. F	ROAD DIST. NO. 1	CONTRACT NO. 60X71

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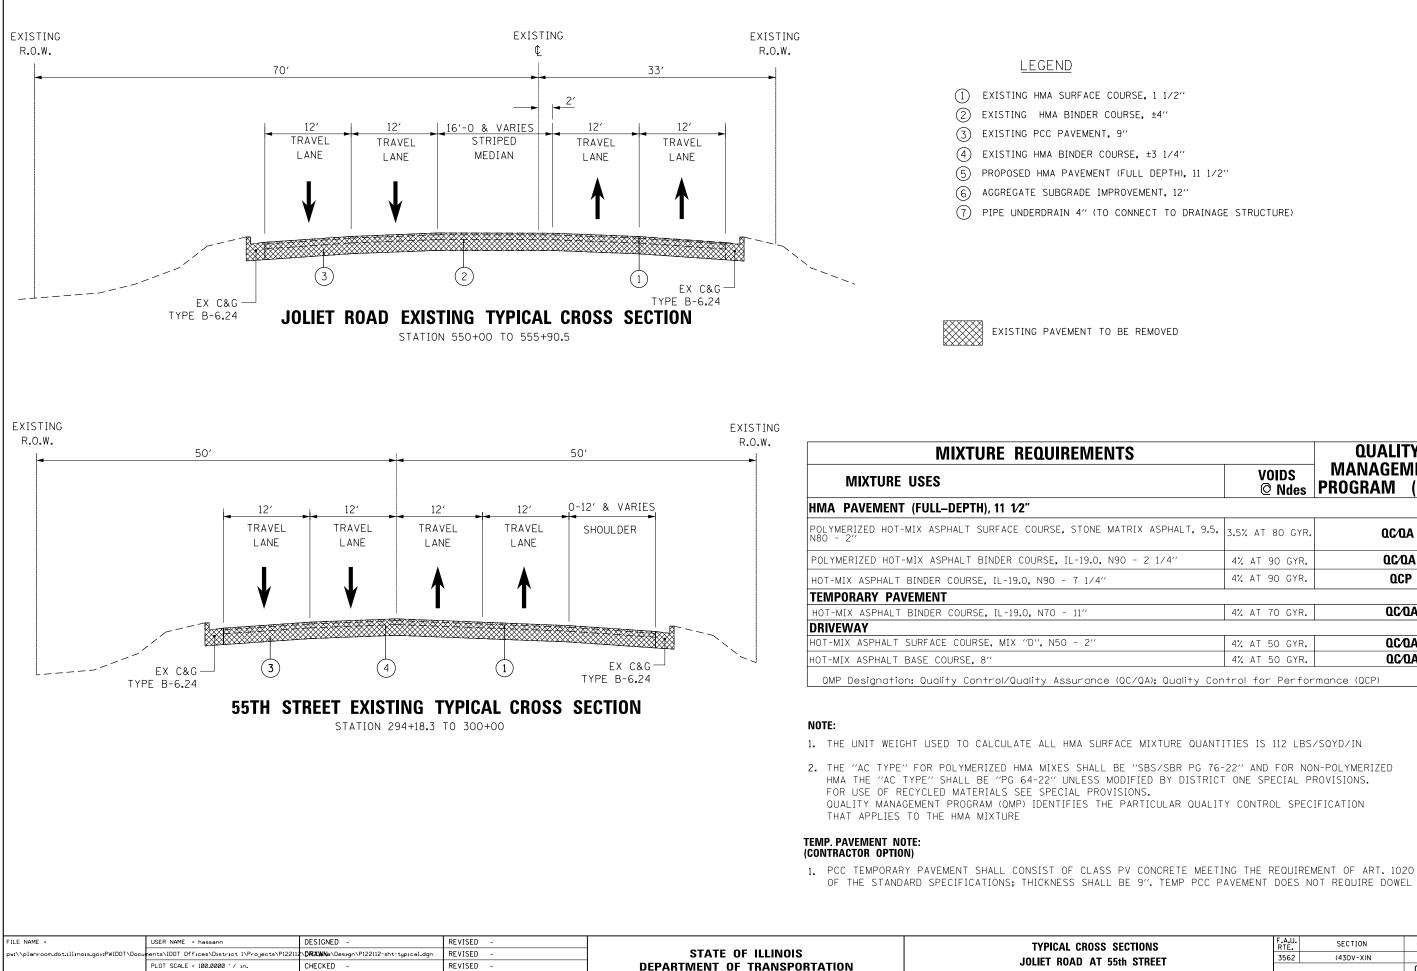
CODE NO		1	URBAN								RY OF QUANTITIES		URBAN	1 1					
,	ITEM	UNIT	TOTAL QUANTITIES	ROADWAY 80% FED 20% STATE 0004	SIGNAL 80% FED 20% STATE 0021	80% FED 20% STATE 0021 (INTERCONNECT)	LIGHTING & EVP 100% VILLAGE 0021	FIRE HYDRANT 100% VILLAGE 0043	CODE NO		ITEM	UNIT	TOTAL QUANTITIES	ROADWAY 80% FED 20% STATE 0004	SIGNAL 80% FED 20% STATE 0021	80% FED 20% STATE 0021 (INTERCONNECT)	LIGHTING & EVP 100% VILLAGE 0021	HYDRANT	£.
0600350	IMPACT ATTENUATORS, RELOCATE (NON- REDIRECTIVE), TEST LEVEL 3	ЕАСН	2	2															
									* 78000650	THERMOPLASTI	C PAVEMENT MARKING - LINE 24"	FOOT	115	115					
72000100	SIGN PANEL - TYPE 1	SQ FT	22	22					* 78009004	MODIFIED URE	ETHANE PAVEMENT MARKING -	FOOT	650	650					
72400100	REMOVE SIGN PANEL ASSEMBLY - TYPE A	ЕАСН	5	5						LINE 4"									
									* 78100100	RAISED REFLE	ECTIVE PAVEMENT MARKER	EACH	140	140					
72400500	RELOCATE SIGN PANEL ASSEMBLY - TYPE A	EACH	5	5															
									78100200	TEMPORARY RA MARKER	AISED REFLECTIVE PAVEMENT	EACH	120	120					
72900100	METAL POST - TYPE A	FOOT	25	25					78200006			EACH	20	20					
78000100	THERMOPLASTIC PAVEMENT MARKING -	SQ FT	75	75					78200006	GUARDRAIL RE	EFLECTORS, TYPE B	EACH	20	20					
	LETTERS AND SYMBOLS								78200011	BARRIER WAL	L REFLECTORS, TYPE C	EACH	120	120					
78000200	THERMOPLASTIC PAVEMENT MARKING - LINE 4"	FOOT	8675	8675															
									72501000	TERMINAL MAR	RKER - DIRECT APPLIED	EACH	4	4					
78000400	THERMOPLASTIC PAVEMENT MARKING - LINE 6"	FOOT	170	170					78300200	RAISED REFLE	ECTIVE PAVEMENT MARKER	ЕАСН	75	75					
70300220	TEMPORARY PAVEMENT MARKING - LINE 4"	FOOT	9325	9325						REMOVAL									
									* 80400100	ELECTRIC SER	RVICE INSTALLATION	EACH	1				1		
70300240	TEMPORARY PAVEMENT MARKING - LINE 6"	FOOT	170	170															
									* 80400200	ELECTRIC UTI	ILITY SERVICE CONNECTION	L SUM	1				1		
70300280	TEMPORARY PAVEMENT MARKING - LINE 24"	FOOT	115	115					* 81028200		CONDUIT, GALVANIZED STEEL,	FOOT	824		556	268			
70300904	PAVEMENT MARKING TAPE, TYPE IV 4"	FOOT	22500	22500						2" DIA.									
									* 81028210	UNDERGROUND 2 1/2" DIA.	CONDUIT, GALVANIZED STEEL,	FOOT	62		62				
70400100	TEMPORARY CONCRETE BARRIER	FOOT	1450	1450															
70400200	RELOCATE TEMPORARY CONCRETE BARRIER	FOOT	1075	1075					* 81028220	UNDERGROUND 0 3" DIA.	CONDUIT, GALVANIZED STEEL,	FOOT	398		263		1 35		
5700200	ALLOCATE TEMPONANT CONCRETE DARRIER		1013	1013					* 81028240	UNDERGROUND	CONDUIT, GALVANIZED STEEL,	FOOT	266		266				
70600250	IMPACT ATTENUATORS, TEMPORARY (NON- REDIRECTIVE), TEST LEVEL 3	ЕАСН	2	2															
0600251	IMPACT ATTENUATORS, TEMPORARY (NON- REDIRECTIVE, NARROW), TEST LEVEL 3	ЕАСН	6	6					* 81400100	HANDHOLE		EACH	6		6				REV-SE
ILE NAME =		SIGNED -		REVISED											F.Δ !!				
	als.gov;PWIDOT\Documents\DOT_Offices\District_NProjects\PI22II2\CADData\Design\PI22II2\sn \$000000000000000000000000000000000000	AWWN - ECKED -		REVISED REVISED REVISED REVISED	-		C		OF ILLINOIS F TRANSPORTA	TION	JOLIET ROAD AND 55 SUMMARY SCALE: SHEET NO. 3 OF 6	OF QUANT	ITIES	ION	F.A.U RTE. 3562			СООК	TOTAL SHEETS NO. 99 6 NO. 60X7

	SUMN	MARY OF OUANTITIES				СС	ONSTRUCTIC	N TYPE CODE			SUMMARY OF QUANTITIES			(	CONSTRUCTI	ON TYPE CO	DE
CODE	NO	ITEM	UNIT	URBAN TOTAL QUANTITIES	ROADWAY 80% FED 20% STATE 0004	SIGNAL 80% FED 20% STATE 0021	80% FED 20% STATE 0021 (INTERCONNECT)	LIGHTING & FIRE EVP 100% VILLAGE 0021 0043	E	CODE NO	ITEM	UNIT	QUANTITIES 20%	WAY SIGNAL FED 80% FED STATE 20% STAT 04 0021		LIGHTING & EVP 100% VILLAGE 0021	FIRE HYDRANT 100% VILLAGE 0043
* 814003	000 DOUBLE HAND	HOLE	EACH	1		1											
										€ 86400100	TRANSCEIVER - FIBER OPTIC	EACH	1		1		
* 816030	UNIT DUCT, 6 GROUND, (XLP POLYETHYLENE	00V, 3-1C NO.4, 1/C NO.6 -TYPE USE), 1 1/4" DIA.	FOOT	1372				1372									
		-								87300925	ELECTRIC CABLE IN CONDUIT, TRACER, NO. 14 1C	FOOT	2237		2237		
* 8170217	70 ELECTRIC CAB	BLE IN CONDUIT, 600V E) 1/C NO. 2/0	FOOT	117				117									
										* 87301215	ELECTRIC CABLE IN CONDUIT, SIGNAL NO.	FOOT	434	434			
* 818003	00 AERIAL CABLE MESSENGER W	E, 3-1/C NO. 2 WITH	FOOT	393				393									
* 821100		ROADWAY, OUTPUT DESIGNATION G	ЕАСН	13				13		87301225	ELECTRIC CABLE IN CONDUIT, SIGNAL NO. 14 3C	FOOT	1079	702		377	
* 825003	30 LIGHTING CON 240VOLT, 60A	NTROLLER, PEDESTAL MOUNTED,	EACH	1		1		1									
										87301245	ELECTRIC CABLE IN CONDUIT, SIGNAL NO. 14 5C	FOOT	1671	1671			
* 830075	00 LIGHT POLE, FT. MAST ARM	ALUMINUM, 35 FT. M.H., 12	EACH	7				7									
										₩ 87301305	ELECTRIC CABLE IN CONDUIT, LEAD-IN, NO. 14 1 PAIR	FOOT	737	737			
* 830572	85 LIGHT POLE, WITH 15FT MA	WOOD, 50 FOOT, CLASS 3,	EACH	2				2									
									9	€ 87301805	ELECTRIC CABLE IN CONDUIT, SERVICE, NO. 6 2 C	FOOT	80	80			
* 8360020	DO LIGHT POLE F	OUNDATION, 24" DIAMETER	FOOT	63				63									
									, and the second	¥ 87301900	ELECTRIC CABLE IN CONDUIT, EQUIPMENT GROUNDING CONDUCTOR, NO. 6 IC	FOOT	1009	1009			
* 8380010	D5 BREAKAWAY DE	VICE, TRANSFORMER BASE, LT CIRCLE	EACH	7				7									
									9	€ 87502500	TRAFFIC SIGNAL POST, GALVANIZED STEEL 16 FT.	EACH	3	3			
* 841001	10 REMOVAL OF T	EMPORARY LIGHTING UNIT	EACH	2				2									
									9	₽ 87502520	TRAFFIC SIGNAL POST, GALVANIZED STEEL 18 FT.	EACH	1	1			
842005	00 REMOVAL OF I	LIGHTING UNIT, SALVAGE	EACH	9				9									
										* 87700160	STEEL MAST ARM ASSEMBLY AND POLE, 24 FT.	EACH	1	1			
842008	804 REMOVAL OF F	POLE FOUNDATION	EACH	9				9									
										* 87700190	STEEL MAST ARM ASSEMBLY AND POLE, 30 FT.	EACH	1	1			
845001	10 REMOVAL OF I	LIGHTING CONTROLLER	EACH	1				1									
										* 87800100	CONCRETE FOUNDATION, TYPE A	FOOT	16	16			
845001	20 REMOVAL OF E INSTALLATION	ELECTRIC SERVICE	ЕАСН	1				1									
									<u> </u>	* 87800150	CONCRETE FOUNDATION, TYPE C	FOOT	4	4			
845001		IGHTING CONTROLLER	EACH	1				1									
										* 87800400	CONCRETE FOUNDATION, TYPE E 30-INCH DIAMETER	FOOT	8.5	8.5			REV-SE
8500020	INSTALLATION		EACH	1			1										CIALTY ITEN
FILE NAME		USER NAME = hassann cuPents\IDOT Offices\District 1\Projects\P122112	DESIGNED - DRDDWNb\Design\P122	112-sht-S00.dgn	REVISED REVISED			S	TATE OF	ILLINOIS	JOLIET ROAD AND			F.A.U RTE. 3562	SECT		COUNTY TOTAL SHE SHEETS NO COOK 99 7
			CHECKED – DATE –		REVISED REVISED	-				RANSPORTA	TION SCALE: SHEET 4 OF 6	Y OF QUANT			·		ONTRACT NO. 60X

	SUMM	ARY OF QUANTITIES			С	ONSTRUCTIO	N TYPE CODE			SUMMA	RY OF QUANTITIES				СС	NSTRUCTIO	ON TYPE CO	DE
CODE NO		ITEM	UNIT	URBAN TOTAL 80% QUANTITIES 20% S 000	ED 80% FED	80% FED 20% STATE 0021 (INTERCONNECT)	LIGHTING & FIRE EVP HYDRANT 100% VILLAGE 0021 0043		CODE NO		ITEM	UNIT	URBAN TOTAL QUANTITIES	ROADWAY 80% FED 20% STATE 0004	SIGNAL 80% FED 20% STATE 0021	80% FED 20% STATE 0021 (INTERCONNECT)	LIGHTING & EVP 100% VILLAGE 0021	FIRE HYDRANT 100% VILLAGE 0043
* 87800415	CONCRETE FOUN DIAMETER	DATION, TYPE E 36-INCH	FOOT	4	4													
								*	< A2016616	TREE, QUERC	JS ELLIPSOIDALIS (HILL'S LIPER, BALLED AND BURLAPPED	EACH	5	5				
<b>*</b> 88030020	SIGNAL HEAD.	LED, 1-FACE, 3-SECTION, TED	EACH	4	4													
	MASI-ARM MOUN								<b>k</b> C2003248		MELIS VERNALIS (VERNAL WITCH HEIGHT, BALLED AND BURLAPPED	EACH	12	12				
<b>88030050</b>	SIGNAL_HEAD,_	LED, 1-FACE, 3-SECTION, ED	EACH	5	5					HAZEL/, 4	TEIGHT, BALLED AND BURLAFFED							
	BRACKET MOUNT	ED						*	¢ C2005724	SHRUB, RHUS	AROMATICA (FRAGRANT SUMAC),	EACH	60	60				
88102717	PEDESTRIAN SI	GNAL HEAD, LED, 1-FACE, ED WITH COUNTDOWN TIMER	ЕАСН	2	2					2' WIDTH, B	ALLED AND BURLAPPED							
*	BRACKET MOUNT	ED WITH COUNTDOWN TIMER							D2001772	EVERGREEN, F	ICEA ABIES (NORWAY SPRUCE).	ЕАСН	13	13				
* 88200410		L BACKPLATE. LOUVERED.	EACH	4	4					6' HEIGHT, E	ALLED AND BURLAPPED							
88200410	FORMED PLASTI								< коо29624	WEED CONTROL	ΤΕΛΟΕΙ	GALLON	0.5	0.5				
<b>*</b> 88500100	INDUCTIVE LOO		ЕАСН	4	4				K0023824		, TEASEL	GALLON	0.5	0.5				
* 88500100			EACH															
									X0301797	GATE REMOVAL		EACH	2	2				
* 88600100	DETECTOR LOOP	, TYPE I	FOOT	152	152													
									X0323716	ACCESS GATE.	DOUBLE, 30 FOOT	EACH	1	1				
* 88800100	PEDESTRIAN PU	SH-BUTTON	EACH	2	2													
								*	x0324085		HICLE PRIORITY SYSTEM LINE , NO. 20 3/C	FOOT	377				377	
* 89000100	TEMPORARY TRA	FFIC SIGNAL INSTALLATION	EACH	1	1													
								*	x0324599	ROD AND CLEA	N EXISTING CONDUIT	FOOT	200			200		
* 89501400		TING EMERGENCY VEHICLE EM, DETECTOR UNIT	EACH	2			2											
									x0325522	REINSTALLING ASSEMBLY	EXISTING STEEL GATE	EACH	2	2				
89501410		STING EMERGENCY VEHICLE TEM, PHASING UNIT	EACH	1			1			AUSEINDE I								
									X0327980		ING REMOVAL - WATER	SQ FT	3350	3350				
89502300		IC CABLE FROM CONDUIT	FOOT	1709		1709				BLASTING								
	I NEMOTE LECIT	TO ONDEE FROM COMPUTE						*	£ X1400081	FULL-ACTUATE P CABINET (S	D CONTROLLER AND TYPE SUPER	ЕАСН	1		1			
89502375	REMOVE EXISTI EQUIPMENT	NG TRAFFIC SIGNAL												<u> </u>				
03302375			EACH		1			*	¢ X1400150	SERVICE INST.	ALLATION, GROUND MOUNTED,	ЕАСН	1		1			
										METERED								
89502380	REMOVE EXIST	ING HANDHOLE	EACH	9	9				X4022000	TEMPORARY ACC	ESS (COMMERCIAL ENTRANCE)	ЕАСН	3	3				
														-				
89502382	REMOVE EXIST	ING DOUBLE HANDHOLE	EACH	1	1				x5164000		IN ROCK (SPECIAL)	CU YD	2.1		2.1			
									AJ104000	DNILLED SHAF	IN NUCK (SFECIAL)		<i>2.1</i>		<b>2.</b> 1			REV-SE
89502385	REMOVE EXIST	ING CONCRETE FOUNDATION	EACH	5	5												· · · · · · · · · · · · · · · · · · ·	
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1		PLOT SCALE = 100.0000 ' / in. PLOT DATE = 3/23/2020	CHECKED -	REVI	ED -		DEPARTME	NT OF TR	ANSPORTA	TION	SUMMARY	OF QUANT	IIEƏ					CONTRACT NO. 60X

	SUMMARY OF QUANTITIES		URBAN				N TYPE CO		 	SUM	MARY OF QUANTITI	ES
CODE NO	ITEM	UNIT	TOTAL QUANTITIES	ROADWAY 80% FED 20% STATE 0004	SIGNAL 80% FED 20% STATE 0021	80% FED 20% STATE 0021 (INTERCONNECT)	EVP	HYDRANT 100% VILLAGE 0043	CODE NO		ITEM	UNI
(7010216	TRAFFIC CONTROL AND PROTECTION, (SPECIAL)	L SUM	1	1								
x7030005	TEMPORARY PAVEMENT MARKING REMOVAL	SO FT	9500	9500								
x7040125	PINNING TEMPORARY CONCRETE BARRIER	ЕАСН	462	462								
x8100105	CONDUIT SPLICE	ЕАСН	1			1						
x8210040	TEMPORARY LUMINAIRE, HIGH PRESSURE SODIUM VAPOR. HORIZONTAL MOUNT. 400 WATT_	ЕАСН	2				2					
x8620200	UNINTERRUPTABLE POWER SUPPLY, SPECIAL	EACH	1		1							
x8710024	FIBER OPTIC CABLE IN CONDUIT, NO. 62.5/125, MM12F SM24F	FOOT	2266			2266						
Z0013798	CONSTRUCTION LAYOUT	L SUM	1	1								
Z0030850	TEMPORARY INFORMATION SIGNING	S0 FT	51.4	51.4								
Z0033020	LUMINAIRE SAFETY CABLE ASSEMBLY	ЕАСН	13				13					
20033028	MAINTENANCE OF LIGHTING SYSTEM	CAL MO	6				6					
Z0033044	RE-OPTIMIZE TRAFFIC SIGNAL SYSTEM LEVEL1	EACH	1			1						
Z0062456	TEMPORARY PAVEMENT	SO YD	100	100								
Z0073510	TEMPORARY TRAFFIC SIGNAL TIMING	EACH	1		1							
Z0076600	TRAINEES	HOUR	1000	1000								
Z0076604	TRAINEES - TRAINING PROGRAM GRADUATE	HOUR	1000	1000								
	PLOT SCALE = 100.0000 ' / in. C	RAWN - HECKED - ATE -		REVISED REVISED REVISED REVISED	-	 	D		ILLINOIS TRANSPORTAT	TION		OAD AND 55TH STR SUMMARY OF QUA 6 OF 6 SHEETS

				СО	NSTRUCTIO	N TYPE	CO	DE	
NIT	URBAN TOTAL QUANTITIES	20% JIAIL	20%		80% FED 20% STATE 0021	LIGHTIN EVP	G&	FIRE HYDRANT 100% VILLAGE 0043	
		0004			(INTERCONNECT)				
									<b>Ø</b> 0042
								Í	REV-SEP
TD	INITERATOR			F.A.U.	SECT		SP		Y ITEM
TREET	INTERSECTI FIES	UN		RTE. 3562	(430-			СООК	99 9
S  STA.		TO STA.		L	1	ILLINOIS   FI	ED. AID	CONTRACT N PROJECT	10. 60x71



REVISED

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PLOT DATE = 3/23/2020

DATE

(7) PIPE UNDERDRAIN 4" (TO CONNECT TO DRAINAGE STRUCTURE)

SCALE: NONE

SHEET


OF

SHEET

NTS		QUALITY
	VOIDS © Ndes	MANAGEMENT PROGRAM (QMP)
	-	-
MATRIX ASPHALT, 9.5,	3.5% AT 80 GYR.	QC⁄QA
N90 - 2 1/4''	4% AT 90 GYR.	0C⁄0A
,	4% AT 90 GYR.	QCP
	4% AT 70 GYR.	QC/QA
	4% AT 50 GYR.	0C/0A
	4% AT 50 GYR.	0C/0A

OF THE STANDARD SPECIFICATIONS; THICKNESS SHALL BE 9". TEMP PCC PAVEMENT DOES NOT REQUIRE DOWEL BARS.

s :	SECTIONS		F.A.U. RTE.	SECTION	COUNTY	SHEET NO.						
5	5th STREET	r	3562	(430V-X)N	СООК	99	10					
				CONTRACT NO. 60X71								
TS STA. TO STA. ILLINOIS FED. AID PROJECT												

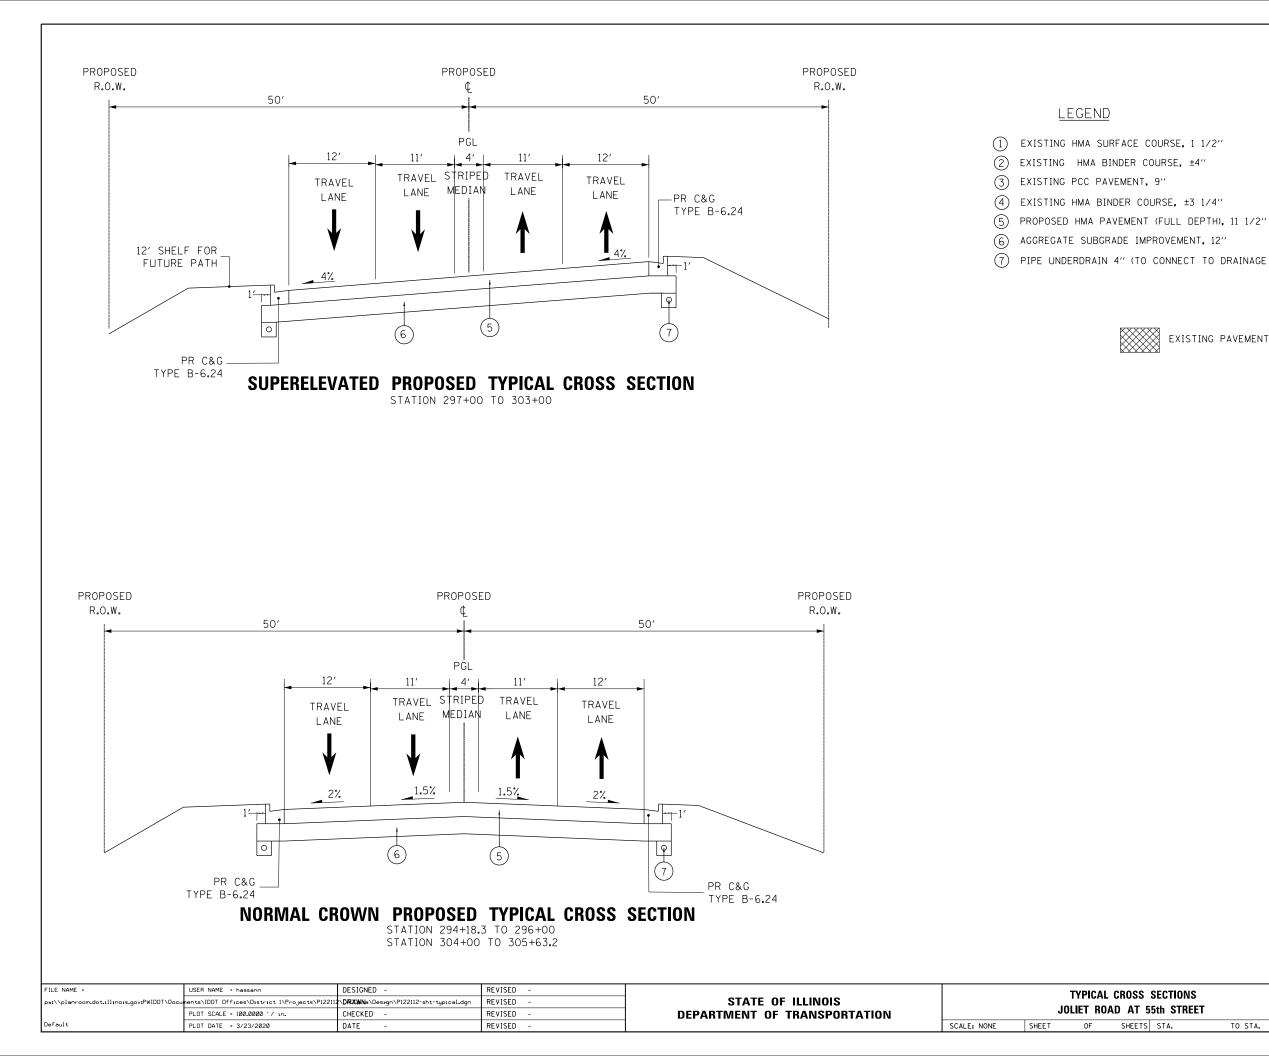

(7) PIPE UNDERDRAIN 4" (TO CONNECT TO DRAINAGE STRUCTURE)



EXISTING PAVEMENT TO BE REMOVED

S.	SECTIONS		F.A.U. RTE.	SECTION	COUNTY	TOTAL SHEETS	SHEET NO.	
55th STREET				(430V-X)N	СООК	99	11	
				CONTRACT NO. 60X71				
TS	STA.	TO STA.		ILLINOIS FED. AI	D PROJECT			

			EARTH	WORK SCH	IEDUI	.E		
JOLIET ROAD AT 55TH STREET	EARTH EXCAVATION (CU. YD.)	TOP SOIL EXCAVATION (CU. YD.)	USED AS TOP SOIL (SHRINKAGE 15%) (CU. YD.)	EXCAVATION USED AS EMBANKMENT (SHRINKAGE 15%) (CU. YD.)	EMBANKMENT (CU. YD.)	TOP SOIL PLACEMENT (CU. YD.)	EARTH WORK BALANCE SURPLUS (+) OR SHORTAGE (-) (CU. YD.)	TOP SOIL BALANCE SURPLUS (+) OR SHORTAGE (-) (CU. YD.)
STAGE I	692.60	845.55	718.72	588.71	803.69	412.57	-214.99	+306.15
STAGE II	244.40	53.35	45.35	207.74	1369.43	520.23	-1161.69	-474.88
TOTAL	936.99	898.90	764.07	796.44	2173.12	932.80	-1376.68	-168.73

<b>PIPE UNDERDRAINS</b>
-------------------------

INSTALL LOCATIONS	OFFSET/SIDE (FEET)				
STA. 294+18.3 TO STA. 305+63.2	± 25′ LT				
STA. 294+18.3 TO STA. 305+63.2	± 25′ RT				

NOTES:

1. "TOPSOIL EXCAVATION AND PLACEMENT" WILL BE MEASURED FOR PAYMENT BASED ON THE TOTAL VOLUME OF TOPSOIL EXCAVATED. THE CONTRACTOR IS RESPONSIBLE FOR THE REMOVAL AND PROPER DISPOSAL OF THE WASTE TOPSOIL FROM THE PROJECT SITE. THIS WORK, IN ACCORDANCE WITH THE STANDARD SPECIFICATION, IS INCLUDED IN THE PAY ITEM "TOPSOIL EXCAVATION AND PLACEMENT." 2. THE ROADWAY GEOTECHNICAL REPORT HAS IDENTIFIED NO POOR/SOFT SOILS FOR REMOVAL WITHIN THE LIMITS OF CONTRACT 60X71, WITH THE EXCEPTION OF THE AREA OF CONTRACTOR DESIGNED GROUND IMPROVEMENT.

THE FOLLOWING PAY ITEMS AND QUANTITIES HAVE BEEN PROVIDED IN THE CONTRACT FOR USE AS DETERMINED BY THE ENGINEER IF POOR /SOFT SOILS ARE IDENTIFIED DURING CONSTRUCTION:


20201200: "REMOVAL AND DISPOSAL OF UNSUITABLE MATERIAL" - 400 CY 30300001: "AGGREGATE SUBGRADE IMPROVEMENT" - 400 CY 21001000: "GEOTECHNICAL FABRIC FOR GROUND STABILIZATION" - 1,100 SY

3. THE QUANTITY OF PAY ITEM 66900200: "NON-SPECIAL WASTE DISPOSAL" WILL REDUCE THE AMOUNT OF AVALIABLE EMBANKMENT MATERIALS. THE QUANTITY OF FURNISHED EXCAVATION HAS BEEN ADJUSTED TO REFLECT THIS.


PAY ITEM NO: 20400800: "FURNISHED EXCAVATION" QUANTITY WILL BE INCREASED BY THE QUANTITY OF PAY ITEM 66900200: "NON-SPECIAL WASTE DISPOSAL" WHICH IS 335 CY.


1,377 CY OF "FURNISHED EXCAVATION" +335 CY OF "NON-SPECIAL WASTE DISPOSAL = 1,712 CY OF "FURNISHED EXCAVATION"

USER NAME = hassann	DESIGNED -	REVISED -			JO	LIET ROA	D AT 5	5TH STREET		F.A.U. RTE	SECTION	COUNTY	TOTAL SHEETS	SHEET NO.
	DRAWN -	REVISED -	STATE OF ILLINOIS		SCHEDULE OF QUANTITIES				3562	(430-X)N	СООК	99	12	
PLOT SCALE = 100.0000 / in.	CHECKED -	REVISED -	DEPARTMENT OF TRANSPORTATION	SCHEDULE OF QUANTITIES					CONTRACT	T NO. 6	0X71			
PLOT DATE = 3/23/2020	DATE -	REVISED -		SCALE:	SHEET	OF	SHEETS	STA.	TO STA.		ILLINOIS FED.	AID PROJECT		

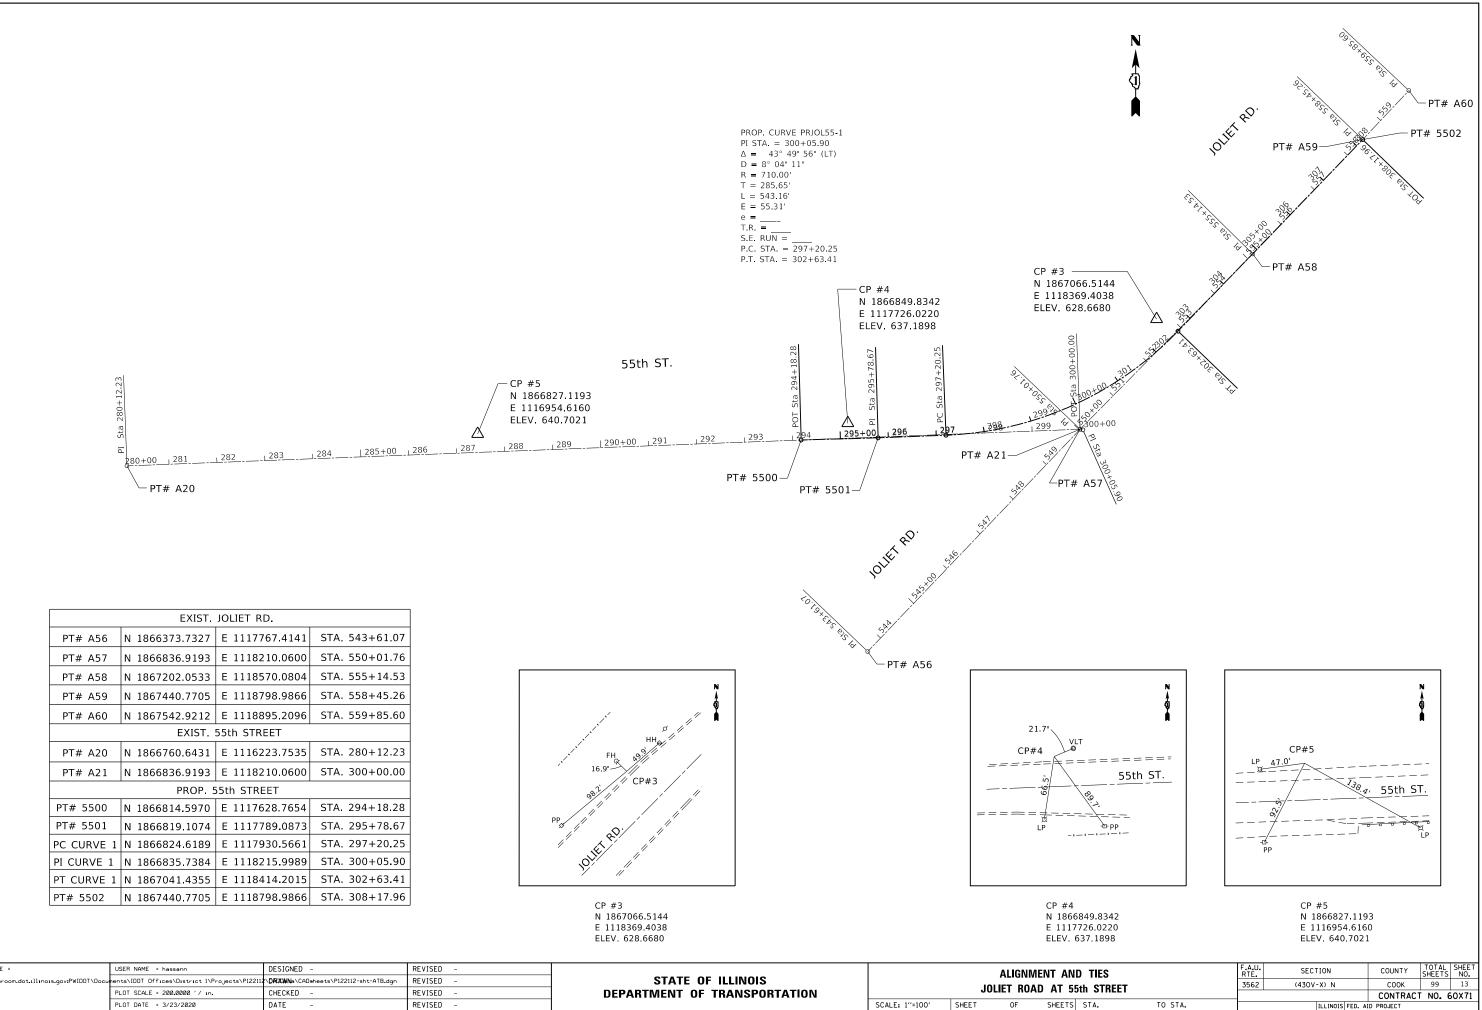

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	PLOT SCALE = 200.0000 ' / in.	CHECKED -	REVISED -	DEPARTMENT OF TRANSPORTATION		JUL	LIET ROA	U AI
Default	PLOT DATE = 3/23/2020	DATE -	REVISED -		SCALE: 1"=100"	SHEET	OF	SHEE

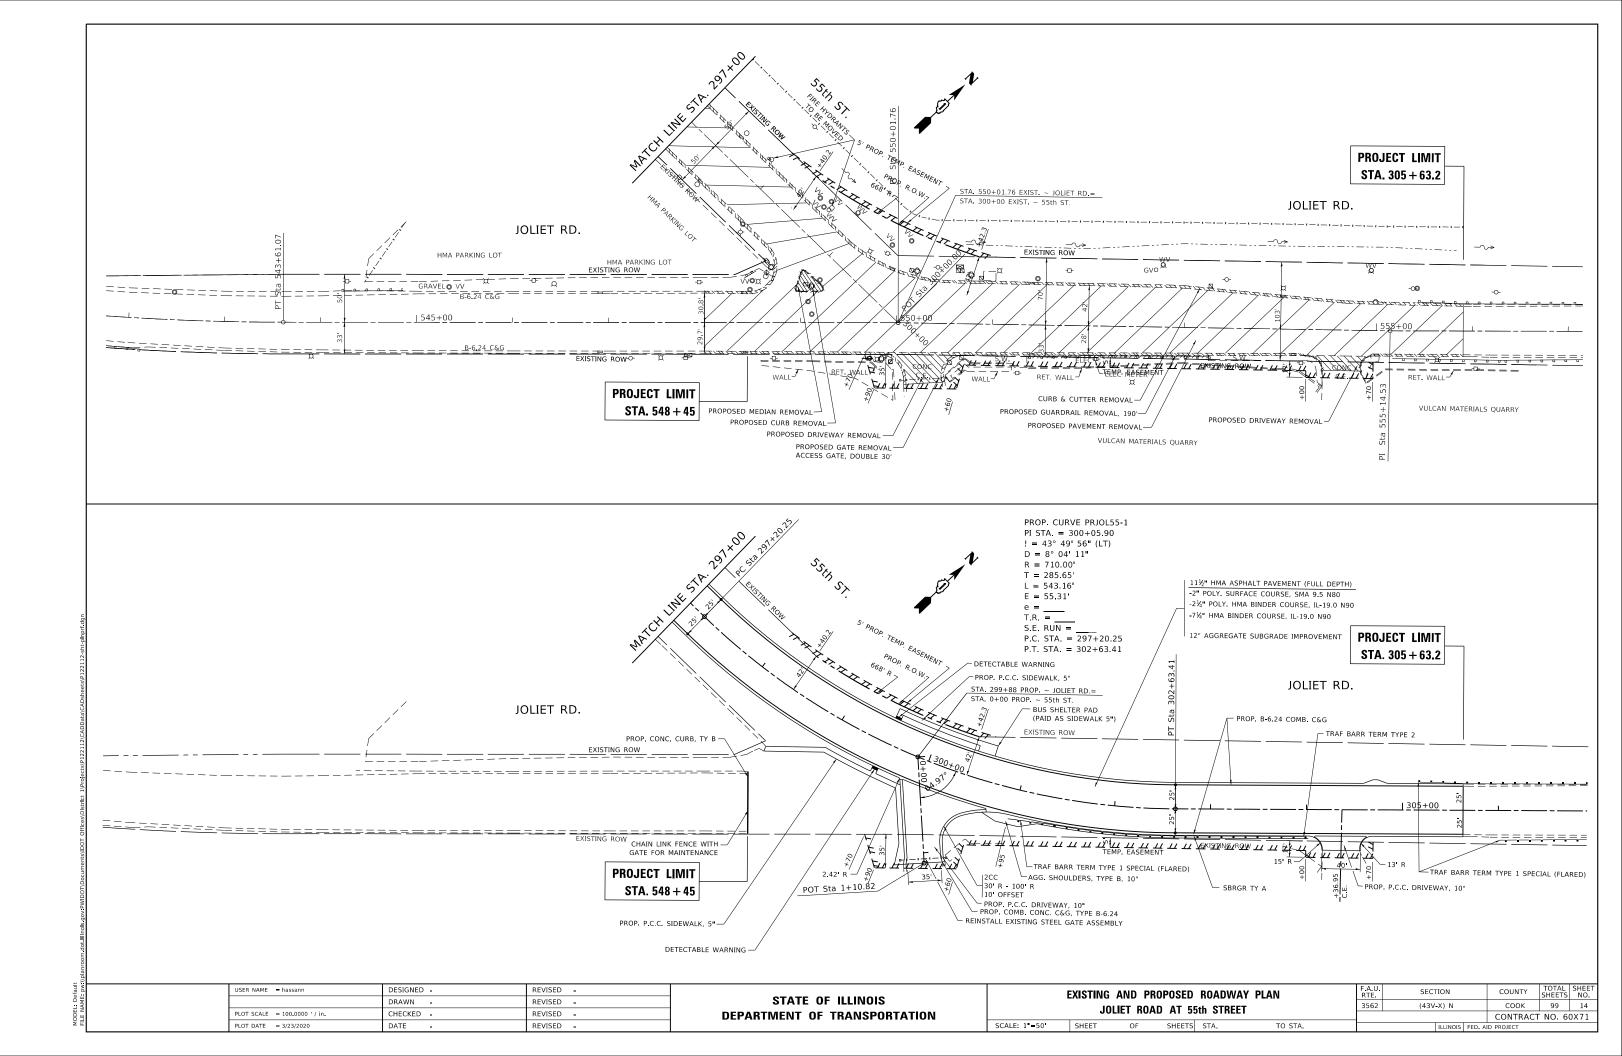

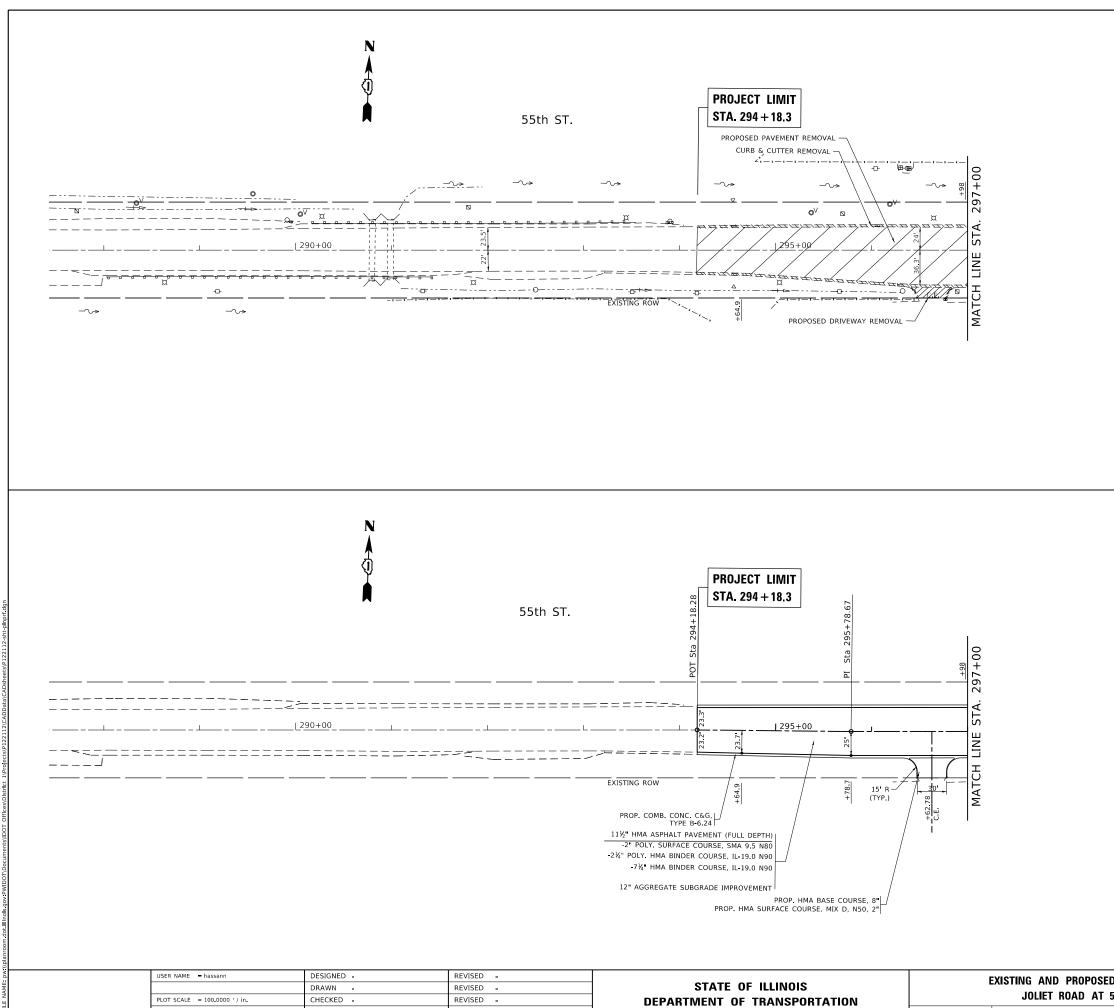

REVISED -

PLOT DATE = 3/23/2020

DATE


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SCALE: 1"=50'	SHEET	OF	SHEET

Đ	ROADWA	AY PLAN	F.A.U. RTE	SECTION			COUNTY	TOTAL SHEETS	SHEET NO.		
6.F	ith STREE	т	3562	(43V	-X) N	СООК 99 15					
J.		• 1		CONTRACT NO. 60X71							
ΤS	STA.	TO STA.			ILLINOIS	FED. AI	D PROJECT				

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3%	POSEI 55th EXIS	TING I 55th	ROAD	WAY F		E		+90.00 EL. 626.78		-2.00		ELEVATION 625.06			+60.00 EL. 628.86		
630.86	9 2+00	628.75	629.62		00+	627.08	627.59		00+ 626.60	625.96	626.25		00+	628.58	628.43	900 630.54	+00
			REET		TO 5 <sup>-</sup>	ГА.			A.U. TE. 562		SECT (43V-		FED. A	C CON		TOT/ SHEE 99 T NO.	



	LEGEND
1	TEMPORARY TAPE TYPE IV (DOUBLE YELLOW)
2	TEMPORARY TAPE TYPE IV (WHITE)
3	TEMPORARY CONCRETE BARRIER (PINNED)
4	FULL DEPTH TEMPORARY PAVEMENT (SEE NOTES)
$\frown$	

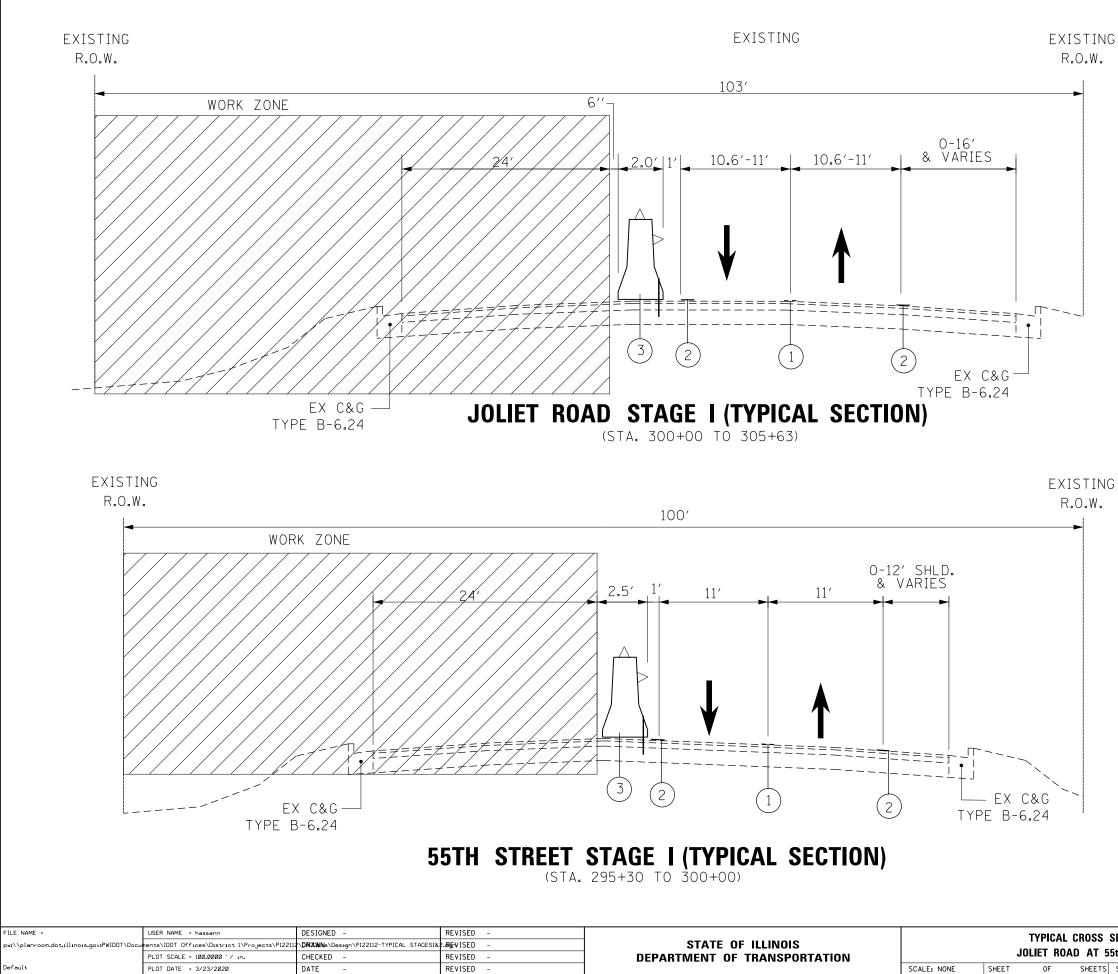(5) 2" POLY HMA SURFACE COURSE, SMA, 9.5, N80

- 6 2 1/4" POLY. HMA BINDER COURSE, IL-19, N90
- 7 1/4 HMA BINDER COURSE, IL-19.0, N90 (7)

#### NOTES

FULL DEPTH TEMPORARY PAVEMENT


OPTION 1:

11" HMA BINDER COURSE, IL-19.0, N70 4" SUBBASE GRANULAR MATERIAL TYPE B (CA-6)

OPTION 2: 9" TEMPORARY PCC PAVEMENT 4" SUBBASE GRANULAR MATERIAL TYPE B (CA-6)

\*CONTRACTOR SHALL BACKFILL ALL EXCAVATED SITES FLUSH TO GRADE BEFORE ENDING WORKDAY.

SECTIONS		F.A.U. RTE.	SECTION	COUNTY	TOTAL SHEETS	SHEET NO.
55th STREE	т	3562	(430V-X)N	СООК	99	17
JJUI JINEL				CONTRACT	NO. 6	50X71
S STA.	TO STA.		ILLINOIS FED. AI	ID PROJECT		

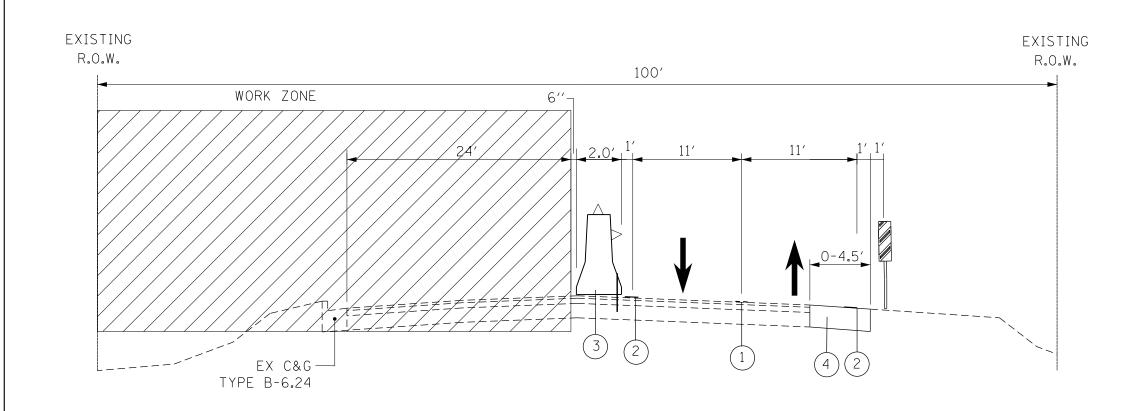

# **55TH STREET STAGE I (TYPICAL SECTION)**

(STA. 292+68 TO 295+30)

<u>NOTES</u>

- FULL DEPTH TEMPORARY PAVEMENT

– OPTION 1:

11" HMA BINDER COURSE, IL-19.0, N70 4" SUBBASE GRANULAR MATERIAL TYPE B (CA-6)

– OPTION 2:

9" TEMPORARY PCC PAVEMENT 4" SUBBASE GRANULAR MATERIAL TYPE B (CA-6)


4 SOBBASE GRANOLAR MATERIAL TITE B (CA-0)

- CONTRACTOR SHALL BACKFILL ALL EXCAVATED SITES FLUSH TO GRADE BEFORE ENDING WORKDAY

SITES FLUSH TO GRAL	DE BEFORE ENDING WORKDAY													
FILE NAME =	USER NAME = hassann	DESIGNED -	REVISED -				TYPICA	L CROSS SECTIONS		F.A.U. RTF.	SECTION	COUNTY	TOTAL SHEETS	SHEET NO.
pw://planroom.dot.illinois.gov:PWIDOT/Doc	cuments\IDOT_Offices\District_I\Projects\P1221	2\ <b>DRXWN</b> =\Design\P122112-TYPICAL_STAGE	sı& <b>≥.64g⊟</b> vISED –	STATE OF ILLINOIS						3562	(430V-X)N	СООК	99	18
	PLOT SCALE = 100.0000 ' / in.	CHECKED -	REVISED -	DEPARTMENT OF TRANSPORTATION		J	ULIET KU	OAD AT 55th STREET				CONTRAC	T NO. 60	JX71
Default	PLOT DATE = 3/23/2020	DATE -	REVISED -		SCALE: NONE	SHEET	OF	SHEETS STA.	TO STA.		ILLINOIS FED.	AID PROJECT		


- 6 2 1/4" POLY. HMA BINDER COURSE, IL-19, N90
   7 7 1/4 HMA BINDER COURSE, IL-19.0, N90
- 5 2" POLY HMA SURFACE COURSE, SMA, 9.5, N80
- (4) FULL DEPTH TEMPORARY PAVEMENT (SEE NOTES)
- 3 TEMPORARY CONCRETE BARRIER (PINNED)
- 2 TEMPORARY TAPE TYPE IV (WHITE)
- 1) TEMPORARY TAPE TYPE IV (DOUBLE YELLOW)

<u>legend</u>

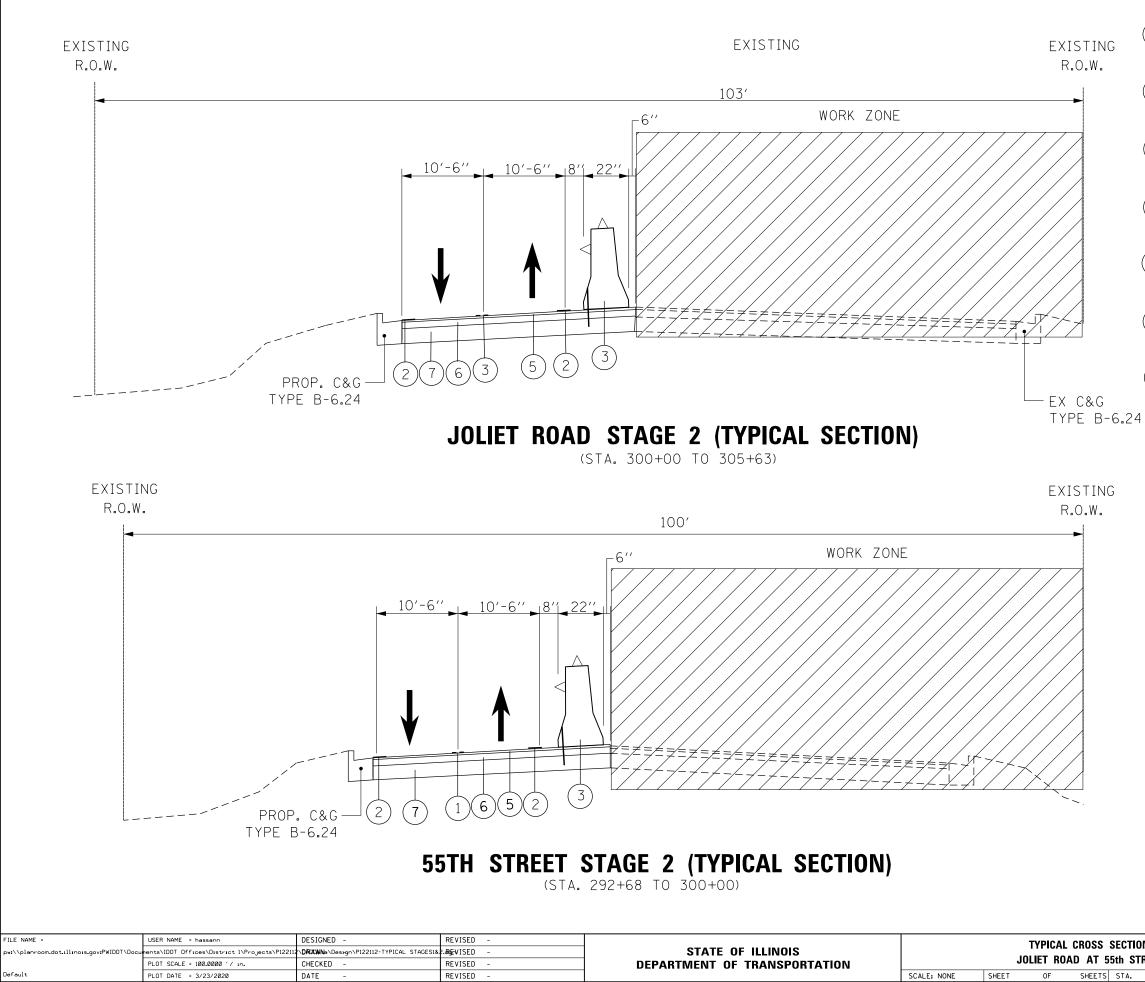


5	1	<u>LEGEND</u> TEMPORARY TAPE TYPE IV (DOUBLE YELLOW)
	2	TEMPORARY TAPE TYPE IV (WHITE)
	3	TEMPORARY CONCRETE BARRIER (PINNED)
	4	FULL DEPTH TEMPORARY PAVEMENT (SEE NOTES)
	5	2″ POLY HMA SURFACE COURSE, SMA, 9.5, N80
	6	2 1/4" POLY. HMA BINDER COURSE, IL-19, N90
	(7)	7 1/4 HMA BINDER COURSE, IL-19.0, N90


S.	SECTIONS		F.A.U. RTE.	SECTION	COUNTY	TOTAL SHEETS	SHEET NO.
5	5th STREET		3562	(430V-X)N	СООК	99	19
3					CONTRAC	T NO. 6	50X71
٢S	STA.	TO STA.		ILLINOIS FED. A	D PROJECT		

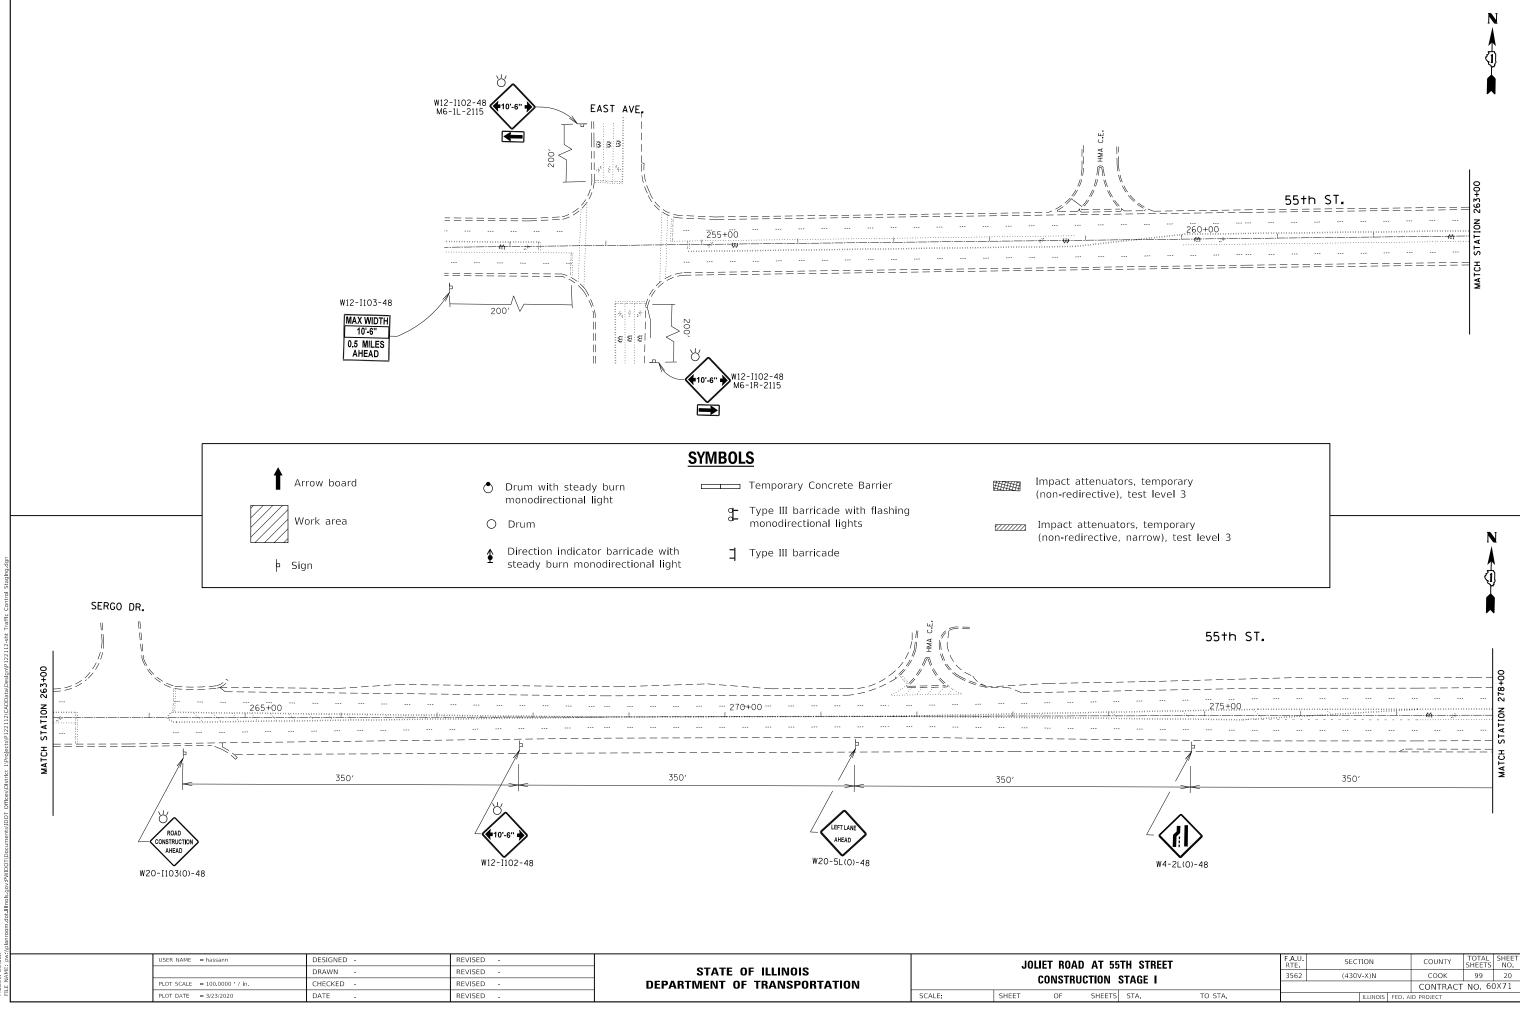


55	TH STREET		F.A.U. RTE	SECT	FION		COUNTY	TOTAL SHEETS	SHEET NO.
	STAGE I		3562	(430\	/-X)N		СООК	99	20
							CONTRACT	NO. 60	DX71
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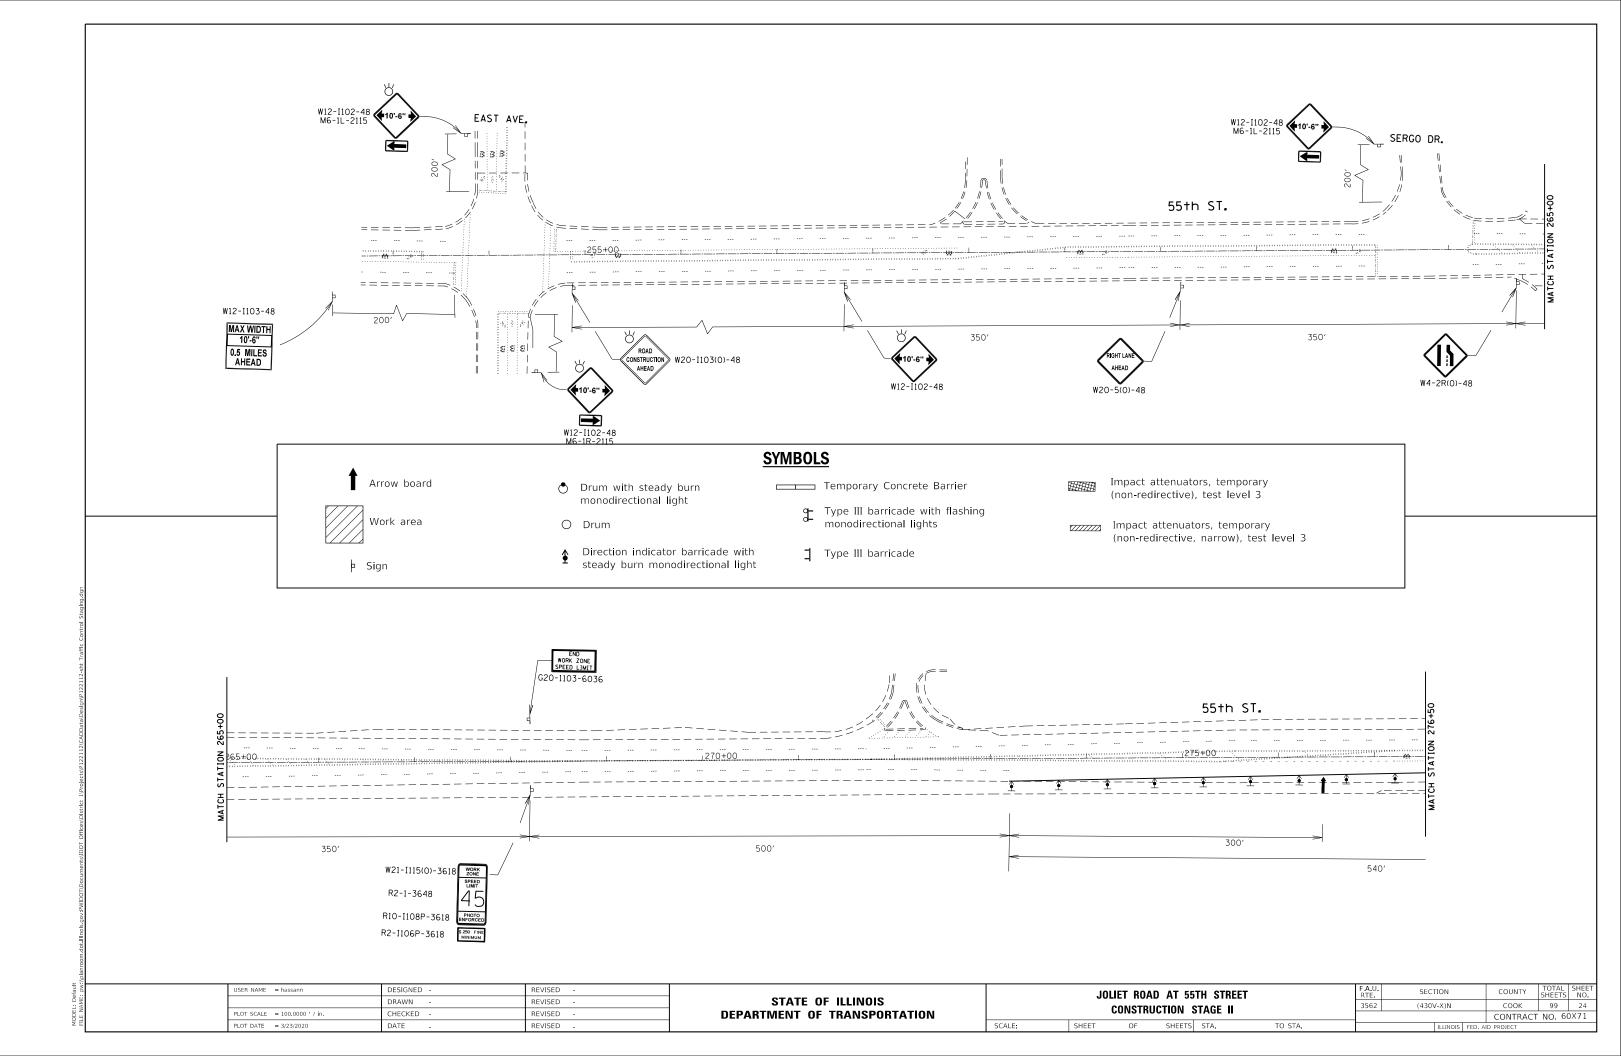


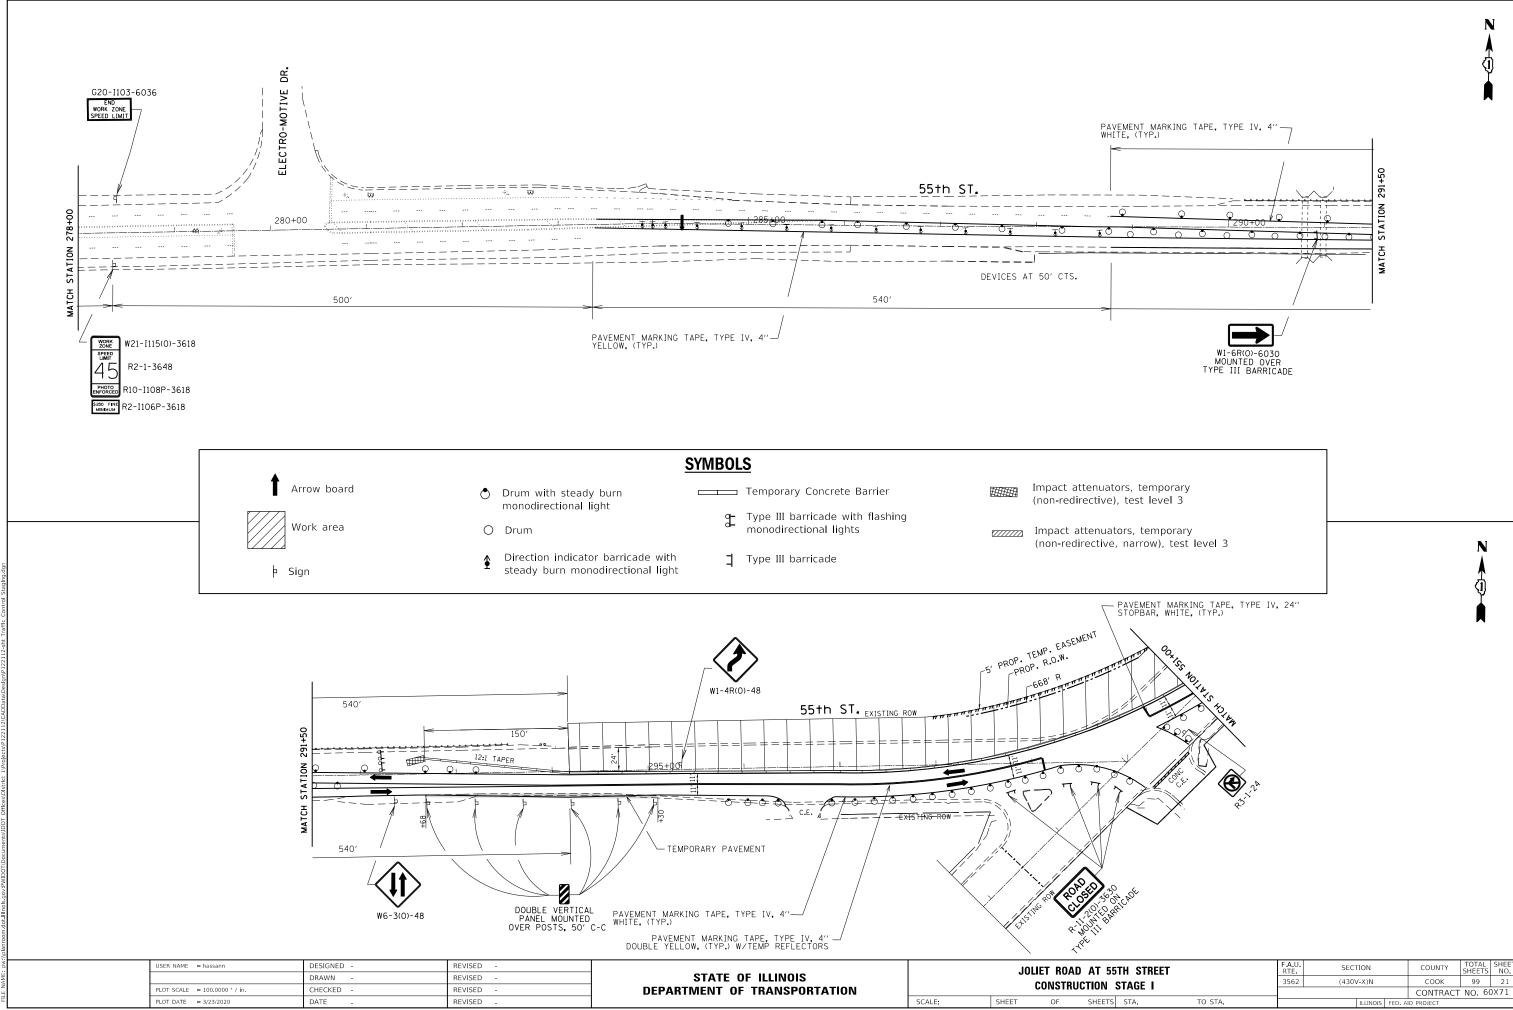
55	TH STREET		F.A.U. RTE	SECT	ION		COUNTY	TOTAL SHEETS	SHEET NO.
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							CONTRACT	NO. 60	)X71
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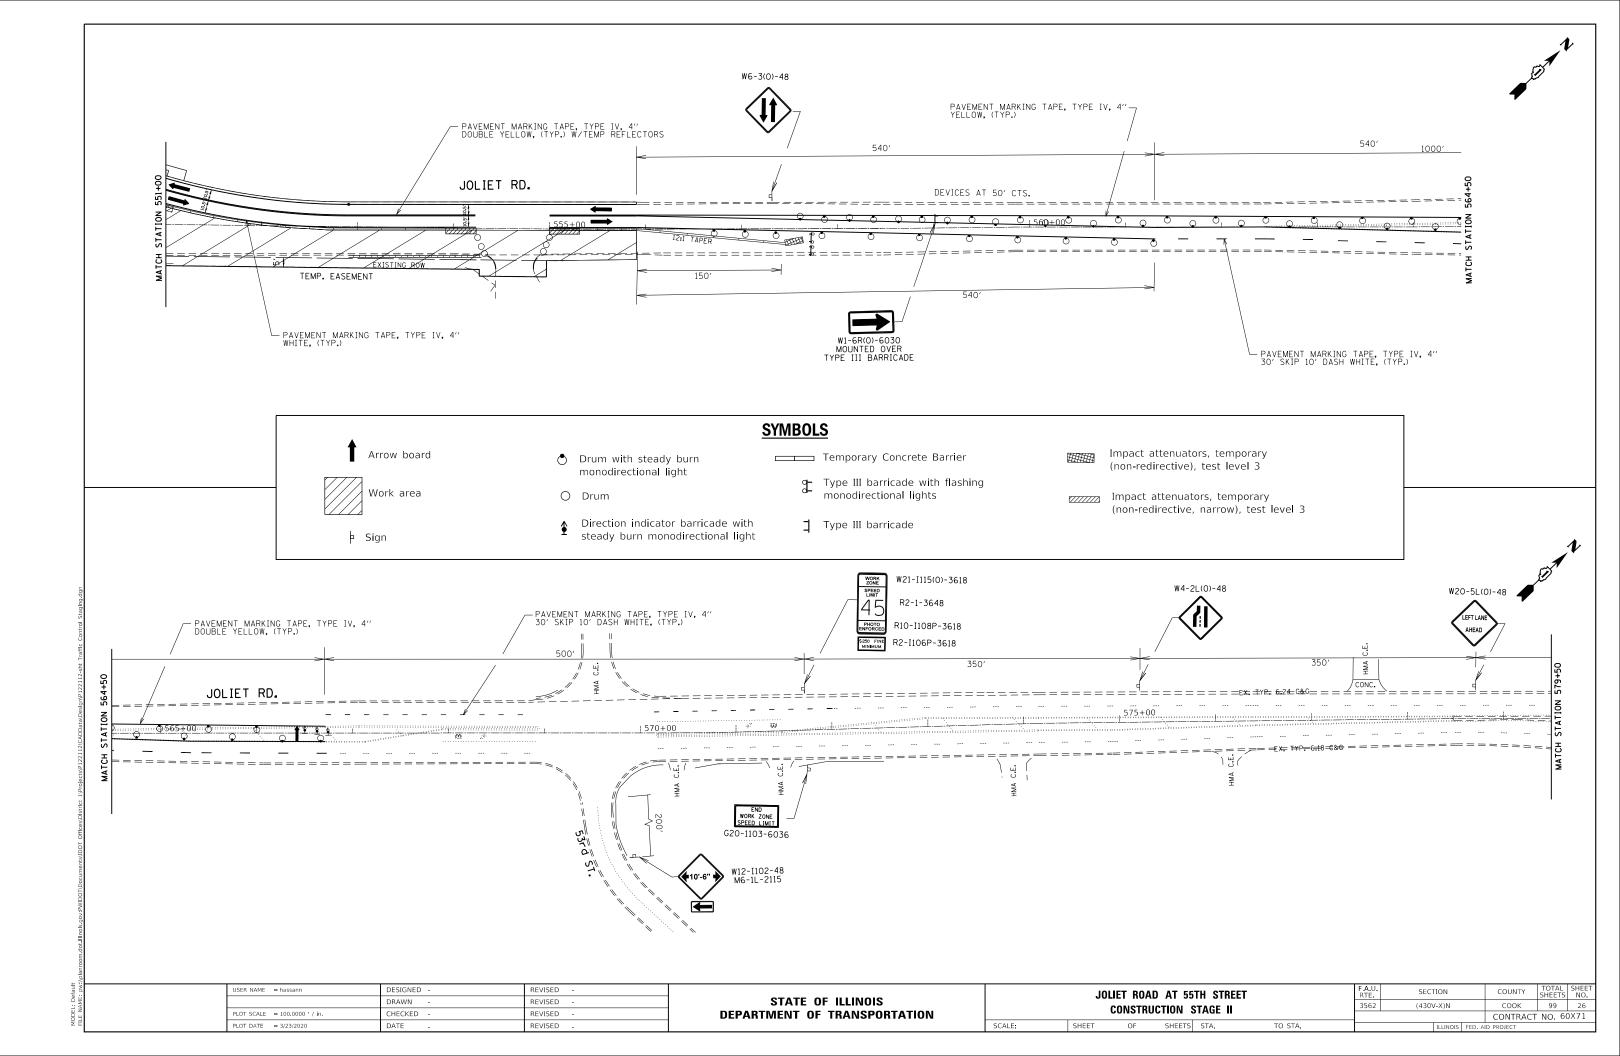


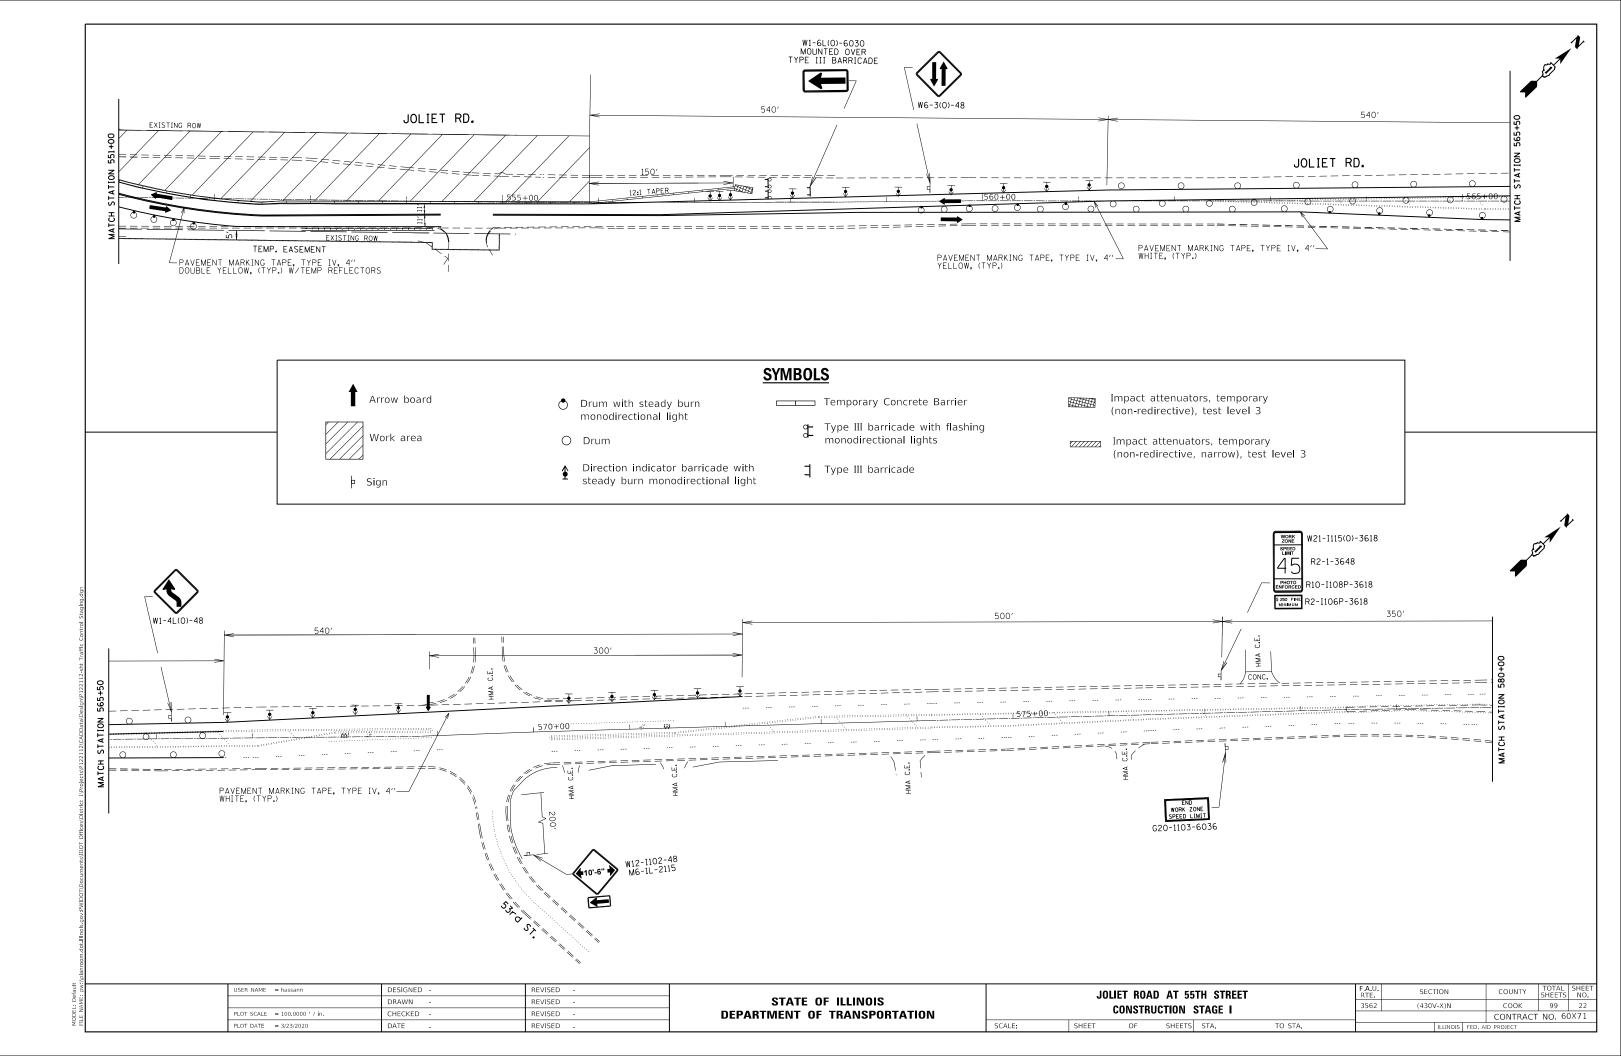


55	TH STREET		F.A.U. RTE	SECT	ION		COUNTY	TOTAL SHEETS	SHEET NO.
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							CONTRACT	NO. 60	)X71
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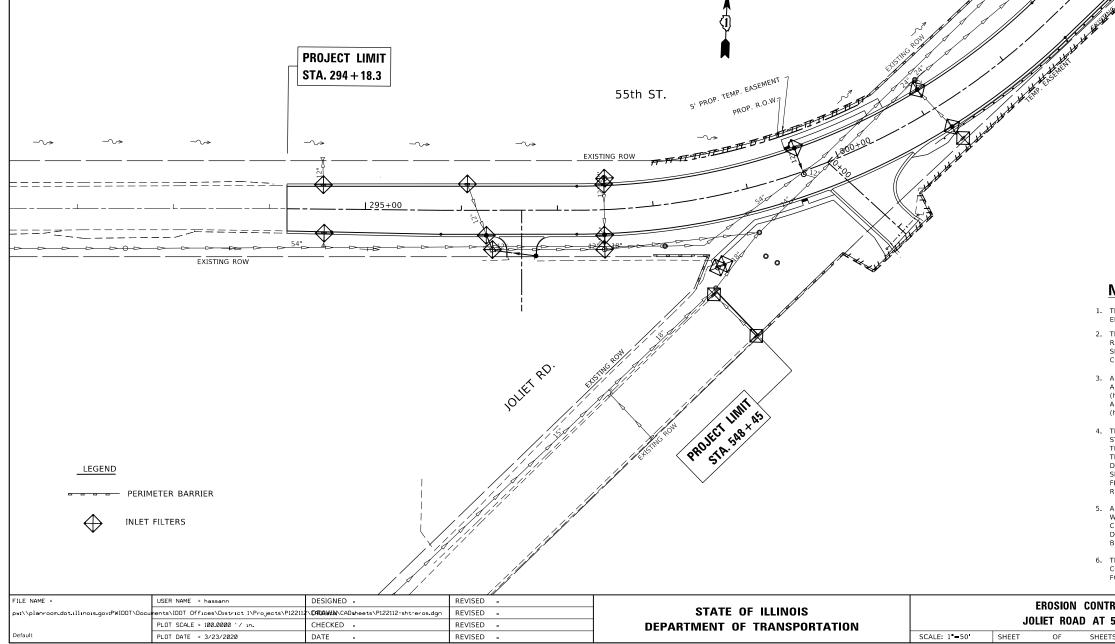


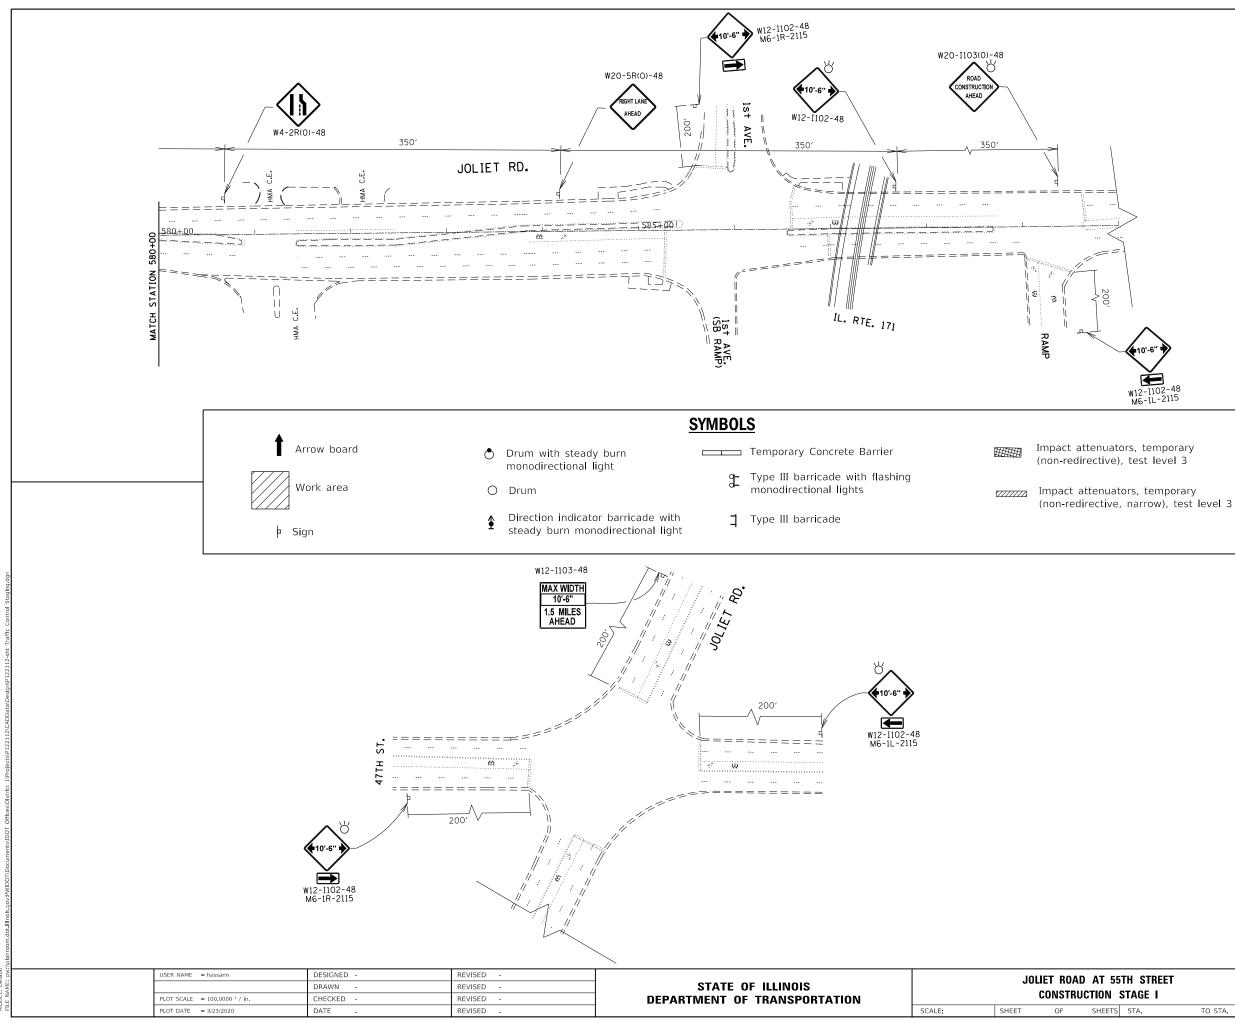


55	TH STREET		F.A.U. RTE	SECT	ΠΟΝ		COUNTY	TOTAL SHEETS	SHEET NO.
	STAGE II		3562	(430\	/-X)N		СООК	99	27
							CONTRACT	NO. 60	)X71
ΤS	STA.	TO STA.			ILLINOIS	FED, AI	D PROJECT		
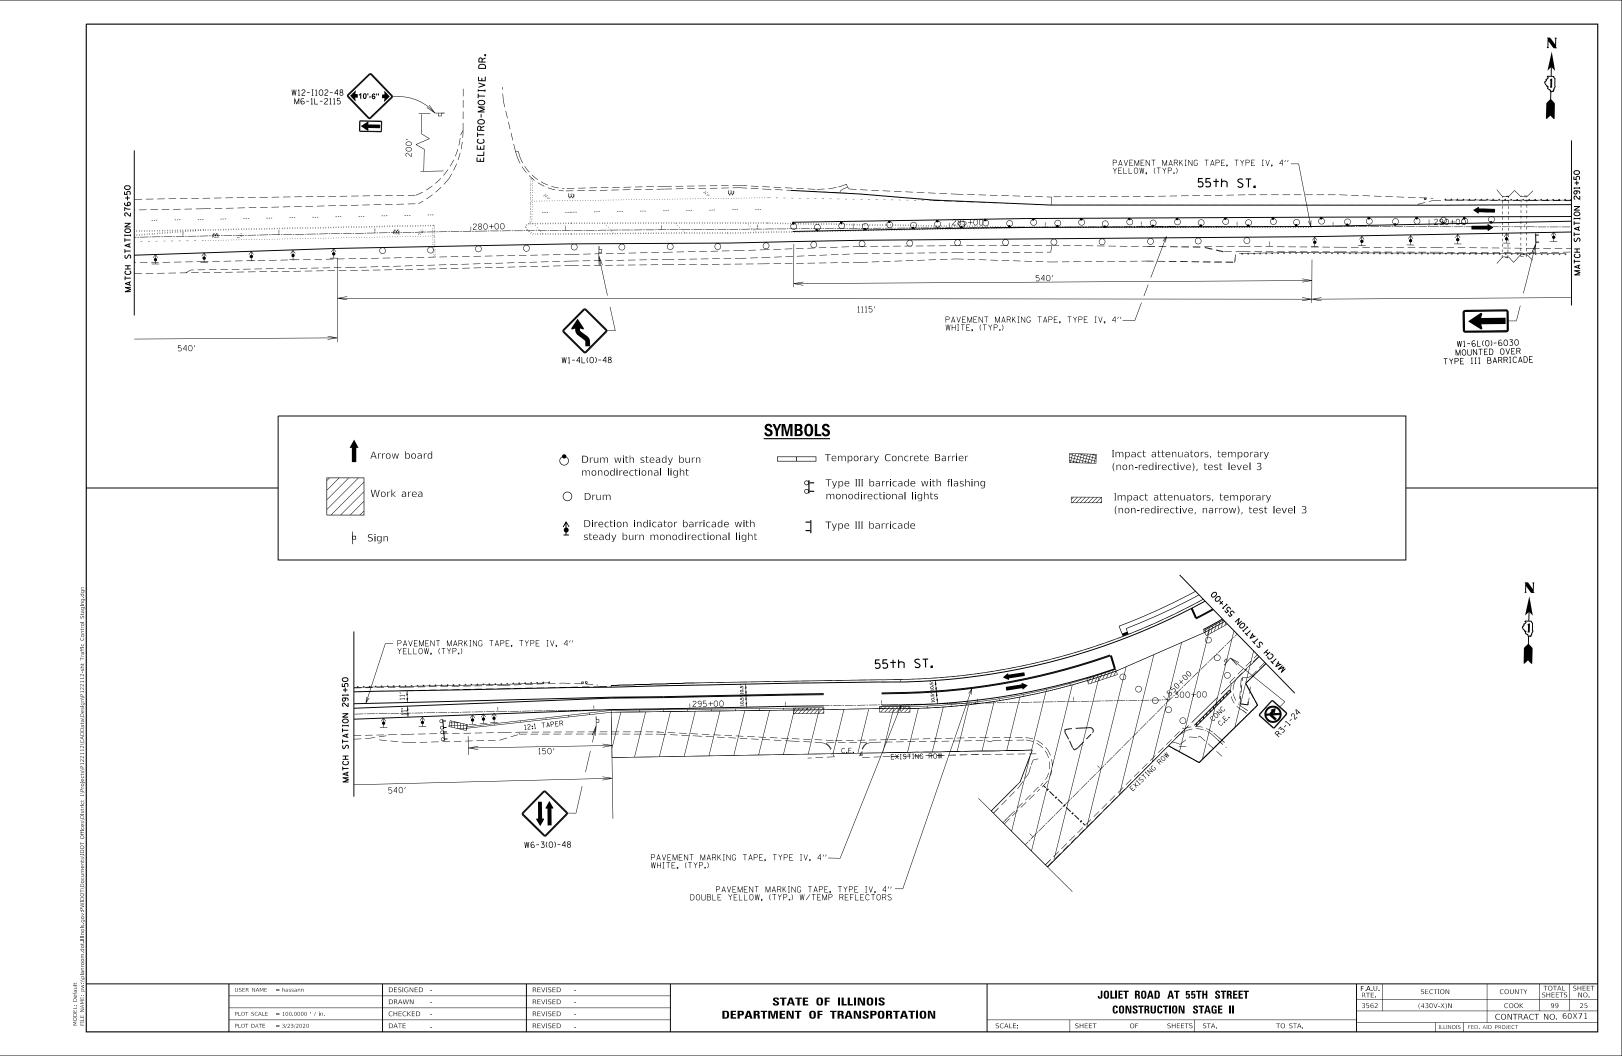
#### NOTES

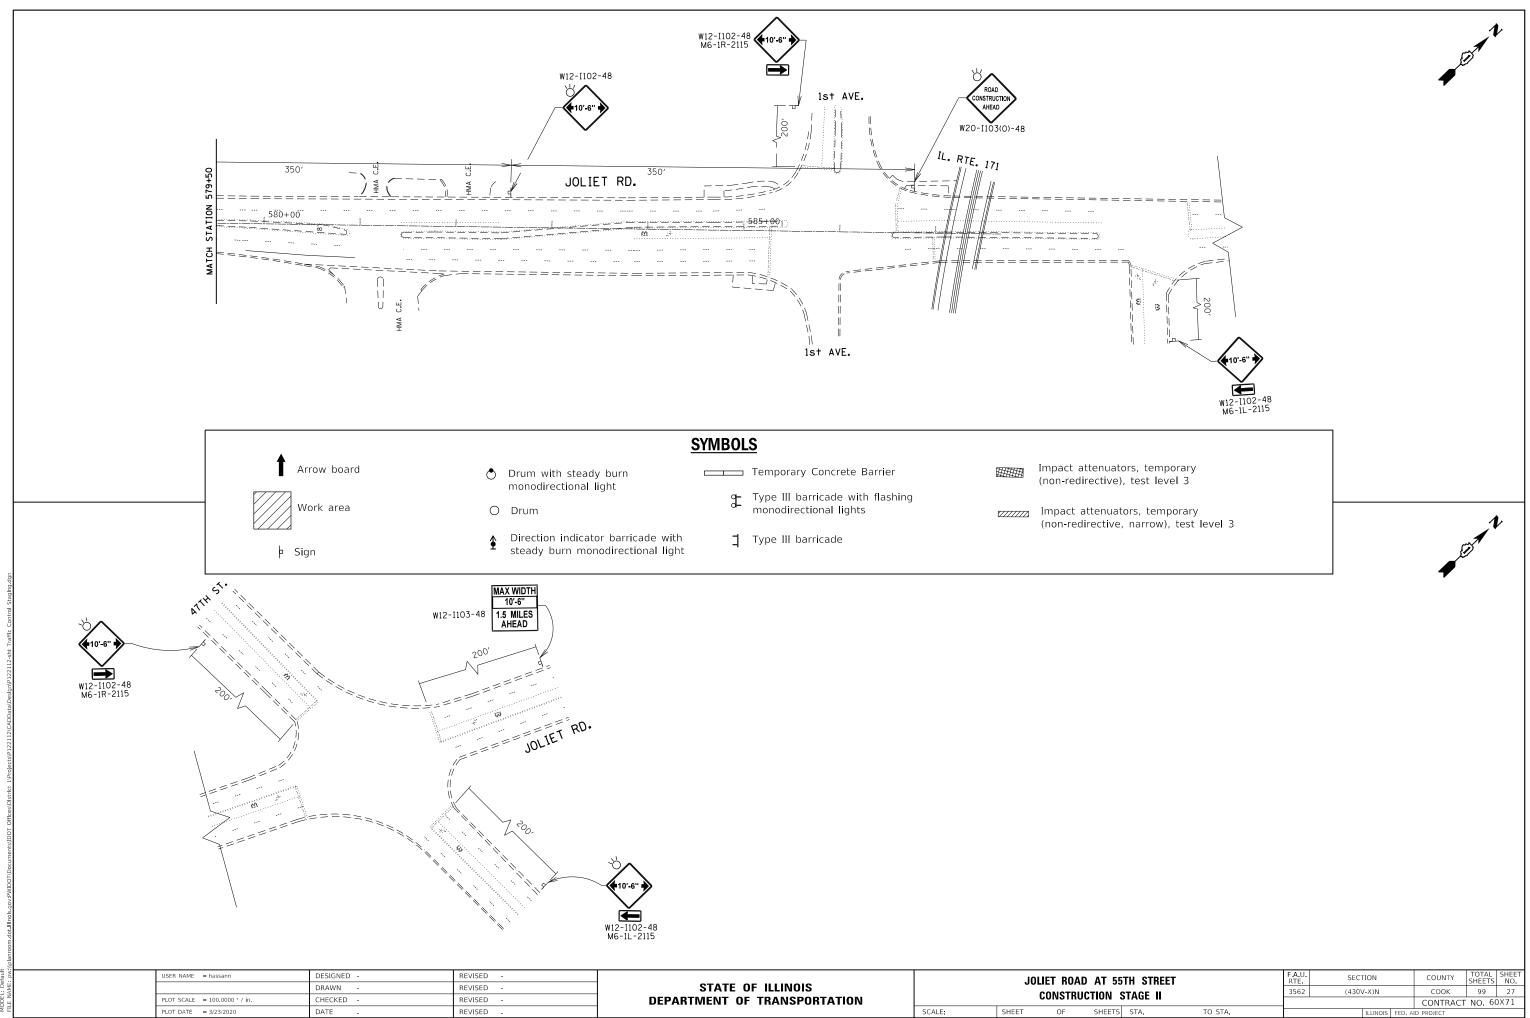- 1. TEMPORARY EROSION CONTROL SEEDING TO BE PROVIDED AT ALL ERODIBLE BARE EARTH AREAS, REFER TO SPECIAL PROVISIONS.
- 2. NPDES PERMIT IS REQUIRED FOR THE PROJECT.
- THE CONTRACTORS SHALL PROVIDE & MAINTAIN INLET PROTECTION AT ALL PROPOSED DRAINAGE STRUCTURES AND AT OTHER LOCATIONS DIRECTED BY THE ENGINEER AND/OR SHOWN ON THE PLANS. INLET PROTECTION SHALL BE PLACED BEFORE THE AREA INVOLVED HAS BEEN DISTURBED.
- 4. ALL EROSION CONTROL MEASURES SHALL BE IN ACCORDANCE WITH THE REQUIREMENTS OF THE STANDARD SPECIFICATIONS AND THE APPLICABLE STATE STANDARDS SPECIFICATION AND OF THE APPLICABLE STATE STANDARDS FOR THE ENTIRE DURATION OF THE CONTRACT OR UNTIL SUCH A TIME AS DIRECTED BY THE ENGINEER.
- AT ANY AREA WHERE THERE IS NO PROPOSED GRADING, THE EXISTING GROUND COVER SHALL REMAIN.
- 6. EROSION CONTROL ITEMS ARE CONSIDERED TO BE HIGH PRIORITY ITEMS ON THIS CONTRACT. THE ENGINEER WILL IMPLEMENT ALL PROVISIONS OF THE SPECIFICATIONS NECESSARY TO ASSUME THAT EROSION CONTROL ITEMS ARE CONSTRUCTED AND MAINTAINED IN A TIMELY WAY. ALL EROSION CONTROL MEASURES SHALL BE INSTALLED PRIOR TO BEGINNING ANY CONSTRUCTION ACTIVITIES WHICH WILL POTENTIALLY CREATE ERODABLE CONDITIONS.
- 7. THE EROSION CONTROL MEASURES SHOWN ARE BUT A GRAPHICAL REPRESENTATION OF SUGGESTED MEASURES, DEVIATIONS FROM THIS PLAN ARE TO BE EXPECTED PENDING JOBSITE INSPECTION BETWEEN THE CONTRACTOR AND THE DEPARTMENT.
- THE CONTRACTOR WILL BE REQUIRED TO IMPLEMENT AND MAINTAIN SEDIMENT CONTROL MEASURES PRIOR TO STRIPPING EXISTING VEGITATION.
- UNDER NO CIRCUMSTANCES SHALL THE CONTRACTOR PROLONG FINAL GRADING AND SHAPING SO THAT THE ENTIRE PROJECT CAN BE PERMANENTLY SEEDED AT ONE TIME.



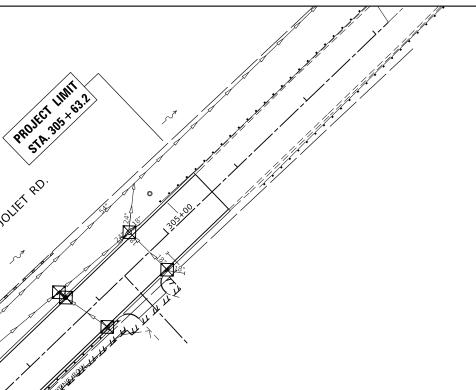

## NOTES

STA.

NOTIEL BD.

1. THE CONTRACTOR WILL ASSUME RESPONSIBILITY FOR MAINTENANCE OF ALL SOIL EROSION CONTROL DURING CONSTRUCTION.

2. THE CONTRACTOR SHALL CHECK ALL ESC MEASURES WEEKLY AND AFTER EACH RAINFALL, 0.5 INCHES OR GREATER IN A 24 HOUR PERIOD, OR EQUIVALENT SNOWFALL. ADDITIONALLY DURING WINTER MONTHS, ALL MEASURES SHOULD BE CHECKED BY THE CONTRACTOR AFTER EACH SIGNIFICANT SNOWMELT.


3. ALL ESC MEASURES WILL BE MAINTAINED IN ACCORDANCE WITH THE IDOT EROSION AND SEDIMENT CONTROL FIELD GUIDE FOR CONSTRUCTION ISPECTION (http://www.idot.illinois.gov/transportation-system/environment/erosion AND IDOT'S BEST MANAGEMENT PRACTICES - MAINTENANCE GUIDE: sion-and-sediment-control (http://www.idot.illinois.gov/transportation-system/environment/erosion-and-sediment-control)


4. THE CONTRACTOR SHOULD PROVIDE TO THE RE A PLAN TO ENSURE THAT A STABILIZED FLOW LINE WILL BE PROVIDED DURING STORM SEWER CONSTRUCTION. THIS IS IMPORTANT WHERE NEW STORM SEWER CONNECTS TO EXISTING CULVERTS. THE USE OF A STABILIZED FLOW LINE BETWEEN INSTALLED STORM SEWER AND OPEN DISTURBANCE WILL REDUCE THE POTENTIAL FOR THE OFFSITE DISCHARGE OF SEDIMENT-BEARING WATERS, ESPECIALLY WHEN RAIN IS FORECASTED, SO THAT FLOW WILL NOT ERODE. LACK OF APPROVED PLAN OR FAILURE TO COMPLY WILL RESULT IN AN ESC DEFICIENCY DEDUCTION.

5. ANY LOOSE MATERIAL DEPOSITED IN THE FLOW LINE OF DRAINAGE STRUCTURES, WHICH OBSTRUCTS THE NATURAL FLOW OF WATER, SHALL BE REMOVED AT THE CLOSE OF EACH WORKING DAY. PRIOR TO ACCEPTANCE OF THE IMPROVEMENT, ALL DRAINAGE STRUCTURES SHALL BE FREE OF DIRT AND DEBRIS. THIS WORK WILL NOT BE PAID FOR SEPARATELY BUT SHALL BE CONSIDERED AS INCIDENTAL

6. TEMPORARY OR PERMANENT STABILIZATION SHALL BE INITIATED IMMEDIATELY UPON COMPLETION OF DISTURBANCE OR IF THE WORK AREA IS TO BE LEFT UNDISTURBED FOR 14 DAYS OR MORE.

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SCALE: 1 =50 SHEET OF SHEET
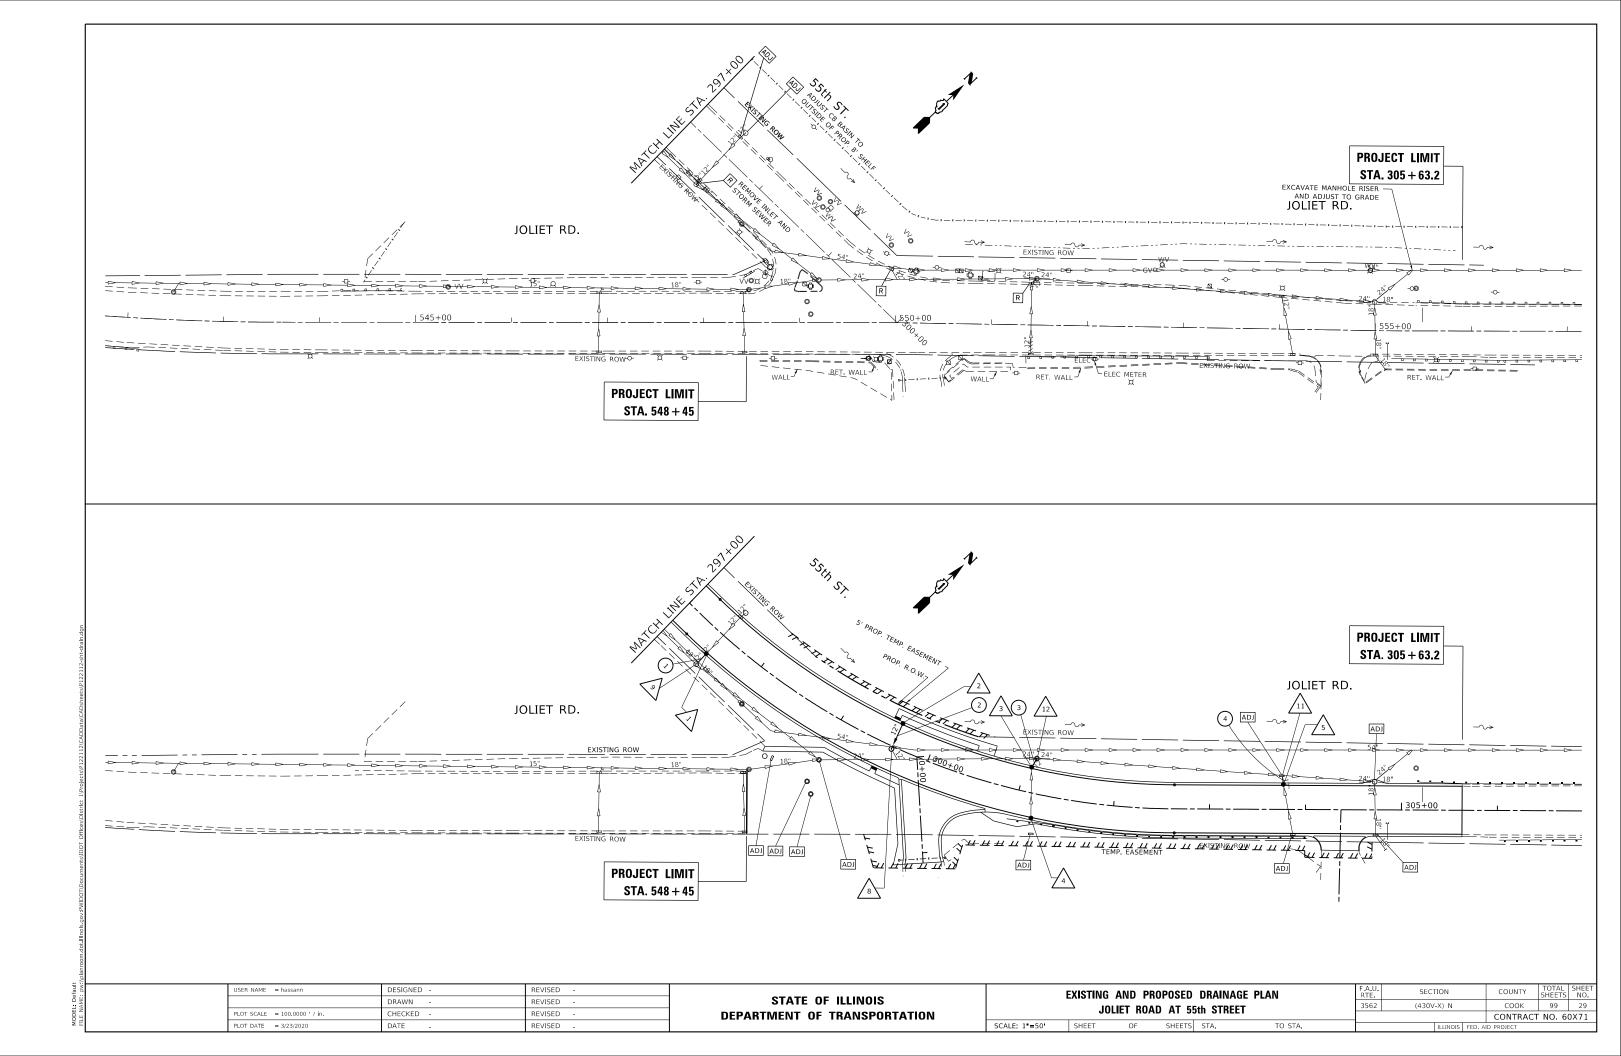
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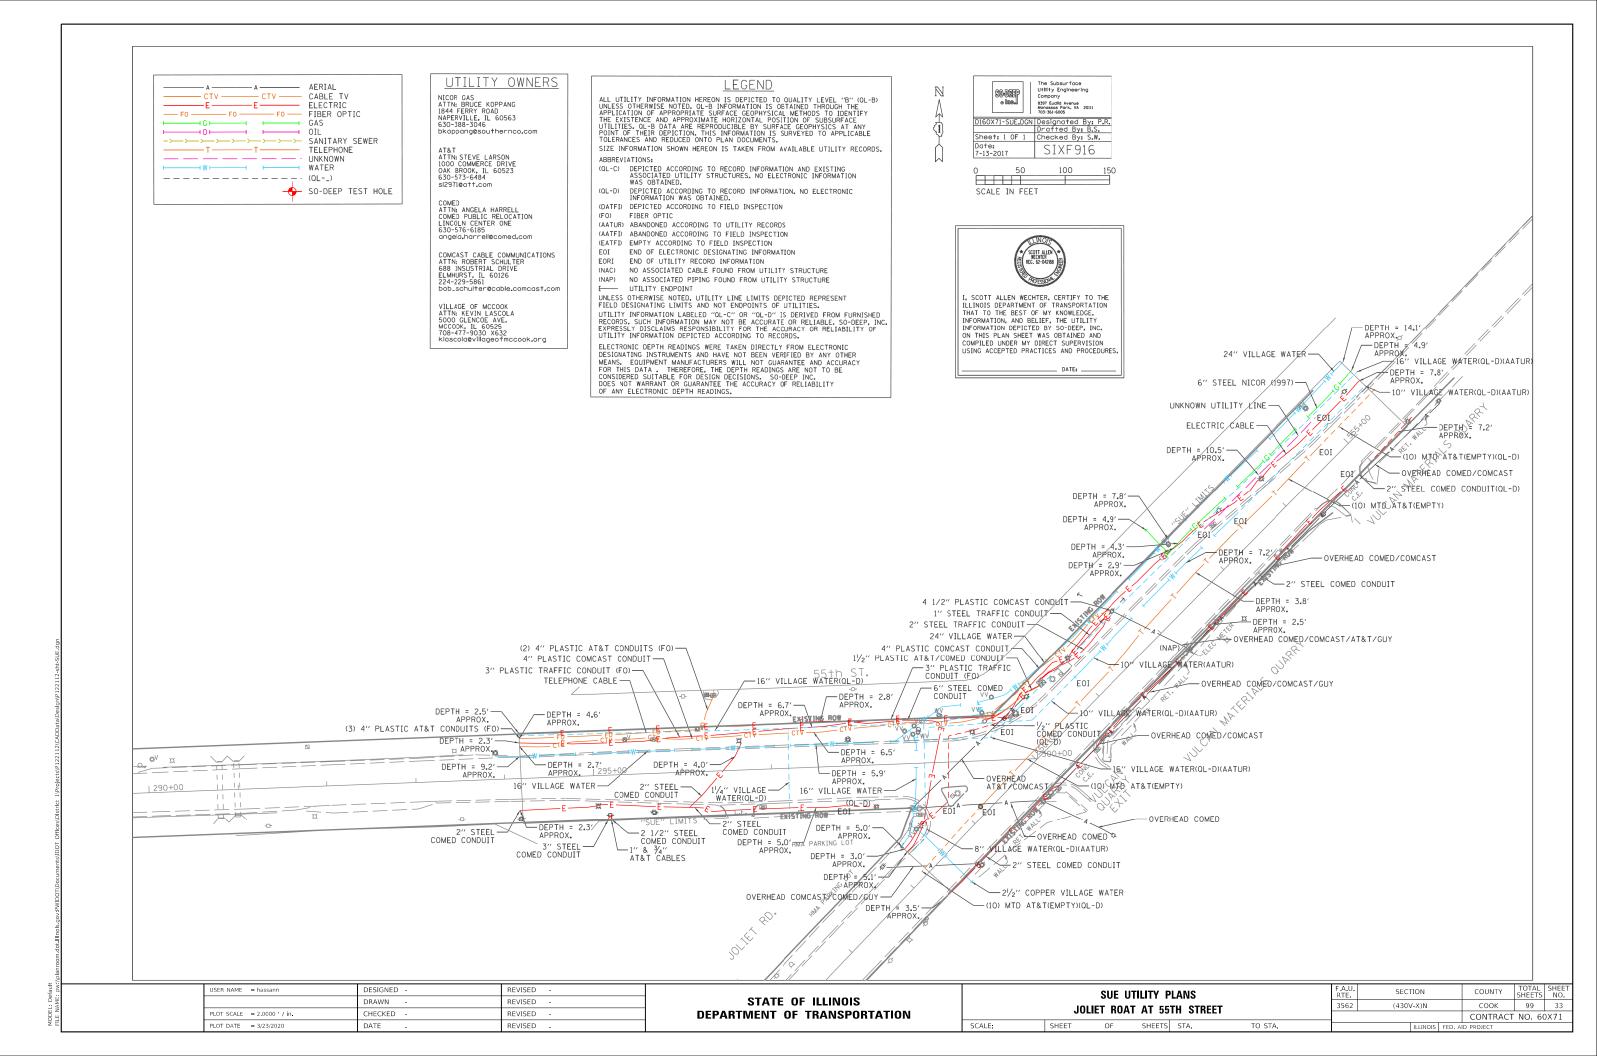
STA 297+48.8 CATCH BASIN, TYPE A, 4' DIAMETER, TYPE 1 FRAME OPEN LID T.O.G.: 636.50 N (12") INV: 630.26 (EXISTING) S (12") INV: 629.90 ①	<u> </u>	STA 303+76.8 CATCH BASIN, TYPE A, 4' DIAMETER, TYPE 1 FRAME OPEN LID T.O.G.: 626.62 SE INV (12''): 622.63 (EXISTING) N (12'') INV: 622.20 ④	Ś	STA 297+48. EXISTING MA ADJUST T.O.G.: MEET N (12'') INV: W (12'') INV: E (18'') INV:
STA 299+60.3 CATCH BASIN, TYPE C, 4' DIAMETER, TYPE 1 FRAME OPEN LID T.O.G.: 633.77 S (12'') INV: 630.77 @	6	REMOVE INLET AND STORM SEWER STA 295+25.9 CATCH BASIN, TYPE A, 4' DIAMETER, TYPE 1 FRAME OPEN LID T.O.G.: 636.79 NW (12') INV: 631.80 (EXISTING) SE (12'') INV: 631.25 (5)	<u>/10</u>	STA 296+32. EXISTING MA ADJUST T.O.G.: MEET NW (12") INV E (12") INV: SE (18") INV
STA 301+07.3 CATCH BASIN, TYPE A, 4' DIAMETER, TYPE 1 FRAME OPEN LID T.O.G.: 631.11 SE INV: 626.47 (EXISTING) N INV: 625.56 (3)	<u>_7</u>	STA 296+62.78 CATCH BASIN, TYPE C, 4' DIAMETER, TYPE 1 FRAME OPEN LID T.O.G.: 636.22 W 12'' INV: 633.55 ⑤	<u>_11</u>	STA 303+75. EXISTING MA ADJUST T.O.G.: MEET SE (12") INV E (24") INV: W (24") INV:
STA 301+18.2 CATCH BASIN, TYPE A, 4' DIAMETER, TYPE 1 FRAME OPEN LID T.O.G.: 632.93 SE (12") INV: 627.63 (EXISTING) NW (12") INV: 627.54 (EXISTING)	<u>^</u> 8	STA 299+60.3 MANHOLES, TYPE A, 4' DIAMETER TYPE 1 FRAME, CLOSED LID T.O.G.: 633.98 SE (12") INV: 628.31 (EXISTING) N (12") INV: 630.34 (2)	12	STA 301+08. EXISTING MA ADJUST T.O.G.: MEET S (12") INV: NE (24") INV SW (24") INV
1) STORM SEWER, CLASS A, TYPE II, 12", 15'	3	) STORM SEWER, CLASS A, TYPE II, 12", 11' (CONNECT TO EXISTING MANHOLE AT EXISTING INVERT)		5) CAST IRON
2) STORM SEWER, CLASS A, TYPE II, 12", 29'	4	STORM SEWER, CLASS A, TYPE II, 12", 9"		5) STORM SE

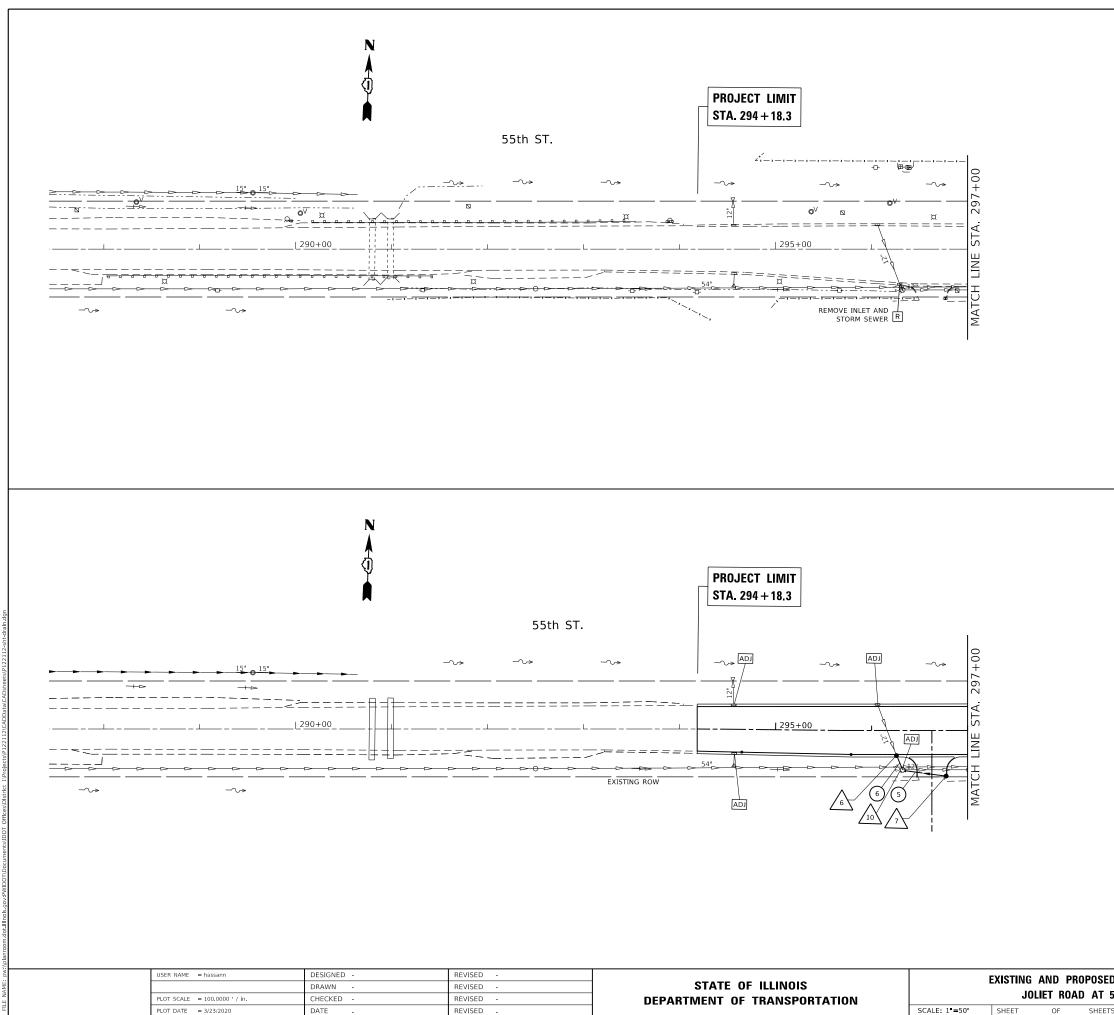USER NAME = hassann	DESIGNED -	REVISED -			PROPOS	ED STRU	ICTURE A	ND PIPE	LEGEND		F.A.U. RTE	SECTION	COUNTY	TOTAL SHEET SHEETS NO.
	DRAWN -	REVISED -	STATE OF ILLINOIS		101						3562	(430V-X)N	СООК	99 32
PLOT SCALE = 100.0000 / in.	CHECKED -	REVISED -	DEPARTMENT OF TRANSPORTATION	JOLIET ROAD AND 55TH STREET					CONTRAC	T NO. 60X71				
PLOT DATE = 3/23/2020	DATE -	REVISED -		SCALE:	SHEET	OF	SHEETS	STA.	TO S	TA.		ILLINOIS F	ED. AID PROJECT	

8.8 ANHOLE T PROPOSED GRADE : 629.66 ① : 629.66 (EXISTING) : 629.56 (EXISTING) 2.6 ANHOLE PROPOSED GRADE V: 630.96 (EXISTING) : 630.86 (EXISTING) IV: 632.88 ⑤ 5.6 ANHOLE PROPOSED GRADE V: 622.09 ④ V: 620.72 (EXISTING) V: 620.72 (EXISTING) V: 620.72 (EXISTING) 3.7 ANHOLE PROPOSED GRADE (\* 625.38 ③ VV: 623.28 (EXISTING) VV: 623.38 (EXISTING)

ON WATER MAIN, 6", 45"

EWER, CLASS A, TYPE II, 12", 16




# STATE OF ILLINOIS DEPARTMENT OF TRANSPORTATION DIVISION OF HIGHWAYS

# PLAT OF HIGHWAYS

JOLIET ROAD SECTION COOK COUNTY LIMITS 55TH STREET

R-90-001-15

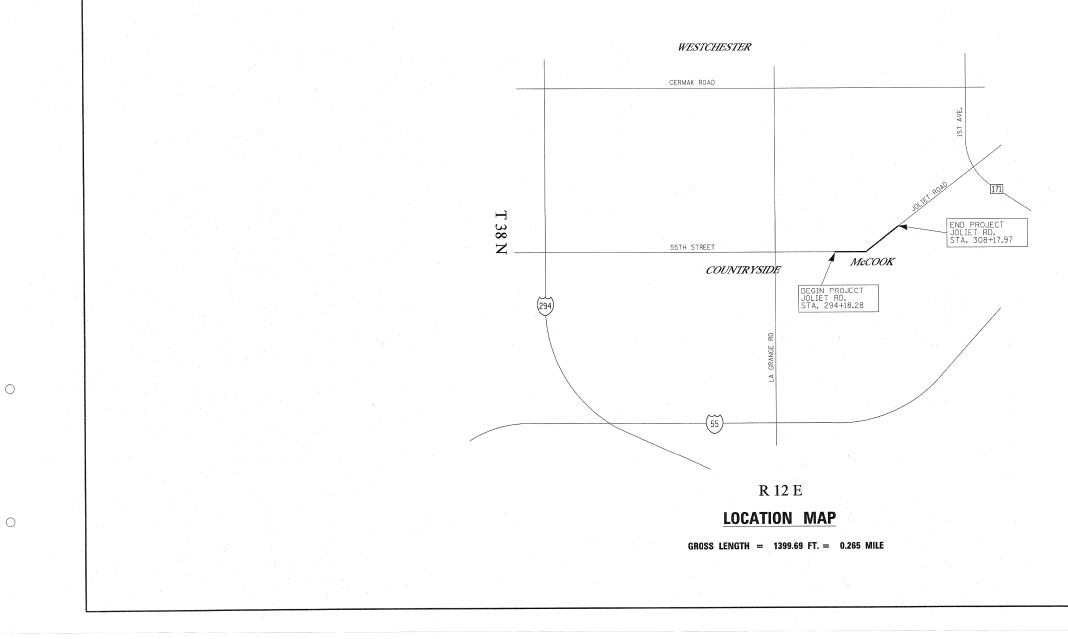

PROPERTY ACQUIRED BY

SHEET NUMBER

2 & 3

2 & 3

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PARCEL NUMBER

0LT0001 0LT0001TE OWNER


ELECTRO-MOTIVE DIESEL, INC.

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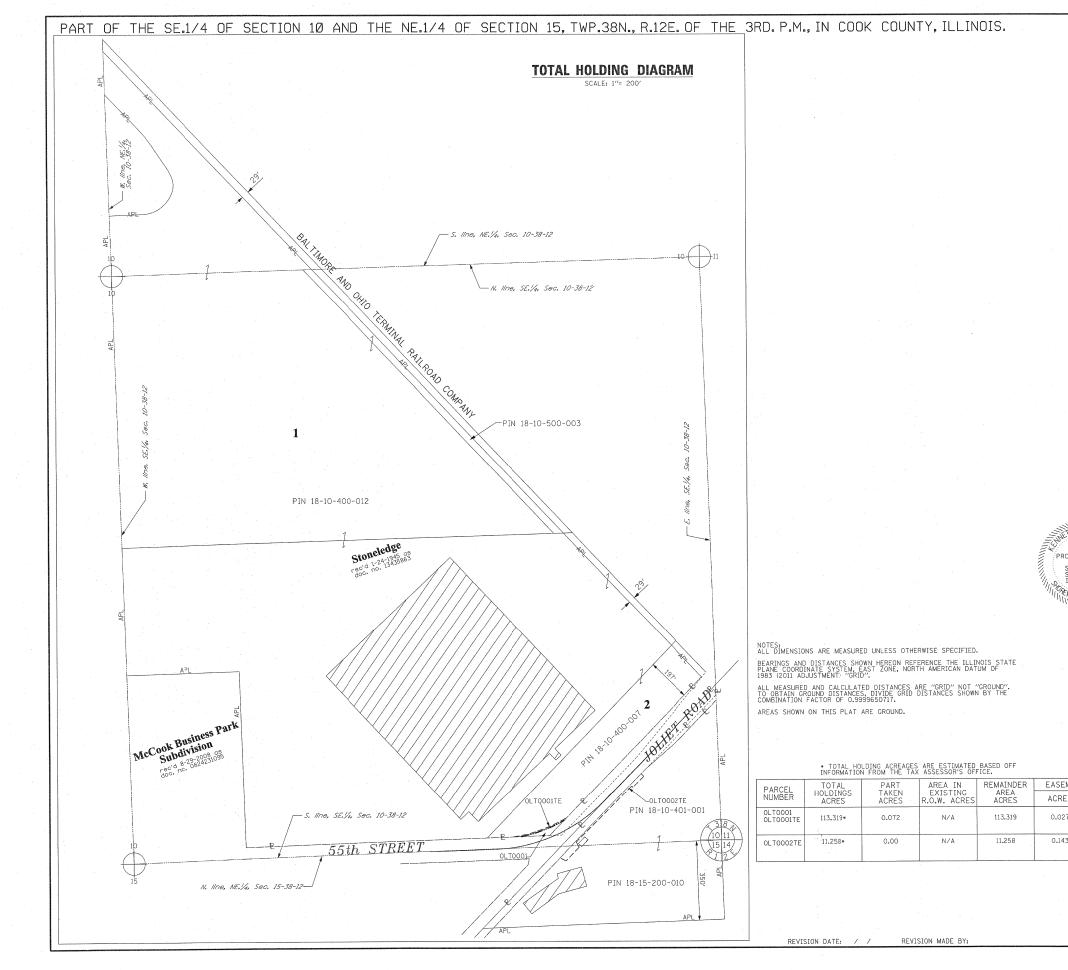
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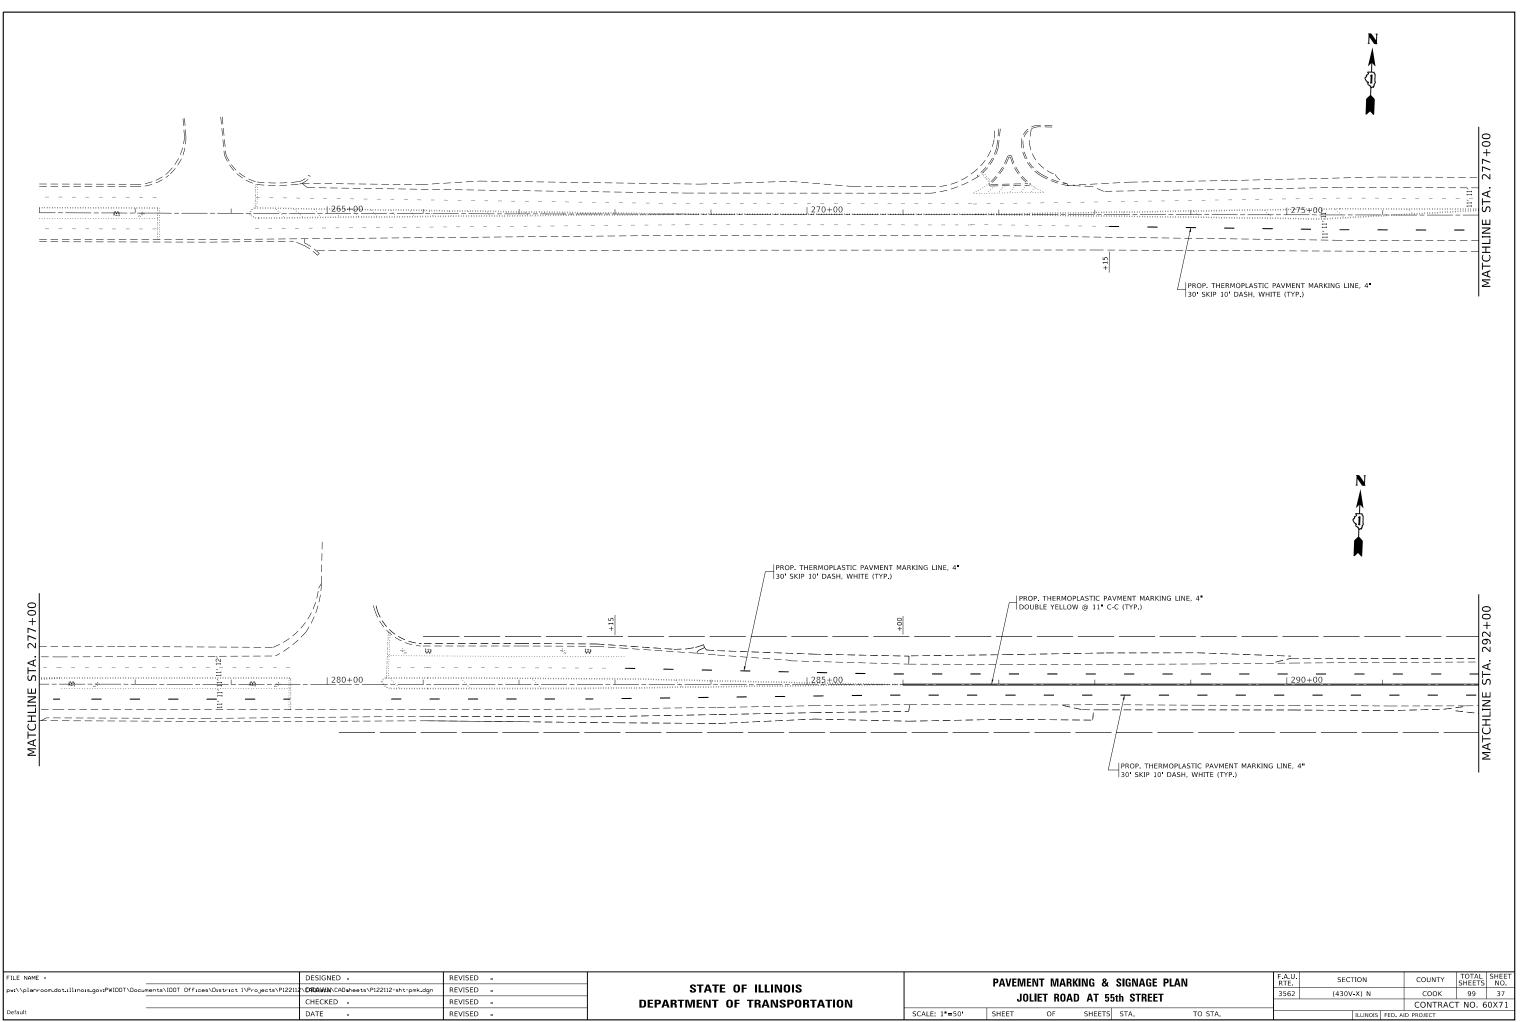
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ANNININI H J. PEC	PROFESSIONAL LAN ILLINOIS PROFESSI 184-001251,) HAVE 15, TOWNSHIP 38 M COOK COUNTY, THA THE BEST OF MY REPRESENTS SAID ARE OF PERMANEN AND THAT THE MO RETRACFD, MADE F ILLINOIS.	ID SURVEYOR, CONAL DESIGN SURVEYED TH VORTH, RANGE IT THE SURVE KNOWLEDGE AN SURVEY, THAT T QUALITY AN NUMENTS ARE OR THE DEPAN	INNETH J. PESAVENTC (WE, RUETTIGER, TON FIRM LAND SURVEYIN E PLAT OF HIGHWAYS 12 EAST OF THE TH Y IS TRUE AND COMM D BELIEF, THAT THE ALL MONUMENTS FC D OCCUPY THE POSIT SUFFICIENT TO ENAR RTMENT OF TRANSPOR	VELLI & ASSOCIATES NG CORPORATION, NU S SHOWN HEREON IN IRD PRINCIPAL MERI PLETE AS SHOWN TO PLAT CORRECTLY DUND AND ESTABLISH TIONS SHOWN THEREO SLE THE SURVEY TO RTATION, STATE OF	MBER SECTIONS DIAN, ED DN BE	10 &
3425	13/1	EWOOD, ILI	INOIS THIS 5th DAY	OF September 2017	A.D.	
DFESSIONA LAND SURVEYOR STATE OF ILLINOIS	ALLINOIS PROFESS	IONAL LAND S ON DATE: 11-3	URVEYOR NO. 3425 0-2018			
WOOD, TLUM	THIS PROFESSIONA ILLINOIS MINIMUM	L SERVICE CO STANDARDS F	ONFORMS TO THE CUP OR A BOUNDARY SUR	RRENT WEY.		
		R &	A Surveyors * Enginee 129 CAPISTJ PH	Tonelli & Associ rs*Planers*Landscape Architects* G. A DRIVE - SHOREWOOD, ILLINO (315)744-600 FAX (815)744-0101 website: www.ruettigertonelli.com	I.S. Consultants IS 60404	
AREA SQUARE	PARCEL INDEX NUMBER			.T. & A. Dwg. No.: 2		1.00
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L.		F.A.U. RTE	SECTION	COUNTY	TOTAL SHEETS	SHEET NO
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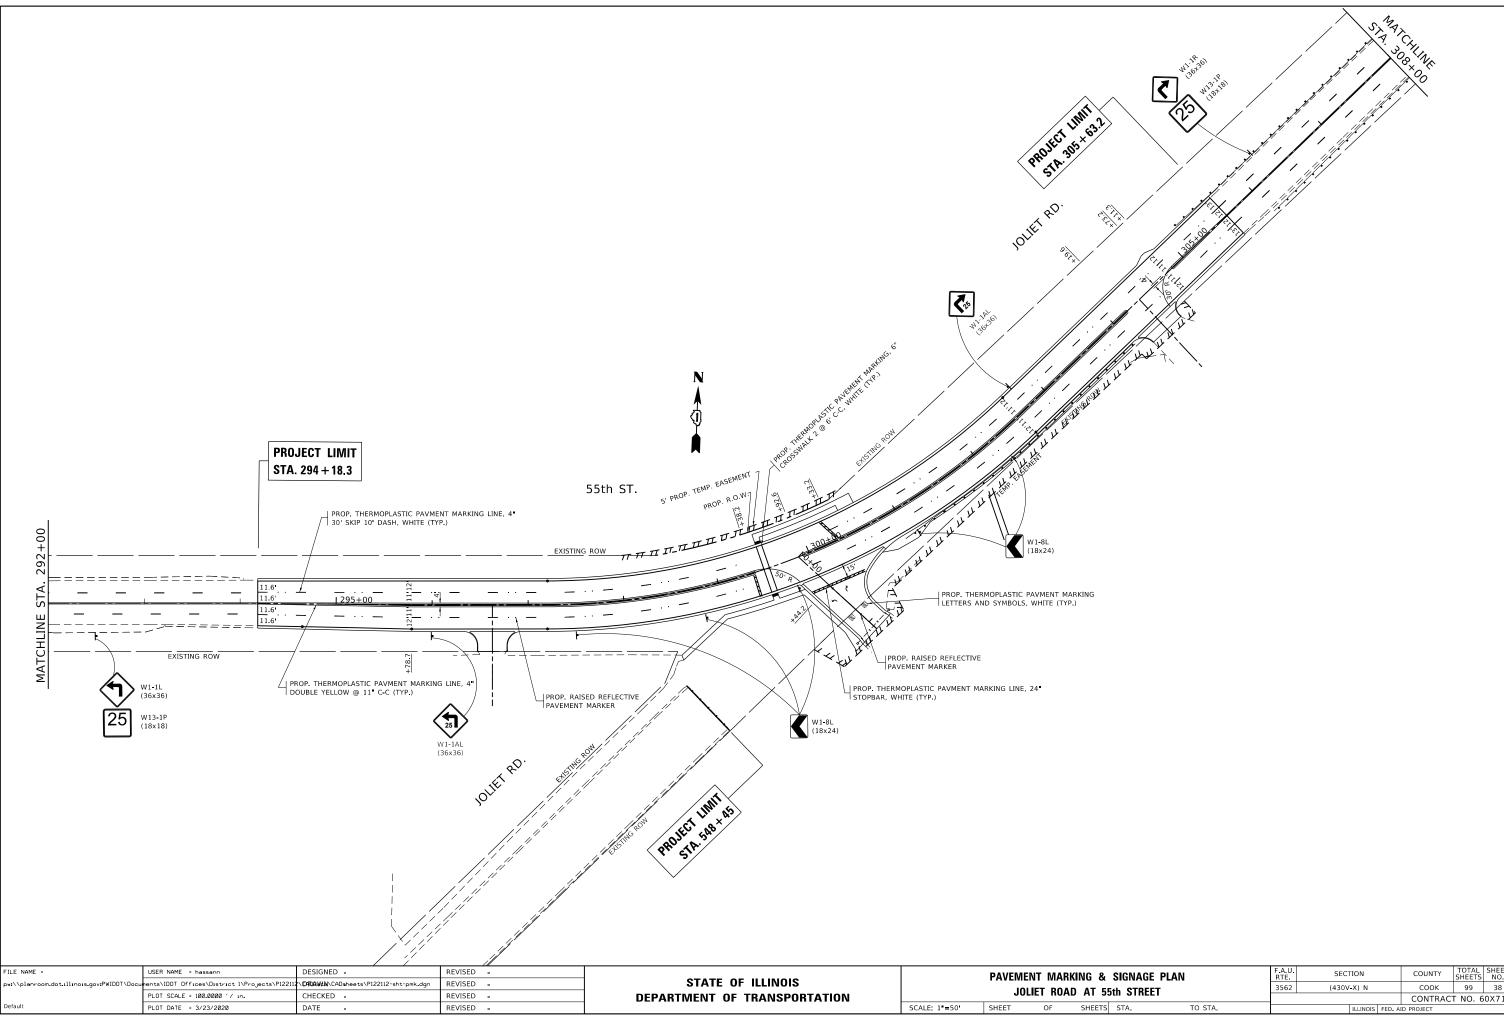
ILLINOIS FED AID PROJECT

CONTRACT NO. 60X71





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			SE	CTION / C	UARTER SECT	ION LINE		
PHOPOSED CENTERLINE     SALE 1''S 50'     PHOPOSED CENTERLINE     SALE 1''S 50'			1			G	RAPHIC SCAL	.E
CALE 1" 50'     CALE 1" 5	-					ç	FEET	50
						ie sc	ALE: 1″= 50	,
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		129.32'	ME	ASURED DIM	ENSION			
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+     CUT CROSS FOUND OR SET     5 / 8*REDAR SET       +     THESE STAKES REFERENCE FOUND OR SET MONNENTION. SIST 5/8 INCH TO THE TOR NOD FUSION CONFERENCE SELVICE OR STAKE TO THE FOUND INFORMATION NUMBER.       •     THESE STAKES, IN CULTIVATED AREAS, REFERENCE FOUND ON SET MONNENTIFIED BY COLORED PLASTIC CAP BEARING SURVEYORS REGISTRATION NUMBER.       •     THESE STAKES, IN CULTIVATED AREAS, REFERENCE FOUND ON SET MONNENTIFIED BY COLORED PLASTIC CAP BEARING SURVEYORS REGISTRATION NUMBER.       •     STAKING OF PROPOSED RICHT OF WAY, SET DIVISION OF HIGHWAY SURVEY MARKER POSITION DENTIFIED BY COLORED PLASTIC CAP BEARN SURVEYORS REGISTRATION NUMBER.       •     STAKING OF PROPOSED RICHT OF WAY, SET DIVISION TO MARK FUTURE SURVEY MARKER POSITION DENTIFIED BY COLORED PLASTIC CAP BEARN SURVEYORS REGISTRATION NUMBER.       •     STAKING OF PROPOSED RICHT OF WAY IN CULTIVATED AREAS. BUREL 5/8 INCH METAL ROD 20 INCHES BELOW GROUND TO MARK FUTURE SURVEY MARKER POSITION DENTIFIED BY COLORED PLASTIC CAP BEARN SURVEYORS REGISTRATION NUMBER.       •     STAKEN OF PROPOSED TO BE SET       •     STAKEN OF PROPOSED TO THE FULL OF HIGHWAYS SHOWN HEREON IN MEETING SURVEYORS REGISTRATION ENDINEST       •     STAKEN OF PROPOSED DESIGNAL DESIGN FIRM LAND SURVEYTME COMPERITORS SHOWN TO FUE OF STATE OF ILLINOIS       •     STAKEN OF PROVINCE ON SURVEY THE PLAT OF HIGHWAYS SHOWN HEREON IN MEETING STATE OF THE DEPARTMENT OF ALLINOIS SHOWN THEREON IN MEETING STATE OF THE DEPARTMENT OF TAMASSON THEREON IN THEREON IN THEREON IN A SURVEYTY AND AND SURVEYTY IS THE ADD COMPLETE AS SHOWN TO FUE OF STAKEN OF THE DURA AND SURVEYTY AND ADD SURVEYTY AND ADD SURVEYTY SURVEY ILLINOIS MINIMUM STANDARDS FOR T		<i><u><u></u></u></i>						
CUT CROSS FOUND OR SET         S / 8'REBAR SET         CUT CROSS FOUND OR SET         THESE STAKES REFERENCE FOUND OR SET MONUMENTATION. SET 5/8 INCH         TO ON ROD FULLENTITIE GAR BEARING SURVEYORS REGISTRATION NUMBER.         THESE STAKES, IN CULTIVATED AREAS, REFERENCE FOUND ON THE FOUND         INCR DATA         STAKING OF PROPOSED RIGHT OF WAY. SET DIVISION OF HIGHWAYS SURVEY         MARCEN TO MONMENT THE POSITION SUMM.         STAKING OF PROPOSED RIGHT OF WAY. SET DIVISION OF HIGHWAYS SURVEY         MARCEN TO MONMENT THE POSITION SUMM.         STAKING OF PROPOSED RIGHT OF WAY. SET DIVISION OF HIGHWAYS SURVEY         MARCEN TO MONMENT THE POSITION SUMM.         MARCEN TO MONMENT THE POSITION SUMM.         MARCEN TO STIMUMENT TO FWAY. SET DIVISION OF HIGHWAYS SURVEY         MARCEN TO STIMUMENT TO FWAY.         MARCEN TO STIMUMENT TO THE FOLL TO LASTIC CAP BEARING         SURVEYORS REGISTRATION NUMBER.         MARCEN TO STIMUMENT MARCEN.         MILLINOIS PROPOSED TO BE SET         STATE OF ILLINOIS          PORTASIGNAL LANS SURVEY IS TRUE AND COMPLETE AS SHOWN TO         THE BEST OF MY KNOWLEDGE AND BELIEF, THAT THE PLAT CORRECTLY         REPERSENTS SID SURVEY. THAT THE SURVEY TO BE         RETARGED, MARCE SUBFICIENT TO ENABLE HERE SHOW HEREON IN SECTIONS IN THE BEAT SHOW TO         THE DEST OF MY KNOWLEDGE AND COMPLETE AS SHOWN TO         THE PROFESSIONAL LANS SURVEY ST TRUE AND COMPLETE AS SHOWN TO         THE PROFESSIONAL LANS SURVEY ST TO ENABLES.         MARCENT SURVEY TO BE         RETARGED, MARCELEF, THAT THE PLAT CORRECTLY         REPRESENTS SID SUBVEY.         MARCENT OSTIMONA DO ESTABLISHED         APOCE								
CUT CROSS FOUND OR SET     5 / 8*REBAR SET     THESE STAKES REFERENCE FOUND OR SET MOMMENTATION. SITS 5/8 INCH     TO IN ROD FULLY WITH GROUND OT IF FOUND INNO STAKE IDENTIFIED BY     COURDED PLASTIC CAP BEARING SURVEYORS REGISTRATION NUMBER.     THESE STAKES, IN DUITIVATED AREAS, REFERENCE FOUND OR SET MOMMENTATION     STACING OF PROPOSED RICHT OF WAY, SET DIVISION OF HIGHWAYS SURVEY     MARKER TO INNUMENT THE POSITION SHOW. IDENTIFIED BY INCOMPENDENTIAL DATA     MOD SURVEYORS REGISTRATION NUMBER.     STAKING OF PROPOSED RICHT OF WAY, SET DIVISION OF HIGHWAYS SURVEY     MARKER TO INNUMENT THE POSITION SHOW. IDENTIFIED BY INCOMPENDENTIED BY INCOMPENDENTIED BY INCOMPENDENTIAL DATA     MOD SURVEYORS REGISTRATION NUMBER.     MARKER TO INNUMENT THE POSITION SHOW. IDENTIFIED BY INCOMPENDENT TO MARK FUTURE SURVEY     MARKER TO INNUMENT THE POSITION SHOW. IDENTIFIED BY INCOMPENDENT TO MARK FUTURE SURVEY     MARKER TO INNUMER.     MARKER TO INNUMINATION SURVEY.     MARKER TO INNUMINATION SURVEY.								
						ET		
BTI       THEES STAKES, IN OLITIVATED AREAS, REFERENCE FOUND OR SET MONUMENTATION.         BIRTED 36, INCH HOW ROD CO INCHES BELOW GROUND TO ITE FOUND BIRNESTAKE, IDENTIFIED BY COLORED PLASTIC CAP BEARING SURVEYORS REGISTRATION NUMBER.         STAKING OF PROPOSED RIGHT OF WAY, SET DIVISION OF HIGHWAYS SURVEY MARKER TO MONUMENT THE POSITION SHOWN. IDENTIFIED BY INSCRIPTION DATA AND SURVEYORS REGISTRATION NUMBER.         M       STAKING OF PROPOSED RIGHT OF WAY IN CULTIVATED AREAS. BURD 5/8 INCH METAL ROD 20 INCHES BELOW GROUND TO MARK FUTURE SURVEY MARKER POSITION IDENTIFIED BY COLORED PLASTIC CAP BEARING SURVEYORS REGISTRATION NUMBER.         M       STAKING OF PROPOSED RIGHT OF WAY IN CULTIVATED AREAS. BURD 5/8 INCH METAL ROD 20 INCHES BELOW GROUND TO MARK FUTURE SURVEY MARKER POSITION IDENTIFIED BY COLORED PLASTIC CAP BEARING SURVEYORS REGISTRATION NUMBER.         M       STAKE OF ILLINOIS )         Y       DEFENAMENT SURVEY MARKER, LD.O.T. STANDARD 2135 (TO BE SET BY OTHERS) RIGHT OF WAY STAKING PROPOSED TO BE SET         STATE OF ILLINOIS )       JS         COUNTY OF WILL       JS         COUNTY OF WILL       JS         STATE OF ILLINOIS )       JS         COUNTY OF WILL       JS         THIS IS TO CERTIFY THAT I, KENNETH J, PESAVENTO, AN ILLINOIS FROFESSIONAL LAND SURVEY IN THE ABO COMPLETE AS SHOWN TO THE BEST OF MY KNOMENDE AND BELLEF, THAT THE PLAT CORRECTLY REPRESENTS SAU SURVEY, THAT TALL MOMMANTS FOULD AND STANLESSHOUND AND THAT HER OWNERDIS AND SURVEY IS THE ABO COMPLETE AS SHOWN TO BE RETRACED, MADE FOR THE DEPARTMENTS FOULD AND SURVEY TO BE RETRACED, MADE FOR THE DEPARTMEN	Τ2	THESE STAKES RE IRON ROD FLUSH V	EFERENCE WITH GROUN	ID TO TIE FO	UND IRON STA	KE IDENTIFIE		
MARKER TO MONUMENT THE POSITION SHOWN. IDENTIFIED BY INSCRIPTION DATA AND SURVEYORS RECISTRATION NUMBER.	<ul> <li>BT1 BT2 BT3</li> </ul>	THESE STAKES, IN BURIED 5/8 INCH IRON STAKE, IDEN	I CULTIVAT IRON ROD TIFIED BY	ED AREAS, RE 20 INCHES BE COLORED PLA	EFERENCE FOL	IND OR SET M TO TIE FOUND		ION.
Image: Staking of PROPOSED RIGHT OF MAY IN CULTIVATED APEAS.         BURIED 5/8 INCH METAL ROD 20 INCHES BELOW GROUND TO MARKER POSITION IDENTIFICAL ROD 201 COLORED PLASTIC CAP BEARING SURVEYORS REGISTRATION NUMBER.         Image: Survey tools registed and the register of the regist		MARKER TO MONUN	MENT THE F	OSITION SHO	WN. IDENTIFIED			
RIGHT OF WAY STAKING PROPOSED TO BE SET         JSS         COUNTY OF WILL         THIS IS TO CERTIFY THAT I, KENNETH J, PESAVENTO, AN ILLINOIS PROFESSIONAL LAND SURVEYOR, (WE, RUETTIGER, TONELLI & ASSOCIATES, AN ILLINOIS PROFESSIONAL DESIGN FIRM LAND SURVEYING CORPORATION, NUMBER INFORMATION, NUMBER INFORMATION, NUMBER SIGNAL AND INFORMATION, THAT THE SURVEY IS TRUE AND COUNTY CORRECTLY REPRESENTS SAID SURVEY, THAT ALL MOMUNENTS SHOWN THEREON IN SECTIONS ID IS, TOWNSHIP 38 NORTH, RANGE 12 EAST OF THE THIRD PRINCIPAL MERIDIAN, COOK COUNTY, THAT THE SURVEY IS TRUE AND COUNTY AND NOT ADELESTICATED IS, TOWNSHIP 38 NORTH, RANGE 12 EAST OF THE THERPORTALION, STATE OF ILLINOIS SAID SURVEY, THAT ALL MOMUNENTS FORMALTICH, STATE OF ILLINOIS.         DATED AT STOCESSIONAL LAW SURVEYOR NO. 3425 LICENSE EXPIRATION DATE: 11-30-2018         THIS PROFESSIONAL SERVICE CONFORMS TO THE CURRENT ILLINOIS MINIMUM STANDARDS FOR A BOUNDARY SURVEY.         NT AREA SUDVARE INDEX NUMBER 1162 1162 1162 1162 1162 1162 1161-0-400-0012 6228 1162 1162 1161-0-400-0012 6228 1162 1162 1162 1161-0-400-0012 6228 1162 1162 1161-0-400-0012 6228 1162 1162 1162 1161-0-400-0012 6228 1162 1162 1162 1162 1161-0-400-0012 1161-0-400-0012 1161-0-400-0012 1161-0-400-0012 1161-0-400-0012 1161-0-400-0012 1161-0-400-0012 1162 1162 1162 1162 1162 1162 1162	M	STAKING OF PROF BURIED 5/8 INCH MARKER POSITION	POSED RIGH METAL ROE IDENTIFIED	T OF WAY IN 20 INCHES 3 BY COLORED	CULTIVATED	TO MARK FL	TURE SURVE	Y
JSS         COUNTY OF WILL         AT INTS IS TO CERTIFY THAT I, KENNETH J, PESAVENTO, AN ILLINOIS PROFESSICNAL LAND SURVEYOR, (WE, RUETTIGER, TONELLI & ASSOCIATES, AN ILLINOIS PROFESSIONAL DESIGN FIRM LAND SURVEYING CORPORATION, NUMBER NAOOR IS, TOWNSHIP 38 NORTH, RANGE 12 EAST OF THE THIRD PENACIPAL MERIDIAN, COOK COUNTY, THAT THE SURVEYED THE PLAT OF HIGHWAYS SHOWN HERERON IN SECTIONS IC IS, TOWNSHIP 38 NORTH, RANGE 12 EAST OF THE THIRD PENACIPAL MERIDIAN, COOK COUNTY, THAT THE SURVEY IS TRUE AND COMPLETE AS SHOWN TO THE DEST OF MY KNOWLEDGE AND BELIEF, THAT THE PLAT CORRECTLY REPRESENTS SAID SURVEY, THAT ALL MONUMENTS FOUND AND ESTABLISHED ARE OF FREMANENT QUALITY AND OCCUPY THE POSITIONS SHOWN THEREON AND THAT THE MONUMENTS ARE SUFFICIENT TO ENABLE THE SURVEY TO BE RETRACED, MADE FOR THE DEPARTMENT OF TRANSPORTATION, STATE OF ILLINOIS PROFESSIONAL LANS SURVEYOR NO. 3425 LICENSE EXPIRATION DATE: 11-30-2018         THIS PROFESSIONAL SERVICE CONFORMS TO THE CURRENT ILLINOIS MINIMUM STANDARDS FOR A BOUNDARY SURVEY.         INTIS PROFESSIONAL SERVICE CONFORMS TO THE CURRENT ILLINOIS MINIMUM STANDARDS FOR A BOUNDARY SURVEY.         INTIS PROFESSIONAL SERVICE CONFORMS TO THE CURRENT ILLINOIS MINIMUM STANDARDS FOR A BOUNDARY SURVEY.         INTIS PROFESSIONAL SERVICE CONFORMS TO THE CURRENT ILLINOIS MINIMUM STANDARDS FOR A BOUNDARY SURVEY.         INTIS PROFESSIONAL SERVICE CONFORMS TO THE CURRENT ILLINOIS MINIMUM STANDARDS FOR A BOUNDARY SURVEY.         INTIS PROFESSIONAL SERVICE CONFORMS TO THE CURRENT ILLINOIS MINIMUM STANDARDS FOR A BOUNDARY SURVEY.         INTIS PROFESSIONAL SERVICE CONFORMS TO THE CURRENT ILLINOIS MINIMUM STANDARD						O BE SET BY	OTHERS)	
COUNTY OF WILL       )         THIS IS TO CERTIFY THAT I, KENNETH J, PESAVENTO, AN ILLINOIS PROFESSICNAL LAND SURVEYOR, (WE, RUETTIGER, TONELLI & ASSOCIATES, AN ILLINOIS PROFESSIONAL DESIGN FIRM LAND SURVEYNO CORPORATION, NUMBER 184-00125:), HAVE SURVEYED THE PLAT OF HIGHWAYS SHOWN HEREON IN SECTIONS IO 184-00125:), HAVE SURVEYED THE PLAT OF HIGHWAYS SHOWN HEREON IN SECTIONS IO 184-00125:), HAVE SURVEYED THE PLAT OF HIGHWAYS SHOWN HEREON IN SECTIONS IO 184-00125:), HAVE SURVEYED IS TRUE AND COMPLETE AS SHOWN TO THE BEST OF MY KNOWLEDGE AND BELIEF, THAT THE PLAT CORRECTLY REPRESENTS SAID SURVEYOR, THAT ALL MONUMENTS FOUND AND ESTABLISHED ARE OF PERMANENT OUALITY AND OCCUPY THE POSITIONS SHOWN THEREON AND THAT THE MONUMENTS ARE SUFFICIENT TO ENABLE THE SURVEY TO BE RETRACED, MADE FOR THE DEPARTMENT OF TRANSPORTATION, STATE OF ILLINOIS.         DATED AT SUBJECT OF THE MONUMENTS ARE SUFFICIENT TO ENABLE THE SURVEY TO BE RETRACED, MADE FOR THE DEPARTMENT OF TRANSPORTATION, STATE OF ILLINOIS MADE FOR THE DEPARTMENT OF TRANSPORTATION, STATE OF ILLINOIS PROFESSIONAL SERVICE CONFORMS TO THE CURRENT ILLINOIS MINIMUM STANDARDS FOR A BOUNDARY SURVEY.         VIT AREA SOUARE FEET INDEX NUMBER FEET INDEX NUMBER FEET INDE		STATE OF ILLINOI						
425 SIONAL AND NULLINOIS PROFESSIONAL LAND SURVEYOR, WE, RUETTIGER, TONELLI & ASSOCIATES, AN ILLINOIS PROFESSIONAL DESIGN FIRM LAND SURVEYING COPRORATION, NUMBER INCLUENCE SURVEYED THE PLAT OF HIGHWAYS SHOWN HEREON IN SECTIONS IO IS, TOWNSHIP 38 NORTH, RANGE 12 EAST OF THE THIRD PRINCIPAL MERIDIAN, COOK COURTY, THAT THE SURVEY IS TRUE AND COMPLETE AS SHOWN TO THE BEST OF MY KNOWLEDGE AND BELIEF, THAT THE PLAT CORRECTLY REPRESENTS SAID SURVEY, THAT ALL MONUMENTS FOUND AND ESTABLISHED ARE OF PERMANENT QUALITY AND OCCUPY THE POSITIONS SHOWN THEREON AND THAT THE MONUMENTS ARE SUFFICIENT TO ENABLE THE SURVEY TO BE RETRACED, MADE FOR THE DEPARTMENT OF TRANSPORTATION, STATE OF ILLINOIS.         DATED AT SHOREMOND, ILLINOIS THISS" DAY OF SEPTICE 20/7 A.D.         ILLINOIS PROFESSIONAL LAND SURVEYOR NO. 3425 LICENSE EXPIRATION DATE; 11-30-2018         THIS PROFESSIONAL SERVICE CONFORMS TO THE CURRENT ILLINOIS MINIMUM STANDARDS FOR A BOUNDARY SURVEY.         NT AREA FEET       PARCEL INDEX NUMBER FEET         1162       18-10-400-001 18-10-400-012 1		COUNTY OF WILL						
ILLINOIS PROFESSIONAL LANG SURVEYOR NO. 3425         LICENSE EXPIRATION DATE: 11-30-2018         THIS PROFESSIONAL SERVICE CONFORMS TO THE CURRENT ILLINOIS MINIMUM STANDARDS FOR A BOUNDARY SURVEY.         INT AREA       PARCEL         SQUARE       INDEX NUMBER ISO-00-012 18-10-400-001         SQUARE       PARCEL         IDOT USE ONLY       RECEIVED SEP 05 2017 W         IDOT USE ONLY       SCHOLAGE STALE         RECEIVED SEP 05 2017 W       BUREAU OF LAND ACOUISITION 201 WEST CENTER COURT SCHAUMBURG, ILLINOIS 60196         BUREAU OF LAND ACOUISITION 201 WEST CENTER COURT SCHAUMBURG, ILLINOIS 60196	AND IVE YOR TE OF INO IS	PROFESSIONAL LAI ILLINOIS PROFESS 184-00125:) HAVE 15, TOWNSHIP 38 COOK COUNTY, TH THE BEST OF MY REPRESENTS SAID ARE OF PERMANEN AND THAT THE MC RETRACED, MADE I	ND SURVEYO IONAL DESI SURVEYED NORTH, RAN AT THE SUI KNOWLEDGE SURVEY, T IT QUALITY DNUMENTS A	DR, (WE, RUET IGN FIRM LAN THE PLAT O NGE 12 EAST RVEY IS TRUE AND BELIEF, HAT ALL MON AND OCCUPY ARE SUFFICIEN	TIGER, TONELL D SURVEYING F HIGHWAYS SF OF THE THIRD E AND COMPLE THAT THE PL JUMENTS FOUNG THE POSITION VT TO ENABLE	L1 & ASSOCIA CORPORATION, HOWN HEREON PRINCIPAL M TE AS SHOWN AT CORRECTL O AND ESTABL S SHOWN THE THE SURVEY	NUMBER IN SECTION ERIDIAN, TO Y ISHED REON TO BE	S 10 :
LICENSE EXPÍRATION DATE: 11-30-2018 THIS PROFESSIONAL SERVICE CONFORMS TO THE CURRENT ILLINOIS MINIMUM STANDARDS FOR A BOUNDARY SURVEY.		dated at <u>SHor</u>	EWOOD .	ILLINOIS TH	IS 5 TH DAY OF	<u>September</u> 20	/7A.D.	
ILLINOIS MINIMUM STANDARDS FOR A BOUNDARY SURVEY.         ILLINOIS MINIMUM STANDARDS FOR A BOUNDARY SURVEY.         INT AREA       PARCEL         SOUARE       PARCEL         SOUARE       INDEX NUMBER         FEET       INDEX NUMBER         I162       I8-10-400-008         I18-10-400-001       STATE OF ILLINOIS         G228       IB-15-200-010         IDOT USE ONLY       GENTION         IDOT USE ONLY       SEP 05 2017 G         PLATS & LEGALS       BUREAU OF LAND ACOUISITION         SEP 0 5 2017 G       BUREAU OF LAND ACOUISITION         PLATS & LEGALS       FA.U.         SECTION       COUNTY TOTAL SH         MUREAU OF LAND ACOUSTION       SCHAUMBURG, ILLINOIS 60196					NO. 3425	· · · ·		
Image: Second								
INDEX       PARCEL         SQUARE       INDEX         INDEX       INDEX         INDEX       MUMBER         1162       18-10-400-008         1162       18-10-400-012         6228       18-15-200-010         18-10-401-001       IB-15-200-010         IDOT USE ONLY       State of ILLINOIS         DEPARTMENT OF TRANSPORTATION       JOLIET ROAD         LIMITS: © 55th STREET       COUNTY: COOK         SEP 05.2017       State of 3 SHEE         SEP 05.2017       BUREAU OF LAND ACOUISITION         PLATS & LEGALS       SCHAUMBURG, ILLINOIS 60196         F.A.U.       SECTION         COUNTY       TOTAL SH				<u>R</u> <u>Γ</u> & Α	Surveyors * Engineers * Pla 129 CAPISTA DRP PH. (815) websit	meet • Landscape Archite VE - SHOREWOOD, IL 744-6600 FAX (815) 744 te: www.ruettigertonelli.co	sts* G.I.S. Consultants LINOIS 60404 -0101 m	
FEET       Definition         1162       18-10-400-008 18-10-400-012         6228       18-10-400-012         6228       18-10-401-001         IDOT USE ONLY RECEIVED SEP 05 2017         SEP 05 2017       State of lubble section:         PLAT OF HIGHWAYS         BUREAU OF IRANSPORTATION JOLIET ROAD         LIMITS: @ 55th STREET       COUNTY: COOK section:         SCALE: N/A       SHEET 3         BUREAU OF LAND ACOUISITION 201 WEST CENTER COURT SCHAUMBURG, ILLINOIS 60196         F.A.U.       SECTION         RTE.       SECTION         SCALE: N/A       SHEET 3         COUNTY       TOTAL         SCHAUMBURG, ILLINOIS 60196	SQUARE	PARCEL INDEX NUMBER						4.00
6228       18-15-200-010 18-10-401-001       DEPARTMENT OF TRANSPORTATION JOLIET ROAD         IDOT USE ONLY       LIMITS: © 55th STREET       COUNTY: COOK SECTION:         IDOT USE ONLY       SECTION:       JOB NO.: R-90-001-15 STA.         STA.       TO STA.         SCALE: N/A       SHEET 3       OF 3         PLATS & LEGALS       BUREAU OF LAND ACOUISITION 201 WEST CENTER COURT SCHAUMBURG, ILLINOIS 60196         F.A.U.       SECTION       COUNTY	FEET		÷.				YS	
6228       18-19-200-010 18-10-401-001       JOLIET RDAD         JOLIET RDAD         LIMITS: © 55th STREET       COUNTY: COOK         JOB NO.: R-90-001-15         STA.       TO STA.         SCALE: N/A       SHEET 3       OF 3         PLATS & LEGALS         FA.U.         FA.U.         FA.U.         FA.U.         SECTION         COUNTY         TOTAL         FA.U.         SECTION         COUNTY         TOTAL         FA.U.         SECTION         COUNTY         TOTAL         INTEL	1162	18-10-400-007					DTATIO	
IDOT USE ONLY         SECTION:         JOB NO.: R-90-001-15           STA.         TO STA.         SHEET 3         OF 3         SHEE           SEP 05.2017         BUREAU OF LAND ACOUISITION         201 WEST CENTER COURT         201 WEST CENTER COURT           PLATS & LEGALS         F.A.U.         SECTION         TOTAL SH           F.A.U.         SECTION         COUNTY         TOTAL SH	6228	18-15-200-010 18-10-401-001	וט	PARINI			KIAIION	4
RECEIVED     STA.     TO STA.       SCALE: N/A     SHEET 3     OF 3       SEP 05.2017     BUREAU OF LAND ACOUISITION 201 WEST CENTER COURT SCHAUMBURG, ILLINOIS 60196       F.A.U.     SECTION       RTE.     SECTION       COUNTY     TOTAL SH SHEETS N		OT USE ONLY	-	55th STREE	r -			15
SEP 0.5 2017 B PLATS & LEGALS FRATE: SECTION SECHAUMBURG, ILLINOIS 60196 F.A.U. SECTION COUNTY TOTAL SH			STA.		STA.	CHEET 3	0E 3	
PLATS & LEGALS 201 WEST CENTER COURT SCHAUMBURG, ILLINOIS 60196			SUALE: N/			· ·		
RTE. SLCHON COONT SHEETS N				201	WEST CENT	TER COURT	•	
				SEC	CTION	COUNTY	TOTAL SHEETS	SHEE NO
CONTRACT NO. 60X7			3562	(430	)V-X)N			36

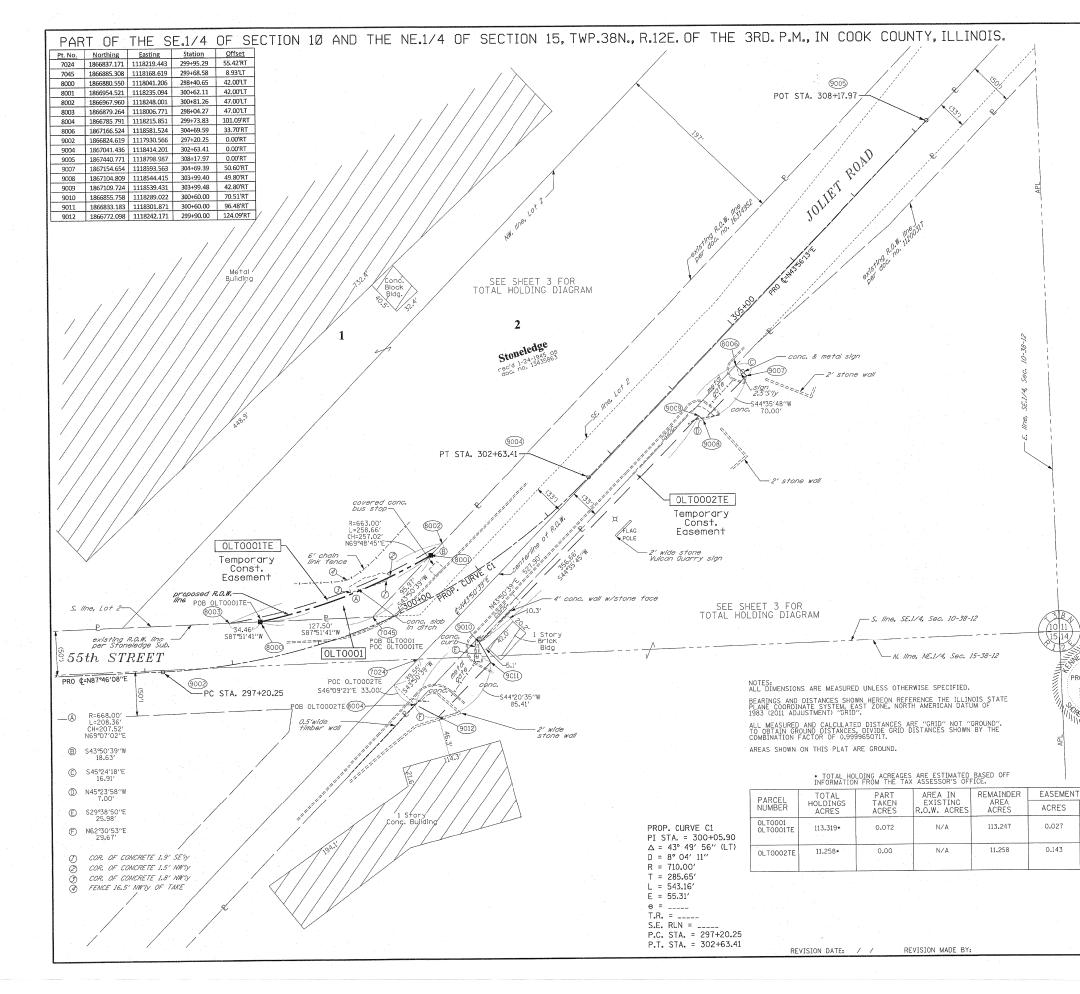



&	SIGNAGE PLAN			F.A.U. RTE. SECTION				TOTAL SHEETS	SHEET NO.
55th STREET		3562	(430V-X) N			СООК	99	38	
33	SSTA SIREEI						CONTRAC	T NO. 6	0X71
ΤS	S STA. TO STA.				ILLINOIS	FED. AI	D PROJECT		

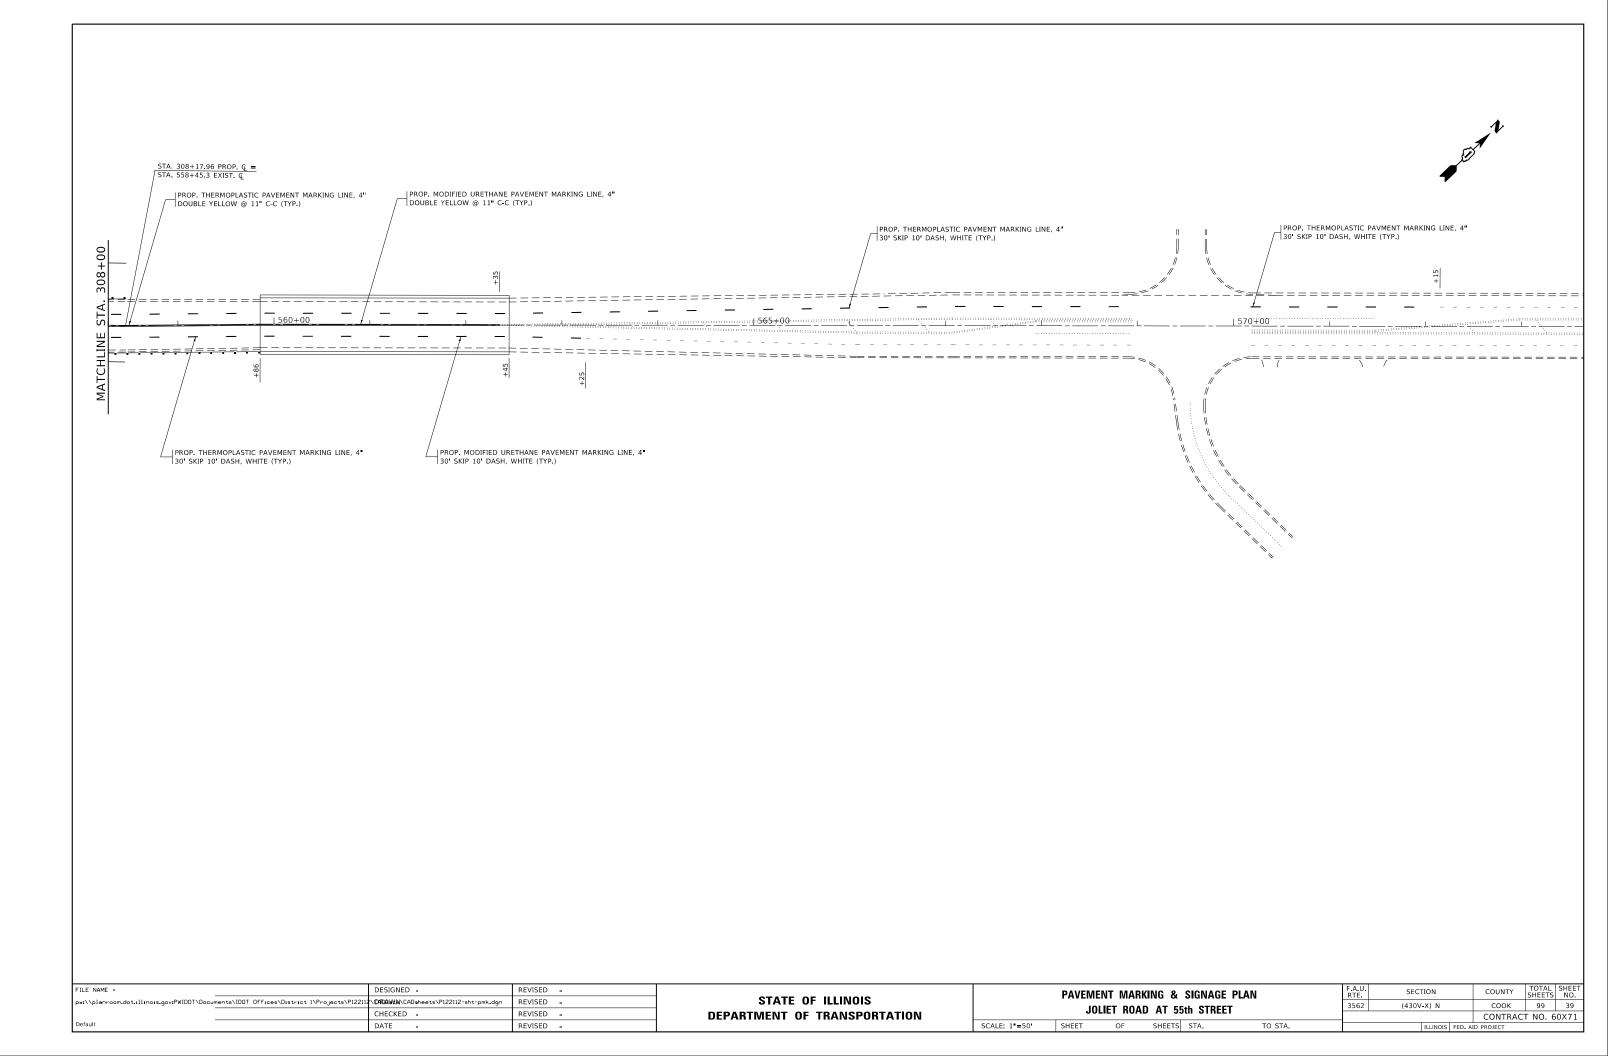

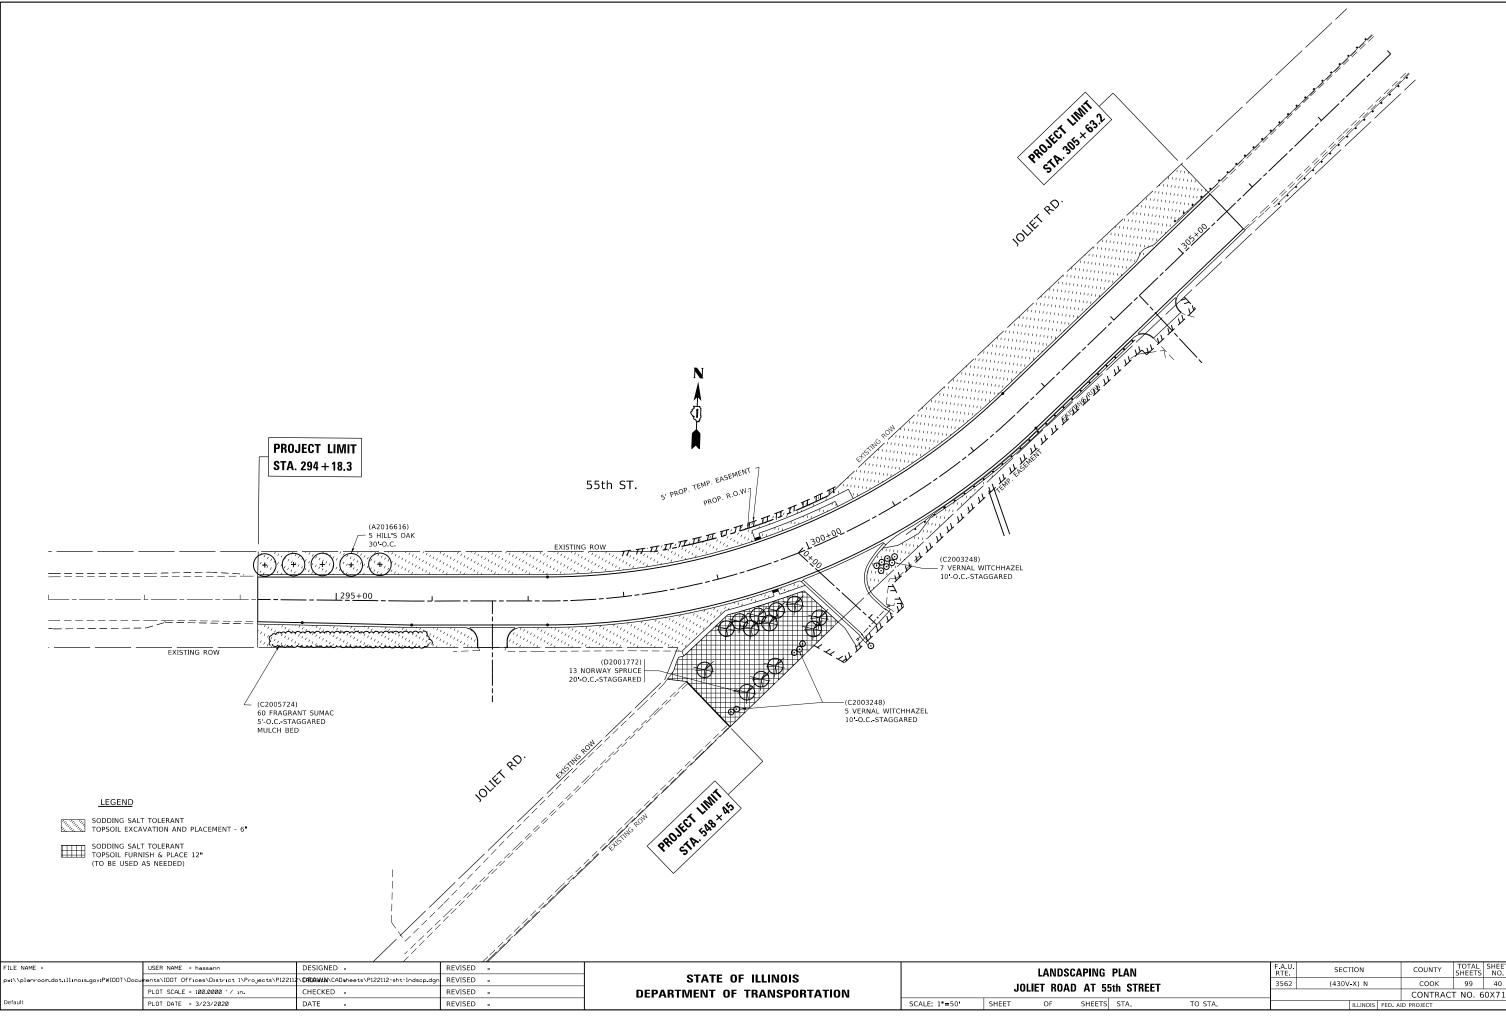

PLAN		F.A.U. RTE	F.A.U. SECTION			COUNTY	TOTAL SHEETS	SHEET NO.
th STREET		3562	(430V	-X) N		СООК 99 4		
						CONTRACT NO. 60X		
TS STA. TO STA.				ILLINOIS	FED. AI	D PROJECT		
	th STREET	th STREET	PLAN RTE. 3562	th STREET	th STREET	th STREET	th STREET	PLAN     RTE.     SECTION     COUNTY     SHEETS       th STREET     3562     (430V-X) N     COOK     99       CONTRACT NO. 6


# TRAFFIC SIGNAL LEGEND

(NOT TO SCALE)


				(NUT TO SCALE)				
ITEM	<u>EXISTING</u>	PROPOSED	ITEM	EXISTING	PROPOSED	ITEM	<b>EXISTING</b>	PROPOSED
CONTROLLER CABINET	$\bowtie$		HANDHOLE -SQUARE	$\square$		SIGNAL HEAD -(P) PROGRAMMABLE SIGNAL HEAD	R R	RR
COMMUNICATION CABINET	ECC	CC	-ROUND					R         R           Y         Y           G         G           +Y         +Y           +G         +G
MASTER CONTROLLER	EMC	MC	HEAVY DUTY HANDHOLE -SQUARE -ROUND	H (b)				$\begin{array}{c c} R & R \\ \hline Y & Y \\ \hline G & G \\ \hline \Phi Y \\ \hline \Phi G \\ \hline \Phi G \\ \hline \end{array}$
MASTER MASTER CONTROLLER	ЕММС	ммс	DOUBLE HANDHOLE				ч	
UNINTERRUPTABLE POWER SUPPLY	Þ	4	JUNCTION BOX	Q	O	SIGNAL HEAD WITH BACKPLATE -(P) PROGRAMMABLE SIGNAL HEAD	R Y Y	R   R     Y   Y
SERVICE INSTALLATION	- <u></u> P	- <b>P</b>	RAILROAD CANTILEVER MAST ARM	X <del>OX X</del> X	Xei X	-(RB) RETROREFLECTIVE BACKPLATE		$ \begin{array}{c c} \hline R \\ \hline Y \\ \hline G \\ \hline \bullet Y \\ \hline \bullet G \\ \hline \end{array} \end{array} \begin{array}{c} \hline R \\ \hline Y \\ \hline G \\ \hline \bullet Y \\ \hline \bullet G \\ \hline \end{array} \end{array} \begin{array}{c} \hline R \\ \hline Y \\ \hline G \\ \hline \bullet Y \\ \hline \bullet G \\ \hline \end{array} \end{array} \begin{array}{c} \hline R \\ \hline Y \\ \hline G \\ \hline \bullet Y \\ \hline \bullet G \\ \hline \end{array} $
-(P) POLE MOUNTED		-	RAILROAD FLASHING SIGNAL	XoX	X•X		P RB	←G ←G ←G P RB
SERVICE INSTALLATION -(G) GROUND MOUNTED -(GM) GROUND MOUNTED METERED	$\boxtimes$ $^{G} \boxtimes$ $^{GM}$	■ <sup>G</sup> ■ <sup>GM</sup>	RAILROAD CROSSING GATE	X <del>oX</del> >	X• I	PEDESTRIAN SIGNAL HEAD		
TELEPHONE CONNECTION	ET	Т	RAILROAD CROSSBUCK	¥	¥	AT RAILROAD INTERSECTIONS	<b>N</b>	1 1
STEEL MAST ARM ASSEMBLY AND POLE	0	•	RAILROAD CONTROLLER CABINET		▶ ◄	PEDESTRIAN SIGNAL HEAD	C C C	C C
ALUMINUM MAST ARM ASSEMBLY AND POLE	$\bigcirc$		UNDERGROUND CONDUIT (UC), GALVANIZED STEEL			WITH COUNTDOWN TIMER		
STEEL COMBINATION MAST ARM ASSEMBLY AND POLE WITH LUMINAIRE	0-¤—	•*	TEMPORARY SPAN WIRE, TETHER WIRE, AND CABLE			ILLUMINATED SIGN "NO LEFT TURN"/"NO RIGHT TURN"		9
SIGNAL POST -(BM) BARREL MOUNTED - TEMPORARY	0	• • BM	SYSTEM ITEM	S	SP IP	NUMBER OF CONDUCTORS, ELECTRIC CABLE NO. 14, UNLESS NOTED OTHERWISE. ALL DETECTOR LOOP CABLE TO BE SHIELDED	5	
WOOD POLE	$\otimes$	Θ	REMOVE ITEM	·	R	GROUND CABLE IN CONDUIT,		<u> </u>
GUY WIRE	$\succ$	$\succ$	RELOCATE ITEM		RL	NO. 6 SOLID COPPER (GREEN)	,	
SIGNAL HEAD		->	ABANDON ITEM		А	ELECTRIC CABLE IN CONDUIT, TRACER NO. 14 1/C	1	1
SIGNAL HEAD WITH BACKPLATE	+1>	+►	CONTROLLER CABINET AND		RCF	COAXIAL CABLE	— <u>c</u>	— <u>C</u> —
SIGNAL HEAD OPTICALLY PROGRAMMED	$- \rightarrow \rightarrow$	- <b>▶</b> <sup>P</sup> + <b>▶</b> <sup>P</sup>	FOUNDATION TO BE REMOVED MAST ARM POLE AND			VENDOR CABLE		
FLASHER INSTALLATION -(FS) SOLAR POWERED	o+⊳ <sup>F</sup> o+⊳ <sup>FS</sup>	$\bullet \bullet^{F} \bullet \bullet^{FS}$	FOUNDATION TO BE REMOVED		RMF	COPPER INTERCONNECT CABLE,		
	₽₽₽ <sup>₽</sup> ₽₽₽ <sup>₽\$</sup>	<b>₽</b> ► <sup>F</sup> <b>₽</b> ► <sup>FS</sup>	SIGNAL POST AND FOUNDATION TO BE REMOVED		RPF	NO. 18, 3 PAIR TWISTED, SHIELDED		
PEDESTRIAN SIGNAL HEAD	-0	-1	DETECTOR LOOP, TYPE I		$\Box$ $\bigcirc$	FIBER OPTIC CABLE -NO. 62.5/125, MM12F	12F	
PEDESTRIAN PUSH BUTTON -(APS) ACCESSIBLE PEDESTRIAN PUSH BUTTON	Ø Ø APS	Ø APS	PREFORMED DETECTOR LOOP	Р	PP	-NO. 62.5/125, MM12F SM12F -NO. 62.5/125, MM12F SM24F	24F	24F
RADAR DETECTION SENSOR	R	R	SAMPLING (SYSTEM) DETECTOR	5 (5)	s s		36F	36F
VIDEO DETECTION CAMERA			INTERSECTION AND SAMPLING (SYSTEM) DETECTOR	IS (IS)	IS (IS)			
RADAR/VIDEO DETECTION ZONE			QUEUE AND SAMPLING	Q5 Q5	Q5 Q5	GROUND ROD -(C) CONTROLLER -(M) MAST ARM	<sup>≟C</sup> ≟ <sup>M</sup> ≟ <sup>P</sup> ≟ <sup>S</sup>	≟C ≟ <sup>M</sup> ≟ <sup>P</sup> ≟ <sup>S</sup>
PAN, TILT, ZOOM (PTZ) CAMERA	PTZ	PTZ	(SYSTEM) DETECTOR WIRELESS DETECTOR SENSOR	@	<u>@</u>	-(M) MASI ARM -(P) POST -(S) SERVICE		
EMERGENCY VEHICLE LIGHT DETECTOR	$\sim$	-	WIRELESS ACCESS POINT		<b>—</b>			
CONFIMATION BEACON	0(]	+1		¥				
WIRELESS INTERCONNECT	0++++++	<b>●+</b> +   -						
WIRELESS INTERCONNECT RADIO REPEATER	ERR	RR						
USER NAME = hassan		REVISED				DISTRICT ONE	F.A.U. RTE. SECTIO	N COUNTY TOTAL SHEE'S NO.
PLOT SCALE = 100.000	0 ' / in. CHECKED -	REVISED REVISED		TE OF ILLINOIS T OF TRANSPORTATION		ANDARD TRAFFIC SIGNAL DESIGN DETAILS	3562 (430V-X <b>TS-05</b>	)N СООК 99 41 СОNTRACT NO. 60Х71
PLOT DATE = 3/23/20	20 DATE -	REVISED		····· ··· ··· ··· ··· ··· ··· ··· ···	SCALE: NONE	SHEET 2 OF 7 SHEETS STA. TO STA.		INOIS FED. AID PROJECT

#### LOOP DETECTOR NOTES

- 1. EACH PAIR OF LOOP WIRES SHALL BE PLACED IN A SEPARATE EMPTY COILABLE NONMETALLIC CONDUIT FROM THE EDGE OF PAVEMENT TO THE HANDHOLE. SPACING BETWEEN THE HOLES DRILLED IN THE PAVEMENT SHALL NOT BE LESS THAN 6" (150 mm). EMPTY COILABLE NONMETALLIC CONDUIT SHALL BE INCLUDED IN THE COST OF THE LOOP WIRE.
- 2. THE NUMBER OF LOOP TURNS SHALL BE AS RECOMMENDED BY THE AMPLIFIER MANUFACTURER. ALL ADJACENT SIDES OF THE LOOPS SHALL BE INSTALLED IN SUCH A WAY THAT THE CURRENT FLOW IS IN THE SAME DIRECTION TO REINFORCE ITS MAGNETIC FIELDS FOR SMALL VEHICLE DETECTION.
- 3. EACH LOOP LEAD-IN SHALL BE IDENTIFIED AND PERMANENTLY TAGGED IN THE HANDHOLE. EACH LEAD-IN CABLE TAG SHALL INDICATE THE LOCATION OF THE LOOP, LOOP ROTATION (CLOCKWISE/COUNTERCLOCKWISE), LOOP LEAD-IN DIRECTION (IN OR OUT), LOOP CABLE NUMBER AND LOCATION IN CABINET, AND NUMBER OF TURNS IN THE DETECTOR LOOPS IN WATER PROOF INK AS INDICATED ON THE DISTRICT 1 STANDARD TRAFFIC SIGNAL DESIGN DETAIL. THE CONTRACTOR SHALL MARK LOOP LOCATIONS ON RECORD DRAWINGS AND PRESENT TO THE ENGINEER AFTER FINAL INSPECTION. LOOPS SHALL BE MARKED BY LANE AND LOOP NUMBER. SEE DETAIL BELOW.
- 4. ALL LOOP CABLE SHALL BE FASTENED WITH PLASTIC TIE WRAP TO THE HANDHOLE HOOKS.
- 5. IN ASPHALT PAVEMENT, LOOPS SHOULD BE PLACED IN THE BINDER AND DIVEHOLES MARKED AT THE CURB WITH A SAW-CUT. THE SAW-CUT SHALL BE CUT IN ACCORDANCE WITH LOCAL AND E.P.A. DUST CONTROL REQUIREMENTS. DETECTOR LOOP(S) SHALL NOT BE INSTALLED IN WET CONDITIONS AND THE SAW-CUTS MUST BE FREE OF DEBRIS AND RESIDUE SUCH AS DUST AND WATER WHICH IS TO BE ACHIEVED BY THE USE OF COMPRESSED AIR, WIRE BRUSHING AND HEAT DRYING ACCORDING TO SEALANT MANUFACTURER REQUIREMENTS. THE DETECTOR WIRE SHALL BE HELD IN PLACE BY THE USE OF FORM WEDGES. WEDGES SHALL BE SPACED NO MORE THAN 18" (450 mm) APART.
- 6. LOOP SPLICES SHALL BE SOLDERED USING A SOLDERING IRON. BLOW TORCHES OR OTHER DEVICES WHICH OXIDIZE COPPER CABLE SHALL NOT BE ALLOWED FOR SOLDERING OPERATIONS. SEE DETAIL BELOW RIGHT.
- 7. PREFORMED DETECTOR LOOPS SHALL BE USED, AS SHOWN ON THE PLANS, WHERE NEW CONCRETE PAVEMENT IS PROPOSED. THE INSTALLATION OF PREFORMED LOOPS SHALL BE IN ACCORDANCE WITH THE DISTRICT 1 SPECIFICATIONS OR AS DIRECTED BY THE ENGINEER

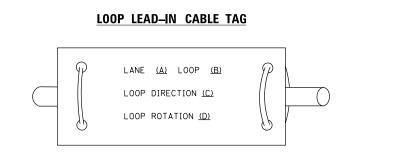


- A. LANE 1 IS THE LANE CLOSEST TO THE CENTERLINE OF THE ROADWAY
- B. LOOP #1 IS THE LOOP IN THE LANE CLOSEST TO THE INTERSECTION.
- C. LABEL LOOP CABLE "IN" OR LOOP CABLE "OUT".
- D. LABEL LOOP CABLE CLOCKWISE OR LOOP CABLE COUNTERCLOCKWISE.

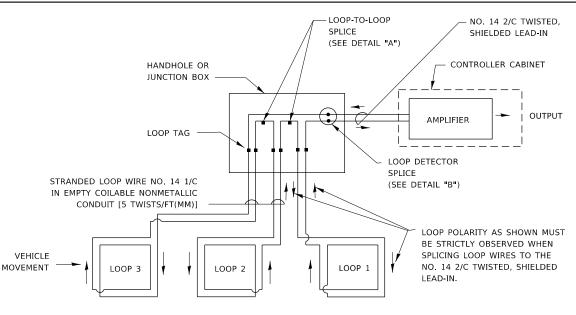

#### DETECTOR LOOP WIRING SCHEMATIC

- LOOPS SHALL BE SPLICED IN SERIES. SAW-CUTS SHALL BE A MINIMUM WIDTH OF 5/16" (8 mm).
- SAW-CUT DEPTHS SHALL BE 3" (75 mm). IF IN CONCRETE,
- THE SAW-CUT DEPTH SHALL BE TO THE TOP OF THE REINFORCEMENT.
- LOOP CORNERS SHALL BE DRILLED WITH A 2" (50 mm) DIAMETER CORE.

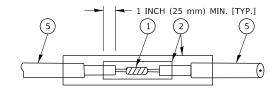


DETAIL "A" LOOP-TO-LOOP SPLICE

(6) 36" TO 60" 1" (25mm) MIN. (TYP) 36" TO 60" DETAIL "A" LOOP-TO-LOOP SPLICE

#### LOOP DETECTOR SPLICE


- (1) WESTERN UNION SPLICE SOLDERED WITH ROSIN CORE FLUX. ALL EXPOSED SURFACES OF THE SOLDER SHALL BE SMOOTH. THE WESTERN UNION SPLICES SHALL BE STAGGERED.
- (2) WCSMW 30/100 HEAT SHRINK TUBE, MINIMUM LENGTH 3" (75 mm), UNDERWATER GRADE
- (3) WCS 200/750 HEAT SHRINK TUBE, MINIMUM LENGHT 6" (150 mm), UNDERWATER GRADE.
- (4) NO. 14 2/C TWISTED, SHIELDED CABLE.

USER NAME = hassann	DESIGNED -	REVISED -			DISTRICT O	NF		F A U BTE	SECTION	COUNTY	TOTAL SHEET SHEETS NO.
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PLOT SCALE = 100.0000 / in.	CHECKED -	REVISED -	DEPARTMENT OF TRANSPORTATION	3		ETAILS		TS-05	CONTRACT	i NO. 60X71	
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LOOP-TO-CONTROLLER SPLICE

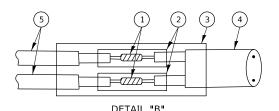
#### TYPE I LOOP




#### PRE-FORMED LOOP

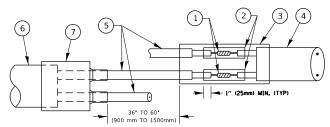DETAIL "B" LOOP-TO-CONTROLLER SPLICE

- 5 LOOP CONDUCTOR WITH FLEXIBLE PLASTIC TUBE. PRE-FORMED LOOP
- (6) XL POLYOLEFIN 2 CONDUCTOR
- (7) BREAKOUT SEALS. TYCO CBR-2 OR APPROVED EQUAL

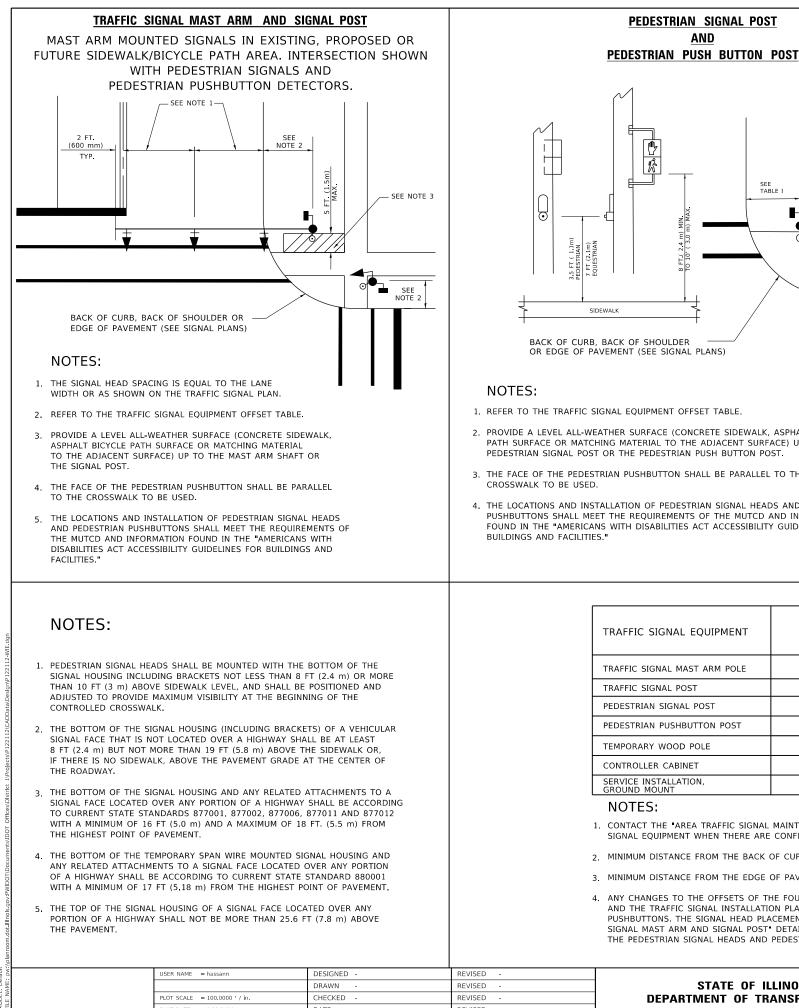

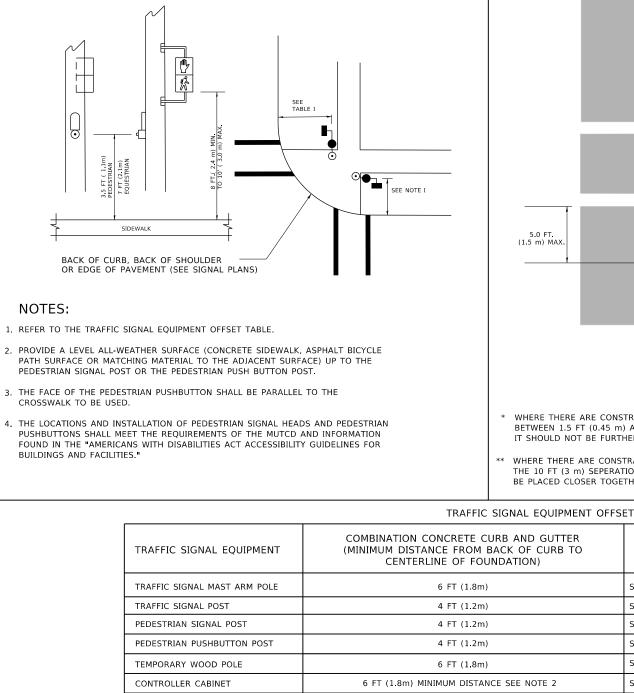

**PEDESTRIAN SIGNAL POST** 

AND

#### NOTES:

1. CONTACT THE "AREA TRAFFIC SIGNAL MAINTENANCE AND OPERATIONS ENGINEER" FOR ASSISTANCE IN LOCATING THE TRAFFIC SIGNAL EQUIPMENT WHEN THERE ARE CONFLICTS WITH DITCHES OR THE MINIMUM OFFSET DISTANCES CANNOT BE MET.


6 FT (1.8m) MINIMUM DISTANCE SEE NOTE 2


2. MINIMUM DISTANCE FROM THE BACK OF CURB TO THE ROADWAY SIDE OF THE FOUNDATION.

3. MINIMUM DISTANCE FROM THE EDGE OF PAVEMENT TOTHE ROADWAY SIDE OF THE FOUNDATION.


4. ANY CHANGES TO THE OFFSETS OF THE FOUNDATIONS, FROM THE MINIMUM DISTANCES LISTED IN THE "TRAFFIC SIGNAL EQUIPMENT OFFSET" CHART AND THE TRAFFIC SIGNAL INSTALLATION PLAN, COULD EFFECT THE PLACEMENT OF THE SIGNAL HEADS, PEDESTRIAN SIGNAL HEADS AND THE PEDESTRIAN PUSHBUTTONS, THE SIGNAL HEAD PLACEMENT ON THE MAST ARMS SHALL REMAIN AS PER THE TRAFFIC SIGNAL INSTALLATION PLAN AND THE "TRAFFIC SIGNAL MAST ARM AND SIGNAL POST DETAIL ABOVE. THE PROPOSED MAST ARM LENGTHS MAY NEED TO BE REVISED TO MEET THE ABOVE REQUIREMENTS. THE PEDESTRIAN SIGNAL HEADS AND PEDESTRIAN PUSHBUTTONS MUST MEET THE REQUIREMENTS UNDER THE DETAILS ON THIS SHEET

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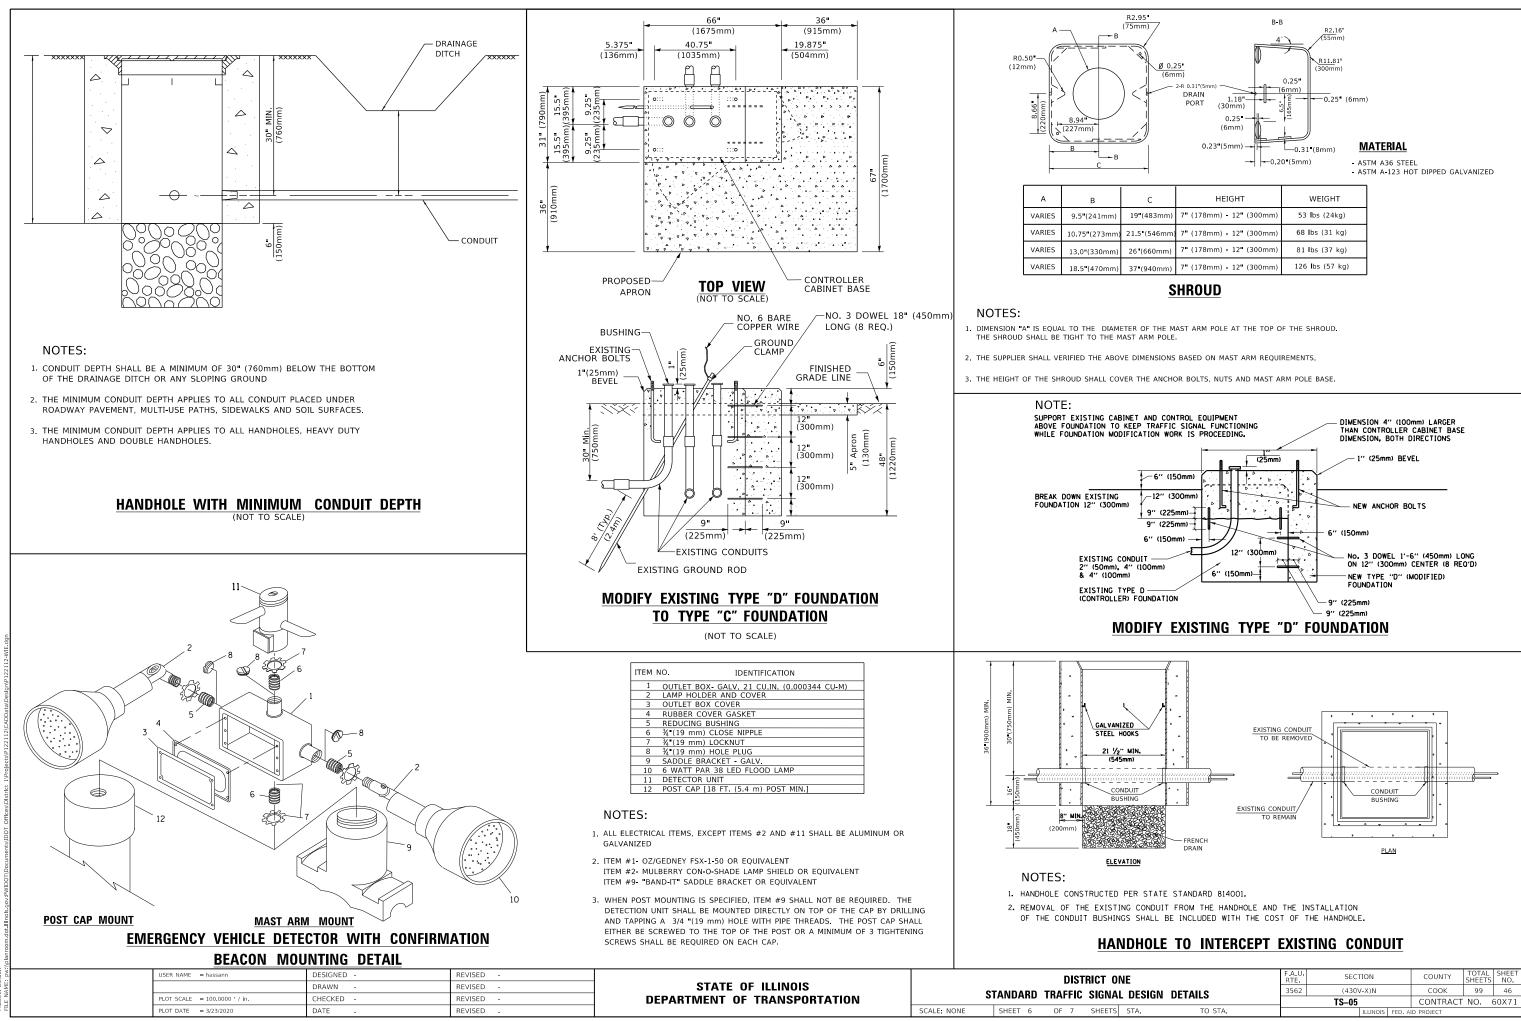
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	AL DESIGN DETAILS			TS05		CONTRACT	NO.	60X71
TS	STA.	TO STA.			ILLINOIS FED. A	ID PROJECT		

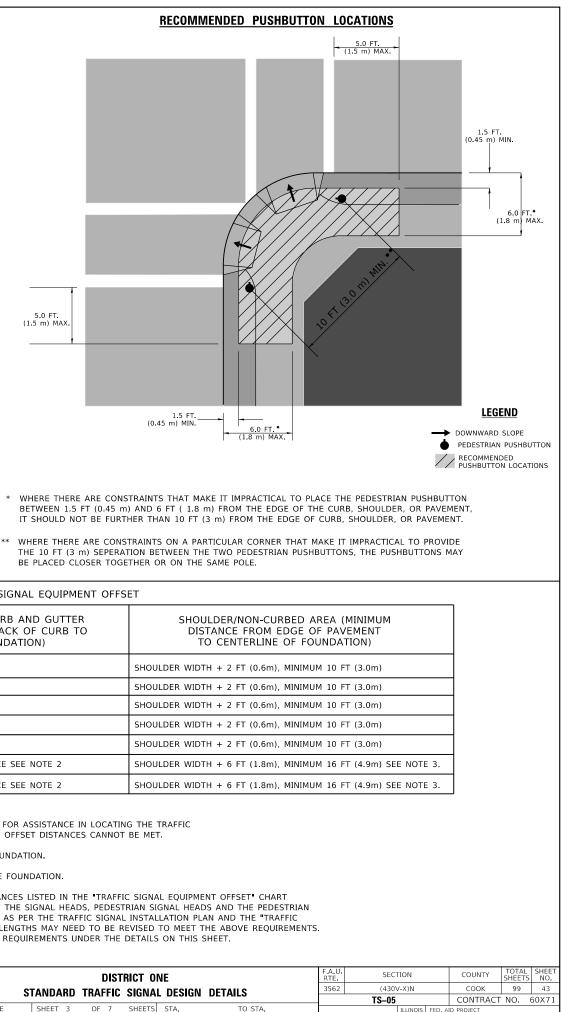
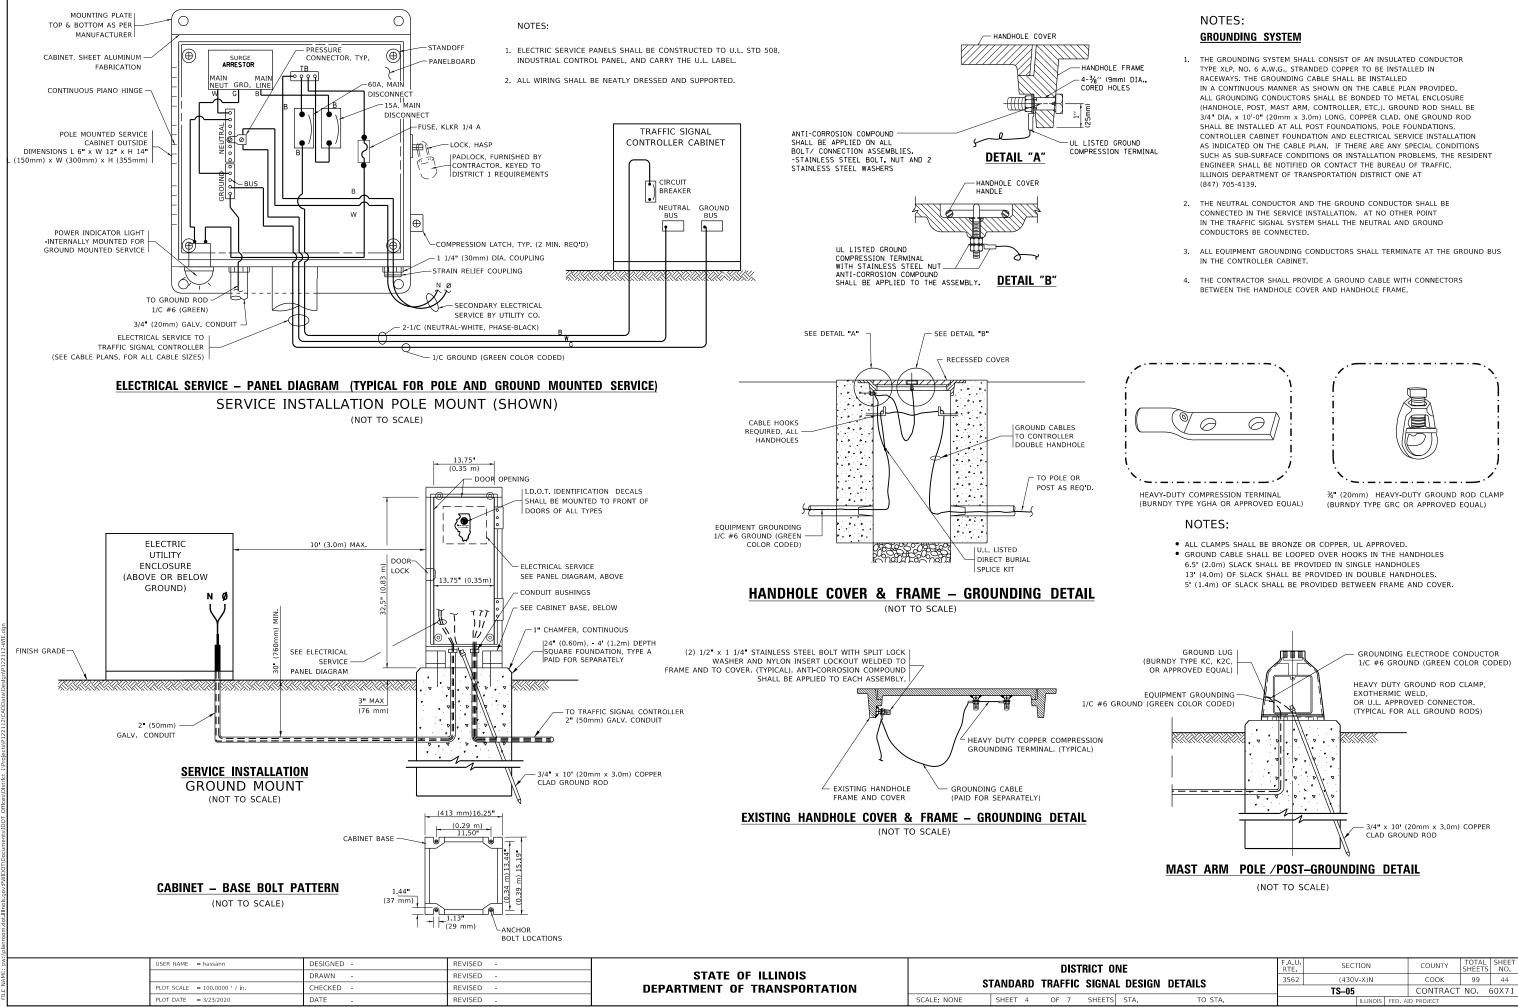
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PLOT DATE = 3/23/2020	DATE -	REVISED -		SCALE: NONE SHEET 5 OF 7 SHEETS STA. TO STA.	ILLINOIS FED. A	.ID PROJECT


ength	① Foundation Depth	Foundation Diameter	Spiral Diameter	Quantity of Rebars	Size of Rebars
′ (9 <b>.</b> 1 m)	10'-0'' (3.0 m)	30" (750mm)	24'' (600mm)	8	6(19)
r equal to	13'-6'' (4.1 m)	30" (750mm)	24'' (600mm)	8	6(19)
less than m)	11'-0'' (3.4 m)	36'' (900mm)	30'' (750mm)	12	7(22)
r equal to less than m)	13'-0'' (4.0 m)	36'' (900mm)	30" (750mm)	12	7(22)
r equal to nd up to m)	15'-0'' (4.6 m)	36'' (900mm)	30'' (750mm)	12	7(22)
r equal to less than m)	21'-0'' (6.4 m)	42'' (1060mm)	36'' (900mm)	16	8(25)
r equal to nd up to m)	25'-0'' (7.6 m)	42'' (1060mm)	36'' (900mm)	16	8(25)
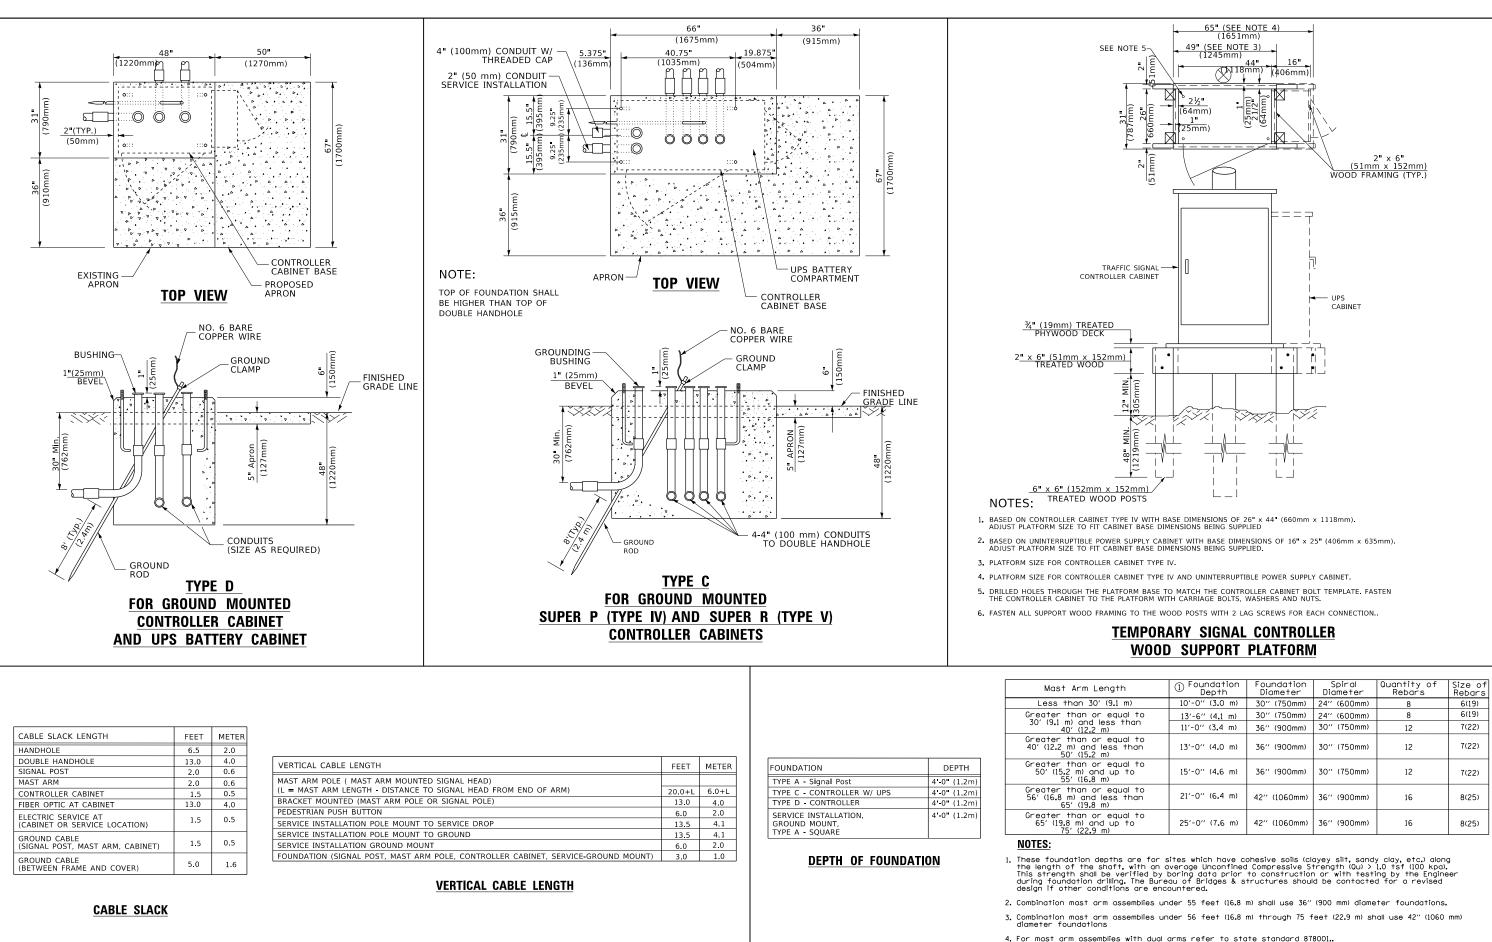
## DEPTH OF MAST ARM FOUNDATIONS, TYPE E




	с	HEIGHT	WEIGHT
n)	19 <b>"</b> (483mm)	7" (178mm) - 12" (300mm)	53 <b>I</b> bs (24kg)
m)	21.5"(546mm)	7" (178mm) - 12" (300mm)	68 <b>l</b> bs (31 kg)
n)	26"(660mm)	7" (178mm) - 12" (300mm)	81 lbs (37 kg)
n)	37 <b>"</b> (940mm)	7" (178mm) - 12" (300mm)	126 <b>l</b> bs (57 kg)

ONE		F.A.U. RTE	SECT	TION		COUNTY TOTAL SHEETS		SHEET NO.
AL DESIGN DETAILS		3562	(430\	(430V-X)N			99	46
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IS STA.	TO STA.			ILLINOIS	FED. AI	ID PROJECT		

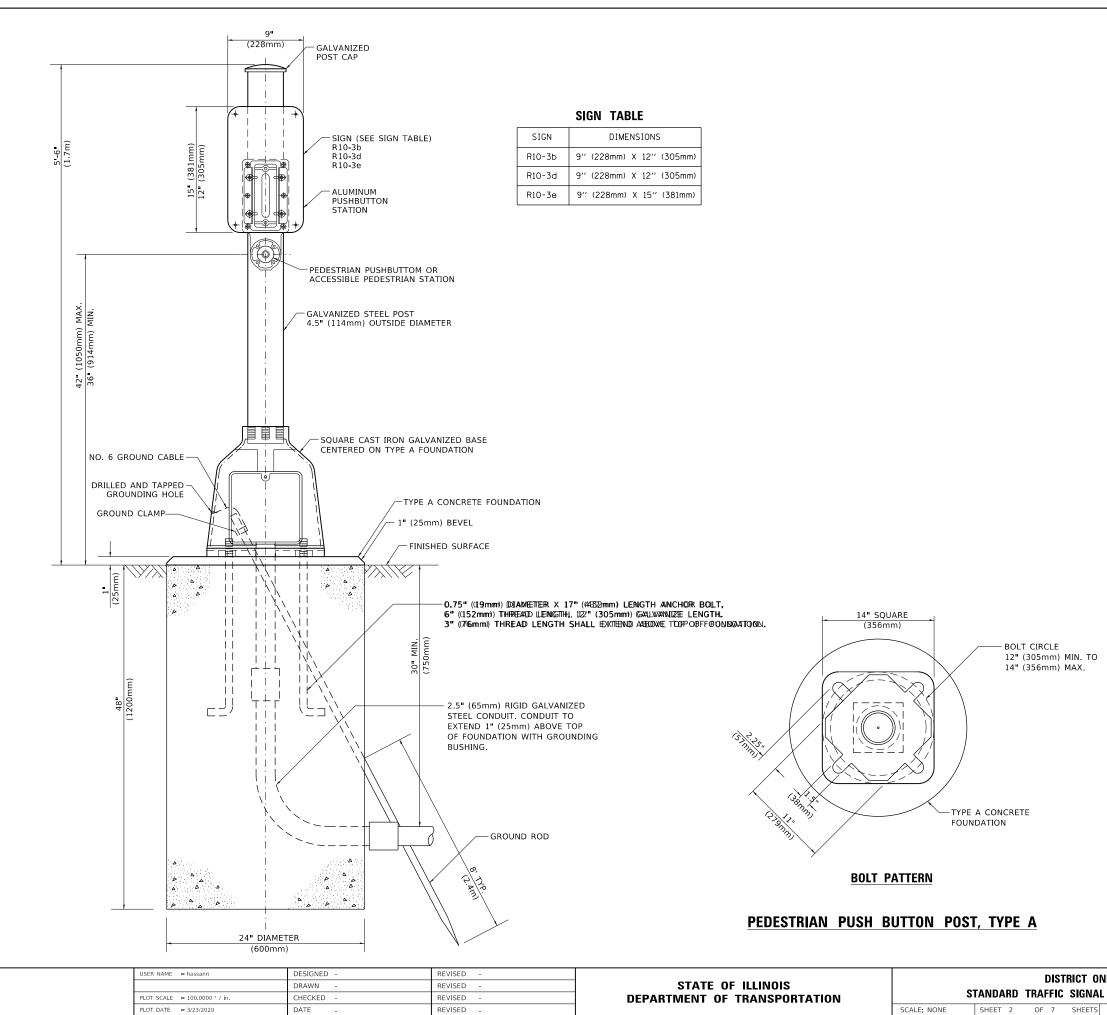

10	NE		F.A.U. RTE	SEC	FION		COUNTY	TOTAL SHEETS	SHEET NO.
AL DESIGN DETAILS		3562	(430)	(430V-X)N			99	47	
	AL DESIGN DETAILS			TS05			CONTRACT	NO.	50X71
TS	STA. TO STA.				ILLINOIS	FED. A	ID PROJECT		

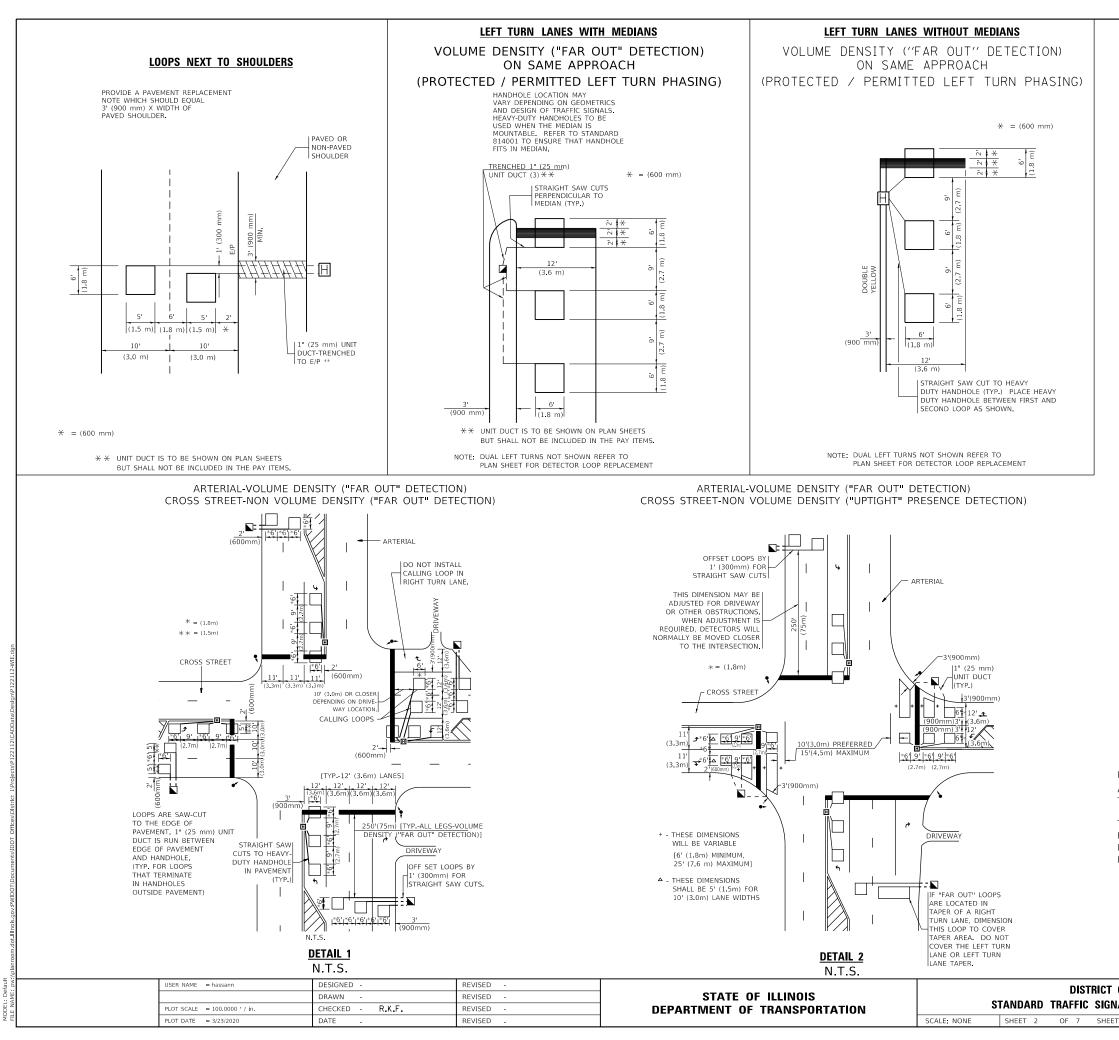

NOTES:

#### VEHICLES LOOP DETECTORS

- \* ALL LEAD IN CABLE SHALL BE TWO CONDUCTOR NO. 14 TWISTED, SHIELDED.
- \* EACH DETECTOR LOOP SHALL HAVE ITS OWN SAW CUT FROM THE LOOP TO THE EDGE OF PAVEMENT OR TO A HANDHOLE IN THE PAVEMENT.
- \* EACH DETECTOR LOOP SHALL HAVE ITS OWN ONE INCH (25 mm) UNIT DUCT BETWEEN THE EDGE OF PAVEMENT AND THE FIRST HANDHOLE OR JUNCTION BOX. EACH UNIT DUCT RUN SHALL BE SHOWN ON THE PLANS BY THE DESIGNER, BUT SHALL NOT BE PAID FOR SEPARATLY. THIS ITEM IS INCIDENTAL TO THE PAY ITEM FOR DETECTOR LOOPS.
- \* ONE DIMENSION OF <u>ALL</u> DETECTOR LOOPS SHALL BE SIX FEET (1.8 m)
- \* EACH LANE OF NON-LOCKING, PRESENCE DETECTION AND EACH LANE OF A DOUBLE LEFT TURN LANE REQUIRES A SEPARATE INDUCTIVE LOOP DETECTOR AND LEAD IN CABLE.
- \* WHEN NON-LOCKING, PRESENCE DETECTION IS USED, <u>MORE</u> THAN ONE LOOP PER LANE IS REQUIRED BEHIND THE STOP BAR (i.e. 1-1/2, 1-3/4, 2).
- \* WHEN SYSTEM LOOPS ARE REQUIRED ON AN APPROACH OF AN INTERSECTION, THE LOOPS USED FOR VOLUME DENSITY AND INTERSECTION TIMING SHALL ALSO BE USED AS SYSTEM DETECTORS. <u>EACH</u> ONE OF THESE TYPE OF LOOPS REQUIRES A <u>SEPARATE</u> TWO CONDUCTOR NO. 14 TWISTED SHIELDED CABLE AND A <u>SEPARATE</u> INDUCTIVE LOOP DETECTOR WHEN NEW CONTROLLERS ARE UTILIZED. THE DESIGNER SHALL LABEL THESE TYPES OF LOOPS AS "INTERSECTION AND SAMPLING (SYSTEM) DETECTORS" ON THE SIGNAL LAYOUT, THE INTERCONNECT PLAN AND THE SYSTEM CABLE PLAN. WHEN AN EXISTING CONTROLLER IS UTILIZED FOR THIS TYPE OF DETECTION, THE PAY ITEM "INDUCTIVE LOOP DETECTOR WITH SYSTEM OUTPUT" SHOULD BE USED.

#### PLACEMENT OF DETECTORS

THE FOLLOWING FIGURES REPRESENT THE MOST COMMON DETECTOR LOOP LOCATIONS AND SIZES. ADJUSTMENTS WILL BE NECESSARY FOR SPECIFIC GEOMETRIC CONSIDERATIONS.

LOCATIONS AND DEMENSIONS OF DETECTOR LOOPS ARE REQUIRED ON <u>ALL</u> SIGNAL LAYOUT PLAN SHEETS.


"FAR OUT" DETECTION REFERS TO LOCKING, PRESENCE TYPE DETECTION LOCATED IN THRU LANES, RIGHT TURN LANES, AND RIGHT TURN LANE TAPER AREAS (IF APPLICABLE), USUALLY 250' (75 m) IN ADVANCE OF STOP BARS. "UPTIGHT" DETECTION REFERS TO NON-LOCKING PRESENCE TYPE DETECTION LOCATED IN ALL LANES AND 10'-15' (3.0 m-4.5 m) BEHIND THE CROSSING STREET'S EDGE OF PAVEMENT EXTENDED.

NOTE:


ALL DETAILS AND NOTES SHOWN ARE FROM THE I.D.O.T. DISTRICT 1 TRAFFIC SIGNAL DESIGN GUIDELINES DATED JANUARY 1995

THIS DRAWING HAS BEEN PREPARED TO ASSIST THE RESIDENT ENGINEER FOR ALL ROADWAY RESURFACING OR S.M.A.R.T. PROJECTS WHERE THE DIMENSIONS ARE NOT SHOWN ON THE PLANS AND THE FINAL LOCATIONS FOR CROSSWALKS OR STOP BARS ARE NOT DETERMINED.

0	NE		F.A.U. RTE	A.U. SECTION			COUNTY	TOTAL SHEETS	SHEET NO.
1.	AL DESIGN DETAILS			(430\	(430V-X)N			99	48
	AL DESIGN DETAILS			TS07			CONTRACT	NO.	60X71
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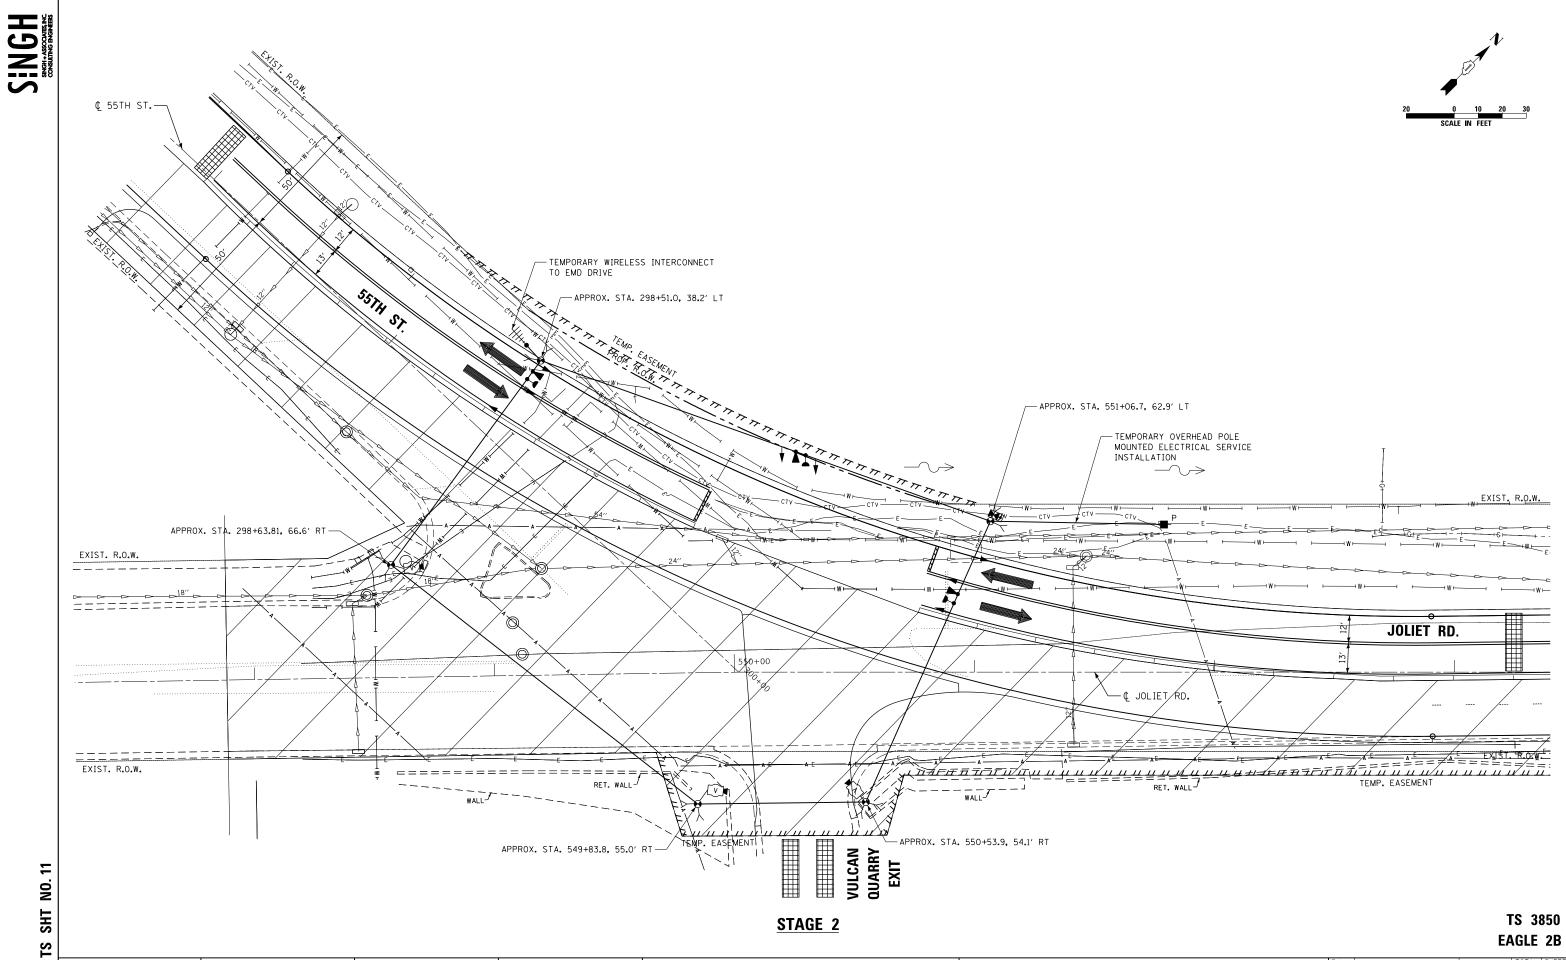

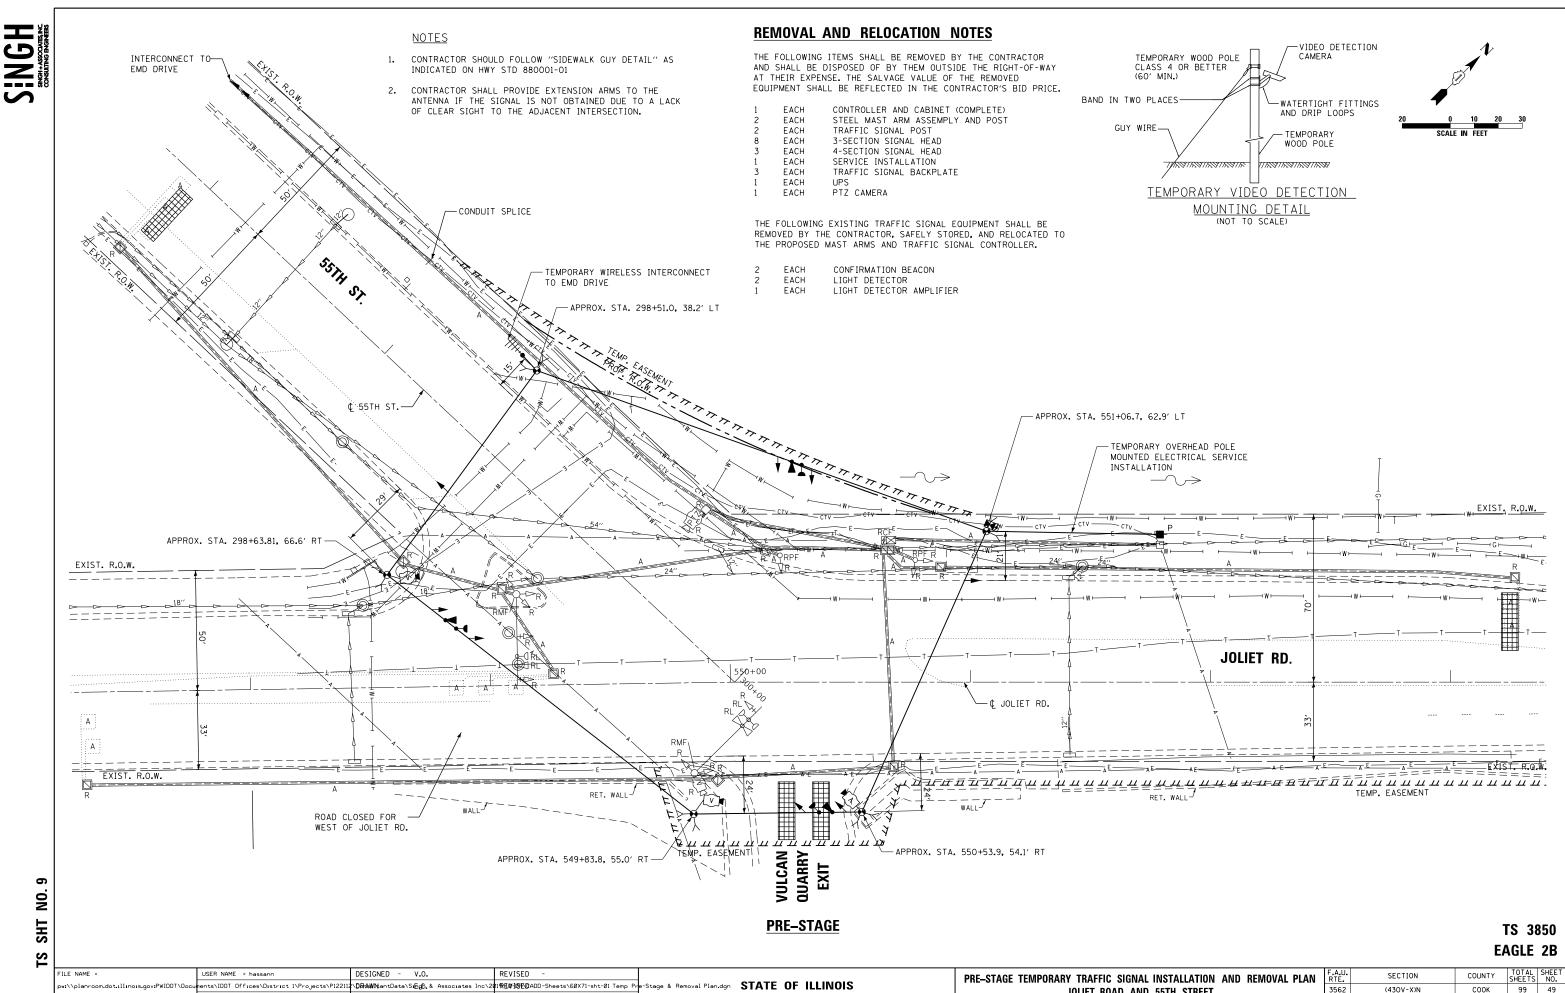
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	PLOT DATE = 3/23/2020	DATE -	5/24/2019	REVISED -		SCALE: 1''=20'	SHEET NO. OF	SHEETS	STA. N/A	TO STA. N/A		ILLINOIS FED. A	ID PROJECT		

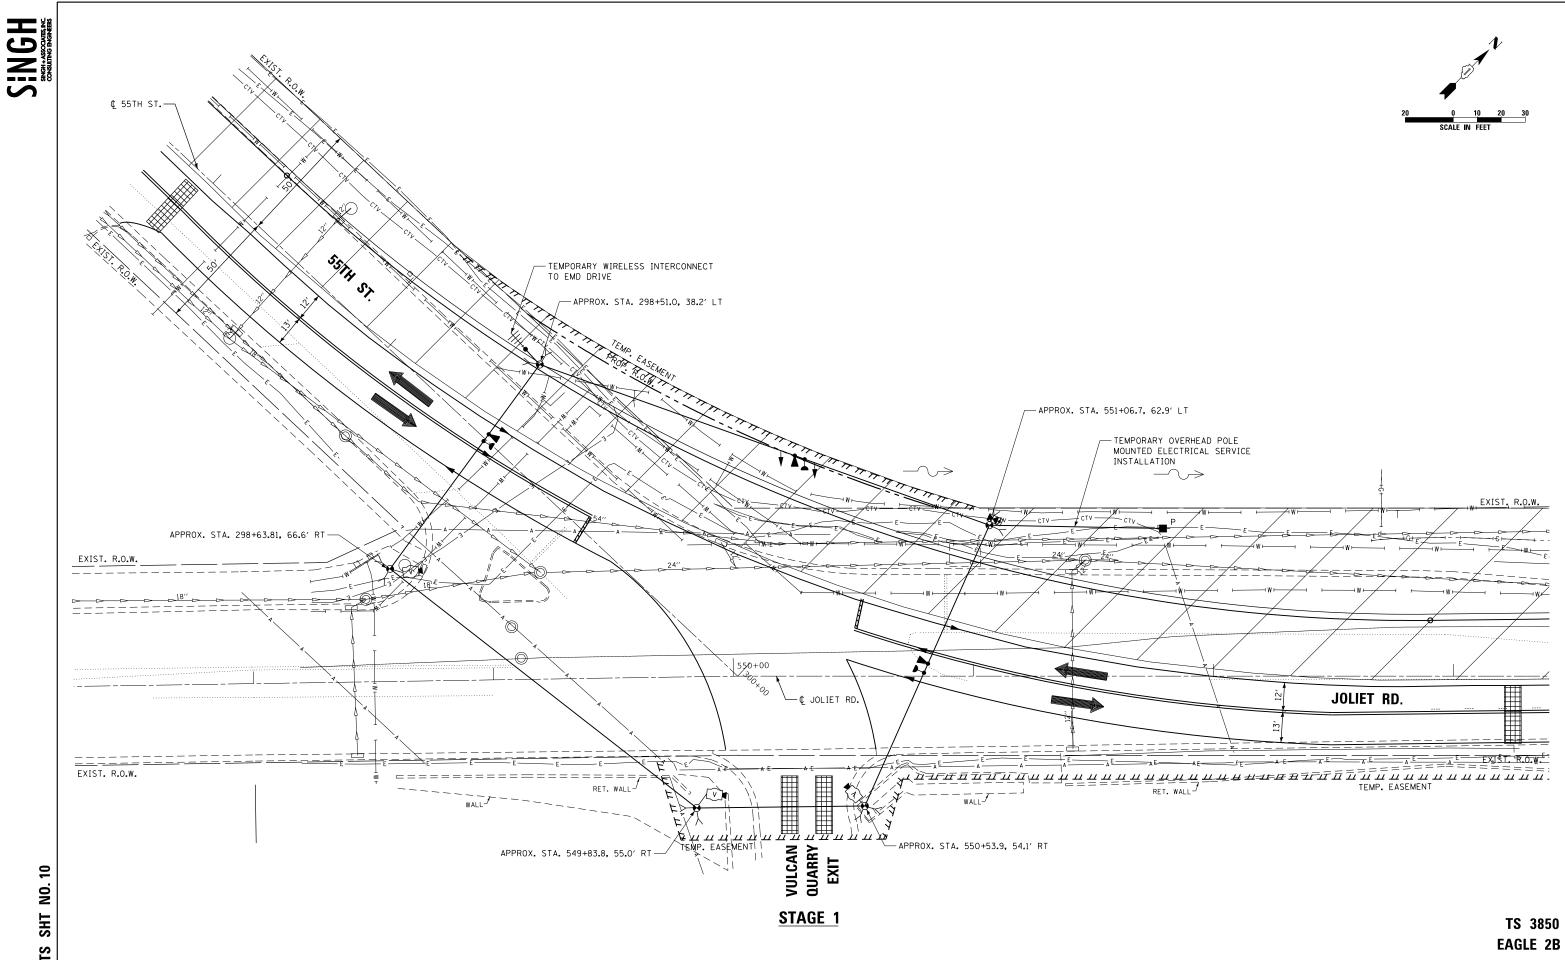


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	PLOT DATE = 3/23/2020	DATE - 5/24/2019	REVISED -		SCALE: 1"=20' SHEET NO. 1 OF 1 SHEETS STA. N/A TO STA. N/A		ILLINOIS FED.	



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	PLOT SCALE = 40.0000 '/ in.	CHECKED - L.S.	REVISED -	DEPARTMENT OF TRANSPORTATION		_		CONTRACT N	NO. 60X71
	PLOT DATE = 3/23/2020	DATE - 5/24/2019	REVISED -		SCALE: 1''=20' SHEET NO. OF SHEETS STA. N/A TO STA. N/A		ILLINOIS FED. A	ID PROJECT	




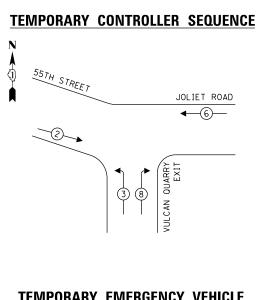


## LEGEND:

- ← (\*)- PROTECTED/PERMITTED PHASE
- ◄- (\*)- ► PEDESTRIAN PHASE
- OVERLAP



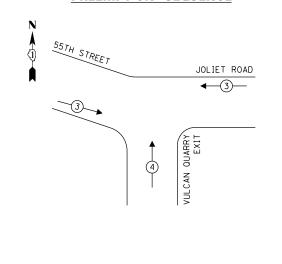


		C SIGN		
ELECTRICA	L SERV	VICE RE	QUIKEME	NIS
	NO. OF	LED	%	TOTAL
TYPE	LAMPS	WATTAGE	OPERATION	WATTAG
SIGNAL (RED)	8	11	50	44.0
(YELLOW)	8	20	5	8.0
(GREEN)	8	12	45	43.2
PERMISSIVE ARROW	-	10	10	-
PED. SIGNAL	-	20	100	-
CONTROLLER	1	100	100	100.0
UPS	1	25	100	25.0
VIDEO SYSTEM	1	150	100	150.0
BLANK-OUT SIGN	-	25	5	-
FLASHER	-	-	50	-
STREET NAME SIGN	-	120	50	-
LUMINAIRE	-	-	-	-
			TOTAL =	370.2
ENERGY COSTS TO:				
VILLAGE OF N	ссоок			
5000 GLENCOE AVEN	NUE			
MCCOOK, IL 60525				
ENERGY SUPPLY: C	ONTACT.			
ENERGY SUFFERE C	· · · ·	(866) 639-	3532	
			ALTH EDISON	
TOWER ACCOUNT				
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TOWER ACCOUNT NUMBER:O	9930-15151											
FILE NAME =	USER NAME = hassann	DESIGNED -	V.O.	REVISED -		Р	RE-STAGE CABLE PLAN, PHASE DESIGNATION DIAGR	AM, AND	F.A.U.	SECTION	COUNTY TOT	TAL SHEET
pw://planroom.dot.illinois.gov:PWIDOT/Docum	ents\IDOT_Offices\District_l\Projects\P122112	\ <b>DBrAWN</b> tantData	\Si <b>Eg6.</b> & Associates Inc\2	01\$ <b>₩∃Ø-]\$\$₽©</b> ADD-Sheets\60X71-sht-04 Temp C	Cable Plan.dgn STATE OF ILLINOIS		EMERGENCY VEHICLE PREEMPTION SEQUENCE		3562	(430V-X)N	СООК 99	9 52
	PLOT SCALE = 40.0000 ' / in.	CHECKED -	L <b>.S.</b>	REVISED -	DEPARTMENT OF TRANSPORTATION		JOLIET ROAD AND 55TH STREET				CONTRACT NO	J. 60X71
	PLOT DATE = 3/23/2020	DATE -	5/24/2019	REVISED -		SCALE: NTS	SHEET NO. 1 OF 1 SHEETS STA. N/A	TO STA. N/A		ILLINOIS FED. A		

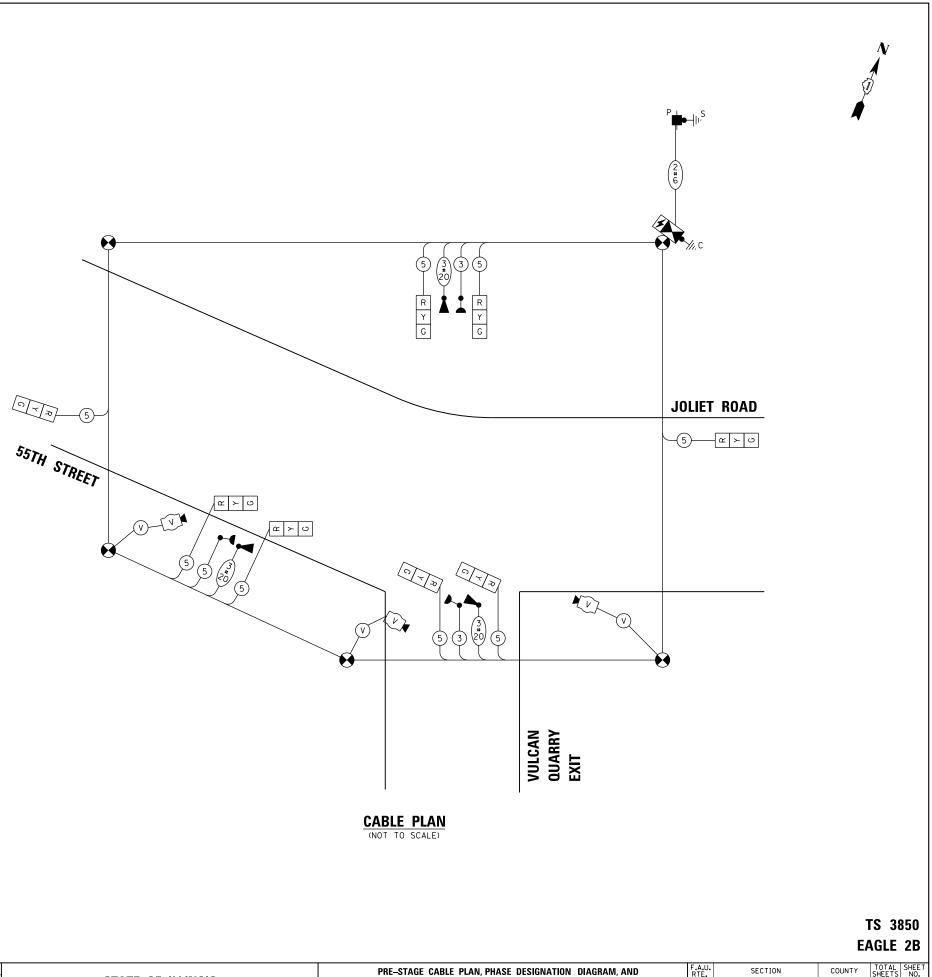




## LEGEND:

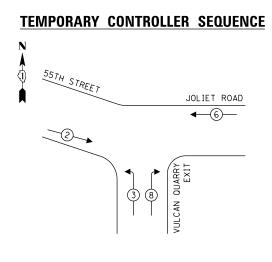
← (\*) PROTECTED PHASE

- ← (\*)- PROTECTED/PERMITTED PHASE
- ◄- (\*)- ► PEDESTRIAN PHASE
- OVERLAP



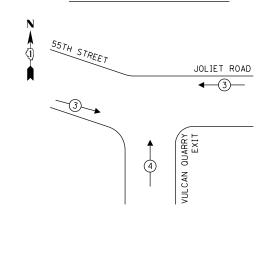


	TRAFFI	C SIGN	AL	
ELECTRICA	L SERV	VICE RE	QUIREMEI	NTS
	NO. OF	LED	%	TOTAL
TYPE	LAMPS	WATTAGE	OPERATION	WATTAG
SIGNAL (RED)	8	11	50	44.0
(YELLOW)	8	20	5	8.0
(GREEN)	8	12	45	43.2
PERMISSIVE ARROW	-	10	10	-
PED. SIGNAL	-	20	100	-
CONTROLLER	1	100	100	100.0
UPS	1	25	100	25.0
VIDEO SYSTEM	1	150	100	150.0
BLANK-OUT SIGN	-	25	5	-
FLASHER	-	-	50	-
STREET NAME SIGN	-	120	50	-
LUMINAIRE	-	-	-	-
ENERGY COSTS TO:			TOTAL =	370.2
VILLAGE OF N 5000 glencoe aven Mccook, il 60525				
ENERGY SUPPLY: C	ONTACT:			
	PHONE:	(866) 639-	3532	
C	OMPANY	COMMONWE	ALTH EDISON	
TOWER ACCOUNT		09930-1515	51	
FILE NAME =		USER NAME	= hassann	
pw://planroom.dot.illinois.go		suments\IDOT_Of	fices\District_1\F	rojects\P12

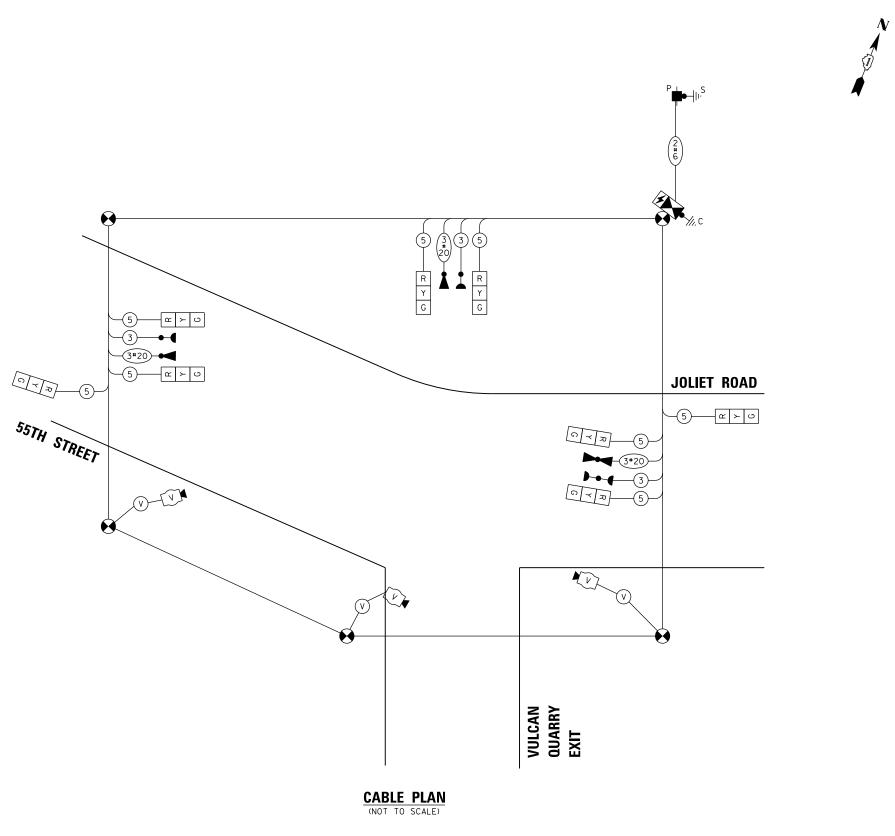

												NULL LU
TOWER ACCOUNT NUMBER:	09930-15151											
ILE NAME =	USER NAME = hassann	DESIGNED -	۷.0.	REVISED -		TEMPOR	ARY STAGE 1 & 2 CABLE PLAN, PHASE DESIGNATION	DIAGRAM,	F.A.U. RTE	SECTION	COUNTY	TOTAL SHEET
«:/\planroom.dot.illinois.gov:PWIDOT\Docu	ments\IDOT_Offices\District_I\Projects\P12211;	\ <b>D&amp;AWN</b> tantData\S	in <b>Eg6.</b> & Associates	Inc\201880705500005heets\60X71-sht-05 Temp	Cable Plan_2.dgn STATE OF ILLINOIS		AND EMERGENCY VEHICLE PREEMPTION SEQUENCE		3562	(430V-X)N	соок	99 53
	PLOT SCALE = 40.0000 ' / in.	CHECKED -	L.S.	REVISED -	DEPARTMENT OF TRANSPORTATION		JOLIET ROAD AND 55TH STREET					T NO. 60X71
	PLOT DATE = 3/23/2020	DATE -	5/24/2019	REVISED -		SCALE: NTS	SHEET NO. 1 OF 1 SHEETS STA. N/A TO	STA. N/A		ILLINOIS FED. A	ID PROJECT	

## TS 3850 EAGLE 2B

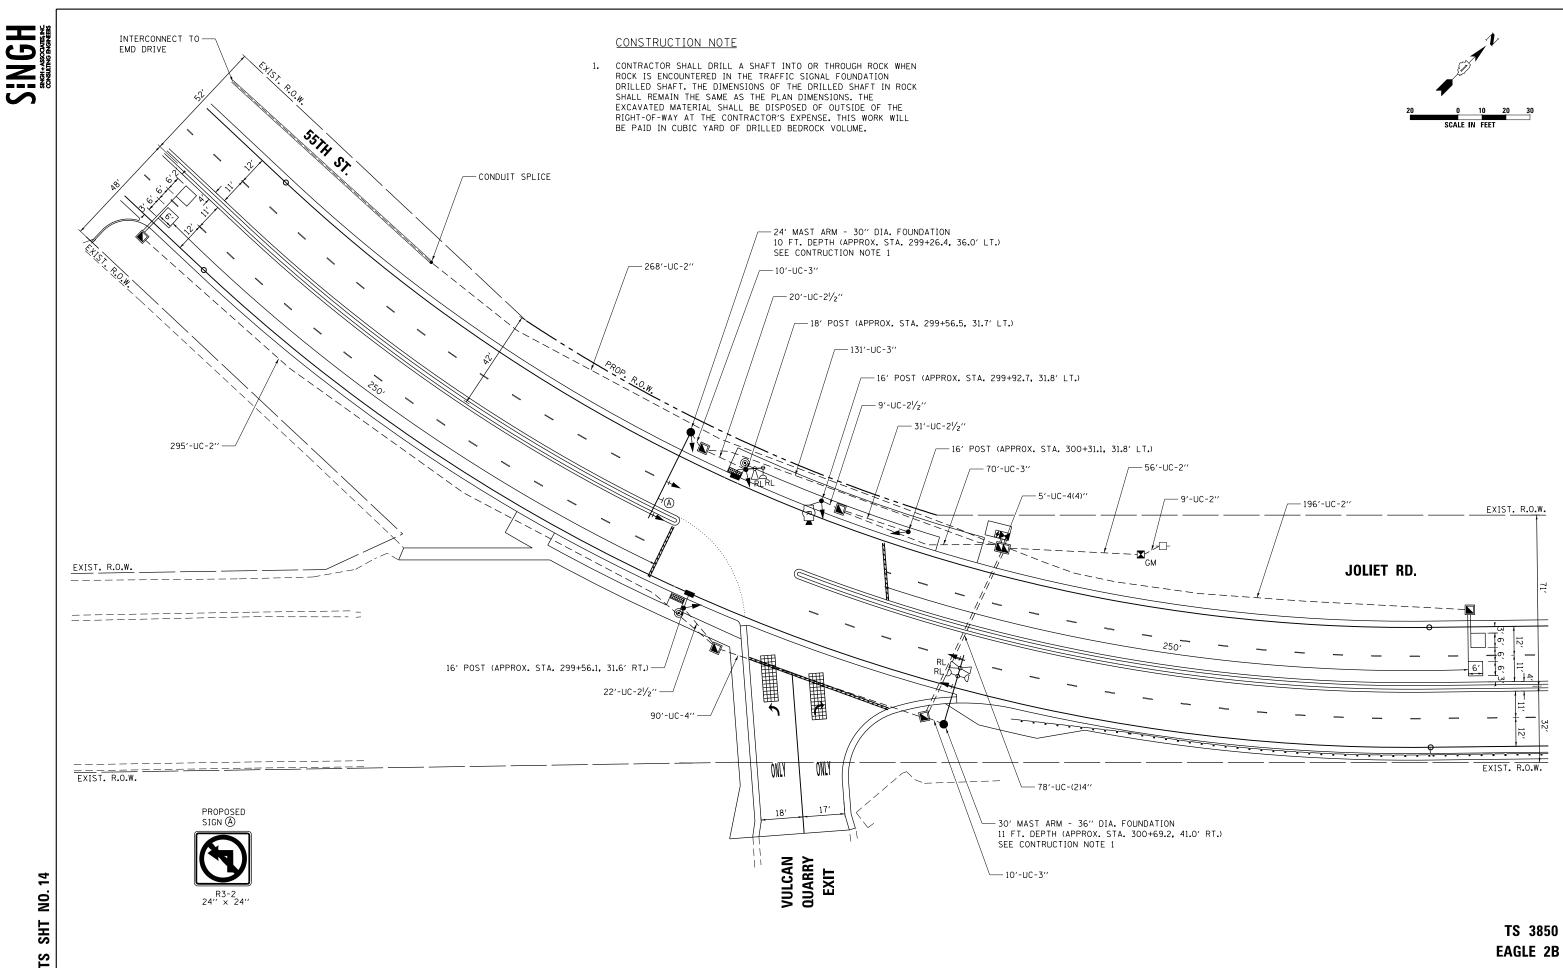

<b>2</b>									
- [	FILE NAME =	USER NAME = hassann	DESIGNED - V.O.	REVISED -		TRAFFIC SIGNAL MODERNIZATION PLAN	F.A.U. RTF	SECTION	COUNTY TOTAL SHEET
	pw://planroom.dot.illinois.gov:PWIDOT/Docu	ments\IDOT Offices\District 1\Projects\P12211	NDRAWNtantData\SiEg8.& Associates Inc\2	201���������������������������	Zation Plandgn STATE OF ILLINOIS	JOLIET ROAD AND 55TH STREET	3562	(430V-X)N	СООК 99 54
		PLOT SCALE = 40.0000 ' / in.	CHECKED - L.S.	REVISED -	DEPARTMENT OF TRANSPORTATION				CONTRACT NO. 60X71
		PLOT DATE = 3/23/2020	DATE - 5/24/2019	REVISED -		SCALE: 1"=20" SHEET NO. OF SHEETS STA. N/A TO STA. N/A		ILLINOIS FED. A	

### **PROPOSED CONTROLLER SEQUENCE**





## 55TH STREET (İ) JOLIET ROAD ←\_6\_\_ 3 \_\_\_\_\_ VULCAN QUARRY EXIT 38


## LEGEND:

← (\*) PROTECTED PHASE

- ← (\*)- PROTECTED/PERMITTED PHASE
- ◄-(\*)- ► PEDESTRIAN PHASE
- OVERLAP

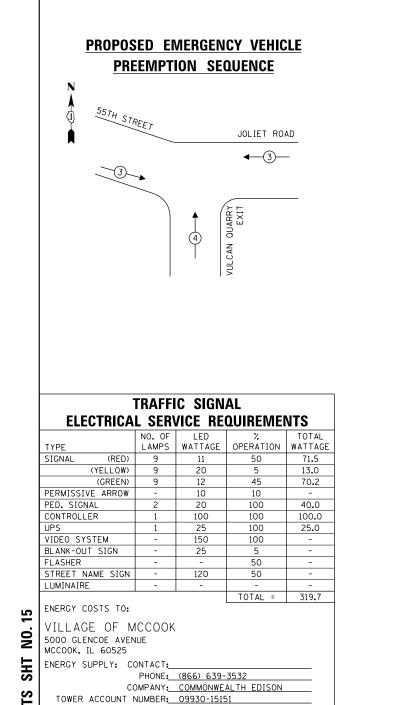

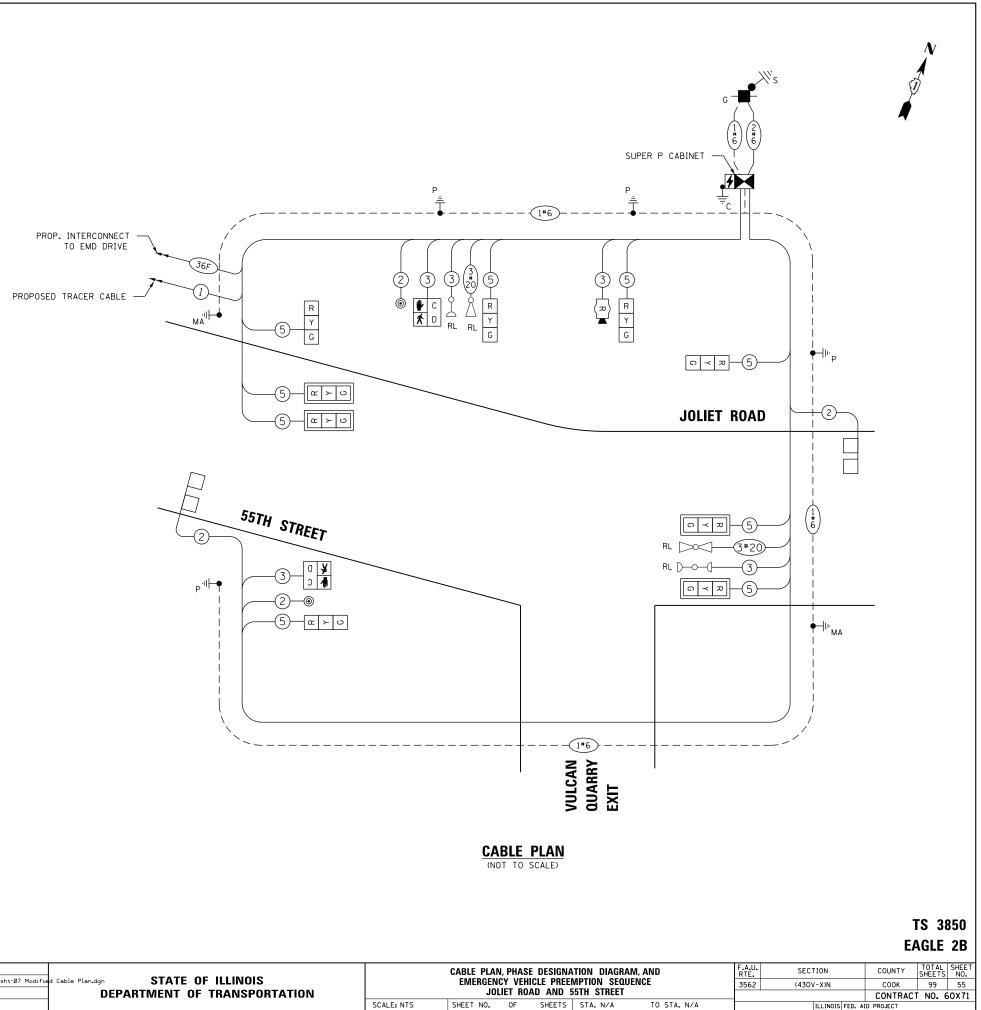

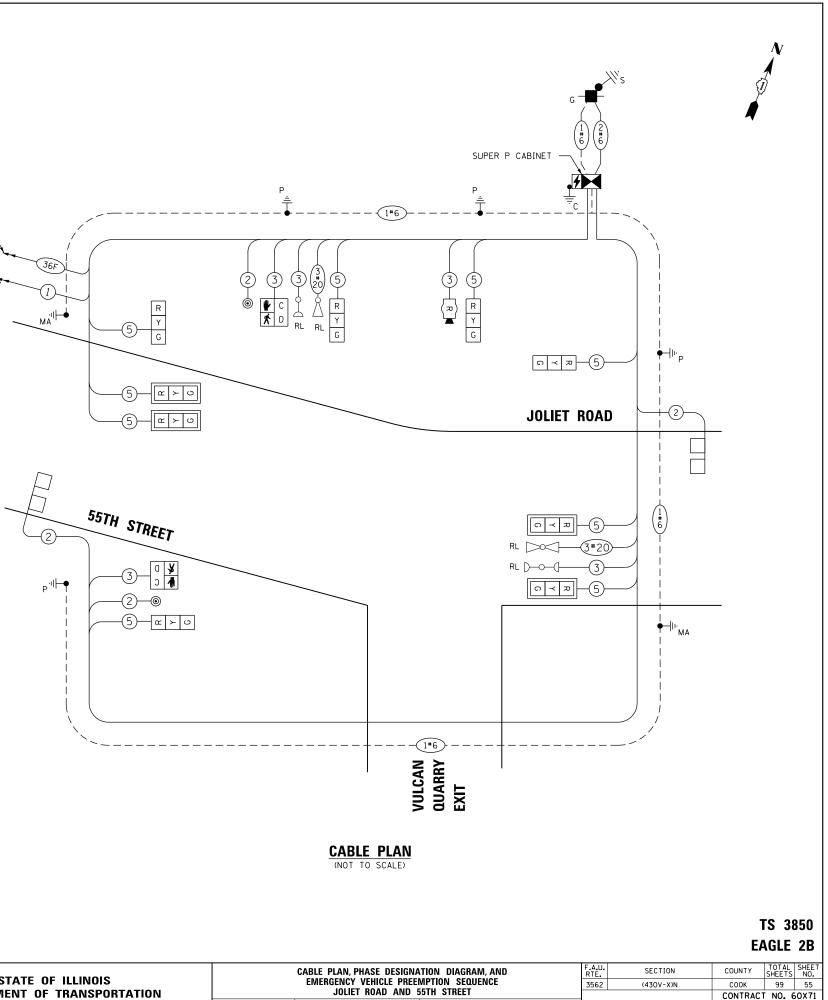

(NOT	ΤO	SCALE)

L	TOWER ACCOUNT NUMBER:	74420-12121					
ſ	FILE NAME =	USER NAME = hassann	DESIGNED - V.O.	REVISED -			CABLE PLAN, PHASE DESIGNAT
	pw://planroom.dot.illinois.gov:PWIDOT/Docu	ments\IDOT_Offices\District_l\Projects\Pl2211	2\ <b>DBrAWNt</b> antData\Si <b>⊡gB.</b> & Associates Inc\2	印册回忆的EDADD-Sheets\60X7l-sht-07 Modifi	d Cable Plan.dgn STATE OF ILLINOIS		EMERGENCY VEHICLE PREEM
		PLOT SCALE = 40.0000 ' / in.	CHECKED - L.S.	REVISED -	DEPARTMENT OF TRANSPORTATION		JOLIET ROAD AND 55
		PLOT DATE = 3/23/2020	DATE - 5/24/2019	REVISED -		SCALE: NTS	SHEET NO. OF SHEETS

# 


## SCHEDULE OF QUANTITIES

ITEM DESCRIPTION	UNITS	TOTAL QTY.
UNDERGROUND CONDUIT, GALVANIZED STEEL, 2" DIA.	FOOT	556
UNDERGROUND CONDUIT, GALVANIZED STEEL, 2 1/2" DIA.	FOOT	62
UNDERGROUND CONDUIT, GALVANIZED STEEL, 3" DIA.	FOOT	263
UNDERGROUND CONDUIT, GALVANIZED STEEL, 4" DIA.	FOOT	266
HANDHOLE	EACH	6
DOUBLE HANDHOLE	EACH	1
ELECTRIC CABLE IN CONDUIT, SIGNAL NO.14 2C	FOOT	434
ELECTRIC CABLE IN CONDUIT, SIGNAL NO.14 3C	FOOT	702
ELECTRIC CABLE IN CONDUIT, SIGNAL NO.14 5C	FOOT	1671
ELECTRIC CABLE IN CONDUIT, LEAD-IN, NO.14 1 PAIR	FOOT	737
ELECTRIC CABLE IN CONDUIT, SERVICE, NO.6 2C	FOOT	80
ELECTRIC CABLE IN CONDUIT, EQUIPMENT GROUNDING CONDUCTOR, NO.6 1C	FOOT	1009
TRAFFIC SIGNAL POST, GALVANIZED STEEL 16 FT.	EACH	3
TRAFFIC SIGNAL POST, GALVANIZED STEEL 18 FT.	EACH	1
STEEL MAST ARM ASSEMBLY AND POLE, 24 FT.	EACH	1
STEEL MAST ARM ASSEMBLY AND POLE, 30 FT.	EACH	1
CONCRETE FOUNDATION, TYPE A	FOOT	16
CONCRETE FOUNDATION, TYPE C	FOOT	4
CONCRETE FOUNDATION, TYPE E 30-INCH DIAMETER	FOOT	8.5
CONCRETE FOUNDATION, TYPE E 36-INCH DIAMETER	FOOT	4
SIGNAL HEAD, LED, 1-FACE, 3-SECTION, MAST-ARM MOUNTED	EACH	4
SIGNAL HEAD, LED, 1-FACE, 3-SECTION, BRACKET MOUNTED	EACH	5
PEDESTRIAN SIGNAL HEAD, LED, 1-FACE, BRACKET MOUNTED WITH COUNTDOWN TIMER	EACH	2
TRAFFIC SIGNAL BACKPLATE, LOUVERED, FORMED PLASTIC	EACH	4
INDUCTIVE LOOP DETECTOR	EACH	4
DETECTOR LOOP, TYPE I	FOOT	152
PEDESTRIAN PUSH-BUTTON	EACH	2
TEMPORARY TRAFFIC SIGNAL INSTALLATION	EACH	1
* RELOCATE EXISTING EMERGENCY VEHICLE PRIORITY SYSTEM, DETECTOR UNIT	EACH	2
* RELOCATE EXISTING EMERGENCY VEHICLE PRIORITY SYSTEM, PHASING UNIT	EACH	1
REMOVE EXISTING TRAFFIC SIGNAL EQUIPMENT	EACH	1
REMOVE EXISTING HANDHOLE	EACH	9
REMOVE EXISTING DOUBLE HANDHOLE	EACH	1
REMOVE EXISTING CONCRETE FOUNDATION	EACH	5
* EMERGENCY VEHICLE PRIORITY SYSTEM LINE SENSOR CABLE, NO. 20 3/C	FOOT	377
FULL-ACTUATED CONTROLLER AND TYPE SUPER P CABINET (SPECIAL)	EACH	1
DRILLED SHAFT IN ROCK (SPECIAL)	CU YD	2.1
SERVICE INSTALLATION, GROUND MOUNTED, METERED	EACH	1
UNINTERRUPTABLE POWER SUPPLY, SPECIAL	EACH	1
TEMPORARY TRAFFIC SIGNAL TIMING	EACH	1

\* 100% COST TO THE VILLAGE OF MCCOOK


- 1										
ſ	FILE NAME =	USER NAME = hassann	DESIGNED - V.O.	REVISED -			SCHEDULE OF QUANTITIES	F.A.U.	SECTION	COUNTY TOTAL SHEE
	pw://planroom.dot.illinois.gov:PWIDOT/Docu	ments\IDOT Offices\District 1\Projects\P122112	\ <b>D&amp;AWN</b> tantData\Sı <b>Eg6.</b> & Associates Inc`	\201₩EØ1@E@ADD-Sheets\60X71-sht-08 Schedul	e of Quantities.dgn STATE OF ILLINOIS		JOLIET ROAD AND 55TH STREET	3562	(430V-X)N	СООК 99 56
		PLOT SCALE = 40.0000 ' / in.	CHECKED - L.S.	REVISED -	DEPARTMENT OF TRANSPORTATION	JULIEI NUAD AND JOIN SINEEI				CONTRACT NO. 60X7
		PLOT DATE = 3/23/2020	DATE - 5/24/2019	REVISED -		SCALE: NTS	SHEET NO. 1 OF 1 SHEETS STA. N/A TO STA. N/A		ILLINOIS FED.	AID PROJECT

## TS 3850 EAGLE 2B

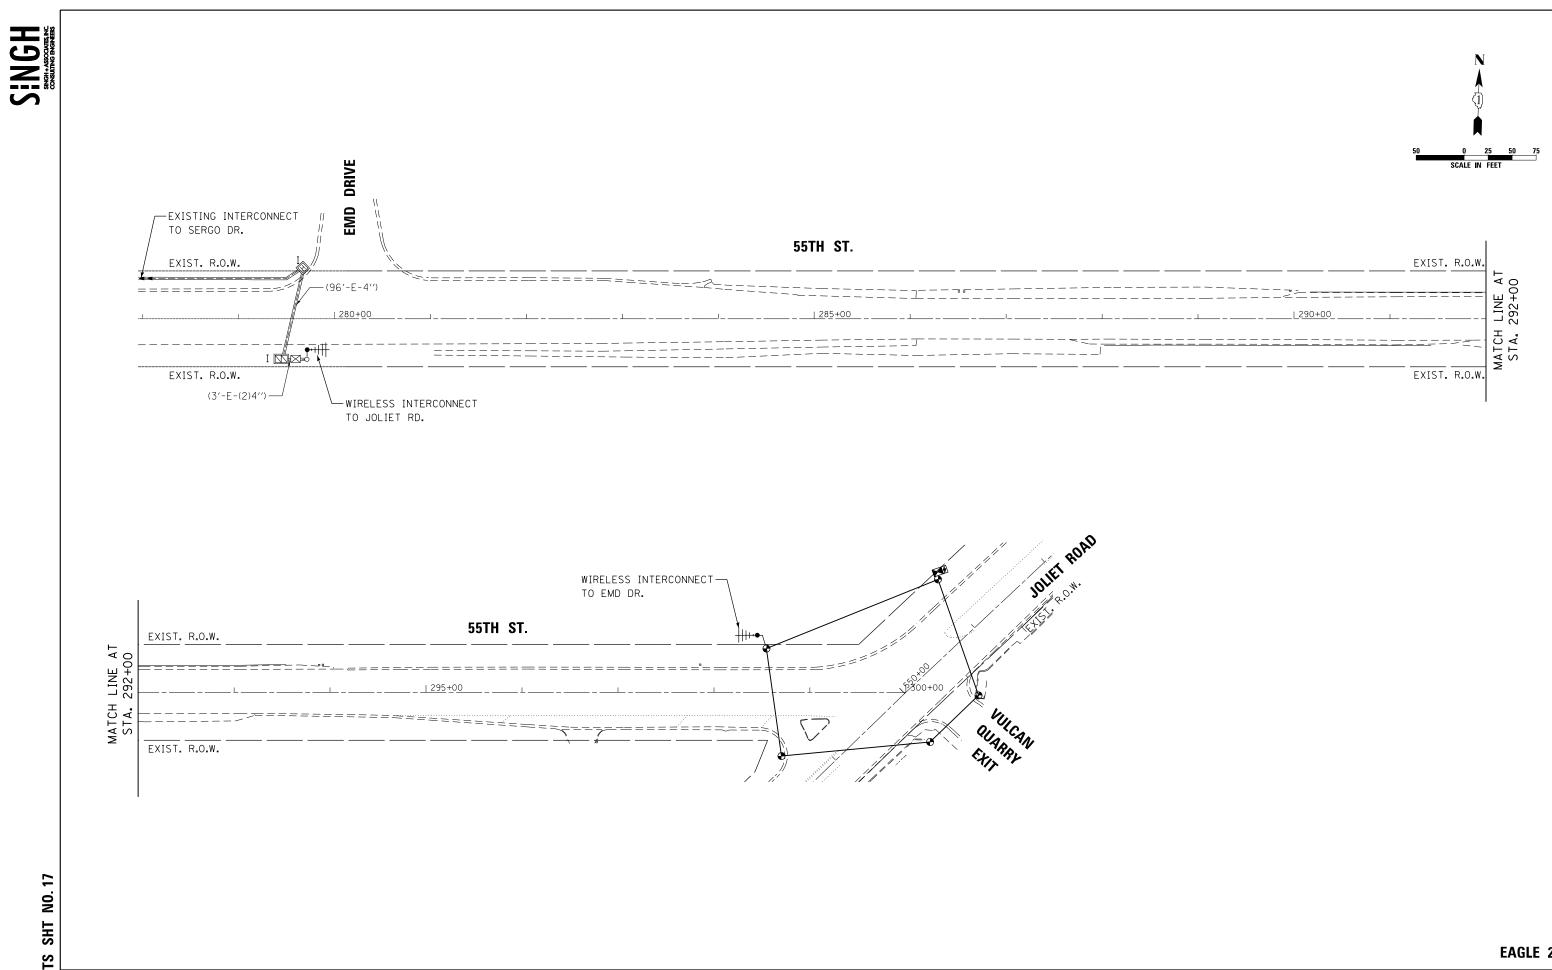


•	FILE NAME =	USER NAME = hassann	DESIGNED - V.O.	REVISED -		TEMPORARY INTERCONNECT PLAN	F.A.U. RTF	SECTION	COUNTY TOTAL SHEET
	pw:\\planroom.dot.illinois.gov:PWIDDT\Docu	nents\IDOT Offices\District l\Projects\Pl	22112\DBAWNtantData\SiEg6.& Associate			55TH STREET FROM EMD DRIVE TO JOLIET ROAD	3562	(430V-X)N	СООК 99 57
		PLOT SCALE = 100.0000 ' / in. PLOT DATE = 3/23/2020	CHECKED - L.S. DATE - 5/24/2019	REVISED - REVISED -	DEPARTMENT OF TRANSPORTATION	SCALE: 1"=50' SHEET NO. 1 OF 1 SHEETS STA. N/A TO STA. N/A		ILLINOIS FED.	CONTRACT NO. 60X71

## EAGLE 2B

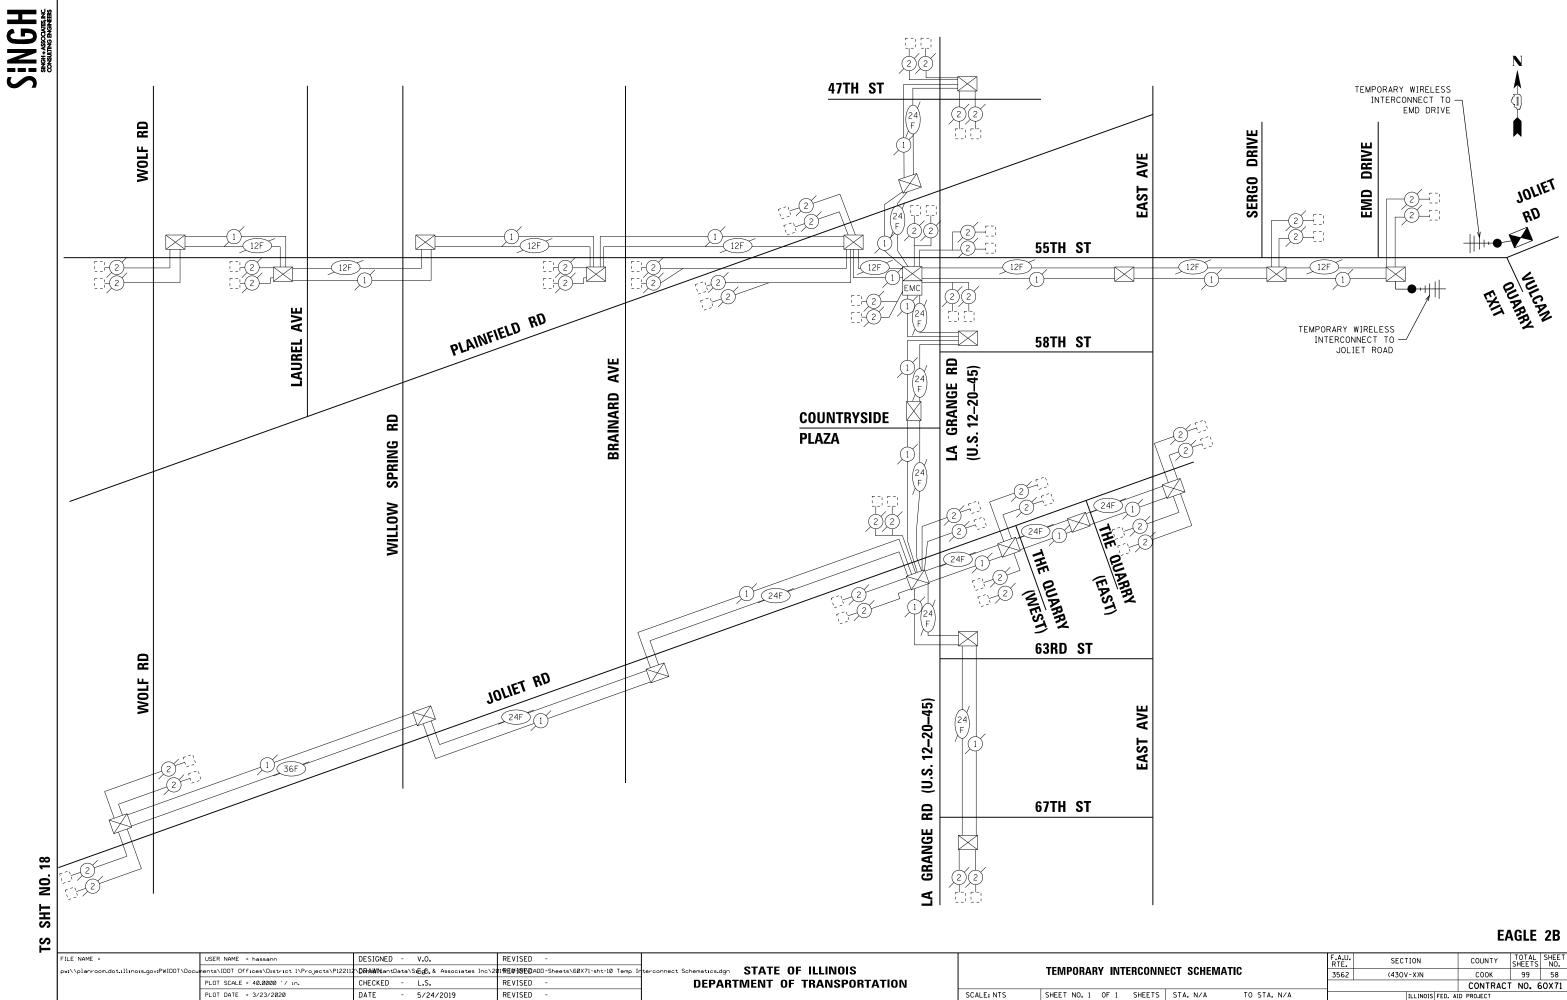


	F.A.U. RTE.	SECTION	COUNTY	TOTAL SHEETS	SHEET NO.			
NECT SCHEMATIC	3562	(430V-X)N	СООК	99	58			
			CONTRACT	NO. 6	50X71			
S STA. N/A TO STA. N/A		ILLINOIS FED. AID PROJECT						

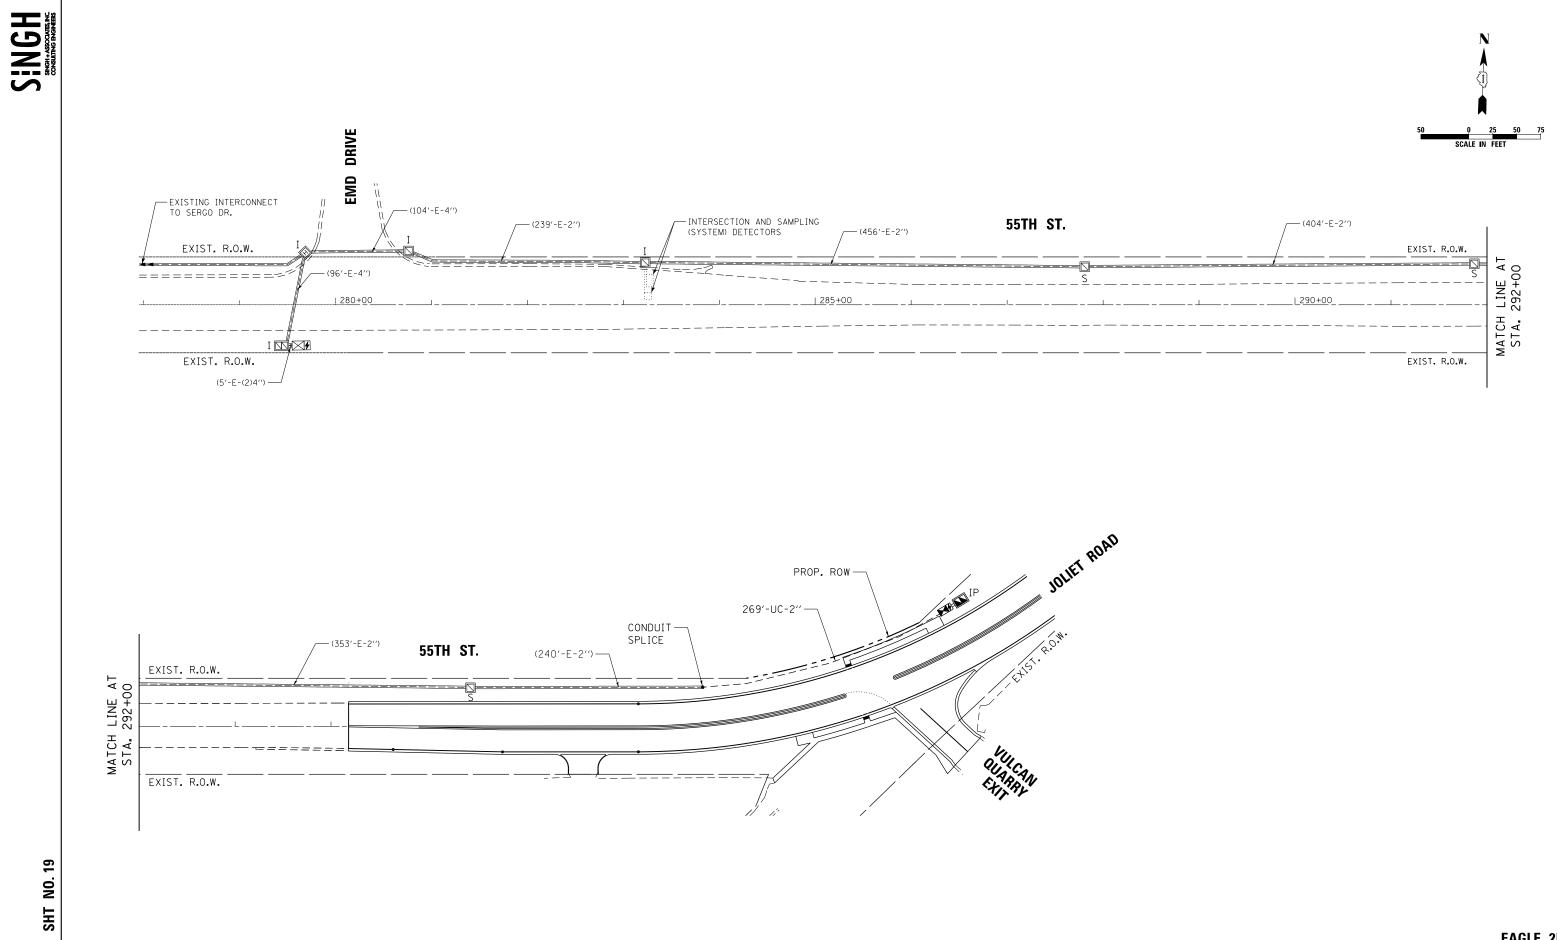

TS SHT NO. 19

FILE	NAME =	USER NAME = hassann	DESIGNED - V.O.	REVISED -			INTERCONNECT	ΡΙΔΝ	F.A.U.	SECTION	COUNTY TOTA	AL SHEET
pw://	planroom.dot.illinois.gov:PWIDOT\Docu	0		2019880/ADD-Sheets\60X71-sht-11 Intercor		55TH	H STREET FROM EMD DRIV		3562	(430V-X)N	СООК 99	59
		PLOT SCALE = 100.0000 ' / in.	CHECKED - L.S.	REVISED -	DEPARTMENT OF TRANSPORTATION			_		CONTRACT NO.	. 60X71	
		PLOT DATE = 3/23/2020	DATE - 5/24/2019	REVISED -		SCALE: 1''=50'	SHEET NO. 1 OF 1 SHEETS	STA. N/A TO STA. N/A		ILLINOIS FED. A	ID PROJECT	


## EAGLE 2B

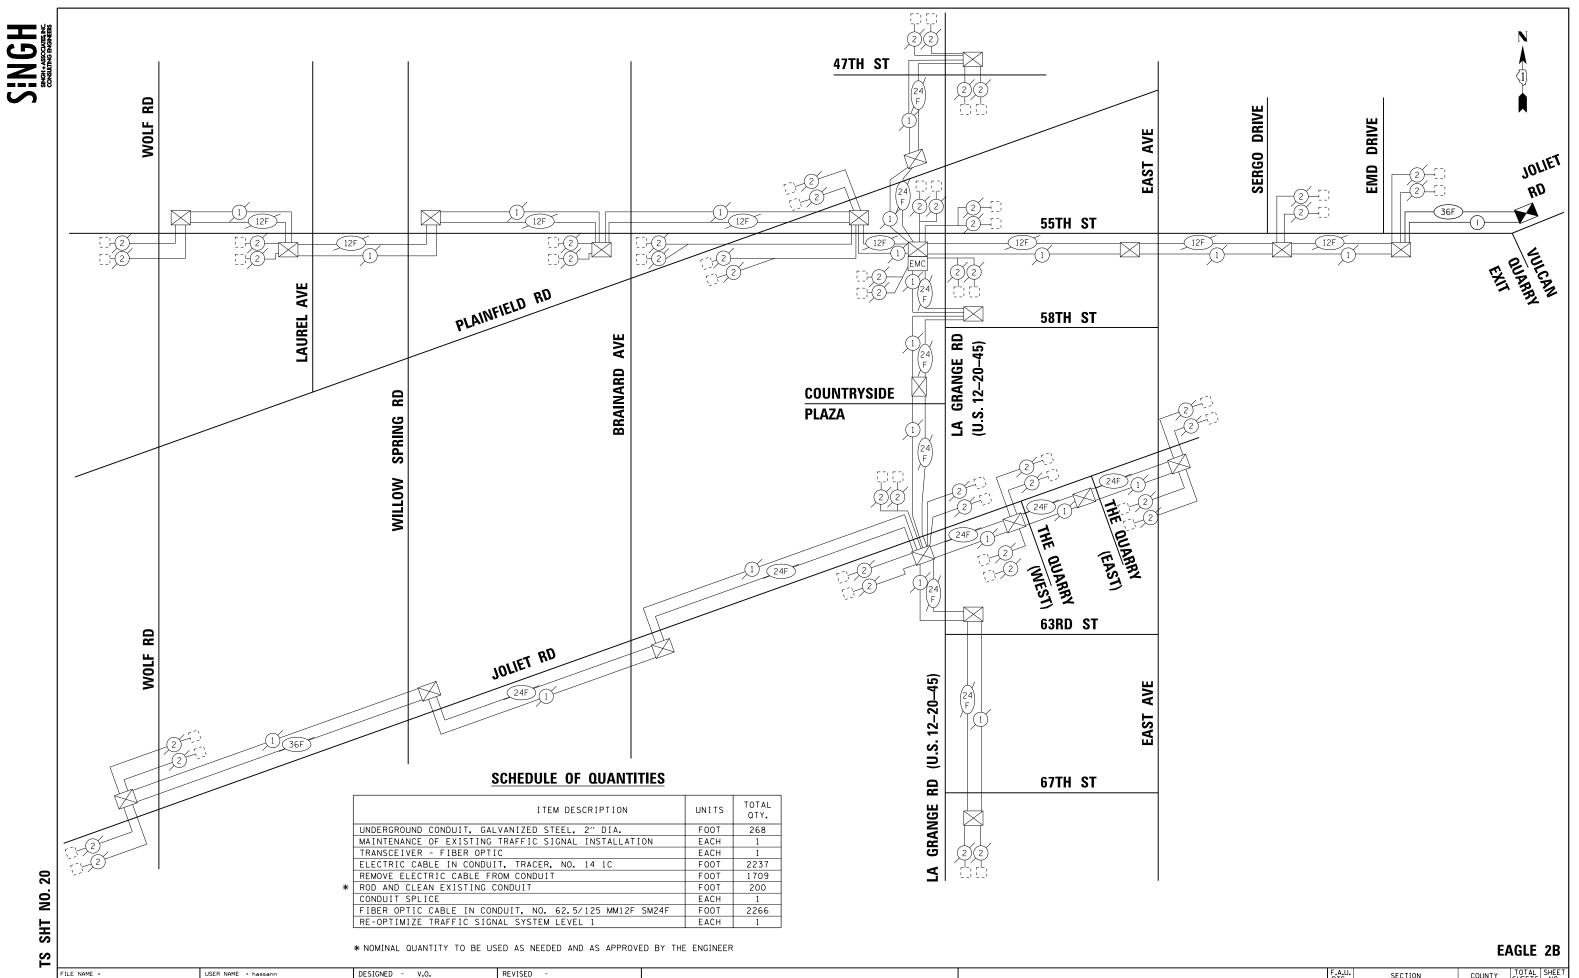

FILE NAME =	USER NAME = hassann	DESIGNED - V.O.	REVISED -					F.A.U.	SECTION	COUNTY TOTAL SHEET
pw:\\planroom.dot.illinois.gov:PWIDOT\Docu	ments\IDOT Offices\District 1\Projects\P122112	\ <b>D&amp;AWN</b> tantData\Si <b>Eg6.</b> & Associates Inc\2	01₩E@H®E@ADD-Sheets\60X71-sht-12 Interco	nnect Schematics.dgn STATE OF ILLINOIS		INTERCONNECT SCHEMATIC	-	3562	(430V-X)N	СООК 99 60
	PLOT SCALE = 40.0000 '/ in.	CHECKED - L.S.	REVISED -	DEPARTMENT OF TRANSPORTATION			-			CONTRACT NO. 60X71
	PLOT DATE = 3/23/2020	DATE - 5/24/2019	REVISED -		SCALE: NTS	SHEET NO. 1 OF 1 SHEETS STA. N/A T	O STA. N/A		ILLINOIS FED. A	


SYMBOL	DESCRIPTION
۰Ä	PROPOSED VILLAGE OF MCCOOK LIGHTING UNIT MOUNTED ON BREAKAWAY TRANSFORMER BASE, 35FT M.H., 12FT MAST ARM UNLESS NOTED OTHERWISE
<b>⊶</b> ₫	TEMPORARY LIGHTING UNIT, 50FT WOOD POLE, 15FT MAST ARM, 400W HPS TYPE III LUMINAIRE AT 40FT MOUNTING HEIGHT UNLESS NOTED OTHERWISE
∩–R	EXISTING VILLAGE OF MCCOOK LIGHTING UNIT TO BE REMOVED, SALVAGE
o−,E)	EXISTING VILLAGE OF MCCOOK LIGHTING UNIT TO REMAIN
۵	EXISTING ELECTRIC UTILITY SERVICE TO BE REMOVED
$\geq$	EXISTING VILLAGE OF MCCOOK LIGHTING CONTROLLER TO BE REMOVED
	PROPOSED VILLAGE OF MCCOOK LIGHTING CONTROLLER
۸	PROPOSED ELECTRIC UTILITY SERVICE
—— - Е —	EXISTING UNDERGROUND UNIT DUCT TO REMAIN
R	EXISTING UNDERGROUND UNIT DUCT TO BE REMOVED OR ABANDONED IN PLACE
-{	PROPOSED UNIT DUCT IN UNDERGROUND CONDUIT, SIZE AND TYPE AS NOTED
	PROPOSED UNIT DUCT, SIZE AND TYPE AS NOTED
A/C	TEMPORARY AERIAL CABLE, SIZE AND TYPE AS NOTED

	ABBREVIATIONS		
BBREVIATION	DESCRIPTION		
AC	ALTERNATING CURRENT		
A/C	AERIAL CABLE		
в.о.с.	BACK OF CURB		
CB	CIRCUIT BREAKER		
СКТ	CIRCUIT	-	<b>`</b>
CM	CENTIMETER		$\mathbf{r}$
CP	CONTROL PANEL		4
СТ	CURRENT TRANSFORMER		
DA	DAVIT ARM		
DC	DIRECT CURRENT		
DIA	DIAMETER		
DP	DISTRIBUTION PANEL		
E	EXISTING UNIT TO REMAIN		
ECA	ELECTRIC CABLE ASSEMBLY		
E.O.P.	EDGE OF PAVEMENT		
F.O.C.	FACE OF CURB		
FT	FEET OR FOOT		
FU	FUSE		
GND	GROUND		
HID	HIGH INTENSITY DISCHARGE		
JB	JUNCTION BOX		
KVA	KILOVOLT-AMPERE		
КW	KILOWATTS		
М	METER		
MA	MAST ARM		
MC	MULTI-CONDUCTOR		
MM	MILLIMETER		
M.H.	MOUNTING HEIGHT		
MW	MESSENGER WIRE		
NO. #	NUMBER		
N.T.S.	NOT TO SCALE		
Р	PROPOSED		
PB	PUSH BUTTON		
PNL	PANEL		
PVC	POLYVINYL CHLORIDE		
PVCC RGC	PVC COATED RIGID GALVANIZED CONDUIT		
PT	POTENTIAL TRANSFORMER		
R	EXISTING UNIT TO BE REMOVED		
	(OWNER SALVAGED U.N.O.)		
RR	EXISTING UNIT TO BE REMOVED AND		
DECE	REINSTALLED		
RECP			
RGC	RIGID GALVANIZED CONDUIT		
SEL SW	SELECTOR SWITCH		
SPARE SPACE	SPARE SPACE		
SPACE	SPACE STAINLESS STEEL		
STA	STATION		
T/F	TOP OF FOUNDATION		
UD	UNIT DUCT		
U.N.O.	UNLESS NOTED OTHERWISE		
UGC, GS	UNDERGROUND CONDUCT, GALVANIZED STEEL		
000, 05 WP	WOOD POLE		
XFMR	TRANSFORMER		
HPS	HIGH PRESSURE SODIUM		
LPS	LOW PRESSURE SODIUM		
LTFM	LIQUID TIGHT FLEXIBLE METALLIC		
		J	

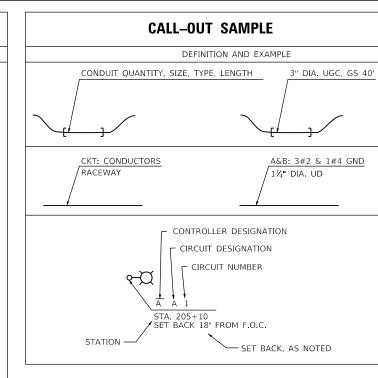

#### INDEX OF DRAWINGS

STANDARD NO.	TITLE
E-01	LEGEND, ABBREVIATION
E-02	SCHEDULE OF QUANTIT
E-03	REMOVAL AND TEMPOR
E-04	PROPOSED LIGHTING P
E-05	LIGHTING CONTROLLER
E-06 TO E-13	DISTRICT 1 BUREAU OF

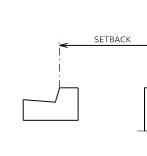

## POLE SETBACK DETAIL

JSER NAME = hassann DESIGNED - SG REVISED LEGEND, ABBREVIATIONS, GENERAL NOTES, AND INDEX OF DRAWINGS STATE OF ILLINOIS DRAWN - SG REVISED LOT SCALE = 99.9998 ' / in. HECKED - RP REVISED **DEPARTMENT OF TRANSPORTATION** SCALE: N.T.S. SHEET OF SHEETS STA. PLOT DATE = 3/23/2020 DATE - 6/18/2019 REVISED

### **GENERAL NOTES**

- THE ELECTRICAL WORK SHALL BE PERFORMED IN ACCORDANCE WITH THE LATEST CODES, STANDARDS AND THE IDOT STANDARD SPECIFICATIONS FOR ROAD AND BRIDGE CONSTRUCTION ADOPTED APRIL 1, 2016, AND SUPPLEMENTAL SPECIFICATIONS AND RECURRING SPECIAL PROVISIONS.
- THE AERIAL CABLE INSTALLATION FOR TEMPORARY LIGHTING SHALL COMPLY WITH NEC (NATIONAL ELECTRICAL CODE) ARTICLE 225.18, NESC AND COMED STANDARDS FOR MINIMUM VERTICAL AND HORIZONTAL CLEARANCES.
- 3. THE CONTRACTOR SHALL CONTACT MEADE ELECTRIC CO. DISTRICT ONE ELECTRICAL MAINTENANCE CONTRACTOR TO LOCATE IDOT ELECTRICAL EQUIPMENT AND UNDERGROUND CABLES 773-287-7672.

## **IDOT-D1 STANDARDS**:

STANDARD NO. TITLE

- BE-220 ELECTRIC SERVICE INSTALLATION AERIAL, REMOTE DISCONNECT
- BE-300 LIGHT POLE FOUNDATION 30' TO 30M.H. 11 1/2" BOLT CIRCLE
- BE-402 ALUMINUM LIGHT POLE 35'-0" MOUNTING HEIGHT
- BE-701 LUMINAIRE SAFETY CABLE ASSEMBLY
- BE-702 MISC. ELECTRICAL DETAILS SHEET A
- BE-800 TEMPORARY LIGHT POLE DETAILS
- BE-801 TEMPORARY AERIAL CABLE INSTALLATION

NS, GENERAL NOTES, AND INDEX OF DRAWINGS

- RARY LIGHTING PLAN
- PLAN
- ER WIRING DIAGRAM
- OF ELECTRICAL DETAIL DRAWINGS


AND INDEX OF DRAWINGS F.A.U. SECTION COUNTY TOTAL SHEETS NO. 3562 (430V-X)N COOK 99 61 CONTRACT NO. 60X71 STA. TO STA.

## SCHEDULE OF QUANTITIES


CODE NO.	ITEM	UNIT	QTY.
50200400	ROCK EXCAVATION FOR STRUCTURES	CU YD	2
80400100	ELECTRIC SERVICE INSTALLATION	EACH	1
80400200	ELECTRIC UTILITY SERVICE CONNECTION	LSUM	1
81028220	UNDERGROUND CONDUIT, GALVANIZED STEEL, 3" DIA.	FOOT	135
81603090	UNIT DUCT, 600V, 3-1C NO.4, 1/C NO.6 GROUND, (XLP-TYPE USE), 1 1/4" DIA. POLYETHYLENE	FOOT	1372
81702170	ELECTRIC CABLE IN CONDUIT, 600V (XLP-TYPE USE) 1/C NO. 2/0	FOOT	117
81800300	AERIAL CABLE, 3-1/C NO. 2 WITH MESSENGER WIRE	FOOT	393
82110007	LUMINAIRE, LED, ROADWAY, OUTPUT DESIGNATION G	EACH	13
82500330	LIGHTING CONTROLLER, PEDESTAL MOUNTED, 240VOLT, 60AMP	EACH	1
83007500	LIGHT POLE, ALUMINUM, 35 FT. M.H., 12 FT. MAST ARM	EACH	7
83057285	LIGHT POLE, WOOD, 50 FOOT, CLASS 3, WITH 15FT MAST ARM	FOOT	2
83600200	LIGHT POLE FOUNDATION, 24" DIAMETER	FOOT	63
83800105	BREAKAWAY DEVICE, TRANSFORMER BASE, 11.5 INCH BOLT CIRCLE	EACH	7
84100110	REMOVAL OF TEMPORARY LIGHTING UNIT	EACH	2
84200500	REMOVAL OF LIGHTING UNIT, SALVAGE	EACH	9
84200804	REMOVAL OF POLE FOUNDATION	EACH	9
84500110	REMOVAL OF LIGHTING CONTROLLER	EACH	1
84500120	REMOVAL OF ELECTRIC SERVICE INSTALLATION	EACH	1
84500130	REMOVAL OF LIGHTING CONTROLLER FOUNDATION	EACH	1
X8210040	TEMPORARY LUMINAIRE, HIGH PRESSURE SODIUM VAPOR, HORIZONTAL MOUNT, 400 WATT	EACH	2
Z0033020	LUMINAIRE SAFETY CABLE ASSEMBLY	EACH	13
Z0033028	MAINTENANCE OF LIGHTING SYSTEM	CAL MO	6

	USER NAME = \$USER\$	DESIGNED - SG	REVISED -				SCHEDUL	E OF QUANTITIES		F.A.U. RTE	SECTION	COUNTY	TOTAL SHEET SHEETS NO.
SINGH		DRAWN - SG	REVISED -	STATE OF ILLINOIS DEPARTMENT OF TRANSPORTATION					3562	(430V-X)N	СООК	99 62	
	PLOT SCALE = \$SCALE\$	CHECKED - RP	REVISED -									CONTRACT	NO. 60X71
SINGH + ASSOCIATES, INC. CONSULTING ENGINEERS	PLOT DATE = \$DATE\$	DATE - 6/18/2019	REVISED -		SCALE: N.T.S.	SHEET	OF	SHEETS STA.	TO STA.		ILLINOIS FED. AID PROJECT		


## E-02

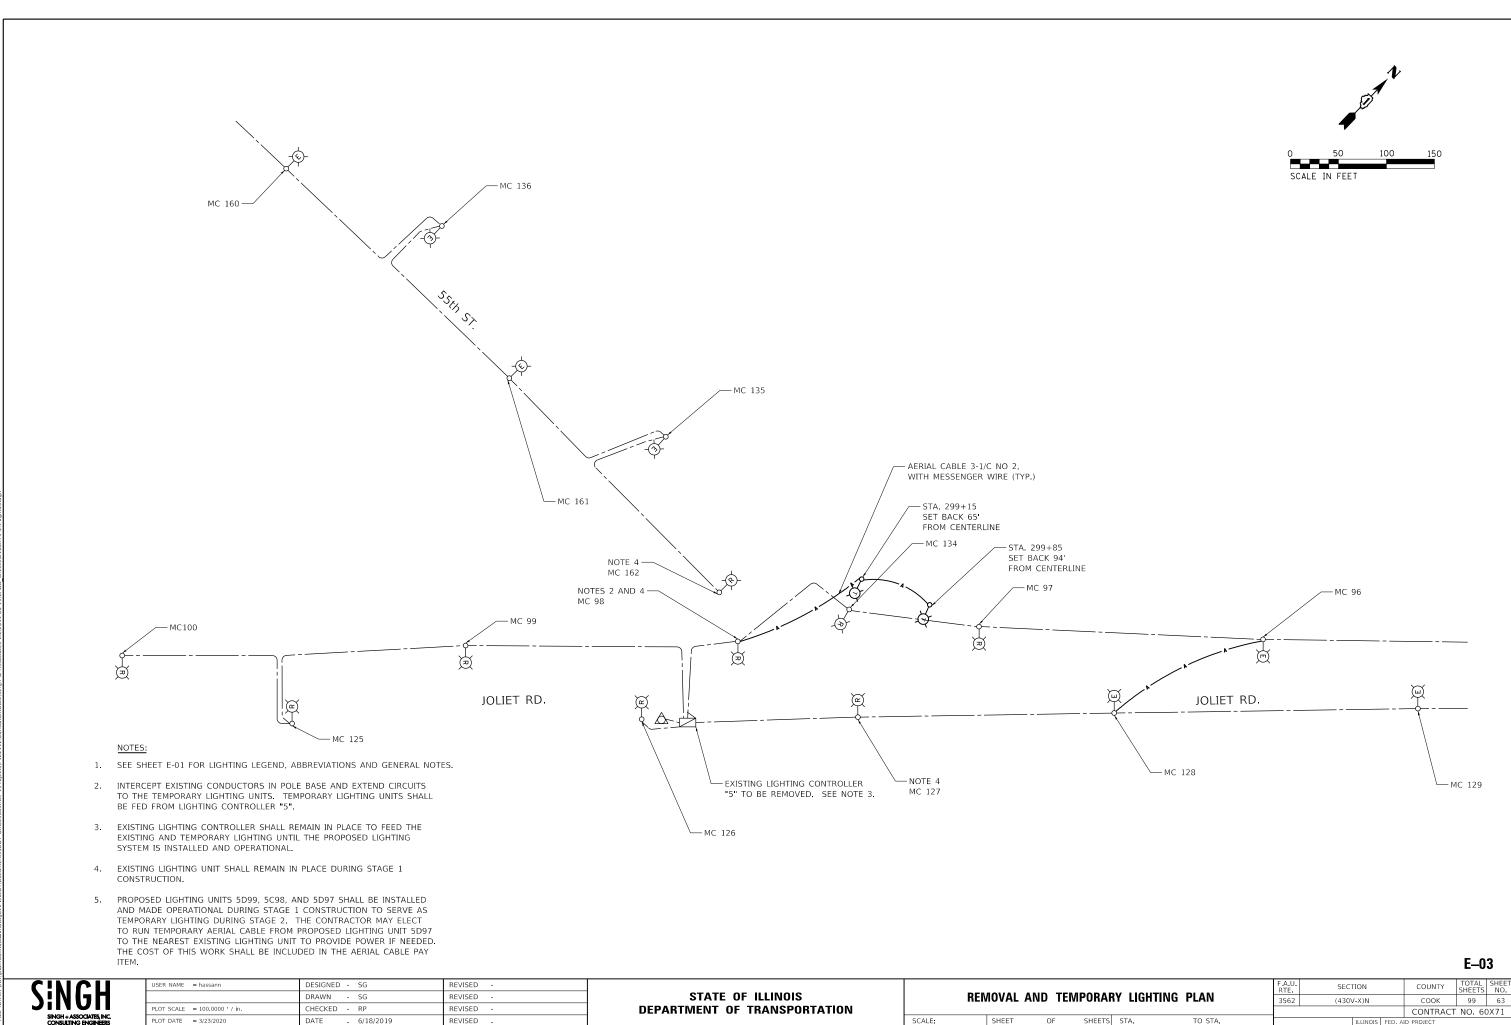


TO STA. ILLINOIS FED.

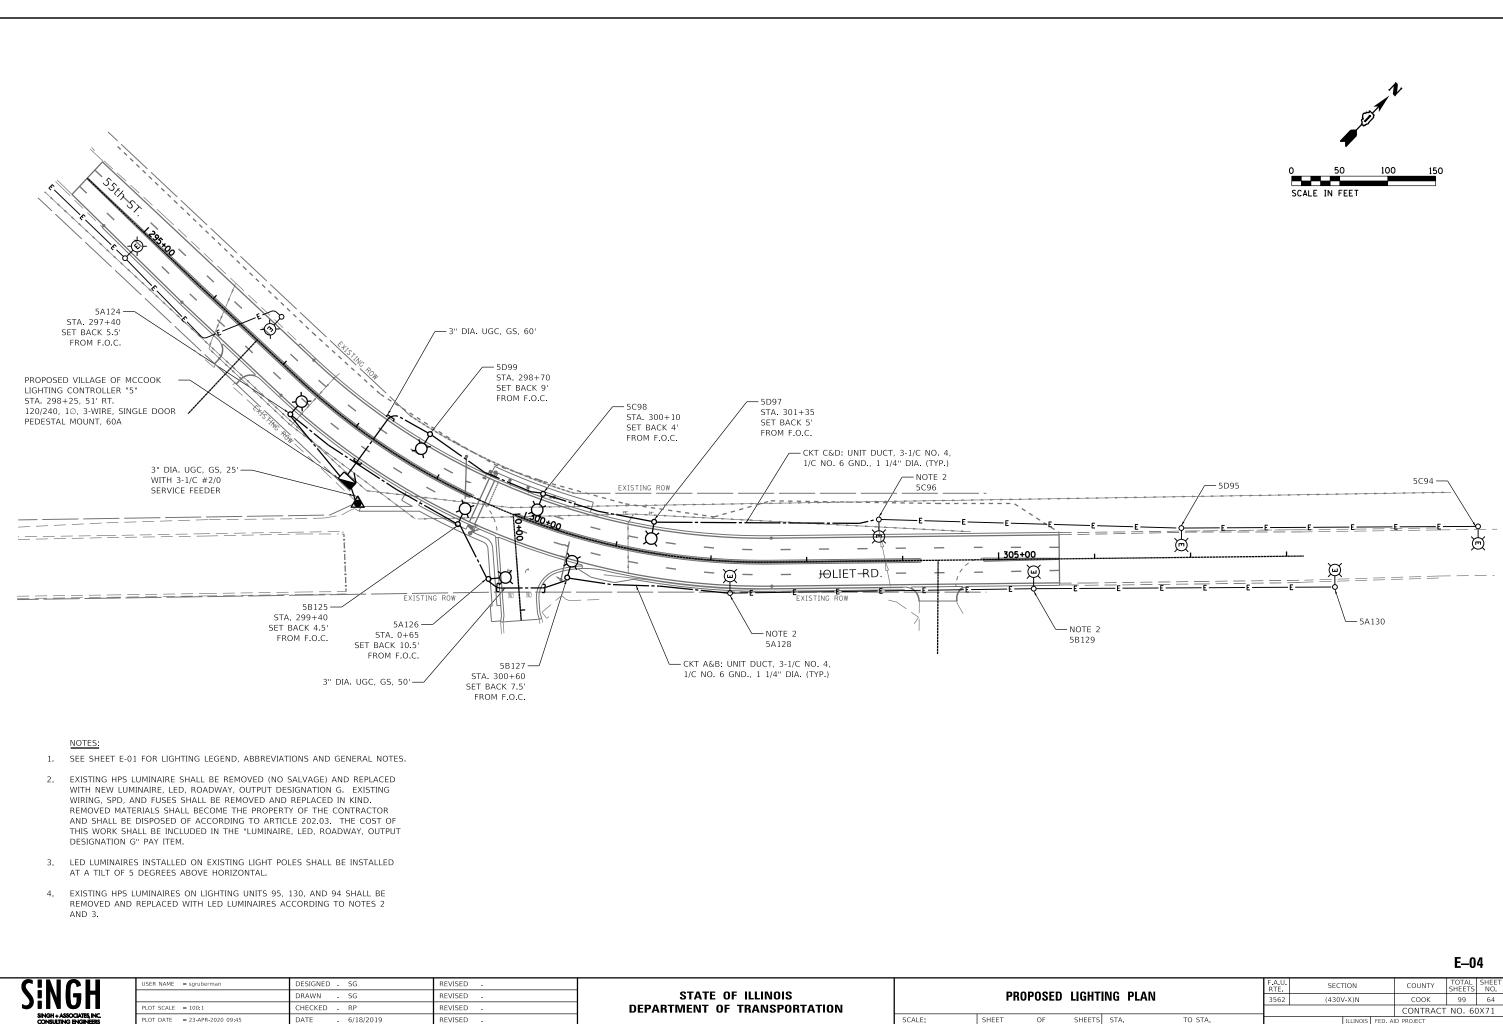


SINGH	USER NAME = sgruberman PLOT SCALE = 100:1	DESIGNED - SG DRAWN - SG CHECKED - RP	REVISED - REVISED - REVISED -	STATE OF ILLINOIS DEPARTMENT OF TRANSPORTATION		PRC	POSED	LIGHTI	ING
SINGH + ASSOCIATES, INC. CONSULTING ENGINEERS	PLOT DATE = 23-APR-2020 09:45	DATE - 6/18/2019	REVISED -		SCALE:	SHEET	OF	SHEETS	STA

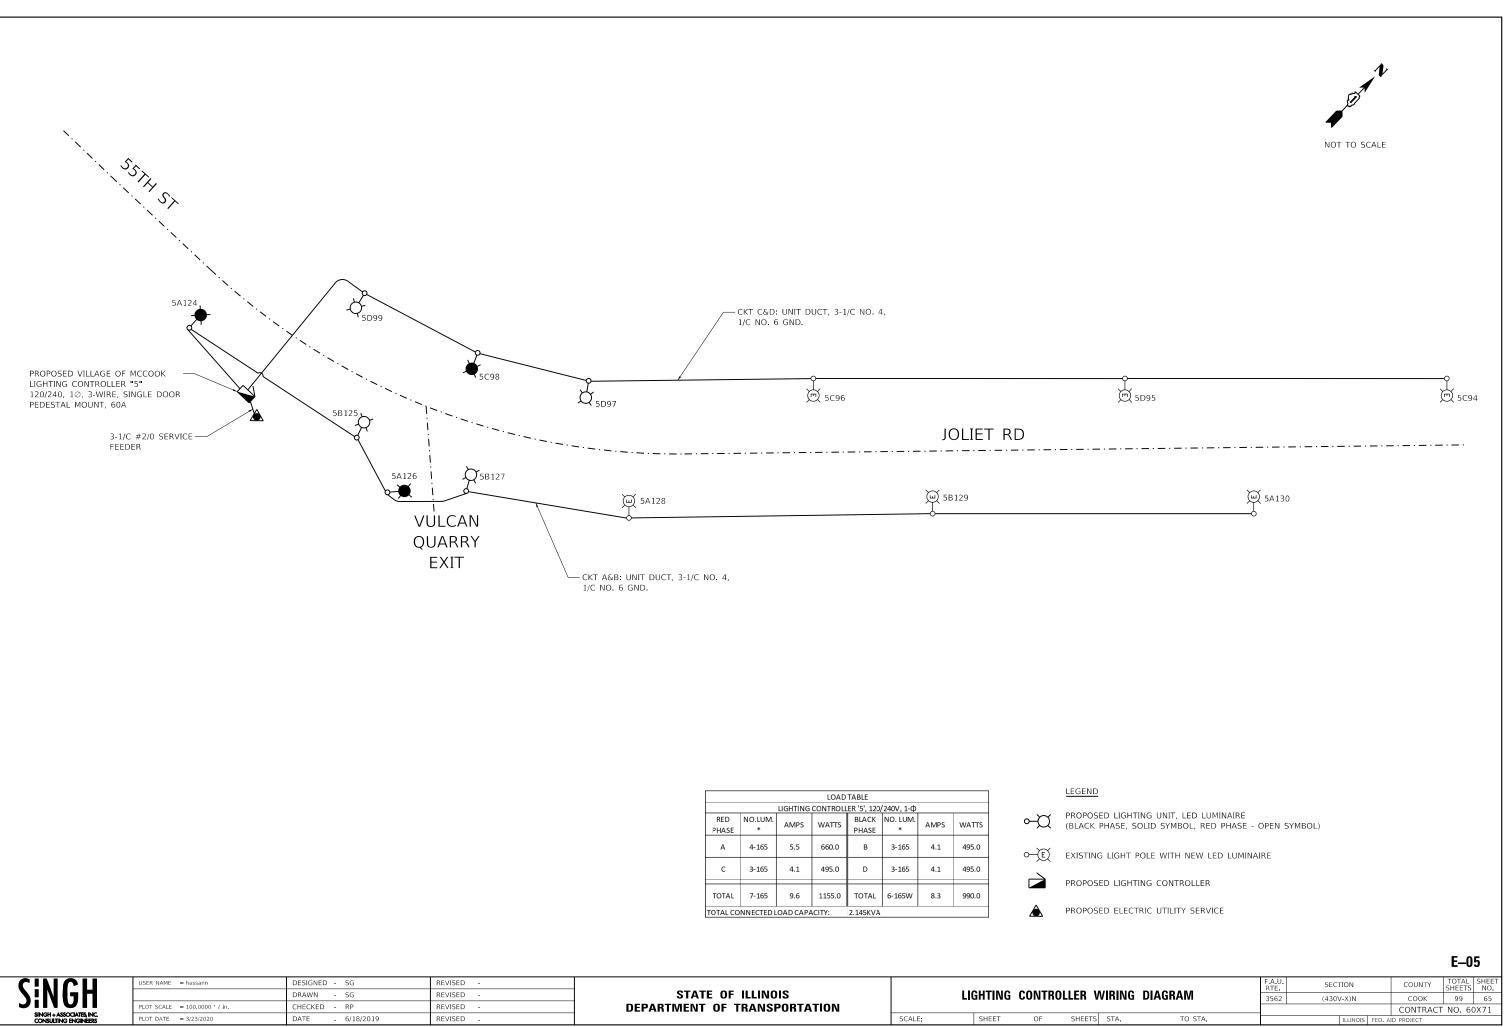

NGH	USER NAME = hassann PLOT SCALE = 100,0000 ' / in.	DESIGNED - SG DRAWN - SG CHECKED - RP	REVISED - REVISED - REVISED -	STATE OF ILLINOIS DEPARTMENT OF TRANSPORTATION	LIC	GHTING	CONTRO	LLER V
NGH + ASSOCIATES, INC. ONSULTING ENGINEERS	PLOT DATE = 3/23/2020	DATE - 6/18/2019	REVISED -		SCALE:	SHEET	OF	SHEETS
		•	•					

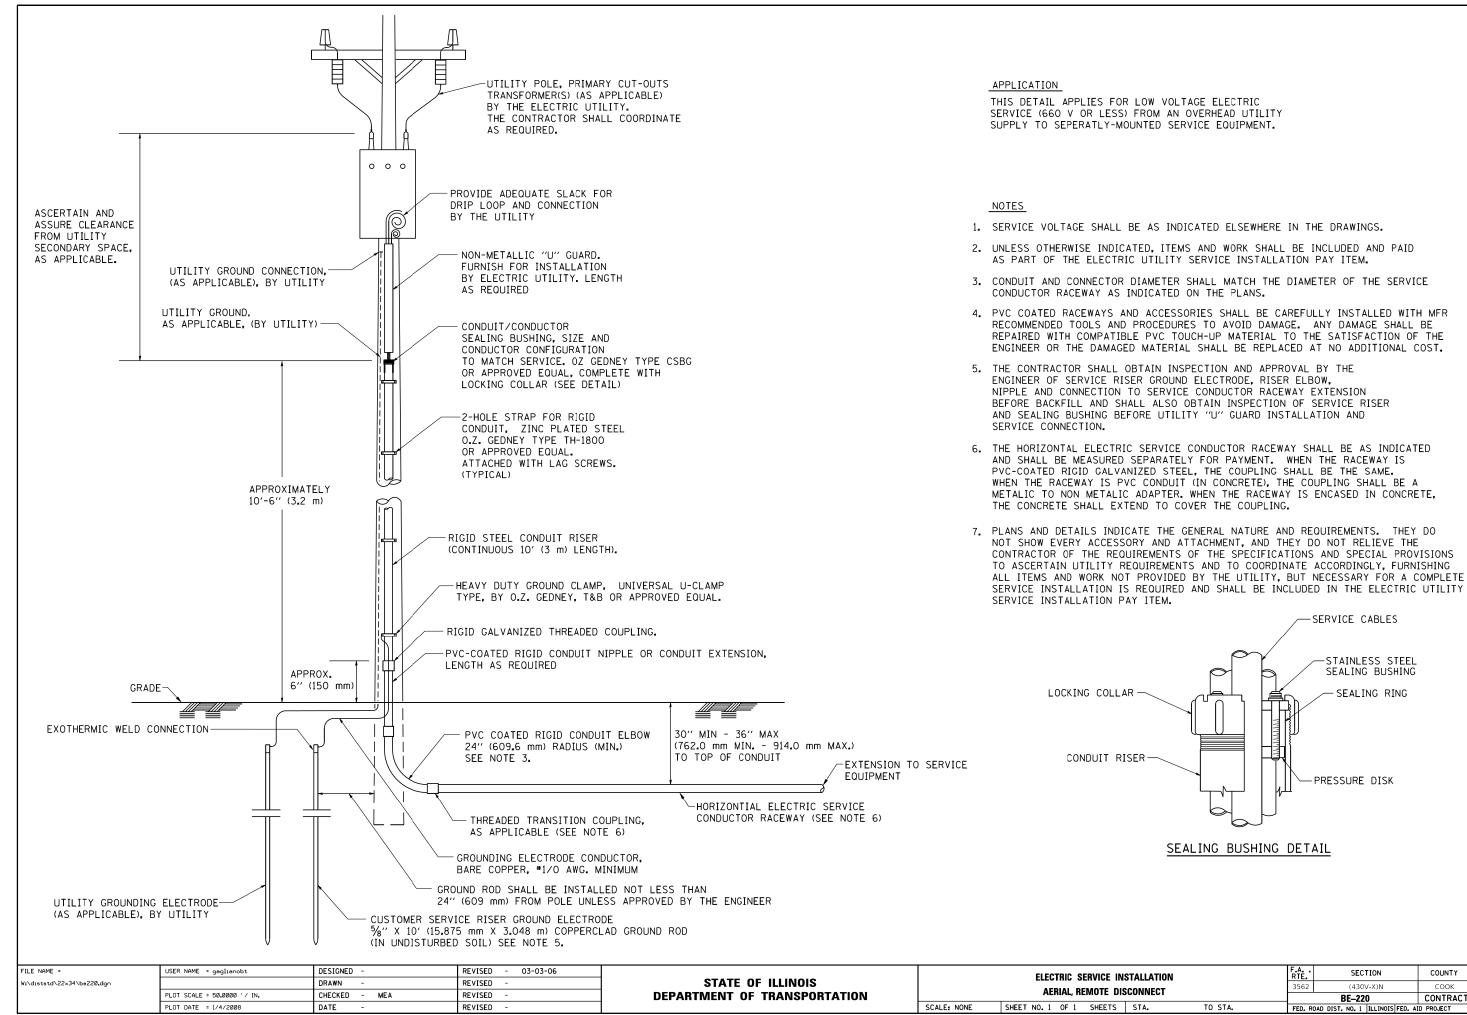

INSTALLATION DISCONNECT		F.A RTE.	SECTION	COUNTY	TOTAL SHEETS	SHEET NO.		
		3562	(430V-X)N	СООК	99	66		
טוט	DISCONNECT			BE-220	CONTRACT	NO. 60	)X71	
5	STA.	TO STA.	FED. ROAD DIST. NO. 1 ILLINOIS FED. AID PROJECT					

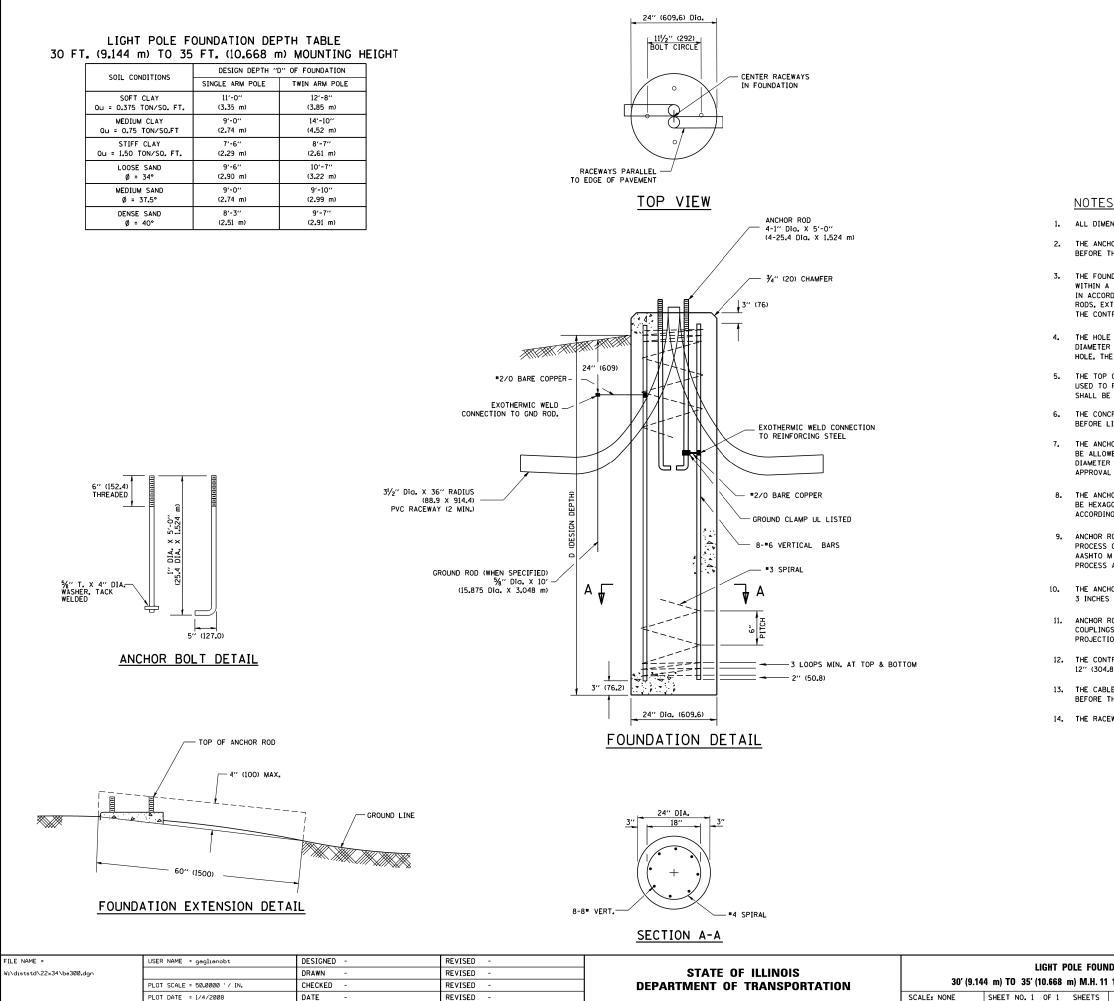

PLOT DATE = 1/4/2008

DATE

REVISED

#### ALL DIMENSIONS ARE IN INCHES (MILLIMETERS) UNLESS OTHERWISE SHOWN

2. THE ANCHOR RODS AND RACEWAYS SHALL BE PROPERLY SECURED IN PLACE BEFORE THE CONCRETE IN PLACED.

3. THE FOUNDATION SHALL NOT PROTRUDE MORE THAN 4 IN. (100 mm) ABOVE THE FINISHED GRADE WITHIN A 60 IN. (1.5 m) CHORD ACROSS THE FOUNDATION, WITH ANCHOR RODS INCLUDED. IN ACCORDANCE WITH AASHTO GUIDELINES. IF THE FOUNDATION HEIGHT, INCLUDING ANCHOR RODS, EXTENDS BEYOND THESE SPECIFIED LIMITS, THE FOUNDATION SHALL BE REPLACED AT THE CONTRACTOR'S EXPENSE. SEE FOUNDATION EXTENSION DETAIL.

4. THE HOLE FOR THE FOUNDATION SHALL BE MADE BY DRILLING WITH AN AUGER, OF THE SAME DIAMETER AS THE FOUNDATION. IF SOIL CONDITIONS REQUIRE THE USE OF A LINER TO FORM THE HOLE. THE LINER SHALL BE WITHDRAWN AS THE CONCRETE IS DEPOSITED.

THE TOP OF THE FOUNDATION SHALL BE CONSTRUCTED LEVEL. A LINER OR FORM SHALL BE USED TO PRODUCE A UNIFORM SMOOTH SIDE TO THE TOP OF THE FOUNDATION. FOUNDATION TOP SHALL BE CHAMFERED 3/4-IN. (20 mm).

6. THE CONCRETE SHALL BE CLASS SI. CONCRETE SHALL CURE ACCORDING TO ARTICLE 1020.13 BEFORE LIGHT POLES ARE INSTALLED.

THE ANCHOR ROD SHALL BE A HOOK ROD TYPE. COLD BENDING OF THE ANCHOR ROD WILL NOT BE ALLOWED. THE RADIUS OF THE HOOK BEND SHALL NOT BE LESS THAN 4 TIMES THE NOMINAL DIAMETER OF THE ANCHOR ROD. A TACK WELDED ANCHOR ROD MAY BE SUBSTITUTED WITH THE APPROVAL OF THE ENGINEER.

8. THE ANCHOR RODS SHALL BE ACCORDING TO ASTM F1554 GRADE 725 (GRADE 105). NUTS SHALL BE HEXAGON NUTS ACCORDING TO ASTM A 194 2H OR ASTM A 563 DH, AND WASHERS SHALL BE ACCORDING TO ASTM F 436.

9. ANCHOR RODS, NUTS AND WASHERS SHALL BE COMPLETELY GALVANIZED BY EITHER THE HOT-DIPPED PROCESS CONFORMING WITH AASHTO M 232, THE MECHANICAL PLATING METHOD CONFORMING TO AASHTO M 298, CLASS 50 WITH A MAXIMUM COATING THICKNESS OF 150 UM(6 NILS) OR THE ELECTROLYTIC PROCESS ACCORDING TO ASTM F 1136.

10. THE ANCHOR RODS SHALL BE THREADED A MINIMUM OF 6 INCHES (150 mm) WITH A MINIMUM OF 3 INCHES (75 mm) OF THREADED ANCHOR ROD EMBEDDED IN THE FOUNDATION.


11. ANCHOR RODS SHALL PROJECT 23/11 (69.9 mm) ABOVE THE TOP OF THE FOUNDATION. IF BREAKAWAY COUPLINGS ARE SPECIFIED, THE CONTRACTOR SHALL CAREFULLY COORDINATE THE ANCHOR ROD PROJECTION WITH THE INSTALLATION REQUIREMENTS OF THE BREAKAWAY COUPLINGS.

12. THE CONTRACTOR SHALL USE A #3 SPIRAL AT 6" (152.4 mm) PITCH OR MAY SUBSTITUTE #3 TIES AT 12" (304.8 mm) O.C. WITH THE APPROVAL OF THE ENGINEER.

13. THE CABLE TRENCHES AND FOUNDATION SHALL BE BACK FILLED AND COMPACTED AS SPECIFIED BEFORE THE LIGHT POLE IS ERECTED.

14. THE RACEWAYS SHALL PROJECT 1" (25.4 mm) ABOVE THE TOP OF THE FOUNDATION.


UNDATION		F.A RTE.	SECTION	COUNTY	TOTAL SHEETS	SHEET NO.		
			3562	(430V-X)N	СООК	99	67	
	11 1⁄2" (292 mm) BOLT CIRCLE			BE-300	CONTRACT	NO. 60	)X71	
	STA.	TO STA.	FED. ROAD DIST. NO. 1 ILLINOIS FED. AID PROJECT					

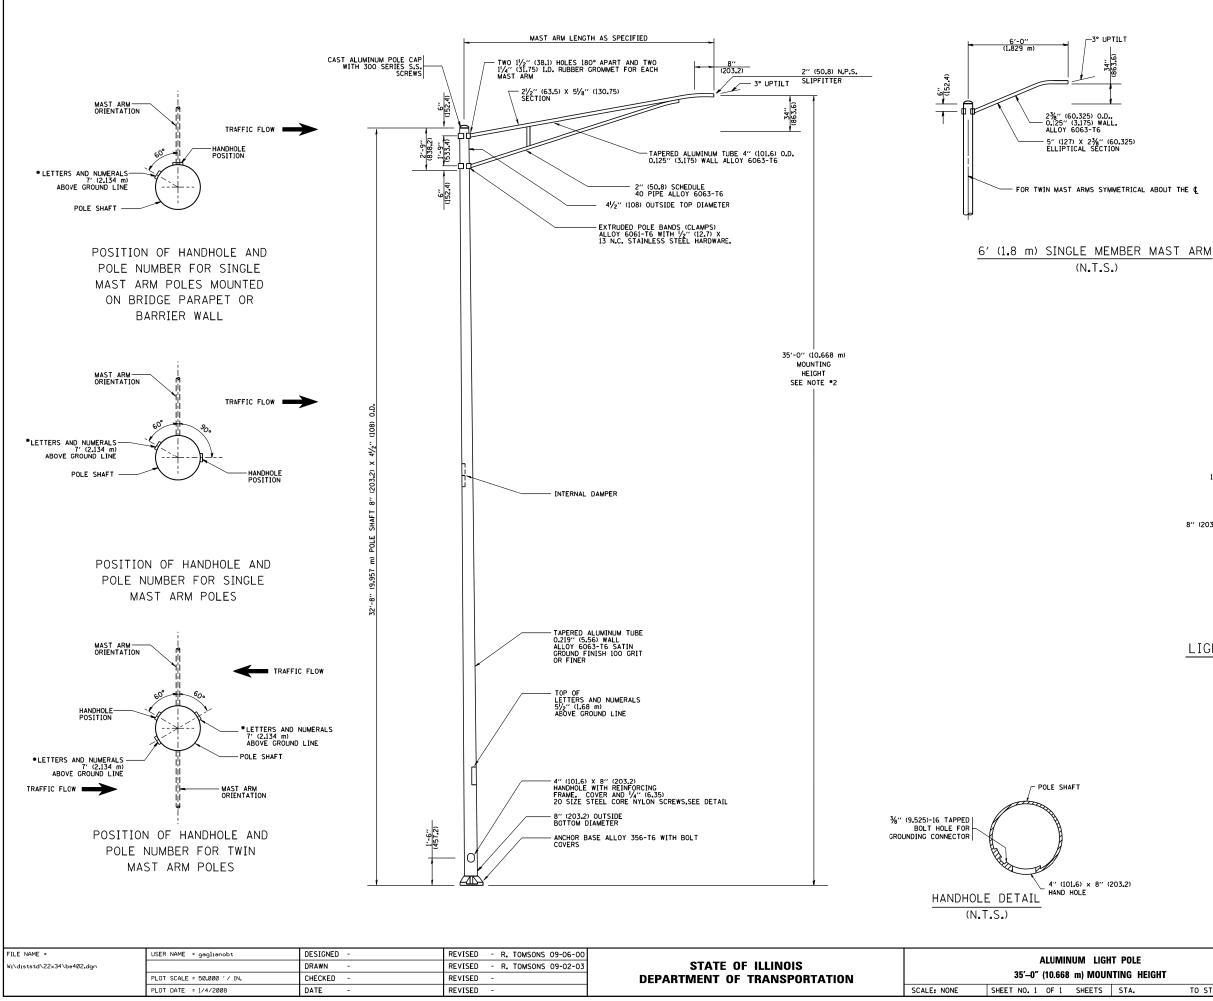

- 34"


NOTES:

- ALL DIMENSIONS ARE IN INCHES (MILLIMETERS) UNLESS OTHERWISE SHOWN.
   MOUNTING HEIGHT IS DEFINED AS THE DISTANCE FROM THE CENTERLINE OF THE TENON TO THE BOTTOM OF THE ANCHOR BASE.
   THE LIGHT POLE WILL MEET AASHTO DESIGN CRITERIA AS SPECIFIED.
   THE INSTALLING CONTRACTOR WILL PROVIDE A UL LISTED GROUNDING CONNECTOR. BURNDY K2C23, T&B SP4DL OR APPROVED EOUAL.
   LIGHT POLES WILL NOT BE INSTALLED WITHOUT MAST ARMS AND LUMINAIRES.
   LIGHT POLES WILL BE SET PLUMB ON THE FOUNDATION WILL BE SET PLUMB ON THE FOUNDATION WILL BE SET PLUMB ON THE NUTS, WASHERS OR SHIMS.
   LIGHT DOLT DENTIFICATION NUMBERS SHALL BE INSTALLED BEFORE THE LIGHTING UNIT IS ENERGIZED.

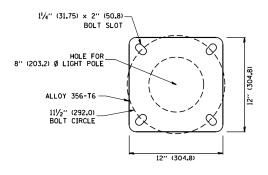

## LIGHT POLE BASE PLATE DETAIL 111/2" (292.0) BOLT CIRCLE

GHT POLE		F.A. RTE.	SECTION	COUNTY TOTAL SHEETS		SHEET NO.				
UNTING HEIGHT			3562	(430V-X)N	соок	99	68			
				BE-402		CONTRACT	NO. 60	)X71		
	STA.	TO STA.	FED. R	FED. ROAD DIST. NO. 1 ILLINOIS FED. AID PROJECT						

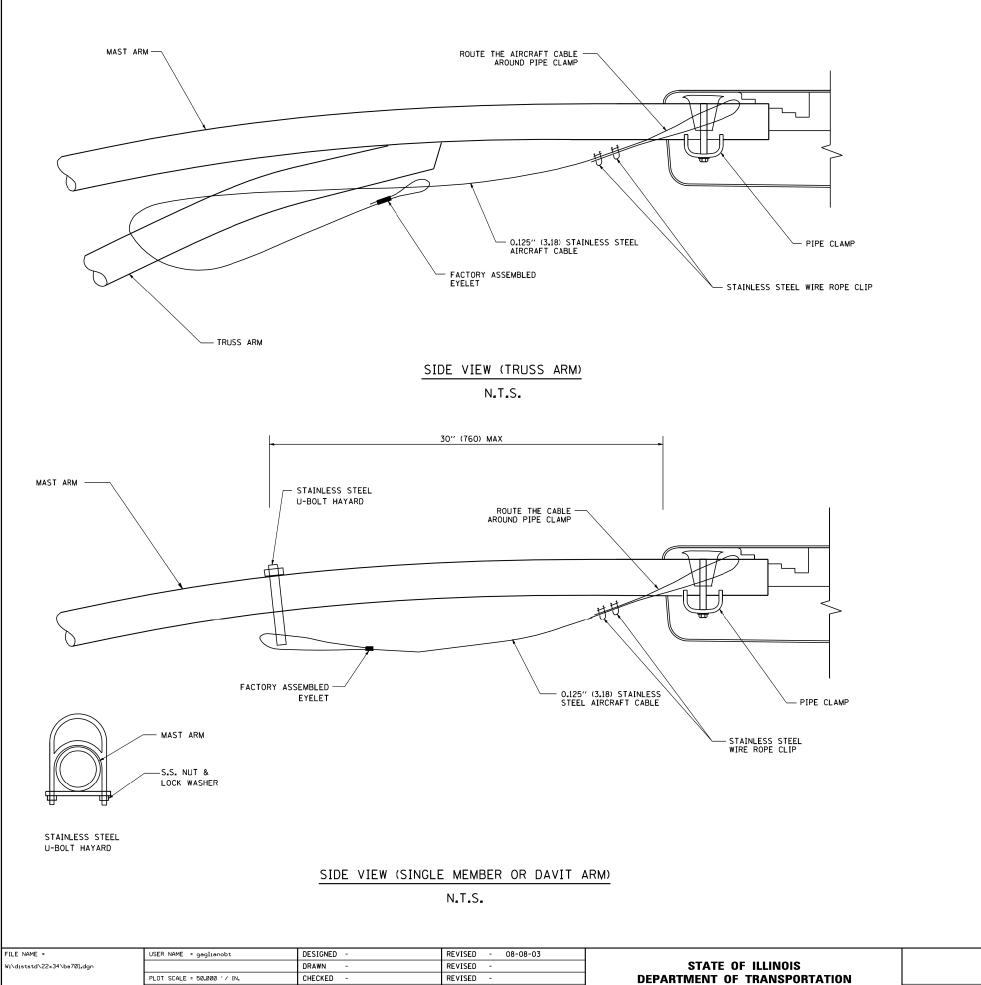


SCALE: NONE SHEET NO. 1 OF 1 SHEETS

REVISED

PLOT DATE = 1/4/2008

DATE

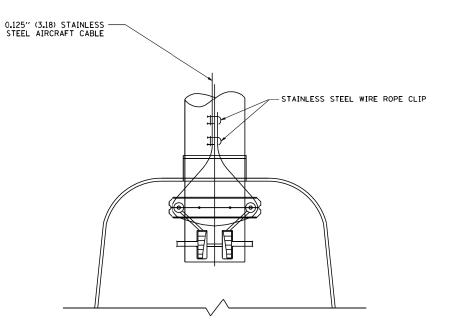


BOTTOM VIEW N.T.S.


NOTES:

- 1. ALL DIMENSIONS ARE IN MILLIMETERS (INCHES) UNLESS OTHERWISE SHOWN.
- 2. CONTRACTOR SHALL ADJUST THE WIRE CLIP TO ELIMINATE ANY SLACK FROM THE WIRE ROPE.
- THE 0.125" (3.18) STAINLESS STEEL AIRCRAFT CABLE SHALL REMAIN VISIBLE FROM THE GROUND LEVEL.
- 4. THE BREAKING STRENGTH OF THE CABLE SHALL BE 1700 LBS. MIN.

LUMINAIRE SAFETY CABLE ASSEMBLY			F.A RTE. SECTION		COUNTY	TOTAL SHEETS	SHEET NO.	
		3562	(430V-X)N	СООК	99	69		
				BE-701 CONTRACT NO. 60X				
EET NO.1 OF 1 SHEETS ST	Α. ΤΟ	) STA.	FED. ROAD DIST. NO. 1 ILLINOIS FED. AID PROJECT					

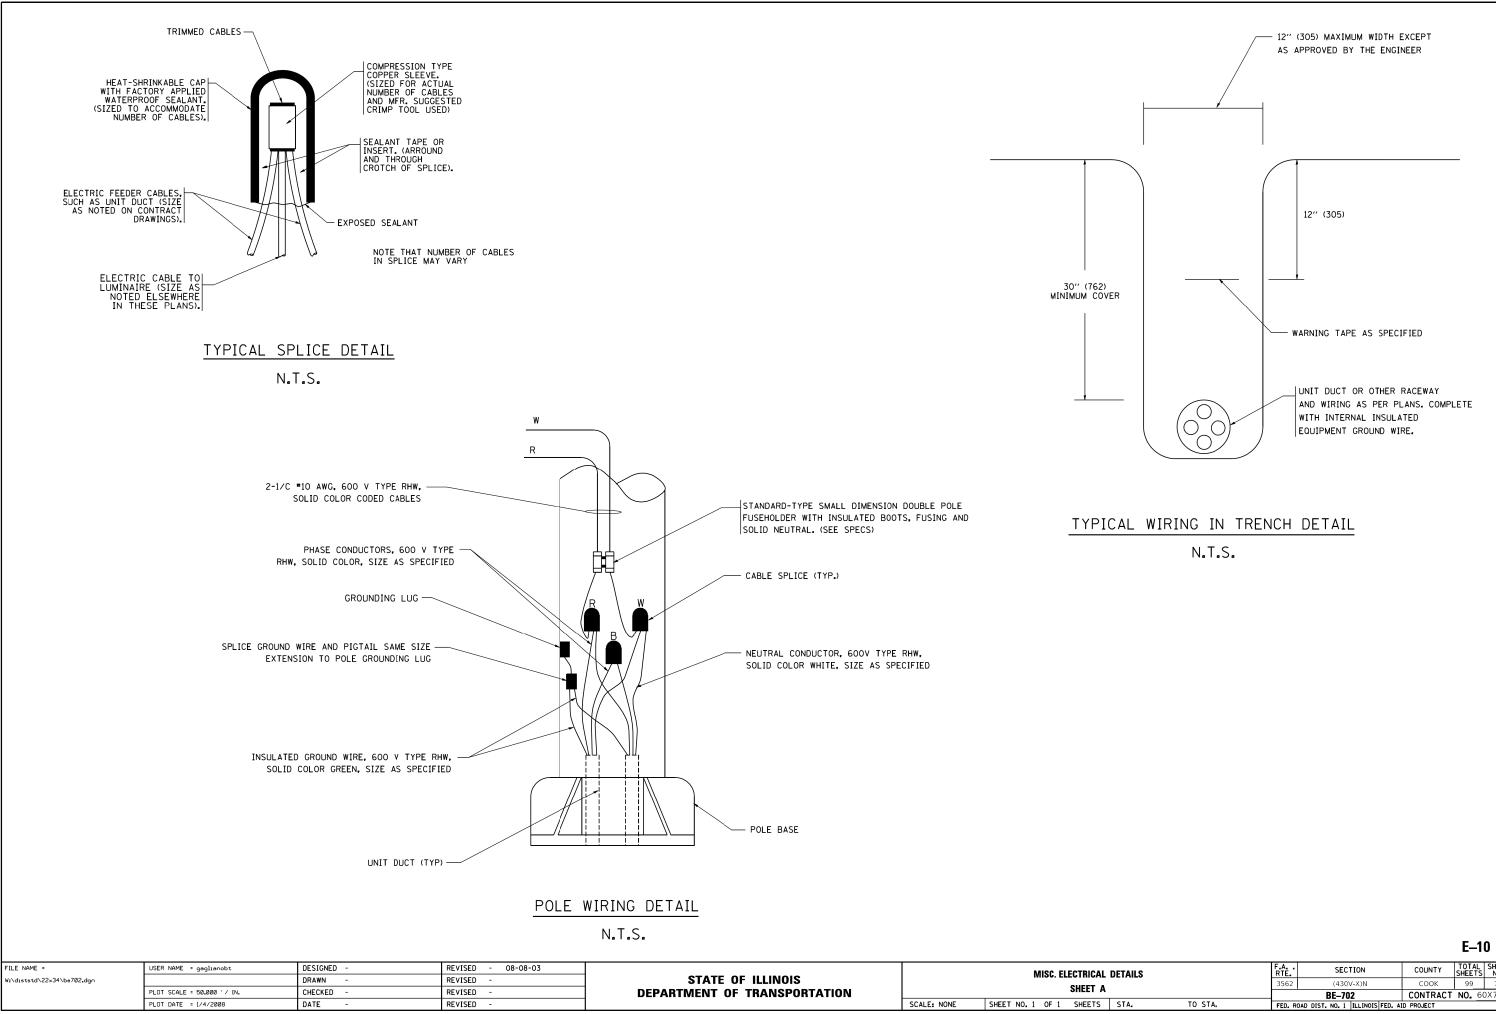

AL DETAILS		F.A RTE.	SECTION	COUNTY	TOTAL SHEETS	SHEET NO.		
٨			3562	(430V-X)N		СООК	99	70
A			BE-702		CONTRACT	NO. 60	DX71	
S	STA.	TO STA.	FED. R	DAD DIST. NO. 1 ILLINOIS	FED. AI	D PROJECT		

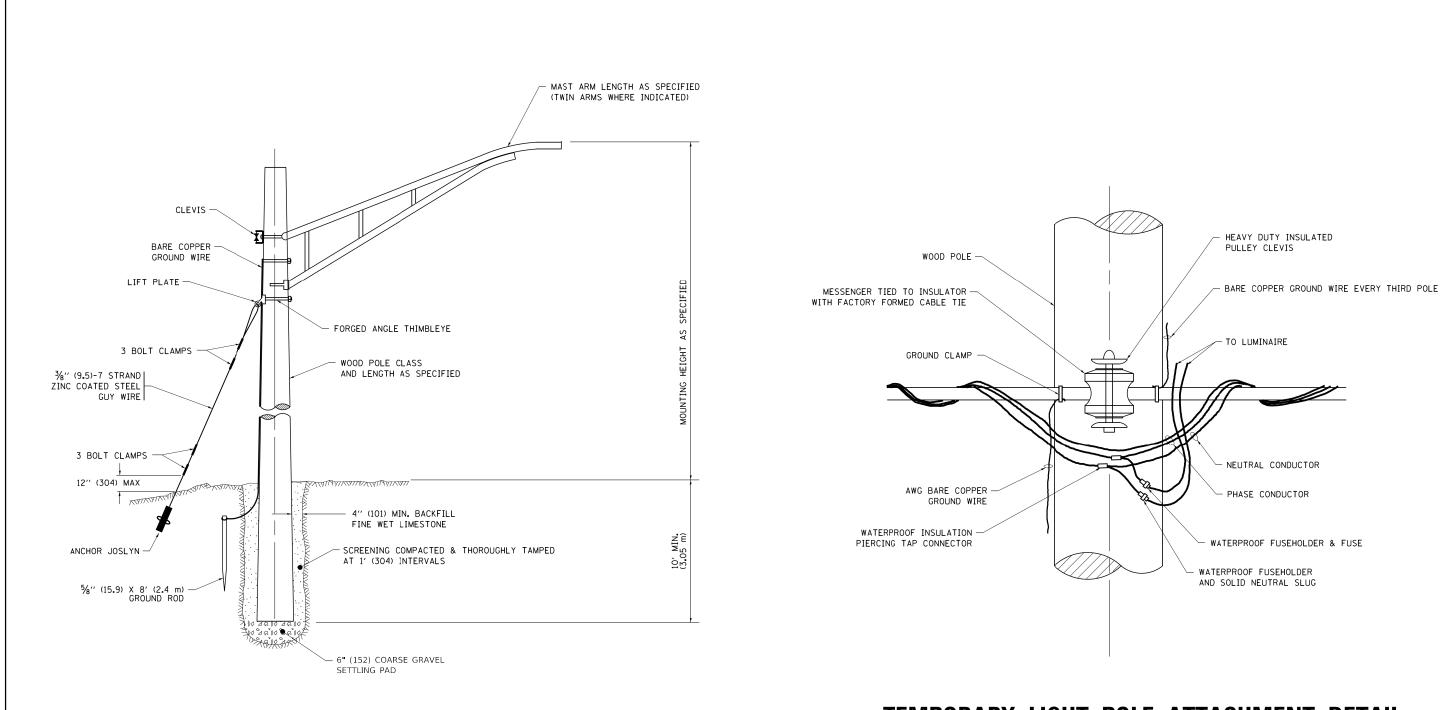

# **TEMPORARY LIGHT POLE DETAIL**


# **TEMPORARY LIGHT POLE ATTACHMENT DETAIL**

#### NOTE:

- 1. ALL DIMENSIONS IN INCHES (MILLIMETERS) UNLESS OTHERWISE INDICATED.
- 2. MAST ARM SHALL BE RATED FOR THE SPECIFIED MOUNTING HEIGHT.

F:	LE NAME =	USER NAME = footemj	DESIGNED -	REVISED - 08-08-03			TEMPORARY LIGHT POLE DETAILS		F.A.	SECTION	COUNTY TOTAL SHEET
p	:\\IL084EBIDINTEG.1111no1s.gov:PWIDOT\Do	uments\IDOT Offices\District 1\Projects\Dist		REVISED - R.T. 07-26-16	STATE OF ILLINOIS				3562	(430V-X)N	COOK 99 71
		PLOT SCALE = 50.000 ' / 10.		REVISED -	DEPARTMENT OF TRANSPORTATION					BE800	CONTRACT NO. 60X71
De	fault	PLOT DATE = 7/27/2016	DATE –	REVISED -		SCALE: NONE	SHEET 1 OF 1 SHEETS STA.	TO STA.	ILLINOIS FED. AID		AID PROJECT


E–11

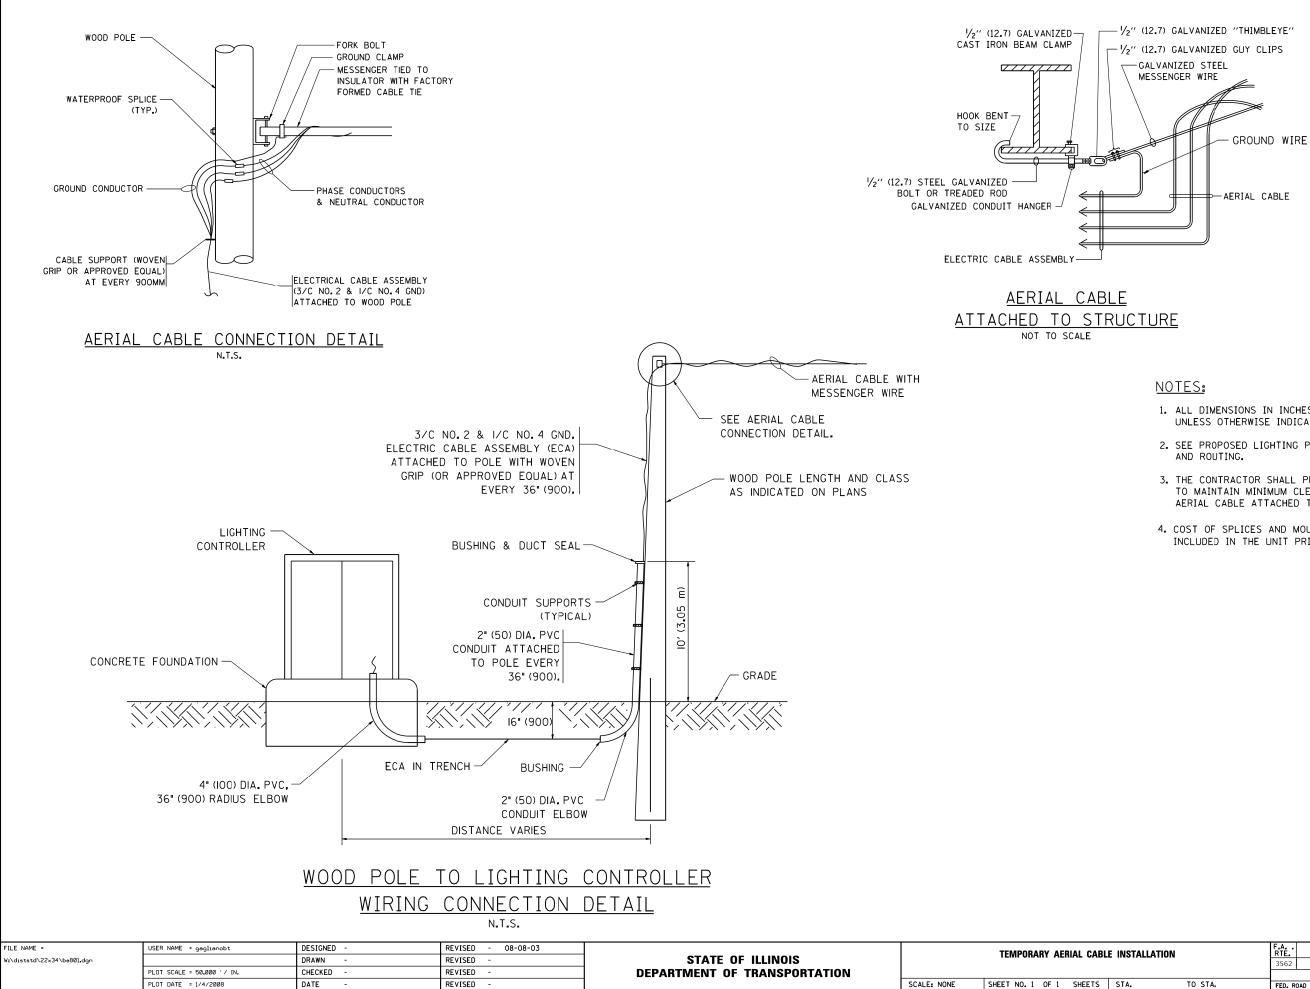

- 1. ALL DIMENSIONS IN INCHES (MILLIMETERS) UNLESS OTHERWISE INDICATED.
- 2. SEE PROPOSED LIGHTING PLAN FOR CONDUIT, CABLE
- 3. THE CONTRACTOR SHALL PROVIDE INTERMEDIATE SUPPORTS TO MAINTAIN MINIMUM CLEARANCES. REFER TO AERIAL AERIAL CABLE ATTACHED TO STRUCTURE DETAIL.
- 4. COST OF SPLICES AND MOUNTING HARDWARE SHALL BE INCLUDED IN THE UNIT PRICE FOR AERIAL CABLE.

BLE INSTALLATION		F.A RTE.	SECTION	COUNTY	TOTAL SHEETS	SHEET NO.		
		3562	(430V-X)N	СООК	99	72		
				BE801	CONTRACT	NO. 60	)X71	
	STA.	TO STA.	FED. ROAD DIST. NO. 1 ILLINOIS FED. AID PROJECT					

E–12

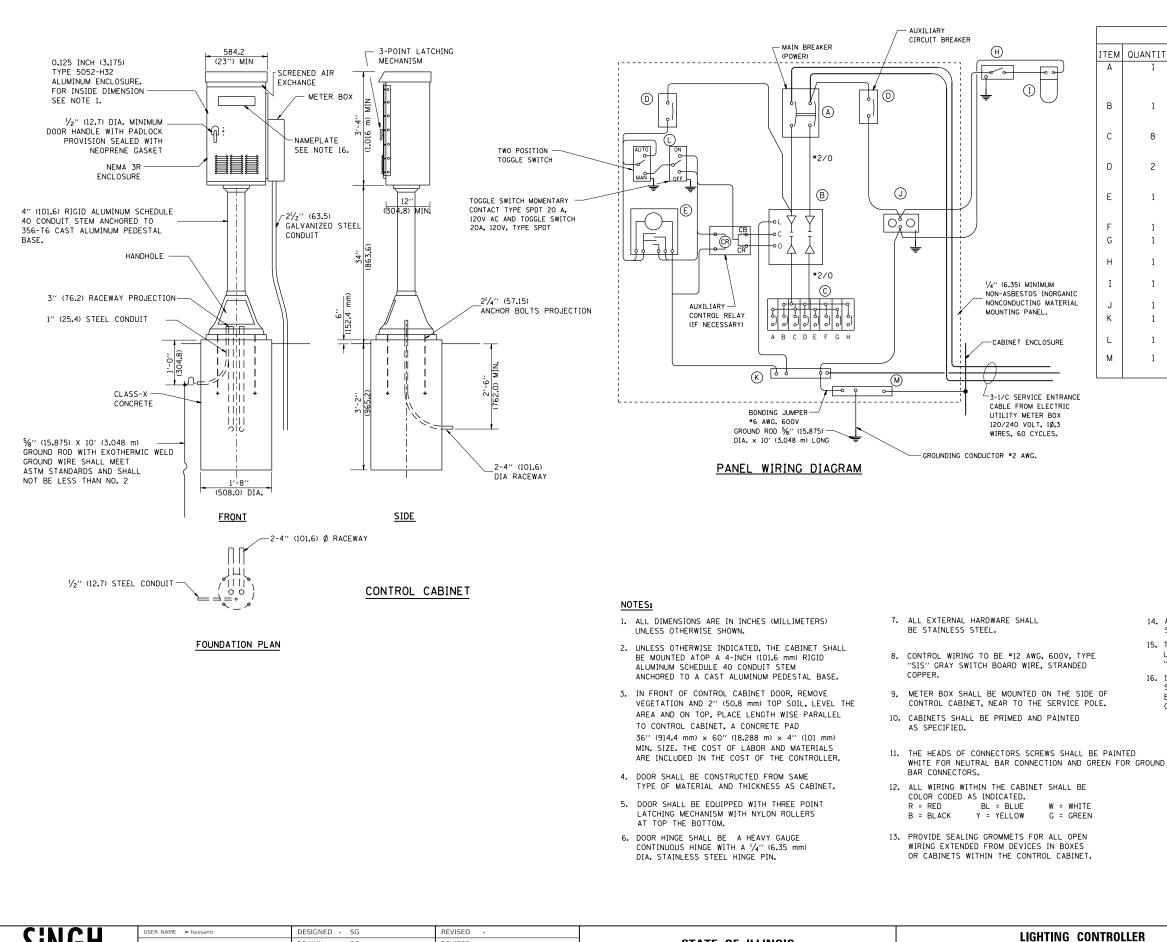


CINCII	USER NAME = hassann	DESIGNED - SG	REVISED -			11	IGHTING	CONT
SINGH		DRAWN - SG	REVISED -	STATE OF ILLINOIS				
	PLOT SCALE = 100.0000 / in.	CHECKED - RP	REVISED -	DEPARTMENT OF TRANSPORTATION			PEDEST	
SINGH + ASSOCIATES, INC. CONSULTING ENGINEERS	PLOT DATE = 3/23/2020	DATE - 6/18/2019	REVISED -		SCALE:	SHEET	OF	SHEETS

		PANEL EQUIPMENT
		BILL OF MATERIAL
ITEM	QUANTITY	DESCRIPTION
A	1	MAIN CIRCUIT BREAKER, 2 POLE, 600 VOLT 100 AMP, FRAME, 60 AMP, NON-INTERCHANGEABLE TRIP INTERRUPTING RATING NEMA-22000 AMP. AT 240 VOLT.
В	1	REMOTE CONTROL SWITCH, ELECTRICALLY OPERATED, MECHANICALLY HELD, 2 POLE, SINGLE THROW, 100 AMP., 600 VOLTS CONTROL CIRCUIT 120 VOLT.
С	8	CIRCUIT BREAKERS, 1 POLE, 120V., 100 AMP., FRAME 50 AMP. NON-INTERCHANGEABLE TRIP INTERRUPTING RATING NEMA-10,000 AMP. AT 120 V.
D	2	CONTROL CIRCUIT-CIRCUIT BREAKER. 1 POLE, 120 V., 100 AMP. FRAME, 15 AMP. NON-INTERCHANGEABLE TRIP INTERRUPTING RATING NEMA-5000 AMP. AT 240 V.
E	1	ASTRONOMIC MICROPROCESSOR-BASED 2-CHANNEL CONTROLLER [TIME SWITCH].
F	1	NOT USED
G	1	NOT USED
н	1	SPST 20A SWITCH ON DOOR, TO TURN LIGHT ON WHEN DOOR IS OPEN,
Ι	1	INCANDESCENT LIGHTING FIXTURE ENCLOSED AND GASKETED WITH 60 WATT, 120 V. LAMP.
J	1	20 A., 120 V., DUPLEX RECEPTACLE, GFCI.
к	1	COPPER GROUND BUS 1/4" (6.35) X 1" (25.4) X 12" (304.8 mm) LONG MOUNTED ON PANEL WITH LUGS AND 4 SPARE LUGS
L	1	TOGGLE SWITCHES MOUNTED IN 4" (101.6) X 4" (101.6 mm) BOX.
м	1	COPPER GROUND BUS $^{\prime}\!\!\!/_4^{\prime\prime}$ (6.35) X 1" (25.4) X 12" (304.8 mm) LONG MOUNTED ON PANEL WITH LUGS AND SPARE LUGS


- 14. ALL WIRING SHALL BE NEATLY DRESSED AND SUPPORTED.
- 15. THE CONTROLLER SHALL BE CONSTRUCTED TO U.L. STD. 508 AND BEAR THE U.L. LABEL "ENCLOSED INDUSTRIAL CONTROL PANEL".
- 16. 12" (304.8) X 16" (406.4 mm) STAINLESS STEEL EXTERIOR NAMEPLATE SHALL BE ENGRAVED TO "STATE OF ILLINOIS LIGHTING CONTROLS" UNLESS OTHERWISE SPECIFIED.

G CONT	ROLLER		F.A.U. RTE	SECT	TION		COUNTY	TOTAL SHEETS	SHEET NO.
TAL M	DUNT		3562	(430\	/-X)N		СООК	99	73
							CONTRACT	NO. 60	)X71
SHEETS	STA.	TO STA.			ILLINOIS	FED. AI	D PROJECT		

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TAIL PLAN	F.A.U. RTE	SECTION	COUNTY	TOTAL SHEET HEETS NO.
55TH STREET	3562	(430V-X)N	соок	99 74
ETS STA. TO STA.		ILLINOIS FF	CONTRACT I	NO. 60X71
	1	Icanois PE		1

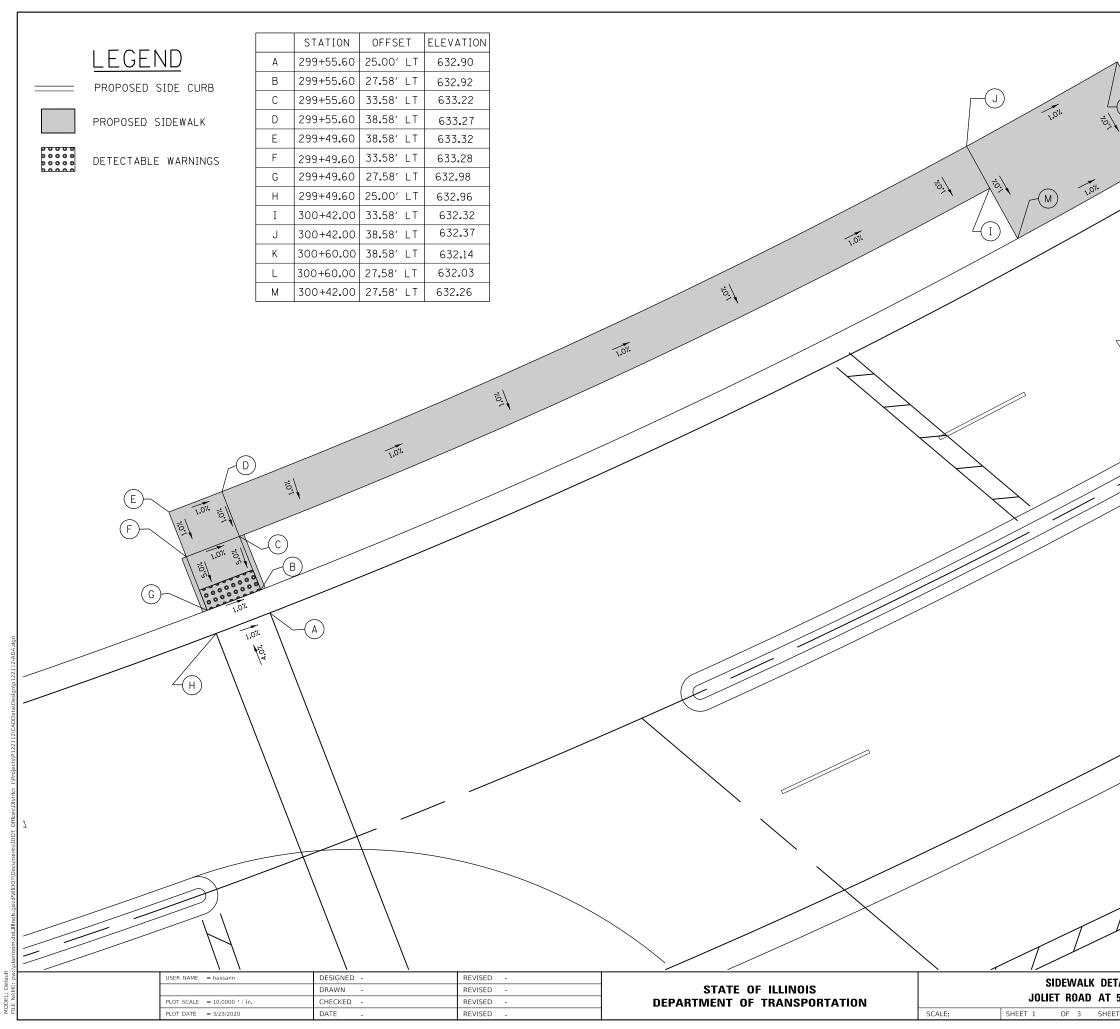

STATION	OFFSET	ELEVATION
299+55.60	25.00' RT	634.90
299+55.60	27.58′ RT	634.92
299+55.60	33.58′ RT	635.22
299+55.60	38.58′ RT	635.27
299+49.60	38.58′ RT	635.32
299+49.60	33.58′ RT	635.28
299+49.60	27.58′ RT	634.98
299+49.60	25.00' RT	634.96
298+98.90	33.58′ RT	635.78
298+49.23	65.20 RT	634.61
298+50.05	70.60 RT	634.50
299+00	38.58′ RT	635.73
299+91.46	38.58′ RT	635.09
299+94.47	33.58′ RT	635.06
1+10.82 D.W.	21.50' RT	632.65
1+10.82 D.W.	31.20′ RT	632.86
0+89.03 D.W.	25.10′ RT	633.41
0+89.03 D.W.	20.10' RT	633.36
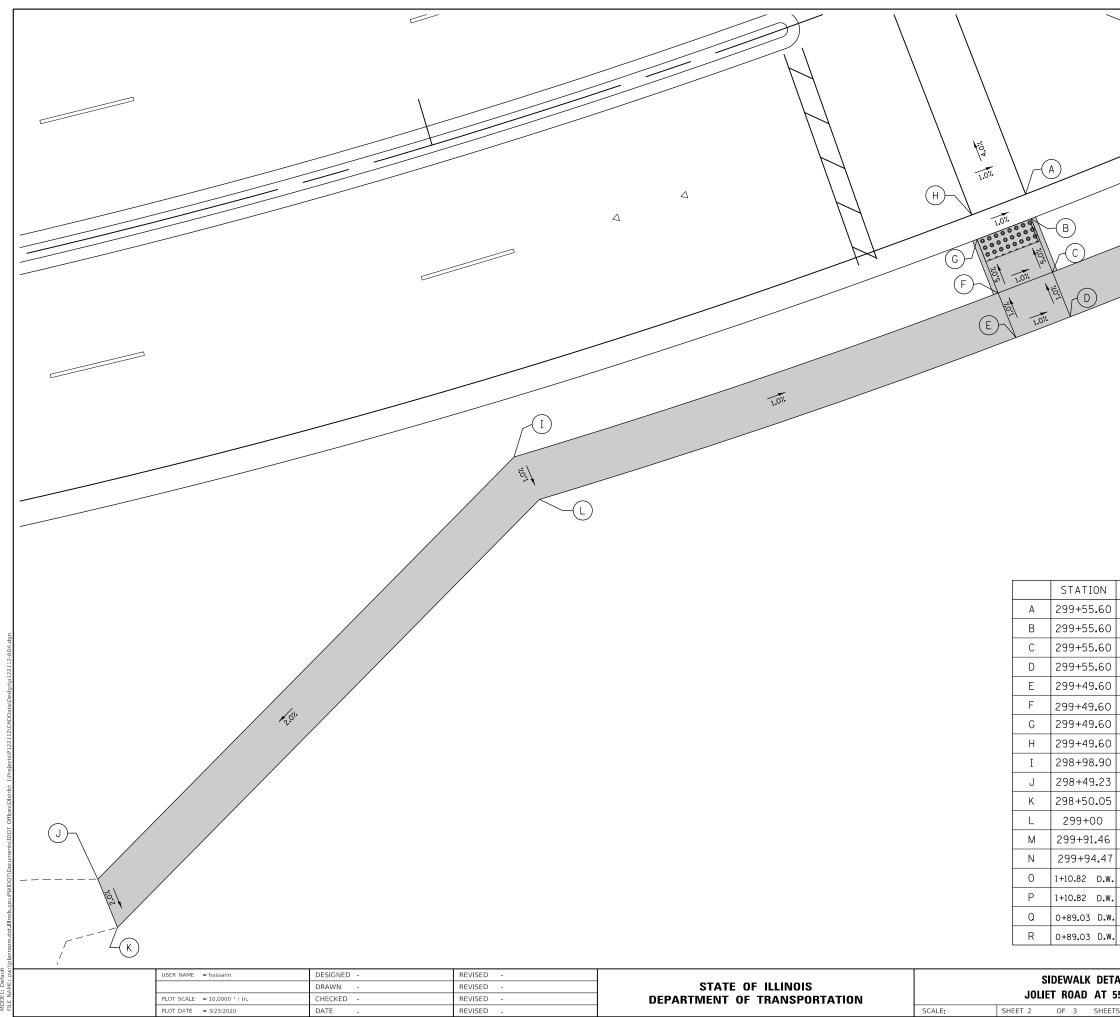
<u>LEGEND</u>

PROPOSED SIDE CURB

PROPOSED SIDEWALK



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DETECTABLE WARNINGS

A	l plan		F.A.U. RTE	9	SECT	ION		COUNTY	TOTAL SHEETS	SHEET NO.
55	TH STREET		3562	(4	130\	/-X)N		СООК	99	75
33								CONTRACT	NO. 6	0X71
TS	STA.	TO STA.				ILLINOIS	FED, AI	D PROJECT		

STATION OFFSET ELEVATION	2.32
A 299+55.60 25.00' RT 634.90	$\mathbb{R}$
B 299+55.60 27.58' RT 634.92	
C 299+55.60 33.58' RT 635.22	
D 299+55.60 38.58' RT 635.27	
E 299+49.60 38.58' RT 635.32	\$7
F 299+49.60 33.58' RT 635.28	
G 299+49.60 27.58' RT 634.98	
H 299+49.60 25.00' RT 634.96	

Ε	G	Е	Ν	D

PROPOSED SIDE CURB

298+98.90 33.58' RT

298+49.23 65.20 RT

298+50.05 70.60 RT

299+00 38.58′ RT

299+91.46 38.58' RT

299+94.47 33.58' RT

1+10.82 D.W. 21.50' RT

1+10.82 D.W. 31.20' RT 0+89.03 D.W. 25.10' RT

0+89.03 D.W. 20.10' RT

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633.36

PROPOSED SIDEWALK

DETECTABLE WARNINGS

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USER	ER NAME = hassann	DESIGNED -	REVISED -		SIDEWAL							
		DRAWN -	REVISED -	STATE OF ILLINOIS		-						
PLOT	OT SCALE = 10.0000 ' / in.	CHECKED -	REVISED -	DEPARTMENT OF TRANSPORTATION		JULIE	T ROAD	AT 5:	ЛН			
PLOT	OT DATE = 3/23/2020	DATE -	REVISED -		SCALE:	SHEET 3	OF 3	SHEETS	S			

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NLK DETAIL PLAN	F.A.U. RTE	SECTION	COUNTY	TOTAL SHEET SHEETS NO.
AD AT 55TH STREET	3562	(430V-X)N	соок	99 76
SHEETS STA. TO STA.	<b> </b>	ILLINOIS FED. AI	CONTRACT D PROJECT	NO. 60X71

0-

UTE FAU 3562 DESCRI	PTION	Pro	pose	d 55t	h St.	& Joliet Rd. Improvement Pro	ject	I	ogged	Ву	٢D
LOCAT	TION 5	5th St	treet a	& Joli	et Ro	d, McCook, IL	SEC	TWP.	RNG	. P	ΡM
UNTY Cook	STRUC	TURE N	10.			(Exist.)				( P	rop.)
-	Drill	ing Me				<b>O T 206-09</b> Hammer Type	Automati	<u>e Han</u>	nmer	1	1
ring No. <b>B-1</b> ation 298+58 fset 76'RT	E L E V.	D E P T	S P T	U C S	M O I S	Surf. Wat. El Groundwater Elev.: When Drilling at Completion	E L E V.	D E P T	S P T	U C S	M O I S
ound rface El. + <b>100.00+/- Feet</b>	(Feet)	H (ft.)	N (blows)	Qu (TSF)	<b>T.</b> (%)	After Hrs	(Feet	H (ft.)	N (blows)	Qu (TSF)	T.
BITUMINOUS CONCRETE 'EMENT	99.5						treet		(DIOWS	(151)	(70)
PORTLAND CEMENT CONCRETE											
.: CLAY LOAM, Dark Brown, Some to	98.9	1.0	4								
e Sand, Trace Gravel, Medium to Stiff,			4	0.75	26.2						
(A-6) berg Limits Test		2.0	3	P	20.2						
34, PL=16, PI=18) bined Analysis)		_	5								
		3.0									
		_									
OMITIC LIMESTONE BEDROCK,	96.0	4.0	5 50	1.25 P	23.0						
Weathered											
	95.0	5.0									
inued on Corresponding ROCK CORE for Boring B-1.											
:		6.0									
op of weathered dolomitic limestone ock was encountered at approximately		_									
t below the existing ground surface		7.0									
atal split spoon sampler refusal was		/.0									
untered at approximately 4.08 feet w the existing ground surface level 50 blows/ 1 inch) and total hollow stem											
er refusal was encountered at		8.0									
oximately 5 feet below the existing nd surface level.		_									
Boring elevation shown is relative to a		9.0									
oring elevation shown is relative to a orary benchmark (BM) that is the top are metal plate in the concrete island erneath on the southwest traffic signal											
t located at the intersection of Joliet d and 55th Street.		10. <u>0</u>									
		11. <u>0</u>									
		12.0									
		13.0									
		_									
		14.0									
		14.0									
Standard Penetration Test-Blows per size	x inche	15.0 es to dr	rive 2"			(QU)B=Bulge S=Shear P=Penetro	ometer Test				
0. Split Spoon Sampler 18" with 140lb l						DRILL RIG D-					

ILLINOIS DEPARTMI OF TRANSPORTATIO		S	OI	LB	OF	RING LOG			-	ge 1 C	
						& Joliet Rd. Improvement Pro	oiect			11/2 By	
	_					-		_			
				& Joh	et Roa	id, McCook, IL	SEC T	WP.	RNG.		M
COUNTY Cook		TURE			CIPT	(Exist.)	A 4 4 * -	TT		(P	rop.
	E	ing M	S		M		Automatic	_		TT	3.4
Boring No. <b>B-2</b> Station <b>299+03</b>	L	E	P	С	0	Surf. Wat. El Groundwater Elev.:	E L	D E	S P	U C	M O
offset 33'LT	E	P T	Т	S	I S	When Drilling DRY	E	P T	Т	S	I S
round	<b>V.</b>	Ĥ	Ν	Qu	T.	at Completion DRY	V.	Ĥ	Ν	Qu	Ť
urface El. + <b>98.98</b> +/- Feet 'FILL: CLAY TOPSOIL, Dark Brown	(Feet)	(ft.)	(blows)	(TSF)	(%)	After Hrs Road and 55th Street.	(Feet)	(ft.)	blows)	(TSF)	(%
(A-7-	5)	_									
	98.0	1.0_	_					16.0			
LL: CLAY LOAM, Dark Brown and own, Trace Sand and Gravel, Hard to		-	5					_			
ery Stiff to Medium, Moist (A-	6)	2.0	7	4.25 P	16.9			17.0			
		-	9	1				_			
			_					18.0			
		3.0	-					18.0			
		-	- 3								
terberg Limits Test		4.0	5	2.25	167			19. <u>0</u>			
LL=32, PL=21, PI=11) Combined Analysis)		_	-	3.25 P	16.7						
		5.0	- 3					20.0			
		_	_								
		6.0	_					21.0			
		-	2					_			
		7.0	2		17.8			22.0			
			3								
		-									
		8.0						23.0			
DLOMITIC LIMESTONE BEDROCK,	90.5		50								
n, Weathered		9.0	-					24.0			
		_	_								
	89.0	10.0	_					25.0			
ontinued on Corresponding ROCK COR OG for Boring B-2.	E	-						_			
ote:		11.0	_					26.0			
Top of weathered dolomitic limestone		-	-								
chock was encountered at approximately 5 feet below the existing ground surface	y		-								
vel.		12.0	_					27.0			
Total split spoon sampler refusal was countered at approximately 8.58 feet low the existing ground surface level		-	-					_			
I=50 blows/ 1 inch) and total hollow ster ger refusal was encountered at	m	13.0	-					28.0			
proximately 10 feet below the existing ound surface level.		_						_			
		14.0						29.0			
Boring elevation shown is relative to a mporary benchmark (BM) that is the top the metal plate in the concrete island	>	_	_					_			
aderneath on the southwest traffic signal ast located at the intersection of Joliet		15.0						30.0			
I=Standard Penetration Test-Blows pe D.D. Split Spoon Sampler 18" with 140						(QU)B=Bulge S=Shear P=Penetr	ometer Test				


USER NAME = hassann	DESIGNED -	REVISED -				SUIL	BORING	10
	DRAWN -	REVISED -	STATE OF ILLINOIS		10			
PLOT SCALE = 100.0000 ' / in.	CHECKED -	REVISED -	DEPARTMENT OF TRANSPORTATION		JU	LIET KUA	AD AT 55	11
PLOT DATE = 3/23/2020	DATE -	REVISED -		SCALE:	SHEET	OF	SHEETS	(


SECTION COUNTY TOTAL SHEET SHEETS NO. (430V-X)N COOK 99 77 CONTRACT NO. 60X71 ILLINOIS FED. AID PROJECT F.A.U. RTE 3562 LOGS (430V-X)N 5TH STREET S STA. TO STA.


ROUTE FAU 3562 DESCRIPTION Proposed 55th St. & Joliet Rd. In	iprov	eme	nt Pr			_	ogged By	
SECTION LOCATION 55th Street & Joliet Road, McCook, IL				SE	СТ	WP.	RNG.	PM
COUNTY Cook CORING METHOD AASHTO T 255-06 (201:	/			[	R		CORE	s
STRUCT. NO. (Prop.) CORING BARREL TYPE & SIZE Diamond Bit		2-1/	8''		Ê C	R		T R
Station     Core Diameter     1       BORING NO.     B-1     Top of Rock Elevation     M.3		Е	D	С	0	ġ	T	E
BORING NO. B-1 Top of Rock Elevation M.S Station 298+58 Begin Core Elevation M.S	.L.	L E	E P	O R	V E		I M	N G
Offset 76'RT		V.	Т	к Е	R	D	E	T
Bedrock Surface Elev. +96.00 +/- Feet			H (ft.)	(#)	Y (%)	(%)	(min/ft)	H (TSF)
DOLOMITIC LIMESTONE BEDROCK, Tan, Weathered		96.0		(#)	(70)	(70)	(1111/11)	(151)
N= 50 Blows / 1" @ 4.08')		95.0	5.0					
DOLOMITIC LIMESTONE BEDROCK, Tan and Light Gray, Fine to Medium Grained, Highly to Moderately Weathered, Moderately to Closely Spaced Horizontal Joints, Moderately Spaced Verti	o cal		_					
loints, Trace Brown Silt Within Joints, Good Discontinuity Condition, Little Vugs, Rock Quality i Very Poor, Estimated Strength: Medium Strong Rock	5		<u>    6</u> .0	RUN 1	92	0.0		
			-					
DOLOMITIC LIMESTONE BEDROCK, Tan and Light Gray, Fine to Medium Grained, Moderat		93.0	7.0					
Weathered, Moderately Spaced Horizontal Joints, Widely Spaced Vertical Joints, Trace Brown Sil Within Joints, Good Discontinuity Condition, Some Vugs, Rock Ouality is Very Poor, Estimated	ť							
Strength: Medium Strong Rock			<u>8</u> .0					
			- 9.0	RUN 2	93	23.0		
		90.0	10.0					
DOLOMITIC LIMESTONE BEDROCK, Tan and Light Gray, Fine to Medium Grained, Moderat Weathered, Moderate Spaced Horizontal Joints, Widely Spaced Vertical Joints, Trace Brown to G	av							
Silt, Clay, and Some Chert Within Joints, Good Discontinuity Condition, Some Vugs, Rock Quali Very Poor, Estimated Strength: Medium Strong Rock	y is		11.0					
			12.0					
			- 12.0					
			<u>_13</u> .0 _					
			-14.0					
			-					
				RUN 3	98	7.0		
			_					
			_ <u>17</u> .0					
			18.0					
			_					
and of Paring @ 20 feat		80.0	20.0					
End of Boring @ 20 feet			_					
Note: Total split spoon refusal at approximately 4.08 feet ( $N=50/1^{\circ}$ ). At 5 feet below the existing			21.0					
grade level a NX size (2-1/8" diameter) diamond bit core barrel attached to the drill rods was then used to core the bedrock.								
		-	23.0					
			0					
			-24.0					

ILLINOIS DEPARTM OF TRANSPORTATIO		J					Page 1 Date 11	
	SCRIPTION Proposed 55th St. & Joliet Rd. Im	provem	ent Pr	oject		L	ogged By	
SECTION	DCATION 55th Street & Joliet Road, McCook, IL			SI	EC I	WP.	RNG.	PM
COUNTY Cook	CORING METHOD AASHTO T 255-06 (2015	)					CODE	
STRUCT. NO. (Prop	.) CORING BARREL TYPE & SIZE _Diamond Bit	,	/8''		R E		CORE	S T
Station	Core Diameter <b>2.04"</b> in	Е	D	С		R	Т	Ř E
BORING NO. <b>B-2</b>	Top of Rock ElevationM.S	. г. L	E	0	V	Q	I	Ν
Station         299+03           Offset         33' LT	Begin Core ElevationM.S	. L. E V.	P T	R E	E R	Ď	M E	G T
Bedrock Surface Elev. +90.48	+/_ Feet	v.	Η		Y	•		Н
DOLOMITIC LIMESTONE BEDROCK,		90.	$\frac{(\text{ft.})}{5}$	(#)	(%) 0	(%)	(min/ft)	(TSF)
(N = 50 Blows / 1 " @ 8.58')			9.0					
		89.	$0^{-10.0}$					
Medium Grained, Moderately Spaced Ho	Tan and Buff Color, Moderately Weathered, Fine to rizontal Joints, Moderately Spaced Vertical Joints, Trace							
Brown Silt Within Joints, Fair Discontinu Poor, Estimated Rock Strength: Medium	ity Condition, Trace to Little Vugs, Rock Quality is Very Strong Rock		_11.0					
			-12.0					
			12.0					
			13.0					
			_					
			14.0					
			15.0					
				Run 1	88	7.0		
			_					
			_17.0					
			-19.0					
			-18.0					
			19.0					
			_					
End of Boring @ 20 feet		79.	0-20.0					
Note:			21.0					
	tely 8.58 feet (N=50/1"). At 10 feet below the existing grad bit core barrel attached to the drill rods was then used to	de	0					
lével a NX size (2-1/8" diameter) diamon core the bedrock.	d bit core barrel attached to the drill rods was then used to	)	22.0					
			_					
			_					
			<u>_26</u> .0					
			27.0					
			28.0					


USER NAME = hassann	DESIGNED -	REVISED -				BOCK	BORING	LOGS		F.A.U. RTE	SECTION	COUNTY	TOTAL SHEET SHEETS NO.
	DRAWN -	REVISED -	STATE OF ILLINOIS		10					3562	(430V-X)N	соок	99 78
PLOT SCALE = 100.0000 ' / in.	CHECKED -	REVISED -	DEPARTMENT OF TRANSPORTATION		JU	LIET KUA	AD AI 5	5TH STREET			,	CONTRACT	T NO. 60X71
PLOT DATE = 3/23/2020	DATE -	REVISED -		SCALE:	SHEET	OF	SHEETS	STA.	TO STA.		ILLINOIS FED	AID PROJECT	

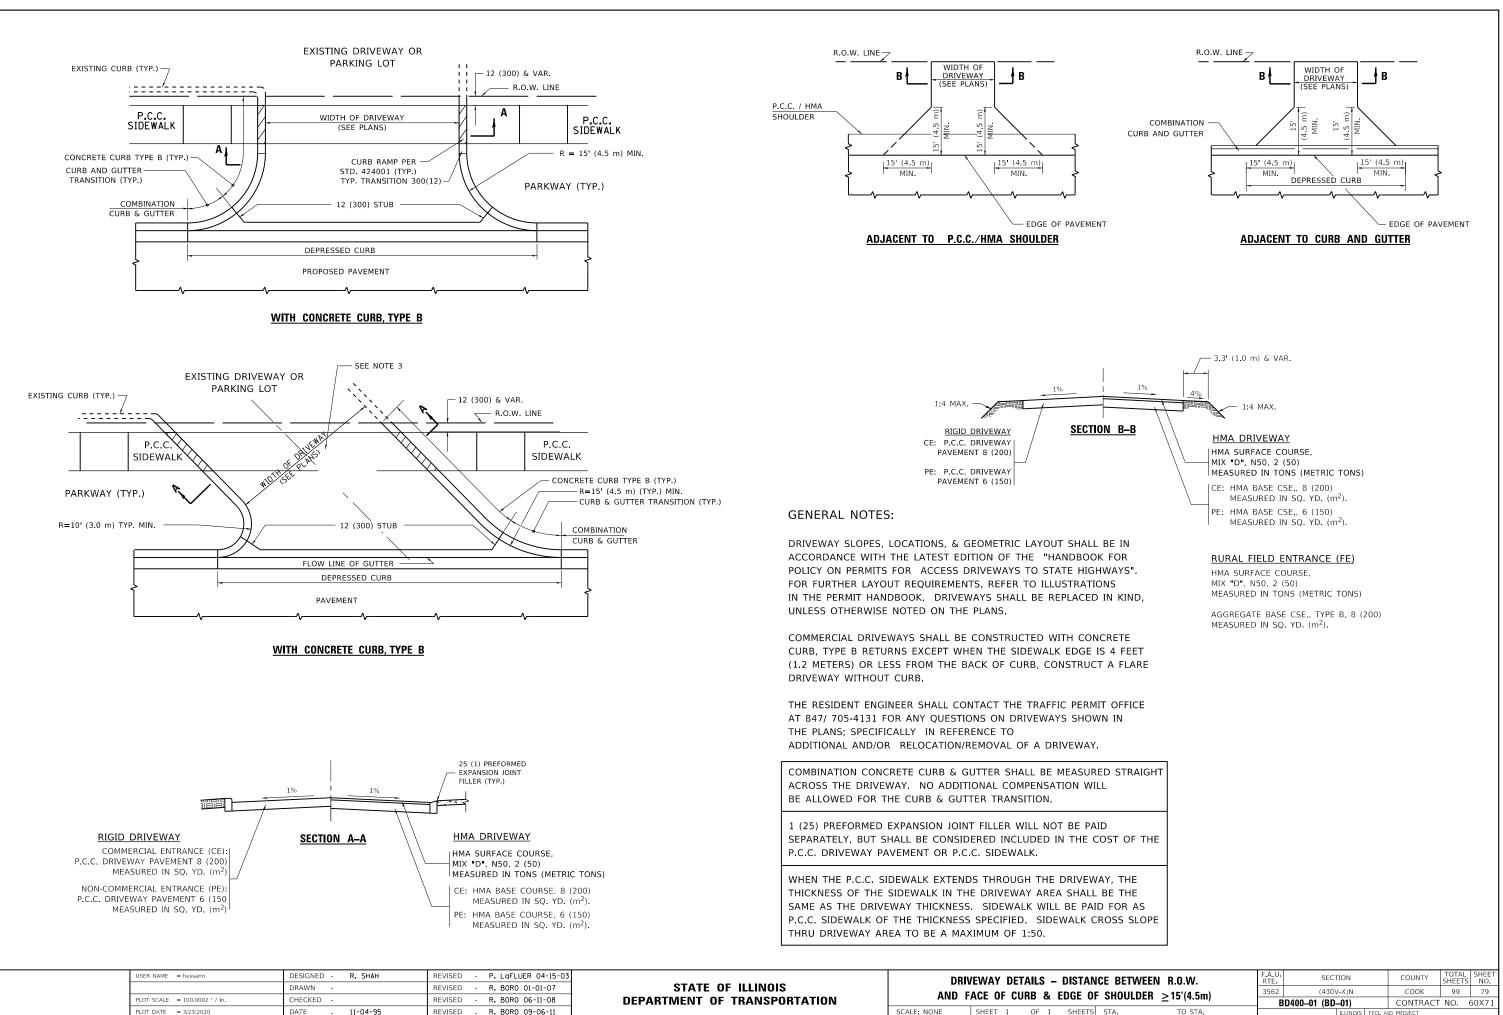

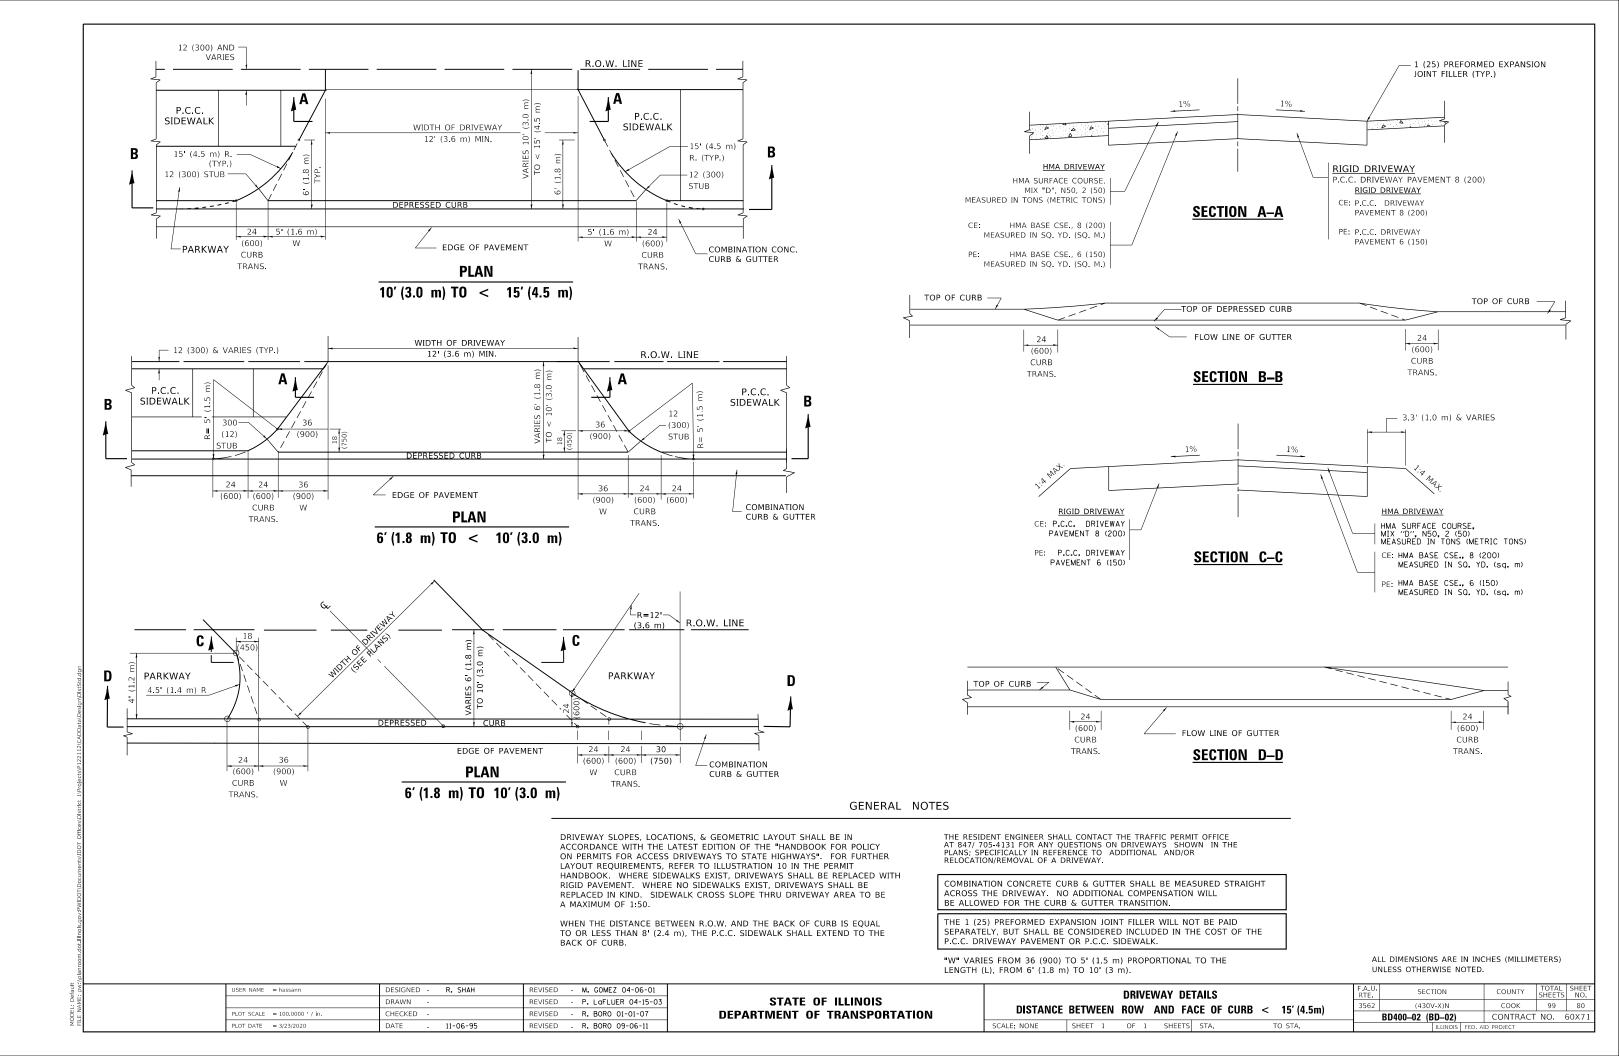

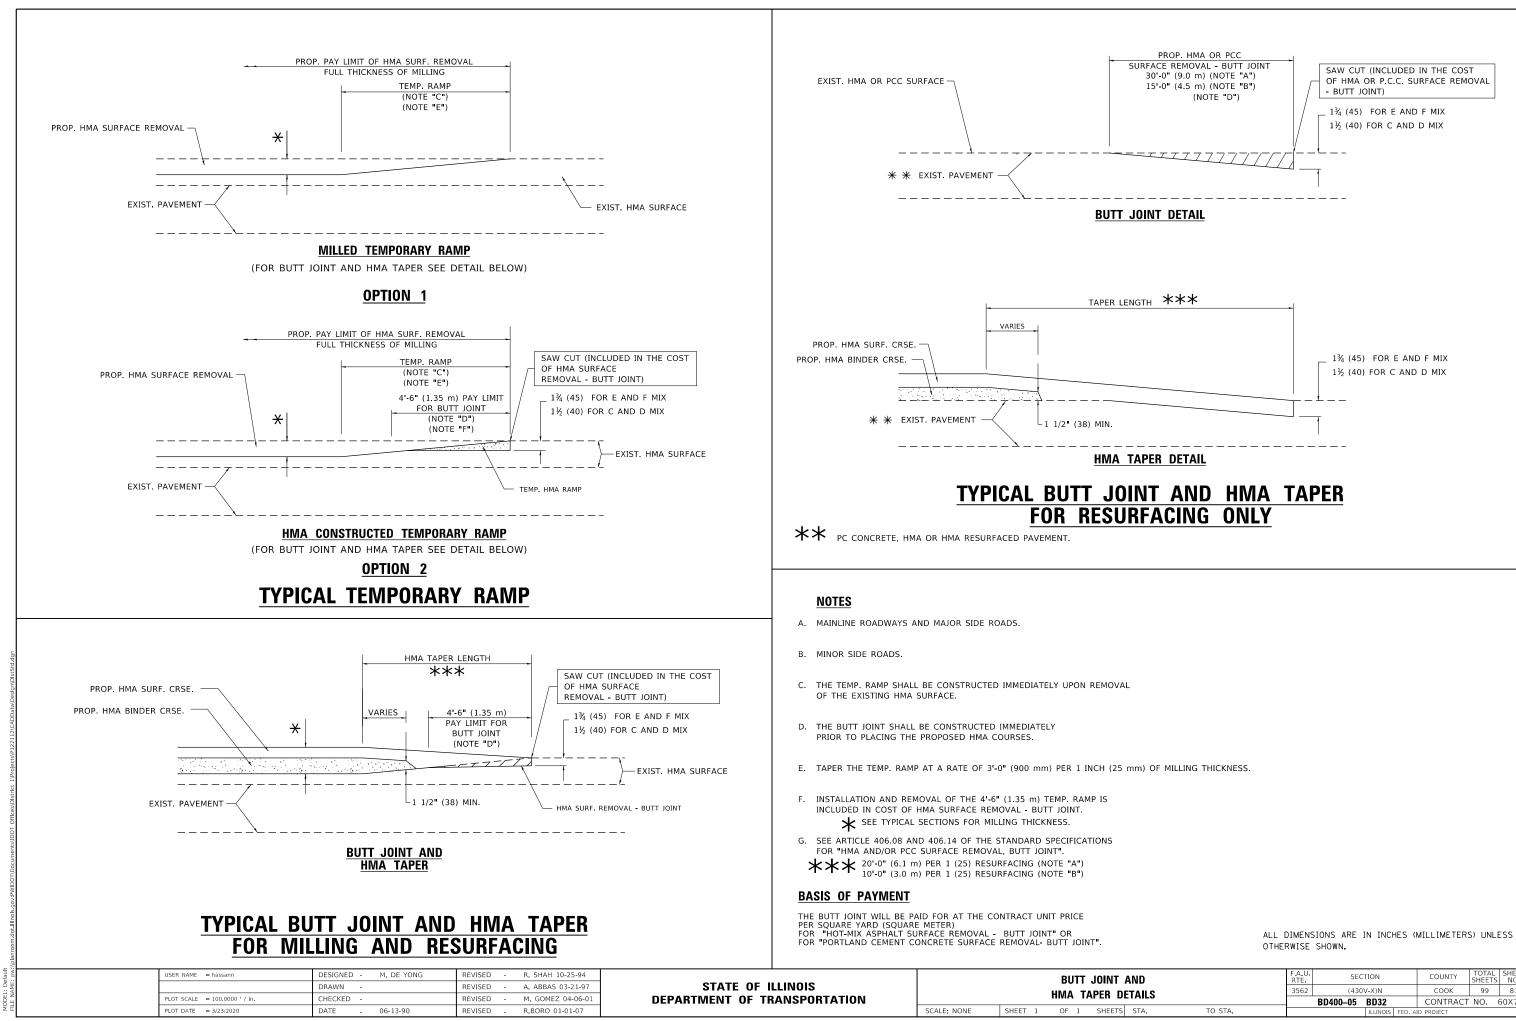

r and		F.A.U. RTE	SECTION	COUNTY	TOTAL SHEETS	SHEET NO.
DETAILS		3562	(430V-X)N	соок	99	81
			BD400–05 BD32	CONTRACT	NO. (	60X71
IS STA.	TO STA.		ILLINOIS FED. A	ID PROJECT		

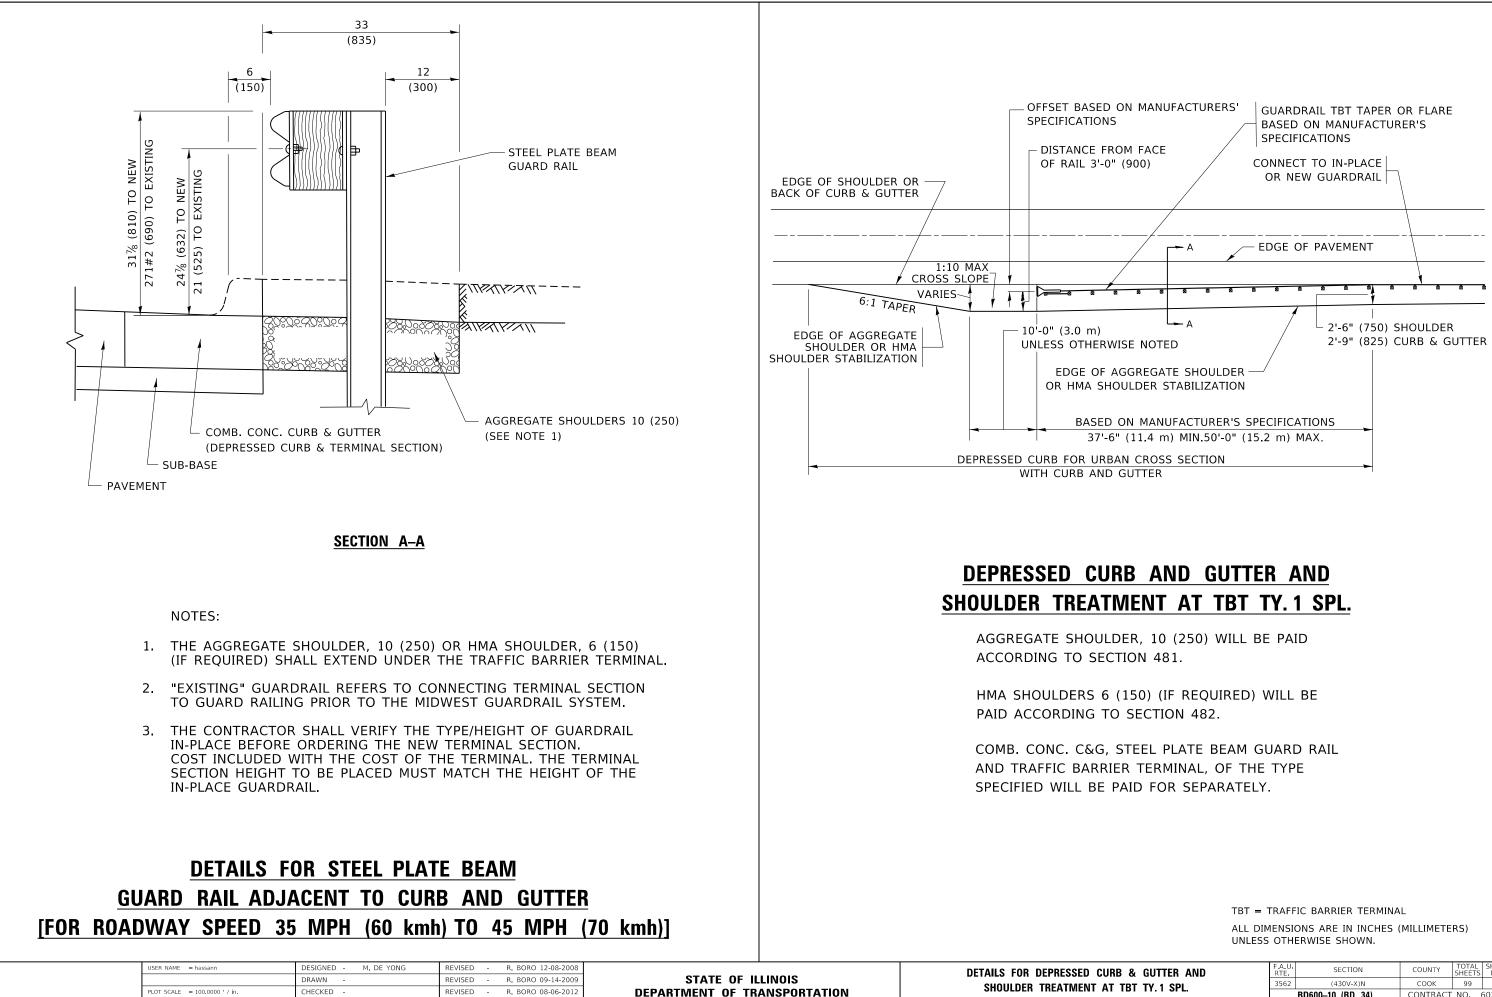

R. BORO 05-08-2015

REVISED -


LOT DATE = 3/23/2020

DATE

09-22-90

SCALE: NONE SHEET 1 OF 1 SHEET

CURB & C	IRB & GUTTER AND		F.A.U. SECTION		COUNTY	TOTAL SHEETS	SHEET NO.	
AT TBT TY.1 SPL		3562	(430\	/-X)N		СООК	99	82
	1. 1 31 L.		BD600-10 (B	D 34)		CONTRACT	NO.	50X71
TS STA.	TO STA.			ILLINOIS	FED. AI	D PROJECT		

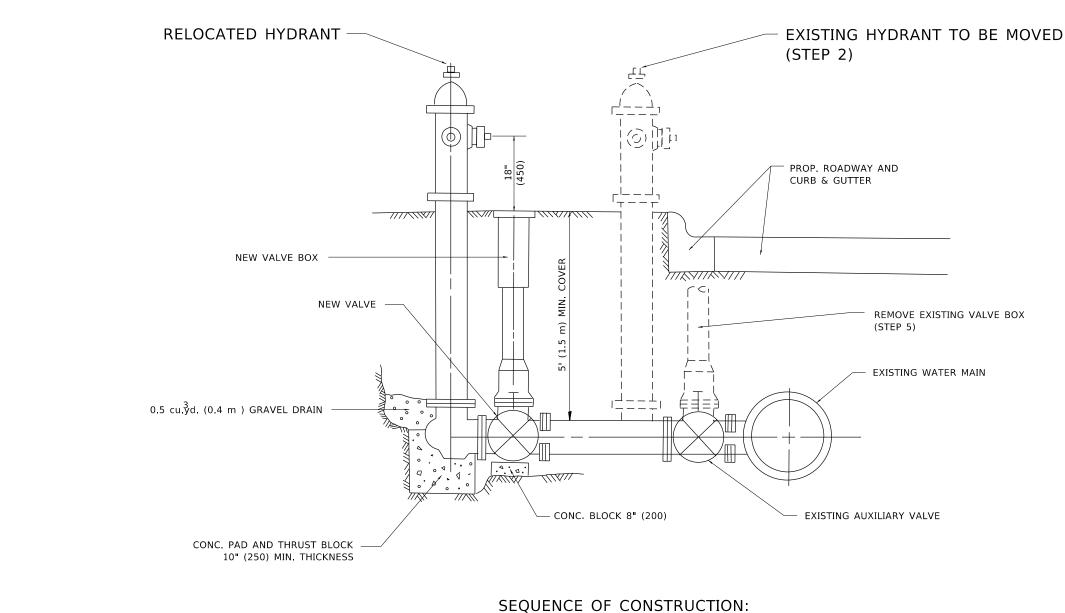

- 1. CLOSE EXISTING VALVE.
- 2. REMOVE EXISTING HYDRANT.
- 3. INSTALL HYDRANT EXTENSION AND NEW VALVE.
- 4. RELOCATE EXISTING HYDRANT.
- 5. OPEN EXISTING VALVE, REMOVE BOX.
- 6. BACKFILL.
- 7. FLUSH AND TEST FOR CHLORIDE RESIDUAL AND PROVIDE TEST.

NOTE:

ALL WORK TO BE DONE IN ACCORDANCE WITH ARTICLE 564 OF THE STANDARD SPECIFICATIONS. NEW VALVE AND BOX SHALL BE SAME MAKE AND MODEL AS EXISTING.


# FIRE HYDRANT TO BE MOVED

USER NAME = hassann	DESIGNED -	REVISED R. SHAH 09-09-94					F.A.U. RTE	SECTION	COUNTY TOTA	AL SHEET ETS NO.
	DRAWN -	REVISED - R. SHAH 10-25-94	STATE OF ILLINOIS		FIRE HYDRANT TO BE MOVED		3562	(430V-X)N	СООК 99	9 83
PLOT SCALE = 100.0000 ' / in.	CHECKED -	REVISED -	DEPARTMENT OF TRANSPORTATION				_	BD36	CONTRACT NO.	. 60X71
PLOT DATE = 3/23/2020	DATE -	REVISED -		SCALE: NONE	SHEET 1 OF 1 SHEETS STA.	TO STA.		ILLINOIS FE	D. AID PROJECT	

# ALL DIMENSIONS ARE IN INCHES (MILLIMETERS) UNLESS OTHERWISE SHOWN.

		-``\' ** **
	15 (380) 21 (530)	* TYPE III BARRICADES WITH TWO FLASHING AMBER LIGHTS ON EACH. (SEE NOTE 2) 200'] (60 m]) DRIVEWAY
		speed Limits 40 MPH (60 km/h) speed Limits 40 MPH (60 km/h) speed 10 ml)
	NOTES:	↔
	SHOWN ON THE DRAWING A a) ONE "ROAD CONSTRUCT MOUNTED ON IT APPRO b) THE CLOSED PORTION C	IMIT OF 40 MPH (60 km/h) OR LESS AS ND AS DIRECTED BY THE ENGINEER: TION AHEAD" SIGN 36 x 36 (900x900) WITH A FLASHER XIMATELY 200' (60 m) IN ADVANCE OF THE MAIN ROUTE. DF THE MAIN ROUTE SHALL BE PROTECTED BY TYPE II OR TYPE III BARRICADES, 1/3 OF
	THE CROSS SECTION OF 2. SIDE ROAD WITH A SPEED L AS SHOWN ON THE DRAWIN a) ONE "ROAD CONSTRUCT	THE CLOSED PORTION. IMIT GREATER THAN 40 MPH (60 km/h) IG AND AS DIRECTED BY THE ENGINEER: TION AHEAD" SIGN 48 x 48 (1.2 m x 1.2 m) WITH A IT APPROXIMATELY 500' (150 m) IN ADVANCE
	<ul> <li>b) BLOCKING WITH TYPE II OF THE CLOSED PORTIC</li> <li>3. CONES MAY BE SUBSTITUTEI SPACING DURING DAY OPER. IN HEIGHT.</li> <li>WHEN THE SIDE ROAD LIES</li> <li>4. SIGNING AND THE WORK ZC</li> </ul>	DF THE MAIN ROUTE SHALL BE PROTECTED BY I BARRICADES, 1/2 OF THE CROSS SECTION DN. D FOR BARRICADES OR DRUMS AT HALF THE ATIONS. CONES SHALL BE A MINIMUM OF 28 (710) BETWEEN THE BEGINNING OF THE MAINLINE DNE, A SINGLE HEADED ARROW (M6-1) SHALL DUBLE HEADED ARROW (M6-4).
STATE OF I		TRAFFIC CONTROL AND PROTECTIO Side Roads, intersections, and di


USER NAME = hassann	DESIGNED L.H.A.	REVISED - A. HOUSEH 10-15-96			TRAFFIC CONTROL AND PROTECTION FOR	F.A.U. RTE	SECTION	COUNTY T	OTAL SHEET
	DRAWN -	REVISED - T. RAMMACHER 01-06-00	STATE OF ILLINOIS		IDE ROADS, INTERSECTIONS, AND DRIVEWAYS	3562	(430V-X)N	соок	99 84
PLOT SCALE = 100.0000 / in.	CHECKED -	REVISED - A. SCHUETZE 07-01-13	DEPARTMENT OF TRANSPORTATION	3	IDE NOADS, INTERSECTIONS, AND DRIVEWATS		TC-10	CONTRACT N	NO. 60X71
PLOT DATE = 3/23/2020	DATE - 06-89	REVISED A SCHUETZE 09-15-16		SCALE: NONE	SHEET 1 OF 1 SHEETS STA. TO STA.		ILLINOIS FED. A	ID PROJECT	

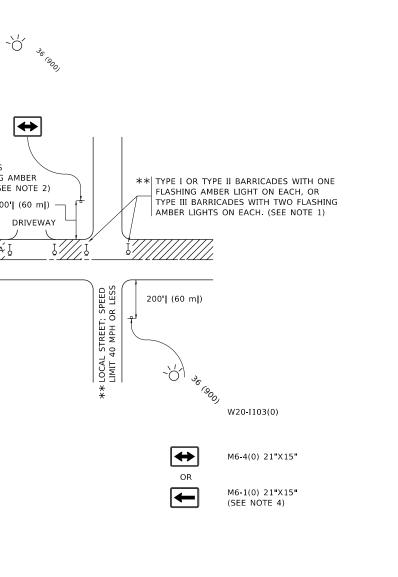


5. WHEN WORK IS BEING PERFORMED ON A SIDE ROAD OR DRIVEWAY, FOLLOW THE APPLICABLE STANDARD(S). THE DIRECTIONAL ARROW (M6-1 OR M6-4) SHALL BE COVERED OR REMOVED WHEN NO LONGER CONSISTENT WITH THE TRAFFIC CONTROL SET-UP.

- 6. ADVANCE WARNING SIGNS ARE TO BE OMITTED ON DRIVEWAYS UNLESS OTHERWISE SPECIFIED IN THE PLANS OR BY THE ENGINEER.
- 7. THE TRAFFIC CONTROL AND PROTECTION FOR SIDE ROADS, INTERSECTIONS, AND DRIVEWAYS SHALL BE INCLUDED IN THE COST OF SPECIFIED TRAFFIC CONTROL STANDARDS OR ITEMS.

### All dimensions are in inches (millimeters) unless otherwise shown.

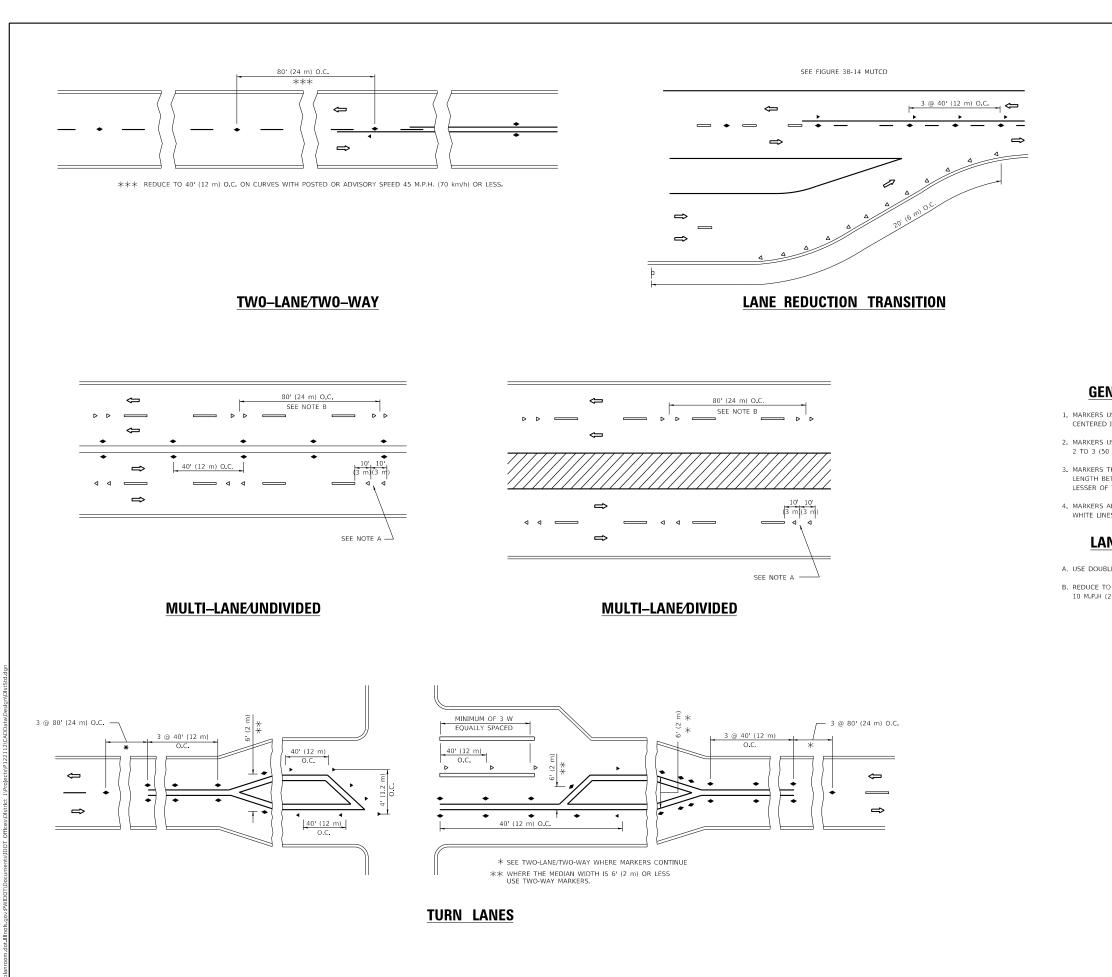

wd :	USER NAME = hassann	DESIGNED -	REVISED - T. RAMMACHER 03-12-99		TYPICAL APPLICATIONS	F.A.U. RTE	SECTION	COUNTY	TOTAL SI	JO.
AME		DRAWN -	REVISED -T. RAMMACHER 01-06-00	STATE OF ILLINOIS		3562	(430V-X)N	соок	99	85
Z H	PLOT SCALE = 100.0000 / in.	CHECKED -	REVISED - C. JUCIUS 09-09-09	DEPARTMENT OF TRANSPORTATION	RAISED REFLECTIVE PAVEMENT MARKERS (SNOW-PLOW RESISTANT)		TC-11	CONTRACT	NO. 60	(71
Ē	PLOT DATE = 3/23/2020	DATE -	REVISED - C. JUCIUS 07-01-13		SCALE: NONE SHEET 1 OF 1 SHEETS STA. TO STA.		ILLINOIS FED. A	ID PROJECT		

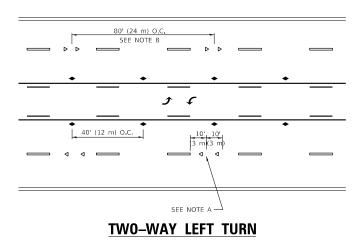

## **GENERAL NOTES**

- 1. MARKERS USED WITH DASHED LINES SHALL BE CENTERED IN THE GAP BETWEEN SEGMENTS.
- 2. MARKERS USED ADJACENT TO SOLID LINES SHALL BE OFFSET 2 TO 3 (50 TO 75) TOWARD TRAFFIC AS SHOWN.
- MARKERS THROUGH TANGENTS LESS THAN 500' (150 m) IN LENGTH BETWEEN CURVES SHALL BE INSTALLED AT THE LESSER OF THE TWO CURVE SPACINGS.
- 4. MARKERS ARE TO BE USED ADJACENT TO BOTH SOLID WHITE LINES IN DUAL LEFT TURN LANES

### LANE MARKER NOTES

- A. USE DOUBLE LANE LINE MARKERS SPACED AS SHOWN.
- B. REDUCE TO 40' (12 m) O.C. ON CURVES WHERE ADVISORY SPEEDS ARE 10 M.P.H (20 km/h) LOWER THAN POSTED SPEEDS.


### **SYMBOLS**


- ----- YELLOW STRIPE
- WHITE STRIPE
- ONE-WAY AMBER MARKER
- ONE-WAY CRYSTAL MARKER (W/O)
- TWO-WAY AMBER MARKER

### **DESIGN NOTES**


- 1. DOUBLE LANE LINE MARKERS SHALL BE USED UNLESS SPECIFIED OTHERWISE.
- EXCEPT AS SHOWN ON THE LANE REDUCTION TRANSITION AND FREEWAY EXIT RAMP DETAIL, MARKERS ARE NOT TO BE SPECIFIED ON RIGHT EDGE LINES.
- 3. THE EXACT MARKER LIMITS, SPACING, AND COLOR SHALL BE INCLUDED IN THE PLANS WHEN STANDARD SPECIFICATIONS ARE NOT BEING USED.
- MARKERS SHOULD NOT BE USED ALONGSIDE CURBS EXCEPT FOR EXTREMELY SHORT SECTIONS OF CURBS WHERE NOT MORE THAN TWO MARKERS WOULD BE INVOLVED.

# All dimensions are in inches (millimeters) unless otherwise shown.

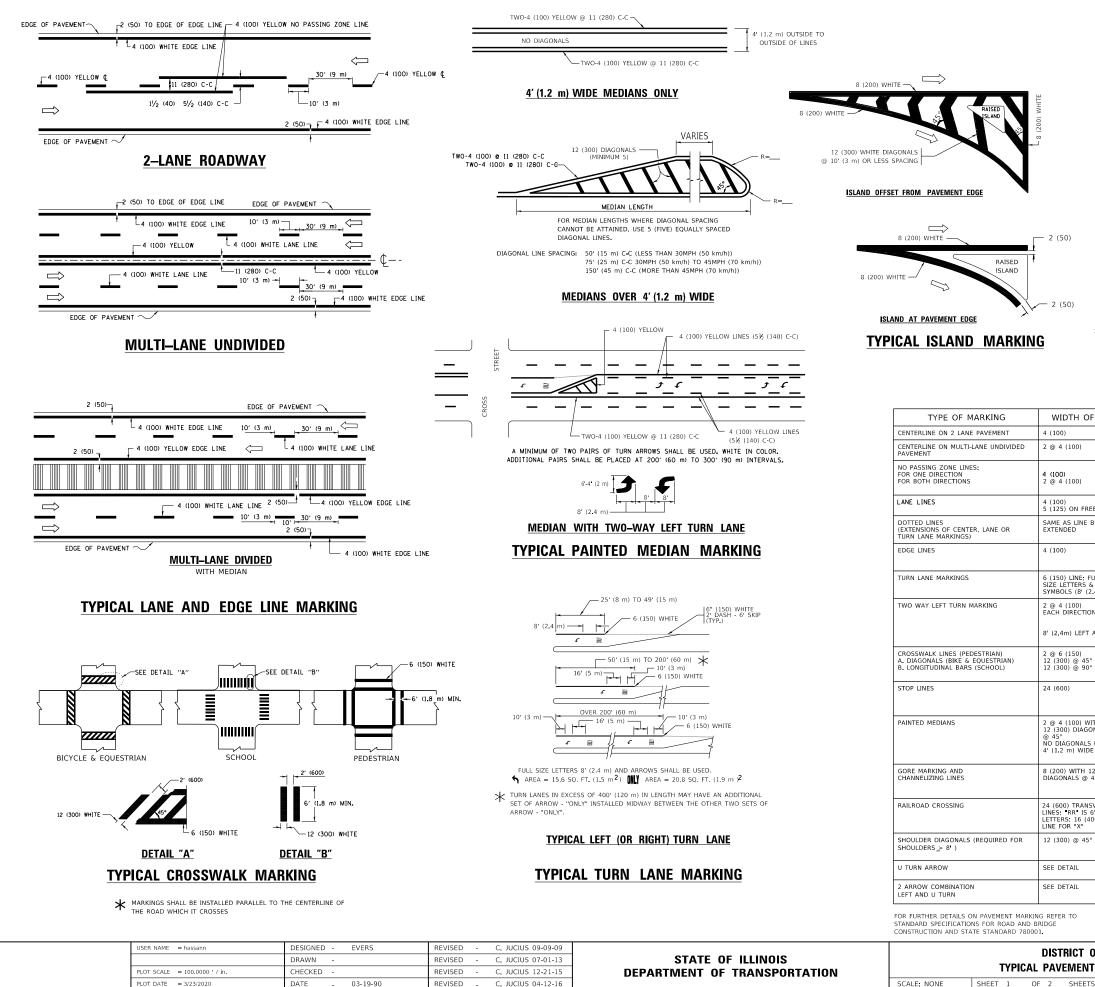

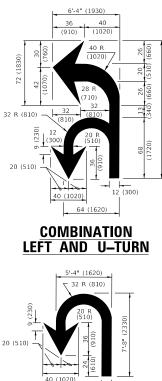

**U\_TURN** 

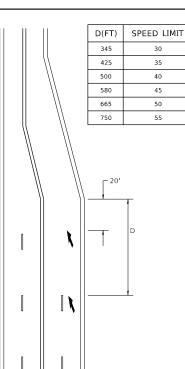


### LANE REDUCTION TRANSITION


★ LANE REDUCTION ARROWS REQUIRED AT SPEEDS OF 45 MPH OR GREATER OR WHEN SPECIFIED IN PLANS.

F LINE	PATTERN	COLOR	SPACING / REMARKS
	SKIP-DASH	YELLOW	10' (3 m) LINE WITH 30' (9 m) SPACE
	SOLID	YELLOW	11 (280) C-C
	SOLID SOLID	YELLOW YELLOW	5½ (140) C-C FROM SKIP-DASH CENTERLINE 11 (280) C-C OMIT SKIP-DASH CENTERLINE BETWEEN
EEWAYS	SKIP-DASH SKIP-DASH	WHITE WHITE	10' (3 m) LINE WITH 30' (9 m) SPACE
BEING	SKIP-DASH	SAME AS LINE BEING EXTENDED	2' (600) LINE WITH 6' (1.8 m) SPACE
	SOLID	YELLOW-LEFT WHITE-RIGHT	OUTLINE MEDIANS IN YELLOW
=ULL & 2.4m))	SOLID	WHITE	SEE TYPICAL TURN LANE MARKING DETAIL
ON ARROW	SKIP-DASH AND SOLID IN PAIRS	YELLOW	10° (3 m) LINE WITH 30° (9 m) SPACE FOR SKIP-DASH: 5½ (140) C-C BETWEEN SOLID LINE AND SKIP-DASH LINE SEE TYPICAL TWO-WAY LEFT TURN MARKING DETAIL
0	SOLID SOLID SOLID	WHITE WHITE WHITE	NOT LESS THAN 6' (1.8 m) APART 2' (500) APART 2' (600) APART SEE TYPICAL CROSSWALK MARKING DETAILS.
	SOLID	WHITE	PLACE 4' (1.2 m) IN ADVANCE OF AND PARALLEL TO CROSSWALK, IF PRESENT, OTHERWISE, PLACE AT DESIRED STOPPING POINT. PARALLEL TO CROSSROAD CENTERLINE, WHERE POSSIBLE
VITH ONALS 5 USED FOR 16 MEDIANS	SOLID	YELLOW: TWO WAY TRAFFIC WHITE: ONE WAY TRAFFIC	11 (280) C-C FOR THE DOUBLE LINE SEE TYPICAL PAINTED MEDIAN MARKING.
12 (300) 45°	SOLID	WHITE	DIAGONALS: 15' (4.5 m) C-C (LESS THAN 30MPH (50 km/h)) 20' (6 m) C-C 30MPH (50 km/h) TO 45MPH (70 km/h)) 30' (9 m) C-C (OVER 45MPH (70 km/h))
SVERSE 6' (1.8 m) 100)	SOLID	WHITE	SEE STATE STANDARD 780001 AREA OF: "R"=3.6 SQ. FT. (0.33 m ÅEACH "X"=54.0 SQ. FT. (5.0 m Å
0	SOLID	WHITE - RIGHT YELLOW - LEFT	50' (15 m) C-C (LESS THAN 30MPH (50 km/h)) 75' (25 m) C-C (30 MPH (50 km/h) TO 45MPH (70 km/h)) 150' (45 m) C-C (OVER 45MPH (70 km/h))
	SOLID	WHITE	16.3 SF
	SOLID	WHITE	30.4 SF
	I		I

All dimensions are in inches (millimeters) unless otherwise shown.


ONE			F.A.U. RTE	SECTION			COUNTY TOTAL SHEETS		SHEET NO.
IT_MARKINGS		3562 (430V-X)N				СООК	99	86	
			TC-13			CONTRACT	NO.	50X71	
TS	STA.	TO STA.	ILLINOIS FED. AID PROJECT						

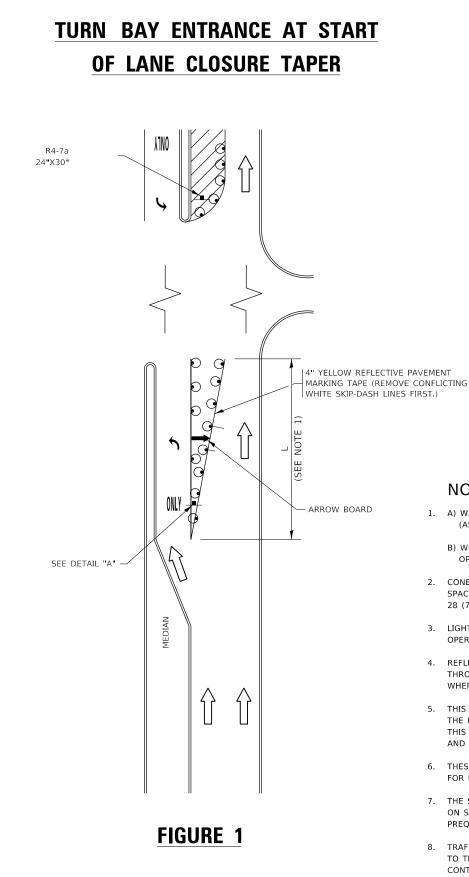

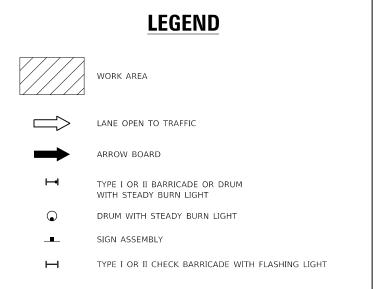


### NOTES:

- 1. A) WHEN "L" IS ≤ THE STORAGE LENGTH OF THE TURN LANE (AS SHOWN IN FIG. 1), USE FIGURE 1.
  - B) WHEN "L" IS > THE STORAGE LENGTH OF THE TURN LANE OR THE TURN LANE IS WITHIN THE LANE CLOSURE, USE FIGURE 2.
- 2. CONES MAY BE SUBSTITUTED FOR BARRICADES OR DRUMS AT HALF THE SPACING DURING DAY OPERATIONS. CONES SHALL BE A MINIMUM OF 28 (710) IN HEIGHT.
- 3. LIGHTS WILL NOT BE REQUIRED ON BARRICADES OR DRUMS FOR DAY OPERATIONS. ALL LIGHTS SHALL BE MONODIRECTIONAL.
- 4. REFLECTIVE TEMPORARY PAVEMENT MARKINGS SHALL BE PLACED THROUGHOUT THE BARRICADED AREAS OF EACH TURN BAY AS SHOWN WHERE THE CLOSURE TIME IS GREATER THAN FOURTEEN (14) DAYS.
- 5. THIS APPLICATION ALSO APPLIES WHEN WORK IS BEING PERFORMED IN THE RIGHT LANE(S) AND THE RIGHT TURN BAY IS TO REMAIN OPEN. UNDER THIS CONDITION, "RIGHT TURN LANE" R3-1100R 24 x 24 (600 x 600) AND M6-2R 21 x 15 (530 x 380) SHALL BE USED.
- 6. THESE CONTROLS SHALL SUPPLEMENT MAINLINE TRAFFIC CONTROL FOR LANE CLOSURES.
- 7. THE SIGNS SHALL BE MOUNTED ABOVE THE BARRICADES/DRUMS ON SEPARATE SIGN SUPPORTS THAT MEET NCHRP 350 OR MASH PREOUIREMENTS.
- 8. TRAFFIC CONTROL AND PROTECTION AT TURN BAYS (TO REMAIN OPEN TO TRAFFIC) SHALL BE INCLUDED IN THE COST OF SPECIFIED TRAFFIC CONTROL STANDARDS OR ITEMS.

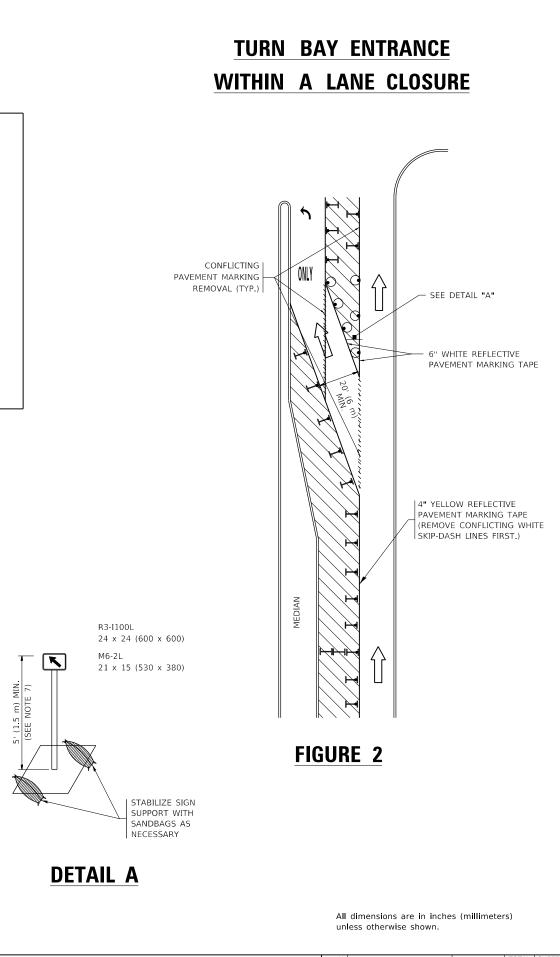


USER NAME = hassann	DESIGNED T. RAMMACHER 09-08-94 REVISED R. BORO 09-14-09	STATE OF ILLINOIS	TRAFFIC CONTROL AND PROTECTION AT TURN BAYS	F.A.U. RTE	SECTION	COUNTY TOTAL SHEET SHEETS NO.
	DRAWN - A. HOUSEH 11-07-95 REVISED - A. SCHUETZE 07-01-13		(TO REMAIN OPEN TO TRAFFIC)	3562	(430V-X)N	СООК 99 87
PLOT SCALE = 100.0000 / in.	CHECKED - A. HOUSEH 10-12-96 REVISED - A. SCHUETZE 09-15-16	DEPARTMENT OF TRANSPORTATION			TC-14	CONTRACT NO. 60X71
PLOT DATE = 3/23/2020	DATE -T. RAMMACHER 01-06-00 REVISED -		SCALE: NONE SHEET 1 OF 1 SHEETS STA. TO STA.	ILLINOIS		D. AID PROJECT

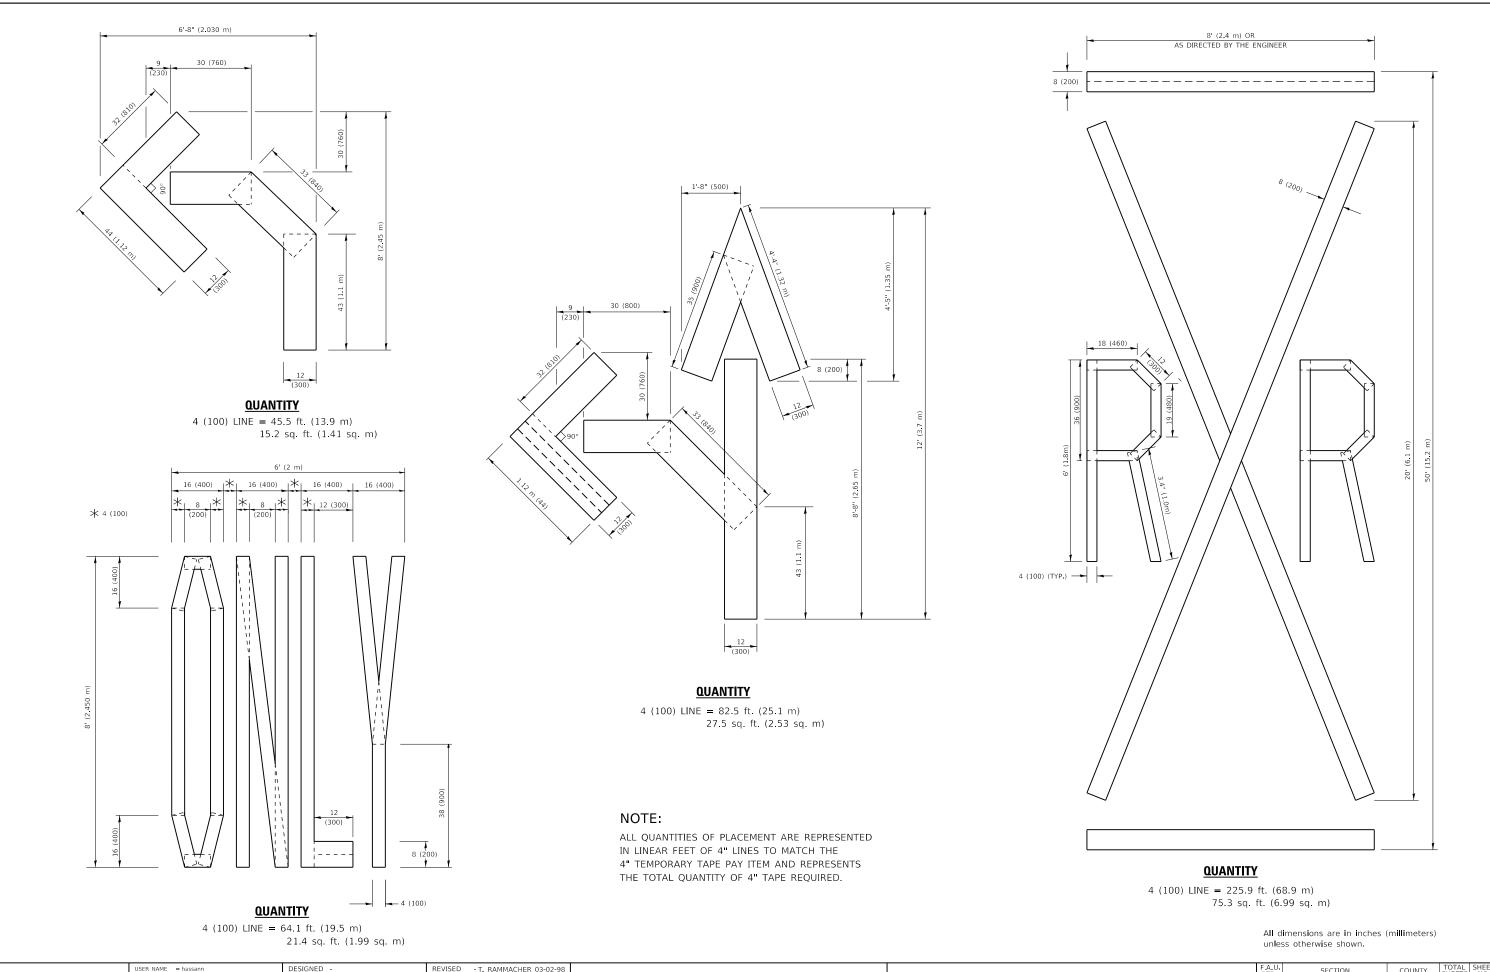

USER NAME = hassann	DESIGNED -	REVISED - T. RAMMACHER 03-02-98		í -	
	DRAWN -	REVISED - E. GOMEZ 08-28-00	STATE OF ILLINOIS	SHORT TE	RM PAVEMENT MARKING
PLOT SCALE = 100.0000 ' / in.	CHECKED -	REVISED - E. GOMEZ 08-28-00	DEPARTMENT OF TRANSPORTATION	1	
PLOT DATE = 3/23/2020	DATE - 09-18-94	REVISED - A. SCHUETZE 09-15-16		SCALE: NONE	SHEET 1 OF 1 SHEETS

NG			F.A. U. SECTION COU		COUNTY	TOTAL SHEETS	SHEET NO.		
	LETTERS AND	SYMBOLS	3562	(430V-X)N	СООК	COOK 99 88	88		
				TC16	CONTRACT NO. 60X7				
ГS	STA.	TO STA.	ILLINOIS FED. AID PROJECT						

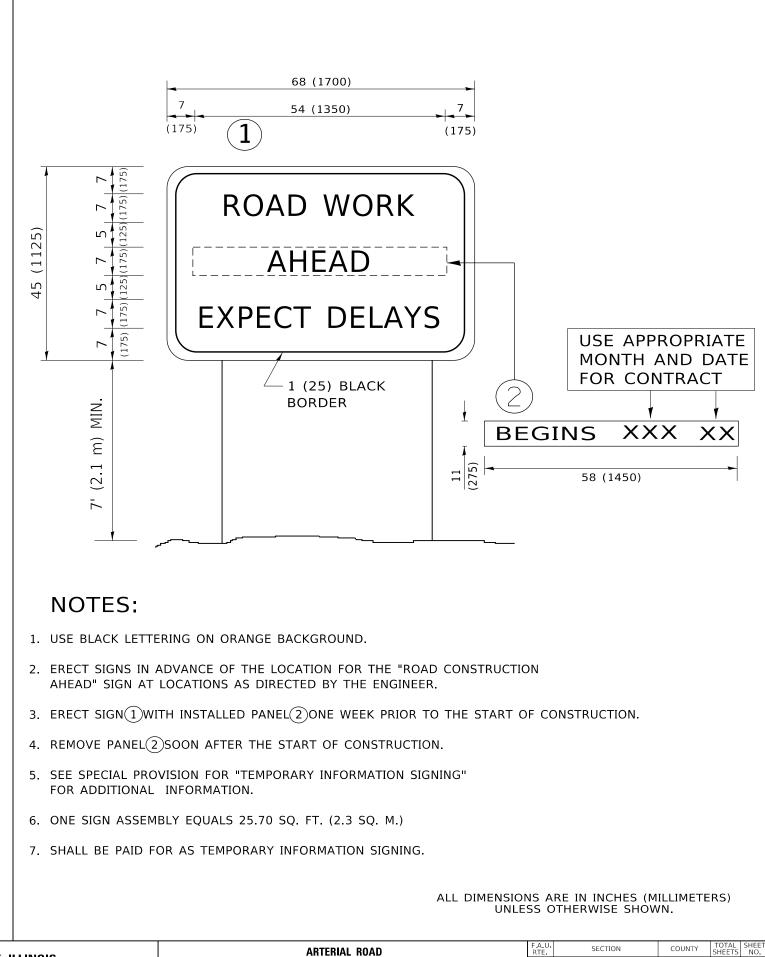

USER NAME = hassann	DESIGNED -	REVISED	- R. MIRS 09-15-97				ARTE	RIAL RO
	DRAWN -	REVISED	- R. MIRS 12-11-97	STATE OF ILLINOIS				
PLOT SCALE = 100.0000 / in.	CHECKED -	REVISED	-T. RAMMACHER 02-02-99	DEPARTMENT OF TRANSPORTATION			INFORM	IATION
PLOT DATE = 3/23/2020	DATE -	REVISED	C. JUCIUS 01-31-07		SCALE: NONE	SHEET 1	OF 1	SHEETS

ROAD			F.A.U. SECTION		COUNTY	TOTAL SHEETS	SHEET NO.			
NSIGN		3562 (430)					СООК 99 89			
			TC-22			CONTRACT	NO.	60X71		
TS STA	TO STA.			ILLINOIS	FED. AI	D PROJECT				



3.0" RADIUS, 0.5" BORDER, WHITE ON GREEN; REFLECTORIZED "DRIVEWAY" D; "ENTRANCE" D; STANDARD ARROW CUSTOM 12.0" x 5.0"

### NOTES:

- 1. HALF OF THE SIGNS WILL REQUIRE A LEFT HAND FACING ARROW.
- 2. TWO SIGNS SHALL BE USED AT EACH COMMERCIAL ENTRANCE PLACED BACK-TO-BACK: ONE WITH A RIGHT HAND ARROW (SHOWN) SHALL BE PLACED ON THE NEAR RIGHT SIDE THE DRIVEWAY AND ONE WITH A LEFT HAND ARROW SHALL BE PLACED ON THE FAR LEFT SIDE OF THE DRIVEWAY.
- 3. SIGNS TO BE PAID FOR AS ITEM "TEMPORARY INFORMATION SIGNING".

USER NAME = hassann	DESIGNED -	REVISED - C. JUCIUS 02-15-07	I			F.A.U. RTE	SECTION	COUNTY	TOTAL SHEET SHEETS NO.	
	DRAWN -	REVISED -	STATE OF ILLINOIS		DRIVEWAY ENTRANCE SIGNING			(430V-X)N	СООК	99 90
PLOT SCALE = 100.0000 ' / in.	CHECKED -	REVISED -	DEPARTMENT OF TRANSPORTATION					TC-26	CONTRACT	T NO. 60X71
PLOT DATE = 3/23/2020	DATE -	REVISED -		SCALE: NONE	SHEET 1 OF 2 SHEETS STA.	TO STA.		ILLINOIS FED. AID PROJECT		

