FOR INDEX OF SHEETS, SEE SHEET NO. 2

PROJECT LOCATED IN: VILLAGE OF DOLTON

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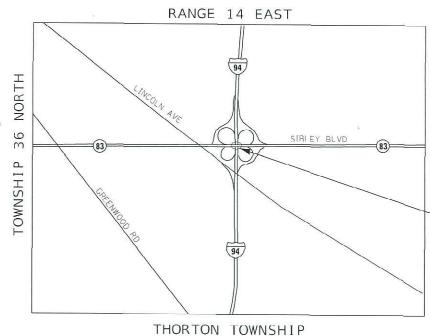
I-94 BISHOP FORD TRAFFIC DATA 2018 ADT = 135,500 POSTED SPEED = 55 MPH

ILL. 83 (SIBLEY BLVD.) TRAFFIC DATA 2018 ADT = 27,000 POSTED SPEED = 35 MPH

STATE OF ILLINOIS DEPARTMENT OF TRANSPORTATION

PROPOSED HIGHWAY PLANS

ROUTE: I-94 BISHOP FORD EXPWY
AT ILL. 83 (SIBLEY BLVD.)
SECTION: 2019-178-BR
BRIDGE BEAM REPLACEMENT, BRIDGE DECK REPAIRS,
BRIDGE JOINT REPAIR
COOK COUNTY
C-91-142-20



I-94 AT IL RTE 83 (SIBLEY BLVD.) STRUCTURE NO: 016-0956

PROJECT LOCATION

FULL SIZE PLANS HAVE BEEN PREPARED USING STANDARD ENGINEERING SCALES. REDUCED SIZED PLANS WILL NOT CONFORM TO STANDARD SCALES. IN MAKING MEASUREMENTS ON REDUCED PLANS, THE ABOVE SCALES MAY BE USED.

J.U.L.I.E.

J.U.L.I.E. JOINT UTILITY LOCATION INFORMATION FOR EXCAVATION 1-800-892-0123 OR 811

PROJECT ENGINEER: PRAVEEN KAINI, P.E. (847) 705–4237
PROJECT MANAGER: FAWAD F. AQUEEL, P.E., PTOE (847) 705–4247

GROSS LENGTH OF PROJECT = 2230 FT. = 0.42 MILES

NET LENGTH OF PROJECT = 1681 FT. = 0.32 MILES

LOCATION MAP

NOT TO SCALE

MILLENNIA PROFESSIONAL SERVICES
MATTHEW D. KOEHLER, P.E.

= 062-067917

Services

Services

AC 062-0679

Services


Services

DATE: 03/11/2020 SIGNATUPE AND SEAL APPLIES TO DRAWINGS: 1-15



D-91-342-20



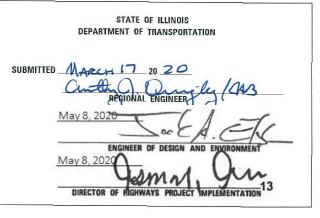



PRINTED BY THE AUTHORITY OF THE STATE OF ILLINOIS

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- 39 TC-21 DETOUR SIGNING FOR CLOSING STATE HIGHWAYS
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LIST OF HIGHWAY STANDARDS

000001-07	STANDARD	SYMBOLS.	ABBREVIATIONS.	AND PATTERNS	

280001-07 TEMPORARY EROSION CONTROL SYSTEMS

631033-08 TRAFFIC BARRIER TERMINAL, TYPE 6B

635001-02 DELINEATORS

701106-02 OFF-RD OPERATIONS, MULTILANE, MORE THAN 15' (4.5 m) AWAY

701400-09 APPROACH TO LANE CLOSURE, FREEWAY / EXPRESSWAY

701401-12 LANE CLOSURE, FREEWAY / EXPRESSWAY

701411-09 LANE CLOSURE, MULTILANE AT ENTRANCE OR EXIT RAMP, FOR SPEEDS GREATER/EQUAL TO 45 MPH

701427-05 LANE CLOSURE, MULTILANE, INTERMITTENT OR MOVING OPER., FOR SPEEDS LESS/EQUAL TO 40 MPH

701428-01 TRAFFIC CONTROL SETUP AND REMOVAL FREEWAY / EXPRESSWAY

701446-10 TWO LANE CLOSURE, FREEWAY / EXPRESSWAY

701606-10 URBAN SINGLE LANE CLOSURE, MULTILANE, 2W WITH MOUNTABLE MEDIAN

701801-06 SIDEWALK, CORNER, OR CROSSWALK CLOSURE

701901-08 TRAFFIC CONTROL DEVICES

704001-08 TEMPORARY CONCRETE BARRIER

782006-01 GUARDRAIL AND BARRIER WALL REFLECTOR MOUNTING DETAILS

COMMITMENTS

NO COMMITMENTS FOR THIS PROJECT

MILLENNIA PROFESSIONAL SERVICES www.millennia.pro

USER NAME = mkochler	DESIGNED - MDK	REVISED -
	DRAWN - MDK	REVISED -
PLOT SCALE = 2.0000 ' / in.	CHECKED - JP	REVISED -
PLOT DATE = 4/8/2020	DATE - 04/08/2020	REVISED -

STATE OF ILLINOIS DEPARTMENT OF TRANSPORTATION

SIBLEY	BOULEVARD AT I-	94 (BISHOP FORD	EXPRESSWAY)
INDEX OF	SHEETS, HIGHWAY	STANDARDS, AND	GENERAL NOTES
SCALE: N/A	SHEET NO. 1 OF 1	SHEETS STA. N/A	TO STA. N/A

- 1. BEFORE STARTING ANY EXCAVATION, THE CONTRACTOR SHALL CALL "J.U.L.I.E." AT (800) 892-0123 OR 811 OR DIGGER AT 312-744-700 FOR FIELD LOCATIONS OF BURIED ELECTRIC, TELEPHONE AND GAS UTILITIES. 48 HOUR NOTIFICATION IS REQUIRED.
- 2. THE CONTRACTOR SHALL TAKE CARE IN REMOVING OR EXCAVATING NEAR ALL EXISTING ITEMS WHICH WILL REMAIN. ANY DAMAGE DONE TO EXISTING ITEMS, BY THE CONTRACTOR, SHALL BE REPAIRED AT THE CONTRACTORS EXPENSE.
- 4. THE RESIDENT ENGINEER SHALL CONTACT THE DEPARTMENT'S ELECTRICAL MAINTENANCE CONTRACTOR, MEADE ELECTRIC COMPANY, AT (773) 287-7672 PRIOR TO THE START OF CONSTRUCTION TO LOCATE ALL IDOT ELECTRICAL EQUIPMENT AND UNDERGROUND CABLES.

THE CONTRACTOR SHALL COORDINATE CONSTRUCTION ACTIVITIES WITH UTILITY COMPANIES, AND THE MUNICIPALITIES LISTED

- 5. THE CONTRACTOR SHALL CONTACT THE DISTRICT ONE TRAFFIC CONTROL SUPERVISOR AT KALPANA, KANNAN-HOSADURGA@ILLINOIS.GOV AND THE EXPRESSWAY TRAFFIC CONTROL SUPERVISOR CLOSURES ON THE EXPRESSWAYS AT (847) 705-4155 A MINIMUM OF 72 HOURS IN ADVANCE OF BEGINNING WORK, THE CONTRACTOR SHALL REGISTER ACCOUNT AT WWW.IDOTLCS.COM TO REQUEST.
- 6. THE CONTRACTOR WILL NOT BE ALLOWED TO SET UP A YARD OR FIELD OFFICE ON STATE PROPERTY WITHOUT WRITTEN PERMISSION FROM THE DEPARTMENT.
- '. THE CONTRACTOR SHALL BE REQUIRED TO PROVIDE ACCESS TO ABUTTING PROPERTY AT ALL TIMES DURING THE CONSTRUCTION OF THIS PROJECT.
- 8. IN ADDITION TO FIELD AND AERIAL SURVEYS, PLAN DIMENSIONS AND DETAILS RELATIVE TO THE EXISTING FACILITIES HAVE BEEN TAKEN FROM EXISTING PLANS AND ARE SUBJECT TO CONSTRUCTION VARIATIONS. IT SHALL BE THE CONTRACTOR'S RESPONSIBILITY TO VERIFY SUCH DIMENSIONS AND EXISTING CONDITIONS IN THE FIELD PRIOR TO CONSTRUCTION AND ORDERING MATERIALS. SUCH VARIATIONS SHALL NOT BE A CAUSE FOR ADDITIONAL COMPENSATION DUE TO A CHANGE IN THE SCOPE OF WORK. HOWEVER, THE CONTRACTOR WILL BE PAID FOR THE QUANTITY ACTUALLY FURNISHED AT THE UNIT PRICE BID FOR THE WORK.
- THE LOCATIONS OF THOSE BURIED AND ABOVE GROUND UTILITIES SHOWN ARE APPROXIMATE, ARE SHOWN FOR CONTRACTOR INFORMATIONAL USE ONLY, AND ARE NOT TO BE REFERENCED FOR CONSTRUCTION PURPOSES. THE IMPLIED PRESENCE OR ABSENCE OF UTILITIES IS NOT TO BE CONSTRUED BY THE OWNER, ENGINEER, CONTRACTOR, OR SUBCONTRACTOR TO BE AN ACCURATE AND COMPLETE REPRESENTATION OF UTILITIES THAT MAY OR MAY NOT EXIST ON THE CONSTRUCTION SITE. BURIED AND ABOVE GROUND UTILITY LOCATIONS, IDENTIFICATION, AND MARKING ARE THE SOLE RESPONSIBILITY OF THE CONTRACTOR, REROUTING, DISCONNECTION, PROTECTION, ETC. OF ANY UTILITIES MUST BE COORDINATED BETWEEN CONTRACTOR, UTILITY COMPANY, AND OWNER. SITE SAFETY, INCLUDING THE AVOIDANCE OF HAZARDS ASSOCIATED WITH BURIED AND ABOVE GROUND UTILITES REMAIN THE SOLE RESPONSIBILITY OF THE CONTRACTOR.
- 10. DO NOT SCALE PLANS FOR CONSTRUCTION DIMENSIONS.

GENERAL NOTES

ON THE COVER SHEET.

- 11. THE CONTRACTOR SHALL TAKE ALL NECESSARY PRECAUTIONS FOR THE PROTECTION OF EXISTING PLANT MATERIAL FOR WHICH THE CONTRACT DOES NOT PROVIDE REMOVAL. THE PROTECTION OF EXISTING PLANT MATERIAL AND THE REPAIR OR REPLACEMENT OF EXISTING PLANT MATERIAL DAMAGED BY THE CONTRACTOR SHALL BE DONE IN ACCORDANCE WITH THE REQUIREMENTS OF SECTION 201 OF THE STANDARD SPECIFICATIONS.
- 12. WHERE SECTION OR SUB-SECTION MONUMENTS ARE ENCOUNTERED, THE ENGINEER SHALL BE NOTIFIED BEFORE SUCH MONUMENTS ARE REMOVED. THE CONTRACTOR SHALL PROTECT AND CAREFULLY PRESERVE ALL PROPERTY MARKERS AND MONUMENTS UNTIL THE OWNER, AN AUTHORIZED SURVEYOR, OR AGENT HAS WITNESSED THEIR LOCATION.
- 13. FRAMES AND GRATES ADJUSTMENT OF PRIVATE UTILITIES WITHIN THE LIMITS OF THE IMPROVEMENTS SHALL BE DONE BY THEIR RESPECTIVE OWNERS AND ARE NOT PART OF THIS CONTRACT.
- 14. ALL DAMAGE TO EXISTING PAVEMENT MARKINGS OR RAISED REFLECTIVE PAVEMENT MARKERS, OUTISDE THE REMOVAL LINE SHOWN ON THE PLANS, SHALL BE REPLACED AT NO ADDITIONAL COST TO THE DEPARTMENT.
- 15. THE "ARTERIAL ROAD INFORMATION" SIGN (TC-22) IS APPLICABLE ONLY TO ARTERIAL ROADS AND SHALL NOT BE APPLIED TO EXPRESSWAYS.
- 16. THE CONTRACTOR SHALL PROVIDE ADEQUATE DRAINAGE AND EROSION CONTROL PROTECTION DURING ALL STAGES OF CONSTRUCTION.
- 17. THE ENGINEER SHALL CONTACT PATRICE HARRIS, AREA TRAFFIC FIELD TECHNICIAN, AT PATRICE.HARRIS@ILLINOIS.GOV A MINIMUM OF TWO (2) WEEKS PRIOR TO THE PLACEMENT OF PERMANENT PAVEMENT MARKINGS.
- 18. THE CONTRACTOR SHALL PLACE ONE (1) CHANGEABLE MESSAGE SIGN AT EACH END OF THE PROJECT AND/OR AS DIRECTED BY THE ENGINEER, TO INFORM MOTORISTS OF UPCOMING CONSTRUCTION ACTIVITIES. THE MESSAGE SIGNS WITH APPROPRIATE INFORMATION SHALL BE PLACED SEVEN (7) DAYS BEFORE THE START OF CONSTRUCTION ACTIVITY. THIS WORK IS TO BE PAID FOR AT THE CONTRACT UNIT PRICE PER CALENDAR DAY "CHANGEABLE MESSAGE SIGN". TWO (2) CHANGEABLE MESSAGE SIGNS WILL BE PLACED AT LOCATIONS WITH CLOSURES ON THE MAINLINE EXPRESSWAY AND ANY IMPACTED RAMPS.
- 20. POLLUTION CONTROL: THE CONTRACTOR SHALL BE REQUIRED TO COMPLY WITH THE STATE REGULATIONS REGARDING AIR, WATER, AND NOISE POLLUTION. THIS WORK IS NOT TO BE PAID SEPARATELY AND SHALL BE INCLUDED IN THE COST OF THE CONTRACT.
- 21. ANY SECTION OF THE GUARDRAIL TERMINAL TYPE, 6B THAT IS DAMAGED DURING THE REMOVAL OPERATION IS TO BE REPLACED BY THE CONTRACTOR AT NO ADDITIONAL EXPENSE TO THE DEPARTMENT.
- 22. THE COST OF SAW CUTTING SHALL BE INCLUDED IN THE UNIT PRICES FOR THE VARIOUS REMOVAL PAY ITEMS.

* DENOTES SPECIALTY ITEM

REV-SEP

COOK 40 3

CONTRACT NO. 62K49

COUNTY



USER NAME = mkoehler	DESIGNED	-	MDK	REVISED	-
	DRAWN	-	MDK	REVISED	-
PLOT SCALE = 2.0000 ' / in.	CHECKED	-	JP	REVISED	-
PLOT DATE = 3/27/2020	DATE	-	3.25.2020	REVISED	-

				TOTAL	CONST. TYPE CODE		
	PAYCODE	ITEM DESCRIPTION	UNIT	URBAN	BRIDGE 100% MCHD 0021 016–0956	BRIDGE 100% STATE 0013 016-0956	
ļ	70600255	IMPACT ATTENUATORS, TEMPORARY (FULLY REDIRECTIVE, NARROW), TEST LEVEL 2	EACH	1	1		
	70600260	IMPACT ATTENUATORS, TEMPORARY (FULLY REDIRECTIVE, NARROW), TEST LEVEL 3	EACH	1	1		
	72000300	SIGN PANEL - TYPE 3	SQ FT	216	216		
	72400330	REMOVE SIGN PANEL - TYPE 3	SQ FT	52	52		
	73304000	OVERHEAD SIGN STRUCTURE - BRIDGE MOUNTED	FOOT	18	18		
*	78000200	THERMOPLASTIC PAVEMENT MARKING - LINE 4"	FOOT	255	255		
*	78008210	POLYUREA PAVEMENT MARKING TYPE I - LINE 4"	FOOT	1,804	1,804		
*	78008240	POLYUREA PAVEMENT MARKING TYPE I - LINE 8"	FOOT	635	635		
*	78008250	POLYUREA PAVEMENT MARKING TYPE I - LINE 12"	FOOT	63	63		
*	78100300	REPLACEMENT REFLECTOR	EACH	24	24		
*	78200005	GUARDRAIL REFLECTORS, TYPE A	EACH	4	4		
*	78200011	BARRIER WALL REFLECTORS, TYPE C	EACH	44	44		
	X0327577	PROTECT AND MAINTAIN EXISTING UNDERPASS LUMINAIRE	L SUM	1	1	_	
	X0327980	PAVEMENT MARKING REMOVAL - WATER BLASTING	SQ FT	1, 138	1,138		
	X7010216	TRAFFIC CONTROL AND PROTECTION, (SPECIAL)	L SUM	1	1	_	
	X7011015	TRAFFIC CONTROL AND PROTECTION (EXPRESSWAYS)	L SUM	1	1		
	X7013820	TRAFFIC CONTROL SURVEILLANCE, EXPRESSWAYS	CAL DA	17	17		
	X7030005	TEMPORARY PAVEMENT MARKING REMOVAL	SQ FT	1,297	1,297		
	X7040125	PINNING TEMPORARY CONCRETE BARRIER	EACH	12	12		
	X7830050	RAISED REFLECTIVE PAVEMENT MARKER, REFLECTOR REMOVAL	EACH	24	24		
	Z0001899	JACK AND REMOVE EXISTING BEARINGS	EACH	2	2		
	Z0001903	STRUCTURAL STEEL REMOVAL	POUND	15,500	15, 160	340	
	Z0012754	STRUCTURAL REPAIR OF CONCRETE (DEPTH EQUAL TO OR LESS THAN 5 INCHES)	SQ FT L SUM	126	126 1		
	Z0013798 Z0018010	DRAINAGE SCUPPERS, DS-33	EACH	1	1		
	Z0030850	TEMPORARY INFORMATION SIGNING	SQ FT	85. 7	85.7		
	Z0050100	REMOVE AND RE-ERECT EXISTING HANDRAIL	FOOT	82	82		
*	Z0073510	TEMPORARY TRAFFIC SIGNAL TIMING	EACH	1	1		
*	Z0073300	TEMPORARY SHORING AND CRIBBING	L SUM	1 500	1	_	
Ø	Z0076604	TRAINEES - TRAINING PROGRAM GRADUATE	HOUR	500	500	_	

* DENOTES SPECIALTY ITEM

Ø 0042



USER NAME = mkoehler	DESIGNED - MDK	REVISED -
	DRAWN - MDK	REVISED -
PLOT SCALE = 2.0000 ' / in.	CHECKED - JP	REVISED -
PLOT DATE = 3/27/2020	DATE - 3.25.2020	REVISED -

MAINTENANCE OF TRAFFIC GENERAL NOTES

- 1. THE TRAFFIC CONTROL DEPICTED IN THE PLANS ARE THE MINIMUM REQUIREMENT. ADDITIONAL TRAFFIC CONTROL DEVICES, AS SPECIFIED IN THE HIGHWAY AND DISTRICT STANDARDS, AS SHOWN IN THE INDEX OF SHEETS, AND SPECIAL PROVISIONS SHALL BE PLACED BY THE CONTRACTOR TO THE SATISFACTION OF THE ENGINEER. ALL TRAFFIC CONTROL DEVICES SHALL BE CONSIDERED INCLUDED IN THE COST OF TRAFFIC CONTROL AND PROTECTION, (EXPRESSWAYS) & TRAFFIC CONTROL AND PROTECTION, (SPECIAL), UNLESS OTHERWISE INDICATED WITHIN THESE GENERAL NOTES, PLANS, OR SPECIAL PROVISIONS.
- 2. TRAFFIC CONDITIONS, ACCIDENTS, AND OTHER UNFORESEEN EMERGENCY CONDITIONS MAY REQUIRE THE ENGINEER TO RESTRICT, MODIFY, OR REMOVE LANE CLOSURES OR CHANNELIZATION SHOWN IN THE PLANS. THE CONTRACTOR SHALL PROMPTLY RESPOND AT THE TIME OF NOTIFICATION BY THE ENGINEER.
- 3. ALL EXISTING SIGNS THAT CONFLICT WITH THE TRAFFIC CONTROL PLAN SHALL BE COVERED OR REMOVED IN ACCORDANCE WITH ARTICLE 107.25 OF THE STANDARD SPECIFICATIONS.
- 4. THE CONTRACTOR SHALL FURNISH, MAINTAIN, AND REMOVE ALL SIGNS AND SIGN SUPPORTS REQUIRED FOR TRAFFIC CONTROL AND PROTECTION.
- 5. THE CONTRACTOR SHALL BE REQUIRED TO MAINTAIN TRAFFIC IN ACCORDANCE WITH THE TRAFFIC CONTROL GENERAL NOTES, PLANS, SPECIAL PROVISIONS, APPLICABLE HIGHWAY & DISTRICT STANDARDS, AND AS DIRECTED BY THE ENGINEER. ANY CHANGES TO THE TRAFFIC CONTROL SHALL BE SUBMITTED TO THE ENGINEER 72 HOURS IN ADVANCE OF ANY PROPOSED CHANGE TO THE SUGGESTED STAGES OF CONSTRUCTION AND TRAFFIC CONTROL PLAN.
- 6. IMMEDIATELY AFTER THE COMPLETION OF CONSTRUCTION, THE CONTRACTOR SHALL RESTORE ALL PERMANENT PAVEMENT MARKINGS, LANDSCAPING, SIGNS, AND OTHER TRAFFIC CONTROL DEVICES THAT WERE COVERED. IF THEY WERE REMOVED, DAMAGED, OR OTHERWISE AFFECTED BY CONSTRUCTION ACTIVITIES, THE COST TO REPAIR ANY DAMAGES WILL BE BORNE BY THE CONTRACTOR AND NOT THE RESPONSIBILITY OF THE DEPARTMENT.
- 7. NO WORK SHALL COMMENCE UNTILL TRAFFIC CONTROL REQUIREMENTS ARE MET.
- REFER TO "KEEPING THE EXPRESSWAY OPEN TO TRAFFIC" SPECIAL PROVISION FOR EXPRESSWAY LANE, RAMP, AND SHOULDER CLOSURE REQUIREMENTS. PLEASE NOTE REQUIREMENTS FOR STAGE CHANGES.
- 9. THE CONTRACTOR SHALL REQUEST AND GAIN APPROVAL FROM THE ILLINOIS DEPARTMENT OF TRANSPORTATION'S EXPRESSWAY TRAFFIC OPERATIONS ENGINEER AT WWW.IDOTLCS.COM TWENTY-FOUR (24) HOURS IN ADVANCE OF ALL DAILY LANE, RAMP, AND SHOULDER CLOSURES AND THREE (3) WEEKS IN ADVANCE OF ALL PERMANENT AND WEEKEND CLOSURES ON ALL FREEWAYS AND/OR EXPRESSWAYS IN DISTRICT 1. THIS ADVANCE NOTIFICATION IS CALCULATED BASED ON WORKWEEK OF MONDAY THROUGH FRIDAY AND SHALL NOT INCLUDE WEEKENDS OR HOLIDAYS.
- THE TIMING OF THE EXISTING TRAFFIC SIGNALS, AT THE INTERSECTION OF SIBLEY BLVD. AND LINCOLN AVE., IS TO BE ADJUSTED FOR THE DURATION OF THE STAGE 2 DETOUR. THIS WORK IS TO BE PAID FOR AS TEMPORARY TRAFFIC SIGNAL TIMING.
- 11. THE CONTRACTOR SHALL PLACE ONE (1) CHANGEABLE MESSAGE ALONG WESTBOUND SIBLEY BLVD., IN ADVANCE OF THE LANE CLOSURE. THE LOCATION OF THE CHANGEBALE MESSAGE SIGN IS TO BE DETERMINED BY THE ENGINEER. THE CHANGEBALE MESSAGE SIGN IS TO REMAIN IN PLACE FOR THE DURATION OF STAGES 1 THRU 3. THIS WORK IS TO BE PAID FOR AT THE CONTRACT UNIT PRICE PER CALENDAR DAY "CHANGEABLE MESSAGE SIGN".

SUGGESTED SEQUENCE OF CONSTRUCTION

STAGE 1

- 1. USING HIGHWAY STANDARDS DURING ALLOWABLE NIGHTTIME CLOSURE HOURS, INSTALL PROTECTIVE SHIELD AS SHOWN ON THE STRUCTURAL PLANS.
- 2. INSTALL TRAFFIC CONTROL DEVICES, WORK ZONE PAVEMENT MARKINGS, AND SIGNAGE ALONG WESTBOUND SIBLEY BOULEVARD ACCORDING TO THE STAGE 1 MAINTENACE OF TRAFFIC PLAN SHEETS.
- 3. USING HIGHWAY STANDARDS DURING ALLOWABLE NIGHTTIME CLOSURE HOURS, REMOVE NORTH PARAPET FENCE, PARAPET, SIDEWALK, AND BRIDGE DECK AS SHOWN ON THE STRUCTURAL PLANS.

STAGE 2

- 1. CLOSE RAMP FROM WESTBOUND SIBLEY BLVD. TO EASTBOUND I-94 ACCORDING THE PROPOSED DETOUR PLAN.
- INSTALL TRAFFIC CONTROL DEVICES AND SIGNAGE AND CLOSE LANES ON EASTBOUND I-94 ACCORDING TO THE STAGE 2 MAINTENANCE OF TRAFFIC PLAN SHEETS.
- 3. INSTALL TEMPORARY SHORING AS SHOWN IN THE STRUCTURAL PLANS.
- REMOVE DIAPHRAGMS BETWEEN BEAMS 1 & 2 ON SPAN #1.
- REMOVE BEAMS 1 & 2 FROM THE WEST ABUTMENT TO THE EXISTING SPLICE AT 11'-6" EAST OF PIER #1.
- REMOVE AND REPLACE BEARINGS AS SHOWN IN THE STRUCTURAL PLANS.
- 7. ERECT NEW BEAMS 1 & 2 FROM THE WEST ABUTMENT TO THE EXISTING SPLICE AT 11'-6" EAST OF PIER #1.
- REMOVE EXISTING GUARDRAIL TERMINAL, TYPE 6B ALONG EASTBOUND I-94 OUTSIDE SHOULDER AS SHOWN IN THE STAING PLANS.
- 9. PERFORM STRUCTURAL REPAIR OF CONCRETE ON NORTH COLUMN AND CAP ON PIER #1.
- 10. REINSTALL EXISTING GUARDRAIL TERMINAL, TYPE 6B ALONG EASTBOUND I-94 OUTSIDE SHOULDER AS SHOWN IN THE STAING PLANS.
- 11. REMOVE TEMPORARY SHORING.
- 12. PERFORM RESTORATION TO DISTURBED LANDSCAPING ALONG EASTBOUND I-94.
- 13. REMOVE TRAFFIC CONTROL DEVICES AND SIGNAGE ALONG EASTBOUND I-94, OPEN LANES ALONG EASTBOUND I-94, AND RAMP FROM WESTBOUND SIBLEY BLVD. TO EASTBOUND I-94.

STAGE 3

- 1. REPLACE REMOVED BRIDGE DECK, SIDEWALK, AND PARAPET.
- USING HIGHWAY STANDARDS DURING ALLOWABLE NIGHTTIME CLOSURE HOURS, REPLACE EXISTING SIGN STRUCTURE ON SPAN #2 ON THE NORTH FACE OF PARAPET, ALONG WESTBOUND SIBLEY BOULEVARD.
- 3. REPLACE REMOVED PARAPET FENCE.
- 4. REMOVE TRAFFIC CONTROL DEVICES AND SIGNAGE ALONG WESTBOUND SIBLEY BLVD.
- 5. INSTALL PERMANENT PAVEMENT MARKINGS ON WESTBOUND SIBLEY BOULEVARD.

STAGE 4


- 1. REMOVE AND REPLACE DIAPHRAGM AT THE EAST ABUTMENT BETWEEN BEAMS 5 & 6 USING HIGHWAY STANDARDS.
- 2. PERFORM RESTORATION TO DISTURBED LANDSCAPING ALONG WESTBOUND I-94.

STAGE 5

1. RESEAL THE EXPANSION JOINTS AT BOTH ABUTMENTS (OUT TO OUT) USING HIGHWAY STANDARDS.

USER NAME = mkoehler	DESIGNED	-	MDK	REVISED	-
	DRAWN	-	MDK	REVISED	-
PLOT SCALE = 2.0000 / in.	CHECKED	-	JP	REVISED	-
PLOT DATE = 4/30/2020	DATE	-	04/08/2020	REVISED	-

SIBLEY B	OULEVARD AT I-94 (BISH	OP FORD I	EXPRESSWAY)	F.A. RTE.	SECTION	COUNTY	TOTAL SHEETS	SHEET NO.
	•	I-94	2019-178-BR	COOK	40	5		
GENERAL NOTES AND SUGGESTED SEQUENCE OF CONSTRUCTION						CONTRACT	NO. 6	2K49
SCALE: N/A	SHEET NO. 1 OF 1 SHEETS	STA. N/A	TO STA. N/A	FED. R	OAD DIST. NO. 1 ILLINOIS FED. A	D PROJECT		

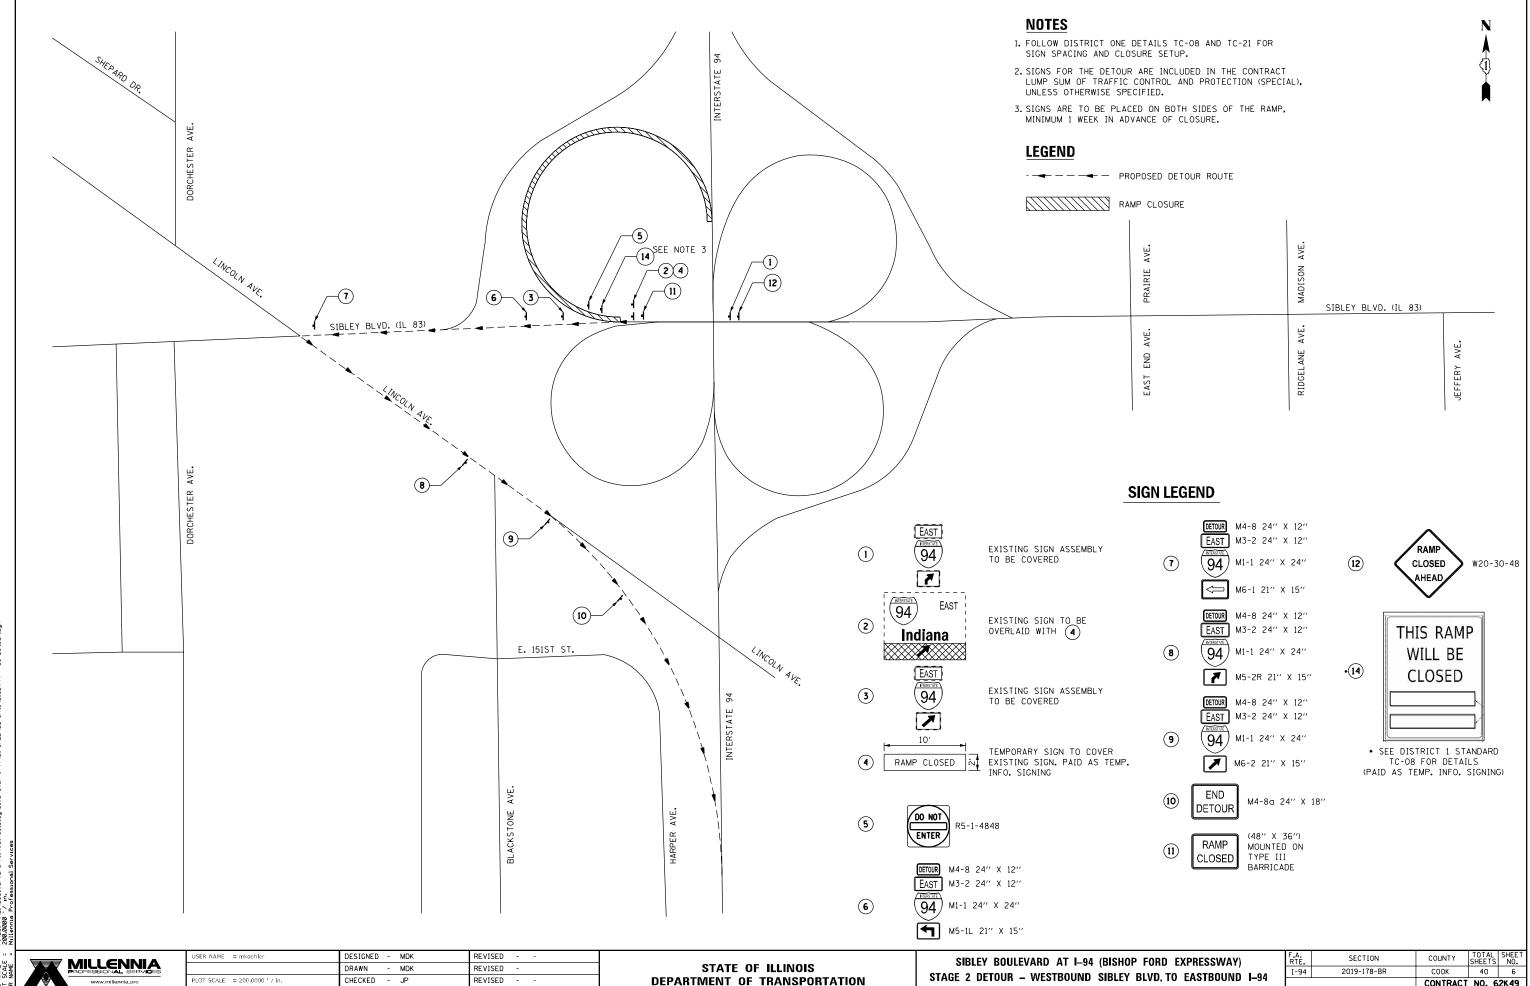


SCALE

CHECKED - JP REVISED -- 3.25.2020 REVISED -

DEPARTMENT OF TRANSPORTATION

SCALE: N/A SHEET NO. 1 OF 1 SHEETS STA. N/A TO STA. N/A FED. ROAD DIST. NO. 1 ILLINOIS FED. AID PROJECT

(LOOKING EAST)

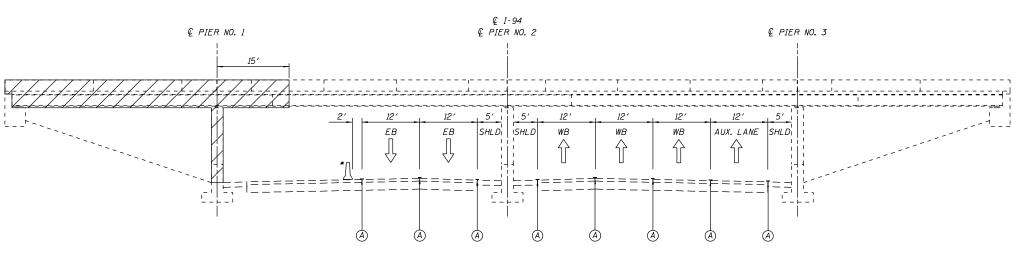

STAGE 2 I-94 AT SIBLEY BOULEVARD (LOOKING NORTH)


*PIN TEMPORARY CONCRETE BARRIER WALL, ON TRAFFIC SIDE, ADJACENT TO TEMPORARY SHORING AND CRIBBING

NOTE:
REFER TO THE "WORK RESTRICTIONS" CONTRACT SPECIAL PROVISION. THE STAGE 2
WEEKEND CLOSURE OF LANE THREE (3) ALONG EASTBOUND I-94, THE AUXILIARY LANE,
AND THE RAMP FROM WESTBOUND SIBLEY BOULEVARD TO EASTBOUND I-94 WILL ONLY
BE PERMITTED FROM 10:00 P.M. ON FRIDAY TO 5:00 A.M. ON MONDAY.

LEGE	<u>ND</u>
Δ	TEMPORARY CONCRETE BARRIER
	WORK ZONE
A	EXISTING PAVEMENT MARKINGS
1	PAVEMENT MARKING TAPE , TYPE IV
<u> </u>	DRUMS, TYPE II BARRICADES, OR VERTICAL BARRICADES,
l î	DIRECTION OF TRAFFIC



USER NAME = mkochler	DESIGNED	-	MDK	REVISED	-
	DRAWN	-	MDK	REVISED	-
PLOT SCALE = 20.0000 ' / in.	CHECKED	-	JP	REVISED	-
PLOT DATE = 4/8/2020	DATE	-	04/08/2020	REVISED	-

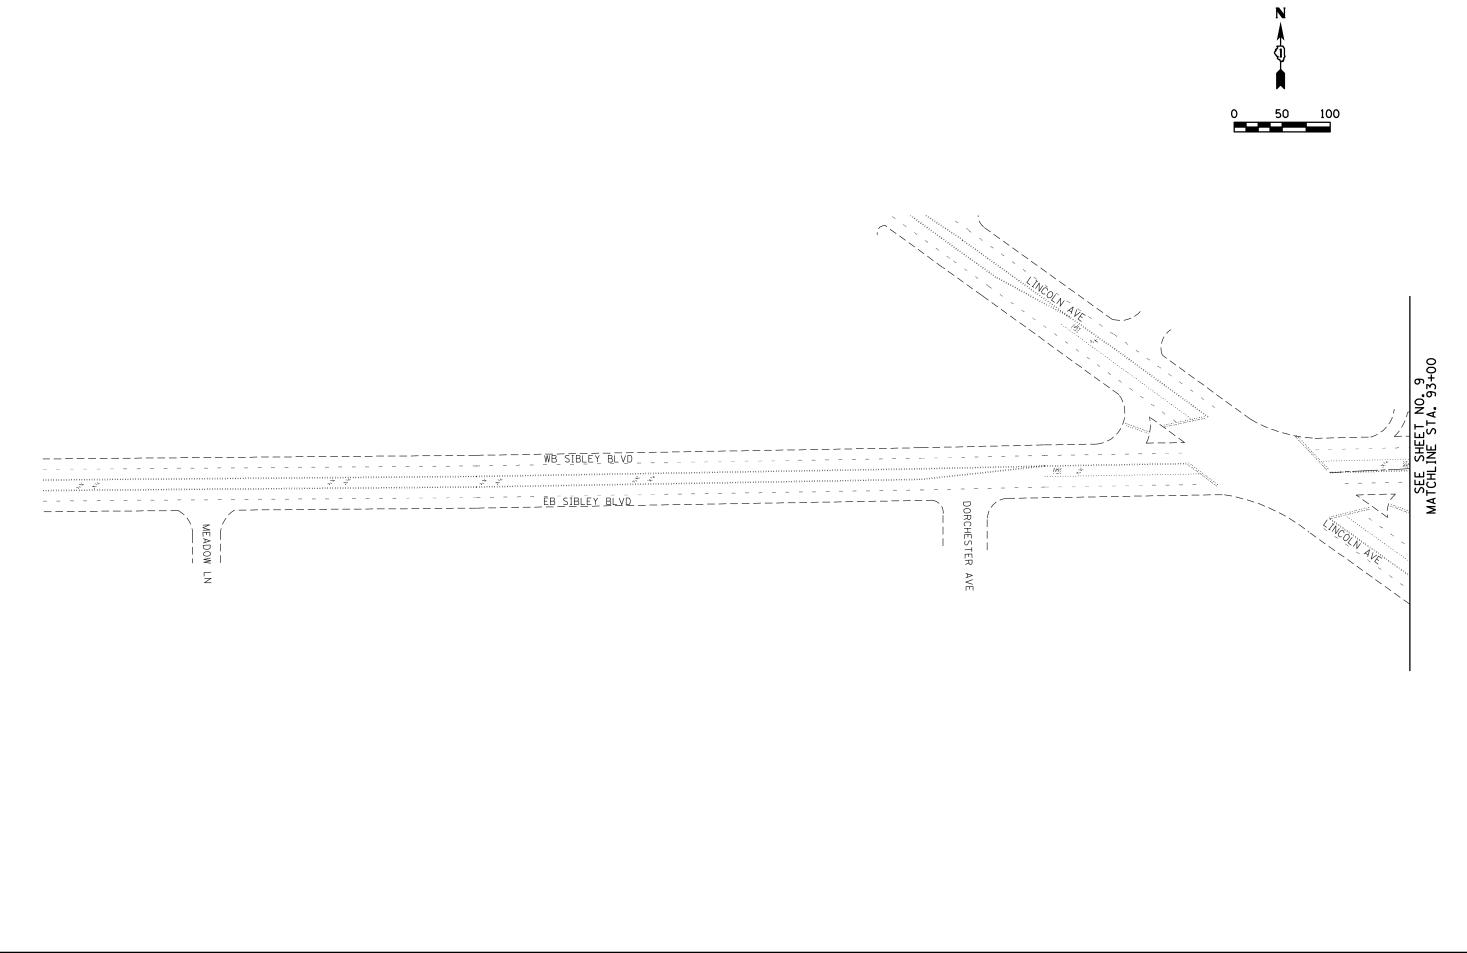

PROFESSIONAL SERVOSS
www.millennia.pro

 USER NAME
 = mkochler
 DESIGNED
 MDK
 REVISED

 PLOT SCALE
 = 100,0000 ' / in.
 CHECKED
 JP
 REVISED

 PLOT DATE
 = 3,25,2020
 DATE
 3,25,2020
 REVISED


STATE OF ILLINOIS
DEPARTMENT OF TRANSPORTATION

SIBLEY BOULEVARD AT I-94 (BISHOP FORD EXPRESSWAY)

MAINTENANCE OF TRAFFIC - STAGE I

SCALE: 1"=50' SHEET NO. 1 OF 3 SHEETS STA. N/A TO STA. N/A

:\2019\ME19003_VorVor_PHII\W014_Sibley Blvd Over I-94\01-CADD\02-Shts\D162K49 - 08-sht-Stage

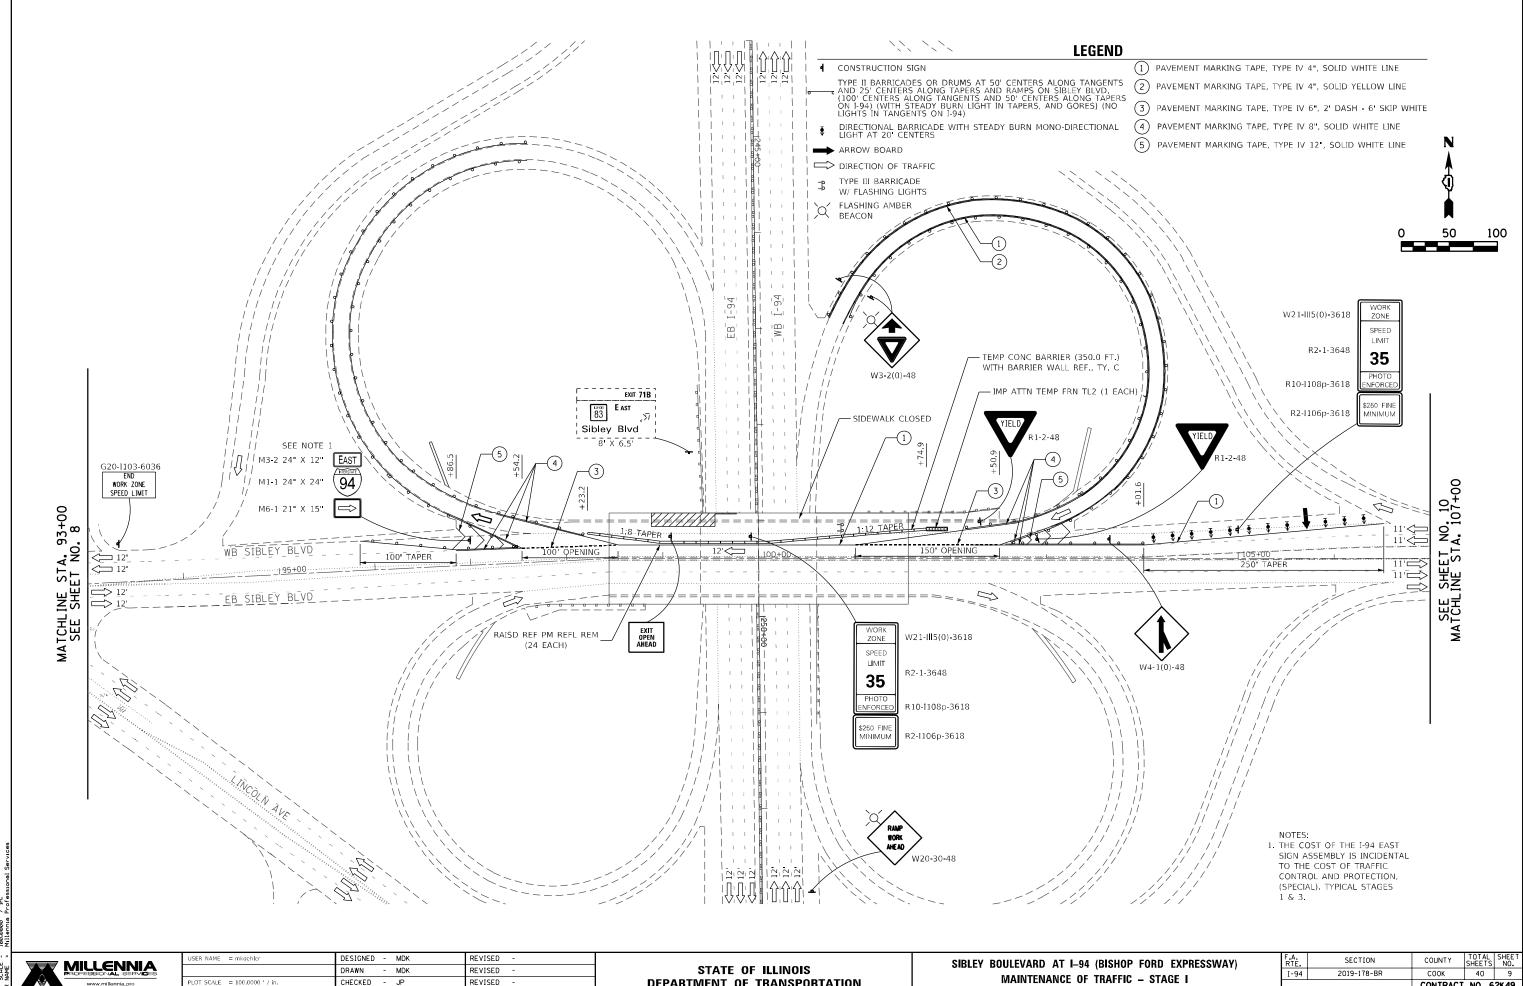

CHECKED - JP REVISED - 04/08/2020 REVISED

DEPARTMENT OF TRANSPORTATION

SCALE: 1"=50" SHEET NO. 2 OF 3 SHEETS STA. 93+00 TO STA. 107+00

NOTES:

1. THIS SIGN IS TO ONLY BE USED WHEN THE OPERATION EXCEEDS ONE (1) HOUR IN DURATION. THE SIGN IS TO BE TAKEN DOWN WHEN WORKERS ARE NOT PRESENT.

MILENIA PROFESBIONAL SERVICES www.millennia.pro

P:\2019\ME19003_Var 100.0000 '/ in.


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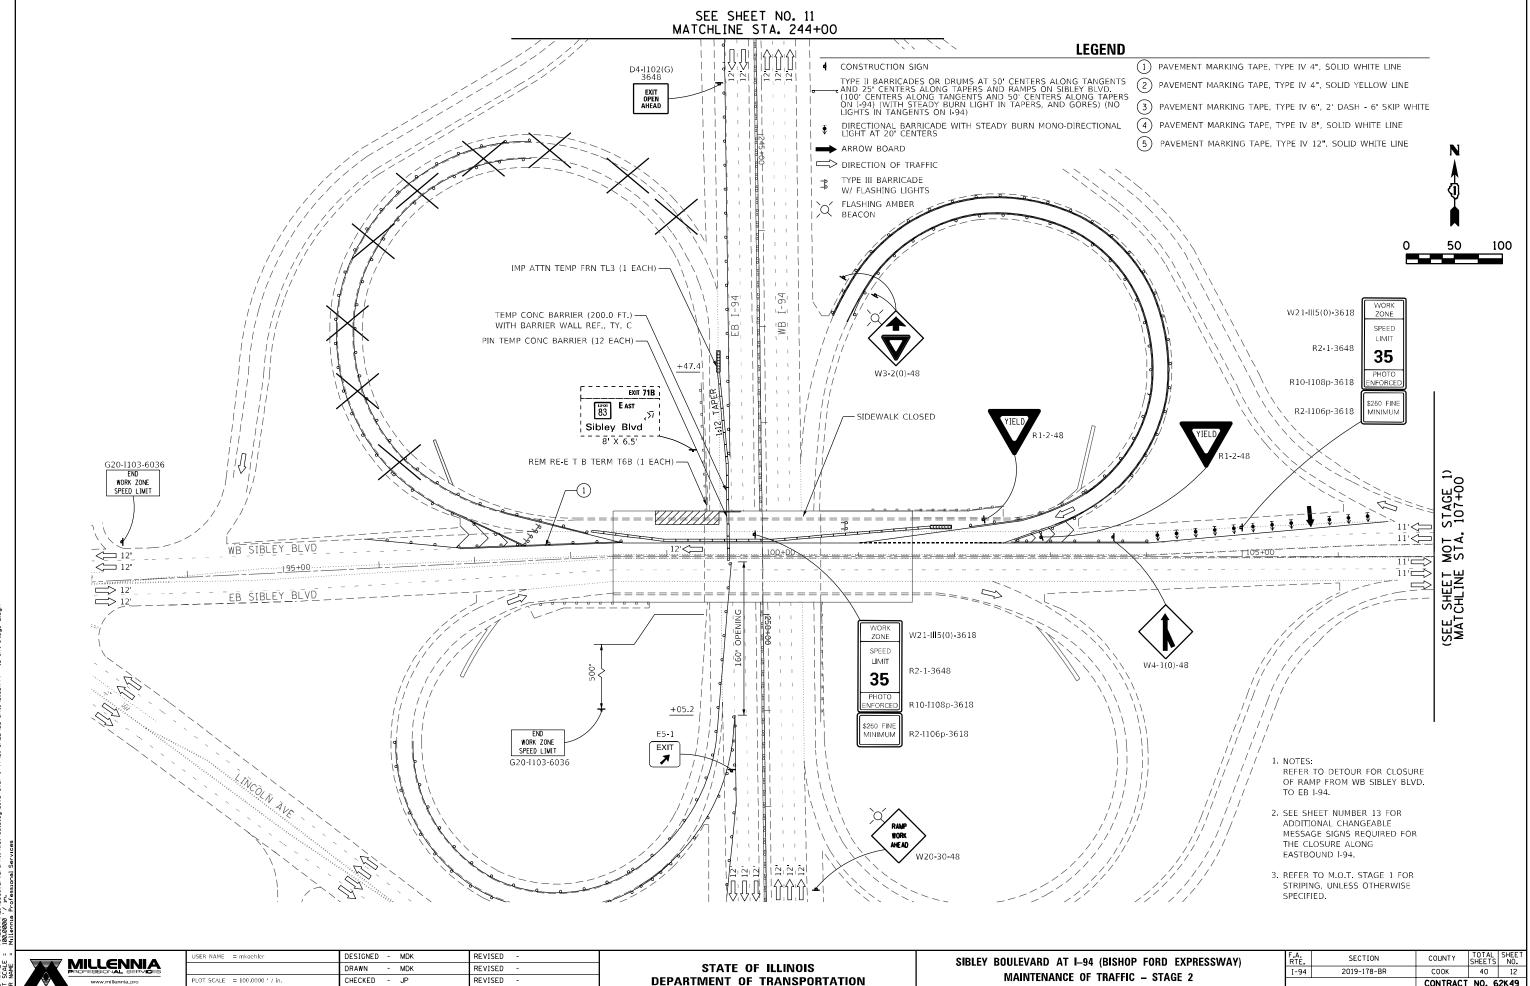
USER NAME = mkochler	DESIGNED	-	MDK	REVISED	-
	DRAWN	-	MDK	REVISED	-
PLOT SCALE = 100.0000 ' / in.	CHECKED	-	JP	REVISED	-
PLOT DATE = 4/8/2020	DATE	-	04/08/2020	REVISED	-

STATE OF ILLINOIS DEPARTMENT OF TRANSPORTATION

SIBLEY	BOULEVARD	AT I-94	(BISHOP	FORD EXP	RESSWAY)				
MAINTENANCE OF TRAFFIC - STAGE I									
1//- 5 0/	CHEET NO 3	OF 7 C	UEETC CT	A N. / A	TO CTA NIZA				

LEGEND



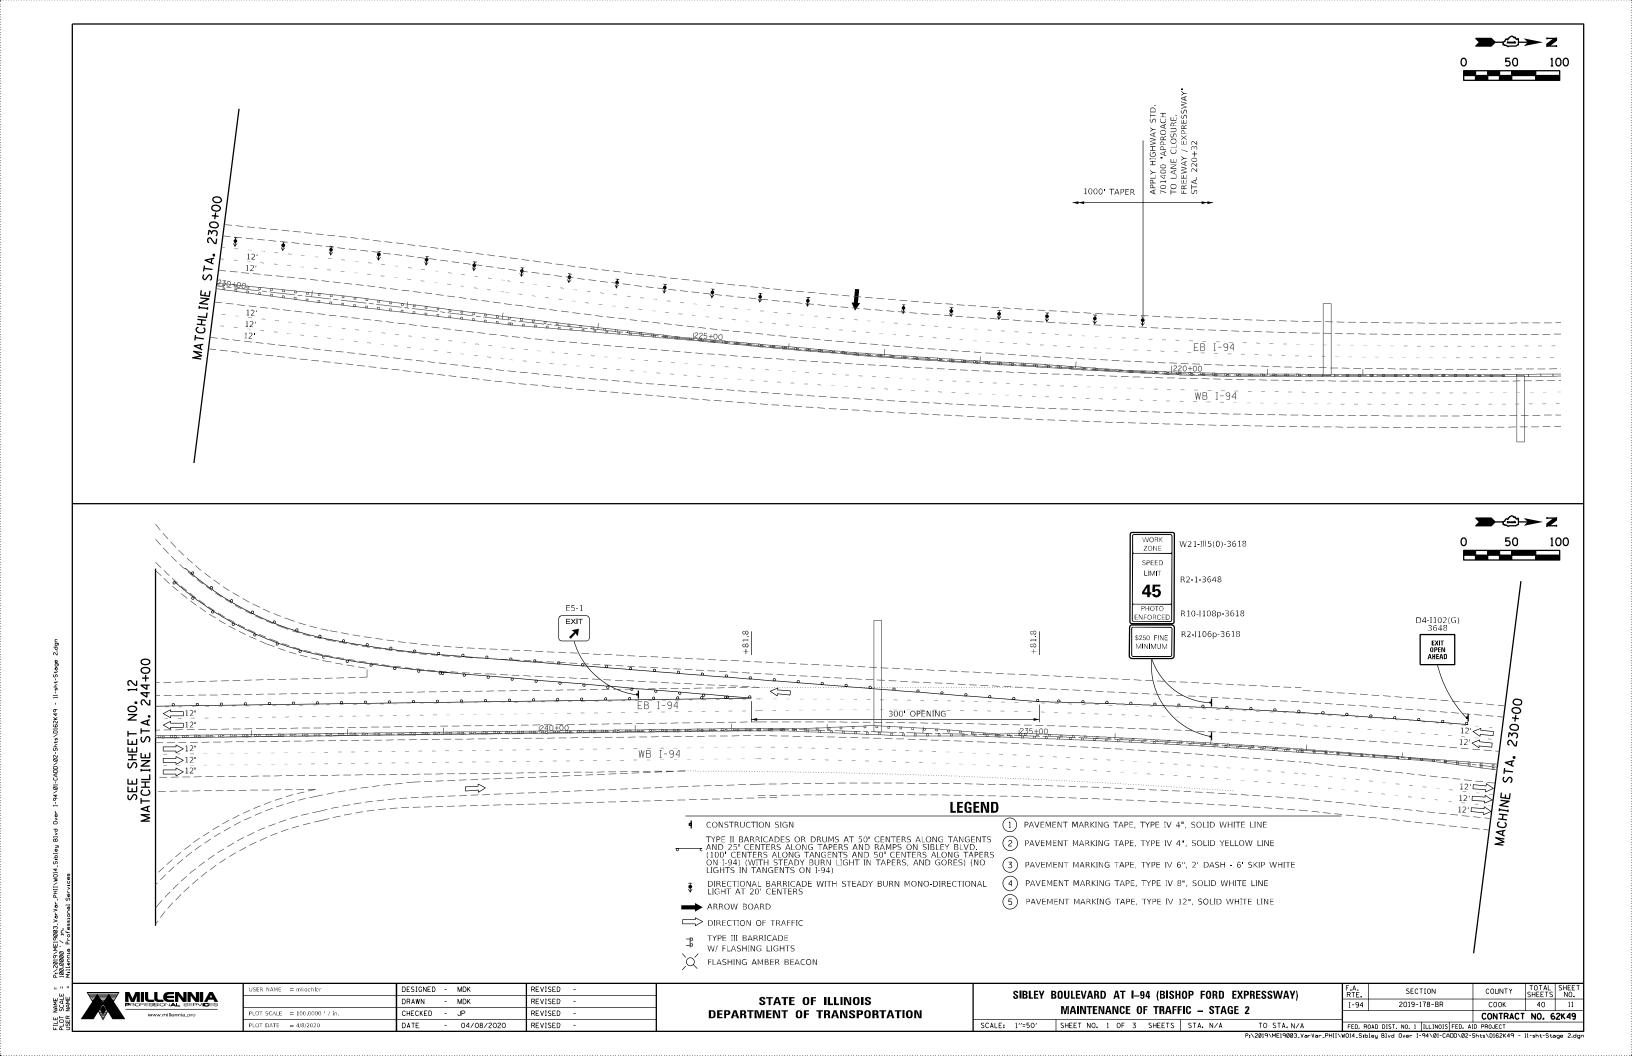

CHECKED - JP REVISED - 04/08/2020 REVISED

SCALE: 1"=50" SHEET NO. 2 OF 3 SHEETS STA. 93+00 TO STA107+00



— PLACE 1 CHANGEABLE MESSAGE SIGN ALONG SOUTHBOUND DAN RYAN EXPRESSWAY, NORTH OF THE CHICAGO SKYWAY



NOTE: THE CHANGEABLE MESSAGE SIGNS AT EACH OF THESE FOUR LOCATIONS ARE TO BE PLACED SEVEN (7) DAYS PRIOR TO IMPLEMENTING THE CLOSURE ALONG EASTBOUND 1-94. THE CHANGEABLE MESSAGE SIGNS ARE TO BE REMOVED ONCE THE CLOSURE ALONG EASTBOUND 1-94 HAS BEEN REMOVED.

- PLACE 1 CHANGEABLE MESSAGE SIGN ALONG NORTHBOUND I-57 AT HALSTED



- PLACE 1 CHANGEABLE MESSAGE SIGN ALONG SOUTHBOUND DAN RYAN EXPRESSWAY, SOUTH OF 87TH STREET



- PLACE 1 CHANGEABLE MESSAGE SIGN ALONG SOUTHBOUND STONEY ISLAND FEEDER, SOUTH OF 95TH ST.




USER NAME = mkochler	DESIGNED	-	MDK	REVISED	-	-
	DRAWN	-	MDK	REVISED	-	
PLOT SCALE = 200.0000 ' / in.	CHECKED	-	JP	REVISED	-	=
PLOT DATE = 3/25/2020	DATE	-	3.25.2020	REVISED	-	=

STATE OF ILLINOIS **DEPARTMENT OF TRANSPORTATION**

SIBLEY E			•	FORD EXPR - STAGE 2	ESSWAY)
SCALE: ·	SHEET NO. 3	OF <u>3</u> S	HEETS ST.	A. N <u>/</u> A	TO STA.N/A


TOTAL SHEET NO. 40 13 SECTION 2019-178-BR СООК CONTRACT NO. 62K49

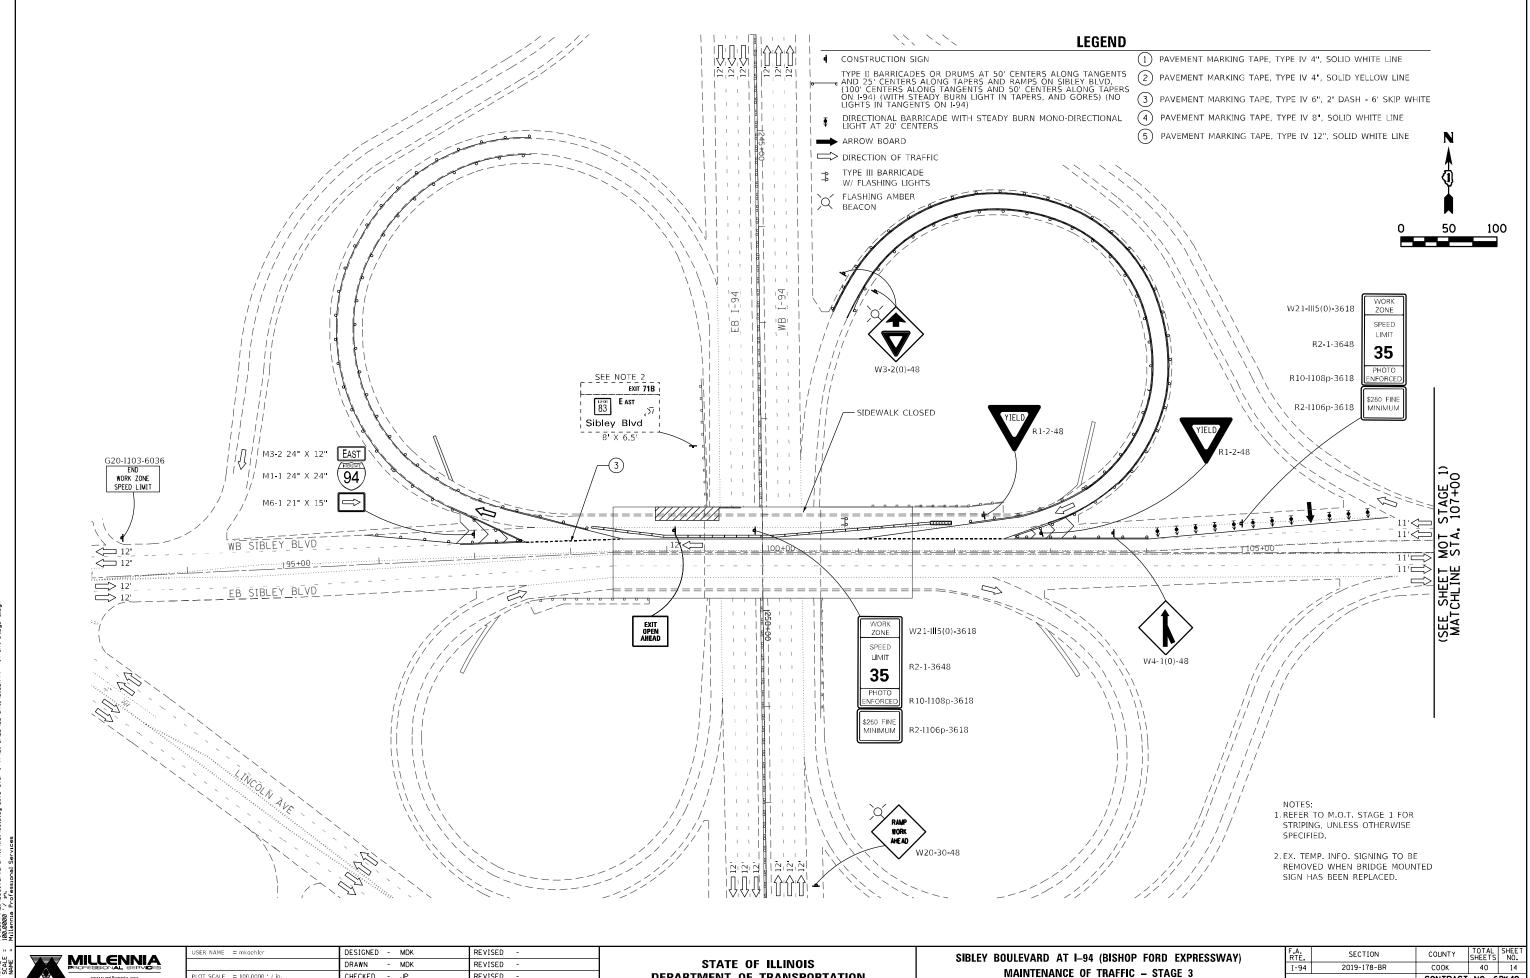

CHECKED - JP REVISED - 04/08/2020 REVISED

DEPARTMENT OF TRANSPORTATION

MAINTENANCE OF TRAFFIC - STAGE 3 SCALE: 1"=50" SHEET NO. 1 OF 1 SHEETS STA. N/A

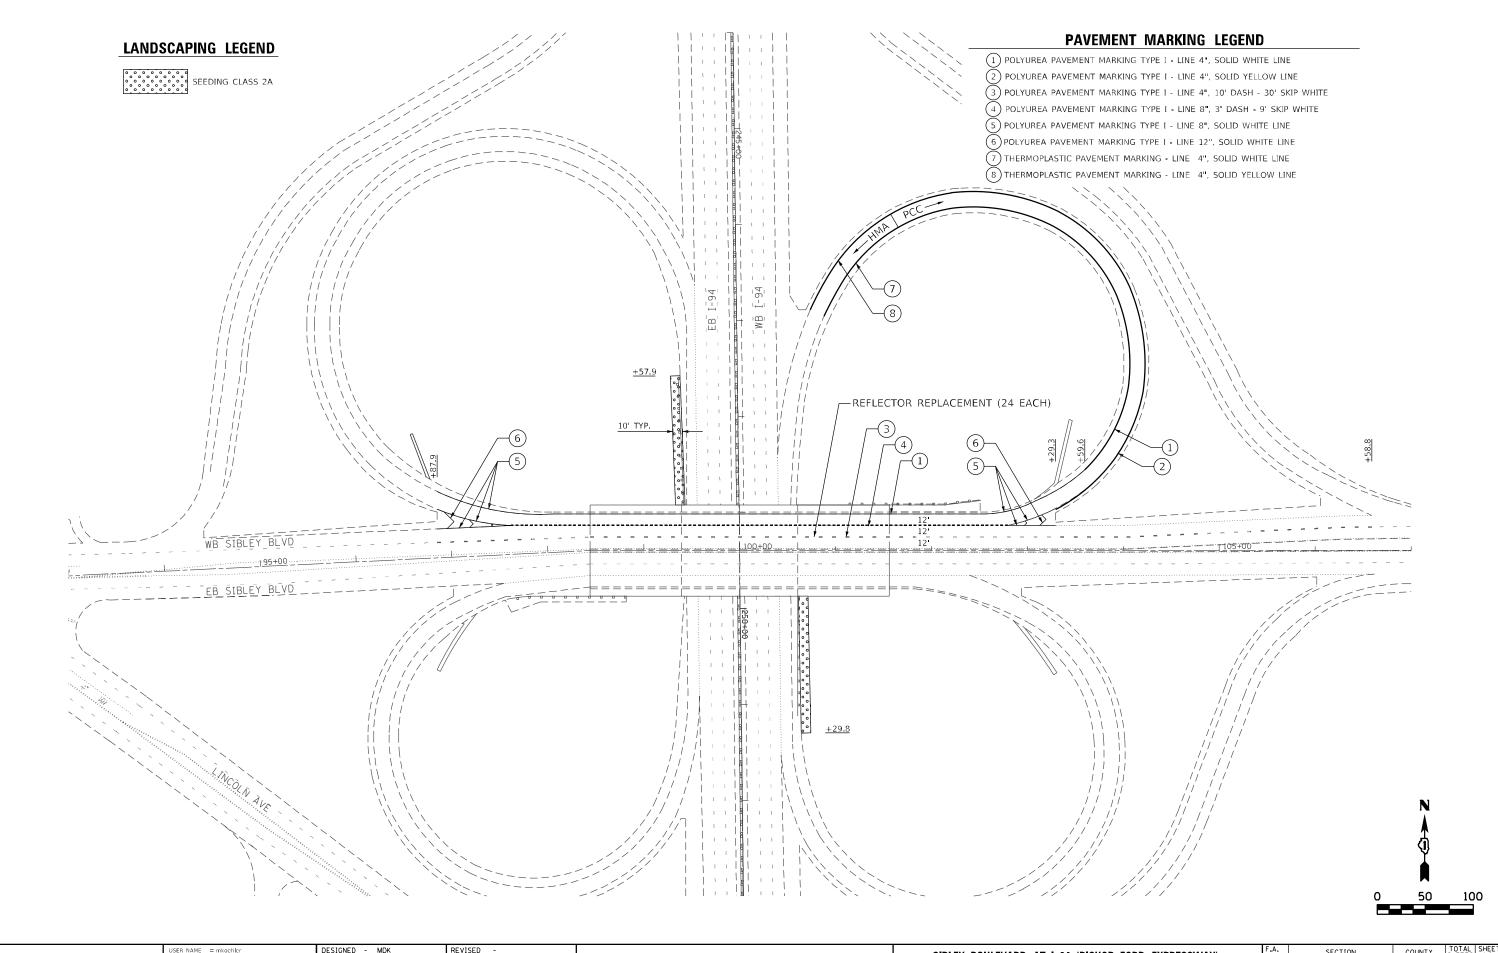


MILLENNA PROFEGBIONAL GERVOES www.millennia.pro STATE OF ILLINOIS DEPARTMENT OF TRANSPORTATION

SIBLEY BOULEVARD AT I-94 (BISHOP FORD EXPRESSWAY)

PAVEMENT MARKING & LANDSCAPING PLAN

SCALE: 1"=50' SHEET NO. 1 OF 1 SHEETS STA. N/A TO STA. N/A

.2019\ME19003_VorVor_PHII\W014_Sibley Blvd Over I-94\01-CADD\02-Shts\D162K49 - 15-sht-Pl

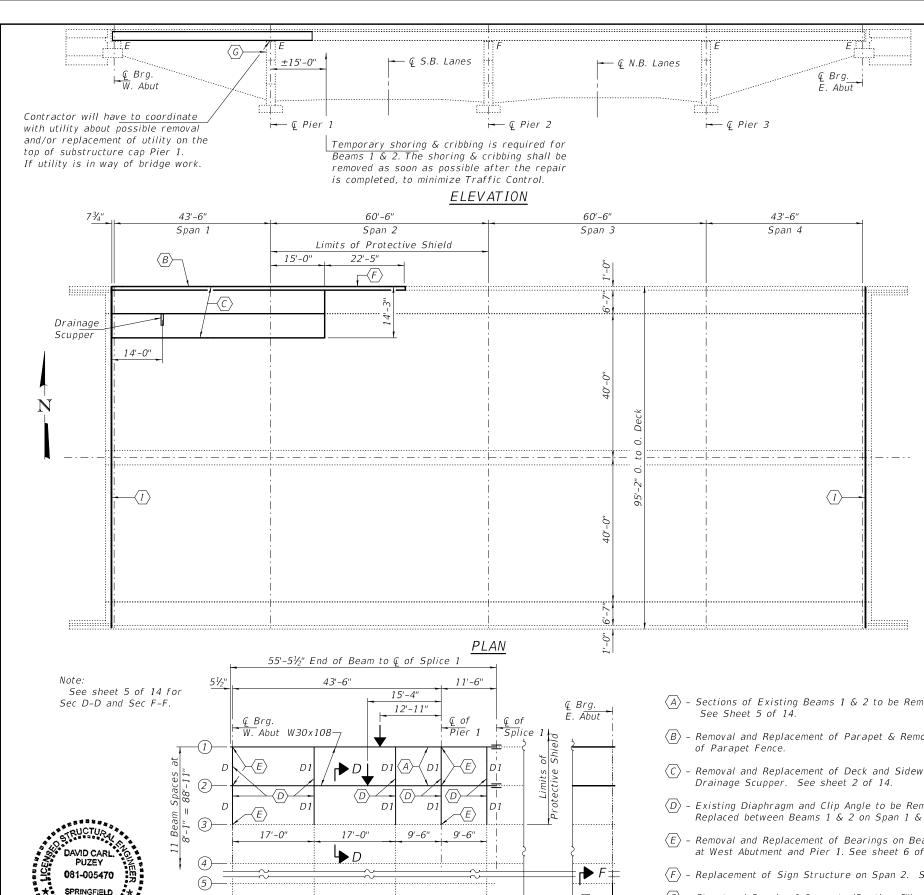

REACTION TABLE AT TEMPORARY SHORING

R₽	(K)	67.0
R Ł	(K)	49.6
Imp.	(K)	13.9
R (Total)	(K)	130.5

GENERAL NOTES

All structural steel shall conform to AASHTO Classification M-270 Gr. 36, unless otherwise noted.

Fasteners shall be high strength bolts. Bolts %" \emptyset , open holes 15/16"Ø, unless otherwise noted.

Reinforcement bars designated (E) shall be epoxy coated. Plan dimensions and details relative to existing plans are subject to nominal construction variations. The Contractor shall field verify existing dimensions and details affecting new construction and make necessary approved adjustments prior to construction or ordering of materials. Such variations shall not be cause for additional compensation for a change in scope of the work, however, the Contractor will be paid for the quantity actually furnished at the unit price bid for the work.

All structural steel shall be shop painted with the inorganic zinc rich primer per AASHTO M300, Type 1. Cost included with Furnishing and Erecting Structural Steel. Full painting of the structure to be completed under a separate contract.

The Contractor shall provide support and/or shoring systems for the slab and beam in the area of existing beam removal. See Special Provisions "Temporary Shoring and Cribbing".

Existing reinforcement bars extending into the removal area shall be cleaned, straightened and incorporated into the new construction. Any reinforcement bars that are damaged during concrete removal shall be replaced with an approved bar splicer or anchorage system. Cost included with Concrete Removal.

The deck surface shall have its final finish tined according to Article 420.09(e)(1) of the Standard Specifications. Cost included with Concrete Superstructure.

Load carrying components designated "NTR" shall conform to the Supplemental Requirements for Notch Toughness, Zone 2.

Existing structural steel that will be in contact with new structural steel shall be cleaned and painted prior to erection as required by the special provision "Cleaning and Painting Contact Surface Areas of Existing Steel Structures".

All soot on the underside of the bridge shall be removed according to Article 592 of the Standard Specifications, to the satisfaction of the engineer. This work shall be limited to Span 1 and portions of Span 2 within the lane closures.

BILL OF MATERIAL

DILL OF MATERIAL		
ITEM	UNIT	QUANTITY
Concrete Removal	Cu. Yd.	39.7
Concrete Superstructure	Cu. Yd.	39.7
Structural Steel Removal	Pound	15500
Stud Shear Connectors	Each	390
Protective Shield	Sq. Yd.	96.0
Preformed Joint Seal 11/4"	Foot	190
Bridge Washing No. 1	Each	1
Anchor Bolts, 1" Ø	Each	12
Jack and Remove Existing Bearings	Each	2
Elastomeric Bearing Assembly Type I	Each	3
Elastomeric Bearing Assembly Type II	Each	3
Furnishing and Erecting Structural Steel	Pound	15720
Protective Coat	Sq. Yd.	120.7
Remove and Re-erect Existing Hand Rail	Foot	82
Reinforcement Bars, Epoxy Coated	Pound	7250
Structural Repair of Concrete (Depth ≤ 5")	Sq. Ft.	126
Temporary Shoring and Cribbing	L. Sum	1
Mechanical Splicers	Each	252
Overhead Sign Structure Bridge Mounted	Foot	18
Drainage Scupper, DS-33	Each	1
On new superstructure concrete only		

- * On new superstructure concrete only.
- ** Shoring to remain in place until repair of Pier, as shown on sheet 7 of 14, is completed.

- $\langle A \rangle$ Sections of Existing Beams 1 & 2 to be Removed and Replaced.
- $\langle B \rangle$ Removal and Replacement of Parapet & Removal and Re-Erection
- Removal and Replacement of Deck and Sidewalk Section including
- $\langle \overline{D} \rangle$ Existing Diaphragm and Clip Angle to be Removed and Replaced between Beams 1 & 2 on Span 1 & partial Span 2.
- $\langle E \rangle$ Removal and Replacement of Bearings on Beams 1, 2 & 3 at West Abutment and Pier 1. See sheet 6 of 14.
- $\langle F \rangle$ Replacement of Sign Structure on Span 2. See sheets 9 thru 12 of 14.
- $\langle G \rangle$ Structural Repair of Concrete (Depth \leq 5") on North Column and Cap on Pier 1. See sheet 7 of 14.
- $\langle H \rangle$ Remove and Replace diaphragm between beams 5 & 6.
- $\langle I \rangle$ Remove and Replace joint out to out of both aboutments with Preformed Joint Seal.

		Line		
DESIGNED - Victor H. Veliz	EXAMINED	Twin A. Alex	DATE -	MAY 1, 2020
CHECKED - Stephen M. Ryan		ENGINEER OF STRUCTURAL SERVICES		
DRAWN - Venkat Reddy	PASSED	So Carl Prones	REVISED	-
CHECKED - VHV SMR		ENGINEER OF BRIDGES AND STRUCTURES	REVISED	-

Expires 11/30/2020


PARTIAL FRAMING PLAN


Impact 🕨


STATE OF ILLINOIS **DEPARTMENT OF TRANSPORTATION**

 $\langle H \rangle$ -

GENERAL PLAN AND ELEVATION SECTION COUNTY SIBLEY BLVD. (IL 83) OVER F.A.I 94 2019-178-BR COOK 40 16 SN 016-0956 CONTRACT NO. 62K49 SHEET NO. 1 OF 14 SHEETS

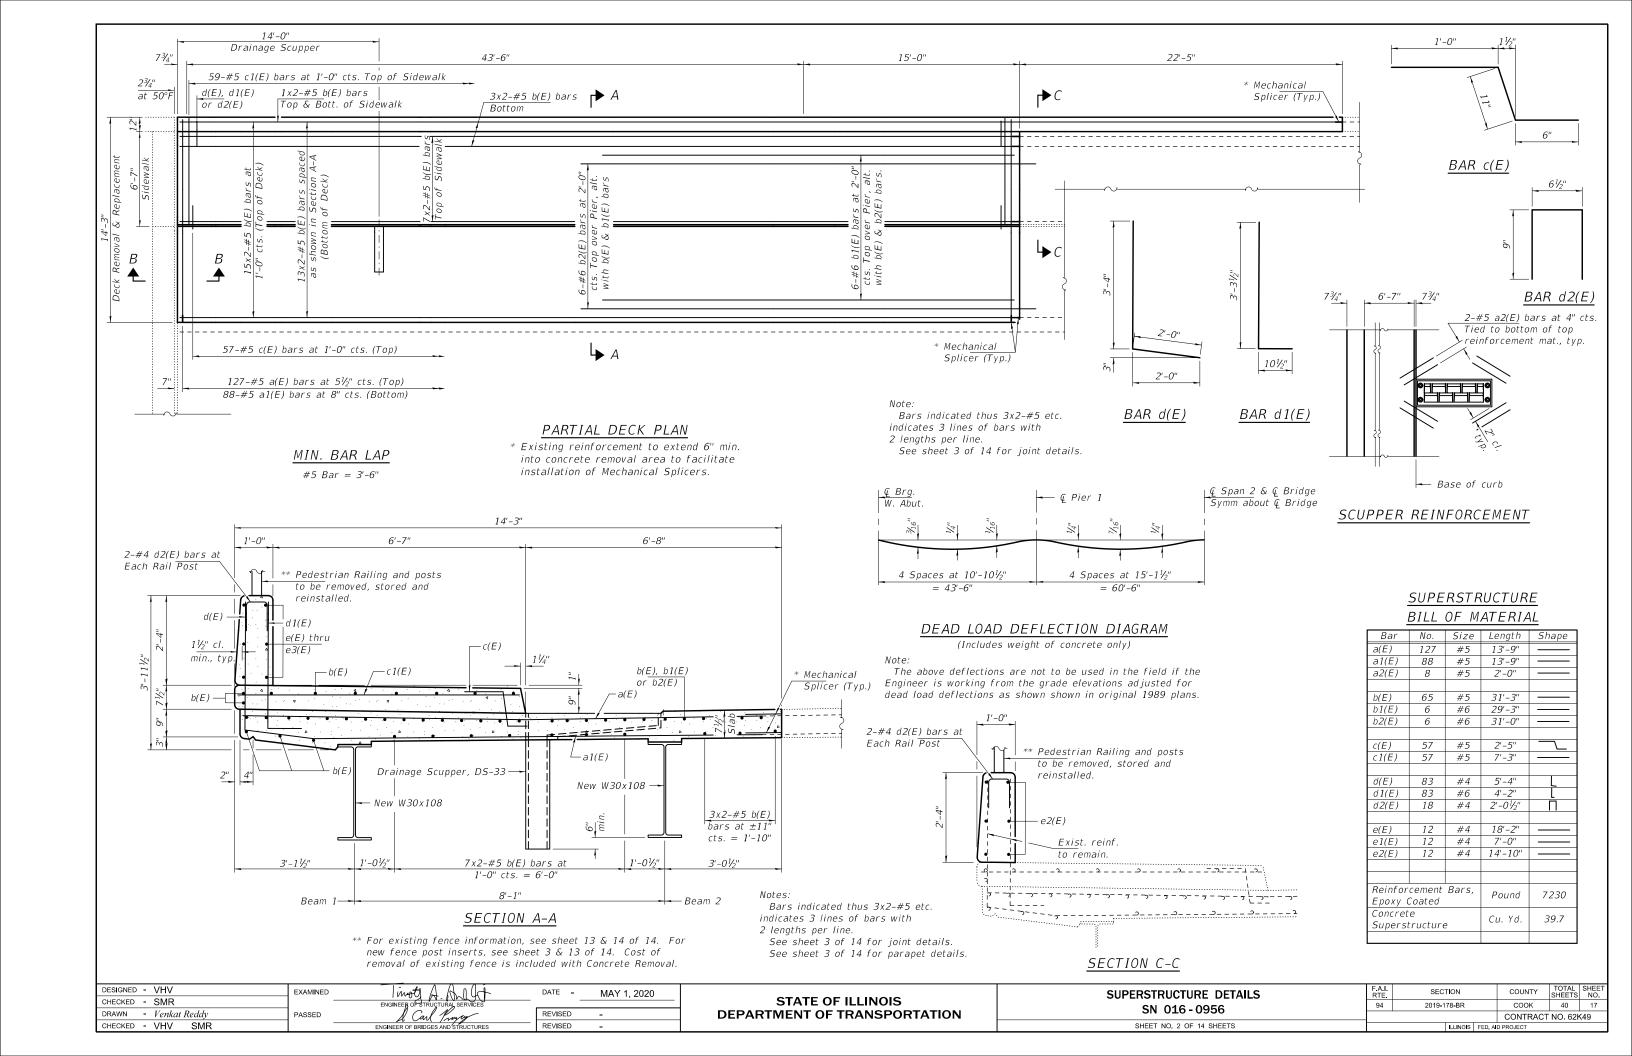

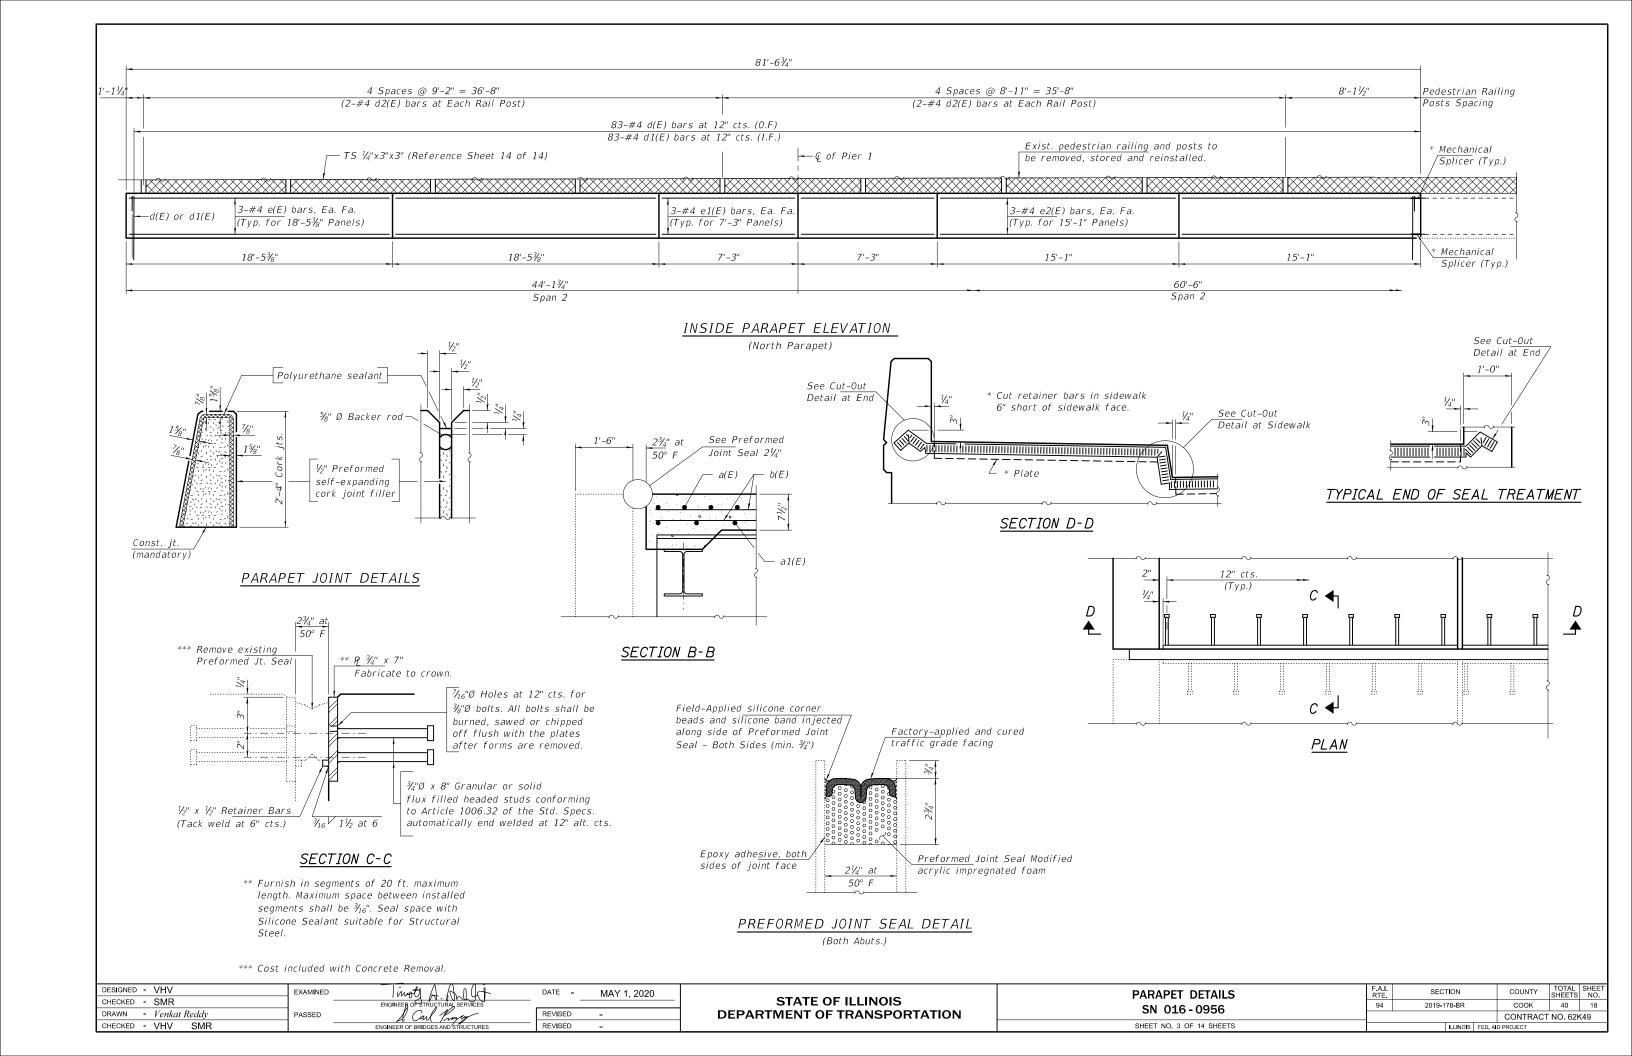

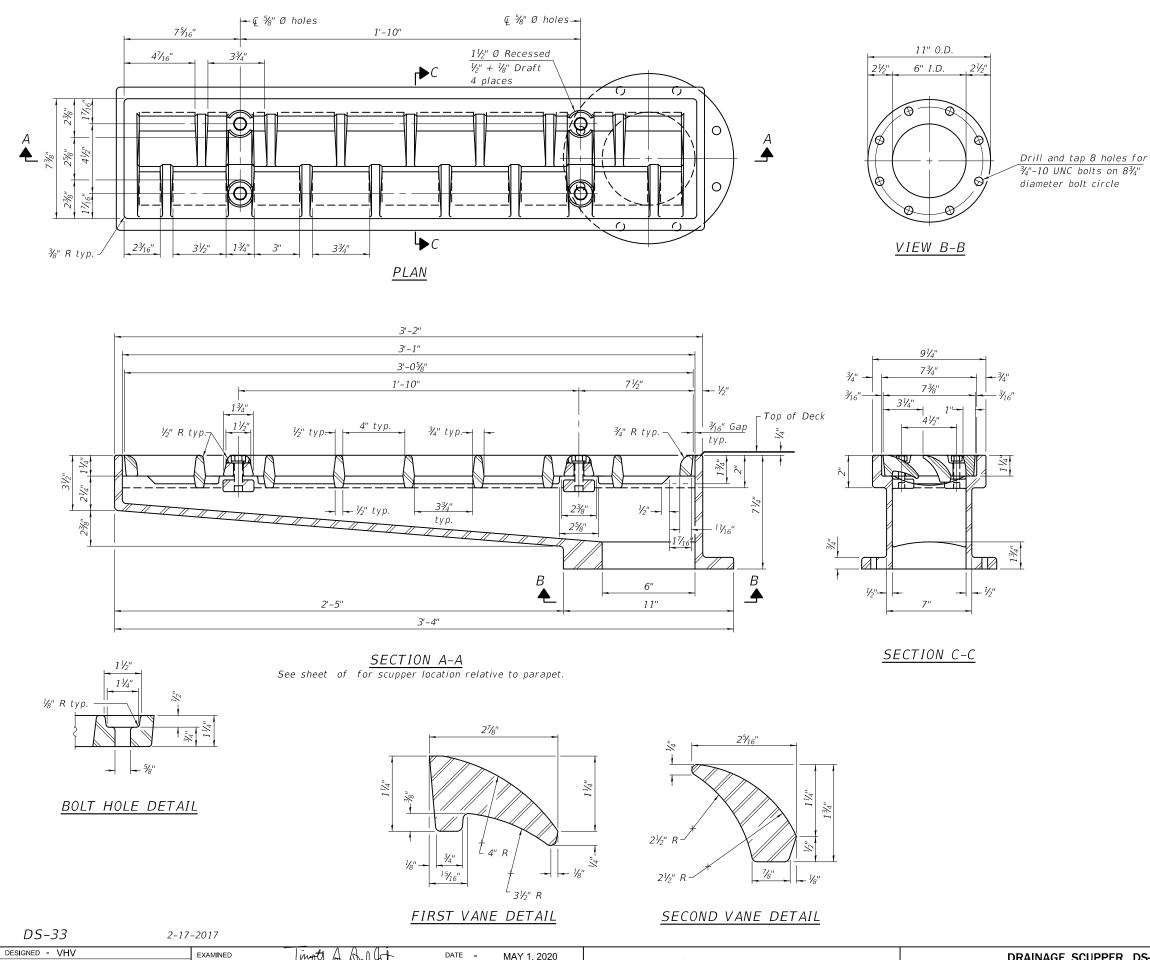

REVISED

CHECKED - SMR

DRAWN - Venkat Reddy

CHECKED - VHV SMR

PASSED

Notes:

All cast iron parts shall be gray iron conforming to the requirements of AASHTO M 105, Class 35B.

Bolts, anchor studs, washers and nuts shall conform to the requirements of ASTM A 307 and shall be galvanized according to AASHTO M 232.

Downspouts located on the exterior side

of a painted steel fascia beam shall be painted with the finish coat specified for the exterior side of the fascia beam.


As an alternate, bolts, anchor studs, washers and nuts may be stainless steel according to Article 1006.29(d) of the Standard Specifications.

Structural steel weldments of equal sections and of the same configuration may be substituted for the cast iron scupper frame. Fillet or full penetration welds shall be used for the weldments. Details shall be submitted to the Engineer for approval. Structural steel weldments shall not be substituted for the cast iron scupper grate. Structural steel frames and downspouts shall be galvanized according to AASHTO M111.

The Contractor shall take appropriate measures to assure that Protective Coat is not applied to the scupper.

Cost of the Grate, Frame, Downspout, Anchor Studs, Bolts, Washers and Nuts including complete installation of the scupper shall be paid for at the contract unit price each for Drainage Scupper, DS-33.

Alternate fiberglass downspout conforming to ASTM D 2996 with a short-time rupture strength hoop tensile stress of 30,000 psi min. may be used in lieu of the cast iron or steel equivalent.

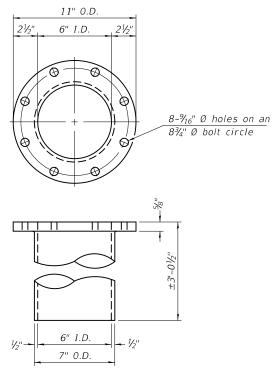


DOWNSPOUT


BILL OF MATERIAL


ITEM	UNIT	QUANTITY
Drainage Scupper, DS-33	Each	1

STATE OF ILLINOIS
DEPARTMENT OF TRANSPORTATION


DRAINAGE SCUPPER, DS-33 SN 016 - 0956 SHEET NO. 4 OF 14 SHEETS

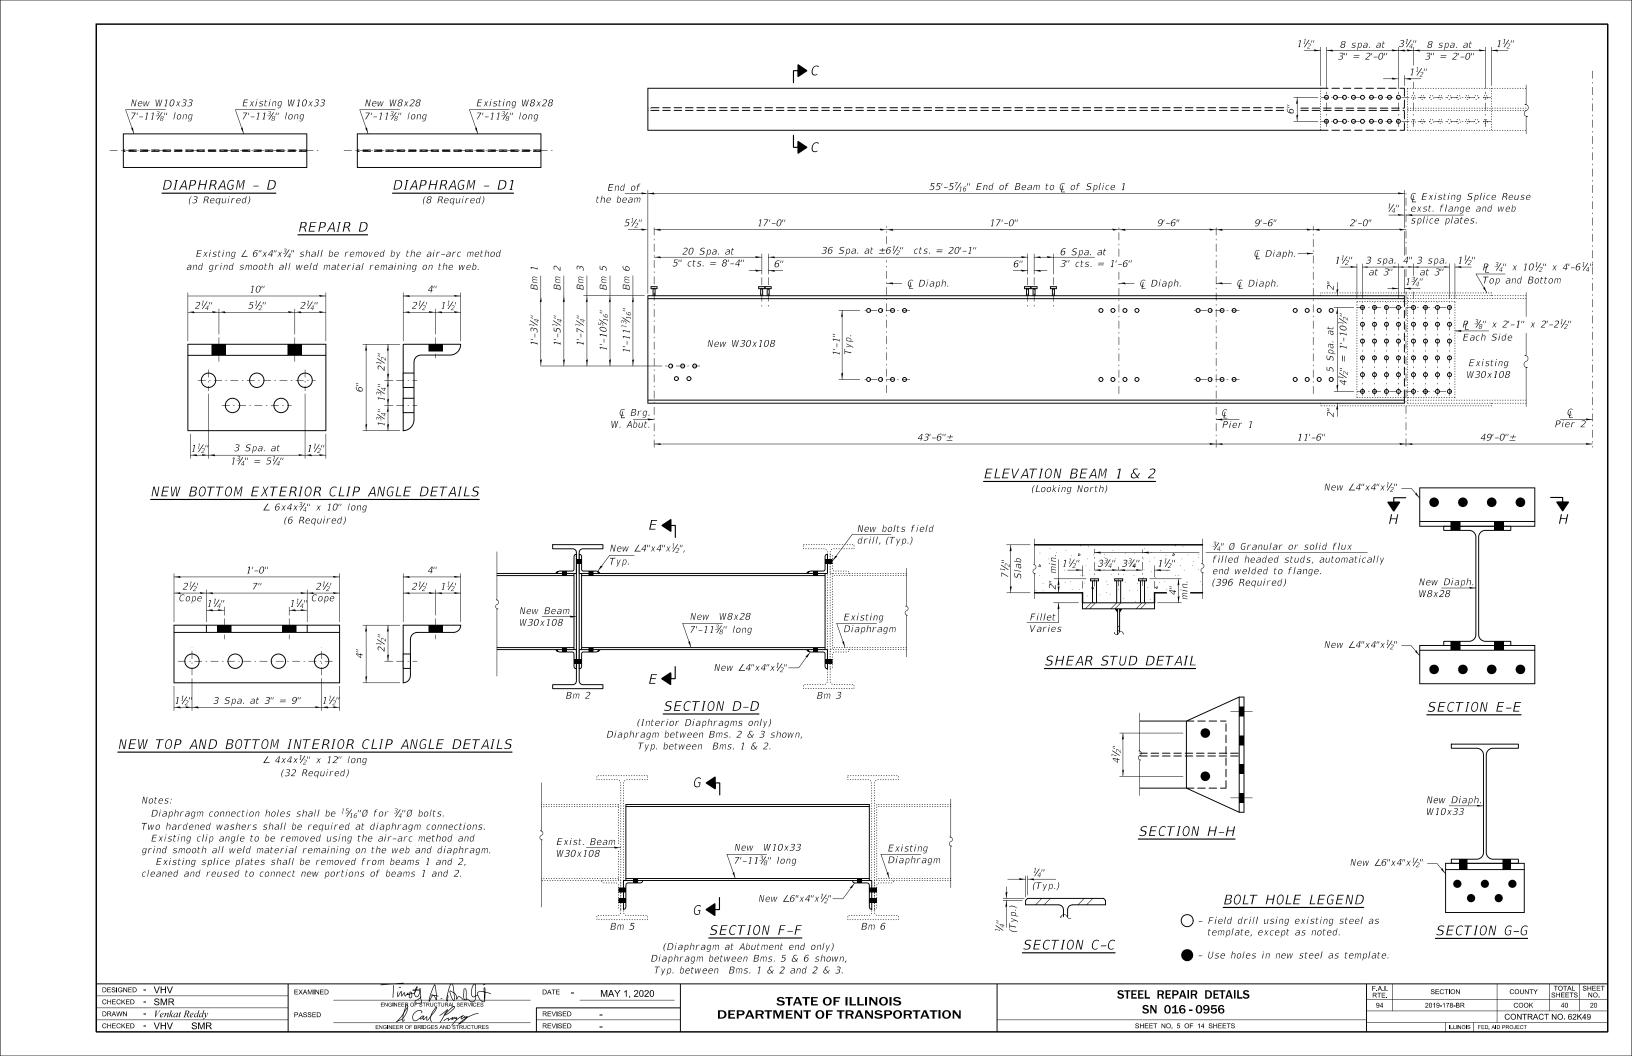


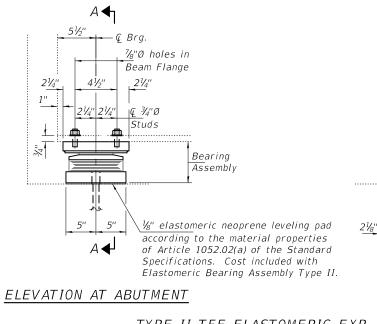

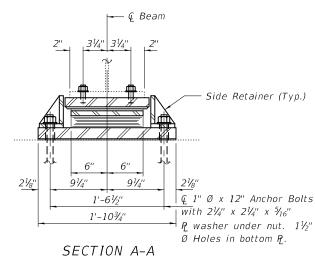


TYPE II TFE ELASTOMERIC EXP. BRG.

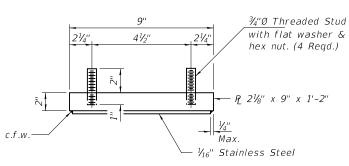


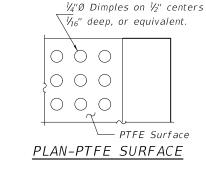


TOP BEARING ASSEMBLY

BOTTOM BEARING ASSEMBLY

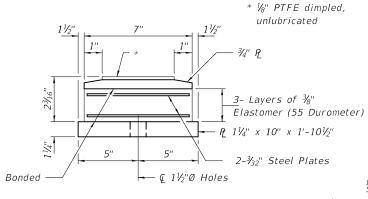

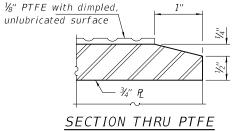

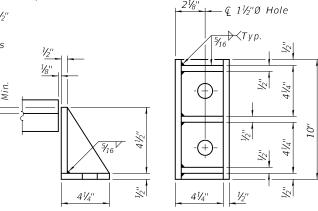

SIDE RETAINER (ABUT.)

Equivalent rolled angle with stiffeners will be allowed in lieu of welded plates.

BEAM REACTIONS

		Abutment	Pier 1
R₽	(K)	18.5	67.0
R Ł	(K)	40.2	49.6
Imp.	(K)	11.7	13.9
R (Total)	(K)	70.4	130.5

Notes:

Side retainers and stainless steel plates shall be included in the cost of Elastomeric Bearing Assembly, Type I and Type II.

Anchor bolts and side retainers at all supports shall be installed as each member is erected unless an equivalent temporary means of lateral restraint is used.

Diaphragm removal and reinstallation may be required to facilitate drilling holes. Cost included with elastomeric bearing assembly Type I and Type II.

Prior to ordering any material, the contractor shall verify in the field all bearing height and shim thickness dimensions. Adjustment must account for deck heave due to pack rust, and beam displacement.

Min. Jack Capacity = 35 tons (Abuts) = 75 tons (Pier 1)

Anchor bolts shall be ASTM F1554 All - Thread (Or an Engineer-Approved alternate material) of the grade(s) and diameter(s) specified. ASTM A307 Grade C Anchor bolts may be used in liew of ASTM F1554 Grade 36 (fy = 36ksi). The corresponding specified Grade of AASHTO M314 Anchor bolts may be used in liew of ASTM F1554.

Drilled and set anchor bolts shall be installed according to article 521.06 of the Standard Specifications.

Two $\frac{1}{8}$ " adjusting shims shall be provided for each bearing in addition to all other plates or shims and placed as shown on bearing details.

All steel components shall be galvanized after fabrication according to Article 520.03 of the Standard Specifications.

The %" PTFE sheet shall be bonded directly to the top steel plate with a two-component, medium viscosity epoxy resin, conforming to the requirements of the Federal Specification MMM-A-134, Type I. The bond agent shall be applied on the full area of the contact surfaces.


Bonding of $\frac{1}{6}$ " PTFE sheet during vulcanizing process will be permitted provided the process and method of adjusting assembly height is approved by the Engineer.


New steel extensions, shim plates and connection bolts are included with Furnishing and Erecting Structural Steel. Prior to ordering any material, the Contractor shall verify

in the field all bearing height and shim thickness dimensions.

Anchor bolts for Type II bearings shall be placed in holes drilled through the bottom bearing plate after members are in place. Side retainers shall be placed after bolts are installed.

83/4"

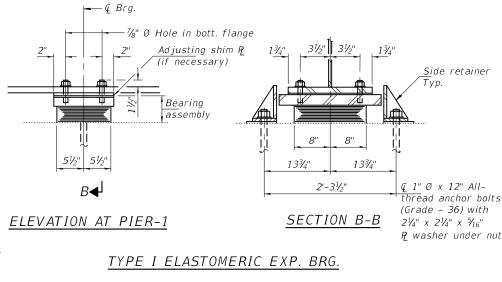

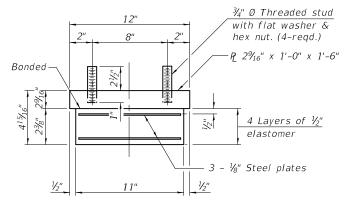


BEARING ASSEMBLY (PIER-1

Note:

B◀₁

Shim plates shall not be placed under bearing assembly.

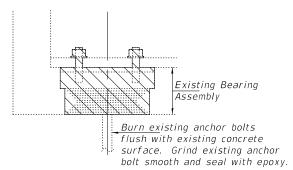

EXISTING BEARING REMOVAL DETAIL

Cost included with Jack and Remove Existing Bearings. (Beam 3, 2 locations) Cost included with structural steel removal (Beams 1 & 2, Total 4 Locations)

BILL OF MATERIAL

Elastomeric Bearing	_ ,	
Assembly Type I	Each	3
Elastomeric Bearing Assembly Type II	Each	3
Anchor Bolts	Each	12
Jack and Remove Existing Bearings	Each	2

SIDE RETAINER (PIER-1)

Equivalent rolled angle with stiffeners will be allowed in lieu of welded plates.

DESIGNED - VHV	EXAMINED	Imot A A I G	DATE -	MAY 1, 2020
CHECKED - SMR		ENGINEER OF STRUCTURAL SERVICES		
DRAWN - Venkat Reddy	PASSED	& Carl Prayey	REVISED	-
CHECKED - VHV SMR		ENGINEER OF BRIDGES AND STRUCTURES	REVISED	_

STATE OF ILLINOIS
DEPARTMENT OF TRANSPORTATION


½" Stainless steel plate, A240, Type 304,


No. 1 finish.

BEARING DETAILS SN 016 - 0956 SHEET NO. 6 OF 14 SHEETS
 F.A.I. RTE.
 SECTION
 COUNTY SHEETS NO.
 SHEETS NO.

 94
 2019-178-BR
 COOK
 40
 21

 CONTRACT NO. 62K49

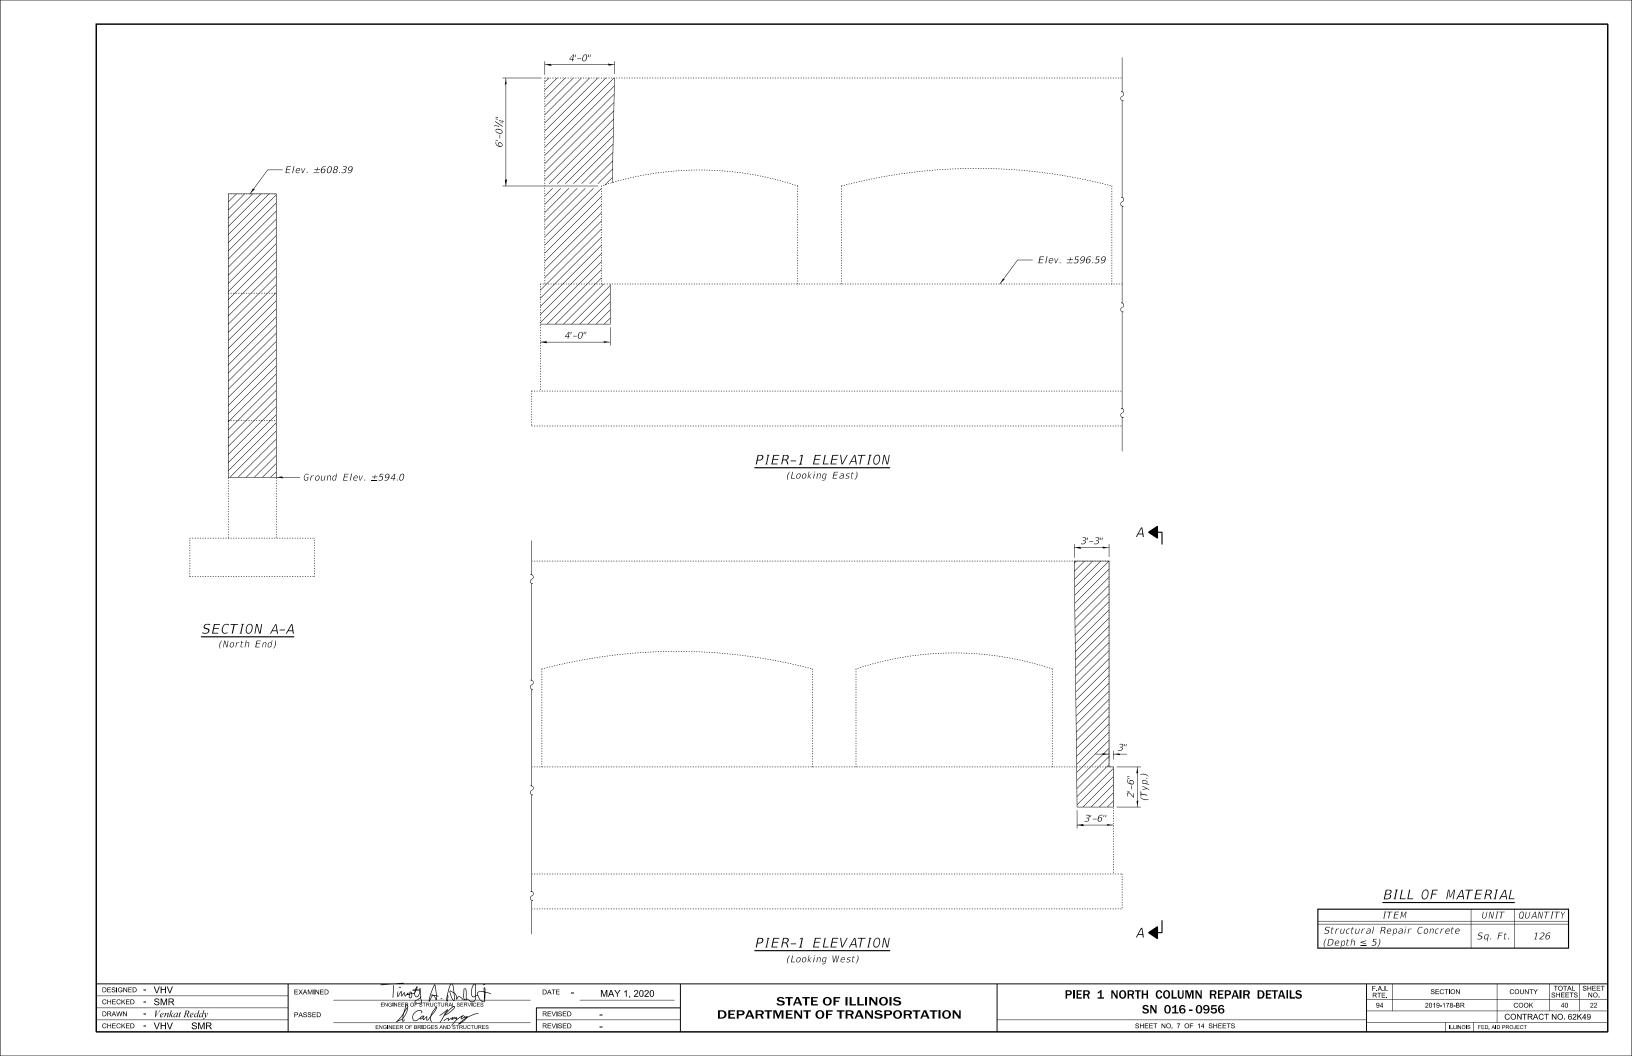

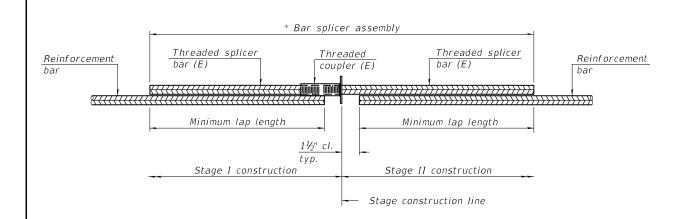


STANDARD BAR SPLICER ASSEMBLY PLAN

(All components shall be provided from one supplier)

Threaded splicer bar length = min. lap length + $1\frac{1}{2}$ " + thread length

* Epoxy not required on Bar Splicer Assembly components used in conjunction with black bars.


Location	Bar size	No. assemblies required	Minimum lap length

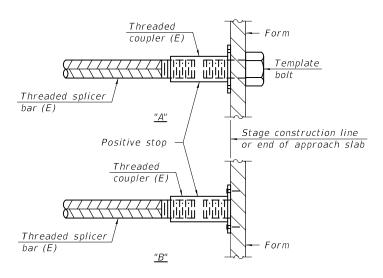

INSTALLATION AND SETTING METHODS

"A": Set bar splicer assembly by means of a template bolt "B": Set bar splicer assembly by nailing to wood forms or

cementing to steel forms.
(E): Indicates epoxy coating.

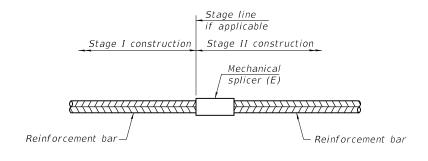

STANDARD MECHANICAL SPLICER

Location	Bar	No. assemblies
Location	size	required
Deck	#5	243
Side Walk	#5	9

Notes:

Splicer bars shall be deformed with threaded ends and have a minimum 60 ksi yield strength.

All reinforcement shall be lapped and tied to the splicer bars.


Bar splicer assemblies shall be epoxy coated according to the requirements


for reinforcement bars. See Section 508 of the Standard Specifications. See approved list of bar splicer assemblies and mechanical splicers for alternatives.

BSD-1

1-1-2020

DESIGNED - VHV	EXAMINED	I mot A All Co	DATE -	MAY 1, 2020
CHECKED - SMR		ENGINEER OF STRUCTURAL SERVICES		,
DRAWN - Venkat Reddy	PASSED	d. Carl Progrey	REVISED	-
CHECKED - VHV SMR	1	ENGINEER OF BRIDGES AND STRUCTURES	REVISED	-

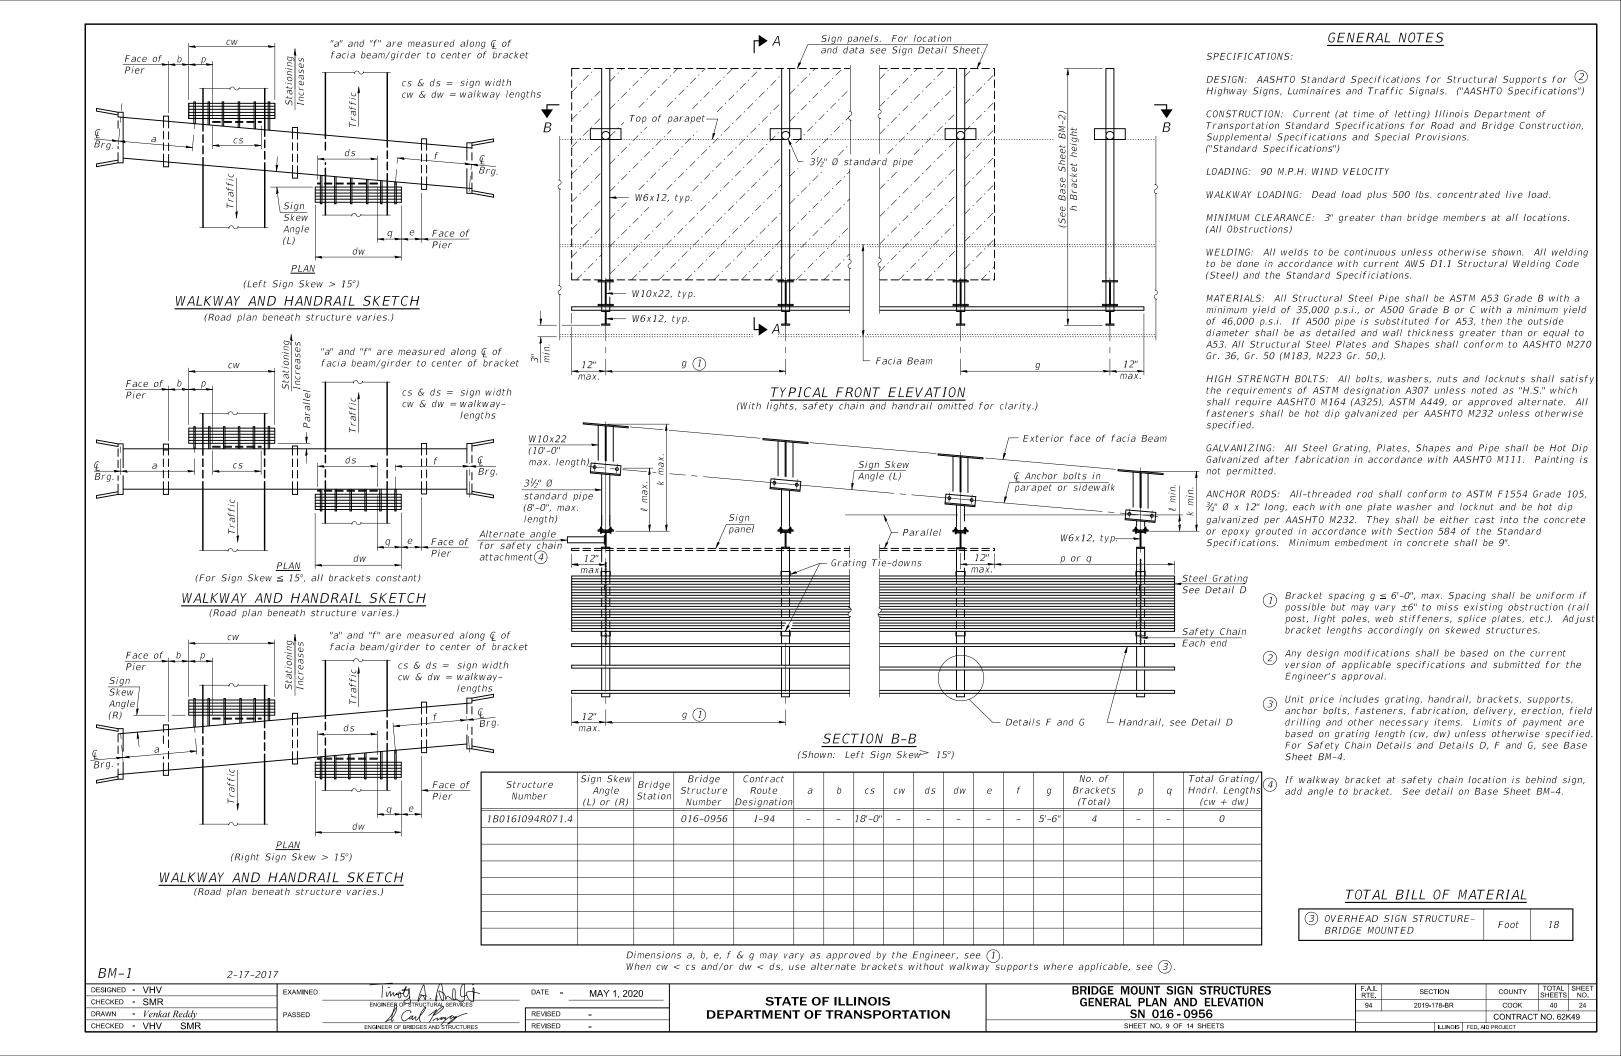

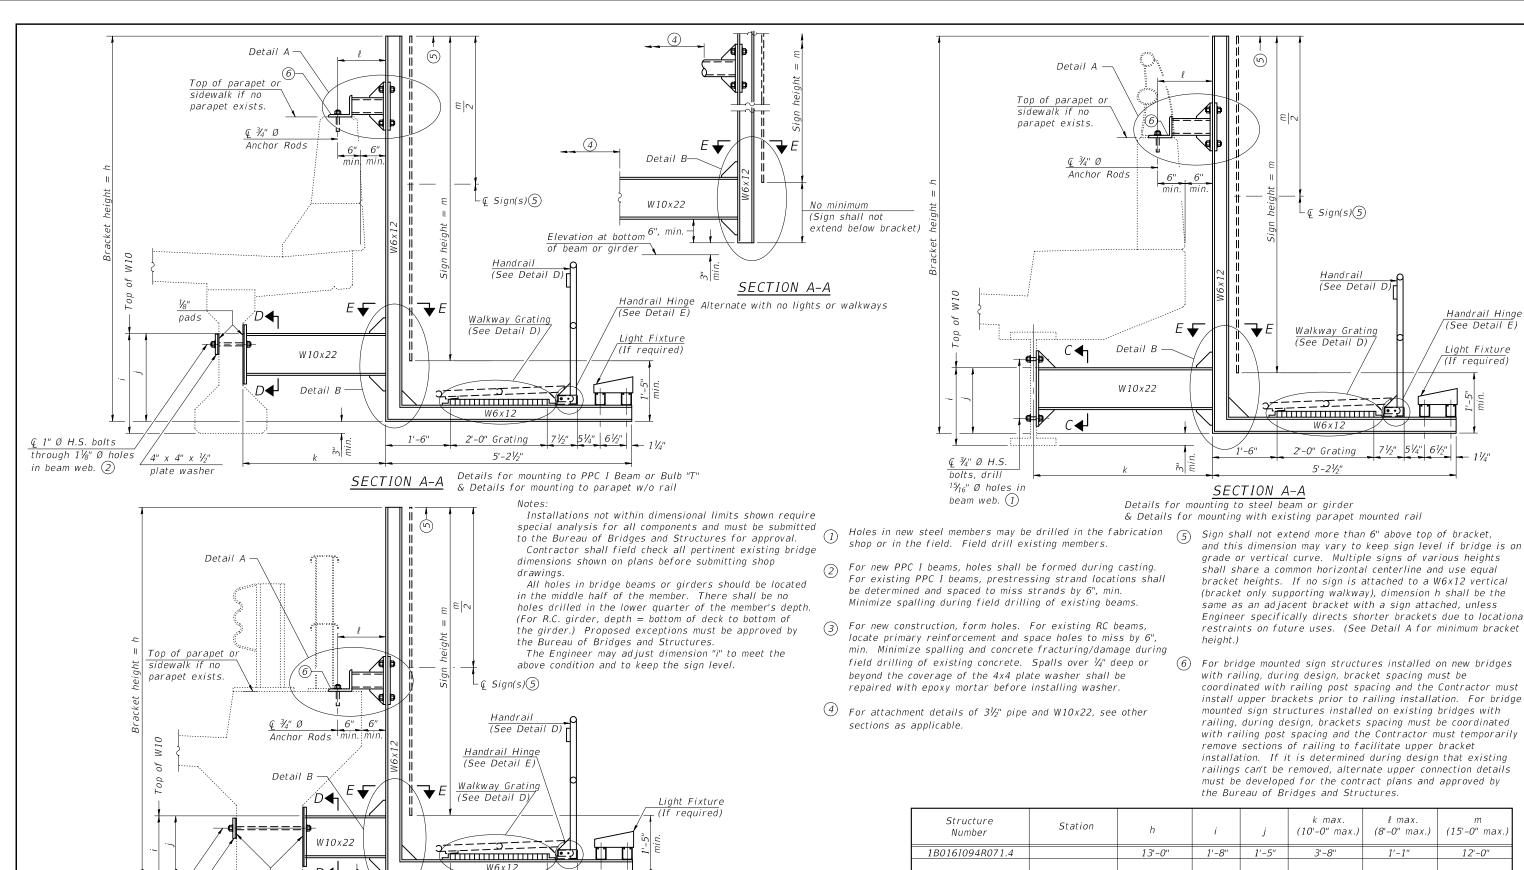

	Number	Station	h	i	j	(10'-0" max.)	(8'-0" max.)	(15'-0" max.)
	1B016I094R071.4		13'-0"	1'-8"	1'-5"	3'-8"	1'-1"	12'-0"
1-4.								

ENGINEER OF STRUCTURAL SERVICES

REVISED -

SECTION A-A

for mounting on safety curb with surface-mount bridge rail

(3) Q 1" Ø H.S. bolts

in girder.

BM-2

DESIGNED - VHV

CHECKED - SMR

DRAWN - Venkat Reddy

CHECKED - VHV SMR

through 1½" Ø holes

4" x 4" x ½"

plate washer

EXAMINED

PASSED

2-17-2017

2'-0" Grating

5'-21/3"


71/2" 51/4" 61/2"


Details for mounting to integral reinforced concrete girder & Details For Details D & E, see Base Sheet BM-


STATE OF ILLINOIS
DEPARTMENT OF TRANSPORTATION


and E-E, see Base Sheet BM-3.


For Details A & B, Sections C-C, D-D

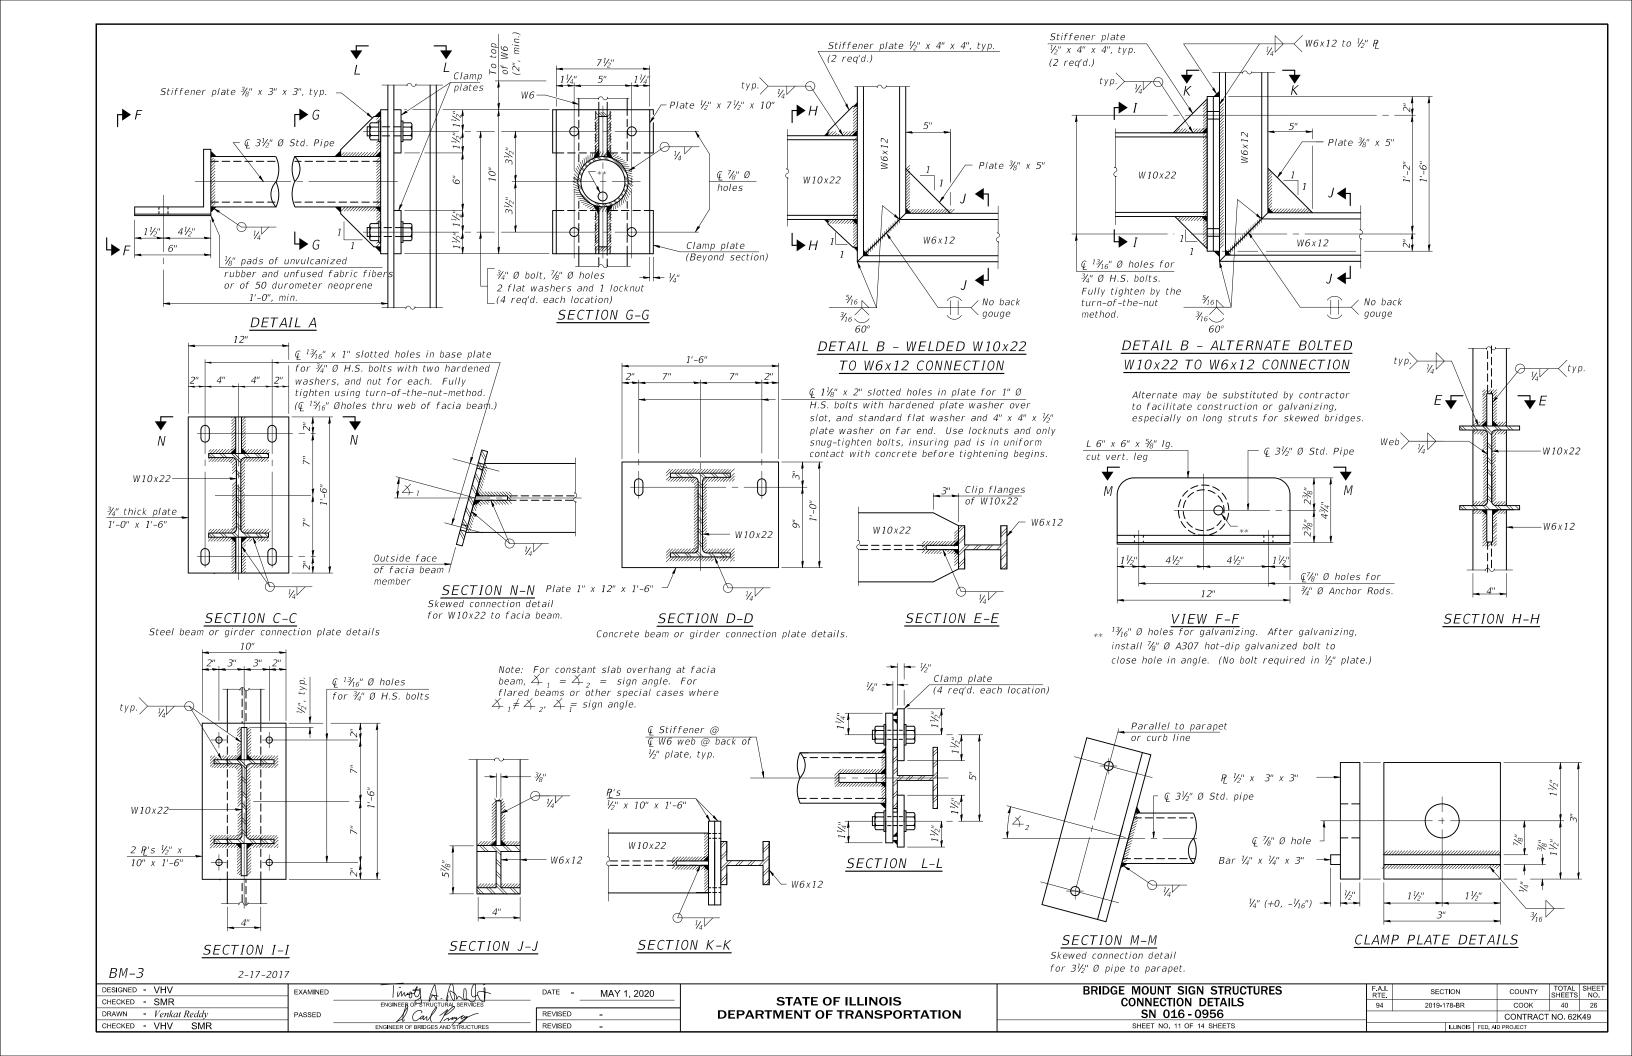


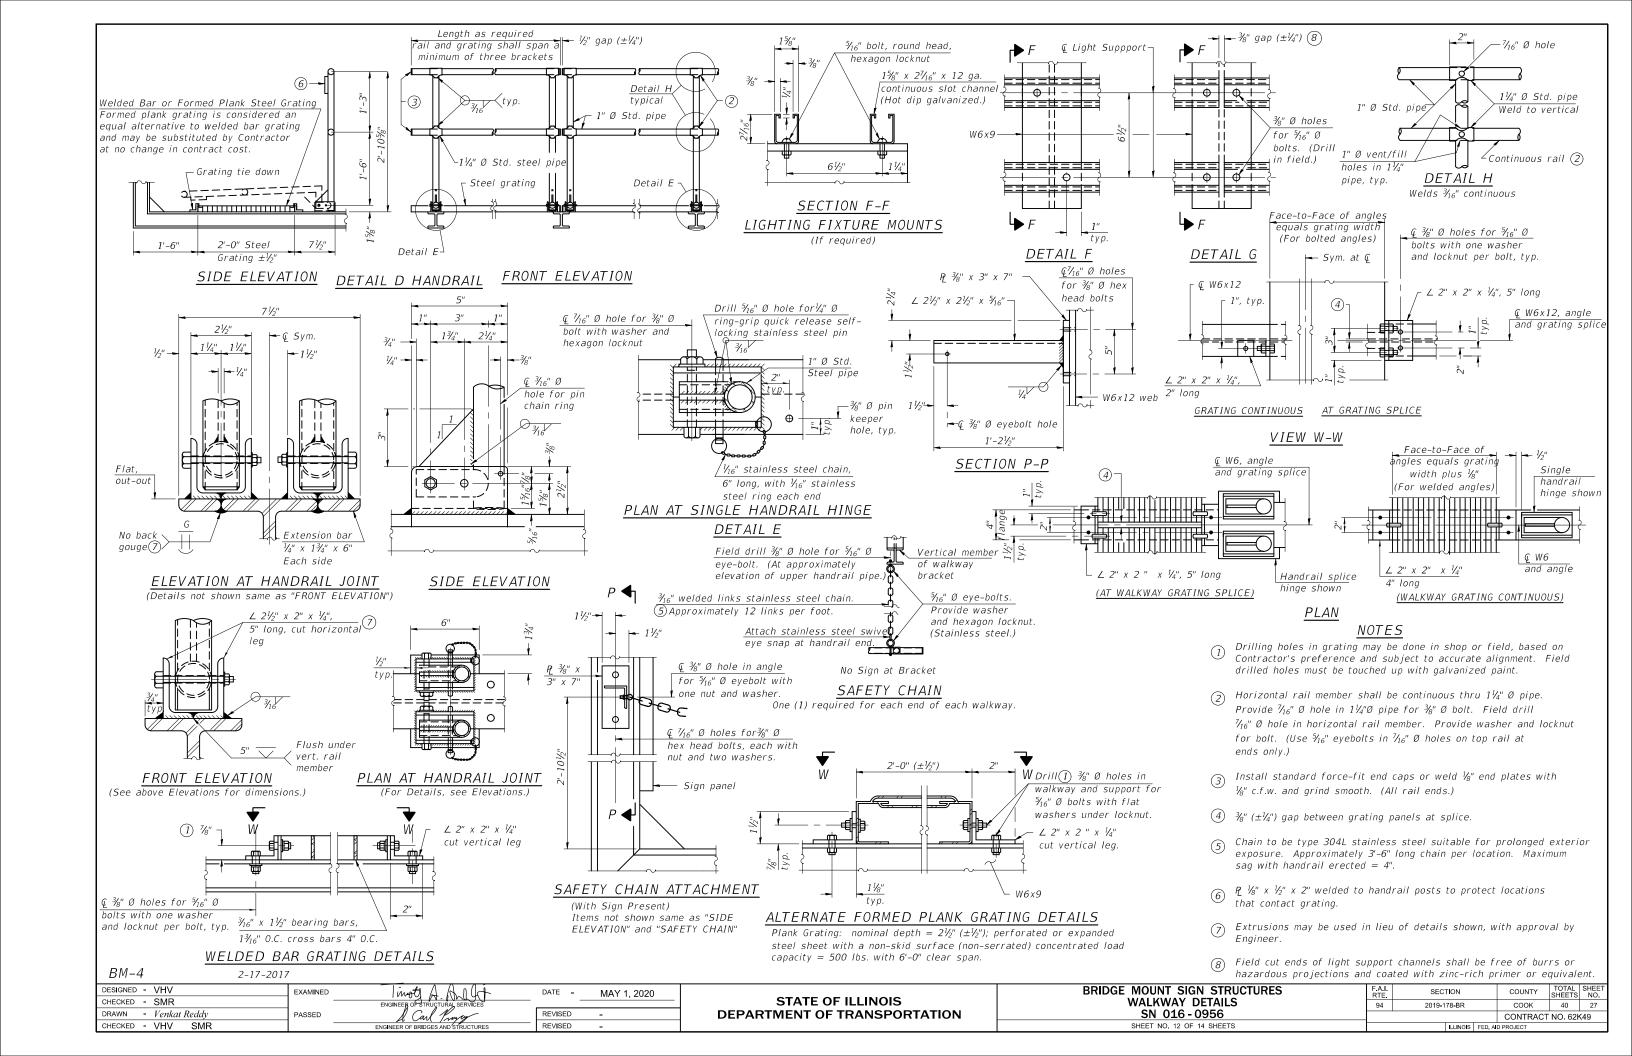

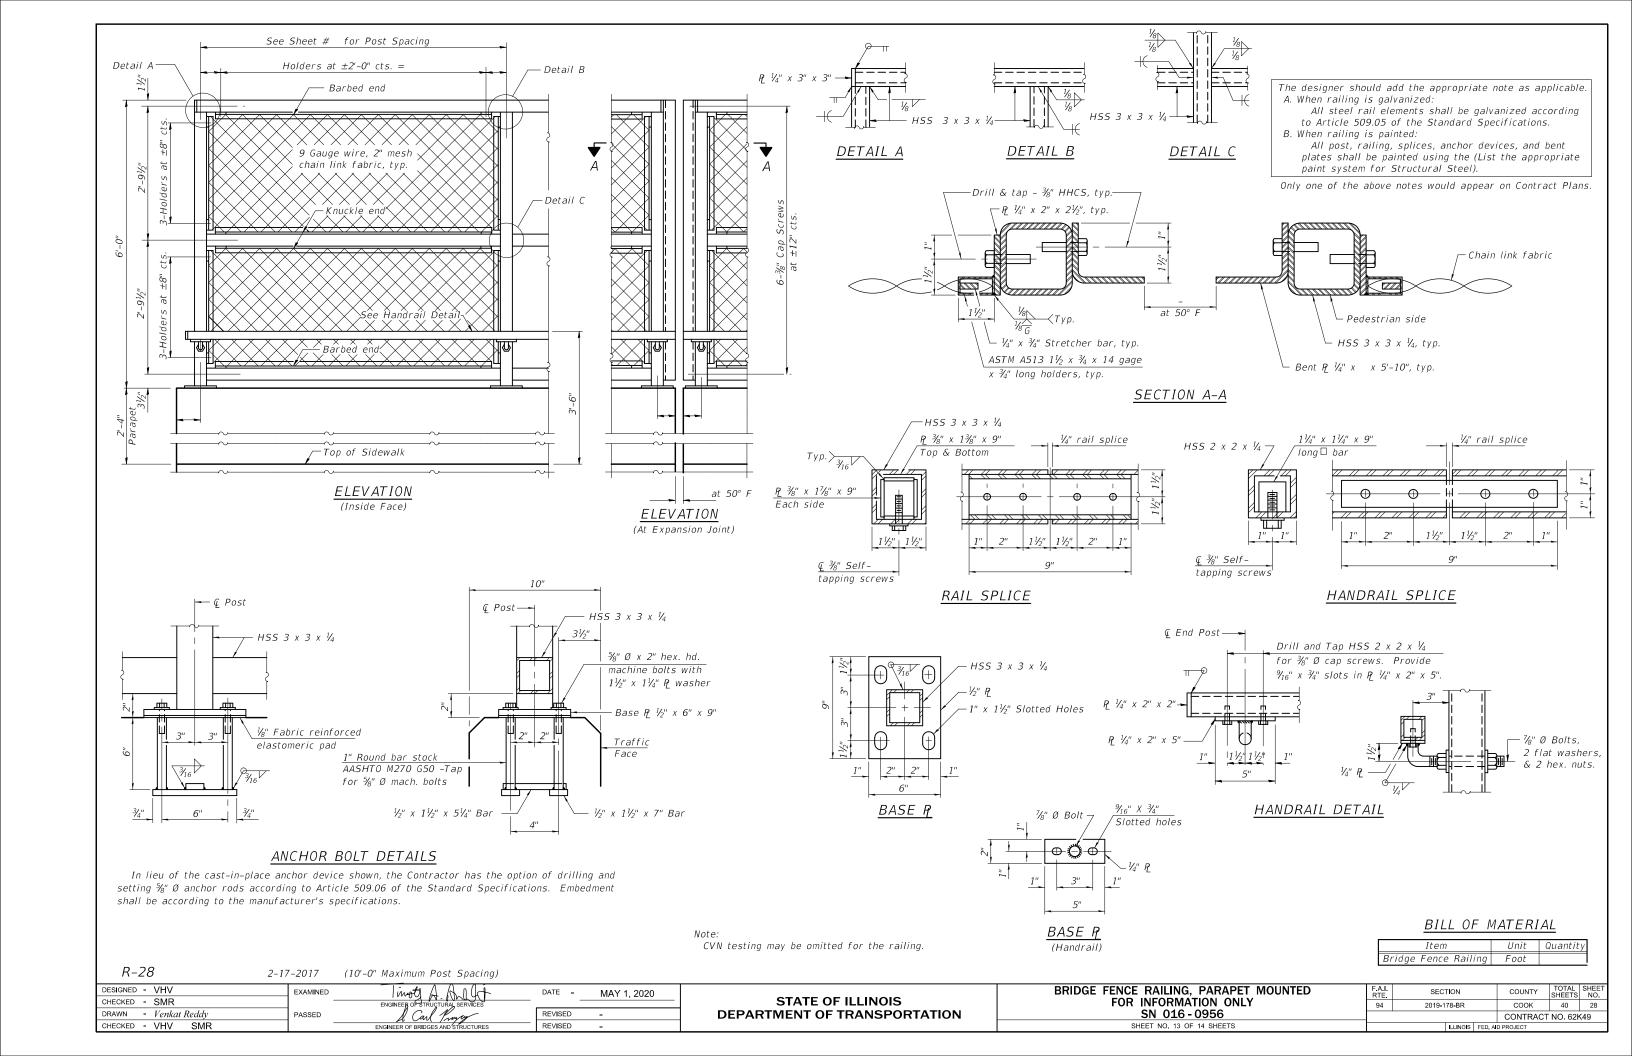

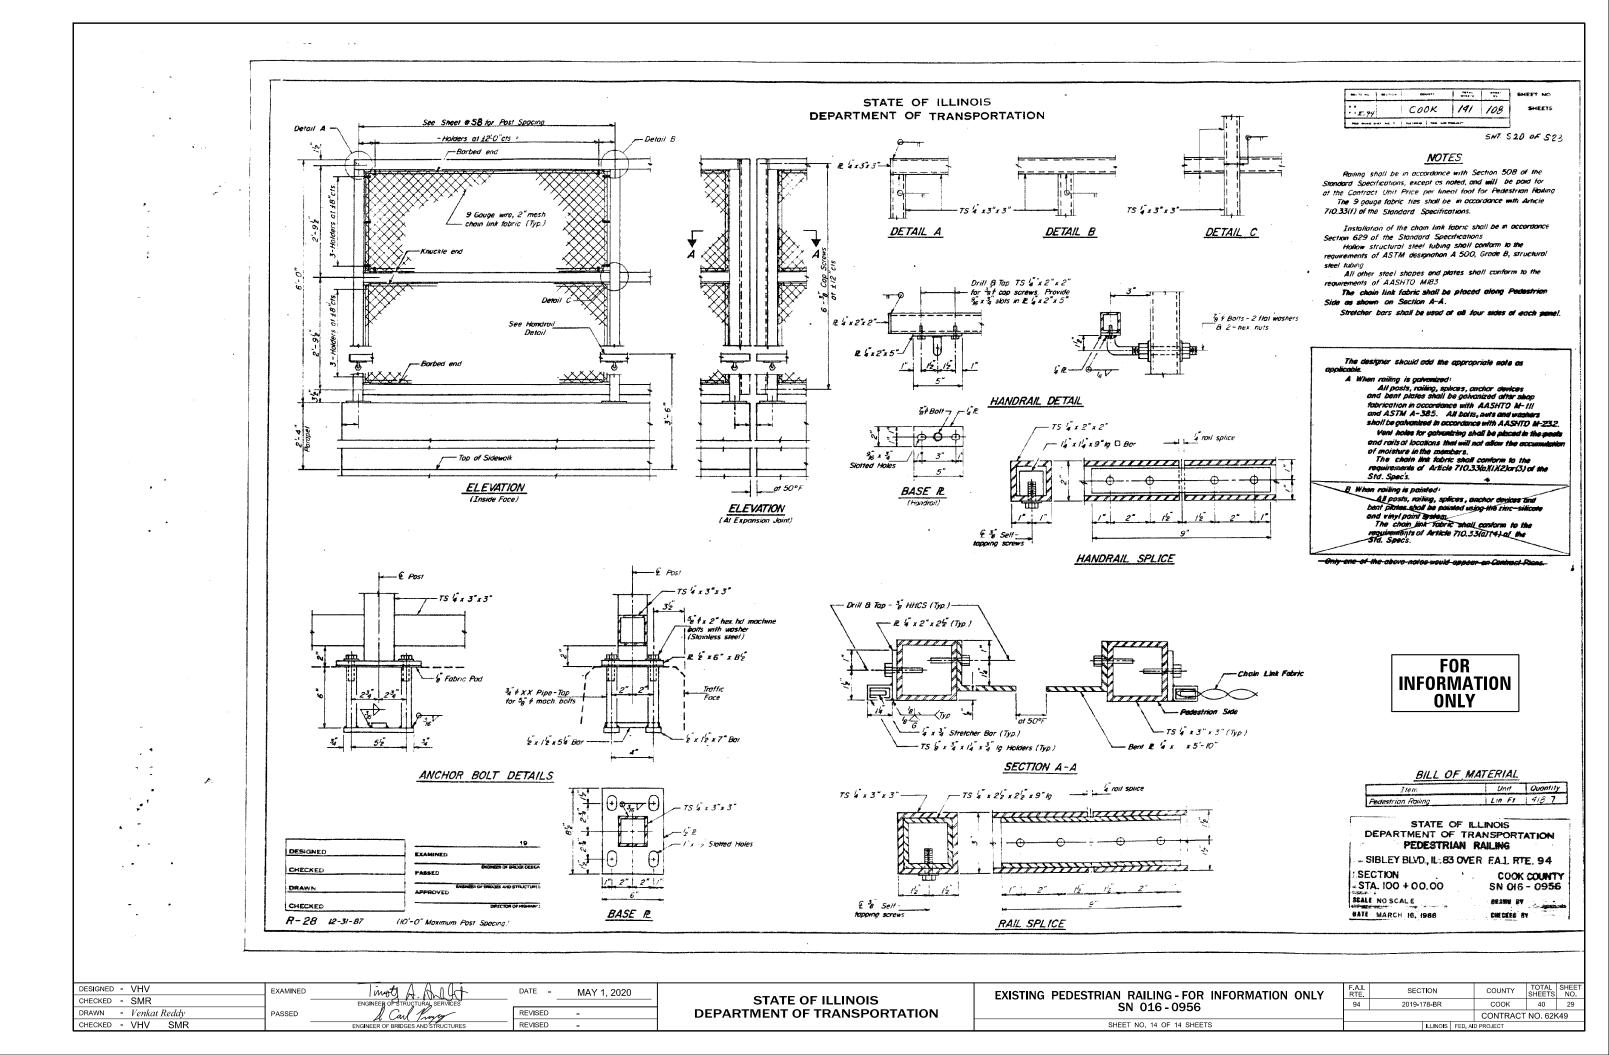

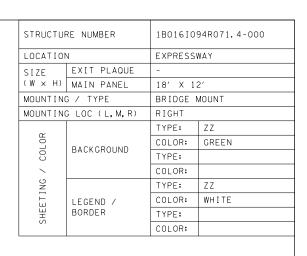

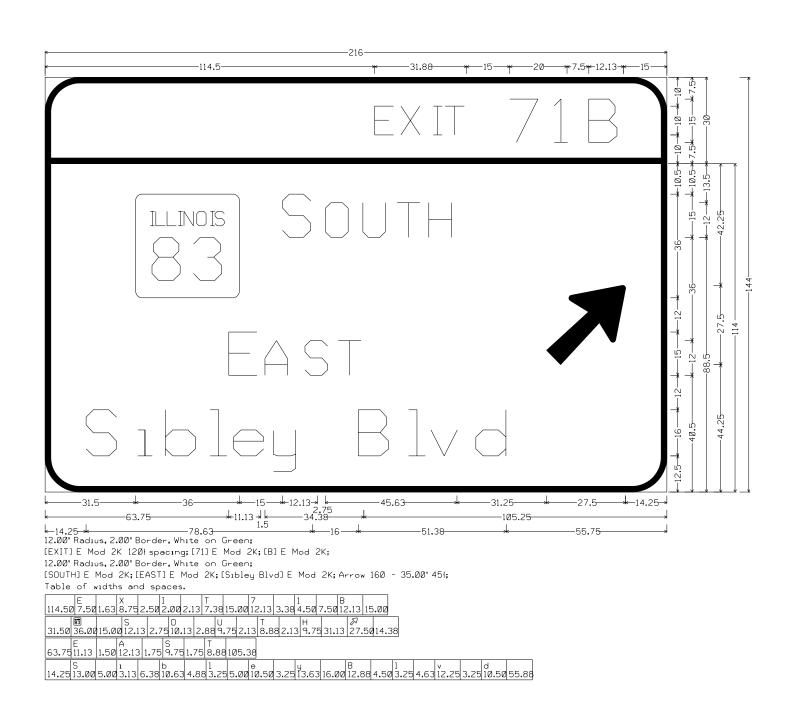



USER NAME = mkochler	DESIGNED -	LP	REVISED -
	DRAWN -	LP	REVISED -
PLOT SCALE = 40.0000 ' / in.	CHECKED -	MD	REVISED -
PLOT DATE = 3/30/2020	DATE -	02/05/2020	REVISED -

STAT	E OF	ILLINOIS
DEPARTMENT	OF	TRANSPORTATION

SCALE:

SIGN PANEL DESIGN								F.A. RTE	S	ECTION		COUNTY	TOTAL SHEETS	SHEI			
EXIT 71B							I-94	201	9-178-BR		соок	40	30				
EAII /ID										CONTRACT	NO. 62	2K49					
	SHEET	1	OF	1	SHEETS	STA.	N/A	TO STA.	N/A				ILLINOI	S FED.	AID PROJECT		

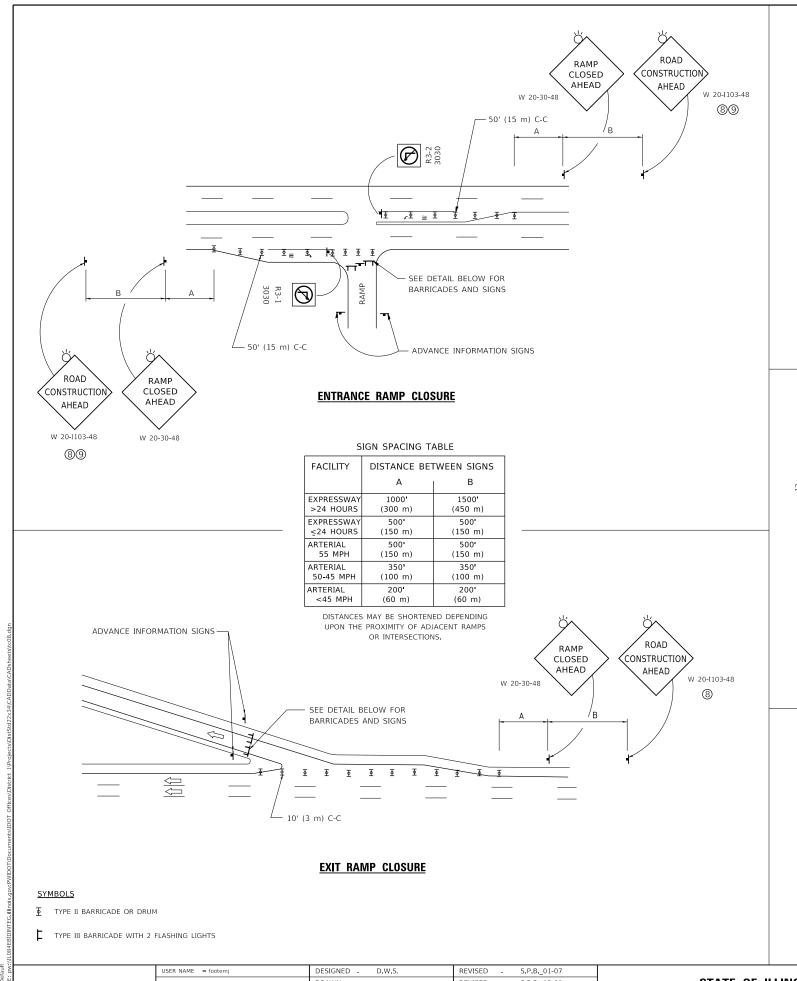

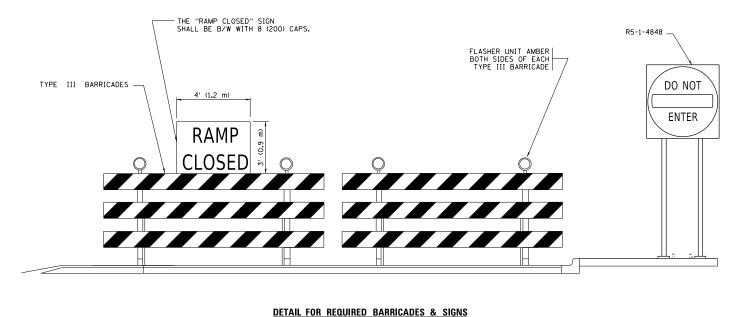


RAMP CLOSED 10' (3 m)

RAMP CLOSURE ADVANCE WARNING SIGN

BLACK LEGEND ON ORANGE BACKGROUND MOUNTED DIAGONALLY E MOD FONT 1 (25) BORDER

THESE SIGNS ARE REQUIRED ON ALL THE EXIT GUIDE SIGNS FOR EXIT RAMPS THAT WILL BE CLOSED FOR MORE THAN FOUR (4) CONSECUTIVE DAYS.

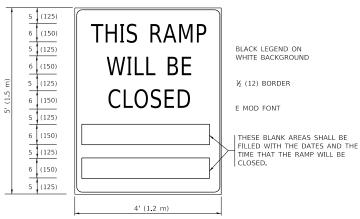

RAMP CLOSURE ADVANCE INFORMATION SIGN

THESE SIGNS ARE REQUIRED ON BOTH SIDES OF THE RAMP, MINIMUM OF 1 WEEK IN ADVANCE OF THE CLOSURE

THESE SIGNS SHALL BE FABRICATED AND PAID FOR ACCORDING TO THE TEMPORARY INFORMATION SIGNING SPECIAL PROVISION

GENERAL NOTES:

- CONES MAY BE SUBSTITUTED FOR DRUMS OR TYPE II BARRICADES DURING DAY OPERATIONS. CONES SHALL BE A MINIMUM OF 28 (700) HIGH.
- (2) VERTICAL BARRICADES SHALL NOT BE USED FOR RAMP CLOSURES.
- 3 A FLAGGER SHALL BE POSITIONED AT EACH CLOSED RAMP THAT IS OPEN TO CONSTRUCTION VEHICLES, PRECEEDED BY A W20-7 FLAGGER WARNING SIGN.
- 4 ALL ROUTE MARKERS AND TRAILBLAZER ASSEMBLIES WHICH DIRECT MOTORISTS TO A CLOSED ENTRANCE RAMP SHALL BE COVERED WHEN THE RAMP IS CLOSED FOR MORE THAN FOUR (4) DAYS.
- THE SIGNING AND BARRICADING WHICH IS REQUIRED BY THIS DETAIL SHALL BE INCLUDED IN THE COST OF TRAFFIC CONTROL AND PROTECTION (EXPRESSWAYS).

- 6 AUTHORIZATION FROM THE DISTRICT'S BUREAU OF TRAFFIC IS REQUIRED FOR ALL RAMP CLOSURES.
- THE RAMP CLOSURE ADVANCE INFORMATION SIGNS SHALL BE ERECTED IF THE CLOSURE TIME EXCEEDS TWENTY-FOUR (24) HOURS. ADDITIONAL ADVANCE WARNING SIGNS ON EXIT GUIDE SIGNING WILL BE REQUIRED FOR EXIT RAMP CLOSURES THAT EXCEED FOUR (4) DAYS IN LENGTH
- (8) ROAD CONSTRUCTION AHEAD SIGNS MAY BE OMITTED WHEN THIS DETAIL IS USED IN CONJUNCTION WITH OTHER TRAFFIC CONTROL THAT ALREADY INCLUDES A ROAD CONSTRUCTION AHEAD SIGN.
- ARTERIAL ROAD CONSTRUCTION AHEAD SIGNS SHALL BE INSTALLED ON THE LEFT SIDE OF TRAFFIC IF THE MEDIAN IS MORE THAN 10 FT WIDE.

ALL DIMENSIONS ARE IN INCHES (MILLIMETERS)
UNLESS OTHERWISE SHOWN.


DRAWN REVISED S.P.B. 12-09 HECKED REVISED M.D._06-13


STATE OF ILLINOIS

ENTRANCE AND EXIT RAMP -94 **CLOSURE DETAILS**

SECTION 2019-178-BR COOK 40 31 CONTRACT NO. 62K49

DEPARTMENT OF TRANSPORTATION SCALE: NONE SHEET 1 OF 1 SHEETS STA M.D. 01-18 TO STA. LOT DATE = 3/4/2019 DATE REVISED

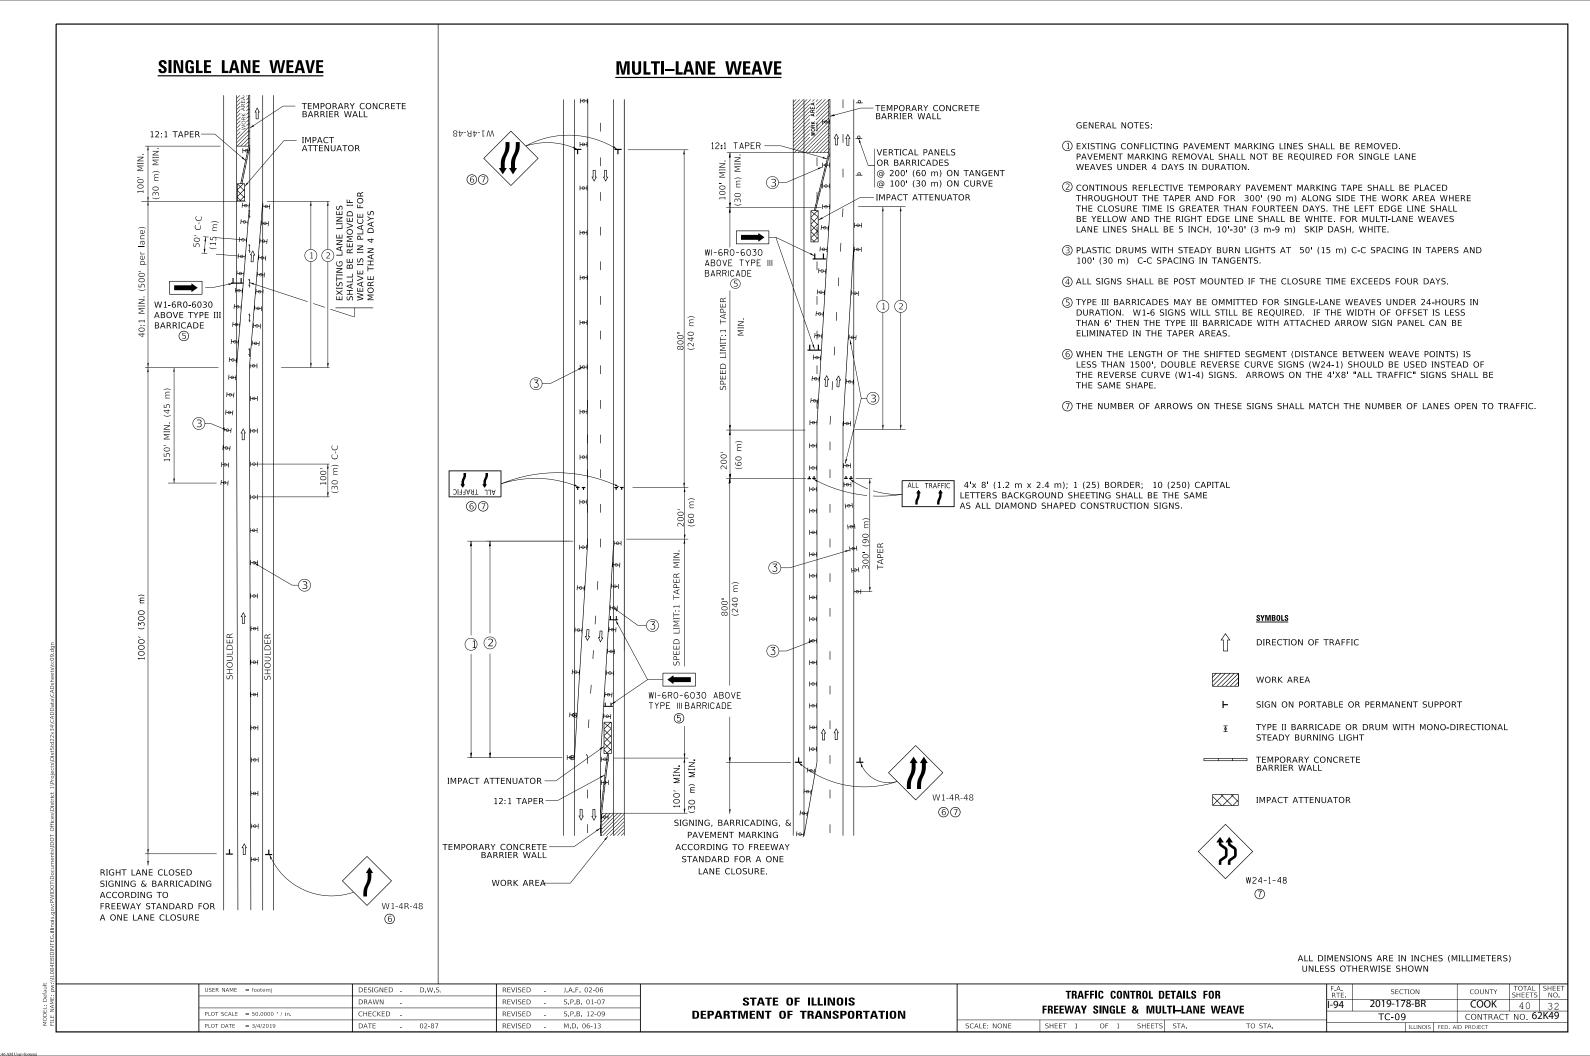

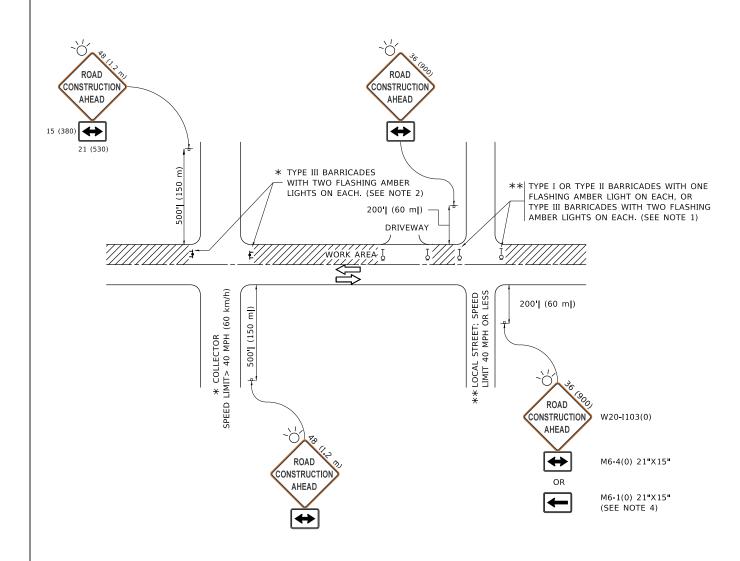

NOTES:

- 1. SIDE ROAD WITH A SPEED LIMIT OF 40 MPH (60 km/h) OR LESS AS SHOWN ON THE DRAWING AND AS DIRECTED BY THE ENGINEER:
- a) ONE "ROAD CONSTRUCTION AHEAD" SIGN 36 x 36 (900x900) WITH A FLASHER MOUNTED ON IT APPROXIMATELY 200' (60 m) IN ADVANCE OF THE MAIN ROUTE.
- b) THE CLOSED PORTION OF THE MAIN ROUTE SHALL BE PROTECTED BY BLOCKING WITH TYPE I, TYPE II OR TYPE III BARRICADES, 1/3 OF THE CROSS SECTION OF THE CLOSED PORTION.
- SIDE ROAD WITH A SPEED LIMIT GREATER THAN 40 MPH (60 km/h) AS SHOWN ON THE DRAWING AND AS DIRECTED BY THE ENGINEER:
- a) ONE "ROAD CONSTRUCTION AHEAD" SIGN 48 x 48 (1.2 m x 1.2 m) WITH A FLASHER MOUNTED ON IT APPROXIMATELY 500' (150 m) IN ADVANCE OF THE MAIN ROUTE.
- THE CLOSED PORTION OF THE MAIN ROUTE SHALL BE PROTECTED BY
 b) BLOCKING WITH TYPE III BARRICADES, 1/2 OF THE CROSS SECTION
 OF THE CLOSED PORTION.
- 3. CONES MAY BE SUBSTITUTED FOR BARRICADES OR DRUMS AT HALF THE SPACING DURING DAY OPERATIONS. CONES SHALL BE A MINIMUM OF 28 (710)

 IN HEIGHT
- WHEN THE SIDE ROAD LIES BETWEEN THE BEGINNING OF THE MAINLINE
 4. SIGNING AND THE WORK ZONE, A SINGLE HEADED ARROW (M6-1) SHALL
 BE USED IN LIEU OF THE DOUBLE HEADED ARROW (M6-4).

- WHEN WORK IS BEING PERFORMED ON A SIDE ROAD OR DRIVEWAY, FOLLOW THE APPLICABLE STANDARD(S). THE DIRECTIONAL ARROW (M6-1 OR M6-4) SHALL BE COVERED OR REMOVED WHEN NO LONGER CONSISTENT WITH THE TRAFFIC CONTROL SET-UP.
- 6. ADVANCE WARNING SIGNS ARE TO BE OMITTED ON DRIVEWAYS UNLESS OTHERWISE SPECIFIED IN THE PLANS OR BY THE ENGINEER
- 7. THE TRAFFIC CONTROL AND PROTECTION FOR SIDE ROADS, INTERSECTIONS, AND DRIVEWAYS SHALL BE INCLUDED IN THE COST OF SPECIFIED TRAFFIC CONTROL STANDARDS OR ITEMS.

All dimensions are in inches (millimeters) unless otherwise shown.


USER NAME = footemj	DESIGNED - L.H.A.	REVISED	- A. HOUSEH 10-15-96
	DRAWN -	REVISED	- T. RAMMACHER 01-06-00
PLOT SCALE = 50.0000 ' / in.	CHECKED -	REVISED	- A. SCHUETZE 07-01-13
PLOT DATE = 3/4/2019	DATE - 06-89	REVISED	_ A. SCHUETZE 09-15-16


STATE OF ILLINOIS
DEPARTMENT OF TRANSPORTATION


TRAFFIC CONTROL AND PROTECTION FOR SIDE ROADS, INTERSECTIONS, AND DRIVEWAYS


| SHEET 1 OF 1 SHEETS STA. TO STA.

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TYPE OF MARKING	WIDTH OF LINE	PATTERN	COLOR	SPACING / REMARKS
CENTERLINE ON 2 LANE PAVEMENT	4 (100)	SKIP-DASH	YELLOW	10' (3 m) LINE WITH 30' (9 m) SPACE
CENTERLINE ON MULTI-LANE UNDIVIDED PAVEMENT	2 @ 4 (100)	SOLID	YELLOW	11 (280) C-C
NO PASSING ZONE LINES: FOR ONE DIRECTION FOR BOTH DIRECTIONS	4 (100) 2 @ 4 (100)	SOLID SOLID	YELLOW YELLOW	5½ (140) C-C FROM SKIP-DASH CENTERLINE 11 (280) C-C OMIT SKIP-DASH CENTERLINE BETWEEN
LANE LINES	4 (100) 5 (125) ON FREEWAYS	SKIP-DASH SKIP-DASH	WHITE WHITE	10' (3 m) LINE WITH 30' (9 m) SPACE
DOTTED LINES (EXTENSIONS OF CENTER, LANE OR TURN LANE MARKINGS)	SAME AS LINE BEING EXTENDED	SKIP-DASH	SAME AS LINE BEING EXTENDED	2' (600) LINE WITH 6' (1.8 m) SPACE
EDGE LINES	4 (100)	SOLID	YELLOW-LEFT WHITE-RIGHT	OUTLINE MEDIANS IN YELLOW
TURN LANE MARKINGS	6 (150) LINE; FULL SIZE LETTERS & SYMBOLS (8' (2.4m))	SOLID	WHITE	SEE TYPICAL TURN LANE MARKING DETAIL
TWO WAY LEFT TURN MARKING	2 @ 4 (100) EACH DIRECTION 8' (2.4m) LEFT ARROW	SKIP-DASH AND SOLID IN PAIRS	YELLOW	10' (3 m) LINE WITH 30' (9 m) SPACE FOR SKIP-DASH; 5½ (140) C-C BETWEEN SOLID LINE AND SKIP-DASH LINE SEE TYPICAL TWO-WAY LEFT TURN MARKING DETAIL
CROSSWALK LINES (PEDESTRIAN) A. DIAGONALS (BIKE & EQUESTRIAN) B. LONGITUDINAL BARS (SCHOOL)	2 @ 6 (150) 12 (300) @ 45° 12 (300) @ 90°	SOLID SOLID SOLID	WHITE WHITE WHITE	NOT LESS THAN 6' (1.8 m) APART 2' (600) APART 2' (600) APART SEE TYPICAL CROSSWALK MARKING DETAILS.
STOP LINES	24 (600)	SOLID	WHITE	PLACE 4" (1.2 m) N ADVANCE OF AND PARALLEL TO CROSSWALK, IF PRESENT, OTHERWISE, PLACE AT DESIGNED STOPPING POINT, PARALLEL TO CROSSROAD CENTERLINE, WHERE POSSIBLE
PAINTED MEDIANS	2 @ 4 (100) WITH 12 (300) DIAGONALS @ 45° NO DIAGONALS USED FOR 4' (1.2 m) WIDE MEDIANS	SOLID	YELLOW: TWO WAY TRAFFIC WHITE: ONE WAY TRAFFIC	11 (280) C-C FOR THE DOUBLE LINE SEE TYPICAL PAINTED MEDIAN MARKING.
GORE MARKING AND CHANNELIZING LINES	8 (200) WITH 12 (300) DIAGONALS @ 45°	SOLID	WHITE	DIAGONALS: 15' (4.5 m) C-C (LESS THAN 30MPH (50 km/h)) 20' (6 m) C-C 30MPH (50 km/h) TO 45MPH (70 km/h)) 30' (9 m) C-C (OVER 45MPH (70 km/h))
RAILROAD CROSSING	24 (600) TRANSVERSE LINES; "RR" IS 6' (1.8 m) LETTERS; 16 (400) LINE FOR "X"	SOLID	WHITE	SEE STATE STANDARD 780001 AREA OF: "R"=3.6 SQ. FT. (0.33 m PEACH "X"=54.0 SQ. FT. (5.0 m P
SHOULDER DIAGONALS (REQUIRED FOR SHOULDERS > 8')	12 (300) @ 45°	SOLID	WHITE - RIGHT YELLOW - LEFT	50' (15 m) C-C (LESS THAN 30MPH (50 km/h)) 75' (25 m) C-C (30 MPH (50 km/h) TO 45MPH (70 km/h)) 150' (45 m) C-C (OVER 45MPH (70 km/h))
U TURN ARROW	SEE DETAIL	SOLID	WHITE	16.3 SF
2 ARROW COMBINATION LEFT AND U TURN	SEE DETAIL	SOLID	WHITE	30.4 SF

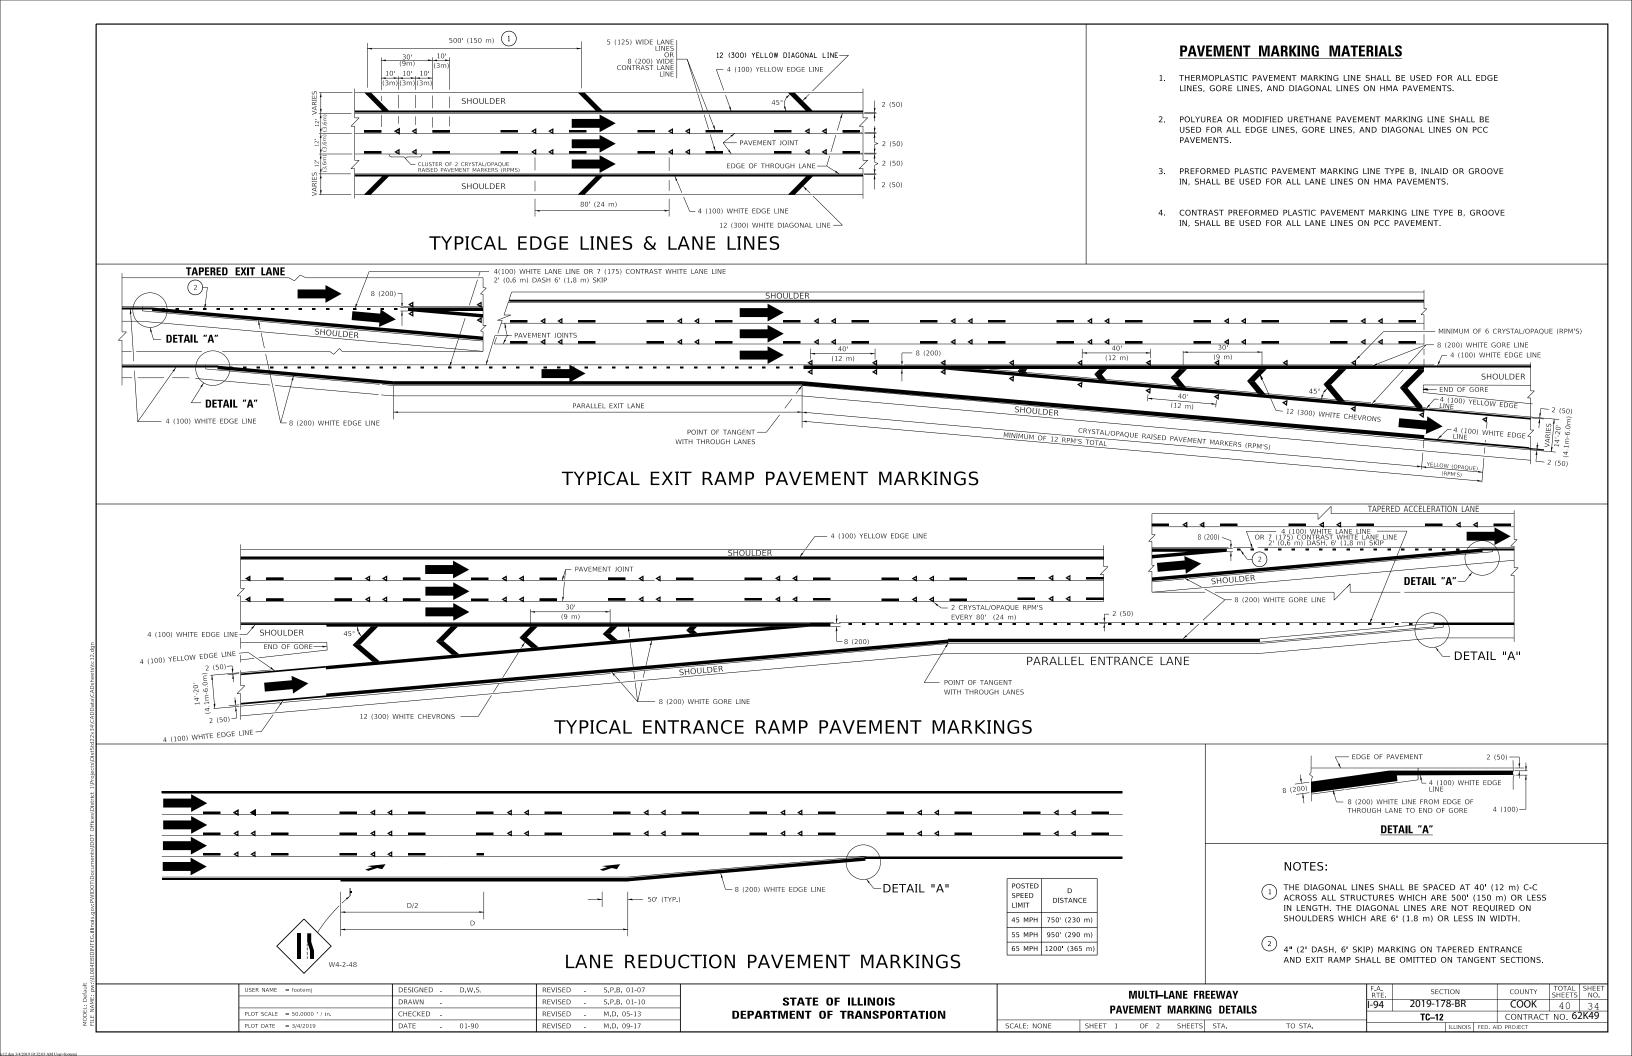FOR FURTHER DETAILS ON PAVEMENT MARKING REFER TO STANDARD SPECIFICATIONS FOR ROAD AND BRIDGE CONSTRUCTION AND STATE STANDARD 780001.

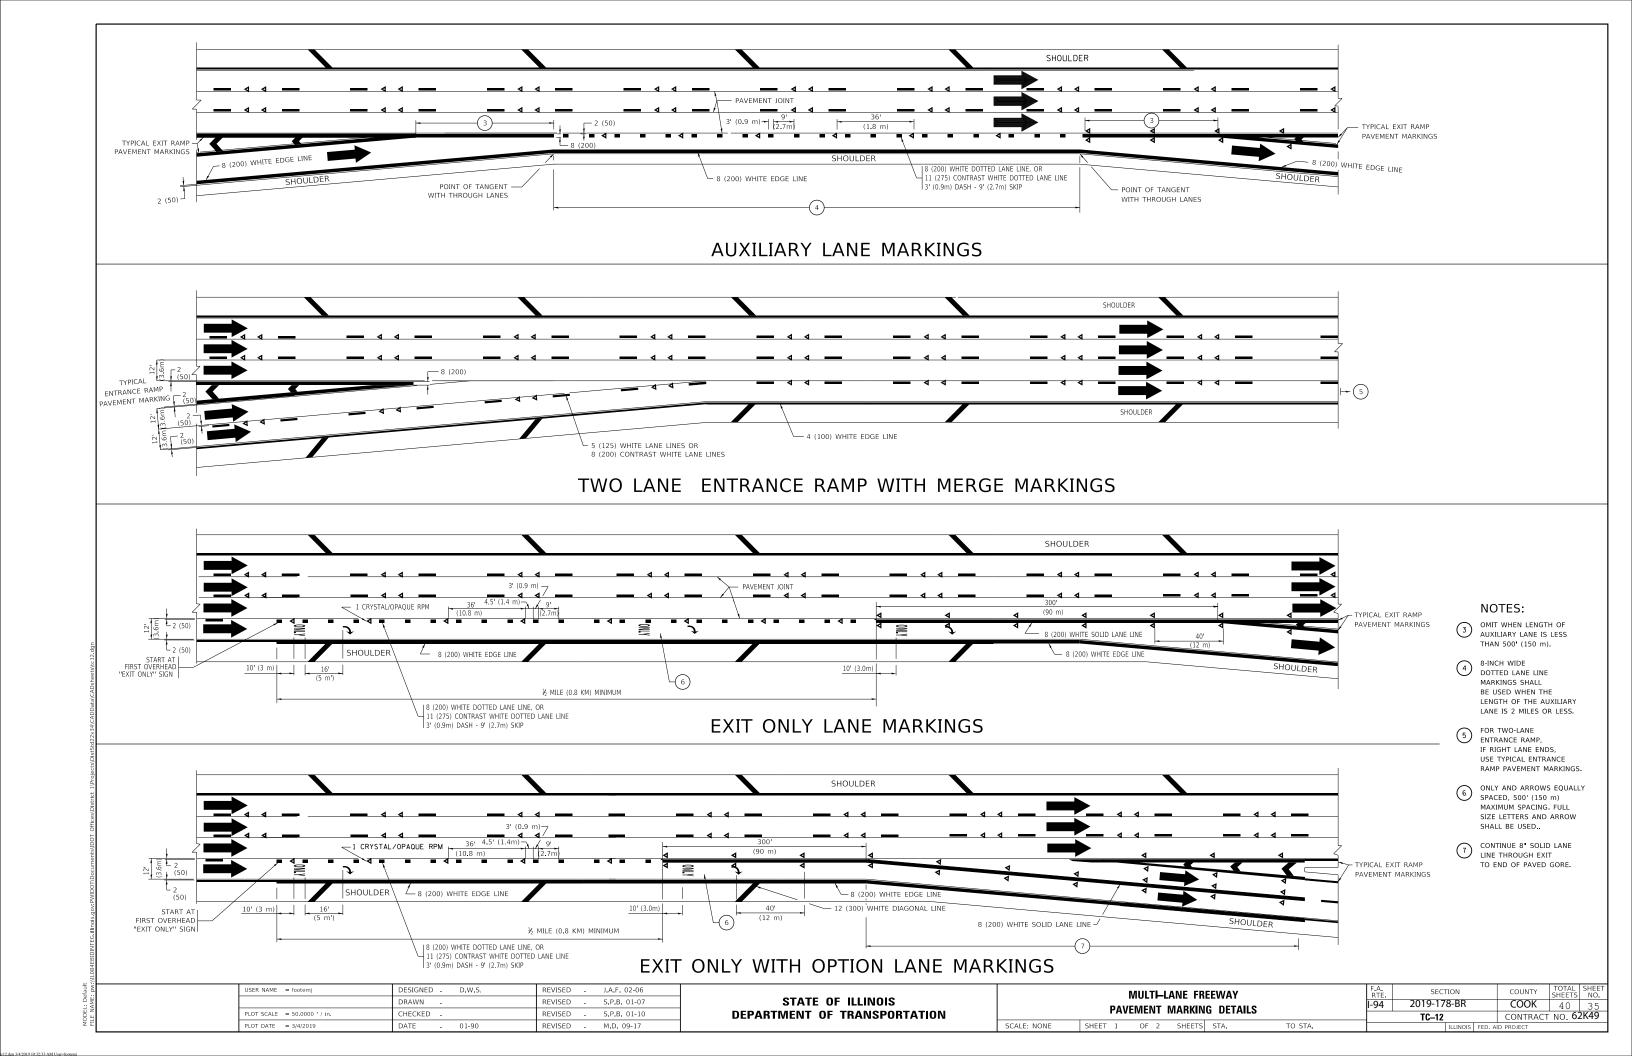SCALE: NONE

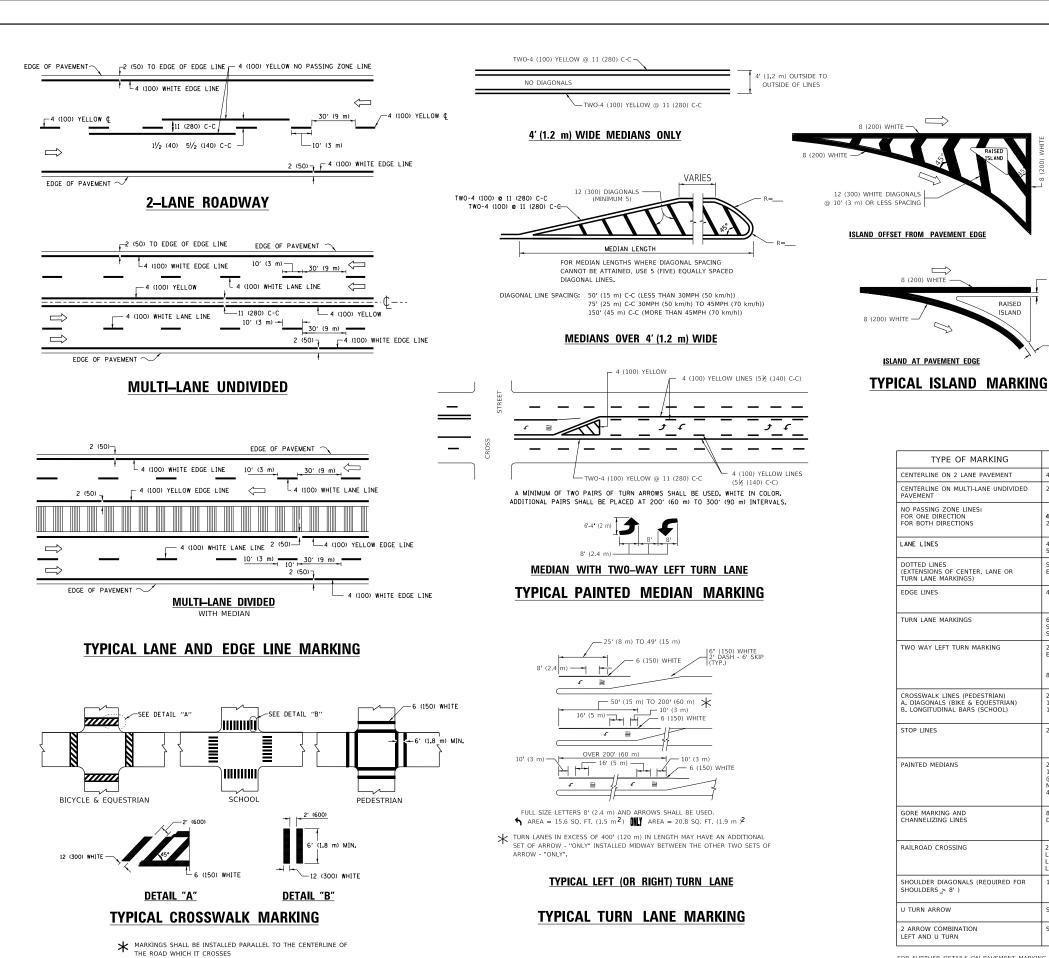
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All dimensions are in inches (millimeters) unless otherwise shown.

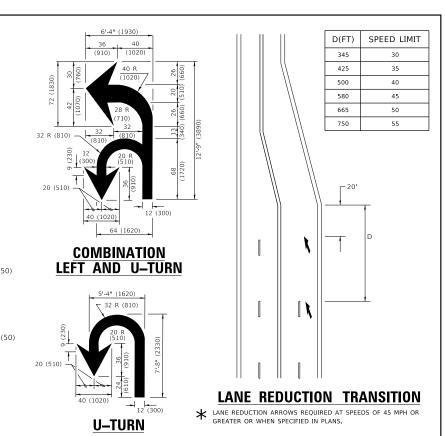JSER NAME = footemj EVERS DESIGNED -C. JUCIUS 09-09-09 DRAWN REVISED C. JUCIUS 07-01-13 HECKED REVISED -DATE


STATE OF ILLINOIS **DEPARTMENT OF TRANSPORTATION**

	DISTRICT ONE TYPICAL PAVEMENT MARKINGS					F.A. RTE	SECTION	COUNTY	TOTAL SHEETS	SHEE NO.	
						I-94	2019-178-BR	COOK	40	36	
							TC-13	CONTRACT	NO. 62	2K49	
	SHEET	1	OF 2	SHEETS	STA.	TO STA.		ILLINOIS FED. A	ID PROJECT		

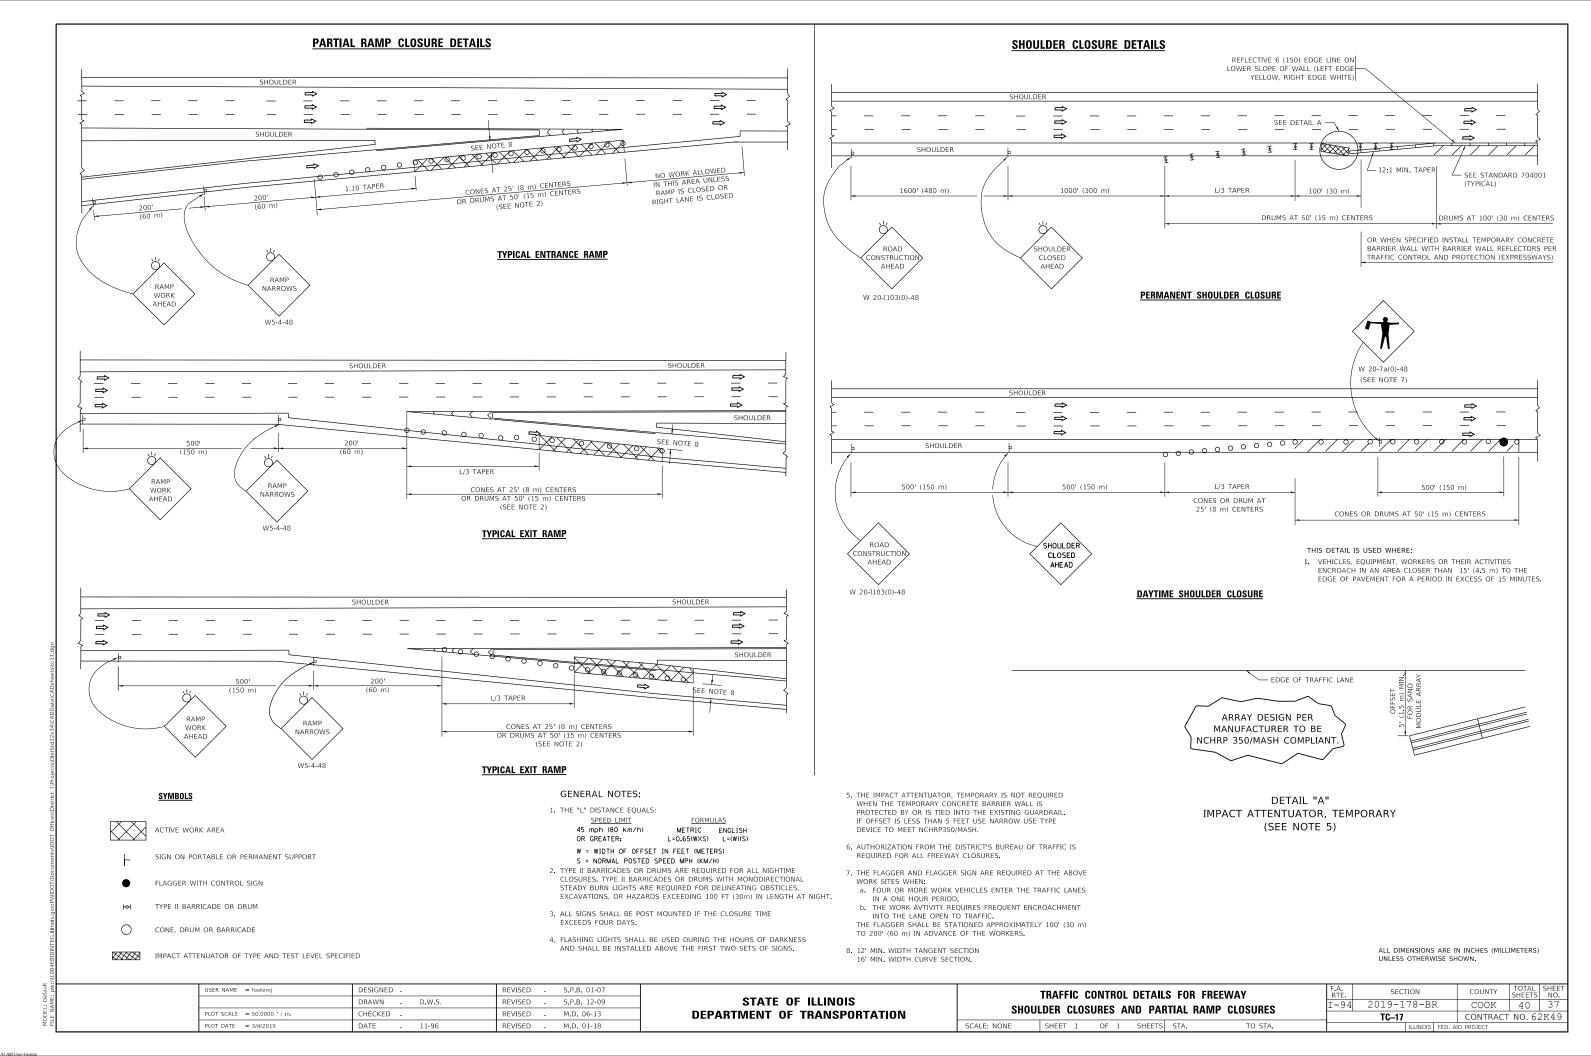


SIGNING FOR FLAGGING OPERATIONS AT WORK ZONE OPENINGS

WORK ZONE EXIT OPENING

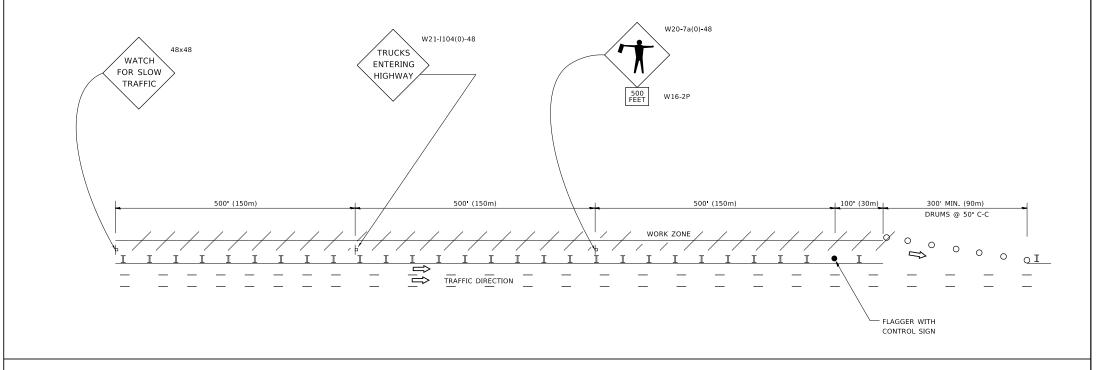

WORK ZONE ENTRY OPENING

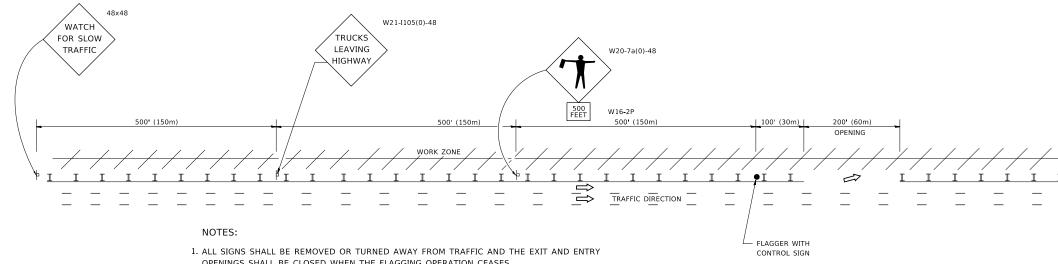


- OPENINGS SHALL BE CLOSED WHEN THE FLAGGING OPERATION CEASES. NON OPERATING EQUIPMENT SHALL COMPLY WITH ARTICLE 701.11
- 2. WORK ZONE OPENINGS SHALL BE A MINIMUM OF ONE HALF MILE APART AND A MINIMUM OF ONE QUARTER MILE FROM ALL ENTRANCE AND EXIT RAMPS.
- 3. EXITING THE WORK ZONE AT ANY PLACE OTHER THAN AT A WORK ZONE EXIT OPENING WILL BE PROHIBITED.
- 4. ALL VEHICLES SHALL ENTER THE WORK ZONE AT ENTRY OPENINGS, USING THEIR TURN SIGNALS TO WARN MOTORISTS
- 5. FLAGGERS SHALL NOT STOP TRAFFIC OR DIRECT TRAFFIC INTO AN ADJACENT LANE.


ALL DIMENSIONS ARE IN INCHES (MILLIMETERS) UNLESS OTHERWISE SHOWN

JSER NAME = footemj DESIGNED -J.A.F. 02-06 REVISED -DRAWN REVISED S.P.B. 01-07 CHECKED REVISED -S.P.B. 12-09 PLOT DATE = 3/4/2019 M.D.06-13 DATE REVISED -

STATE OF ILLINOIS **DEPARTMENT OF TRANSPORTATION** FREEWAY /EXPRESSWAY SIGNING FOR FLAGGING OPERATIONS AT WORK ZONE OPENINGS ON FREEWAYS /EXPRESSWAYS SHEET 1 OF 1 SHEETS STA.

-94 COOK 40 38 TC-18 CONTRACT NO. 62K49

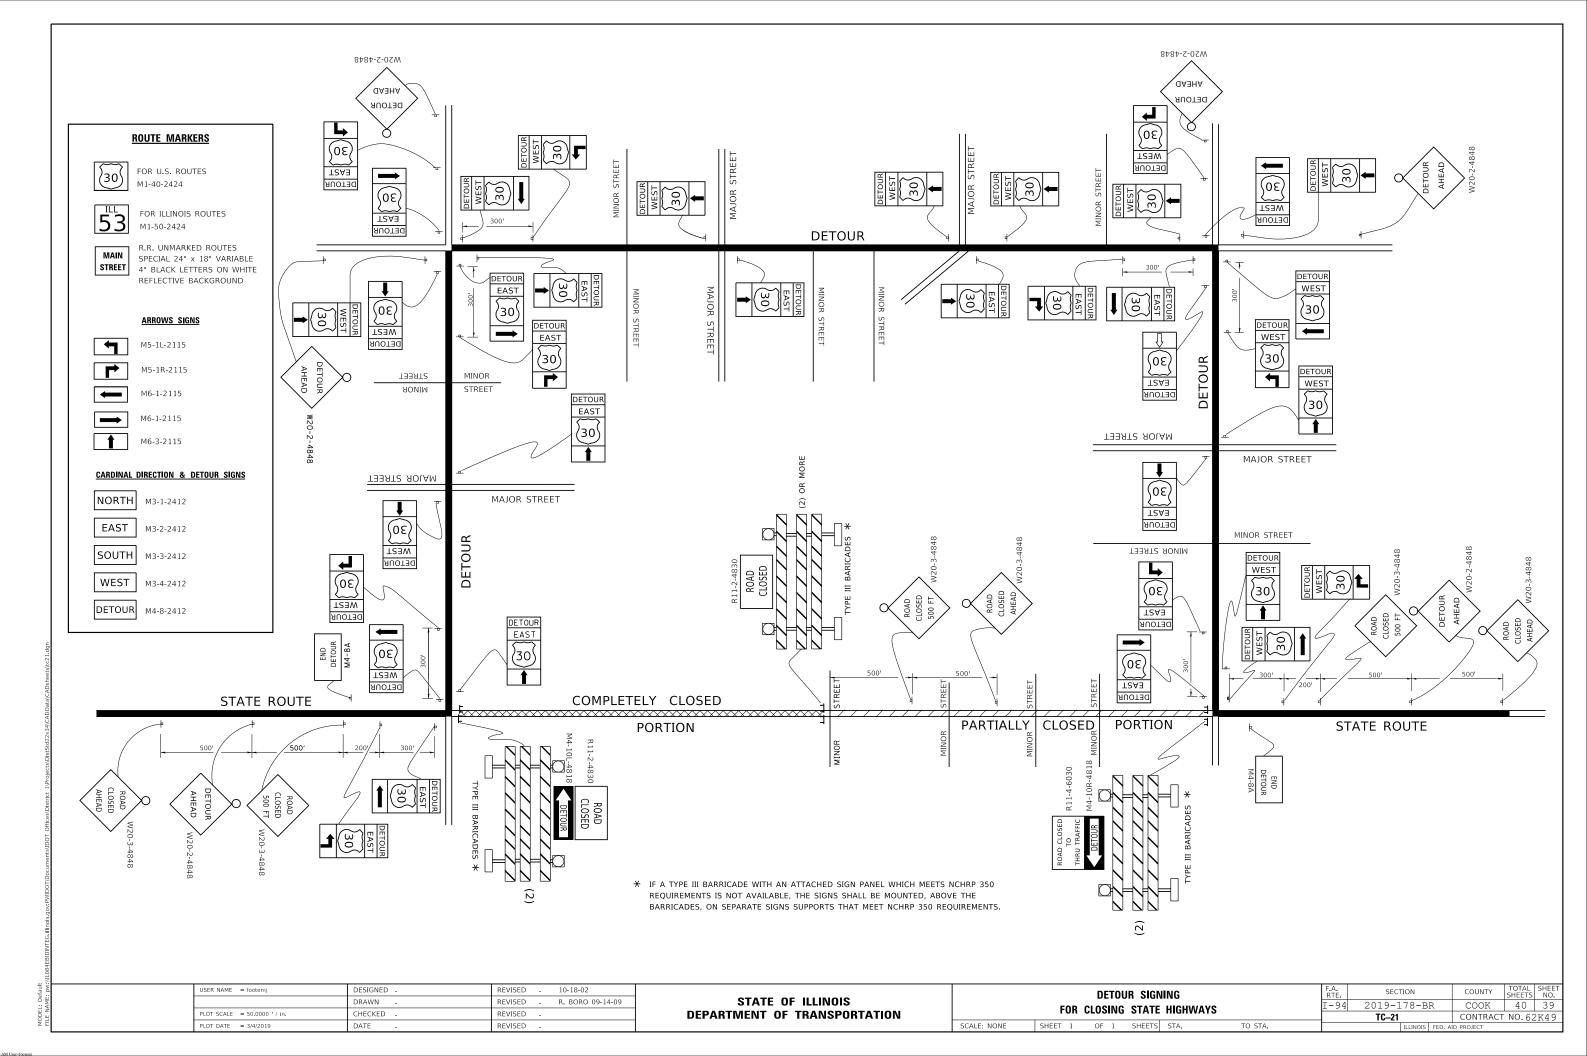

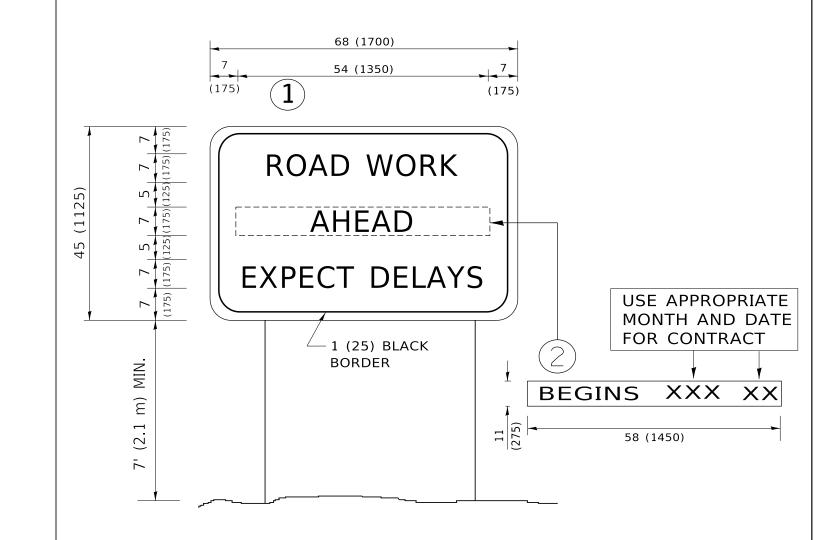

NOTES:

- 1. USE BLACK LETTERING ON ORANGE BACKGROUND.
- 2. ERECT SIGNS IN ADVANCE OF THE LOCATION FOR THE "ROAD CONSTRUCTION AHEAD" SIGN AT LOCATIONS AS DIRECTED BY THE ENGINEER.
- 3. ERECT SIGN 1 WITH INSTALLED PANEL 2 ONE WEEK PRIOR TO THE START OF CONSTRUCTION.
- 4. REMOVE PANEL(2)SOON AFTER THE START OF CONSTRUCTION.
- 5. SEE SPECIAL PROVISION FOR "TEMPORARY INFORMATION SIGNING" FOR ADDITIONAL INFORMATION.
- 6. ONE SIGN ASSEMBLY EQUALS 25.70 SQ. FT. (2.3 SQ. M.)

SCALE: NONE

7. SHALL BE PAID FOR AS TEMPORARY INFORMATION SIGNING.

ALL DIMENSIONS ARE IN INCHES (MILLIMETERS) UNLESS OTHERWISE SHOWN.

USER NAME = footemj	DESIGNED -	REVISED	-	R. MIRS 09-15-97
	DRAWN -	REVISED	-	R. MIRS 12-11-97
PLOT SCALE = 50.0000 ' / in.	CHECKED -	REVISED	- T.	RAMMACHER 02-02-99
PLOT DATE = 3/4/2019	DATE -	REVISED	_	C. JUCIUS 01-31-07

STATE 0	F ILLINOIS
DEPARTMENT OF	TRANSPORTATION

	ARTERIAL ROAD INFORMATION SIGN								SECTION
									2019-178
			1141 4	JIII	VIATION	JIGIN			TC-22
	SHEET	1	OF	1	SHEETS	STA.	TO STA.		ILLIN