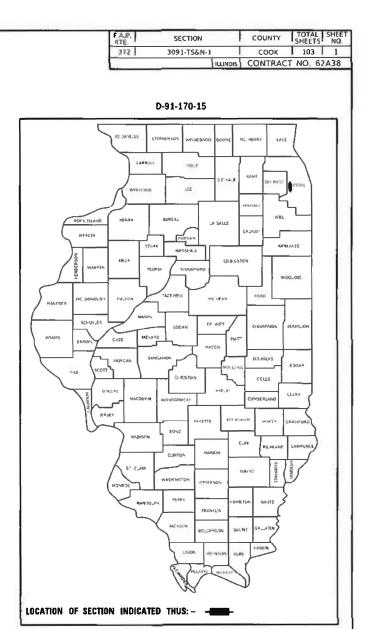


ROOSEVELT RD.: GROSS AND NET LENGTH OF IMPROVEMENT - 1054 FT. - 0.20 MILES

CONTRACT NO. 62A38





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83 DRIVEWAY ENTRANCE SIGNING (TC-26)

(SNOW-PLOW RESISTANT) (TC-11)

84 DISTRICT ONE MAST ARM MOUNTED STREET NAME SIGNS (TS-02)

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STATE STANDARDS 000001-07 STANDARD SYMBOLS, ABBREVIATIONS AND PATTERNS

1-07	TEMPORARY EROSION CONTROL SURVEY	OR "CUAN" (CHICAGO U BURIED ELECTRIC, TELE
1-11	PERPENDICULAR CURB RAMPS FOR SIDEWALKS	10 FEET (3 METERS) TR
1-05	DEPRESSED CORNER RAMPS FOR SIDEWALKS	MEDIAN ITEMS OF WOR OTHERWISE SHOWN. TH
1-03	CLASS C AND D PATCHES	THE PROPOSED ITEMS O
1-02	CATCH BASIN, TYPE A	THE CONTRACTOR SHAL
1-06	PRECAST MANHOLE, TYPE A, 4FT. DIAMETER	AND THE VILLAGES OF
6-10	PRECAST MANHOLE, TYPE A, 6FT. DIAMETER	THE CONTRACTOR WILL WITHOUT WRITTEN PER
1-05	FRAME AND LIDS, TYPE 1	BEFORE BEGINNING AN
1-03	FRAME AND GRATE, TYPE 24	EXISTING PAVEMENT MA LOCATIONS CAN BE RE-
1-07	CONCRETE CURB TYPE B AND COMBINATION CONCRETE CURB AND GUTTER	BE AS DIRECTED BY TH
1-04	PC CONRETE ISLANDS AND MEDIANS	WHEN THE MILLED PAVI PASSES OF THE MILLING
1-05	OFF-ROAD OPERATIONS, MULTILANE 15 FT (4.5 m) TO 24 IN. (600 mm) FROM PAVEMENT EDGE	LIMIT IS 40 MPH (80 km THAN 40 MPH (80 km/ 1 OF 3 INCHES (75 mm) I
6-02	OFF-ROAD OPERATIONS, MULTILANE, MORE THAN 15 FT. (4.5 m) AWAY	MINIMUM (1:3).
7-05	LANE CLOSURE, MULTILANE, INTERMITTENT OR MOVING OPERATIONS FOR SPEEDS LESS THAN OR EQUAL TO 45 MPH	THE THICKNESS OF THE FROM THE NOMINAL TH IN THE EXISTING SURFA
1-09	URBAN LANE CLOSURE, MULTILANE, 1W OR 2W WITH NON-TRAVERSABLE MEDIAN	ANY DAMAGE TO EXIST THE REMOVAL LINE SHO
2-10	URBAN LANE CLOSURE, MULTILANE, 2W WITH BI-DIRECTIONAL LEFT TURN LANE	ALL PAVEMENT PATCHIN
6-10	URBAN SINGLE LANE CLOSURE, MULTILANE, 2W WITH MOUNTABLE MEDIAN	DRAINAGE ADJUSTMENT THE ENGINEER.
1-10	URBAN LANE CLOSURE, MULTILANE INTERSECTION	
1-06	LANE CLOSURE, MULTILANE, 1W OR 2W CROSSWALK OR SIDEWALK CLOSURE	FOR FRAMES AND LIDS UNLESS OTHERWISE SPI
1-08	TRAFFIC CONTROL DEVICES	LOCATION OF COMBINA CURB AND GUTTER, WI
1-01	SIGN PANEL MOUNTING DETAILS	BY TH ENGINEER.
1-08	TEMPORARY CONCRETE BARRIER	FRAMES AND GRATES A
1-05	TYPICAL PAVEMENT MARKINGS	BY THEIR REPSECTIVE C
1-04	TYPICAL APPLICATION RAISED REFLECTIVE PAVEMENT MARKERS	SIDEWALK REMOVAL AN
1-03	CONCRETE HANDHOLES	PAVEMENT MARKING TA SURFACES. THE COST O
6-02	DOUBLE HANDHOLES	IN THE COST OF SHORT
1-01	STANDARD PHASE DESIGNATION DIAGRAMS AND PHASE SEQUENCES	THE CONTRACTOR SHAL
1-01	UNITERRUPTABLE POWER SUPPLY (UPS)	A MINIMUM OF 72 HOUR
1-02	TRAFFIC SIGNAL GROUNDING AND BONDING	BUTT JOINTS WILL BE IN EXISTING PAVEMENT), II
1-08	STEEL MAST ARM ASSEMBLY AND POLE 16 FT. THRU 55 FT.	INCLUDED IN THE PLAN
6-06	STEEL MAST ARM ASSEMBLY AND POLE WITH DUAL MAST ARMS	PERMANENT PAVEMENT BE PLACED IN ACCORDA
1-10	CONCRETE FOUNDATION DETAILS	
1-01	SPAN WIRE MOUNTED SIGNALS AND FLASHING BEACON INSTALLATION	THE RESIDENT ENGINEE AT PATRICE.HARRIS@ILL
6-01	TRAFFIC SIGNAL MOUNTING DETAILS	PAVEMENT MARKINGS.

886001-01 DETECTOR LOOP INSTALLATIONS

880006-01

IT SHALL BE THE CONTRACTOR'S RESPONSIBILITY TO VERIFY ALL DIMENSION AND CONDITIONS EXISTING IN THE FIELD PRIOR TO CONSTRUCTION AND ORDERING MATERIALS AND BEGINNING CONSTRUCTION. THIS SHALL INCLUDE LOCATING THE MAST ARM AND FOUNDATION AND VERIFYING THE MAST ARM LENGTHS.

THE CONTRACTOR SHALL BE REQUIRED TO PROVIDE ACCESS TO ABUTTING PROPERTY AT ALL TIMES DURING THE CONSTRUCTION OF THIS PROJECT

FOR STORM SEWER CONSTRUCTED UNDER ROADWAY, BACKFILLING METHODS TWO AND THREE AUTHORIZED UNDER PROVISIONS OF ARTICLE 550.07 OF THE STANDARD SPECIFICATIONS WILL NOT BE ALLOWED.

THE CONTRACTOR WILL BE REQUIRED TO KEEP A RECORD OF THE LOCATIONS OF BURIED STRUCTURES ACCORDING TO THE STATION OFFSET LEFT OR RIGHT OF THE CENTERLINE OF PAVEMENT, UPON COMPLETION OF THE WORK THE CONTRACTOR WILL DELIVER THE RECORD TO THE ENGINEER.

EXISTING BROKEN FRAMES AND LIDS SHALL BE REMOVED AND DISPOSED OF THE CONTRACTOR AND SHALL BE REPLACED AS DIRECTED BY THE ENGINEER, REPLACEMENT FRAMES AND LIDS WILL BE PAID FOR ACCORDING TO ARTICLE 109.04 OF THE STANDARD SPECIFICATION UNLESS A SEPERATE PAY ITEM HAS BEEN PROVIDED.

DO NOT SCALE PLANS FOR CONSTRUCTION DIMENSIONS.

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PLOT DATE = 3/27/2020	DATE -	REVISED -		SCALE: NONE	SHEET	OF	SHEETS STA.	TO STA.		ILLINOIS FEE	D. AID PROJECT	

GENERAL NOTES:

BEFORE STARTING ANY EXCAVATION THE CONTRACTOR SHALL CALL "JULIE" AT 800-892-0123 OR "CUAN" (CHICAGO UTILITY ALERT NETWORK) AT 312-744-7000 FOR FIELD LOCATIONS OF RIC. TELEPHONE AND GAS FACILITIES. (48 HOURS NOTIFICATION IS REQUIRED)

> TERS) TRANSITION SHALL BE USED TO MATCH PROPOSED CURB AND GUTTER AND OF WORK TO EXISTING CURBS AND GUTTERS AND MEDIANS IN THE FIELD. UNLESS IOWN. THE TRANSITION SHALL BE PAID FOR AT THE CONTRACT UNIT PRICE FOR ITEMS OF WORK SPECIFIED.

TOR SHALL COORDINATE CONSTRUCTION ACTIVITIES WITH THE UTILITY COMPANIES AGES OF MAYWOOD AND FOREST PARK.

FOR WILL NOT BE ALLOWED TO SET UP A YARD OR FIELD OFFICE ON STATE PROPERTY TEN PERMISSION FROM THE DEPARTMENT.

NING ANY WORK. THE CONTRACTOR SHALL RETAIN AND RECORD FOR FUTURE REFERENCE. ALL MENT MARKING LINES (RAISED REFLECTIVE PAVEMENT MARKERS) IN ORDER THAT THESE N BE RE-ESTABLISHED FOR STRIPING. EXACT LOCATIONS OF ALL PAVEMENT MARKINGS SHALL ED BY THE ENGINEER

LED PAVEMENT IS OPEN TO TRAFFIC THE MAXIMUM GRADE DIFFERENTIAL BETWEEN MILLING MACHINE SHALL NOT EXCEED 1 1/2 INCHES (40 mm) WHERE THE SPEED H (80 km/ h) OR LESS AND 1 INCH (25 mm) WHERE THE SPEED LIMIT IS GREATER (80 km/ h). WITH WRITTEN APPROVAL OF THE ENGINEER, A MAXIMUM GRADE DIFFERENTIAL 75 mm) MAY BE ALLOWED IF THE EDGE OF THE MILLING MACHINE IS SLOPED A

S OF THE HMA MIXTURE SHOWN ON THE PLANS IS THE NOMINAL THICKNESS, DEVIATIONS AINAL THICKNESS WILL BE PERMITTED WHENSUCH DEVIATIONS OCCUR DUE TO IRREGULARITIES IG SURFACE OR BASE ON WHICH THE HMA MIXTURE IS PLACED.

TO EXISTING PAVEMENT MARKINGS OR RAISED REFLECTIVE PAVEMENT MARKERS OUTSIDE LINE SHOWN ON THE PLANS SHALL BE REPLACED AT THE CONTRACTOR'S EXPENSE.

PATCHING LOCATIONS WILL BE DETERMINED IN THE FIELD BY THE ENGINEER

USTMENT OR RECONSTRUCTION LOCATIONS WILL BE DETERMINED IN THE FIELD BY

ND LIDS ADJUSTMENT WITHOUT MILLING, REUSE EXISTING FRAMES AND LIDS WISE SPECIFIED IN THE PLANS

COMBINATION CONCRETE CURB AND GUTTER REMOVAL AND REPLACEMENT (OR COMBINATION ITER, WITH THE TYPE SPECIFIED ON THE PLANS), WILL BE DETERMINED IN THE FIELD

GRATES ADJUSTMENT OF PRIVATE UTILITIES WITHIN THE PROJECT LIMITS SHALL BE DONE ECTIVE OWNERS AND ARE NOT PART OF THIS CONTRACT.

IOVAL AND P.C.C. SIDEWALK, 5 INCH LOCATIONS SHALL BE DETERMINED BY THE ENGINEER.

RKING TAPE, TYPE III SHALL BE USED FOR SHORT TERM PAVEMENT MARKING ON FINAL COST OF THE PAVEMENT MARKING TAPE, TYPE III AND ITS REMOVAL SHALL BE INCLUDED OF SHORT TERM PAVEMENT MARKING.

TOR SHALL CONTACT THE DISTRICT ONE TRAFFIC CONTROL CENTER AT (847) 705-4470 72 HOURS IN ADVANCE OF BEGINNING WORK.

VILL BE INSTALLED AT THE ENDS OF ALL RESURFACING (WHERE RESURFACING MEETS MENT), IN ACCORDANCE WITH THE "BUTT JOINT AND HMA TAPER DETAILS" SHEET HE PLANS, UNLESS OTHERWISE SPECIFIED.

AVEMENT MARKINGS SHALL BE THERMOPLASTIC (OF THE EXTRUDED TYPE) AND SHOULD ACCORDANCE WITH THE "DISTRICT ONE TYPICAL PAVEMENT MARKINGS" DETAIL. (TC-13)

ENGINEER SHALL CONTACT PATRICE HARRIS, AREA TRAFFIC FIELD TECHNICIAN, VIA E-MAIL RRIS@ILLINOIS.GOV, A MINIMUM OF TWO (2) WEEKS PRIOR TO THE PLACEMENT OF PERMANENT

_ _. . . _ _

GENERAL NOTES (CONT.):

POROUS GRANULAR EMBANKMENT, SUBGRADE (P.G.E.S.) HAS BEEN PROVIDED FOR USE FOR SOILS THAT TEND TO BE UNSUITABLE OR UNSTABLE. THE ACTUAL NEED FOR REMOVAL AND REPLACEMENT WITH P.G.E.S. WILL BE DETERMINED IN THE FIELD AT THE TIME OF CONSTRUCTION BY THE GEOTECHNICIAL ENGINEER. ALL POTENTIAL UNSTABLE SOILS SHOULD BE TESTED WITH A STATIC CONE PENETROMETER AND TREATED IN ACCORDANCE WITH ARTICLE 301.03 OF THE STANDARD SPECIFICATIONS AND GUIDELINES IN THE IDOT SUBGRADE STABILITY MANUAL. IF UNSTABLE AND/OR UNSUITABLE MATERIAL IS ENCOUNTERED, THE SOIL SHALL BE REMOVED AND REPLACED WITH P.G.E.S. OR EMBANKMENT AS DETERMINED BY THE GEOTECHNICAL ENGINEER. IF UNSTABLE AND/OR UNSUITABLE MATERIAL IS NOT ENCOUNTERED, THEN THE QUANTITY SHALL BE DEDUCTED AND NO ADDITIONAL COMPENSATION WILL BE DUE TO THE CONTRACTOR."

THE EXACT LOCATION OF ALL UTILITIES SHALL BE FIELD VERIFIED BY THE CONTRACTOR BEFORE ORDERING ANY MATERIALS AND STARTING ANY WORK. FOR LOCATIONS OF UTILITIES, LOCALLY AND EQUIPMENT, LEASED ENFORCEMENT CAMERA FACILITIES AND IDOT UNDERGROUND FACILITIES, CONTACT THE LOCAL COUNTIES, MUNICIPALITIES AND IDOT FOR LOCATIONS.

THE CONTRACTOR SHALL CAN "J.U.L.I.E." AT (800) 892-0123 OR 811. IN THE CITY OF CHICAGO CONTACT DIGGER AT (312) 744-7000 FOR FIELD LOCATIONS OF BURIED UTILITIES (48 HOURS NOTIFICATION REQUIRED).

RESTORATION OF THE TRAFFIC SIGNAL WORK AREA SHALL BE INCLUDED IN THE RELATED PAY ITEMS SUCH AS FOUNDATION, CONDUIT, HANDHOLE, ETC., AND NO EXTRA COMPENSATION SHALL BE ALLOWED. ALL ROADWAY SURFACE SUCH AS SHOULDERS, MEDIAN, SIDEWALKS, PAVEMENT, ETC., SHALL BE REPLACED IN KIND. ALL DAMAGE TO MOWED LAWNS SHALL BE REPLACED WITH APPROVED SOD, AND ALL DAMAGE TO UNMOWED FIELDS SHALL BE SEEDED IN ACCORDANCE WITH THE STANDARD SPECIFICATIONS 250 AND 252 RESPECTIVIELY.

IF THIS CONTRACT REQUIRES THE SERVICES OF AN ELECTRICAL CONTRACTOR, THE CONTRACTOR SHALL BE RESPONSIBLE AT HIS/HER OWN EXPENSE FOR LOCATING IDOT EXISTING ELECTRICAL FACILITIES PRIOR TO PERFORMING ANY WORK, IF THIS CONTRACT DOES NOT REQUIRE THE SERVICES OF AN ELECTRICAL CONTRACTOR, THE CONTRACTOR MAY REQUEST ONE FREE LOCATE FOR EXISTING IDOT ELECTRICAL FACILITIES FROM THE DISTRICT ONE ELECTRICAL MAINTENANCE CONTRACTOR PRIOR TO THE START OF ANY WORK. ADDITIONAL REQUEST SHALL BE AT THE EXPENSE OF THE CONTRACTOR, THE LOCATION OF UNDERGROUND FACILITIES DOES NOT RELIEVE THE CONTRACTOR OF THEIR RESPONSIBILITY TO REPAIR ANY FACILITIES DAMAGED DURING CONSTRUCTION AT THEIR EXPENSE.

THE CONTRACTOR SHALL CHECK THE PROPOSED TRAFFIC SIGNAL EQUIPMENT LOCATIONS FOR OVERHEAD UTILITY CONFLICTS. THE CONTRACTOR SHALL COORDINATE ANY CONFLICT WITH THE UTILITY COMPANIES AND THE RESIDENT ENGINEER BEFORE ORDERING MATERIALS.

USER NAME = Velichkovvv	DESIGNED -	REVISED -		INDEX OF	SHEETS	, STATE	STANDA	RDS A	ND GENERAL NOTES	F.A.P. RTE		SECTION	COUNTY	TOTAL SHEET SHEETS NO.
	DRAWN -	REVISED -	STATE OF ILLINOIS	FAP 372 /IL ROUTE 171(1ST AVENUE) AT ROOSEVELT ROAD				372	30	091-TS&N-1	соок	103 3		
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PLOT DATE = 3/27/2020	DATE -	REVISED -		SCALE: NONE SHEET OF SHEETS STA. TO STA.					TO STA.			ILLINOIS FED.	AID PROJECT	

		SUMMARY OF QUANTITIES				CC	NSTRUCTIO	ON TYPE C			SUMMA	ARY OF QUANTITIES				CC	ONSTRUCTIO	ON TYPE CO	DDE	
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1 mode	20800150	TRENCH BACKFILL	CU YD	522	4 3 8				84											
Statisticity Statisticity <th< td=""><td></td><td></td><td></td><td></td><td></td><td></td><td></td><td></td><td></td><td>4060417</td><td>2 POLYMERIZED</td><td>HOT-MIX ASPHALT SURFACE</td><td>TON</td><td>1811</td><td>1811</td><td></td><td></td><td></td><td></td><td></td></th<>										4060417	2 POLYMERIZED	HOT-MIX ASPHALT SURFACE	TON	1811	1811					
Image: mark mark <td>21001000</td> <td>GEOTECHNICAL FABRIC FOR GROUND</td> <td>SQ YD</td> <td>72</td> <td>72</td> <td></td> <td></td> <td></td> <td></td> <td></td> <td>COURSE, IL-</td> <td>9.5, MIX "E", N70</td> <td></td> <td></td> <td></td> <td></td> <td></td> <td></td> <td></td> <td></td>	21001000	GEOTECHNICAL FABRIC FOR GROUND	SQ YD	72	72						COURSE, IL-	9.5, MIX "E", N70								
$ \begin{array}{c c c c c c c c c c c c c c c c c c c $		STABILIZATION																		
$ \ \ \ \ \ \ \ \ \ \ \ \ \ \ \ \ \ \ \$										4200130		COAT	SQ YD	955	955					
200000 PROPARING FETILIZER NUTRIENT POIM 13 13 13 14 15 15 15 15 15 16<	25000400	NITROGEN FERTILIZER NUTRIENT	POUND	13		13														
Image: state of the state										4230020	D PORTLAND CE	MENT CONCRETE DRIVEWAY	SQ YD	18	18					
$ \ \ \ \ \ \ \ \ \ \ \ \ \ $	25000500	PHOSPHORUS FERTILIZER NUTRIENT	POUND	13		13					PAVEMENT,	6 INCH								
$ \ \ \ \ \ \ \ \ \ \ \ \ \ $											_									
220010 500 DRG. SALT TOLEMANT 50 °D 102 <	25000600	POTASSIUM FERTILIZER NUTRIENT	POUND	13		13				4240010	D PORTLAND CE	MENT CONCRETE SIDEWALK 4	SO FT	116	116					
$ \begin{array}{ c c c c c c c c c c c c c c c c c c c$							 				INCH									
2200200 SUPPLEMENTAL WATERING UNIT 4 1 4 1 4 1 <	25200110	SODDING, SALT TOLERANT	SO YD	1022		1022														
Image: mark and pipe PRIMETER ERGSION BARRIER FOD 3975 3975 C										4240030		MENT CONCRETE SIDEWALK 6	SO FT	6350	6350					
Image: mark and pipe protection EACH 21<	25200200	SUPPLEMENTAL WATERING	UNIT	4		4					INCH									
Image: mark and pipe protection EACH 21<																				
Image: Construction of the constructing of the construc	28000400	PERIMETER EROSION BARRIER	FOOT	3975	3975					4240080	DETECTABLE	WARNINGS	SO FT	128	128					
Image: Construction of the constructing of the construc	28000500		EACH	21	21					4400010		MOVAL	SO XD	2751	2751					
$ \begin{array}{ c c c c c c c c c c c c c c c c c c c$	20000000	INCLUMENTIC FROTEGIUN										mo ral		2151	2131					
$ \begin{array}{ c c c c c c c c c c c c c c c c c c c$	30300001	AGGREGATE SUBGRADE IMPROVEMENT	CU YD	48	48					4400015	9 HOT-MIX ASP	HALT SURFACE REMOVAL. 2	SQ YD	18280	18280					
30300112 ACCREGATE SUBGRADE IMPROVEMENT 12" S0 YD 284 284 Column 1 Column 1<																				
35501314 HOT-MIX ASPHALT BASE COURSE, 7 1/2" SO YD 199	30300112	AGGREGATE SUBGRADE IMPROVEMENT 12"	SO YD	284	284															
$\frac{1}{16}$				<u> </u>		<u> </u>				4400020	D DRIVEWAY PA	VEMENT REMOVAL	SQ YD	15	15					
$\frac{1}{16}$	35501314	HOT-MIX ASPHALT BASE COURSE, 7 1/2"	SO YD	199	199															
File NAME = USER NAME = Volication DESIGNED - REVISED - TOTAL will/glarroom.dd/1111/nds.gov.PWIDDT\Documents\DOT 01/rdest/district NProjeeds/PII3612-cxh0dard/design/PII3612-cxh0dard/de										4400050	COMBINATION	URB AND GUTTER REMOVAL	FOOT	797	797			* SPE	R CIALTY ITEMS	EV-SEP
Description Description Description State of illinois plot scale = 100,0000 // In CHECKED - REVISED - State of illinois DEPARTMENT OF TRANSPORTATION FAP 372 / IL 171 (1st. AVENUE) AT ROOSEVELT ROAD 372 3091-T5&N-1 COOK 103	40600290	BITUMINOUS MATERIALS (TACK COAT)	POUND	12340	12340	ĺ				4400060	O SIDEWALK RE	MOVAL	SO FT	3066	3066				-PARTICIPATING	ITEMS
Description Description Description State of illinois plot scale = 100,0000 // In CHECKED - REVISED - State of illinois DEPARTMENT OF TRANSPORTATION FAP 372 / IL 171 (1st. AVENUE) AT ROOSEVELT ROAD 372 3091-T5&N-1 COOK 103				1		-	<u> </u>	1	1		1	CUMM				F.A.P.	SECT	ION		TAL SHEET
	pw:\\planroom.dotJllinois					-		P 1							ROAD	372	3091-T		СООК 10	03 4
PLOT DATE = 3/27/2020 DATE - REVISED - REVISED - REVISED - REVISED - DATE PROJECT		PLUT SCALE = 1000000 ' / //. PLOT DATE = 3/27/2020	DATE -		REVISED	-		וט	CFARINIÈ	OF TRANSPUR						FED DO	DAD DIST. NO 1 IT			62A38

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	JUNIM	THE OF QUARTITIES		-	90% FEDERAL 10% STATE	90% FEDERAL 10% STATE	TRAFFIC SIGNALS					SUMM4	INT OF QUANTITIES	
CODE NO		ITEM	UNIT	TOTAL QUANTITIES	ROADWAY ITEMS	LANDSCAPING ITEMS		80% FEDERAL 20% VILLAGE OF FOREST PARK			CODE NO		ITEM	UNII
44201711	CLASS D PATC	HES, TYPE IV, 5 INCH	SO YD	50	0004	0031	0021	0021	0043 50		60219000	MANHOLES, T	YPE A, 4'-DIAMETER, TYPE 8	EACH
												GRATE		
44201851	CLASS D PATC	HES, TYPE II, 17 INCH	SO YD	229	229									
											60221100	MANHOLES, T	YPE A, 5'-DIAMETER, TYPE 1	EACH
44201855	CLASS D PATC	HES, TYPE III, 17 INCH	SO YD	1 3 7	137							FRAME, CLOS	ED LID	
44201857	CLASS D PATC	HES, TYPE IV, 17 INCH	SO YD	92	92						60223800	MANHOLES, T	YPE A, 6'-DIAMETER, TYPE 1	EACH
												FRAME, CLOS	ED LID	
550A0050	STORM SEWERS	, CLASS A, TYPE 1 12"	FOOT	369	369									
											60237460	INLETS, TYP	E A, TYPE 23 FRAME AND GRATE	EACH
550A0070	STORM SEWERS	, CLASS A, TYPE 1 15"	FOOT	202	202									
							1				60603800	COMBINATION	CONCRETE CURB AND GUTTER.	FOOT
550A0160	STORM SEWERS	, CLASS A, TYPE 1 36"	FOOT	280	280							TYPE B-6.12		
550A0340	STORM SEWERS	, CLASS A, TYPE 2 12"	FOOT	11					11		60605000	COMBINATION	CONCRETE CURB AND GUTTER,	FOOT
												TYPE B-6.24		
550A0700	STORM SEWERS	, CLASS A, TYPE 3 21"	FOOT	10					10					
											60619200	CONCRETE ME	DIAN, TYPE SB-6.06	SO F
60108204	PIPE UNDERDR	AINS, TYPE 2, 4"	FOOT	230	230									
											* 66900200	NON-SPECIAL	WASTE DISPOSAL	CU Y
60200105	CATCH BASINS	, TYPE A, 4'-DIAMETER, TYPE	EACH	5	5									
	1 FRAME, OPE	N LID									* 66900530	SOIL DISPOS	AL ANALYSIS	EACH
60203805	CATCH BASINS	, TYPE A, 5'-DIAMETER, TYPE	ЕАСН	3	3						* 66901001	REGULATED S	UBSTANCES PRE-CONSTRUCTION	LSUN
	1 FRAME, OPE											PLAN		
60203905	CATCH BASINS	, TYPE A, 5'-DIAMETER, TYPE	EACH	3	3						* 66901003	REGULATED S	UBSTANCES FINAL CONSTRUCTION	LSUN
	1 FRAME, CLO	SED LID										REPORT		
60218400	MANHOLES. TY	PE A, 4'-DIAMETER, TYPE 1	EACH	4	3				1		* 66901006	REGULATED S	UBSTANCES MONITORING	CAL
	FRAME, CLOSE													
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			CHECKED - DATE -		REVISED REVISED			U	CPAKIME	VI UF I	RANSPORTA		SCALE: SHEET NO. OF	SHEETS

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	TOTAL	90% FEDERAL 10% STATE	90% FEDERAL 10% STATE		TRAFFIC SIGNALS	DRAINAGE IMPROVEMENT	
1 T		ROADWAY ITEMS	LANDSCAPING ITEMS	IL 171 @ ROOSEVELT RD. INTERCONNECT	80% FEDERAL 20% VILLAGE OF FOREST PARK	ROOSEVELT RD.@ 17TH AVE.	
ΙT	QUANTITIES	ITEMS	ITEMS	INTERCONNECT	FOREST PARK		
		0004	0031	0021	0021	0043	
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СН	2					2	
СН	1	1					
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		_					
СН	3	3					
от	52					52	
от	756	756					
01	100	100					
FT	2620	2620					
YD	25	25					
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						 r	REV-SEP
DA	20	20			* spe	CIALTY ITEMS	NEV-SEP
					D NO	N-PARTICIPATING	G ITEMS
			F.A.P. (TAL SHEET
	TITIES		RTE. 372	SECTI 3091-TS			TAL SHEET EETS NO. 103 5
	ROOSEVELT					CONTRACT N	
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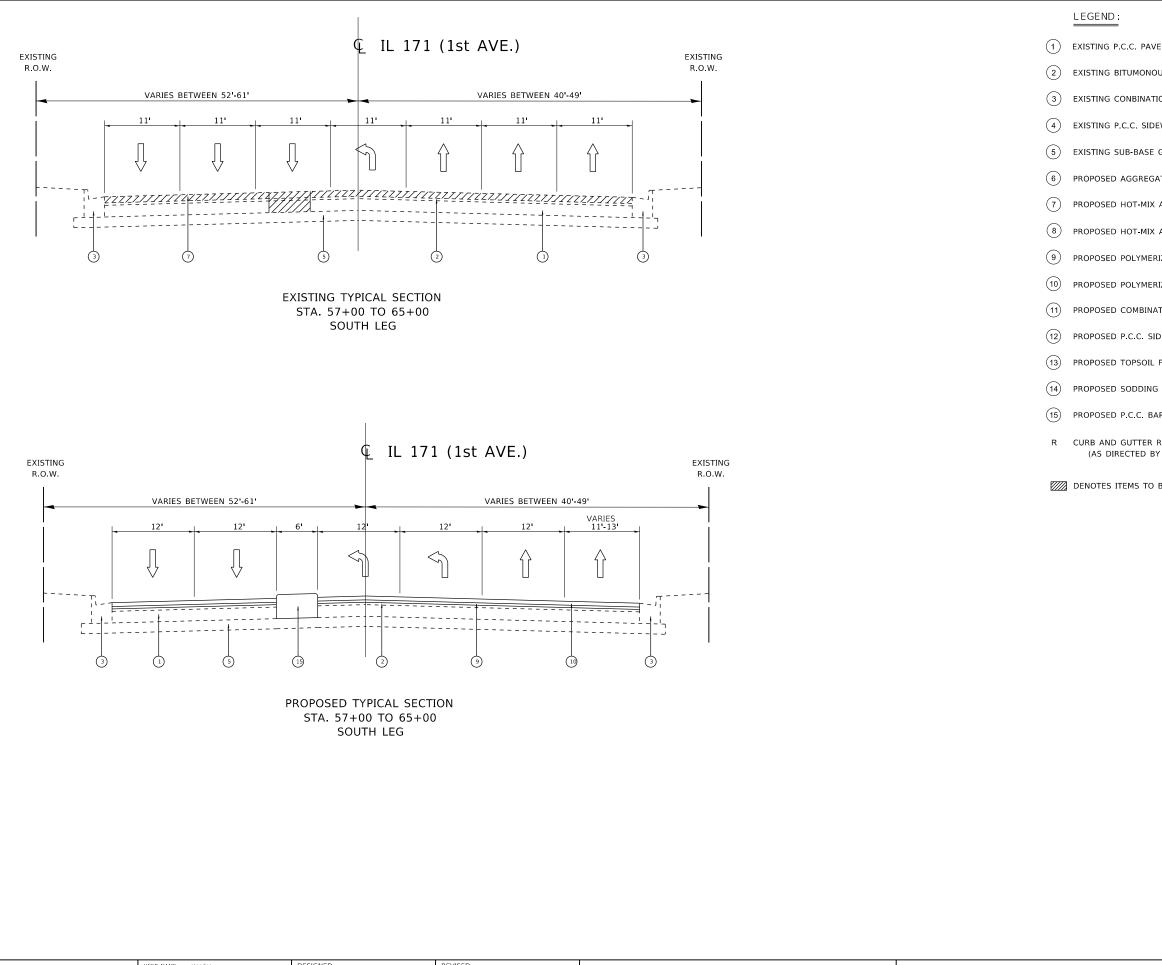
	SUMMARY OF QUANTITIES				CC	NSTRUCTIC	N TYPE CO					SUMMARY OF QUANTITIES				CC	NSTRUCTIO	N TYPE CO	DDE
			TOTAL	90% FEDERAL 10% STATE	90% FEDERAL 10% STATE	TRAFFIC SIGNALS	TRAFFIC SIGNALS	DRAINAGE IMPROVEMENT						TOTAL	90% FEDERAL 10% STATE	90% FEDERAL 10% STATE		TRAFFIC SIGNALS	DRAINAGE IMPROVEMENT
CODE NO	ITEM	UNIT	QUANTITIES	ROADWAY ITEMS	LANDSCAPING ITEMS	IL 171 @ ROOSEVELT RD. INTERCONNECT	80% FEDERAL 20% VILLAGE OF FOREST PARK	ROOSEVELT RD.@ 17TH AVE.		c	CODE NO	ITEM	UNIT	QUANTITIES	ROADWAY ITEMS	LANDSCAPING ITEMS	IL 1/1 @ ROOSEVELT RD. INTERCONNECT	80% FEDERAL 20% VILLAGE OF FOREST PARK	ROOSEVELT RD.@ 17TH AVE.
				0004	0031	0021	0021	0043		$ _{-}$					0004	0031	0021	0021	0043
67000400	ENGINEER'S FIELD OFFICE, TYPE A	CAL MO	6	6						7	72000100	SIGN PANEL - TYPE 1	SO FT	58.5			58.5		
67100100	MOBILIZATION	LSUM	1	1						* 7	78000100	THERMOPLASTIC PAVEMENT MARKING -	SQ FT	583	583				
												LETTERS AND SYMBOLS							
70300100	SHORT TERM PAVEMENT MARKING	FOOT	2164	2164															
										* 7	78000200	THERMOPLASTIC PAVEMENT MARKING - LINE	FOOT	7929	7789				140
70300150	SHORT TERM PAVEMENT MARKING REMOVAL	SQ FT	361	361								4"							
70700010		CO 51	F03	F 0 7						¥ 7	70000400		FOOT	2204	0704				
70300210	TEMPORARY PAVEMENT MARKING LETTERS AND	SQ FT	583	583							78000400	THERMOPLASTIC PAVEMENT MARKING - LINE	FOOT	2384	2384				
	SYMBOLS											0							
70300220	TEMPORARY PAVEMENT MARKING - LINE 4"	FOOT	7789	7789						* 7	78000600	THERMOPLASTIC PAVEMENT MARKING - LINE	FOOT	755	755				
												12"							
70300240	TEMPORARY PAVEMENT MARKING - LINE 6"	FOOT	2384	2384															
										* 7	78000650	THERMOPLASTIC PAVEMENT MARKING - LINE	FOOT	227	200				27
70300260	TEMPORARY PAVEMENT MARKING - LINE 12"	FOOT	755	755								24''							
70300280	TEMPORARY PAVEMENT MARKING - LINE 24"	FOOT	200	200						* 7	78100100	RAISED REFLECTIVE PAVEMENT MARKER	EACH	272	272				
70300520	PAVEMENT MARKING TAPE. TYPE III 4"	FOOT	14348	14348						7	78300200	RAISED REFLECTIVE PAVEMENT MARKER	ЕАСН	224	224				
												REMOVAL							
70300900	PAVEMENT MARKING TAPE, TYPE IV -	SQ FT	915	915															
	LETTERS AND SYMBOLS									8	81028200	UNDERGROUND CONDUIT, GALVANIZED STEEL,	FOOT	2291			2291		
												2" DIA.							
70300904	PAVEMENT MARKING TAPE, TYPE IV 4"	FOOT	20966	20966															
										8	81028220	UNDERGROUND CONDUIT, GALVANIZED STEEL,	FOOT	105			105		
70300906	PAVEMENT MARKING TAPE, TYPE IV 6"	FOOT	7010	7010								3" DIA.							
70300912	PAVEMENT MARKING TAPE, TYPE IV 12"	FOOT	532	532						8	81028240	UNDERGROUND CONDUIT, GALVANIZED STEEL,	FOOT	545			545		
												4" DIA.						* 595	REV-SEP
70300924	PAVEMENT MARKING TAPE, TYPE IV 24"	FOOT	537	537															N-PARTICIPATING ITEMS
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		TE -		REVISED	-						JIIIA	SCALE. SHEET NO. OF			O STA.	FED. RO	AD DIST. NO. 1	LLINOIS FED. AID F	CONTRACT NO. 62A38 PROJECT

	SUMMARY OF QUANTITIES				CC	NSTRUCTIC	N TYPE C	DDE		SUMMARY OF QUANTITIES				cc	NSTRUCTIO	ON TYPE CO	DE
	SUMMART OF COARTITIES		тота	90% FEDERAL 10% STATE	90% FEDERAL 10% STATE	TRAFFIC SIGNALS	TRAFFIC SIGNALS	DRAINAGE IMPROVEMENT					90% FEDERAL 10% STATE	90% FEDERAL 10% STATE			DRAINAGE IMPROVEMENT
CODE NO	ITEM	UNIT	TOTAL QUANTITIES	ROADWAY ITEMS	LANDSCAPING ITEMS	IL 171 @ ROOSEVELT RD. INTERCONNECT	80% FEDERAL 20% VILLAGE OF FOREST PARK	ROOSEVELT RD.@ 17TH AVE	CODE NO	ITEM	UNIT	TOTAL QUANTITIES	ROADWAY ITEMS	LANDSCAPING ITEMS	IL 171 @ ROOSEVELT RD. INTERCONNECT	80% FEDERAL 20% VILLAGE OF FOREST PARK	ROOSEVELT RD.@ 17TH AVE.
				0004	0031	0021	0021	0043					0004	0031	0021	0021	0043
81400100	HANDHOLE	EACH	6			6			87301900	ELECTRIC CABLE IN CONDUIT, EQUIPMENT	FOOT	758			758		
										GROUNDING CONDUCTOR, NO. 6 1C							
81400200	HEAVY-DUTY HANDHOLE	EACH	4			4											
									87502500	TRAFFIC SIGNAL POST, GALVANIZED STEEL	ЕАСН	3			3		
81400300	DOUBLE HANDHOLE	EACH	2			2				16 FT.							
85000200	MAINTENANCE OF EXISTING TRAFFIC SIGNAL	EACH	3			3			87700210	STEEL MAST ARM ASSEMBLY AND POLE, 34	EACH	1			1		
	INSTALLATION								_	FT.							
86400100	TRANSCEIVER - FIBER OPTIC	EACH	1			1			87700250	STEEL MAST ARM ASSEMBLY AND POLE, 42	EACH	1			1		
										FT.							
87300925	ELECTRIC CABLE IN CONDUIT, TRACER, NO.	FOOT	3211			3211											
	14 1C								87700270	STEEL MAST ARM ASSEMBLY AND POLE, 46	EACH	1			1		
										FT.							
87301215	ELECTRIC CABLE IN CONDUIT, SIGNAL NO.	FOOT	1497			1497											
	14 2C								87800100	CONCRETE FOUNDATION, TYPE A	FOOT	20			20		
									_								
87301225	ELECTRIC CABLE IN CONDUIT, SIGNAL NO.	FOOT	2267			2267			87800150	CONCRETE FOUNDATION, TYPE C	FOOT	4			4		
	14 3C								_								
									87800415	CONCRETE FOUNDATION, TYPE E 36-INCH	FOOT	37			37		
87301245	ELECTRIC CABLE IN CONDUIT, SIGNAL NO.	FOOT	2916			2916				DIAMETER							
	14 5C								_								
									87800420	CONCRETE FOUNDATION, TYPE E 42-INCH	FOOT	22			22		
87301255	ELECTRIC CABLE IN CONDUIT, SIGNAL NO.	FOOT	1520			1520			_	DIAMETER							
	14 7C																
									87900200	DRILL EXISTING HANDHOLE	EACH	3			3		
87301305	ELECTRIC CABLE IN CONDUIT, LEAD-IN, NO.	FOOT	2945			2945											
	14 1 PAIR								88030020	SIGNAL HEAD, LED, 1-FACE, 3-SECTION,	EACH	8			8		
										MAST-ARM MOUNTED							
87301805	ELECTRIC CABLE IN CONDUIT, SERVICE, NO.	FOOT	1 38			1 38			_							-	REV-SE
	6 2 C															NON NON	-PARTICIPATING ITEMS
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	PLOT SCALE = 100.0000 ' / In. CH	ECKED -		REVISED			DI		TRANSPORT	ATION FAP 372 /IL 171 (1st					3091-15	(СООК 103 7 СОNTRACT NO. 62АЗВ
	PLOT DATE = 3/27/2020 DA	TE -		REVISED	-					SCALE: SHEET NO. OF	SHEETS ST	Α. Τ(O STA.	FED. RO	AD DIST. NO. 1 I	LLINOIS FED. AID P	

	SUMMARY OF QUANTITIES				CC	NSTRUCTIO	ON TYPE C			SUMMARY OF QUANTITIES				00	NSTRUCTIO	ON TYPE CO	
			тота	90% FEDERAL 10% STATE	90% FEDERAL 10% STATE	TRAFFIC SIGNALS	TRAFFIC SIGNALS	DRAINAGE IMPROVEMENT				TOTAL	90% FEDERAL 10% STATE	90% FEDERAL 10% STATE		TRAFFIC SIGNALS	DRAINAGE IMPROVEMENT
CODE NO	ITEM	UNIT	TOTAL QUANTITIES		LANDSCAPING ITEMS	IL 171 @ ROOSEVELT RD. INTERCONNECT	FOREST PARK	ROOSEVELT RD.@ 17TH AVE	CODE NO	ITEM	UNIT	QUANTITIES		LANDSCAPING ITEMS	INTERCONNECT	20% VILLAGE OF FOREST PARK	ROOSEVELT RD.@ 17TH AVE.
88030050	SIGNAL HEAD, LED, 1-FACE, 3-SECTION,	ЕАСН	4	0004	0031	0021 4	0021	0043	89502380	REMOVE EXISTING HANDHOLE	ЕАСН	14	0004	0031	0021	0021	0043
	BRACKET MOUNTED								_								
									89502382	REMOVE EXISTING DOUBLE HANDHOLE	EACH	2			2		
88030100	SIGNAL HEAD, LED, 1-FACE, 5-SECTION,	EACH	2			2											
	BRACKET MOUNTED								89502385	REMOVE EXISTING CONCRETE FOUNDATION	EACH	9			9		
88030110	SIGNAL HEAD, LED, 1-FACE, 5-SECTION,	EACH	6			6			x0322080	BUS SHELTER REMOVE AND RELOCATE	EACH	1	1				
	MAST-ARM MOUNTED																
									x0324085	EMERGENCY VEHICLE PRIORITY SYSTEM LINE	FOOT	716				716	
88102717	PEDESTRIAN SIGNAL HEAD, LED, 1-FACE, BRACKET MOUNTED WITH COUNTDOWN TIMER	EACH	8			8			_	SENSOR CABLE, NO. 20 3/C							
									X0327294	STORM SEWERS TO BE GROUTED	CU YD	2					2
88200410	TRAFFIC SIGNAL BACKPLATE, LOUVERED,	EACH	14			14											
	FORMED PLASTIC								×1400108	FULL-ACTUATED CONTROLLER AND TYPE SUPER	EACH	1			1		
88500100	INDUCTIVE LOOP DETECTOR	ЕАСН	11			11			_	R CABINET (SPECIAL)							
									×1400150	SERVICE INSTALLATION, GROUND MOUNTED,	ЕАСН	1			1		
88600100	DETECTOR LOOP, TYPE I	FOOT	903			903				METERED							
88700200	LIGHT DETECTOR	EACH	3				3		x4402805	ISLAND REMOVAL	SO FT	278	278				
88700300	LIGHT DETECTOR AMPLIFIER	EACH	1				1		x7010216	TRAFFIC CONTROL AND PROTECTION,	L SUM	1	1				
88800100	PEDESTRIAN PUSH-BUTTON	EACH	8			8											
									×8600105	MASTER CONTROLLER (SPECIAL)	EACH	1			1		
89000100	TEMPORARY TRAFFIC SIGNAL INSTALLATION	EACH	1			1											
89502300	REMOVE ELECTRIC CABLE FROM CONDUIT	FOOT	2722			2722			×8620200	UNINTERRUPTABLE POWER SUPPLY, SPECIAL	EACH	1			1		
									x8710024	FIBER OPTIC CABLE IN CONDUIT, NO.	FOOT	7150			7150		
89502375	REMOVE EXISTING TRAFFIC SIGNAL	EACH	1			1				62.5/125, MM12F SM24F						-	REV-SEP
	EQUIPMENT					 											-PARTICIPATING ITEMS
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	PLOT SCALE = 100,0000 1/ In. CH	HECKED -		REVISED	-		DI		TRANSPORT	TION FAP 372 /IL 171 (1st /				372	3091-T		COOK 103 8
	PLOT DATE = 3/27/2020 D	ATE -		REVISED	-					SCALE: SHEET NO. OF	SHEETS ST	Α. Τ	O STA.	FED. RC	AD DIST. NO. 1 I	LLINOIS FED. AID F	

	SUMMARY OF QUANTITIES				-				1		SUMM	ARY OF QUANTITIES	
CODE NO	ITEM	UNIT	TOTAL QUANTITIES	90% FEDERAL 10% STATE ROADWAY ITEMS	90% FEDERAL 10% STATE LANDSCAPING ITEMS	TRAFFIC SIGNALS IL 171 @ ROOSEVELT RD. INTERCONNECT	TRAFFIC SIGNALS 80% FEDERAL 20% VILLAGE OF FOREST PARK)	CODE NO		ITEM	UNII
				0004	0031	0021	0021	0043					
x8760055	PEDESTRIAN PUSH-BUTTON POST, TYPE A	EACH	1			1							
Z001 3798	CONSTRUCTION LAYOUT	LSUM	1	1						ļ			
Z0030850	TEMPORARY INFORMATION SIGNING	SO FT	102.8	102.8									
Z0033046	RE-OPTIMIZE TRAFFIC SIGNAL SYSTEM LEVEL	ЕАСН	1			1							
	2												
Z0062456	TEMPORARY PAVEMENT	SO YD	31	31									
Z0073510	TEMPORARY TRAFFIC SIGNAL TIMING	EACH	1			1							
Z0076600		HOUR	500	500									
Z00766 04	TRAINEES - TRAINING PROGRAM GRADUATE	HOUR	500	500									
] [] [
FILE NAME = pw:\\planroom.dot.JIIIn	USER NAME = Velichtowv DI nols.gov;PWIDDT\DocumentsVDDT Offices\District \Projects\PII36i2\CADData\Design\PII36i2\sht	ESIGNED - RAWN -	1	REVISED REVISED			1	ST	ATE OF	ILLINOIS	I		SUMMARY OF QU
		HECKED - ATE -		REVISED REVISED	-		D			RANSPORT	TION	FAP 372 /IL SCALE: SHEET NO.	171 (1st AVENUE)

IIT	TOTAL QUANTITIES			NSTRUCTIO			JDE	
								Ø 0042
					*	SPE		REV-SEP
						NO	N-PARTICIPATIN	G ITEMS
			F.A.P. RTE. 372	SECTI 3091-TS8				DTAL SHEET EETS NO. 03 9
) AT I STA.	ROOSEVELT R	D STA.	,	AD DIST. NO. 1 [IL			ONTRACT	



USER NAME = steedpa	DESIGNED -	REVISED -		F	XISTING		OPOSED TYPICAL	SECTIONS	F.A.P. BTE	SECTION	COUNTY	TOTAL SHEET
	DRAWN -	REVISED -	STATE OF ILLINOIS	_		TE 474/4			372	3091-TS&N-1	соок	103 10
PLOT SCALE = 99.9900 / in.	CHECKED -	REVISED -	DEPARTMENT OF TRANSPORTATION	FAP 3/4	2 /IL ROU		ST AVENUE) AT	NUUSEVELI NUAD			CONTRACT	T NO 62A38
PLOT DATE = 3/26/2020	DATE -	REVISED -		SCALE: NONE	SHEET	OF	SHEETS STA.	TO STA.		ILLINOIS F	ED. AID PROJECT	

(1) EXISTING P.C.C. PAVEMENT ±10"

(2) EXISTING BITUMONOUS SURFACE ± 7 " (AFTER MILLING)

(3) EXISTING CONBINATION CONCRETE CURB AND GUTTER, TYPE B-6.24

(4) EXISTING P.C.C. SIDEWALK

5 EXISTING SUB-BASE GRANULAR MATERIAL

(6) PROPOSED AGGREGATE SUBGRADE IMPROVEMENT, 12"

(7) PROPOSED HOT-MIX ASPHALT SURFACE REMOVAL, $2\frac{1}{2}$ "

(8) PROPOSED HOT-MIX ASPHALT BASE COURSE, $7\frac{1}{2}$

(9) PROPOSED POLYMERIZED HOT-MIX ASPHALT BINDER COURSE, IL-4.75, N50, $\frac{3}{4}$ "

(10) PROPOSED POLYMERIZED HOT-MIX ASPHALT SURFACE COURSE, MIX "E", N70, $1\frac{3}{4}$ "

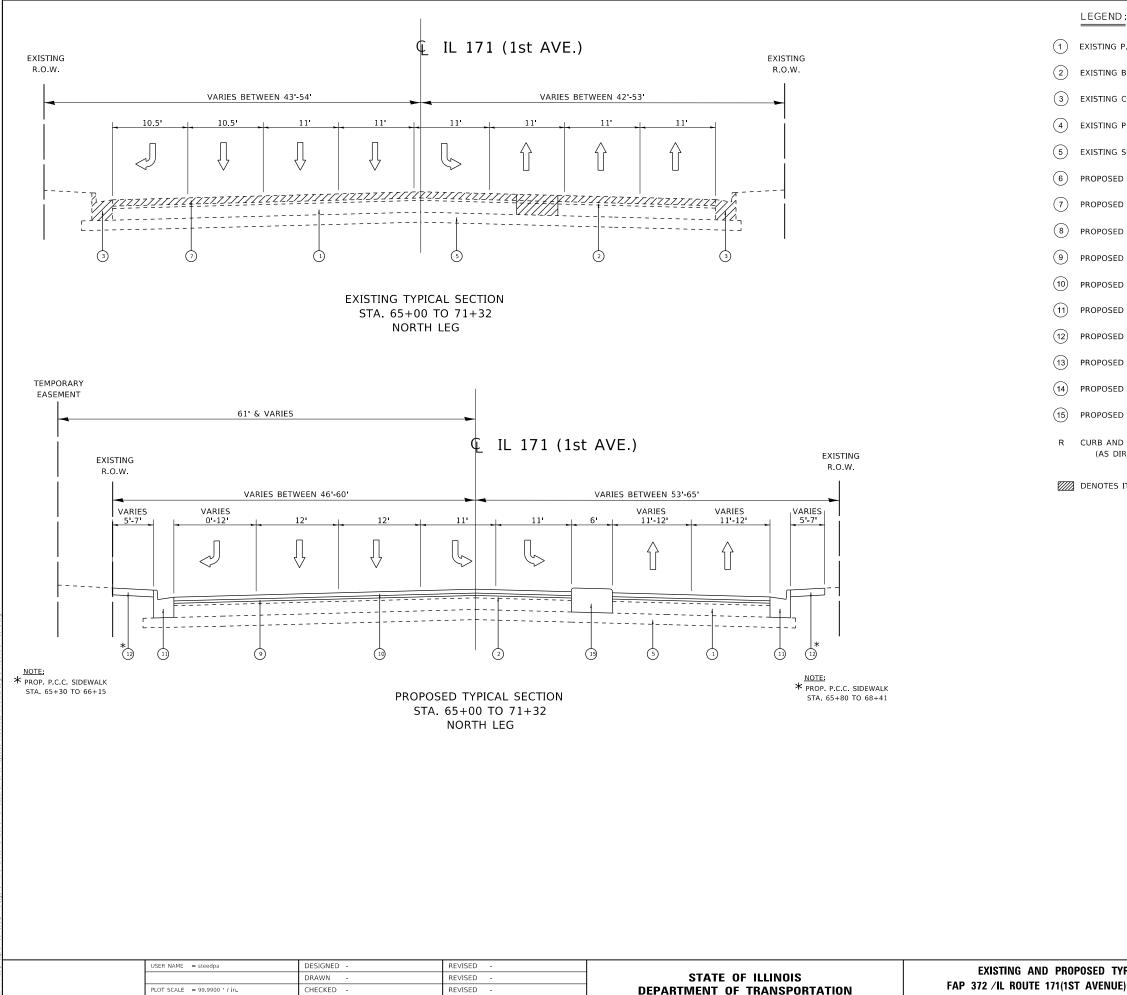
(1) PROPOSED COMBINATION CONCRETE CURB AND GUTTER, TYPE B-6.24

(12) PROPOSED P.C.C. SIDEWALK

(13) PROPOSED TOPSOIL FURNISH AND PLACE, 4"

(15) PROPOSED P.C.C. BARRIER MEDIAN

R CURB AND GUTTER REMOVAL AND REPLACEMENT (AS DIRECTED BY THE ENGINEER)



REVISED

PLOT DATE = 3/26/2020

DATE

SCALE: NONE SHEET OF SHEET

(1) EXISTING P.C.C. PAVEMENT ±10"

(2) EXISTING BITUMONOUS SURFACE ±7" (AFTER MILLING)

(3) EXISTING CONBINATION CONCRETE CURB AND GUTTER, TYPE B-6.24

(4) EXISTING P.C.C. SIDEWALK

5 EXISTING SUB-BASE GRANULAR MATERIAL

PROPOSED AGGREGATE SUBGRADE IMPROVEMENT, 12*

PROPOSED HOT-MIX ASPHALT SURFACE REMOVAL, $2\frac{1}{2}$ "

(8) PROPOSED HOT-MIX ASPHALT BASE COURSE, $7\frac{1}{2}$ "

PROPOSED POLYMERIZED HOT-MIX ASPHALT BINDER COURSE, IL-4.75, N50, $\frac{3}{4}$

PROPOSED POLYMERIZED HOT-MIX ASPHALT SURFACE COURSE, MIX "E", N70, $1\frac{3}{4}$ "

(1) PROPOSED COMBINATION CONCRETE CURB AND GUTTER, TYPE B-6.24

(12) PROPOSED P.C.C. SIDEWALK


PROPOSED TOPSOIL FURNISH AND PLACE, 4

PROPOSED SODDING

(15) PROPOSED P.C.C. BARRIER MEDIAN

R CURB AND GUTTER REMOVAL AND REPLACEMENT (AS DIRECTED BY THE ENGINEER)

D	TYPICA	L SECTIONS	F.A.P. RTE	SECT	TION		COUNTY	TOTAL SHEETS	SHEET NO.
FNI	IIF) AT	ROOSEVELT ROAD	372	3091-T	S&N-1		СООК	103	11
		NOOSEVEET NOAD					CONTRACT	NO. 62	2A38
TS	STA.	TO STA.			ILLINOIS	FED. A	D PROJECT		

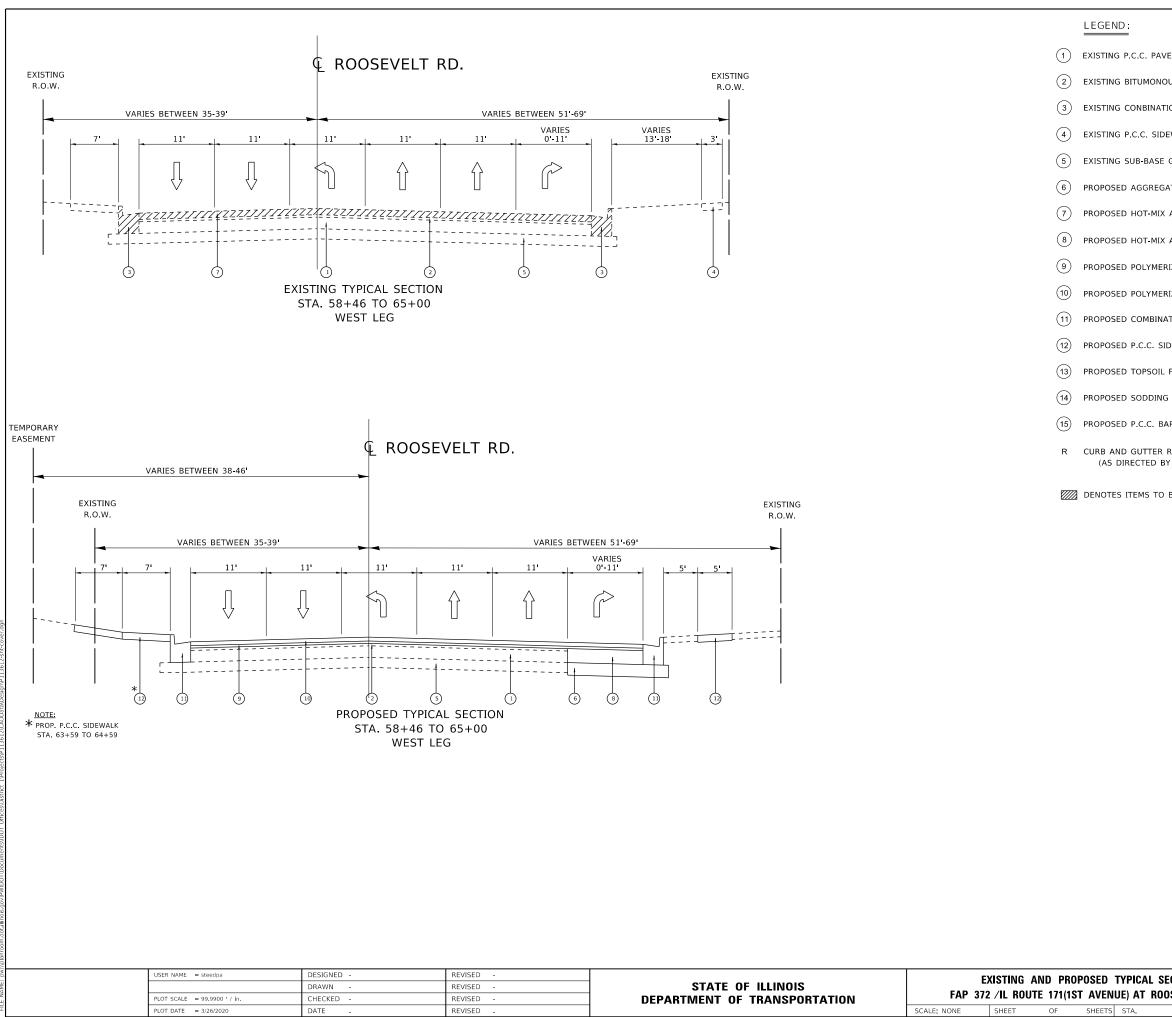

(1) EXISTING P.C.C. PAVEMENT $\pm 10^{\circ}$

(2) EXISTING BITUMONOUS SURFACE ±7" (AFTER MILLING)

(3) EXISTING CONBINATION CONCRETE CURB AND GUTTER, TYPE B-6.24

(4) EXISTING P.C.C. SIDEWALK

5 EXISTING SUB-BASE GRANULAR MATERIAL

PROPOSED AGGREGATE SUBGRADE IMPROVEMENT, 12"

(7) PROPOSED HOT-MIX ASPHALT SURFACE REMOVAL, 2¹/₂

8 PROPOSED HOT-MIX ASPHALT BASE COURSE, 7¹/₂"

PROPOSED POLYMERIZED HOT-MIX ASPHALT BINDER COURSE, IL-4.75, N50, $\frac{3}{4}$

(10) PROPOSED POLYMERIZED HOT-MIX ASPHALT SURFACE COURSE, MIX "E", N70, $1\frac{3}{4}$ "

(1) PROPOSED COMBINATION CONCRETE CURB AND GUTTER, TYPE B-6.24


(12) PROPOSED P.C.C. SIDEWALK

(13) PROPOSED TOPSOIL FURNISH AND PLACE, 4"

(15) PROPOSED P.C.C. BARRIER MEDIAN

R CURB AND GUTTER REMOVAL AND REPLACEMENT (AS DIRECTED BY THE ENGINEER)

D	TYPICA	L SECTIONS	F.A.P. RTE	SECT	ION		COUNTY	TOTAL SHEETS	SHEET NO.
ENI		ROOSEVELT ROAD	372	3091-T	S&N-1		СООК	103	12
		NOOSEVEET NOAD					CONTRACT	NO. 62	2A38
тs	STA.	TO STA.			ILLINOIS	FED. AI	D PROJECT		

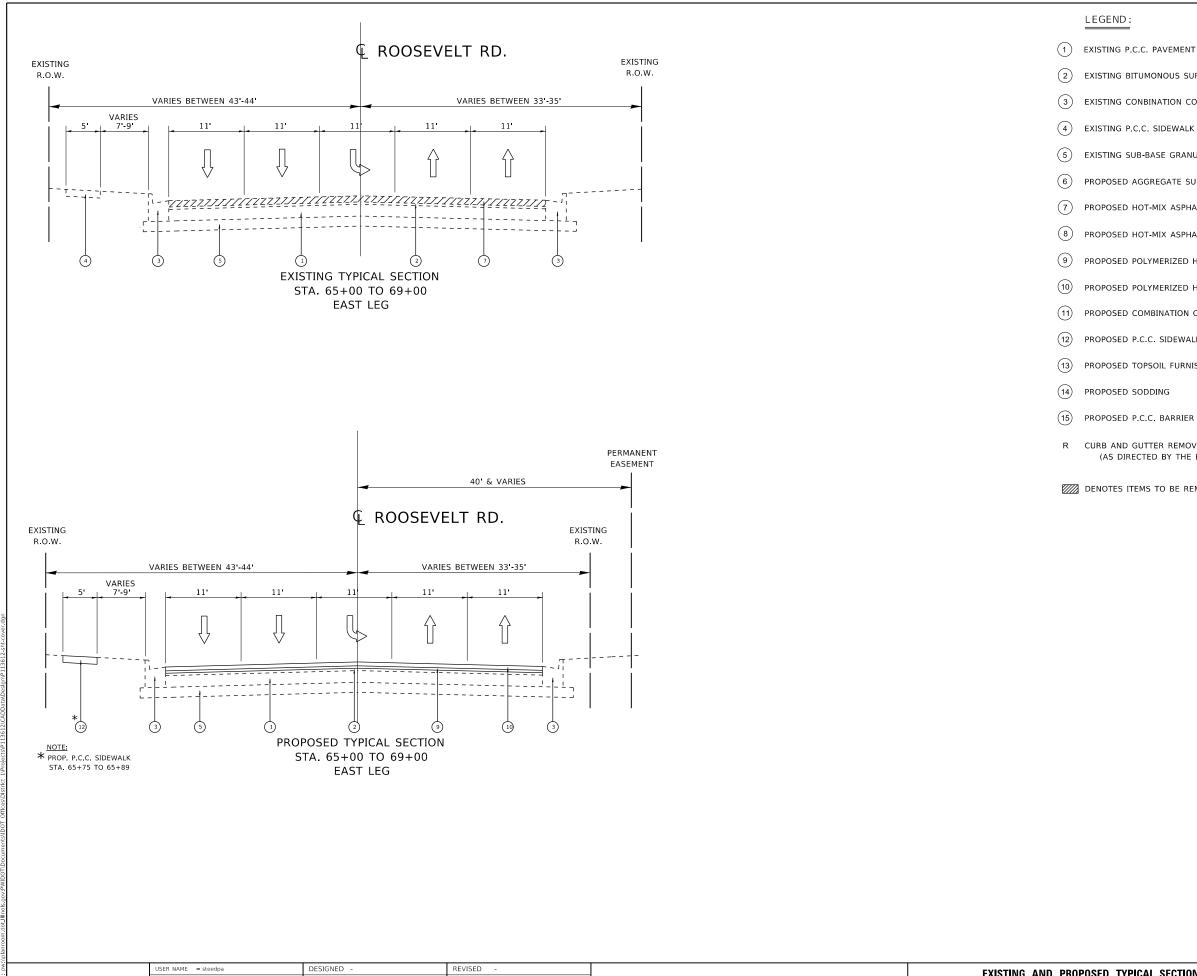

USER NAME = steedpa	DESIGNED -	REVISED -			EXISTING		OPOSED	туріс	AL SECTIONS	F.A.P. BTF	SECTION	COUNTY	TOTAL	SHEET
	DRAWN -	REVISED -	STATE OF ILLINOIS	FAD 0					ROOSEVELT ROAD	372	3091-TS&N-1	СООК	103	13
PLOT SCALE = 99.9900 / in.	CHECKED -	REVISED -	DEPARTMENT OF TRANSPORTATION	FAP 3	72 / IL NUU		SI AVEN	NUE) AI	RUUSEVELI RUAD			CONTRAC	T NO. 6	52A38
PLOT DATE = 3/26/2020	DATE -	REVISED -		SCALE: NONE	SHEET	OF	SHEETS	5 STA.	TO STA.		ILLINOIS FEE	AID PROJECT		

(1) EXISTING P.C.C. PAVEMENT $\pm 10^{\circ}$ (2) EXISTING BITUMONOUS SURFACE ± 7 " (AFTER MILLING)

(3) EXISTING CONBINATION CONCRETE CURB AND GUTTER, TYPE B-6.24

5 EXISTING SUB-BASE GRANULAR MATERIAL

(6) PROPOSED AGGREGATE SUBGRADE IMPROVEMENT, 12"

(7) PROPOSED HOT-MIX ASPHALT SURFACE REMOVAL, $2\frac{1}{2}$ "

(8) PROPOSED HOT-MIX ASPHALT BASE COURSE, $7\frac{1}{2}$

PROPOSED POLYMERIZED HOT-MIX ASPHALT BINDER COURSE, IL 4.75, N50, $\frac{3}{4}$

(10) PROPOSED POLYMERIZED HOT-MIX ASPHALT SURFACE COURSE, MIX "E", N70, $1\frac{3}{4}$ "

(1) PROPOSED COMBINATION CONCRETE CURB AND GUTTER, TYPE B-6.24

(12) PROPOSED P.C.C. SIDEWALK

(13) PROPOSED TOPSOIL FURNISH AND PLACE, 4"

PROPOSED SODDING

(15) PROPOSED P.C.C. BARRIER MEDIAN

R CURB AND GUTTER REMOVAL AND REPLACEMENT (AS DIRECTED BY THE ENGINEER)

EARTHWORK SCHEDULE FOR IL 171 (1st AVENUE)

LOCATION	EARTH EXCAVATION	EARTH EXCAVATION ADJUSTED FOR SHRINKAGE (^{SHRINKAGE FACTOR})	EMBANKMENT	EARTHWORK BALANCE WASTE (+) OR SHORTAGE (-)
	CUBIC YARDS	CUBIC YARDS	CUBIC YARDS	CUBIC YARDS
STA. 62+00 TO 63+00	0	0	0	0
STA. 63+00 TO 64+00	0	0	0	0
STA. 64+00 TO 66+00	6.15	5.23	0	+5.23
STA. 66+00 TO 67+00	3.07	2.61	0	+2.61
TOTAL	9.22	7.84	0	+7.84

EARTHWORK SCHEDULE FOR ROOSEVELT RD.

LOCATION	EARTH EXCAVATION	EARTH EXCAVATION ADJUSTED FOR SHRINKAGE (^{SHRINKAGE FACTOR})	EMBANKMENT	EARTHWORK BALANCE WASTE (+) OR SHORTAGE (-)
	CUBIC YARDS	CUBIC YARDS	CUBIC YARDS	CUBIC YARDS
STA. 59+00 TO 59+25.69	6.89	5.86	0	+5.86
STA. 59+25.69 TO 59+86.41	28.61	24.32	0	+24.32
STA. 59+86.41 TO 60+00	9.38	7.97	0	+7.97
STA. 60+00 TO 61+00	86.26	73.32	0	+73.32
STA. 61+00 TO 61+59.96	44.10	37.49	0.18	+37.31
STA. 61+59.96 TO 62+00	13.79	11.72	0.15	+11.57
STA. 62+00 TO 63+00	16.30	13.86	1.85	+12.01
STA. 63+00 TO 64+00	22.67	19.27	2.81	+16.46
STA. 64+00 TO 64+50.93	25.47	21.65	2.58	+19.07
TOTAL	253.47	215.46	7.57	+207.89

MIXTURE REQUIREMENTS

MIXTURE TYPE	AIR VOIDS @ Ndes	QMP
PAVEMENT PATCHING		
CLASS "D" PATCHES (HMA BINDER COURSE, IL-19MM)	4% @ 70 GYR.	QC / QA

PAVEMENT RESURFACING

POLYMERIZED HOT-MIX ASPHALT SURFACE COURSE, MIX "E", N70 (IL-9.5MM), $1\frac{3}{4}$ "	4% @ 70 GYR.	QCP
POLYMERIZED HOT-MIX ASPHALT BINDER COURSE, IL-4.75, N50, $\frac{3}{4}$ "	3.5% @ 50 GYR.	QC / QA

PAVEMENT WIDENING

POLYMERIZED HOT-MIX ASPHALT SURFACE COURSE, MIX "E", N70, $1\frac{3}{4}$ " (IL-9.5MM)	4% @ 70 GYR.	QC / QA
POLYMERIZED HOT-MIX ASPHALT BINDER COURSE, IL-4.75, N50, $\frac{3}{4}$ "	3.5% @ 50 GYR.	QC / QA
HOT-MIX ASPHALT BASE COURSE, IL-19.0, N70, $7\frac{1}{2}$ "	4% @ 70 GYR.	QC / QA
QMP DESIGNATION: QUALITY CONTROL FO QUALITY CONTROL/ QUALITY ASSURANCE PAY FOR PERFORMANCE (PFP)		CP);

NOTES:

THE UNIT WEIGHT USED TO CALCULATE ALL HOT-MIX ASPHALT QUANTITIES IS 112 LBS./SQ. YD./ IN.

THE "AC TYPE" FOR POLYMERIZED HMA MIXES SHALL BE "SBS/SBR PG 76 -22" AND FOR NON-POLYMERIZED HMA THE "AC TYPE" SHALL BE "PG 64 -22" UNLESS MODIFIED BY DISTRICT ONE SPECIAL PROVISIONS.

THE MILLING SHALL BE DONE PRIOR TO PATCHING

QUALITY MANAGEMENT PROGRAM (QMP) IDENTIFIES THE PARTICULAR QUALITY CONTROL SPECIFICATION THAT APPLIES TO THE HMA MIXTURE

FOR USE OF RECYCLED MATERIALS SEE SPECIAL PROVISIONS


USER NAME = steedpa	DESIGNED -	REVISED -		SCHED	ULE OF O	UANTITIE	ES AND	міхти	RE REQUIREMENTS	F.A.P. RTE	SECTION	COUNTY	TOTAL SHEET SHEETS NO.
	DRAWN -	REVISED -	STATE OF ILLINOIS	FAP 3	72 /IL DOI	ITE 171/1	ST AVE		F ROOSEVELT ROAD	372	3091-TS&N-1	соок	103 14
PLOT SCALE = 100.0000 / in.	CHECKED -	REVISED -	DEPARTMENT OF TRANSPORTATION	IAF J			ST AVLI	VUL) AI	I NOUSEVEET NUAD			CONTRAC	T NO. 62A38
PLOT DATE = 3/26/2020	DATE -	REVISED -		SCALE: NONE	SHEET	OF 1	SHEETS	S STA.	TO STA.		ILLINOIS	FED. AID PROJECT	

STRUCTURES ON:

MH, TY-A, 4 FT. DIA., W/ TY-1 FR CL STA. 61+16, 47.5 FT. (RT) T.G. 624.30 INV. 616.74 B 36" DIA., STORM SEWER CLASS A, TY-2, 82.1 F TBF = 72 CU YDS. G CB, TY-A, 4 FT. DIA., W/ TY-1 FR OP L STA. 62+19, 41.7 FT. (RT) T.G. 623.21 INV. 617.56 (10) 36" DIA., STORM SEWER CLASS A, TY-1, 93.9 F
CB, TY-A, 4 FT. DIA., W/ TY-1 FR OP L STA. $62+19$, 41.7 FT. (RT) T.G. 623.21 INV. 617.56 TBF = 27 CU YDS. TBF = 27 CU YDS. (10) 36" DIA., STORM SEWER CLASS A, TY-1, 93.9 F
INV. 617.56 36" DIA., STORM SEWER CLASS A, TY-1, 93.9 F
TBF = 82 CU YDS.
MH, TY-A, 4 FT. DIA., W/ TY-1 FR CL STA. 62+25, 50.6 FT. (RT) T.G. 624.10 INV. 617.53 36" DIA., STORM SEWER CLASS A, TY-1, 103.7 FT. TBF = 90 CU YDS.
$\begin{array}{c} 12 \\ 15^{"} \text{ DIA., STORM SEWER CLASS A, TY-1, 30.7 FT.} \\ \text{TBF} = 11 \text{ CU YDS.} \end{array}$
<u>ON:</u>
DUTE 171 (1ST AVENUE)
12" DIA., STORM SEWER CLASS A, TY-1, 37.6 FT. ROOSEVELT ROAD TBF = 13 CU YDS.
(13) 12" DIA., STORM SEWER CLASS A, TY-2, 65.4 FT. TBF = 22 CU YDS.
12" DIA., STORM SEWER CLASS A, TY-1, 77.2 FT. TBF = 25 CU YDS.
$\begin{array}{c} 14 \\ \text{TBF} = 3 \text{ CU YDS.} \end{array}$
12" DIA., STORM SEWER CLASS A, TY-1, 72.5 FT. TBF = 24 CD YDS.
$\begin{array}{c} 15\\ 12" \text{ DIA., STORM SEWER CLASS A, TY-2, 5.7 FT.}\\ \text{TBF} = 2 \text{ CU YDS.} \end{array}$
15" DIA., STORM SEWER CLASS A, TY-1, 56 FT. TBF = 20 CU YDS.
(16) 12" DIA., STORM SEWER CLASS A, TY-2, 5.9 FT.TBF = 2 CU YDS.
12" DIA., STORM SEWER CLASS A, TY-1, 20.1 FT. TBF = 7 CU YDS.
12" DIA., STORM SEWER CLASS A, TY-1, 18.8 FT. TBF = 7 CU YDS.

USER NAME = steedpa	DESIGNED -	REVISED -			PROPOSI	FD PIPF A		RUCTURES	TARIF	F.A.P.	SECTION	COUNTY	TOTAL SHEET
	DRAWN -	REVISED -	STATE OF ILLINOIS							372	3091-TS&N-1	соок	103 15
PLOT SCALE = 100.0000 ' / in.	CHECKED -	REVISED -	DEPARTMENT OF TRANSPORTATION	FAP 3	2 /IL ROU		IAVEN	UE) AT RUC	OSEVELT ROAD			CONTRAC	T NO. 62A38
PLOT DATE = 3/26/2020	DATE -	REVISED -		SCALE: NONE SHEET OF 1 SHEETS STA.		TO STA.		ILLINOIS FED. /	AID PROJECT				

8	36" DIA., STORM SEWER CLASS A, TY-2, 82.1 FT. TBF = 72 CU YDS.
9	12" DIA., STORM SEWER CLASS A, TY-1, 84.3 FT. TBF = 27 CU YDS.
10	36" DIA., STORM SEWER CLASS A, TY-1, 93.9 FT. TBF = 82 CU YDS.
11	36" DIA., STORM SEWER CLASS A, TY-1, 103.7 FT. TBF = 90 CU YDS.
12	15" DIA., STORM SEWER CLASS A, TY-1, 30.7 FT. TBF = 11 CU YDS.

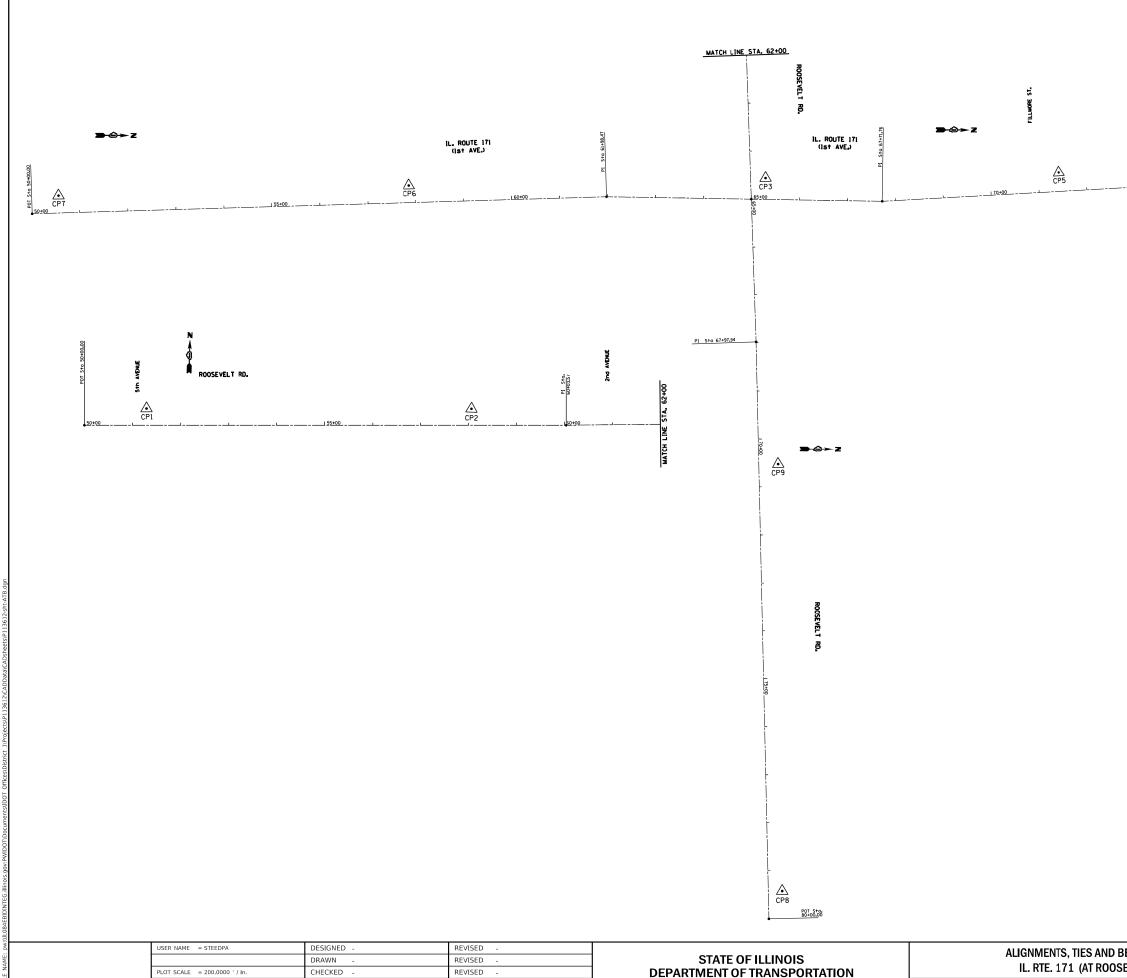

PLOT DATE = 8/31/2017

DATE

REVISED

SCALE: SHEET OF SHEETS

SITE BENCHMARK #1

CP4

ELEV. = 625.43 SET "X" CUT ON TOP OF ARROW HEAD FLANGE BOLT OF FIRE HYDRANT AT NW CORNER OF 1st AVE. AND ROOSEVELT RD.

SITE BENCHMARK #2

ELEV. = 626.19 SET "X" CUT ON TOP OF ARROW HEAD FLANGE BOLT OF FIRE HYDRANT AT NW CORNER OF 5+H AVE. AND ROOSEVELT RD.

SITE BENCHMARK #3

ELEV. = 623.80

SET SQUARE CUT ON TOP OF NE CORNER OF CONCRETE PAD FOR AN IDOT TRAFFIC CONTROL BOX AT SW CORNER OF 13+H ST. AND 1st AVE. ALSO BEING THE FIRST ENTRANCE TO LOYOLA UNIVERSITY MEDICAL CENTER SOUTH OF ROOSEVELT RD.

SITE BENCHMARK #4

ELEV. = 623.90

SET "X" CUT ON TOP OF NW FLANGE BOLT OF FIRE HYDRANT ON NORTH SIDE OF ROOSEVELT RD. AND 75' WEST AND 15' SOUTH OF SW CORNER 3 STORY BRICK BUILDING #8311 W. ROOSEVELT RD. (RIVERSIDE HOSPITAL)


SITE BENCHMARK #5

ELEV. = 626.27

SET "X" CUT ON TOP OF ARROW HEAD FLANGE BOLT OF FIRE HYDRANT AT SW CORNER OF HARVARD ST. AND 1st AVE.


	ROUTE	POINT	N	ORTHING	EASTIN	3	S	TATION	
		POT CLO1	1892	2100.6849	1120467.50	608	50	+00.00	
	IL. RTE. 171	PI CLO2	189.	3298.4156	1120425.50	520	61	+98.47	
	(1st AVE.)	PI CLO3	189	3599.9305	1120428.88	819	65	+00	
		PI CLO4	1893	3871.6740	1120431.87	740	67	+71.76	
		PI CLO5				747	71	+41.68	
		POT CLO6	189	5098.2938	1120370.6	362	80	+00	
		POT CL07	189	3552.7620	1118929.64	142	50	+00	
		PI CLO8	1893	3580.6282	1119932.83	310	60	+03.57	
	ROOSEVELT RD.	PI CLO3	189	3599 . 9305	1120428.88	319	65	+00	
		PI CLO9	189	3611.5150	1120726.5	930	67	+97.94	
		POT CL10	1893	3644.6398	1121928.20	001	80	+00	
BENC	HMARKS		F.A.P. RTE.	SEC	TION	COL	JNTY	TOTAL SHEETS	SHEE NO.
SEVE	LT RD.)		372	3091-7	ΓS&N-1		ЮК	103	16
	,						ITRACT	NO. 6	52A38
STA.	TO ST	A.			ILLINOIS FED. AI	D PROJE	СТ		

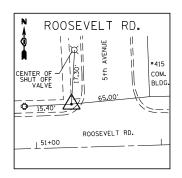Sto. 41.68



CONTROL POINT #1

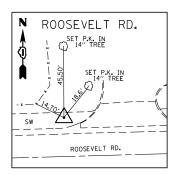SET "X" CUT IN CONC. SIDEWALK STA. 51+28.91, 34.8 LT N=1893591.1193 E=1119057.5424 ELEV.=624.42



CONTROL POINT #2

SET "X" CUT STA. 58+06.22, 34.1 LT N=1893609.2286 E=1119734.6093 ELEV.=624.96



CONTROL POINT #3

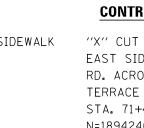
SET "X" CUT STA. 64+57.11, 31.1 LT N=1893629.3352 E=1120384.8150 ELEV.=623.65





CONTROL POINT #4


SET "X" CUT IN CONC. SIDEWALK STA. 78+05.29, 31.7 LT N=1894902.5574 E=1120346.0931 ELEV.=623.54






CONTROL POINT #7

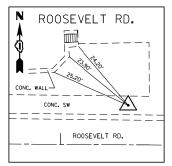SET IRON ROD STA. 50+55.86, 36.1 LT N=1892155.2400 E=1120429.4862 ELEV.=621.97



CONTROL POINT #8

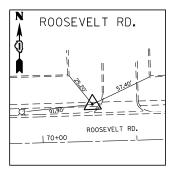SET "X" CUT IN SIDEWALK STA. 79+43.00, 28.9 LT N=1893671.9291 E=1121870.4257 ELEV.=622.74




CONTROL POINT #9

SET "X" CUT IN SIDEWALK STA. 70+53.62, 40.2 LT N=1893658.7034 E=1120981.0772 ELEV.=623.08

Nd ::	USER NAME = STEEDPA	DESIGNED -	REVISED -			ALIGN	IMENTS 1	TIFS AND	BENCHMAR	RKS	F.A.P. BTE	SECTION	COUNTY	TOTAL SHEET SHEETS NO.
AME		DRAWN -	REVISED -	STATE OF ILLINOIS		, in the second s	,				372	3091-TS&N-1	соок	103 17
ц Ц	PLOT SCALE = 200.0000 ' / in.	CHECKED -	REVISED -	DEPARTMENT OF TRANSPORTATION		IL.	RIE. 171		SEVELT RD.)				CONTRAC	CT NO. 62A38
	PLOT DATE = 8/31/2017	DATE -	REVISED -		SCALE:	SHEET	OF	SHEETS	STA.	TO STA.		ILLINOIS FED.	AID PROJECT	


CONTROL POINT #5

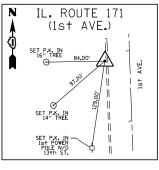
"X" CUT IN CONC. WALK ON EAST SIDE OF BUFFALO GROVE RD. ACROSS FROM GOLFVIEW TERRACE STA. 71+43.45, 39.4 LT N=1894240.2643 E=1120369.8419 ELEV.=622.79



CONTROL POINT #6

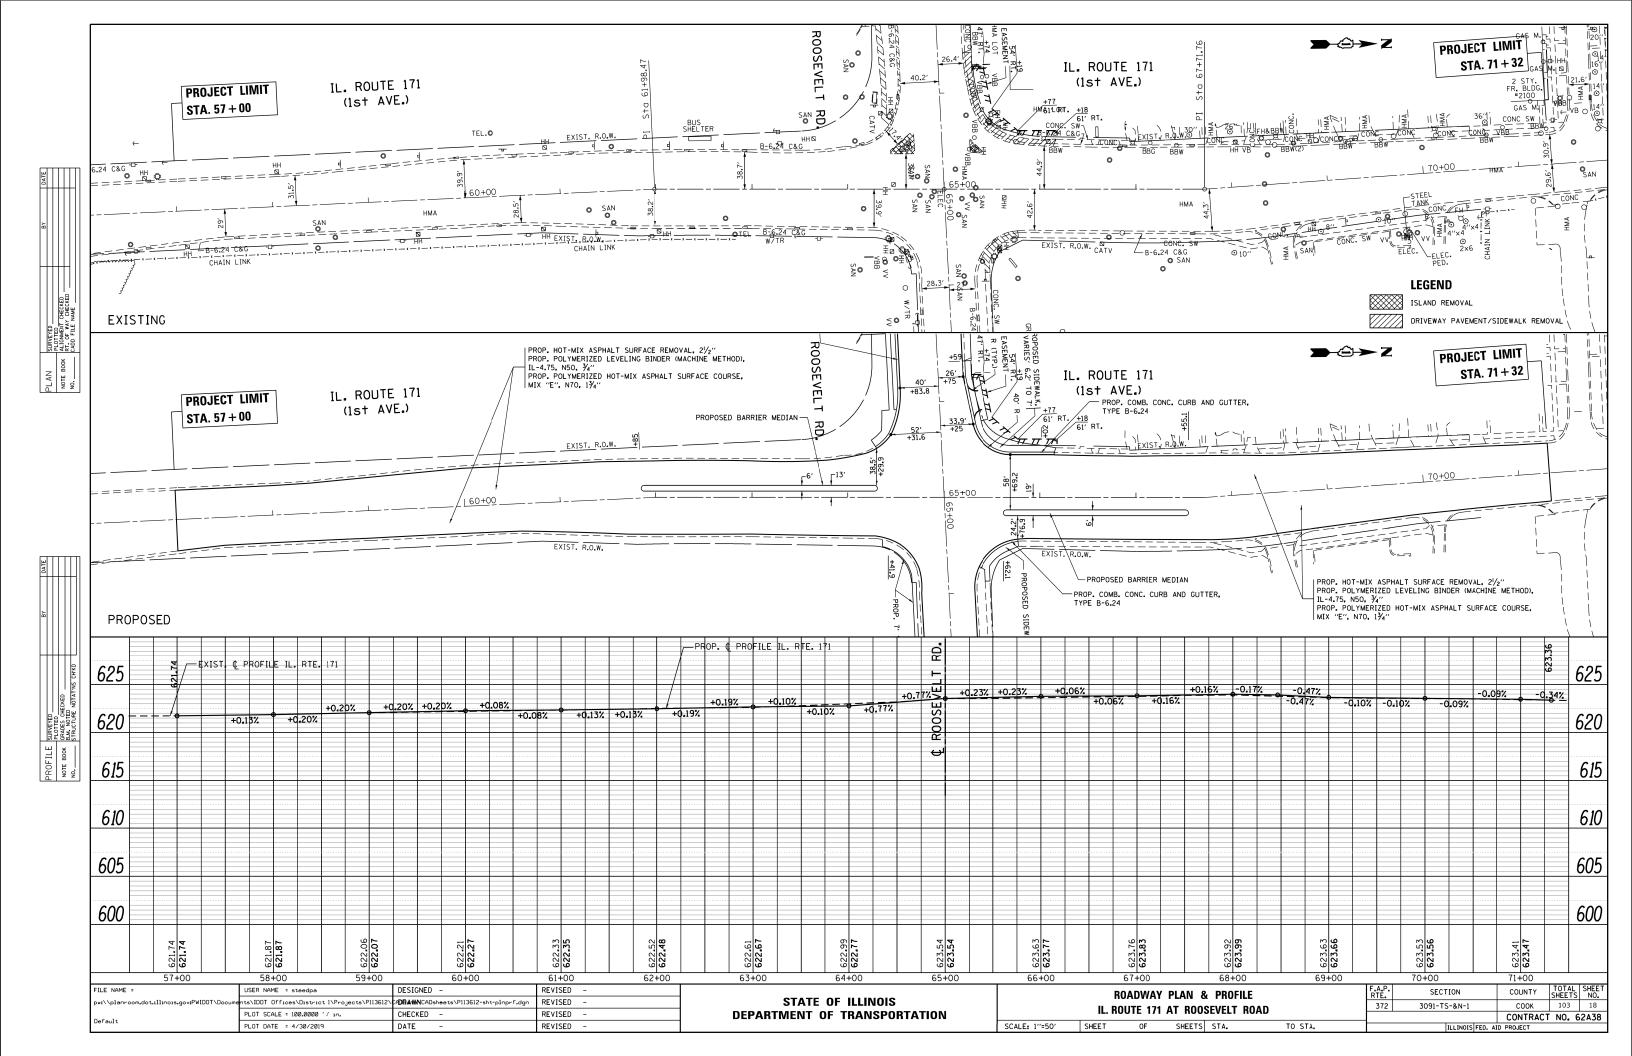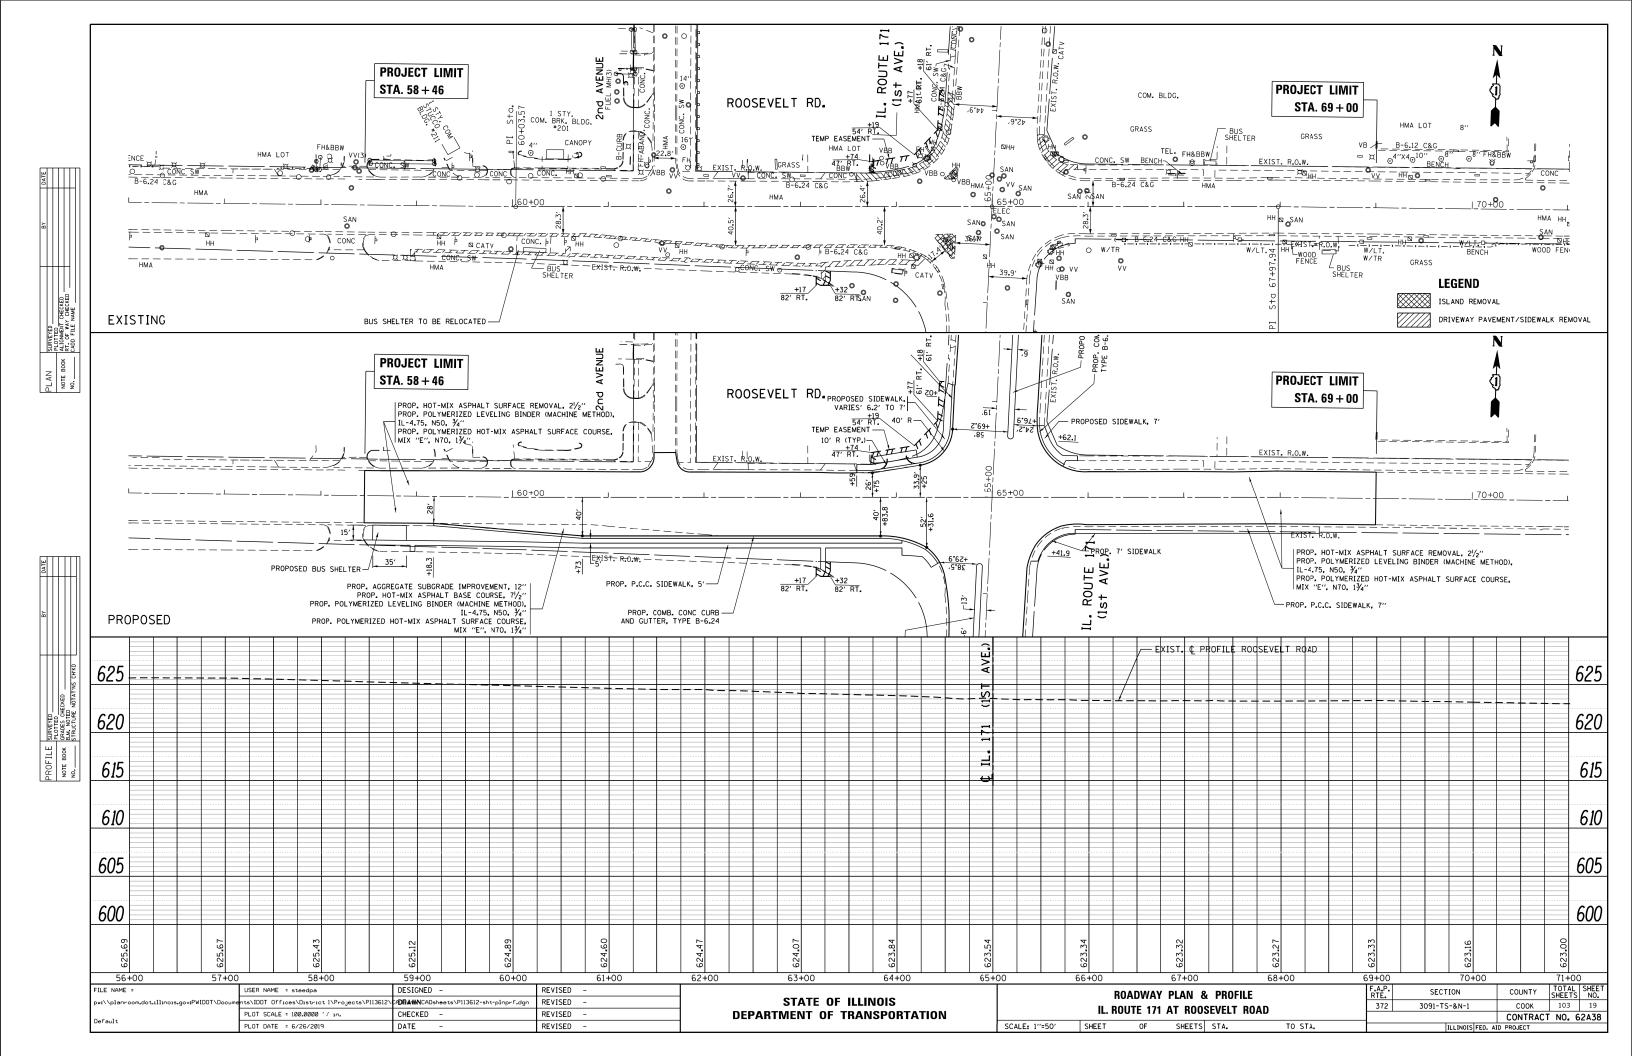SET IRON ROD STA. 57+86.67, 35.6 LT N=1892885.6287 E=1120404.4604 ELEV.=621.92





USER NAME = steedpa	DESIGNED -	REVISED -		SUG	CESTED S	TAGING	AND TRAFFIC	CONTROL NOTES	F.A.P. BTE	SECTION	COUNTY	TOTAL SHEE	ET
	DRAWN -	REVISED -	STATE OF ILLINOIS						372	3091-TS&N-1	соок	103 20	j –
PLOT SCALE = 100.0000 / in.	CHECKED -	REVISED -	DEPARTMENT OF TRANSPORTATION	FAP 3	72 /IL ROU	ITE 171(1	ST AVENUE) AT	ROOSEVELT ROAD	-		CONTRACT	F NO. 62A38	3
PLOT DATE = 3/26/2020	DATE -	REVISED -		SCALE: NONE	SHEET	OF	SHEETS STA.	TO STA.		ILLINOIS FED	. AID PROJECT		_

NOTE: ALL EROSION CONTROL MEASURES SHALL BE INSTALLED PRIOR TO BEGINNING ANY CONSTRUCTION ACTIVITIES WHICH WILL POTENTIALLY CREATE AN ERODABLE CONDITION

INSTALLATION OF THERMOPLASTIC PAVEMENT MARKING AND RAISED REFLECTIVE PAVEMENT MARKERS AS SHOWN ON THE PAVEMENT MARKING PLAN

COURSE ON IL 171 (1st AVENUE) AND ROOSEVELT ROAD

MILLING THE EXISTING HMA PAVEMENT AND INSTALLING POLYMERIZED LEVELING BINDER AND HMA SURFACE

ESTABLISH TRAFFIC CONTROL AS SHOWN ON THE SUGGESTED STAGING AND TRAFFIC CONTROL STAGE II INSTALLATION OF P.C.C. BARRIERS MEDIANS ALONG THE NORTH AND SOUTH LEGS OF IL 171 (1st AVENUE)

ESTABLISH TRAFFIC CONTROL AS SHOWN ON THE SUGGESTED STAGING AND TRAFFIC CONTROL STAGE I CONSTRUCT THE EXTENSION AND RESURFACING OF THE RIGHT TURN LANE ALONG THE WEST LEG OF EASTBOUND ROOSEVELT ROAD ADJUSTMENT OF THE NORTHWEST AND NORTHEAST CORNER RADII ON ROOSEVELT ROAD AT IL 171 (1st AVENUE) INSTALLATION OF PROP. SIDEWALK ALONG THE WEST LEG OF EASTBOUND ROOSEVELT ROAD INSTALLATION OF PROP. CURB & GUTTER, PACE BUS SHELTER AND SODDING ALONG THE WEST LEG OF EASTBOUND ROOSEVELT ROAD INSTALLATION OF PROP. P.C.C. DRIVEWAY ALONG THE WEST LEG OF WESTBOUND ROOSEVELT ROAD

INSTALLATION OF TEMPORARY PAVEMENT IN PLACE OF EXISTING P.C.C. ISLANDS ALONG SOUTHBOUND IL 171 (1st AVENUE)

REMOVE EXISTING P.C.C. ISLANDS ALONG SOUTHBOUND IL 171 (1st AVENUE)

REMOVE EXISTING SIDEWALK, CURB & GUTTER AND PACE BUS SHELTER ALONG EASTBOUND ROOSEVELT ROAD

INSTALL TEMPORARY EROSION CONTROL MEASURES AS SHOWN ON THE EROSION CONTROL PLAN (SEE NOTE)


PRE STAGE ESTABLISH TRAFFIC CONTROL AS SHOWN ON THE SUGGESTED STAGING AND TRAFFIC CONTROL PRE STAGE

STAGE I

STAGE II

STAGE III

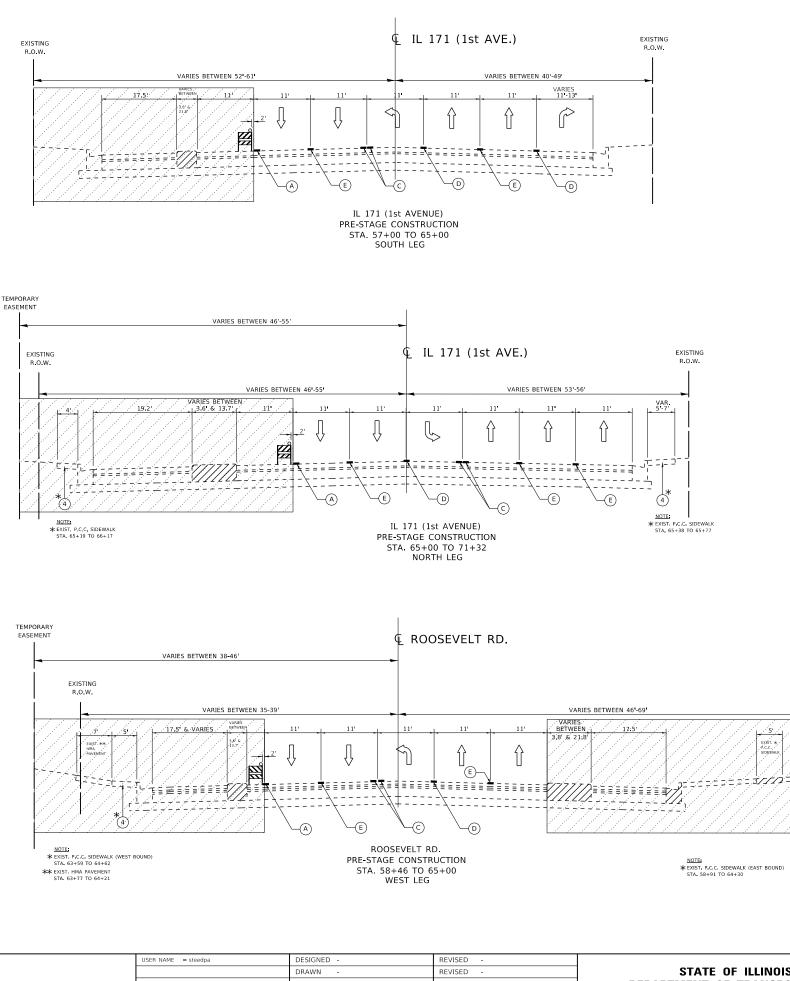THE APPROPRIATE TRAFFIC CONTROL AND PROTECTION STANDARDS WILL BE UTILIZED WHEN PERFORMING THIS WORK




(1) EXISTING P.C.C. PAVEMENT $\pm 10^{\circ}$ (4) EXISTING P.C.C. SIDEWALK 5 EXISTING SUB-BASE GRANULAR MATERIAL (7)

LEGEND:

- 8 PROPOSED HOT-MIX ASPHALT BASE COURSE, $7\frac{1}{2}$ "
- (9)
- (11)
- (12) PROPOSED P.C.C. SIDEWALK
- (13) PROPOSED TOPSOIL FURNISH AND PLACE, 4"
- (14) PROPOSED SODDING
- (15) PROPOSED P.C.C. BARRIER MEDIAN

PAVEMENT MARKING LEGEND:

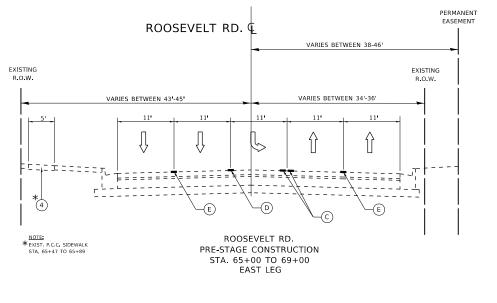- (A) PAVEMENT MARKING TAPE, TYPE IV, EDGE LINE, 4" WHITE (B) PAVEMENT MARKING TAPE, TYPE IV, EDGE LINE, 4" YELLOW
- (E) PAVEMENT MARKING TAPE, TYPE IV, SKIP DASH, 4" WHITE
- (F) PAVEMENT MARKING TAPE, TYPE IV, DIAGONALS, 12" YELLOW
- G PAVEMENT MARKING TAPE, TYPE IV, STOP BARS, 24 YELLOW



USER NAME = steedpa	DESIGNED -	REVISED -		SUGGESTEI) STAGIN	G AND	TRAFFIC CONTROL	TYPICAL SECTION	F.A.P. RTE	SECTION	COUNTY TOTAL SHEETS	SHEET NO.
	DRAWN -	REVISED -	STATE OF ILLINOIS	FAP 372		TE 171/10	ST AVENUE) AT RO		372	3091-TS&N-1	СООК 103	21
PLOT SCALE = 100.0000 / in.	CHECKED -	REVISED -	DEPARTMENT OF TRANSPORTATION	FAF 372			SI AVENUE, AI NU	JUSEVELI NUAD			CONTRACT NO. 62	2A38
PLOT DATE = 3/26/2020	DATE -	REVISED -		SCALE: NONE	SHEET	OF	SHEETS STA.	TO STA.		ILLINOIS FED.	AID PROJECT	

EXIST *

EXISTING

R.O.W.

(2) EXISTING BITUMONOUS SURFACE ±7" (AFTER MILLING) (3) EXISTING CONBINATION CONCRETE CURB AND GUTTER, TYPE B-6.24 (6) PROPOSED AGGREGATE SUBGRADE IMPROVEMENT, 12" PROPOSED HOT-MIX ASPHALT SURFACE REMOVAL, $2^{\frac{1}{2}}$ PROPOSED POLYMERIZED HOT MIX ASPAHLT BINDER COURSE, IL-4.75, N50, $\frac{3}{4}$

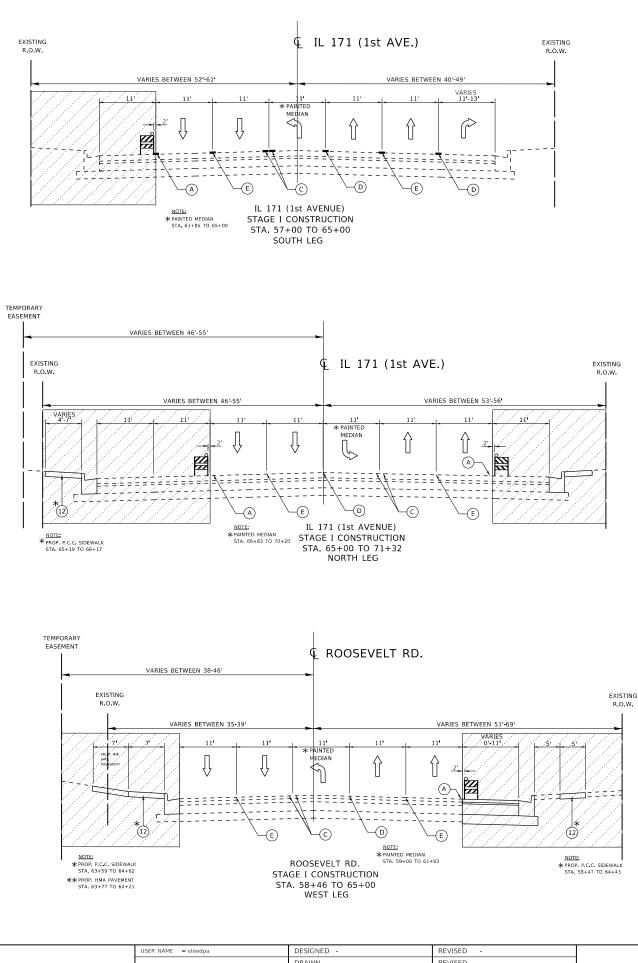
(10) PROPOSED POLYMERIZED HOT-MIX ASPHALT SURFACE COURSE, MIX "E", N70, $1\frac{3}{4}$ "

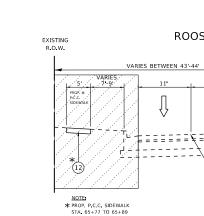
PROPOSED COMBINATION CONCRETE CURB AND GUTTER, TYPE B-6.24

DENOTES ITEMS TO BE REMOVED WORK AREA FOR CONSTRUCTION (WORK ZONE)

(C) PAVEMENT MARKING TAPE, TYPE IV, DOUBLE YELLOW CENTERLINE, 4"

(D) PAVEMENT MARKING TAPE, TYPE IV, TURN LANE LINE, 6" WHITE






USER NAME = steedpa	DESIGNED -	REVISED -		SUGGESTE) STAGI	NG AND	TRAFFIC	C CON	ITROL TYPICAL	. SECTION	F.A.P. RTE	SECTION	COUNTY	TOTAL SHEET SHEETS NO.
	DRAWN -	REVISED -	STATE OF ILLINOIS	FAP 37	2 /IL ROL	ITE 171/1	ST AVE		AT ROOSEVELT	BUVD	372	3091-TS&N-1	соок	103 22
PLOT SCALE = 100.0000 / in.	CHECKED -	REVISED -	DEPARTMENT OF TRANSPORTATION							IIUAD	_		CONTRAC	T NO. 62A38
PLOT DATE = 3/26/2020	DATE -	REVISED -		SCALE: NONE	SHEET	OF	SHEETS	S STA.	. то) STA.		ILLINOIS FED.	AID PROJECT	

LEGEND:


- (1) EXISTING P.C.C. PAVEMENT ±10"
- (2) EXISTING BITUMONOUS SURFACE ±7" (AFTER MILLING)
- (3) EXISTING CONBINATION CONCRETE CURB AND GUTTER, TYPE B-6.24
- (4) EXISTING P.C.C. SIDEWALK
- 5 EXISTING SUB-BASE GRANULAR MATERIAL
- (6) PROPOSED AGGREGATE SUBGRADE IMPROVEMENT, 12•
- $\overline{7}$ PROPOSED HOT-MIX ASPHALT SURFACE REMOVAL, 2¹/₂"
- 8 PROPOSED HOT-MIX ASPHALT BASE COURSE, $7\frac{1}{2}$
- (9) PROPOSED POLYMERIZED HOT-MIX ASPHALT BINDER COURSE, IL-4.75, N50, $\frac{3}{4}$
- (10) PROPOSED POLYMERIZED HOT-MIX ASPHALT SURFACE COURSE, MIX "E", N70, $1\frac{3}{4}$ "
- (11) PROPOSED COMBINATION CONCRETE CURB AND GUTTER, TYPE B-6.24
- (12) PROPOSED P.C.C. SIDEWALK
- (13) PROPOSED TOPSOIL FURNISH AND PLACE, 4"
- (14) PROPOSED SODDING
- (15) PROPOSED P.C.C. BARRIER MEDIAN

DENOTES ITEMS TO BE REMOVED WORK AREA FOR CONSTRUCTION (WORK ZONE)

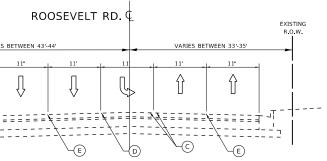- PAVEMENT MARKING LEGEND:
- (A) PAVEMENT MARKING TAPE, TYPE IV, EDGE LINE, 4" WHITE
- (B) PAVEMENT MARKING TAPE, TYPE IV, EDGE LINE, 4" YELLOW
- C PAVEMENT MARKING TAPE, TYPE IV, DOUBLE YELLOW CENTERLINE, 4"
- (D) PAVEMENT MARKING TAPE, TYPE IV, TURN LANE LINE, 6" WHITE
- E PAVEMENT MARKING TAPE, TYPE IV, SKIP DASH, 4" WHITE
- (F) PAVEMENT MARKING TAPE, TYPE IV, DIAGONALS, 12" YELLOW
- G PAVEMENT MARKING TAPE, TYPE IV, STOP BARS, 24" YELLOW




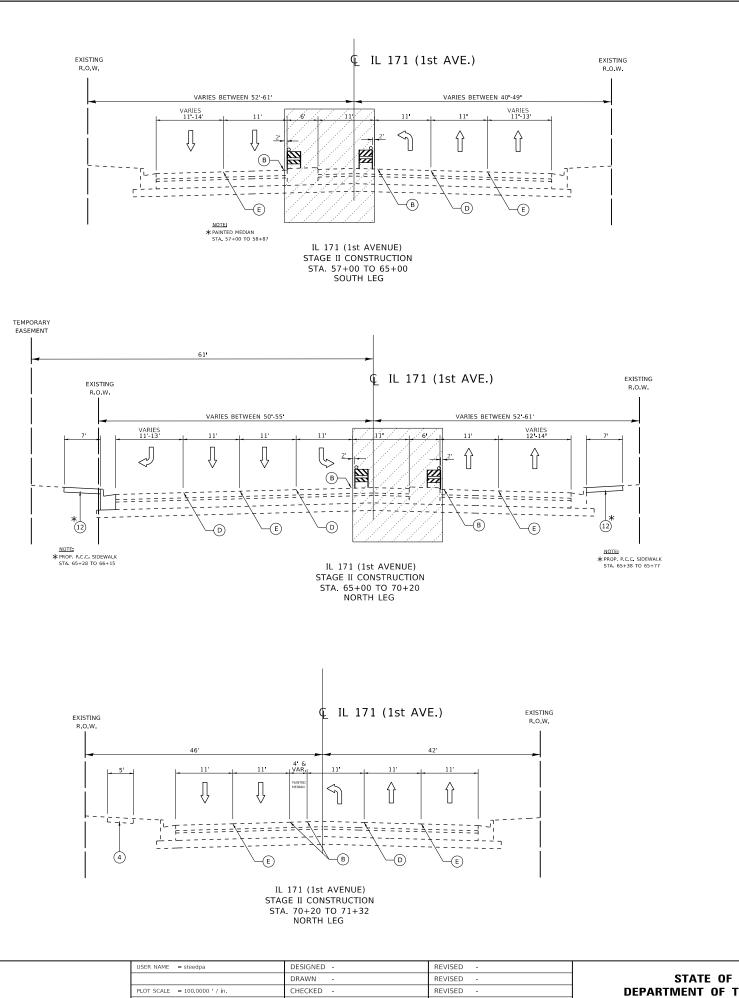
ROOSEVELT RD. STAGE I CONSTRUCTION STA. 65+00 TO 69+00 EAST LEG




PAVEMENT MARKING LEGEND:

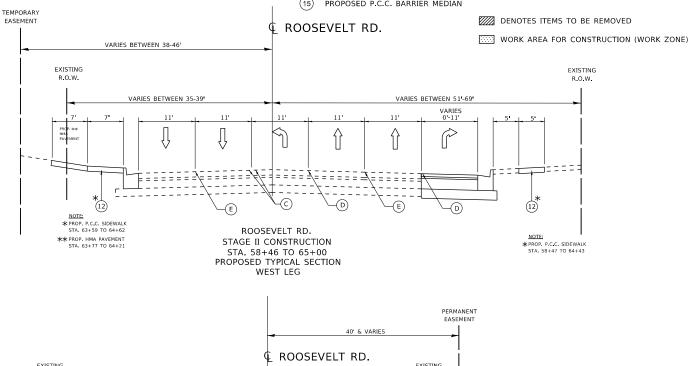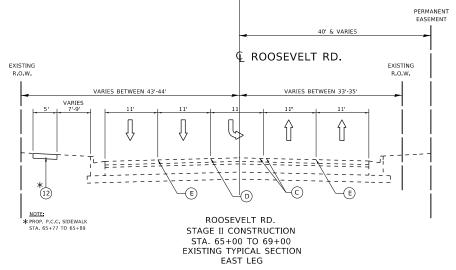- (A) PAVEMENT MARKING TAPE, TYPE IV, EDGE LINE, 4" WHITE
- B PAVEMENT MARKING TAPE, TYPE IV, EDGE LINE, 4" YELLOW
- C PAVEMENT MARKING TAPE, TYPE IV, DOUBLE YELLOW CENTERLINE, 4*
- (D) PAVEMENT MARKING TAPE, TYPE IV, TURN LANE LINE, 6" WHITE
- E PAVEMENT MARKING TAPE, TYPE IV, SKIP DASH, 4" WHITE
- (F) PAVEMENT MARKING TAPE, TYPE IV, DIAGONALS, 12" YELLOW
- G PAVEMENT MARKING TAPE, TYPE IV, STOP BARS, 24" YELLOW






						EAS	ST LEG							
USER NAME = steedpa	DESIGNED -	REVISED -		SUGGESTE	N STAGIN		TRAFFIC	CONTROL	L TYPICAL SECTION	F.A.P. BTE	SECTION	COUNTY	TOTAL '	SHEET
	DRAWN -	REVISED -	STATE OF ILLINOIS							372	3091-TS&N-1	соок	103	23
PLOT SCALE = 100.0000 ' / in.	CHECKED -	REVISED -	DEPARTMENT OF TRANSPORTATION	FAP 3	Z /IL KUU		SI AVEN	IUE) AT K	OOSEVELT ROAD			CONTRAC	T NO. 624	438
PLOT DATE = 3/26/2020	DATE -	REVISED -		SCALE: NONE	SHEET	OF	SHEETS	STA.	TO STA.		ILLINOIS FED.	AID PROJECT		

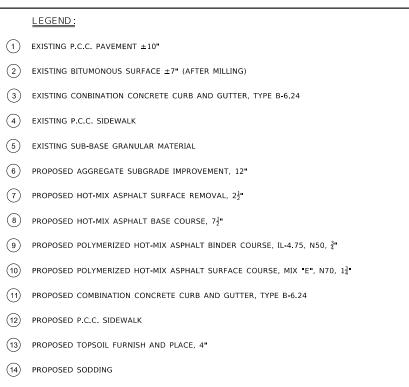

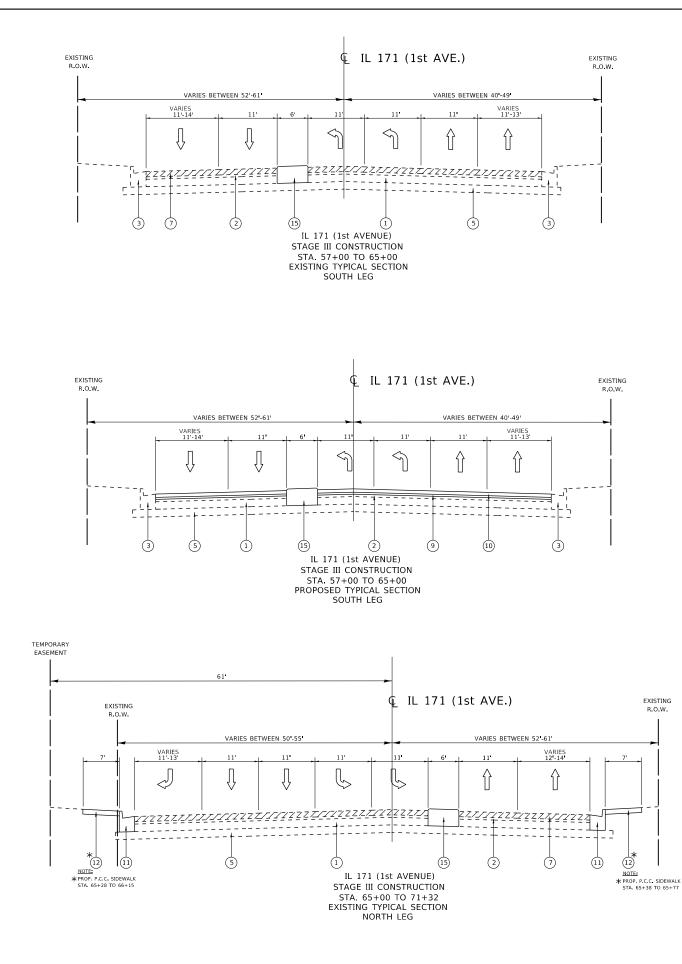(15) PROPOSED P.C.C. BARRIER MEDIAN



	LEGEND:	
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- (1) EXISTING P.C.C. PAVEMENT $\pm 10^{\circ}$
- (4) EXISTING P.C.C. SIDEWALK
- 5 EXISTING SUB-BASE GRANULAR MATERIAL

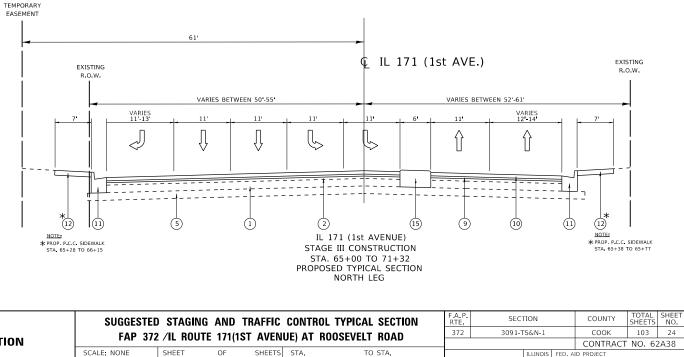
- 8 PROPOSED HOT-MIX ASPHALT BASE COURSE, $7\frac{1}{2}$ "

- (12) PROPOSED P.C.C. SIDEWALK
- (13) PROPOSED TOPSOIL FURNISH AND PLACE, 4"
- (14) PROPOSED SODDING
- (15) PROPOSED P.C.C. BARRIER MEDIAN

PAVEMENT MARKING LEGEND:

- (A) PAVEMENT MARKING TAPE, TYPE IV, EDGE LINE, 4" WHITE

- G PAVEMENT MARKING TAPE, TYPE IV, STOP BARS, 24 YELLOW




DRAWN REVISED STATE OF ILLINOIS PLOT SCALE = 100.0000 / In. CHECKED - REVISED PLOT DATE = 3/26/2020 DATE REVISED	USER NAME = steedpa	DESIGNED -	REVISED -		SUGGESTED	STAGING A			- 0
DEPARIMENT OF TRANSPORTATION		DRAWN -	REVISED -	STATE OF ILLINOIS					-
PLOT DATE = 3/26/2020 DATE _ REVISED _ SCALE: NONE SHEET OF SHEETS	PLOT SCALE = 100.0000 / in.	CHECKED -	REVISED -	DEPARTMENT OF TRANSPORTATION	FAP 3/2	IL RUUIE	11(121.1	AVENUE)
	PLOT DATE = 3/26/2020	DATE -	REVISED -		SCALE: NONE	SHEET	DF S	HEETS	,Т

(2) EXISTING BITUMONOUS SURFACE $\pm 7"$ (AFTER MILLING) (3) EXISTING CONBINATION CONCRETE CURB AND GUTTER, TYPE B-6.24 (6) PROPOSED AGGREGATE SUBGRADE IMPROVEMENT, 12" 7 PROPOSED HOT-MIX ASPHALT SURFACE REMOVAL, 2^{1}_{2} (9) PROPOSED POLYMERIZED HOT-MIX ASPHALT BINDER COURSE, IL-4.75, N50, $\frac{3}{4}$ (10) PROPOSED POLYMERIZED HOT-MIX ASPHALT SURFACE COURSE, MIX "E", N70, $1\frac{3}{4}$ "

(1) PROPOSED COMBINATION CONCRETE CURB AND GUTTER, TYPE B-6.24

DENOTES ITEMS TO BE REMOVED WORK AREA FOR CONSTRUCTION (WORK ZONE)

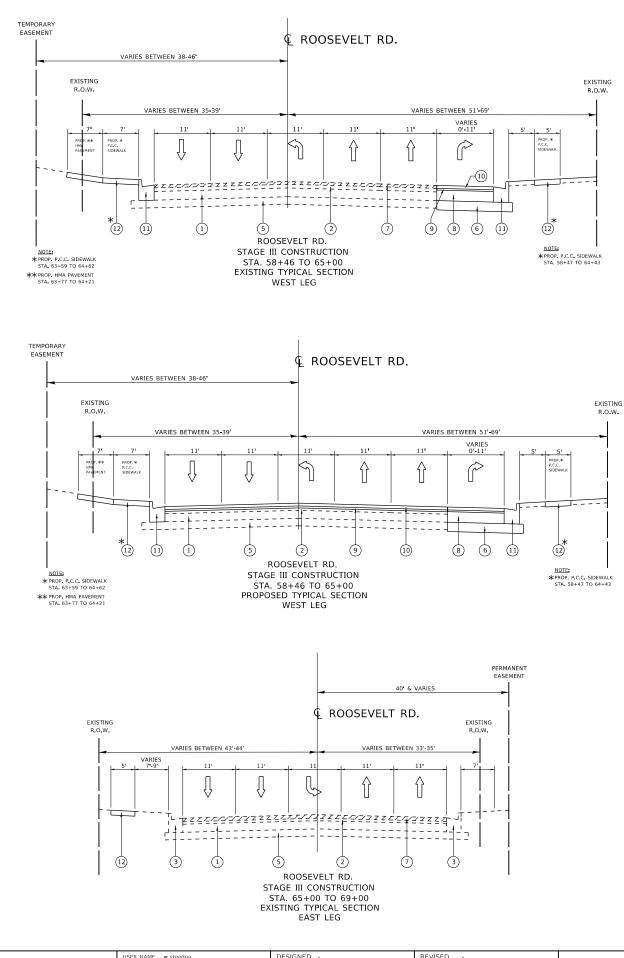(B) PAVEMENT MARKING TAPE, TYPE IV, EDGE LINE, 4" YELLOW C PAVEMENT MARKING TAPE, TYPE IV, DOUBLE YELLOW CENTERLINE, 4" (D) PAVEMENT MARKING TAPE, TYPE IV, TURN LANE LINE, 6" WHITE (E) PAVEMENT MARKING TAPE, TYPE IV, SKIP DASH, 4" WHITE (F) PAVEMENT MARKING TAPE, TYPE IV, DIAGONALS, 12" YELLOW



LEGEND:

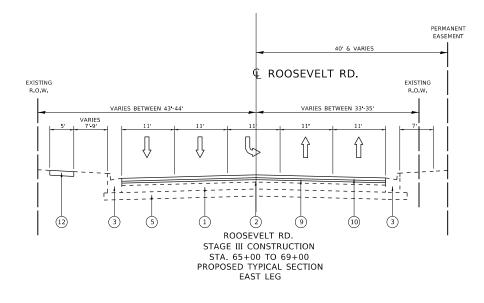
- (1) EXISTING P.C.C. PAVEMENT $\pm 10^{\circ}$

- (4) EXISTING P.C.C. SIDEWALK

- (12) PROPOSED P.C.C. SIDEWALK
- (13) PROPOSED TOPSOIL FURNISH AND PLACE, 4"
- (14) PROPOSED SODDING
- (15) PROPOSED P.C.C. BARRIER MEDIAN

PAVEMENT MARKING LEGEND:

- (B) PAVEMENT MARKING TAPE, TYPE IV, EDGE LINE, 4" YELLOW
- (D) PAVEMENT MARKING TAPE, TYPE IV, TURN LANE LINE, 6" WHITE
- (E) PAVEMENT MARKING TAPE, TYPE IV, SKIP DASH, 4" WHITE
- (F) PAVEMENT MARKING TAPE, TYPE IV, DIAGONALS, 12" YELLOW
- G PAVEMENT MARKING TAPE, TYPE IV, STOP BARS, 24" YELLOW



USER NAME = steedpa	DESIGNED -	REVISED -		SUGGEST	ED STAGIN	G AND	TRAFFIC	CONTI	ROL TYPICAL SECTION	F.A.P. RTE	SECTION	COUNTY	TOTAL SHEET SHEETS NO.
	DRAWN -	REVISED -	STATE OF ILLINOIS						ROOSEVELT ROAD	372	3091-TS&N-1	соок	103 25
PLOT SCALE = 100.0000 ' / in.	CHECKED -	REVISED -	DEPARTMENT OF TRANSPORTATION				ST AVLI	UUL) AI	NUUSEVEET NUAD			CONTRACT	F NO. 62A38
PLOT DATE = 3/26/2020	DATE -	REVISED -		SCALE: NONE	SHEET	OF	SHEETS	S STA.	TO STA.		ILLINOIS FED	AID PROJECT	

(2) EXISTING BITUMONOUS SURFACE $\pm 7"$ (AFTER MILLING) (3) EXISTING CONBINATION CONCRETE CURB AND GUTTER, TYPE B-6.24 5 EXISTING SUB-BASE GRANULAR MATERIAL (6) PROPOSED AGGREGATE SUBGRADE IMPROVEMENT, 12" 7 PROPOSED HOT-MIX ASPHALT SURFACE REMOVAL, 22 8 PROPOSED HOT-MIX ASPHALT BASE COURSE, $7\frac{1}{2}$ (9) PROPOSED POLYMERIZED HOT-MIX ASPHALT BINDER COURSE, IL-4.75, N50, $\frac{3}{4}$

(10) PROPOSED POLYMERIZED HOT-MIX ASPHALT SURFACE COURSE, MIX "E", N70, $1\frac{3}{4}$ "

(1) PROPOSED COMBINATION CONCRETE CURB AND GUTTER, TYPE B-6.24

DENOTES ITEMS TO BE REMOVED WORK AREA FOR CONSTRUCTION (WORK ZONE)

(A) PAVEMENT MARKING TAPE, TYPE IV, EDGE LINE, 4" WHITE

(C) PAVEMENT MARKING TAPE, TYPE IV, DOUBLE YELLOW CENTERLINE, 4"

- (1) PAVEMENT MARKING TAPE, TYPE IV, EDGE LINE, 4" WHITE
- 2 PAVEMENT MARKING TAPE, TYPE IV, DOUBLE YELLOW CENTERLINE, 4", 11" C-C (TYP.)
- 3 PAVEMENT MARKING TAPE, TYPE IV, SKIP DASH, 4" WHITE (TYP.)
- 4 PAVEMENT MARKING TAPE, TYPE IV, TURN LANE LINES, 6" WHITE (TYP.)
- (5) PAVEMENT MARKING TAPE, TYPE IV, DOTTED DASHED LINES, 6" WHITE (TYP.)
- 6 PAVEMENT MARKING TAPE, TYPE IV, PEDESTRIAN CROSSWALK, 6" WHITE (TYP.)
- 7 PAVEMENT MARKING TAPE, TYPE IV, DIAGONALS, 12" WHITE (TYP.)

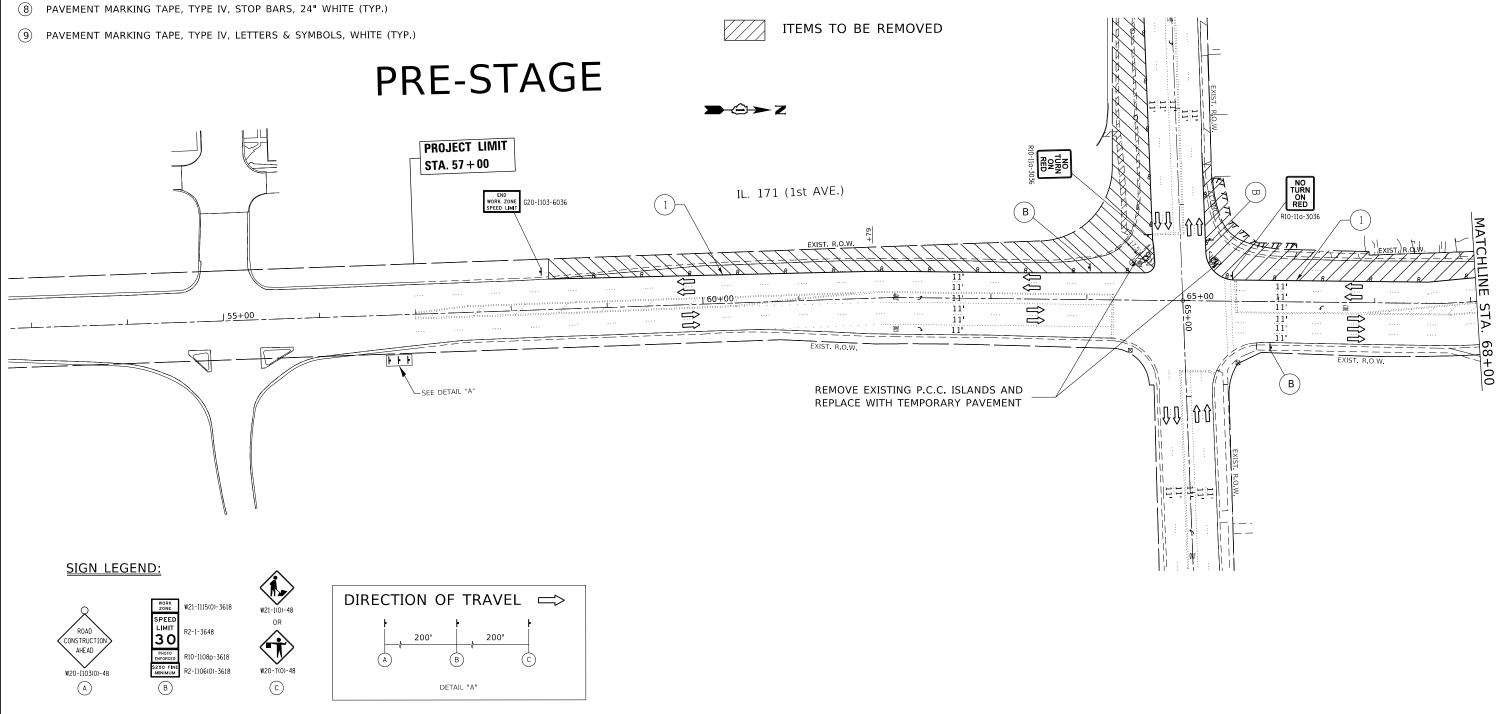
LEGEND:




- CONSTRUCTION SIGN ON PORTABLE OR PERMANENT SUPPORT ____
- DIRECTION OF TRAVEL \square
- ARROW BOARD

WORK ZONE






and I	USER NAME = steedpa	DESIGNED -	REVISED -		SUGGESTED STAGING AND TRAFFIC CONTROL, PRE-STAGE	F.A.P. RTE	SECTION	COUNTY	FOTAL SHEET
AME		DRAWN -	REVISED -	STATE OF ILLINOIS	FAP 372 /IL ROUTE 171(1ST AVENUE) AT ROOSEVELT ROAD	372	3091-TS&N-1	соок	103 26
1 1	PLOT SCALE = 100.0000 ' / in.	CHECKED -	REVISED -	DEPARTMENT OF TRANSPORTATION	TAI 372 / L HOUTE TITITST AVENUE, AT HOUSEVEET HOAD			CONTRACT I	NO. 62A38
E	PLOT DATE = 3/26/2020	DATE -	REVISED -		SCALE: 1"= 50' SHEET OF SHEETS STA. TO STA.		ILLINOIS FED. A	AID PROJECT	

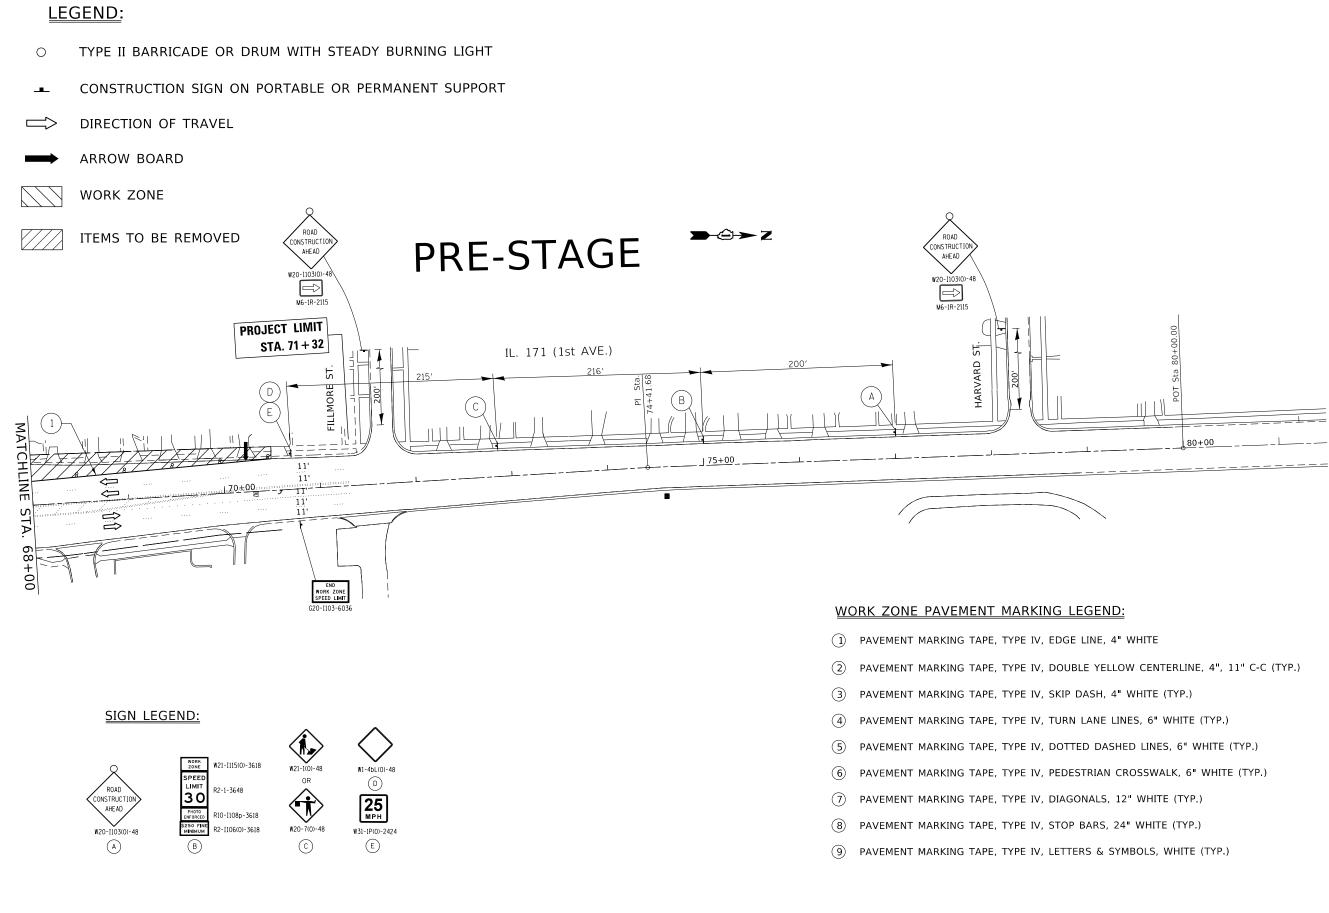

	USER NAME = steedpa	DESIGNED -	REVISED -		SUGGES	TED ST			IC CON	ITROL, PRE-STAGE	F.A.P. BTE	SECTION	COUNTY	TOTAL SHEET
		DRAWN -	REVISED -	STATE OF ILLINOIS						ROOSEVELT ROAD	372	3091-TS&N-1	СООК	103 27
PLOT SCALE = 100.0000 / In. CHECKED REVISED DEPARTMENT OF TRANSPORTATION FAP 372 / IL ROUTE 171(1ST AVENUE) A						UE) AI	RUUSEVELI RUAD			CONTRAC	T NO. 62A38			
	PLOT DATE = 3/26/2020	DATE -	REVISED -		SCALE: 1"= 50'	SHEET	OF	SHEETS	STA.	TO STA.		ILLINOIS	FED. AID PROJECT	

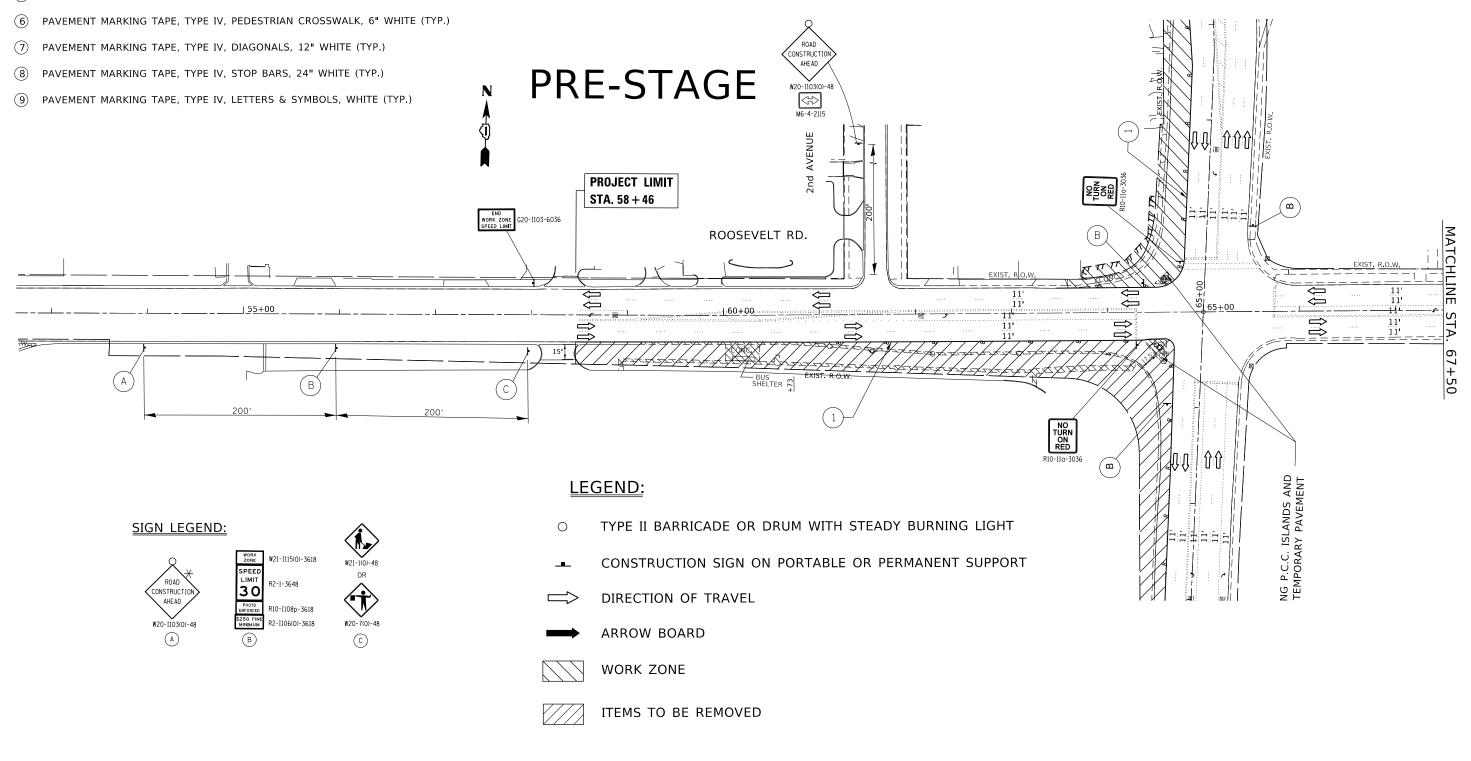- (1) PAVEMENT MARKING TAPE, TYPE IV, EDGE LINE, 4" WHITE
- (2) PAVEMENT MARKING TAPE, TYPE IV, DOUBLE YELLOW CENTERLINE, 4", 11" C-C (TYP.)
- (3) PAVEMENT MARKING TAPE, TYPE IV, SKIP DASH, 4" WHITE (TYP.)
- PAVEMENT MARKING TAPE, TYPE IV, TURN LANE LINES, 6" WHITE (TYP.) (4)
- (5) PAVEMENT MARKING TAPE, TYPE IV, DOTTED DASHED LINES, 6" WHITE (TYP.)




Md	USER NAME = steedpa	DESIGNED -	REVISED -		SUGGESTED STAGING AND TRAFFIC CONTROL, PRE-STAGE	F.A.P. BTE	SECTION	COUNTY TO	JTAL SHEET
AME		DRAWN -	REVISED -	STATE OF ILLINOIS		372	3091-TS&N-1	соок 1	103 28
LE	PLOT SCALE = 100.0000 ' / in.	CHECKED -	REVISED -	DEPARTMENT OF TRANSPORTATION	FAP 372 /IL ROUTE 171(1ST AVENUE) AT ROOSEVELT ROAD			CONTRACT NO	O. 62A38
Ξ.	PLOT DATE = 3/26/2020	DATE -	REVISED -		SCALE: 1"= 50' SHEET OF SHEETS STA. TO STA.		ILLINOIS FED. A	AID PROJECT	




- (1) PAVEMENT MARKING TAPE, TYPE IV, EDGE LINE, 4" WHITE
- 2 PAVEMENT MARKING TAPE, TYPE IV, DOUBLE YELLOW CENTERLINE, 4", 11" C-C (TYP.)
- (3) PAVEMENT MARKING TAPE, TYPE IV, SKIP DASH, 4" WHITE (TYP.)
- 4 PAVEMENT MARKING TAPE, TYPE IV, TURN LANE LINES, 6" WHITE (TYP.)
- (5) PAVEMENT MARKING TAPE, TYPE IV, DOTTED DASHED LINES, 6" WHITE (TYP.)
- 6 PAVEMENT MARKING TAPE, TYPE IV, PEDESTRIAN CROSSWALK, 6" WHITE (TYP.)
- (7)PAVEMENT MARKING TAPE, TYPE IV, DIAGONALS, 12" WHITE (TYP.)
- (8) PAVEMENT MARKING TAPE, TYPE IV, STOP BARS, 24" WHITE (TYP.)
- 9 PAVEMENT MARKING TAPE, TYPE IV, LETTERS & SYMBOLS, WHITE (TYP.)

- LEGEND:
- TYPE II BARRICADE OR DRUM WITH STEADY BURNING LIGHT Ο
- CONSTRUCTION SIGN ON PORTABLE OR PERMANENT SUPPORT
- DIRECTION OF TRAVEL \square
- ARROW BOARD
- WORK ZONE
 - ITEMS TO BE REMOVED

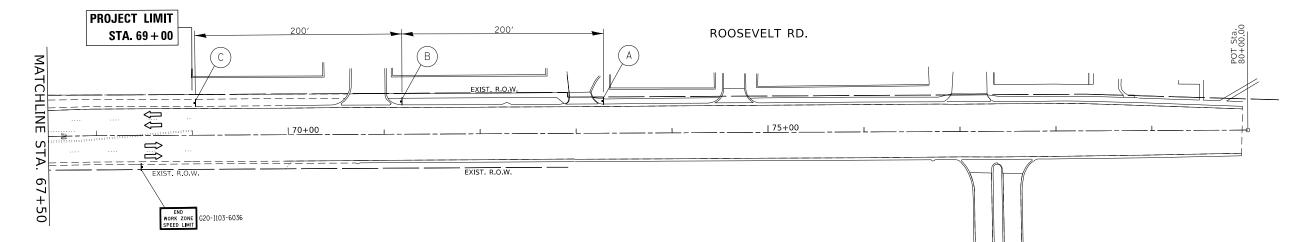PRE-STAGE



SIGN LEGEND:

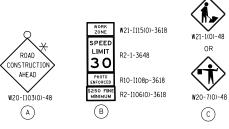

JSER NAME = steedpa DESIGNED -REVISED SUGGESTED STAGING AND TRAF STATE OF ILLINOIS DRAWN REVISED FAP 372 /IL ROUTE 171(1ST AVEN LOT SCALE = 100.0000 ' / in. CHECKED REVISED **DEPARTMENT OF TRANSPORTATION** PLOT DATE = 3/26/2020 REVISED SCALE: 1"= 50' SHEET OF SHEET DATE


N

F.A.P. RTE	SECT	TION		COUNTY	TOTAL SHEETS	SHEET NO.
372	3091-T	S&N-1		СООК	103	29
_				CONTRACT	NO. 62	2A38
		ILLINOIS	FED. AI	ID PROJECT		
	RTE.	RTE. SEC	RTE. SECTION 372 3091-TS&N-1	RTE. SECTION 372 3091-TS&N-1	RTE. SECTION COUNT 372 3091-TS&N-1 COOK CONTRACT	RTE SECTION COUNTY SHEETS 372 3091-TS&N-1 COOK 103 CONTRACT NO. 62


- 1) PAVEMENT MARKING TAPE, TYPE IV, EDGE LINE, 4" WHITE
- (2) PAVEMENT MARKING TAPE, TYPE IV, DOUBLE YELLOW CENTERLINE, 4", 11" C-C (TYP.)
- 3 PAVEMENT MARKING TAPE, TYPE IV, SKIP DASH, 4" WHITE (TYP.)
- PAVEMENT MARKING TAPE, TYPE IV, TURN LANE LINES, 6" WHITE (TYP.) (4)
- (5) PAVEMENT MARKING TAPE, TYPE IV, DOTTED DASHED LINES, 6" WHITE (TYP.)
- 6 PAVEMENT MARKING TAPE, TYPE IV, PEDESTRIAN CROSSWALK, 6" WHITE (TYP.)
- (7) PAVEMENT MARKING TAPE, TYPE IV, DIAGONALS, 12" WHITE (TYP.)
- (8) PAVEMENT MARKING TAPE, TYPE IV, STOP BARS, 24" WHITE (TYP.)
- (9) PAVEMENT MARKING TAPE, TYPE IV, LETTERS & SYMBOLS, WHITE (TYP.)

LEGEND:

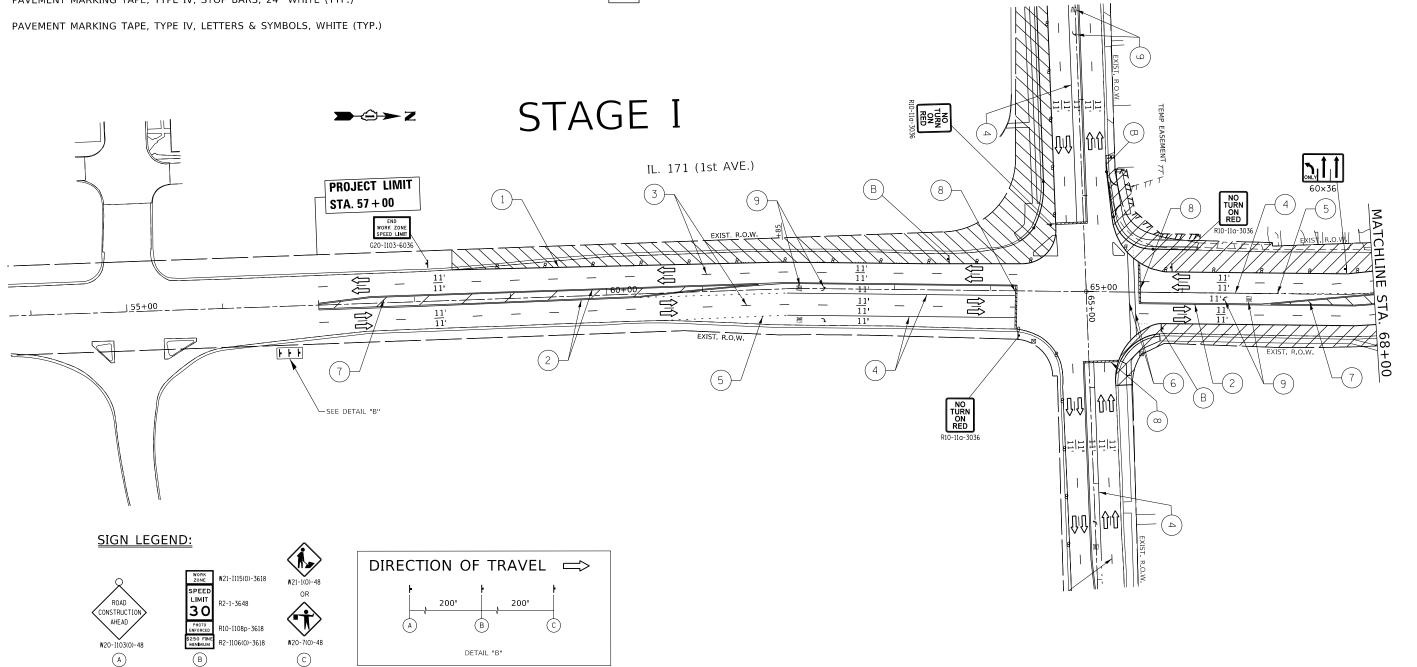
- TYPE II BARRICADE OR DRUM WITH STEADY BURNING LIGHT 0
- TYPE III BARRICADE WITH STEADY BURNING LIGHT ш
- CONSTRUCTION SIGN ON PORTABLE OR PERMANENT SUPPORT _
- \Rightarrow DIRECTION OF TRAVEL
- ARROW BOARD
- WORK ZONE
- TEMPORARY PAVEMENT



USER NAME = steedpa	DESIGNED -	REVISED -		SUGGE	STED ST		ND TRAFFIC CON	TROL STAGE 1	F.A.P. BTE	SECTION	COUNTY	TOTAL SHEETS	SHEET
	DRAWN -	REVISED -	STATE OF ILLINOIS						372	3091-TS&N-1	соок	103	30
PLOT SCALE = 100.0000 ' / in.	CHECKED -	REVISED -	DEPARTMENT OF TRANSPORTATION	FAF 3/2	FAP 372 /IL ROUTE 171(1ST AVENUE) AT ROOSEVELT ROAD						CONTRACT	NO. 62	.A38
PLOT DATE = 3/26/2020	DATE -	REVISED -		SCALE: 1"= 50'	SHEET	OF	SHEETS STA.	TO STA.		ILLINOIS FED	. AID PROJECT	-	

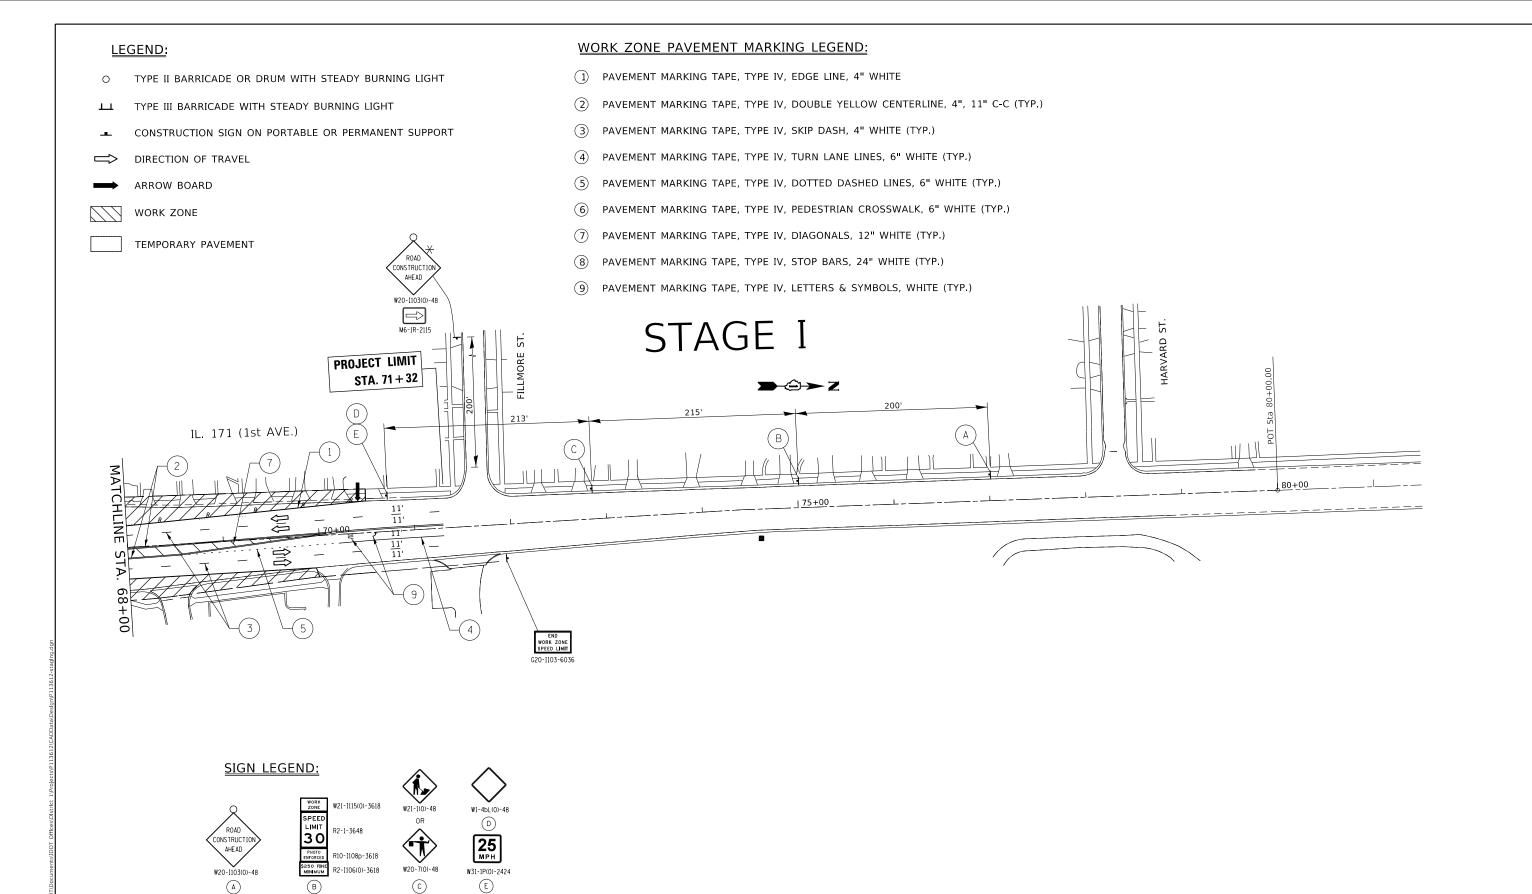

USER NAME = steedpa	DESIGNED -	REVISED -		SUGGI	ESTED	STAGING	AND T	BAF	FIC CONTROL, S	TAGE 1	F.A.P. RTE	SECTION	COUNT	TOTAL SHEET SHEETS NO.
	DRAWN -	REVISED -	STATE OF ILLINOIS	EAD 272 /IL DOLITE 171/10T AVENUEL AT DOOCEVELT DO			372	3091-TS&N-1	соок	103 31				
PLOT SCALE = 100.0000 / in	CHECKED -	REVISED -	DEPARTMENT OF TRANSPORTATION	FAF JI			III AV	ENU	E) AT NUUSEVEL				CONTR	CT NO. 62A38
PLOT DATE = 3/26/2020	DATE -	REVISED -		SCALE: 1"= 50'	SHEET	OF	SHEE	ETS	STA.	TO STA.		ILLINOIS F	ED. AID PROJECT	

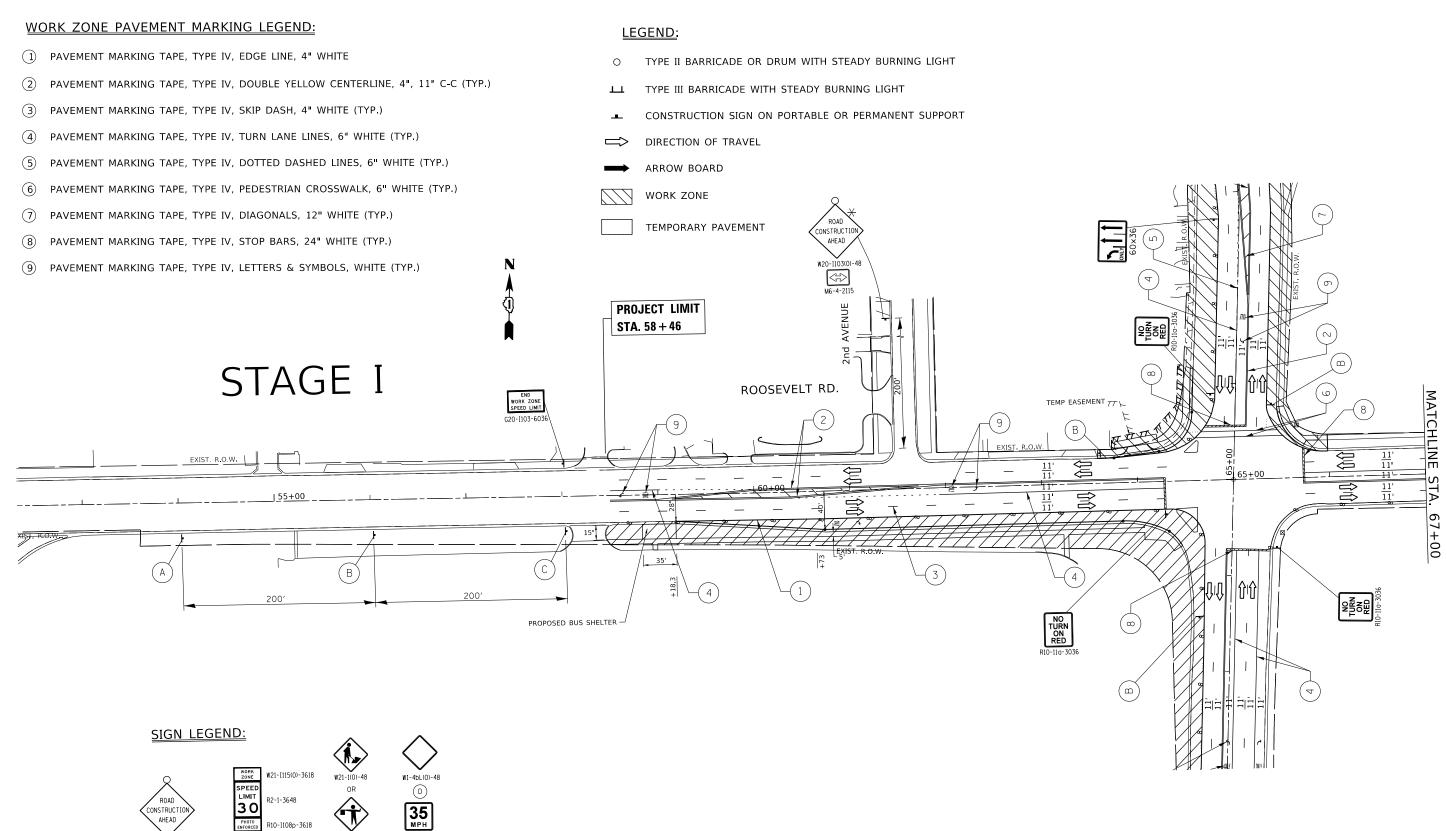

W20-I103(0)-48

(A)

JSER NAME = steedpa

PLOT DATE = 3/26/2020

LOT SCALE = 100.0000 ' / in.

SPEED LIMIT 30 $\langle \mathbf{t} \rangle$ PHOTO R10-I108p-3618 \$250 FINE MINIMUM W20-7(0)-48 R2-I106(0)-3618 (C) (B)





DESIGNED -

CHECKED

DRAWN

DATE



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REVISED

REVISED

REVISED

REVISED




STATE OF ILLINOIS **DEPARTMENT OF TRANSPORTATION**

SUGGESTED STAGING AND TRA FAP 372 /IL ROUTE 171(1ST AVE

SCALE: 1"= 50' SHEET OF SHEET

RAI	FFIC CO	NTROL, STAGE 1	F.A.P. RTE	SECT	ION		COUNTY	TOTAL SHEETS	SHEET NO.
NUE) AT ROOSEVELT ROAD			372	3091-T	S&N-1		СООК	103	32
		NOOSEVEET NOAD					CONTRACT	NO. 62	2A38
TS	STA.	TO STA.			ILLINOIS	FED. AI	D PROJECT		

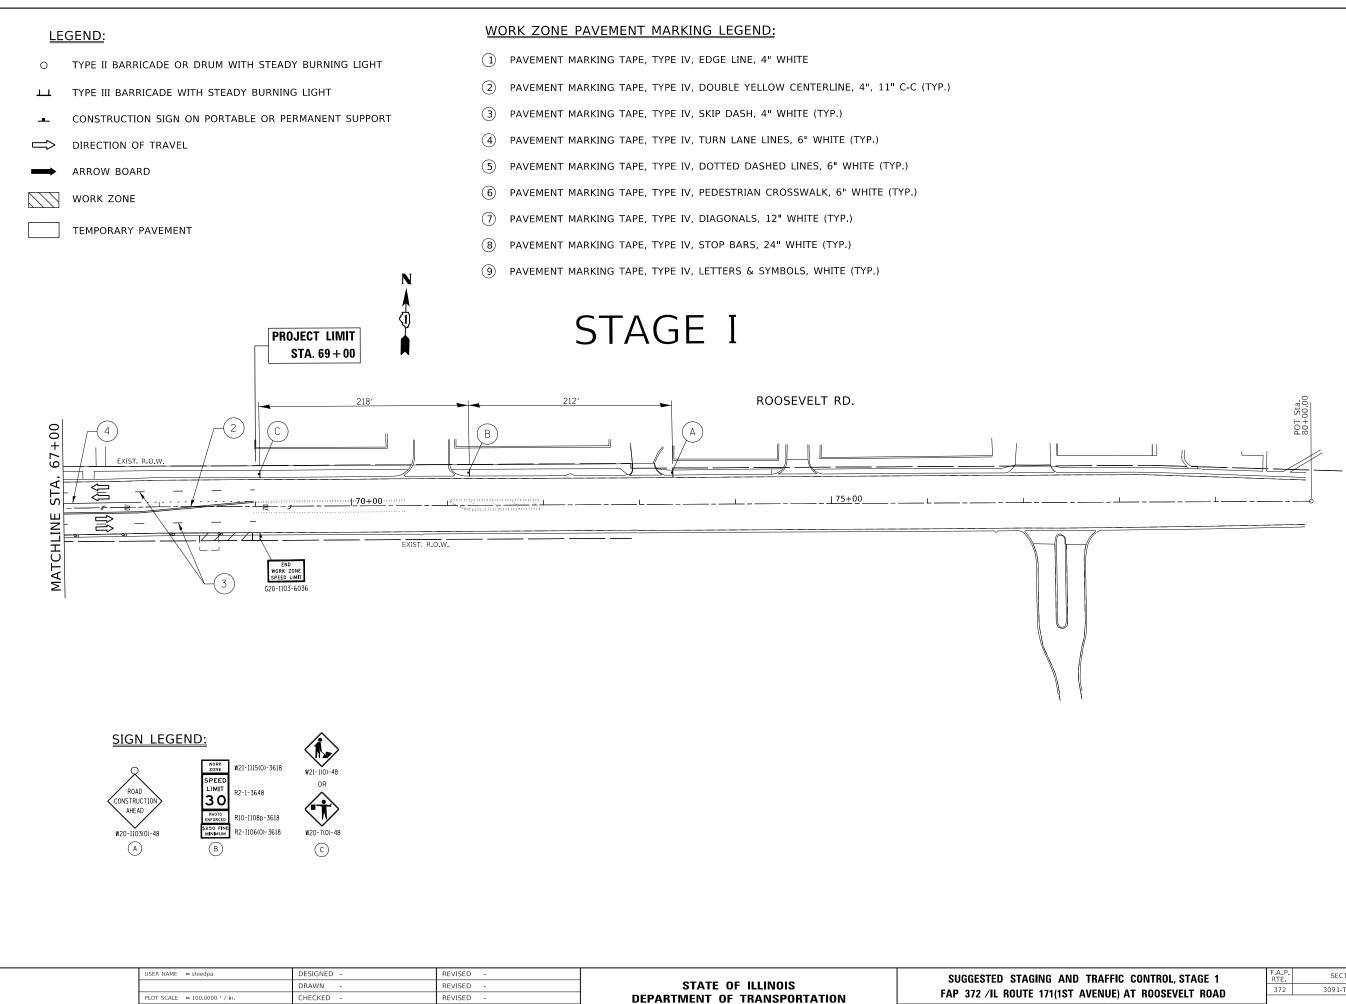

PLOT DATE = 3/26/2020

DATE

REVISED

SCALE: 1"= 50' SHEET OF SHEET

HEET OF SHEET

RA	FFIC CO	NTROL, STAGE 1	F.A.P. RTE	SECT	FION		COUNTY	TOTAL SHEETS	SHEET NO.
ENUE) AT ROOSEVELT ROAD			372	3091-T	S&N-1		СООК	103	33
		NOOSEVEET NOAD					CONTRACT	NO. 62	2A38
ΤS	STA.	TO STA.			ILLINOIS	FED. AI	D PROJECT		

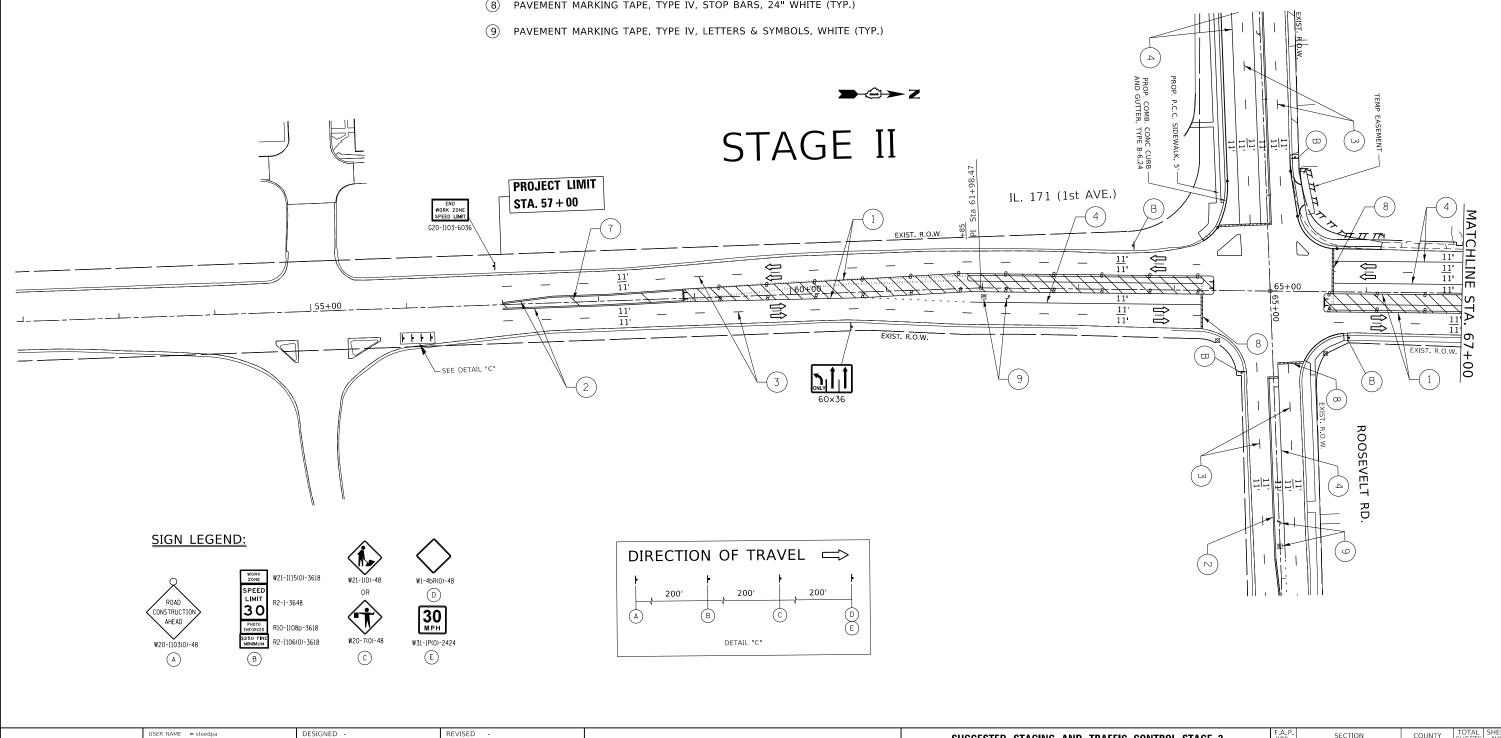
LEGEND:

- TYPE II BARRICADE OR DRUM WITH STEADY BURNING LIGHT 0
- TYPE III BARRICADE WITH STEADY BURNING LIGHT ш
- CONSTRUCTION SIGN ON PORTABLE OR PERMANENT SUPPORT _
- DIRECTION OF TRAVEL \Rightarrow
- ARROW BOARD
- WORK ZONE $\langle \rangle \rangle$


TEMPORARY PAVEMENT

WORK ZONE PAVEMENT MARKING LEGEND:

- (1) PAVEMENT MARKING TAPE, TYPE IV, EDGE LINE, 4" WHITE
- (2) PAVEMENT MARKING TAPE, TYPE IV, DOUBLE YELLOW CENTERLINE, 4", 11" C-C (TYP.)
- 3 PAVEMENT MARKING TAPE, TYPE IV, SKIP DASH, 4" WHITE (TYP.)
- (4) PAVEMENT MARKING TAPE, TYPE IV, TURN LANE LINES, 6" WHITE (TYP.)
- (5) PAVEMENT MARKING TAPE, TYPE IV, DOTTED DASHED LINES, 6" WHITE (TYP.)
- (6) PAVEMENT MARKING TAPE, TYPE IV, PEDESTRIAN CROSSWALK, 6" WHITE (TYP.)
- (7) PAVEMENT MARKING TAPE, TYPE IV, DIAGONALS, 12" WHITE (TYP.)
- (8) PAVEMENT MARKING TAPE, TYPE IV, STOP BARS, 24" WHITE (TYP.)



	USER NAME = steedpa	DESIGNED -	REVISED -		SUGG	STED	STAGING		TRΔF	FIC CONT	TROL, STAGE 2	F.A.P. BTE	SECTION	COUNTY	TOTAL	SHEET
		DRAWN -	REVISED -	STATE OF ILLINOIS							•	372	3091-TS&N-1	соок	103	34
	PLOT SCALE = 100.0000 ' / in.	CHECKED -	REVISED -	DEPARTMENT OF TRANSPORTATION	FAP 37	2 /IL F		I(ISI A	AVENU	JE) AT KU	DOSEVELT ROAD			CONTRAC	T NO. 6	j2A38
PL	PLOT DATE = 3/26/2020	DATE -	REVISED -		SCALE: 1"= 50'	SHEET	OF	SH	HEETS	STA.	TO STA.		ILLINOIS FED.	AID PROJECT		

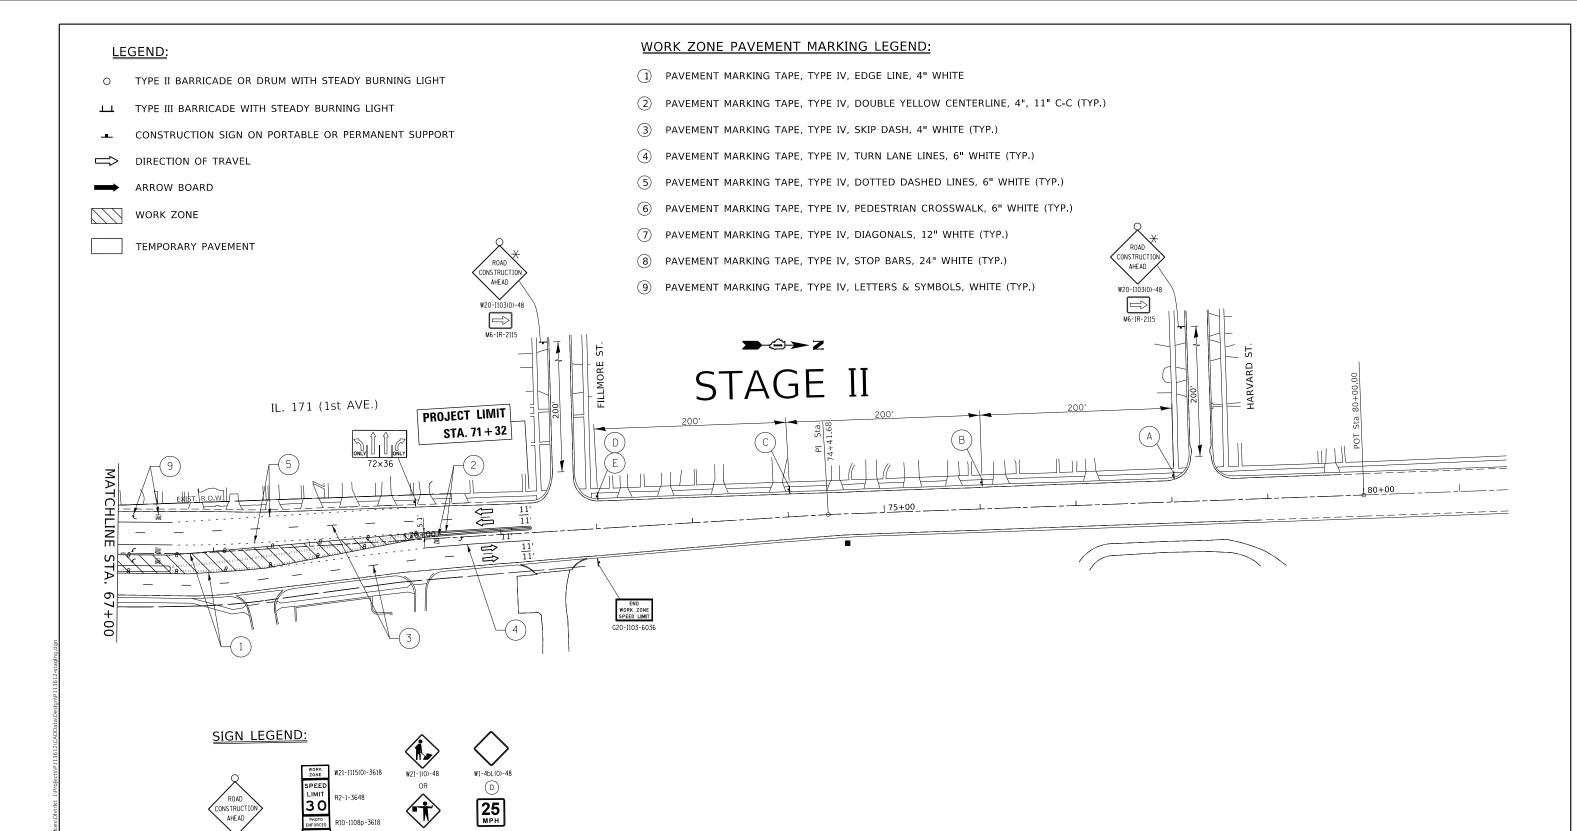

	USER NAME = steedpa	DESIGNED -	REVISED -		SUGGE	STED S	TAGING A	AND TRAFFIC CON	TROL, STAGE 2	F.A.P. RTE	SECTION	COUNTY	TOTAL SHEET SHEETS NO.
		DRAWN -	REVISED -	STATE OF ILLINOIS	FAP 372 /IL ROUTE 171(1ST AVENUE) AT ROOSEVELT R				•	372	3091-TS&N-1	соок	103 35
-	PLOT SCALE = 100.0000 ' / in.	CHECKED -	REVISED -	DEPARTMENT OF TRANSPORTATION				ST AVENUE, AT IN		_		CONTRACT	F NO. 62A38
	PLOT DATE = 3/26/2020	DATE -	REVISED -		SCALE: 1"= 50'	SHEET	OF	SHEETS STA.	TO STA.		ILLINOIS FEE	AID PROJECT	

W20-I103(0)-48

(A)

\$250 FINE MINIMUM

(B)

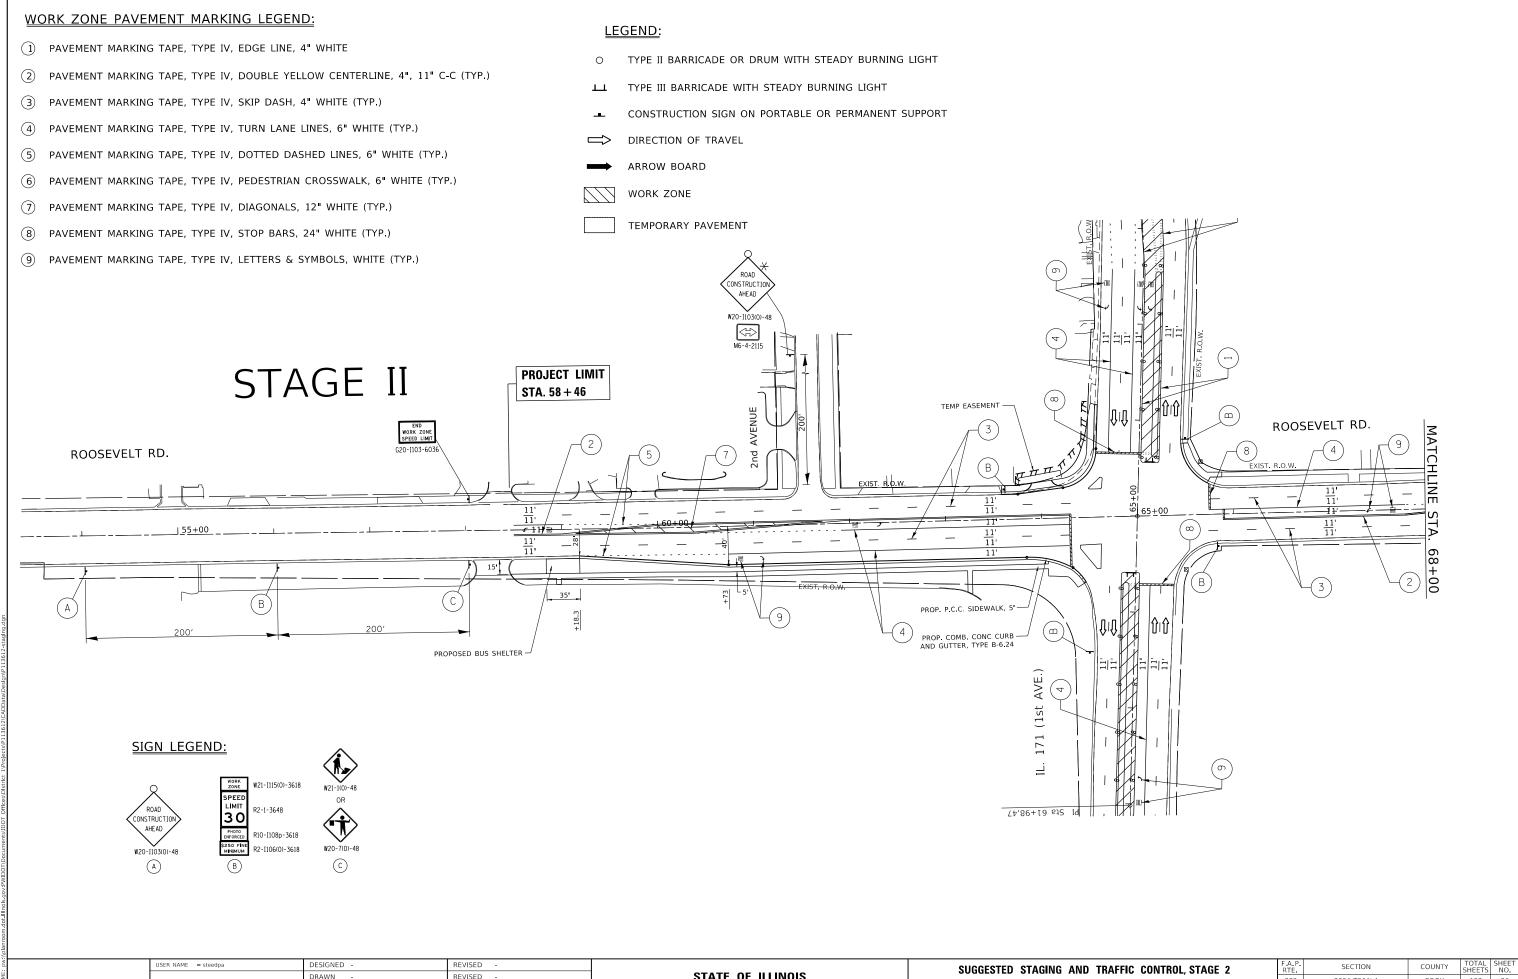
R2-I106(0)-3618

W20-7(0)-48


(C)

W31-1P(0)-2424

E



USER NAME = steedpa	DESIGNED -	REVISED -		SUGGESTED STAGING	AND T	RAFFIC CO	NTROL, STAGE 2	F.A.P. BTE	SECTION	COUNTY	TOTAL S	HEET NO.
	DRAWN -	REVISED -	STATE OF ILLINOIS					372	3091-TS&N-1	СООК	103	36
PLOT SCALE = 100.0000 / in.	CHECKED -	REVISED -	DEPARTMENT OF TRANSPORTATION	FAP 3/2 /IL RUUTE 1/1	FAP 372 /IL ROUTE 171(1ST AVENUE) AT ROOSEVEI					CONTRAC	T NO. 62/	38
PLOT DATE = 3/26/2020	DATE -	REVISED -		SCALE: 1"= 50' SHEET OF	SHEE	TS STA.	TO STA.		ILLINOIS FI	D. AID PROJECT		

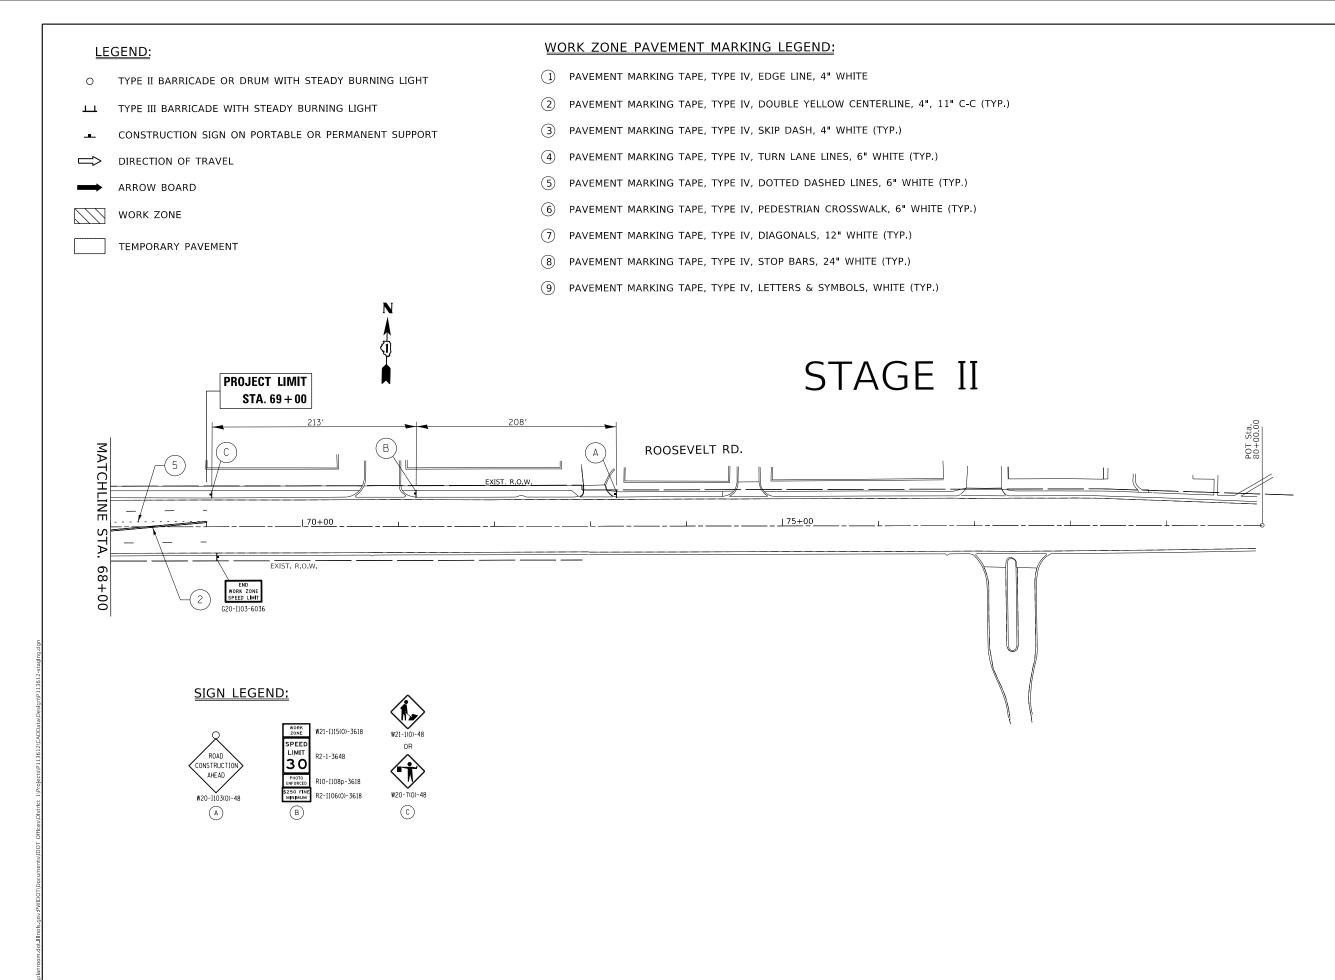


USER NAME = steedpa	DESIGNED -	REVISED -		SUGGESTED STAGING AND TRAFFIC CONTROL, STAGE 2 FAP 372 /IL ROUTE 171(1ST AVENUE) AT ROOSEVELT ROAD		F.A.P. BTE	SECTION	COUNTY	TOTAL SHEET SHEETS NO	
	DRAWN -	REVISED -	STATE OF ILLINOIS			372	3091-TS&N-1	соок	103 37	
PLOT SCALE = 100.0000 / in.	CHECKED -	REVISED -	DEPARTMENT OF TRANSPORTATION			NUUSEVELI NUAD			CONTRAC	NO 62A38
PLOT DATE = 3/26/2020	DATE -	REVISED -		SCALE: 1"= 50' SHEET OF SHEETS STA. TO STA.			ILLINOIS FED. AID PROJECT			



- 1) PAVEMENT MARKING TAPE, TYPE IV, EDGE LINE, 4" WHITE
- 2 PAVEMENT MARKING TAPE, TYPE IV, DOUBLE YELLOW CENTERLINE, 4", 11" C-C (TYP.)

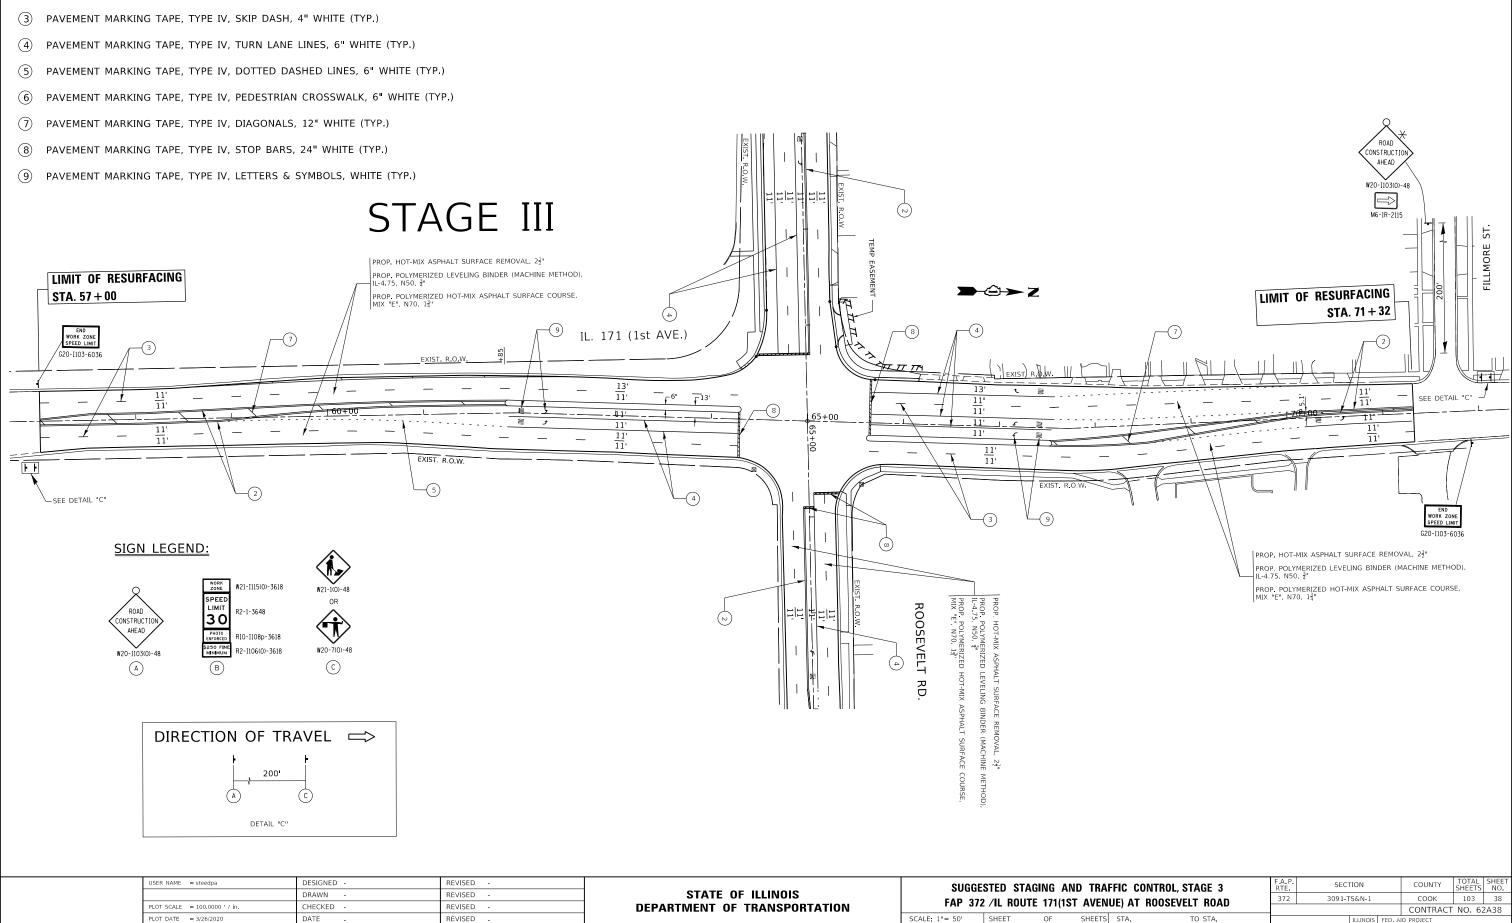
- PAVEMENT MARKING TAPE, TYPE IV, DIAGONALS, 12" WHITE (TYP.)



USER NAME = steedpa	DESIGNED - DRAWN -	REVISED - REVISED -	STATE OF ILLINOIS	SUGGE FAP 372	ING AN 171(1S1		
PLOT SCALE = 100.0000 / in.	CHECKED -	REVISED -	DEPARTMENT OF TRANSPORTATION			171(101	
PLOT DATE = 3/26/2020	DATE -	REVISED -		SCALE: 1"= 50'	SHEET	OF	SHEETS

WORK ZONE PAVEMENT MARKING LEGEND:

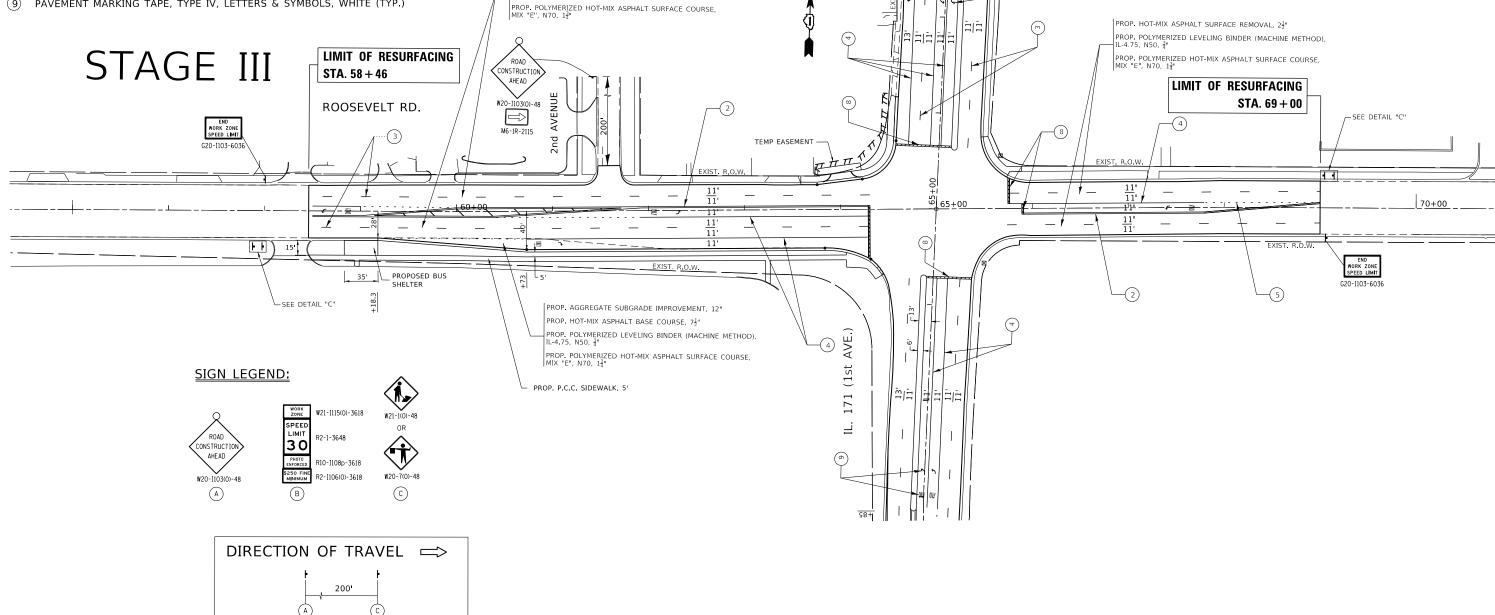- 1 PAVEMENT MARKING TAPE, TYPE IV, EDGE LINE, 4" WHITE
- 2 PAVEMENT MARKING TAPE, TYPE IV, DOUBLE YELLOW CENTERLINE, 4", 11" C-C (TYP.)
- 3 PAVEMENT MARKING TAPE, TYPE IV, SKIP DASH, 4" WHITE (TYP.)
- (4) PAVEMENT MARKING TAPE, TYPE IV, TURN LANE LINES, 6" WHITE (TYP.)
- 5 PAVEMENT MARKING TAPE, TYPE IV, DOTTED DASHED LINES, 6" WHITE (TYP.)
- (6) PAVEMENT MARKING TAPE, TYPE IV, PEDESTRIAN CROSSWALK, 6" WHITE (TYP.)
- $\overline{7}$ PAVEMENT MARKING TAPE, TYPE IV, DIAGONALS, 12" WHITE (TYP.)
- 8 PAVEMENT MARKING TAPE, TYPE IV, STOP BARS, 24" WHITE (TYP.)
- 9 PAVEMENT MARKING TAPE, TYPE IV, LETTERS & SYMBOLS, WHITE (TYP.)



N


	USER NAME = steedpa	DESIGNED - DRAWN -	REVISED - REVISED -	STATE OF ILLINOIS		STED STAG		
	PLOT SCALE = 100.0000 ' / in.	CHECKED -	REVISED -	DEPARTMENT OF TRANSPORTATION	FAP 3/2	2 /IL ROUTE	1/1(151	
	PLOT DATE = 3/26/2020	DATE -	REVISED -		SCALE: 1"= 50'	SHEET	OF	SHEETS

DETAIL "C"


PROP. HOT-MIX ASPHALT SURFACE REMOVAL, 2


PROP. POLYMERIZED LEVELING BINDER (MACHINE METHOD), IL-4.75, N50, $\frac{3}{4}$ "


$- \frac{11}{11} \neq$		-	70+0	0	
$-\sqrt{\frac{11}{11}}$ $ -$	+				
	EXIST. R.O.W.	<u> </u>			=
2		end work zone speed limit G20-1103-6036			
			I		IFFT
RAFFIC CONTROL, STAGE 3	F.A.P. RTE. 372	SECTION 3091-TS&N-1	COUNTY COOK		HEET NO. 39
ENUE) AT ROOSEVELT ROAD	372	2021-12/01/-1	CONTRACT		
TS STA. TO STA.		ILLINOIS FED. A	ID PROJECT		

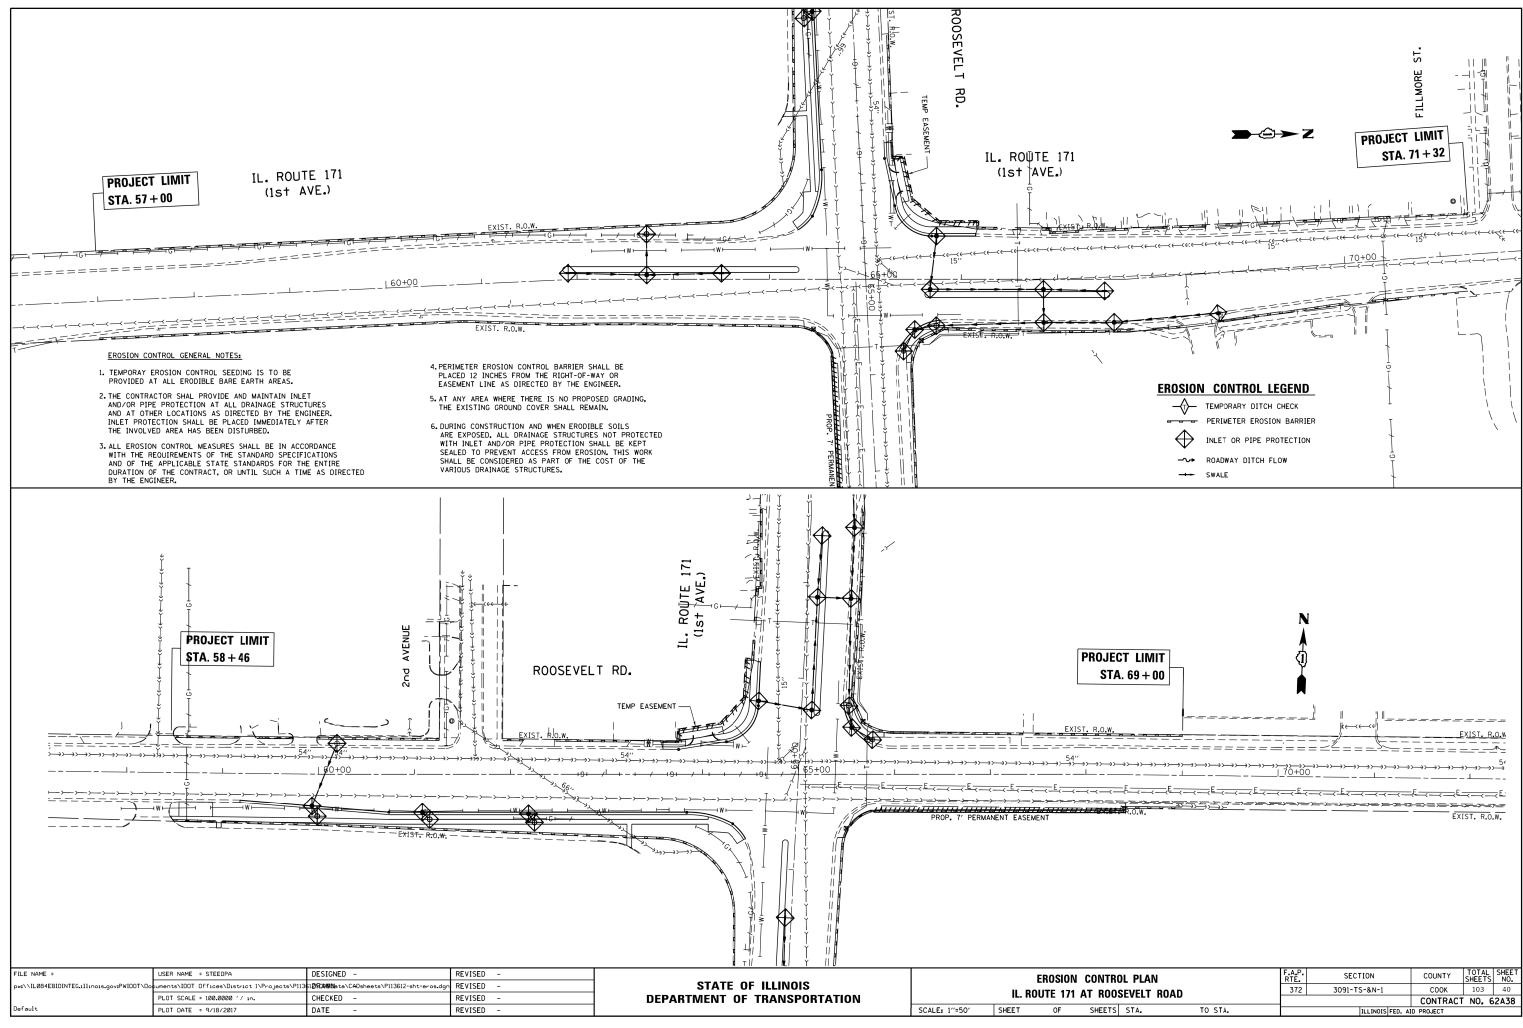


ROL PLAN		F.A.P. RTE.	SECTION	COUNTY	TOTAL SHEET SHEETS NO.	
OSEVELT ROAD		372	3091-TS-&N-1	СООК	103	40
			CONTRACT NO. 62A38			
IS STA.	TO STA.		ILLINOIS FED. AI	D PROJECT		

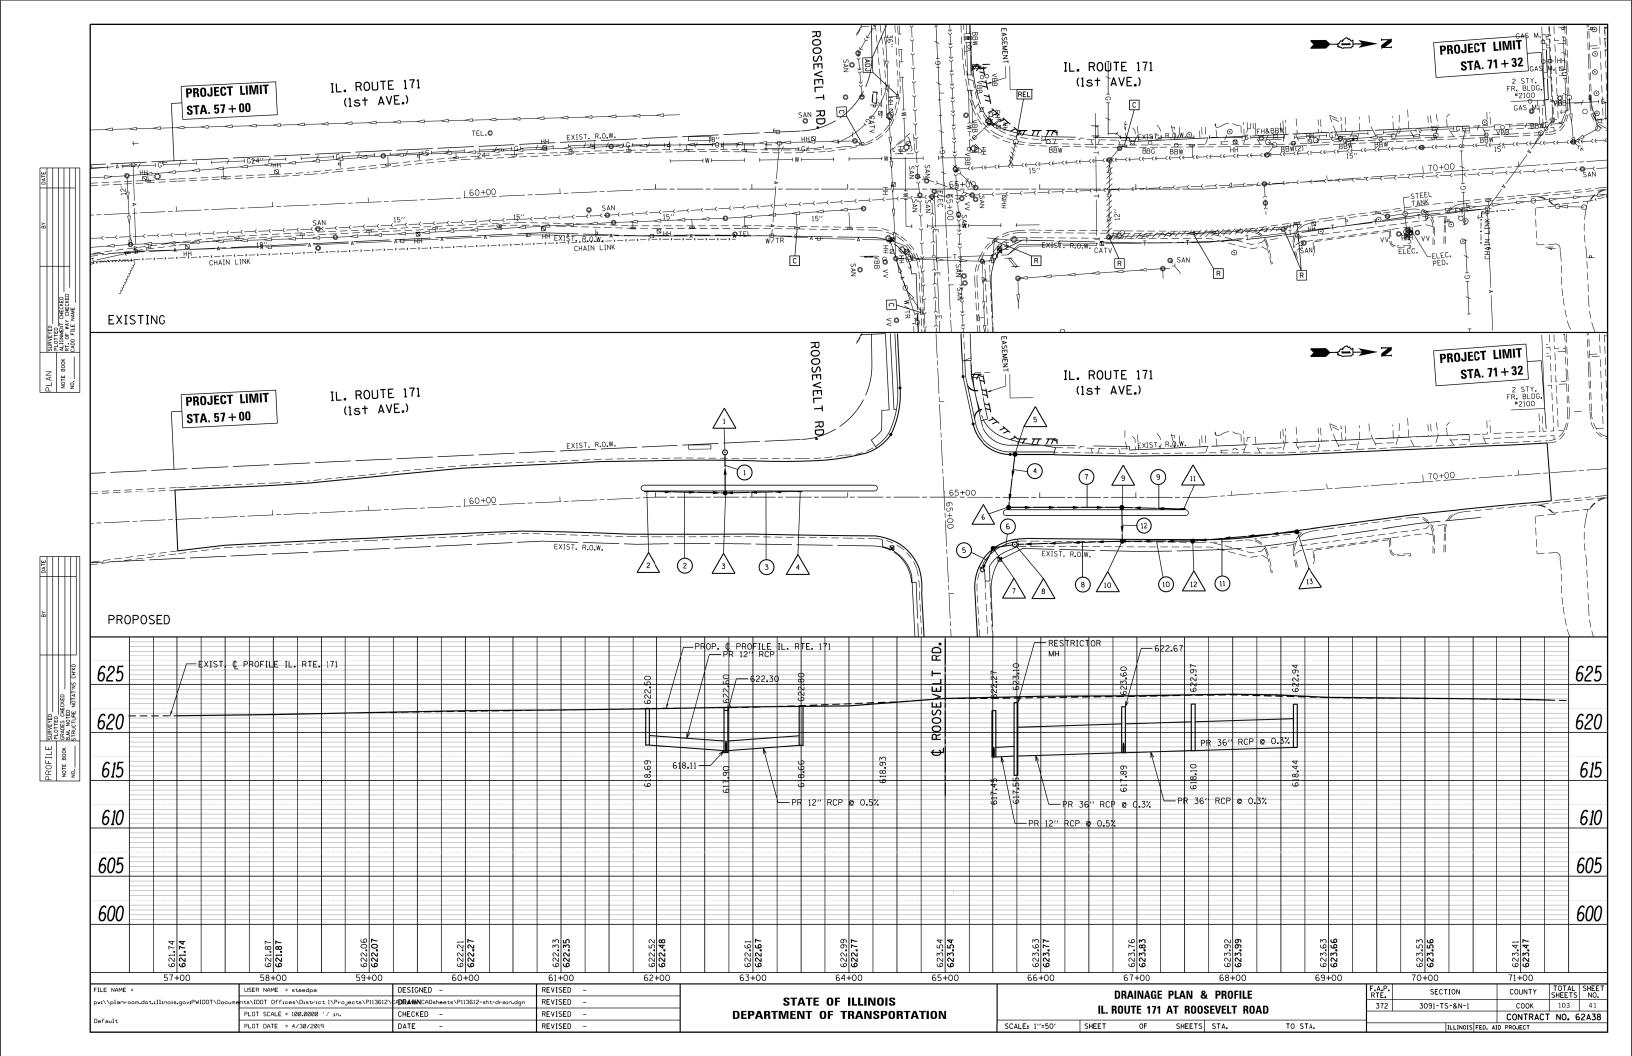

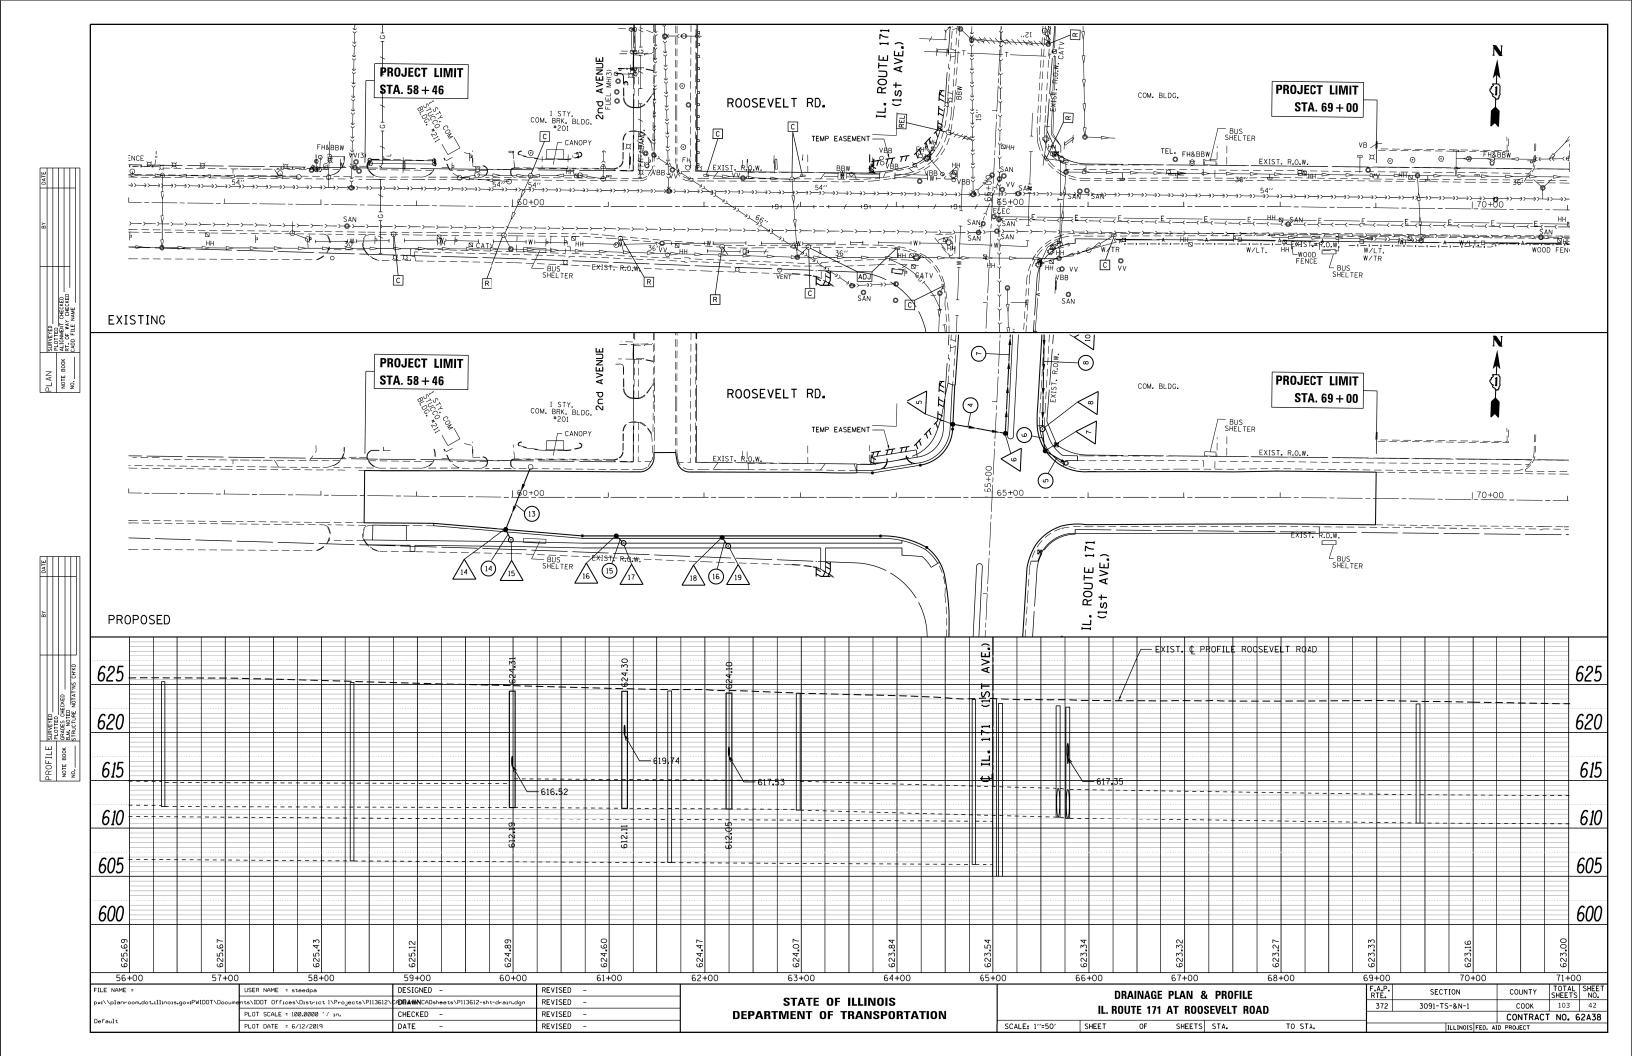

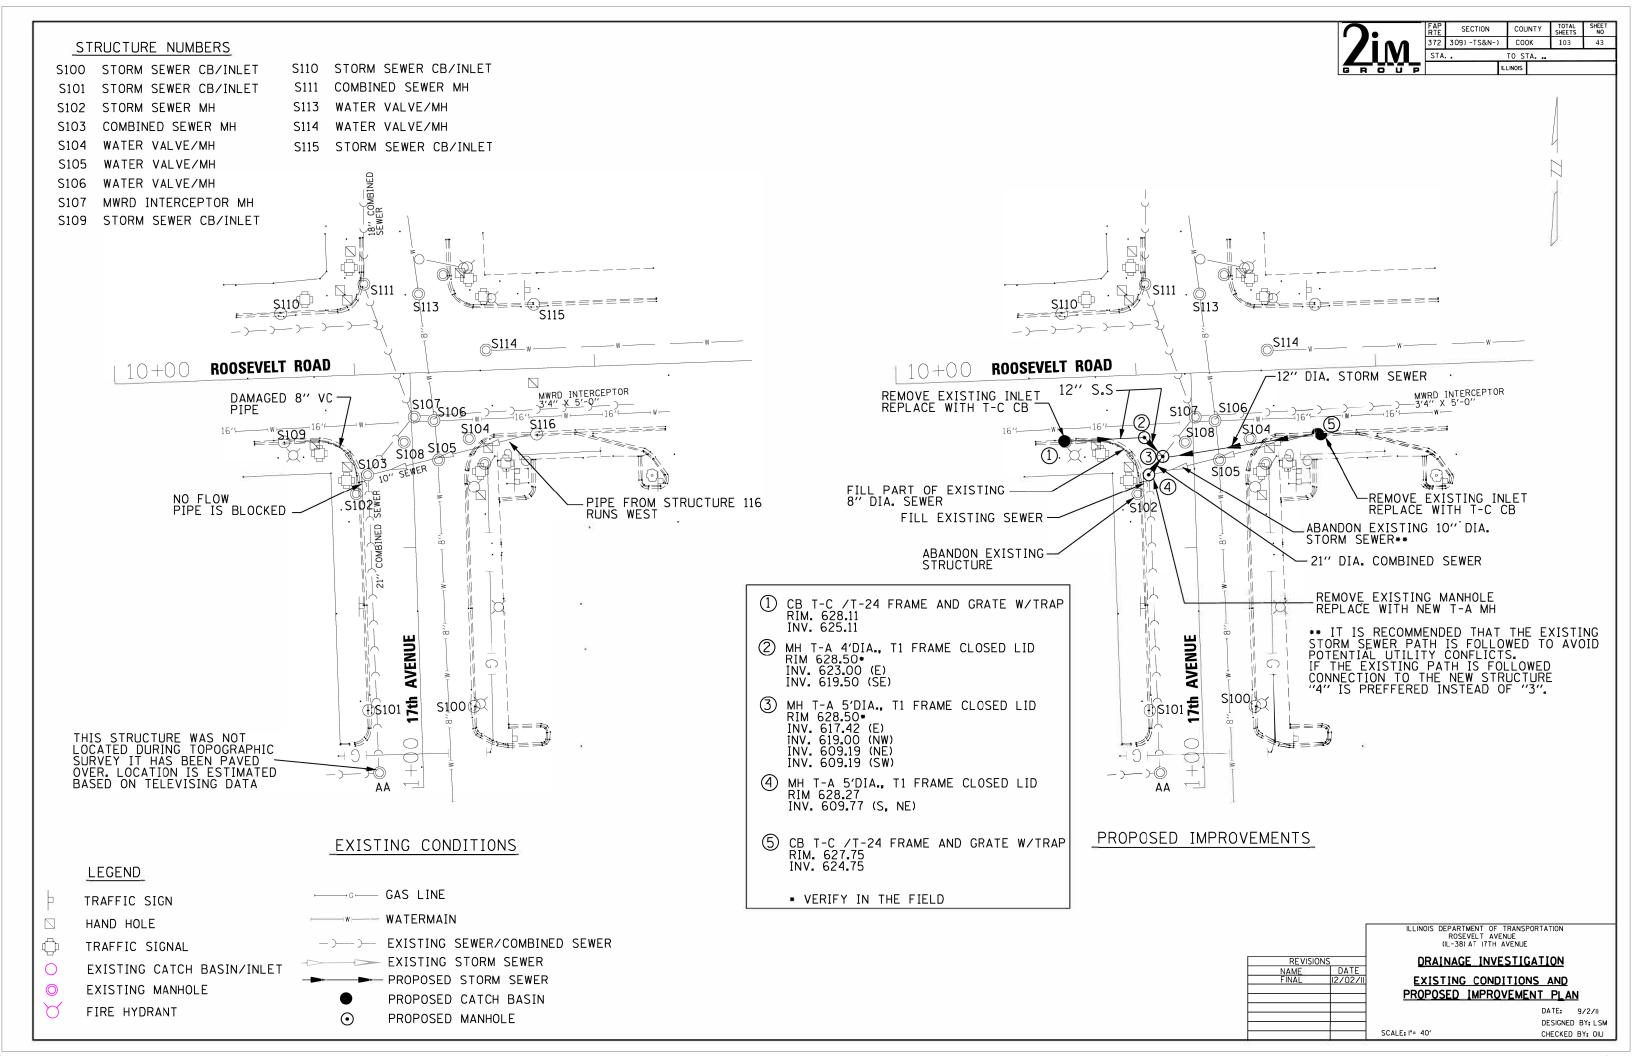

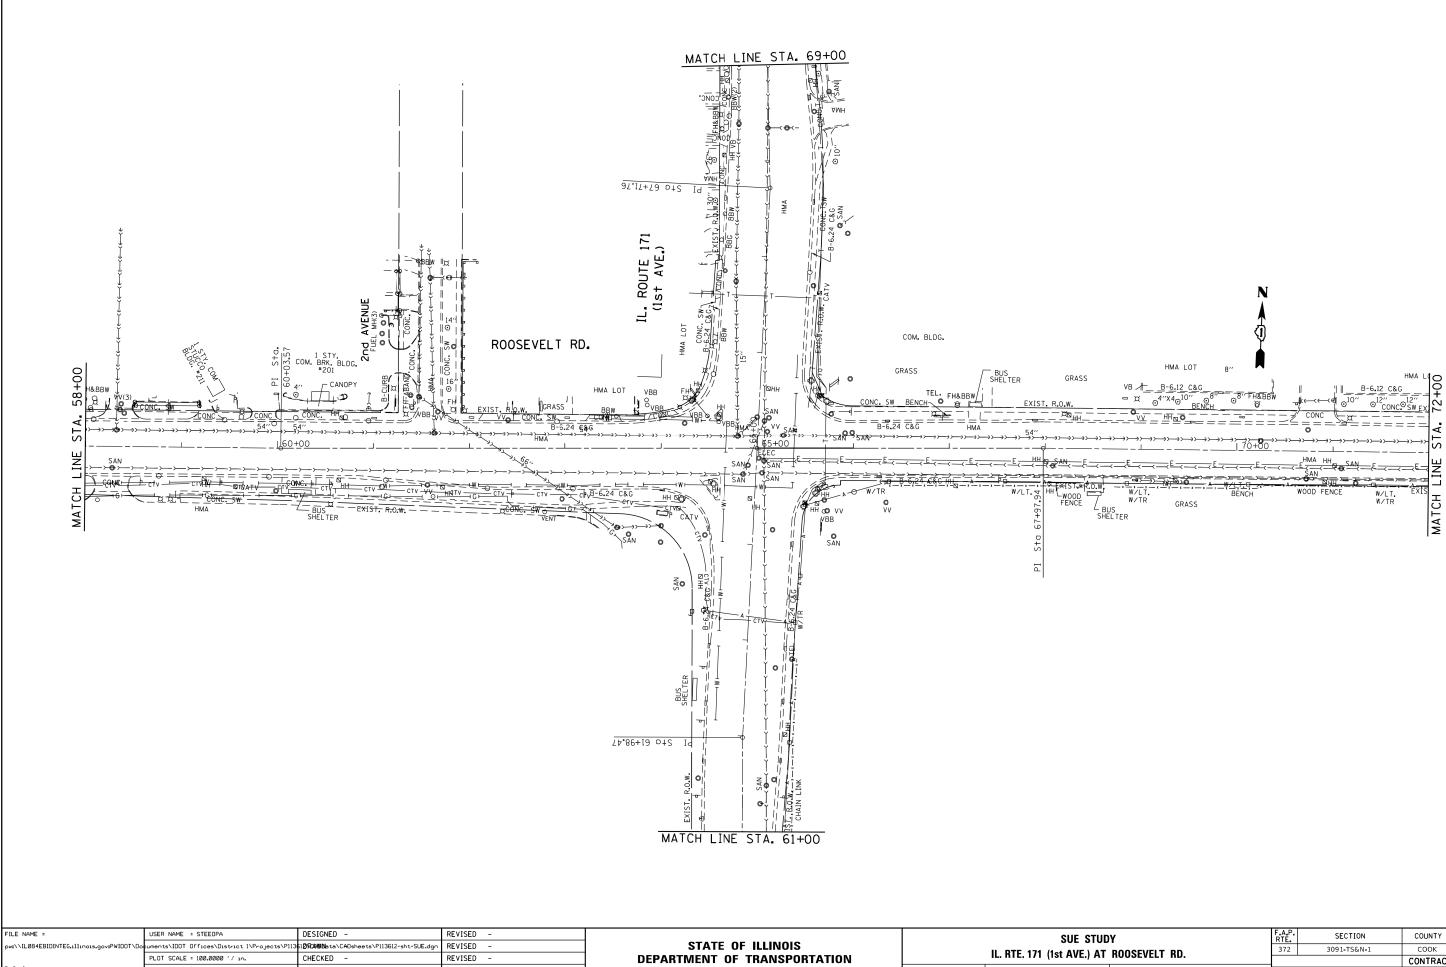

SCALE:


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PLOT DATE = 8/31/2017


DATE

REVISED -


	SUE STUDY IL. RTE. 171 (1st AVE.) AT ROOSEVELT RD.						SECTION	COUNTY TOTAL SHEET		SHEET NO.
							3091-TS&N-1	соок	103	44
	IL. NIL. I	/1 (151/	AVE./ AT	NUUSLVLI		CONTRACT NO. 62A				
	SHEET	OF	SHEETS	STA.	TO STA.		ILLINOIS FED. A	ID PROJECT		

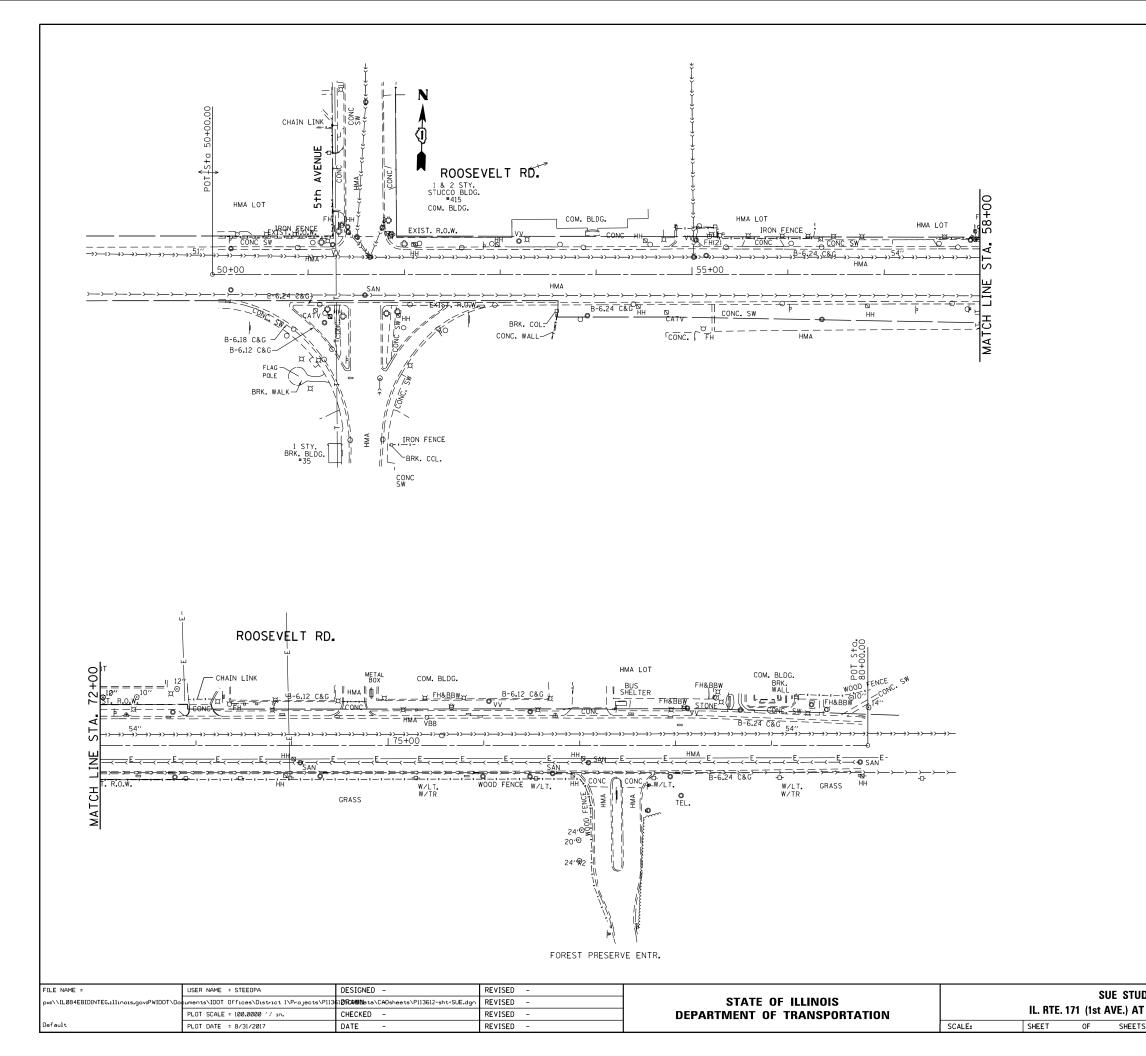

JDY T ROOSEVELT RD.		F.A.P. RTE	SECTION	COUNTY	TOTAL SHEETS	SHEET NO.				
		372	3091-TS&N-1	соок	103	45				
	I NUUSEVELI ND.			CONTRACT NO. 62A38						
rs s	STA.	TO STA.	ILLINOIS FED. AID PROJECT							

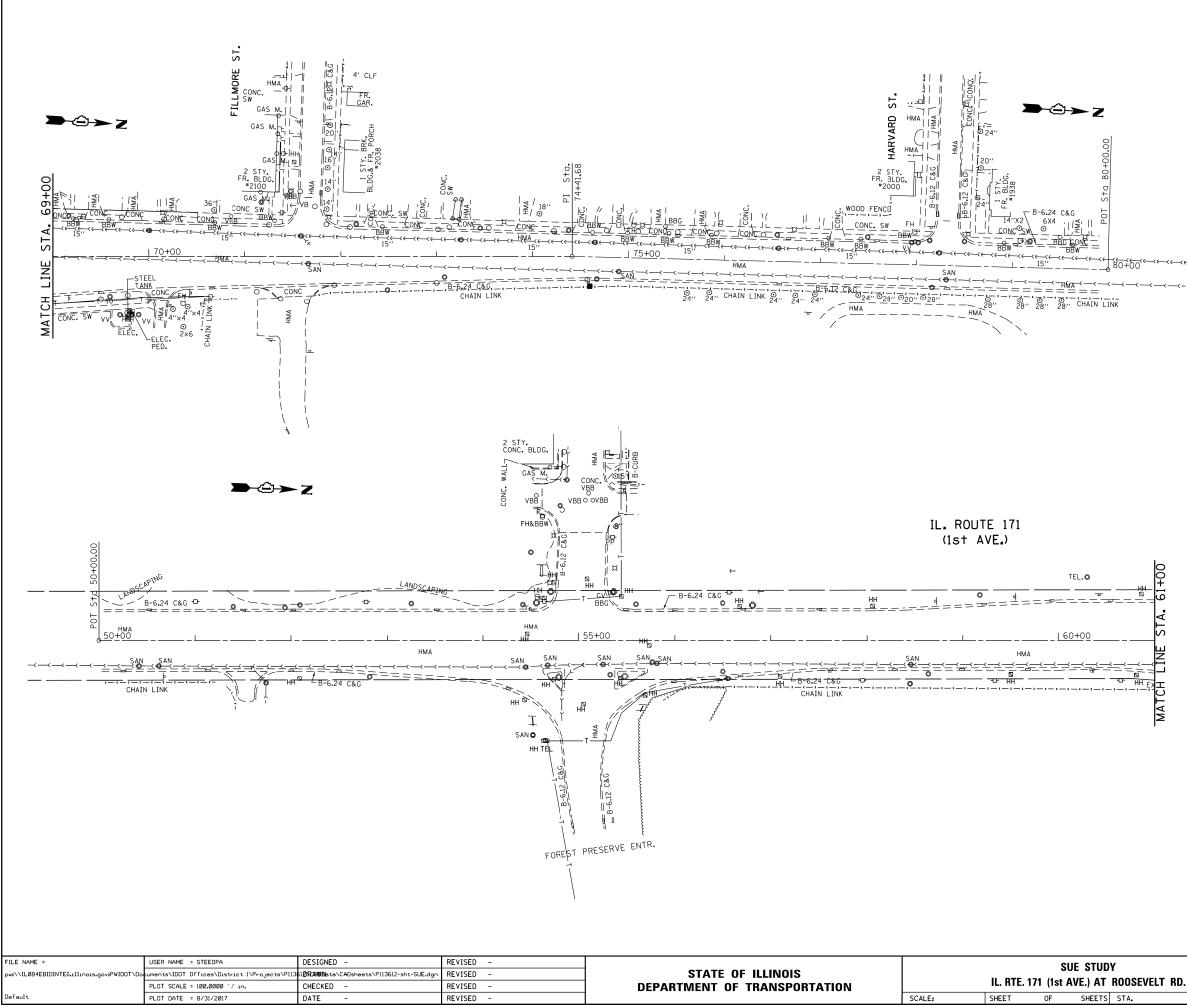


IDY T ROOSEVELT RD.		F.A.P. RTE.	SECTION	COUNTY	TOTAL SHEETS	SHEET NO.		
		372	3091-TS&N-1	СООК	103	46		
I NUUJEVELI ND.				CONTRACT	NO. 62	2A38		
IS ST	A. TO STA.		ILLINOIS FED. AID PROJECT					

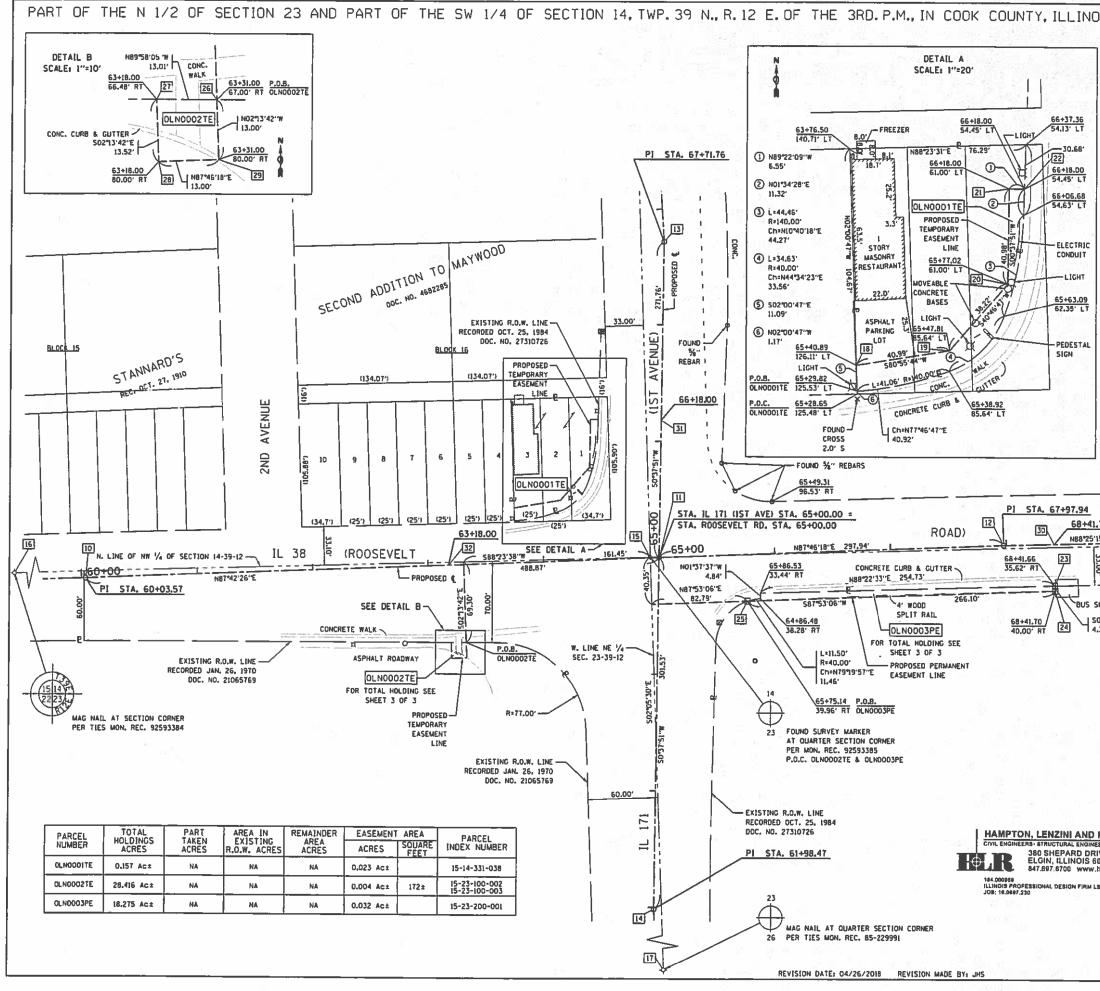
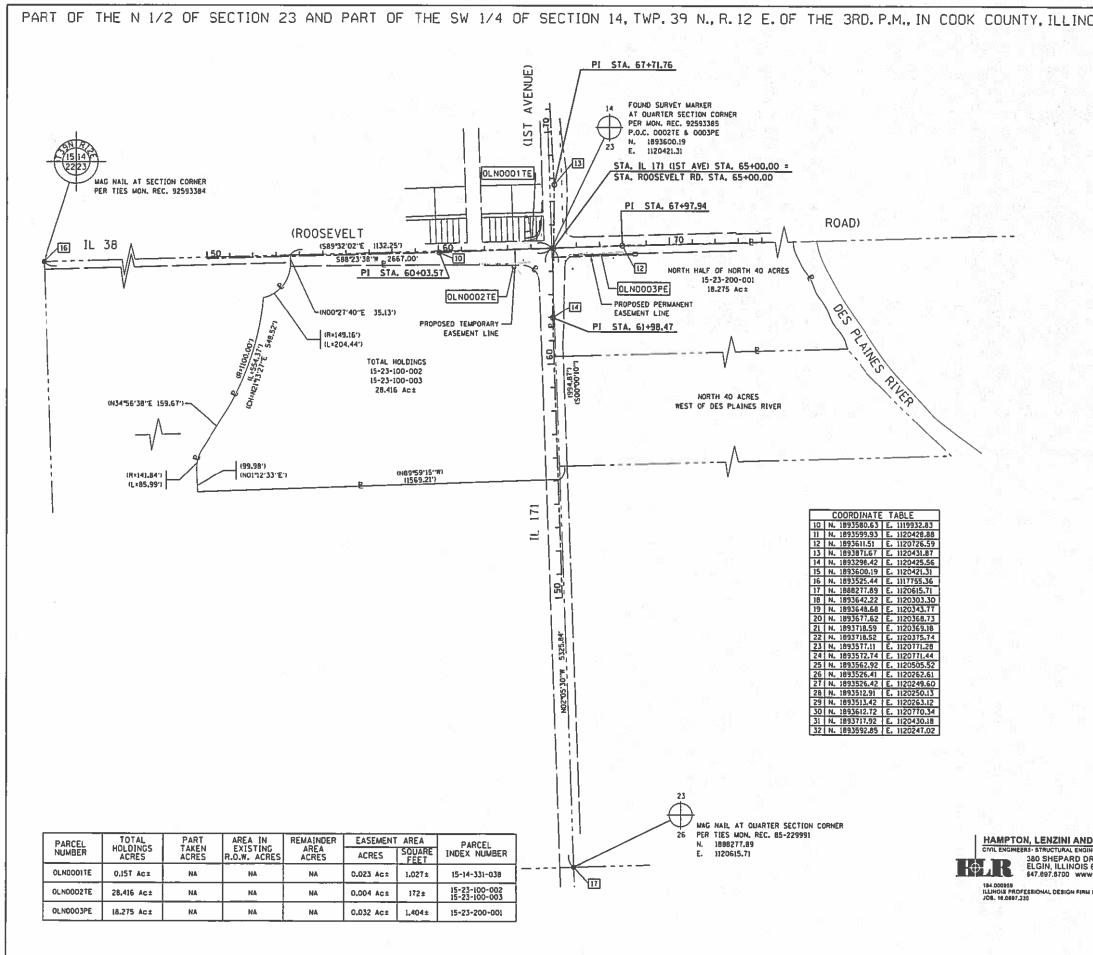
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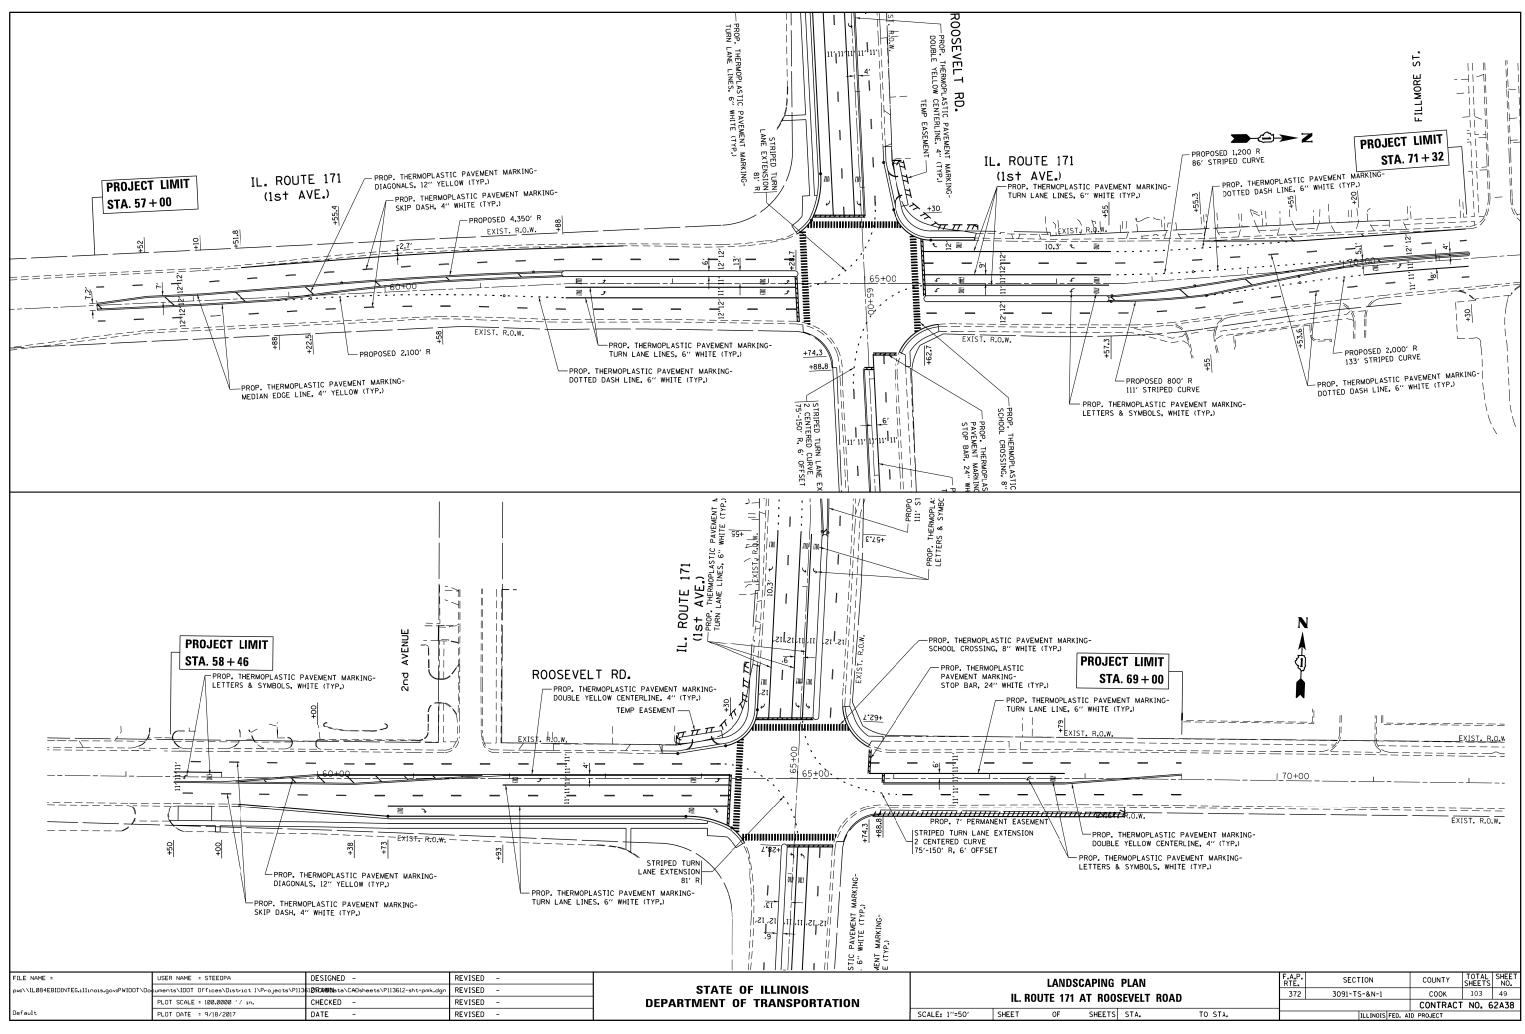
s.	t on the	LEGEND
	10 SECT	
	1615 CORM	IER 16 IS SECTION CORNER
		SECTION / DUARTER SECTION LINE
	34 E	PLATTED LOT LINES
1		APL APPARENT PROPERTY LINE GRAPHIC SCALE
N		EXISTING CENTERLINE
		EXISTING RIGHT OF WAY LINE SCALE: 1": 40"
		PROPOSED RIGHT OF WAY LINE EXISTING EASEMENT
		- PROPOSED EASEMENT
°—		- AC - PROPOSED ACCESS CONTROL LINE
	129.32' 129.32' (COMP)	MEASURED DIMENSION COMPUTED DIMENSION
	(129.32')	RECORDED DIMENSION
	Summelle	EXISTING BUILDING
,	IRON PIPE OR RO	D FOUND 🐵 'MAG' NAIL SET
100	CUT CROSS FOUN	D OR SET . 5 / 8' REBAR SET
TL T2	IRON ROD FLUSH	EFERENCE FOUND OR SET MONUMENTATION, SET 5/8 INCH WITH GROUND TO TIE FOUND IRON STAKE IDENTIFIED BY
T3	COLORED PLASTIC	CAP BEARING SURVEYORS REGISTRATION NUMBER.
8T1 8T2 8T3	BURIED 5/8 INCH	I CULTIVATED AREAS, REFERENCE FOUND DR SET MONUMENTATION. IRON ROD 20 INCHES BELOW GROUND TO TIE FOUND TIFIED BY COLORED PLASTIC CAP BEARING TRATION NUMBER.
b.	MARKER TO MONUN	DSED RIGHT OF WAY. SET DIVISION OF HIGHWAYS SURVEY JENT THE POSITION SHOWN, IDENTIFIED BY INSCRIPTION ORS REGISTRATION NUMBER,
M	BURIED 5/8 INCH	OSED RIGHT OF WAY IN CULTIVATED AREAS. METAL ROD 20 INCHES BELOW GROUND TO MARK FUTURE SURVEY IDENTIFIED BY COLORED PLASTIC CAP BEARING TRATION MUMBER.
	PERMANENT SURVE	Y MARKER, I.D.D.T. STANDARD 2135 (TO BE SET BY OTHERS) AKING PROPOSED TO BE SET
	STATE OF ILLINOI	
2	COUNTY OF KANE	ISS)
 rer 7'19'E	PROFESSIONAL LAN NIGHWAYS SHOWN I NORTH, RANGE IZ COOK COUNTY, THA AS SHOWN TO THE THAT THE PLAT CC THAT ALL MONUME PERMANENT OUAL! THEREON AND THAY ENABLE THE SURVI	FY THAT 1, JOHN H. SWEET, AN ILLINDIS DO SURVEYOR, HAVE SURVEYED THE PLAT OF MEREON IN SECTIONS 14 & 23, TOWNSHIP 39 AEST OF THE THIRD PRINCIPAL MERIDIAN, IT THE SURVEY IS TRUE AND COMPLETE BEST OF MY KNOWLEDGE AND BELIEF. DRRECTLY REPRESENTS SAID SURVEY. TY AND OCCUPY THE POSITIONS SHOWN T THE MONUMENTS ARE SUFFICIENT TO EY TO BE RETRACED, MADE FOR THE RANSPORTATION. STATE OF ILLINDIS.
	DATED AT	
		INAL LAND SURVEYOR NO.
	LICENSE EXPIRATIO	DN DATE:
		SIONAL SERVICE CONFORMS TO THE CURRENT ILLINDIS MINIMUM OR A BOUNDARY SURVEY FOR THAT PORTION SHOWN AS PROPOSED
	AND DISTANCE COORDINATE	NNS ARE MEASURED UNLESS OTHERWISE SPECIFIED. ALL BEARINGS ES SHOWN HEREON REFERENCE THE ILLINDIS STATE PLANE SYSTEM, EAST ZONE, NORTH AMERICAN DATUM OF 1983
	3. ALL MEASURE	MENT) "GRID". D AND CALCULATED DISTANCES ARE "GRID" NOT "GROUND". TO ND DISTANCES. DIVIDE GRID DISTANCES SHOWN BY THE COMBINATION .999971610.
WICH	K, INC.	PLAT OF HIGHWAYS
LAND SU	RVEYORS	STATE OF ILLINOIS
) 1gineer	ing.com	DEPARTMENT OF TRANSPORTATION
	PORATION	IL 171 (1ST AVE.)
		LIMITS: AT IL 38 (ROOSEVELT RD) COUNTY: COOK
		SECTION: JOB NO.: R-90-003-15 STA. 63+18 TO STA. 68+41.70
	in the second se	SCALE: 1"=40' SHEET 2 OF 3 SHEETS
1	APR 2 0 2018	BUREAU OF LAND ACQUISITION
	PLATS & LEGALS	201 WEST CENTER COURT




REVISION DATE: 04/26/2018 REVISION MADE BY: JHS


Real Martine Contractor

DIS.		LEGEND
		N N
	9 10 1615 CORM	
194		SECTION / QUARTER SECTION LINE
6 1	and Mills and a	PLATTED LOT LINES
_		APL APPARENT PROPERTY LINE GRAPHIC SCALE
5.5		EXISTING CENTERLINE FEET
8 2-		EXISTING RIGHT OF WAY LINE SCALE: I": 200"
8.7		
		- PROPOSED EASEMENT
		AC - EXISTING ACCESS CONTROL LINE - AC - PROPOSED ACCESS CONTROL LINE
	129.32	MEASURED DIMENSION
	129.32' (COMP) (129.32')	COMPUTED DIMENSION RECORDED DIMENSION
	(Innin)	EXISTING BUILDING
- 18		성 철도 전문을 위한 것이라는 것이 많이 많
0 +	IRON PIPE OR RO CUT CROSS FOUN	
• TI 12 T3	IRON ROD FLUSH COLORED PLASFIC	EFERENCE FOUND OR SET MONUMENTATION, SET 5/8 INCH WITH GROUND TO TIE FOUND IRON STAKE IDENTIFIED BY CAP BEARING SURVEYORS REGISTRATION MUMBER.
• B1 B1 B1	IRON STAKE. IDEN	N CULTIVATED AREAS.REFERENCE FOUND OR SET MONUMENTATION. IRON ROD 20 INCHES BELOW GROUND TO TIE FOUND ITIFIED BY COLORED PLASTIC CAP BEARING ITATION NUMBER.
	MARKER TO MONUI	POSED RICHT OF WAY. SET DIVISION OF HICHWAYS SURVEY MENT THE POSITION SHOWN, IDENTIFIED BY INSCRIPTION FORS REGISTRATION NUMBER.
ш м	BURIED 5/8 INCH MARKER POSITION	POSED RIGHT OF WAY IN CULTIVATED AREAS, METAL ROD 20 INCHES BELOW CROUND TO MARK FUTURE SURVEY I IDENTIFIED BY COLORED PLASTIC CAP BEARING ITRATION NUMBER.
•		EY MARKER, J.D.O.T. STANDARD 2135 (TO BE SET BY OTHERS) (AKING PROPOSED TO BE SET
	STATE OF ILLINO	(S))SS
	COUNTY OF KANE	1
	PROFESSIONAL LA HIGHWAYS SHOWN NORTH, RANCE 12 COOK COUNTY, TH AS SHOWN TO THE THAT THE PLAT C THAT ALL MONUME PERNAMENT OUALI THEREON AND THA ENABLE THE SURV	IFY THAT I, JOHN H. SWEET, AN ILLINOIS ND SURVEYOR. HAVE SURVEYED THE PLAT OF HEREON IN SECTIONS SURVEYED THE PLAT OF HEREON IN SECTIONS THAT ALL AND COMPLETE DEST OF THE THIRD PRINCIPAL MERIDIAN, AT THE SURVEY IS TRUE AND COMPLETE BEST OF MY KNOWLEDGE AND BELIEF. ORRECTLY REPRESENTS SAID SURVEY, ENTS FOUND AND ESTABLISHED ARE OF TY AND OCCUPY THE POSITIONS SHOWN IT THE MORUMENTS ARE SUFFICIENT TO EY TO BE RETRACED, MADE FOR THE FRAMSPORTATION, STATE OF ILLINOIS.
	DATED AT	, ILLINDIS THIS DAY OF 20 A.D.
	ILLINOIS PROFESS	
	NOTES	<u>NQV, 3D, 2018</u>
		SIGNAL SERVICE CONFORMS TO THE CURRENT ILLINOIS MINIMUM For a boundary survey for that portion shown as proposed Y.
	AND DISTANC COORDINATE	ONS ARE MEASURED UNLESS OTHERWISE SPECIFIED, ALL BEARINGS ES SHOWN HEREON REFERENCE THE ILLINDIS STATE PLANE SYSTEM, EAST ZONE, NORTH AMERICAN DATUM OF 1983
	3. ALL MEASURE OBTAIN GROU	IMENT) "GRID". ED AND CALCULATED DISTANCES ARE "GRID" NDT "GROUND", TO IND DISTANCES. DIVIDE GRID DISTANCES SHOWN BY THE COMBINATION
	FACTOR OF (
RENWICK, INC.		PLAT OF HIGHWAYS
RIVE 50123 Juhirengir	neering.com	STATE OF ILLINOIS DEPARTMENT OF TRANSPORTATION IL 171 (1ST AVE.)
	E CORPORATION	LIMITS: AT IL 38 (ROOSEVELT RD) COUNTY1COOK
	IDOT USE ONLY	SECTION: JOB NO.5 R*90-003-15
	SS	STA. 50+00 TO STA. 74+00 SCALE: 1"+200" SHEET 3 OF 3 SHEETS





0	SEVELT ROAD		372	3091-TS-&N-1		COOK	103	49
						CONTRACT	NO. 6	52A38
rs	STA.	TO STA.		ILLINOIS	FED. A	D PROJECT		

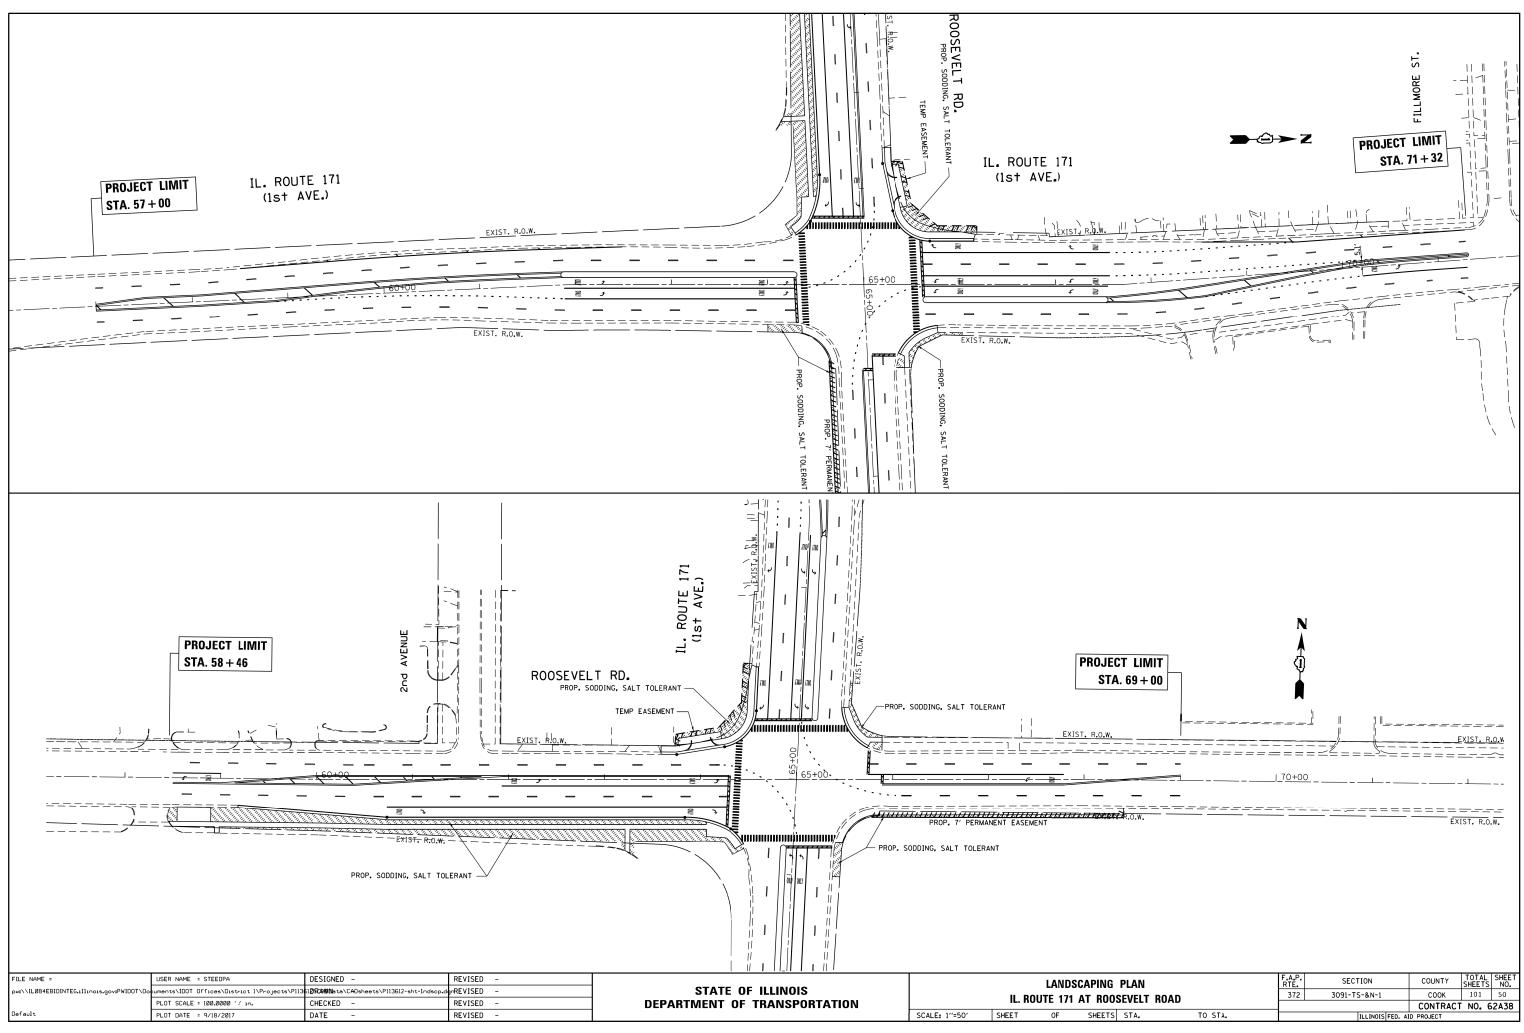

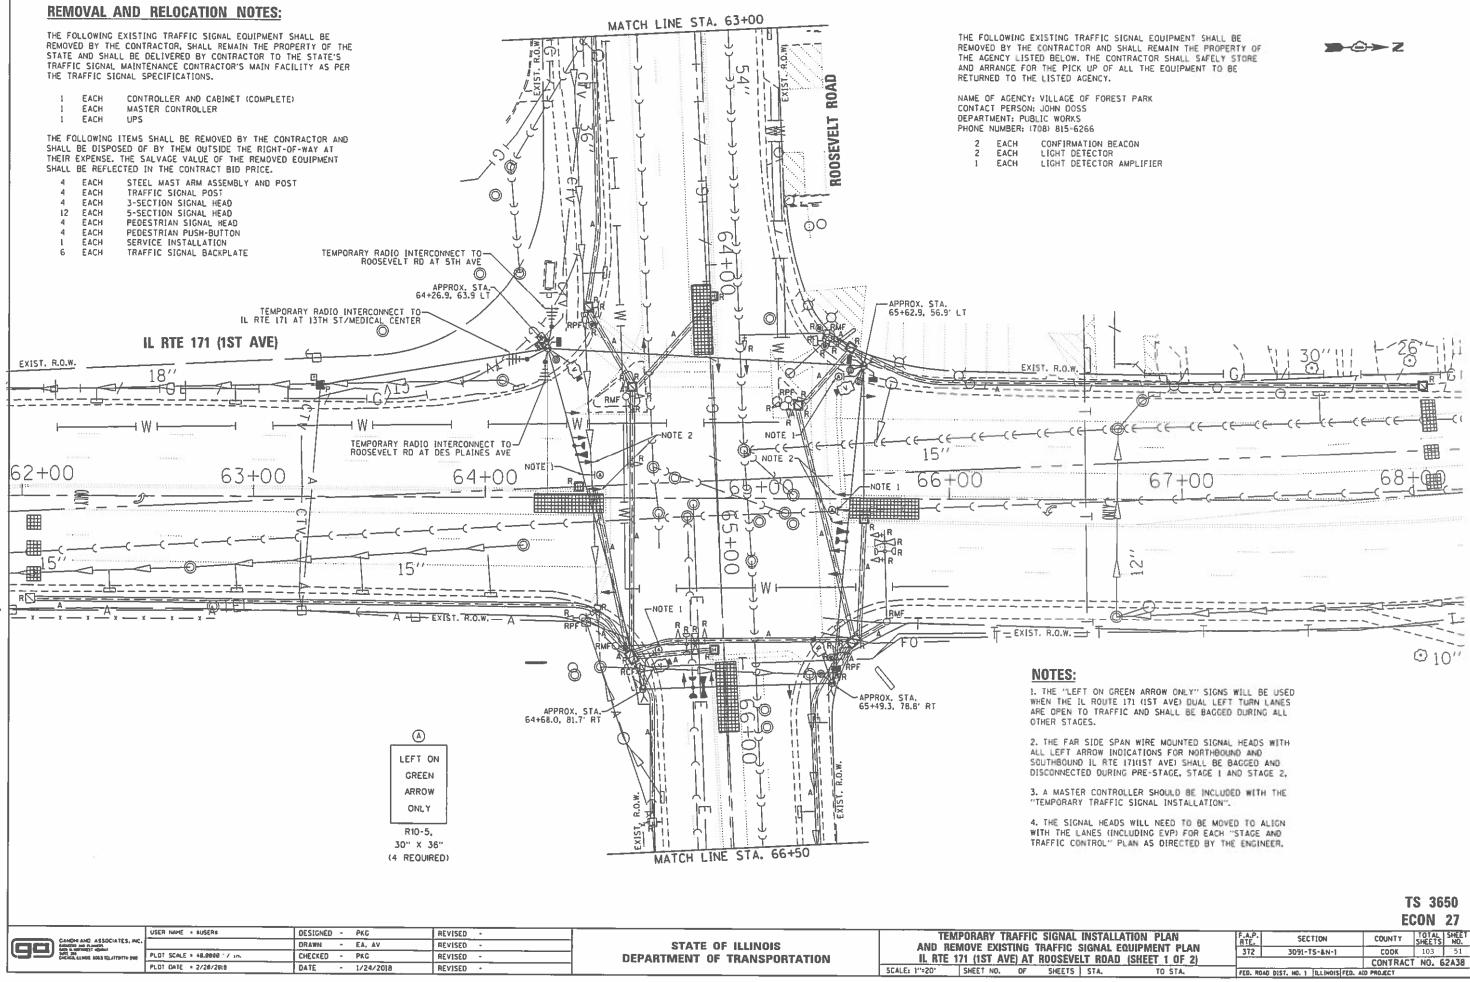


ISTALLATION PLAN	F.A.P. RTE.			COUNTY	TOTAL SHEETS	SHEET NO.
GNAL EQUIPMENT PLAN ROAD (SHEET 1 OF 2)		372 3091-TS-&N-1		COOK	103	51
				CONTRACT	NO. 6	2A38
STA. TO STA.	FED. RO	AD DIST. NO. 1 IL	LINOIS FED. AL	D PROJECT		

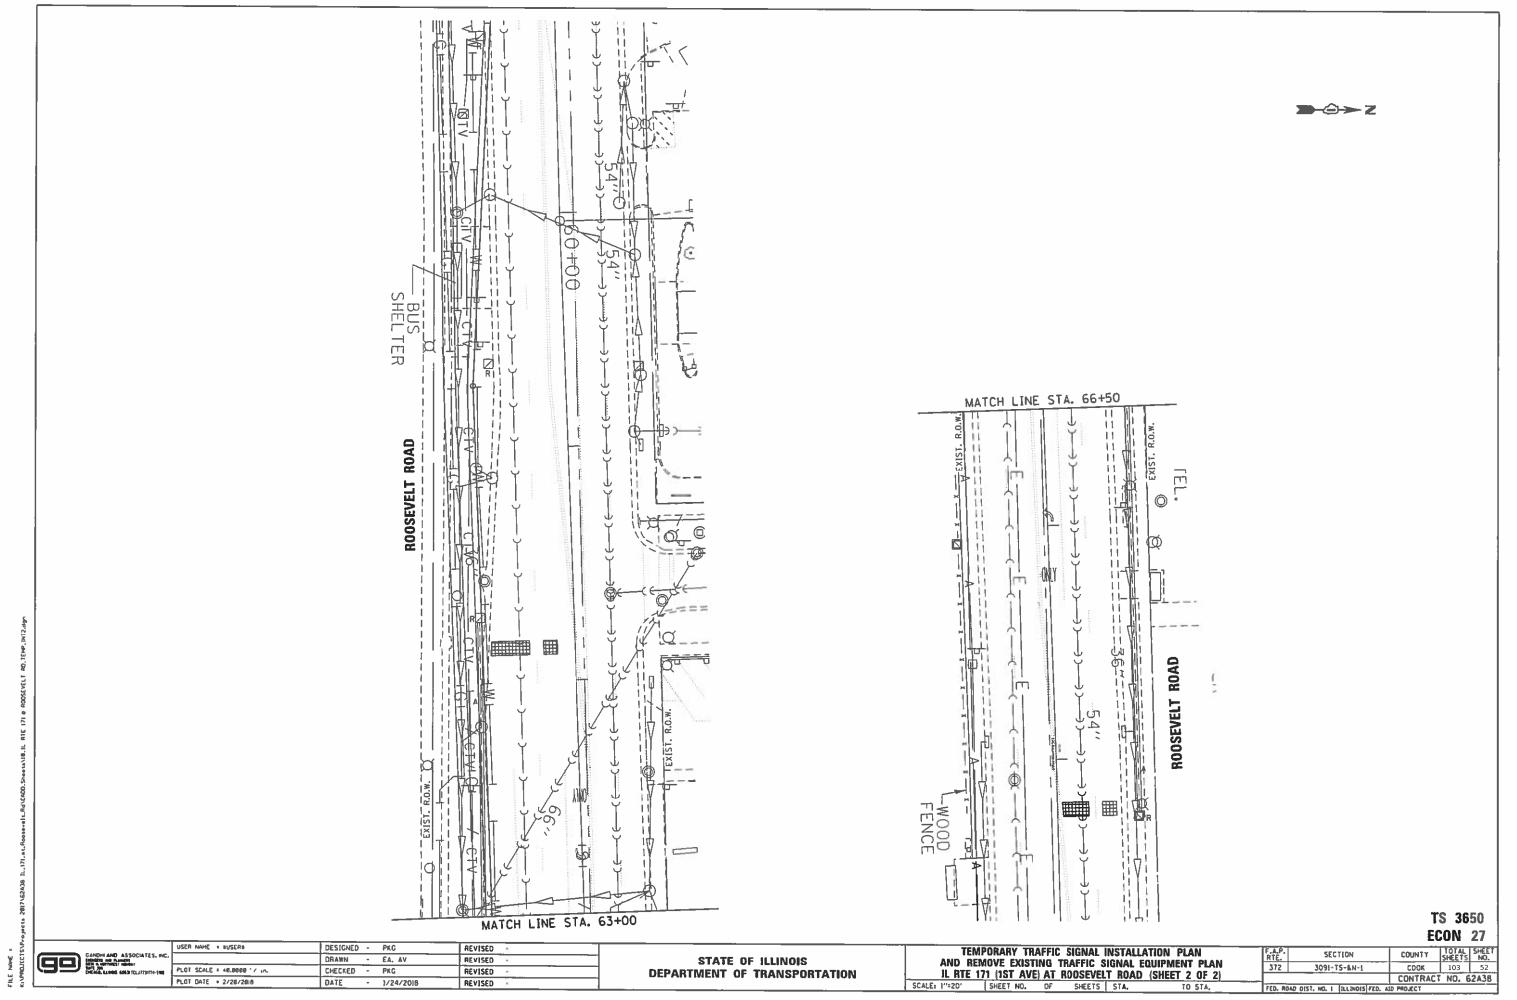

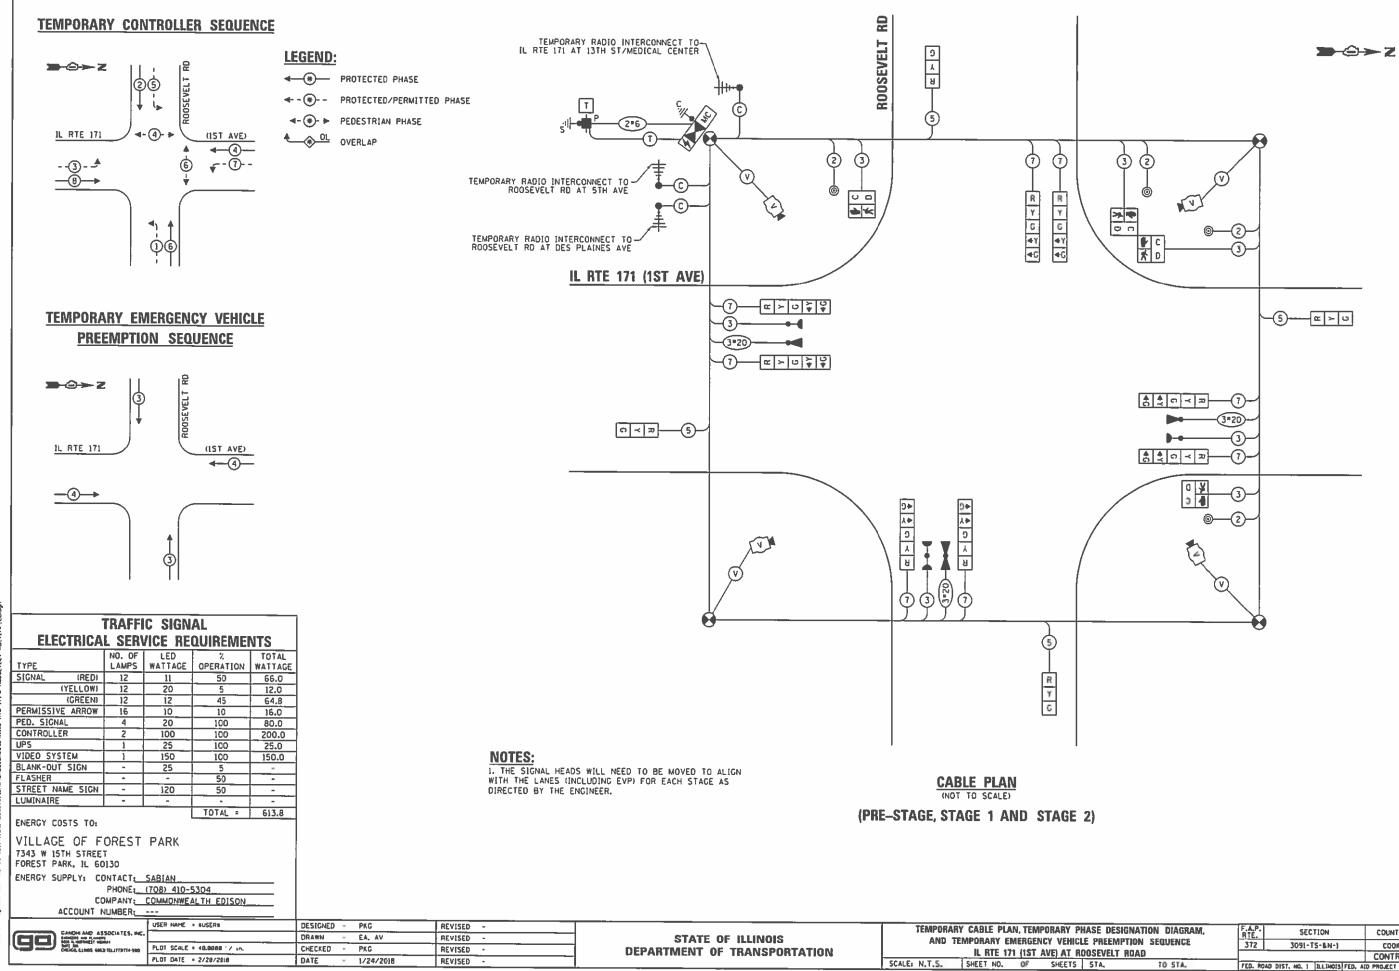


1

SE DESIGNA		F.A.P. RTE.	SECTION	COUNTY	TOTAL SHEETS	SHEET NO.
PREEMPTION SEQUENCE		372	3091-15-6N-1	COOK	103	53
DSEVELT ROA	-			CONTRACT	T NO. 6	52A38
<u>5TA.</u>	TO STA.	FED. ROA	O DIST. NO. 1 DLLINOIS FED. A	ID PROJECT		

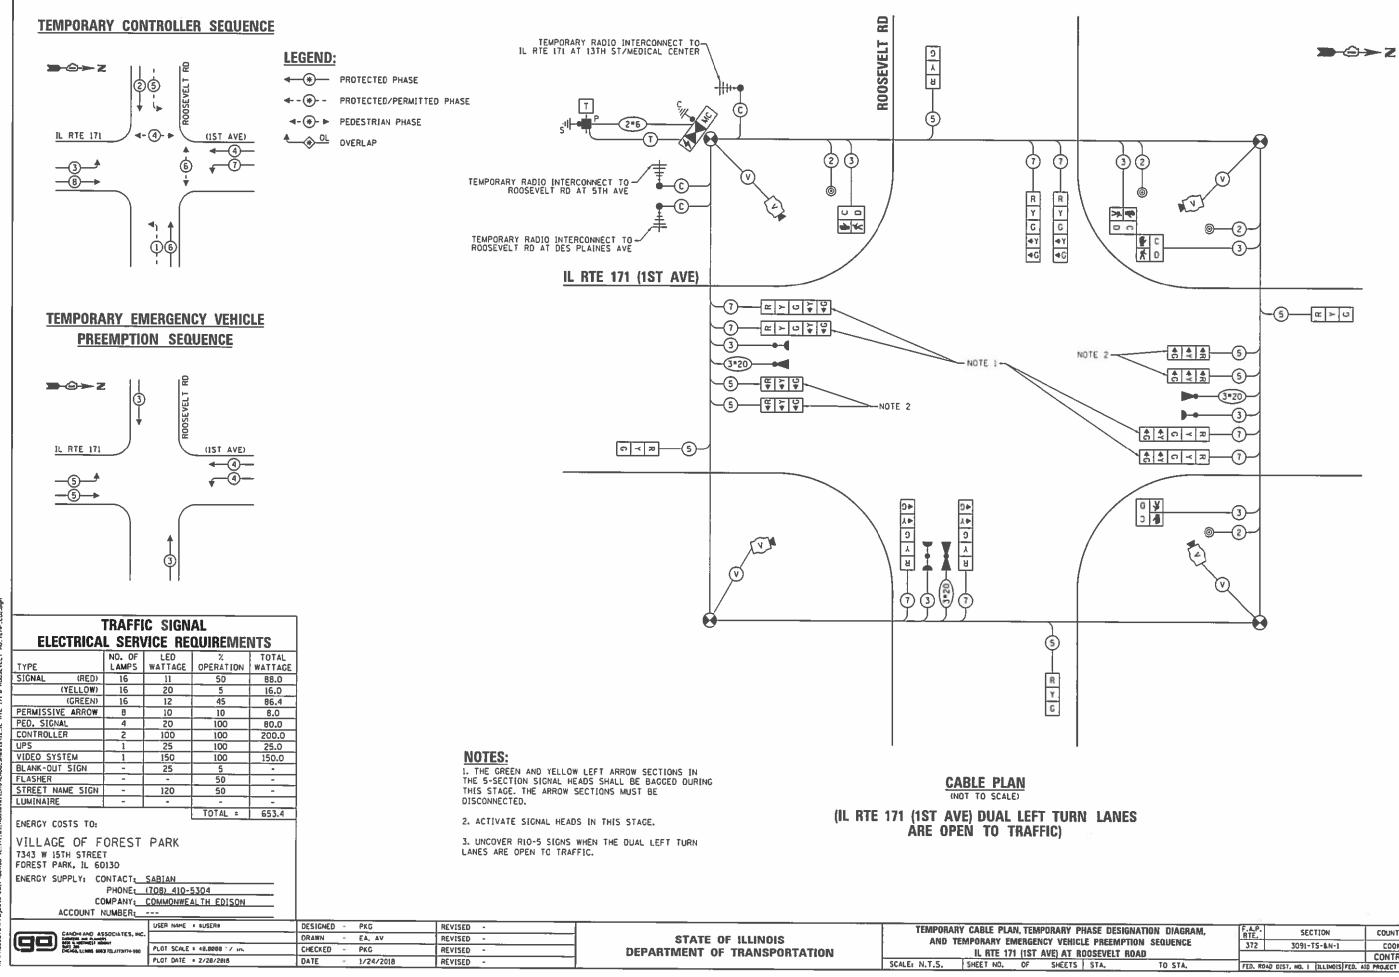

ILE .

TOL DESIGNATION DIAGRAM,	F.A.P. RTE.	SECTION	COUNTY	TOTAL SHEETS	SHEET NO.
PREEMPTION SEQUENCE	372	3091-TS-&N-1	COOK	103	54
DSEVELT ROAD			CONTRACT	NO. 6	2438
STA, TO STA,	FED. RO	AD DIST. NO. 1 JILLINOIS FED. AS	D PROJECT		

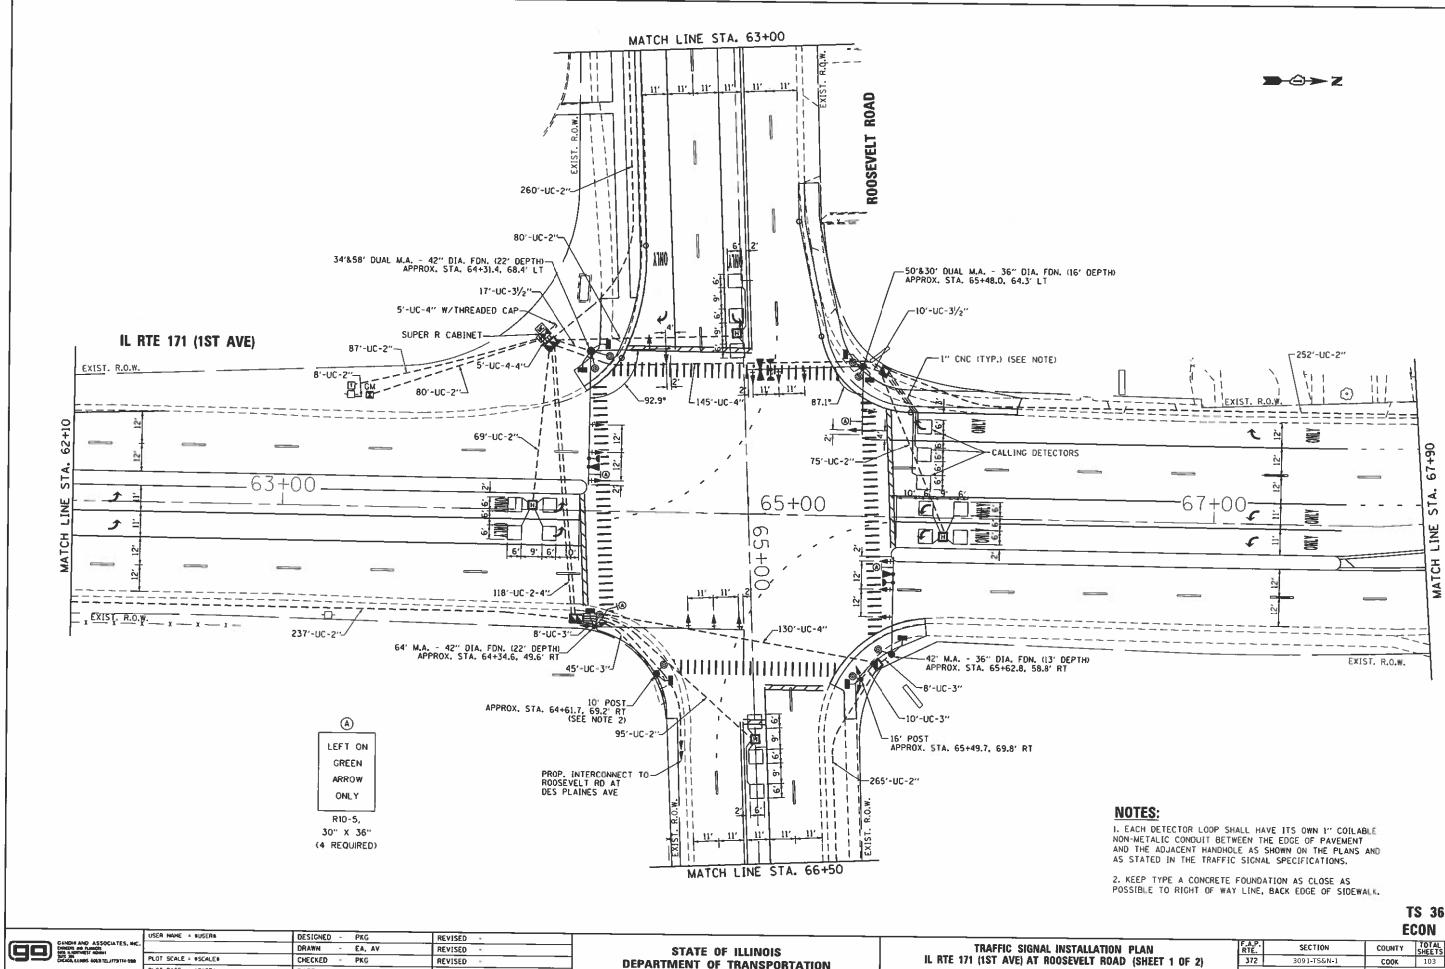

NAME EL. EILE

PLOT DATE = aDATEs

DATE


9/10/2018

REVISED

SCALE: L"=20" SHEET NO. OF SHEETS STA



						0011	
ATION PLAN			F.A.P. RTE.	SECTION	COUNTY	TOTAL	SHEET NO.
ROAD	(SHEET	1 OF 2)	372	3091-TS&N-1	COOK	103	55
	-				CONTRAC	T NO. 6	2A38
'A.	10	STA.	FED. RC	DAD DIST. NO ILLINOIS FED. A	ID PROJECT		

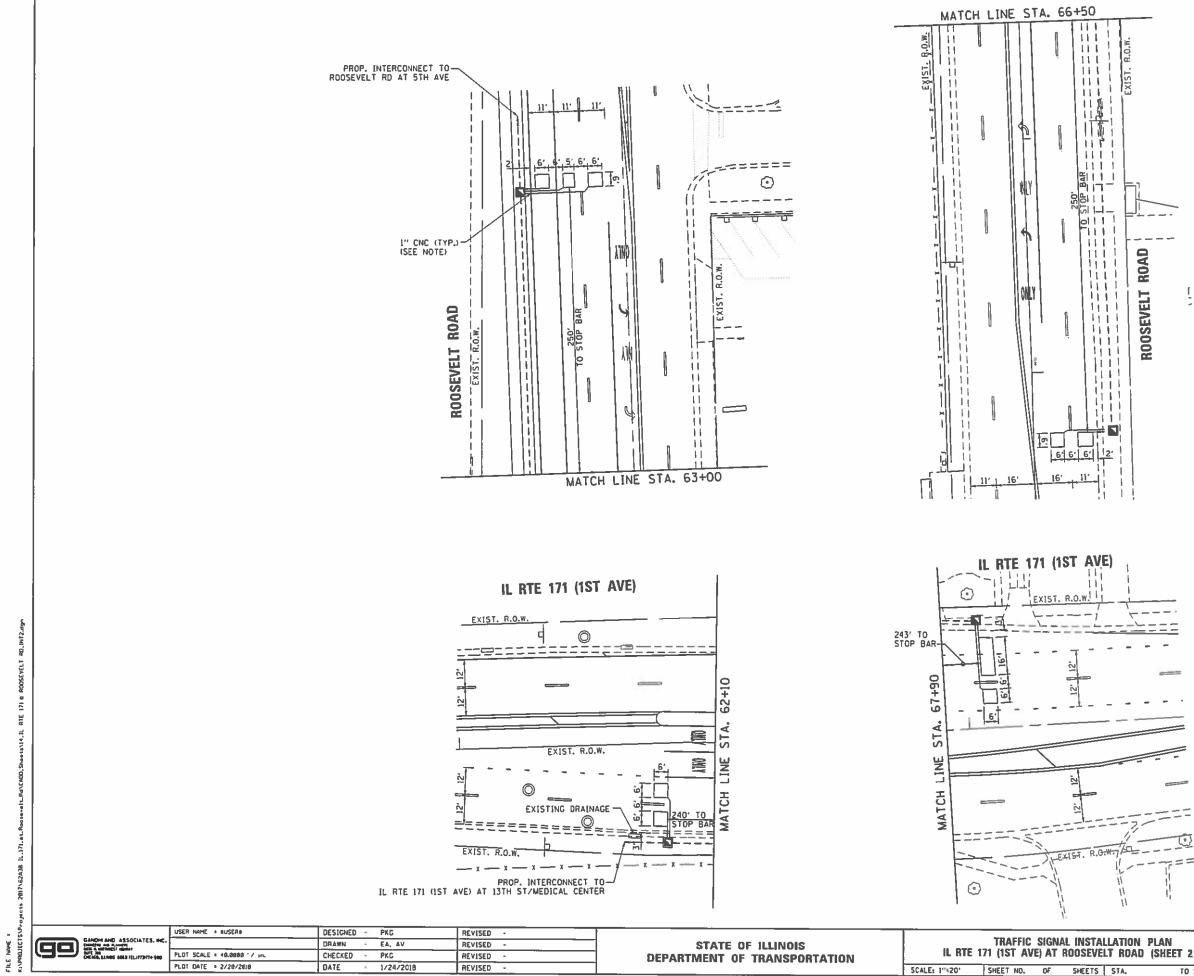



TS 3650 ECON 27

			EL	UIN .	21
ATION PLAN	F.A.P. RTE.	SECTION	COUNTY	TOTAL SHEETS	SHEET NO.
ROAD (SHEET 2 OF 2)	372	3091-TS-&N-1	COOK	103	56
			CONTRACT	NO. 6	2A38
STA. TO STA.	FED. RO	AD DIST. NO. 1 ILLINOIS FED. A	D PROJECT		

NOTES:

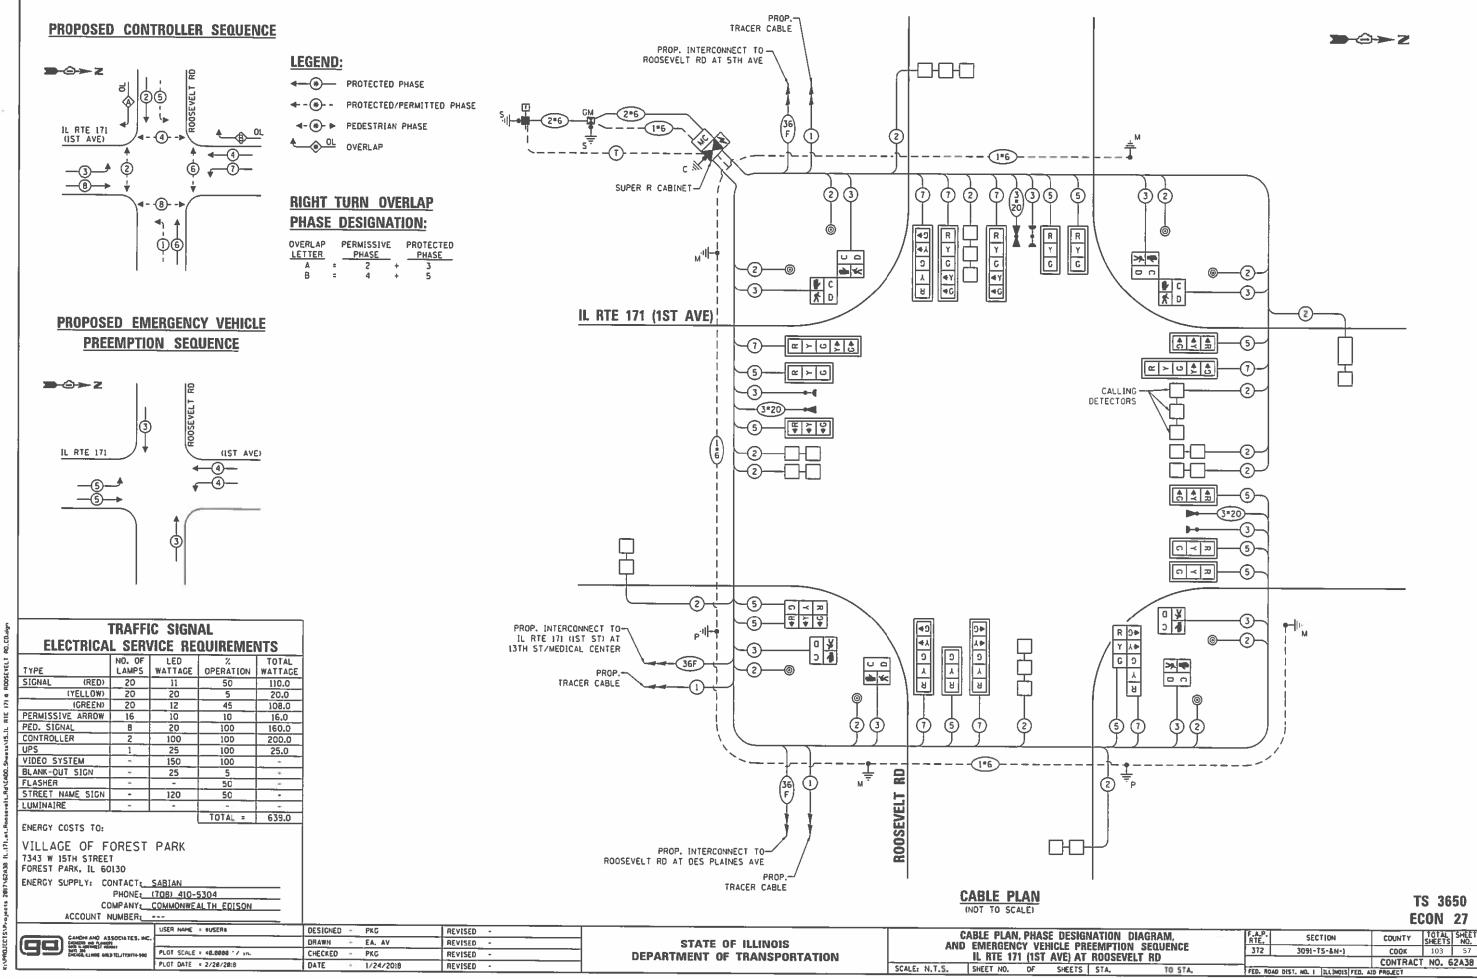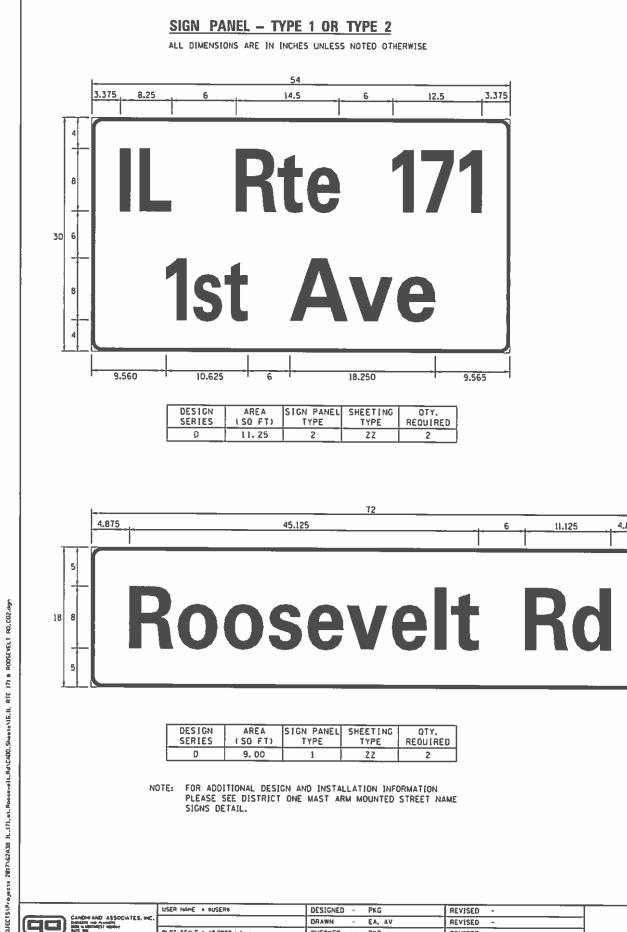I. EACH DETECTOR LOOP SHALL HAVE ITS OWN 1" COILABLE NON-METALIC CONDUIT BETWEEN THE EDGE OF PAVEMENT AND THE ADJACENT HANDHOLE AS SHOWN ON THE PLANS AND AS STATED IN THE TRAFFIC SIGNAL SPECIFICATIONS.






21


ITEM DESCRIPTION	UNITS	T
SIGN PANEL - TYPE 1	SO FT	
SIGN PANEL - TYPE 2	SQ FT	
UNDERGROUND CONDUIT. GALVANIZED STEEL, 2" DIA.	FOOT	
UNDERGROUND CONDUIT. GALVANIZED STEEL, 3" DIA.	FOOT	_
UNDERGROUND CONDUIT, GALVANIZED STEEL, 32" DIA.	FOOT	
UNDERGROUND CONDUIT, GALVANIZED STEEL, 4" DIA.	FODT	
HANDHOLE	EACH	
HEAVY-DUTY HANDHOLE	EACH	
DOUBLE HANDHOLE	EACH	-
TRANSCEIVER - FIBER OPTIC	EACH	
ELECTRIC CABLE IN CONDUIT, SIGNAL NO. 14 2C	FODT	
ELECTRIC CABLE IN CONDUIT, SIGNAL NO. 14 3C	FOOT	
ELECTRIC CABLE IN CONDUIT, SIGNAL NO. 14 SC	FODT	
ELECTRIC CABLE IN CONDUIT, SIGNAL NO. 14 TC	FOOT	
ELECTRIC CABLE IN CONDUIT, LEAD-IN, NO. 14 1 PAIR	FOOT	
ELECTRIC CABLE IN CONDUIT, SERVICE, ND. 6 20	FODT	
ELECTRIC CABLE IN CONDUIT, EQUIPMENT GROUNDING CONDUCTOR, NO. 6 10	FOOT	
TRAFFIC SIGNAL POST, GALVANIZED STEEL 16 FT.	EACH	
STEEL MAST ARM ASSEMBLY AND POLE. 38 FT.	EACH	
STEEL MAST ARM ASSEMBLY AND POLE, 42 FT.	EACH	_
CONCRETE FOUNDATION, TYPE A	FOOT	
CONCRETE FOUNDATION, TYPE C	FOOT	_
CONCRETE FOUNDATION, TYPE E 36-INCH DIAMETER	FOOT	
CONCRETE FOUNDATION, TYPE E 42-INCH DIAMETER	FOOT	
SIGNAL HEAD, LED, 1-FACE, 3-SECTION, MAST ARM MOUNTED	EACH	_
SIGNAL HEAD, LED, 1-FACE, 3-SECTION, BRACKET MOUNTED	EACH	
SIGNAL HEAD, LED, 1-FACE, 5-SECTION, BRACKET MOUNTED		
SIGNAL HEAD, LED, 1-FACE, 5-SECTION, MAST ARM MOUNTED	EACH	
PEDESTRIAN SIGNAL HEAD, LED, 1-FACE, BRACKET MOUNTED WITH COUNTDOWN TIMER	EACH	
TRAFFIC SIGNAL BACKPLATE, LOUVERED, FORMED PLASTIC	EACH	
INDUCTIVE LOOP DETECTOR	EACH	_
DETECTOR LOOP, TYPE 1	EACH	
LIGHT DETECTOR	FOOT	_
LIGHT DETECTOR AMPLIFIER	EACH	
PEDESTRIAN PUSH-BUTTON	EACH	
TEMPORARY TRAFFIC SIGNAL INSTALLATION	EACH	
REMOVE EXISTING TRAFFIC SIGNAL EDUIPMENT	EACH	
REMOVE EXISTING TRAFFIC SIGNAL EDUPMENT	EACH	
REMOVE EXISTING HANDHOLE	EACH	
	EACH	_
REMOVE EXISTING CONCRETE FOUNDATION	EACH	
EMERGENCY VEHICLE PRIORITY SYSTEM LINE SENSOR CABLE, NO. 20 3/C	FOOT	
FULL-ACTUATED CONTROLLER AND TYPE SUPER R CABINET (SPECIAL)	EACH	
SERVICE INSTALLATION, GROUND MOUNTED, METERED	EACH	
UNINTERRUPTABLE POWER SUPPLY, SPECIAL	ÉACH	
TEMPORARY TRAFFIC SIGNAL TIMING	EACH	
STEEL MAST ARM ASSEMBLY AND POLE WITH DUAL MAST ARMS, 34 FT. AND 58 FT.	EACH	
STEEL MAST ARM ASSEMBLY AND POLE WITH DUAL MAST ARMS. 30 FT. AND 50 FT.	EACH	


4													EGUN Z/
- 23		USER NAME + SUSERS	DESIGNED -	PKG	REVISED -		ſ	MAST ARM N	MOUNTED ST	REET NAME SIGNS	F.A.P.	SECTION	COUNTY TOTAL SHEET
¥ 5	CANDIN AND ASSOCIATES, MC.		DRAWN -	EA, AV	REVISED -	STATE OF ILLINOIS			CHEDULE OF		RTE.		JANEE 1 JANEE
2 2		PLOT SCALE + 48.8888 1/ 10.	CHECKED	PKG	REVISED +	DEPARTMENT OF TRANSPORTATION				ROOSEVELT RD	372	3091-TS-6N-1	COOK 103 58
316		PLOT DATE + 2/28/2018	DATE	1/24/2018	REVISED -		SCALE: N.T.S.	SHEET NO. OF	SHEETS			O DIST. NO. 1 DLLINDIS FED.	CONTRACT NO. 62438
								311,2,7 1103 01	316613	10 316	FED. NOA	J DIST. NO. 1 ILLINOIS FED.	ALD PHOJECT


4.875

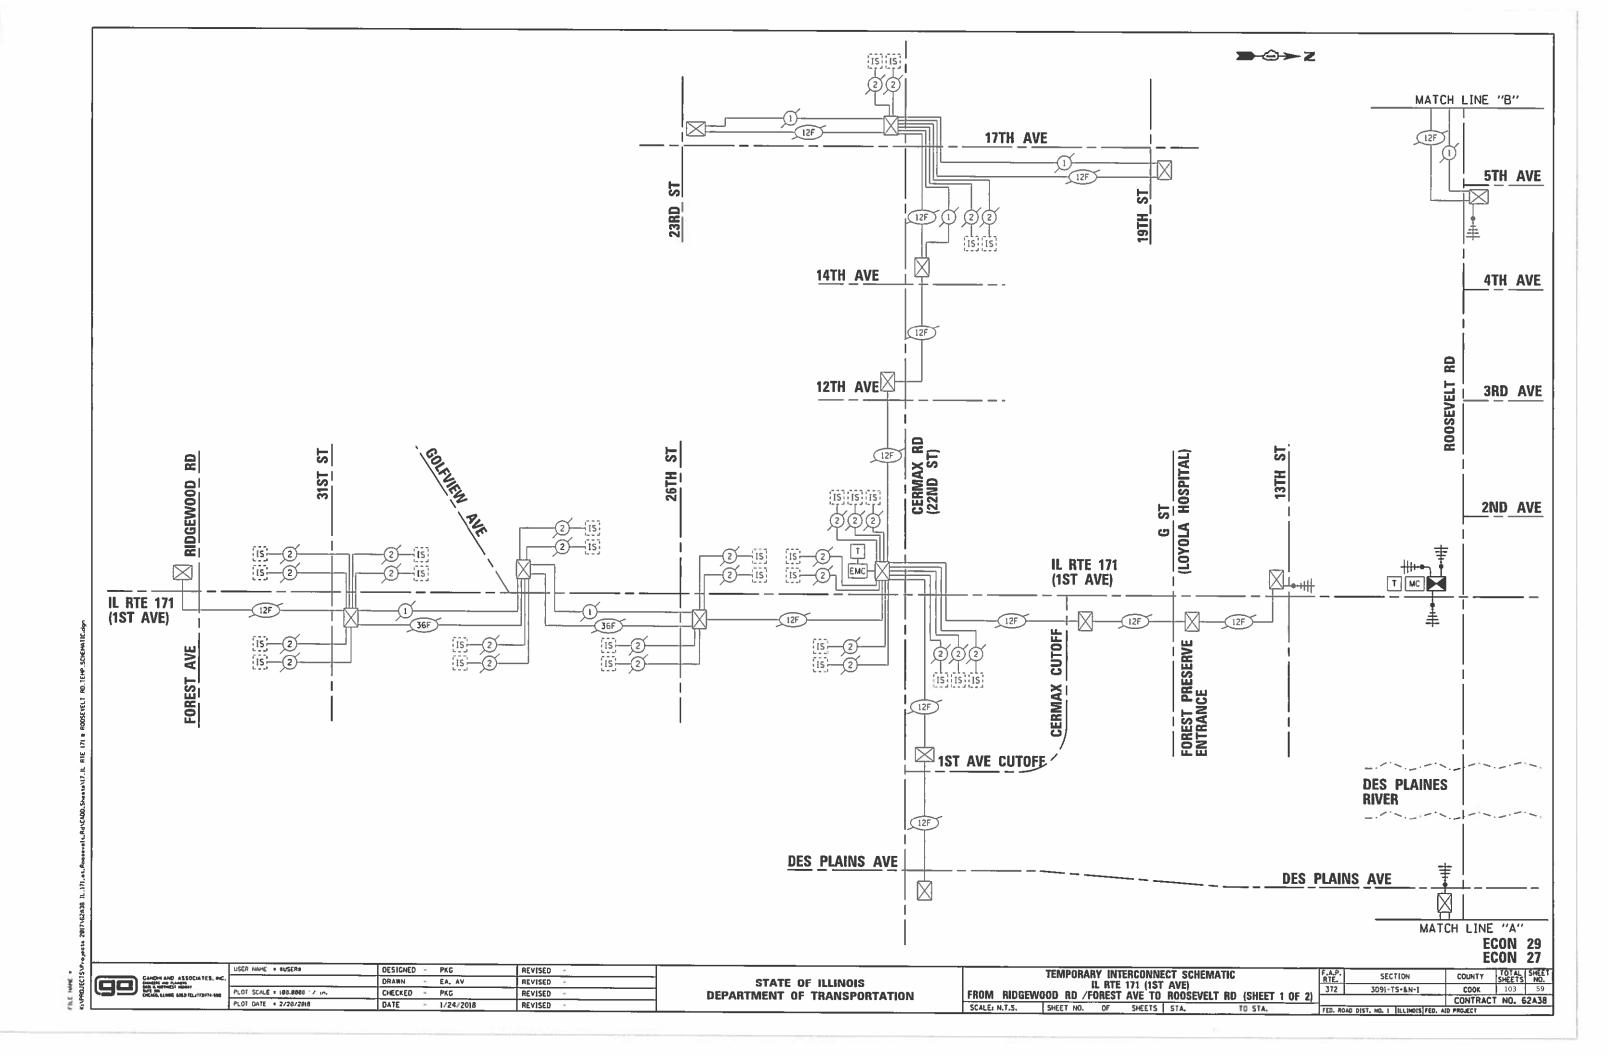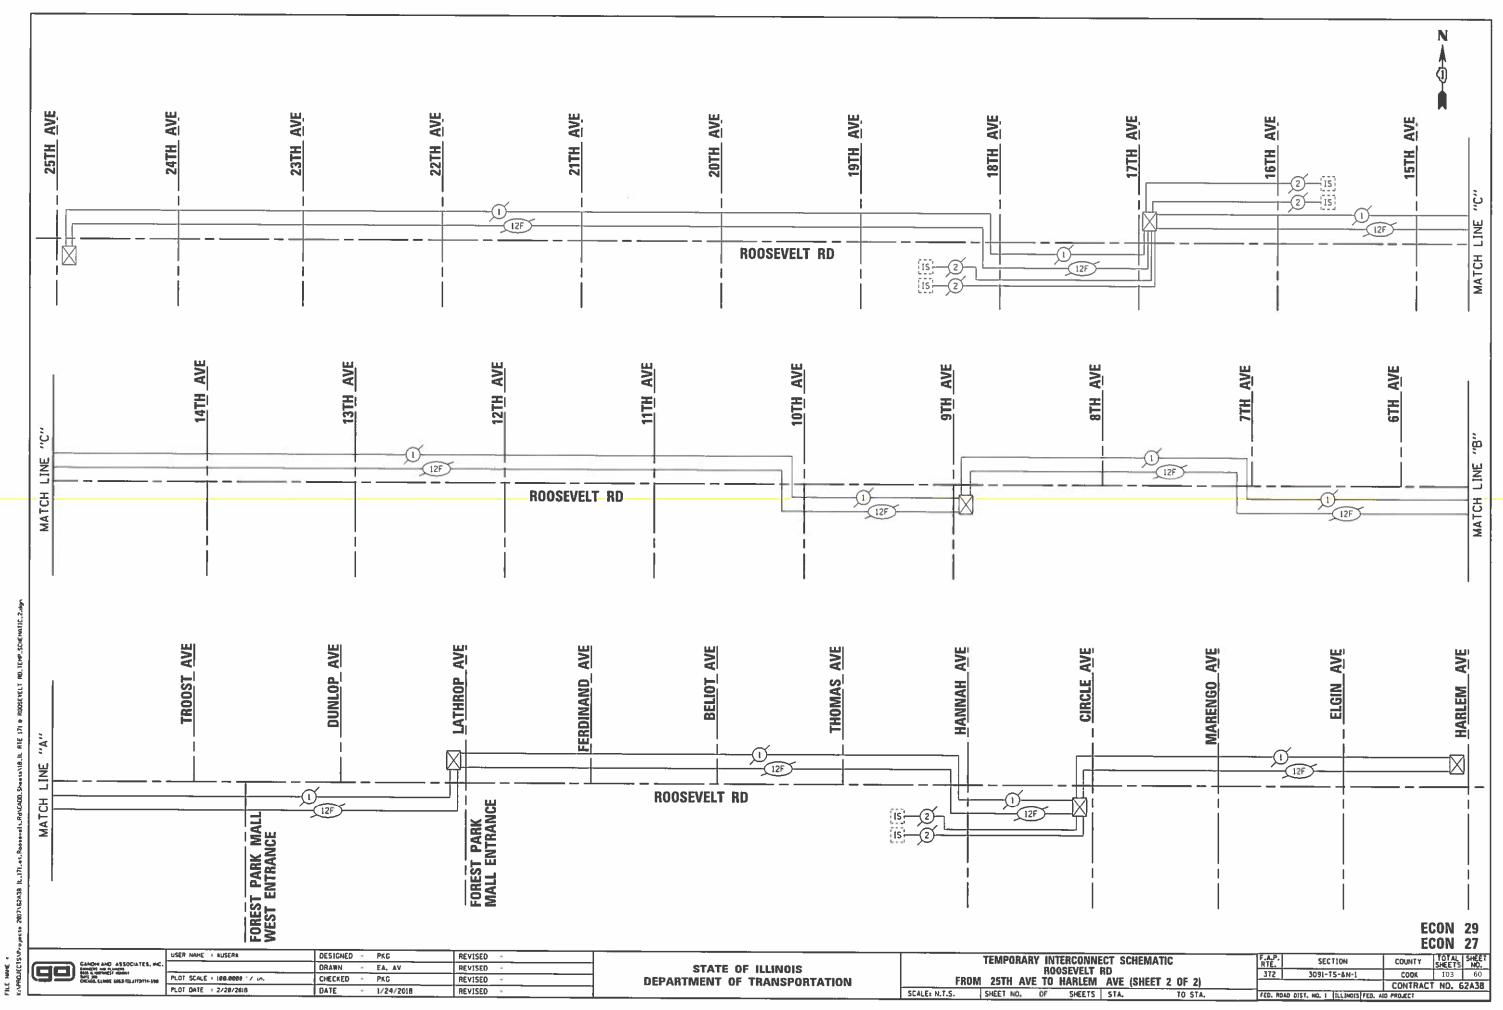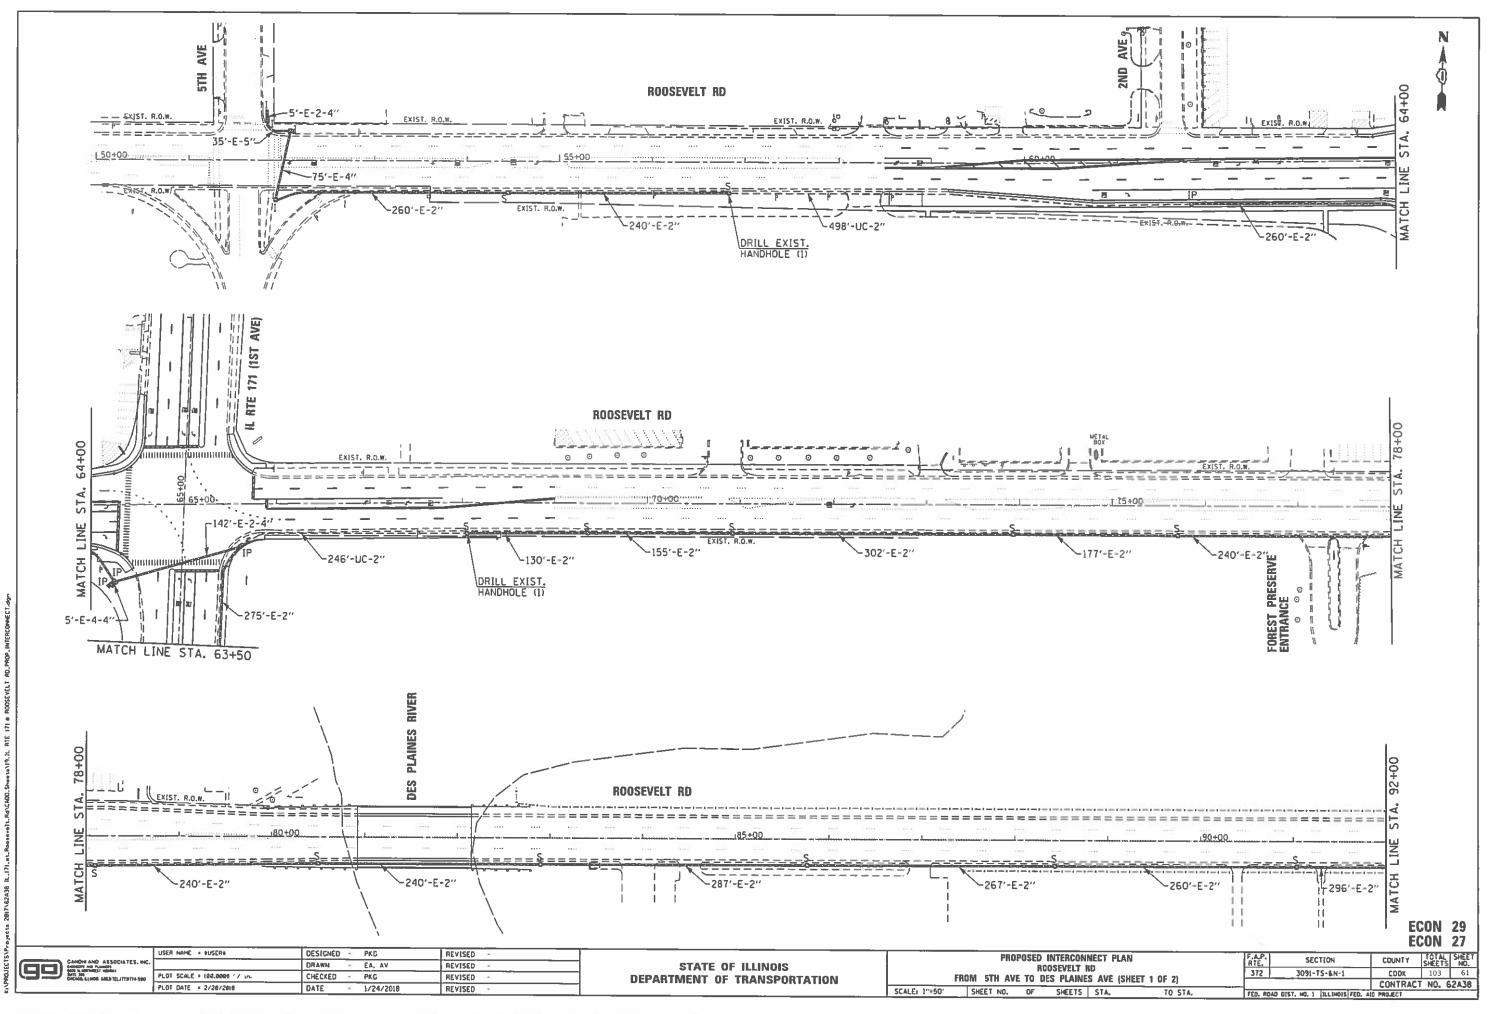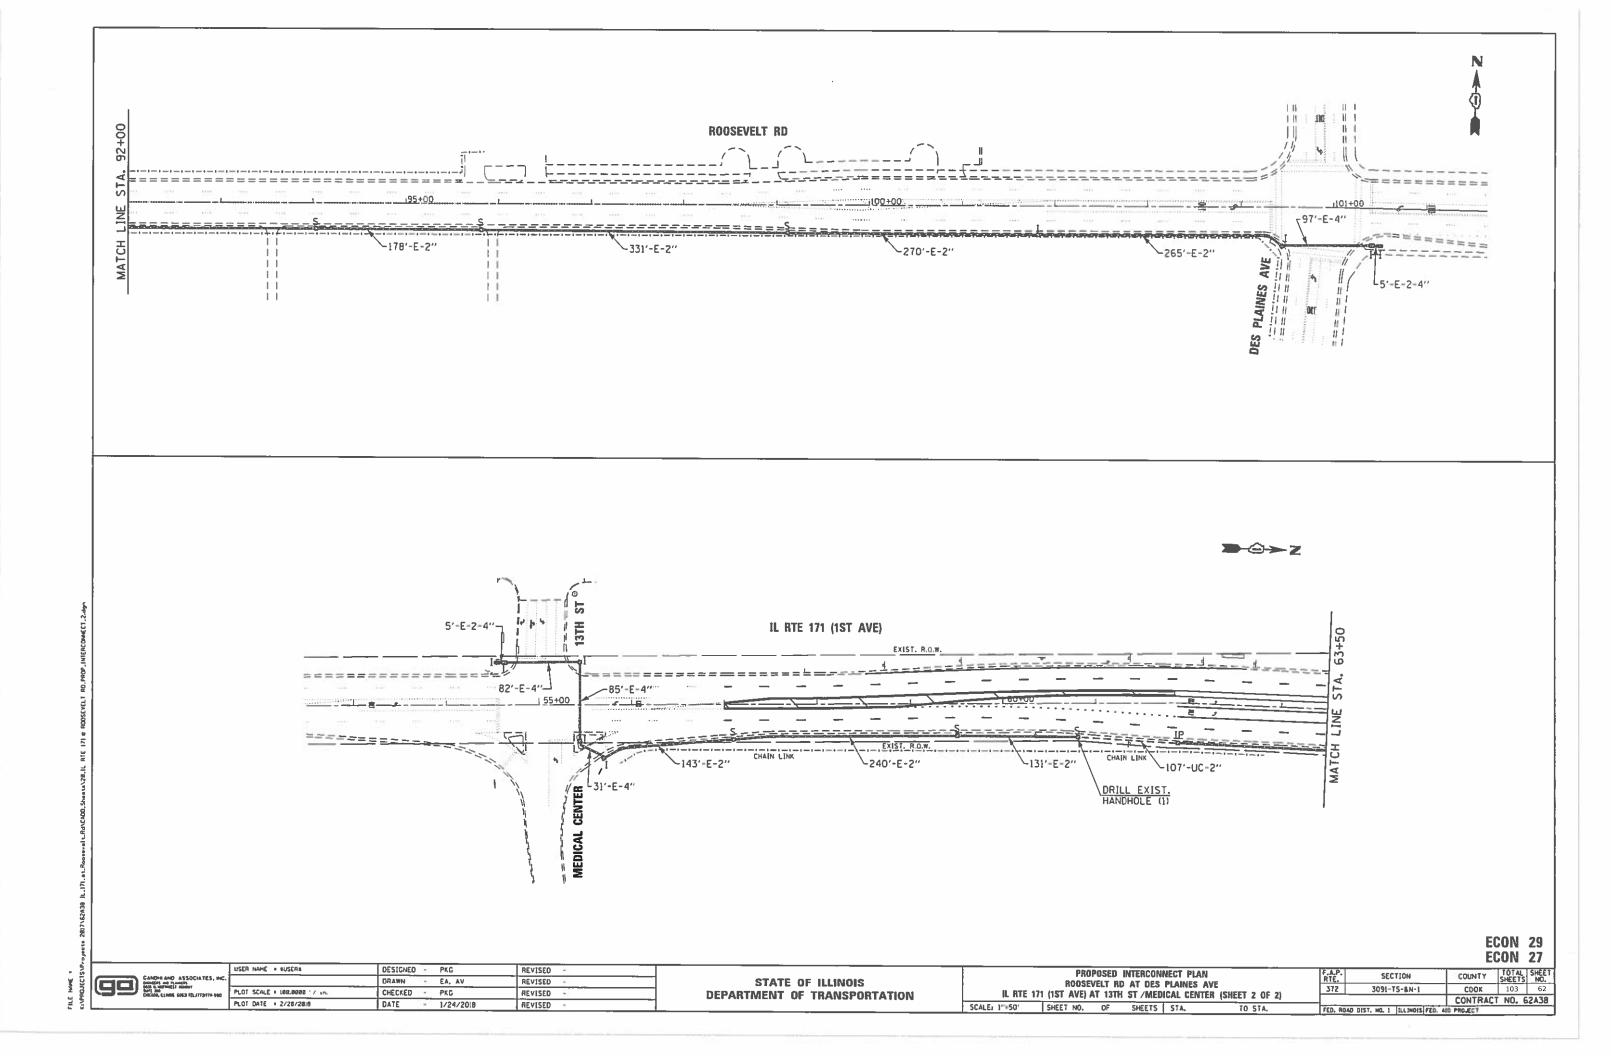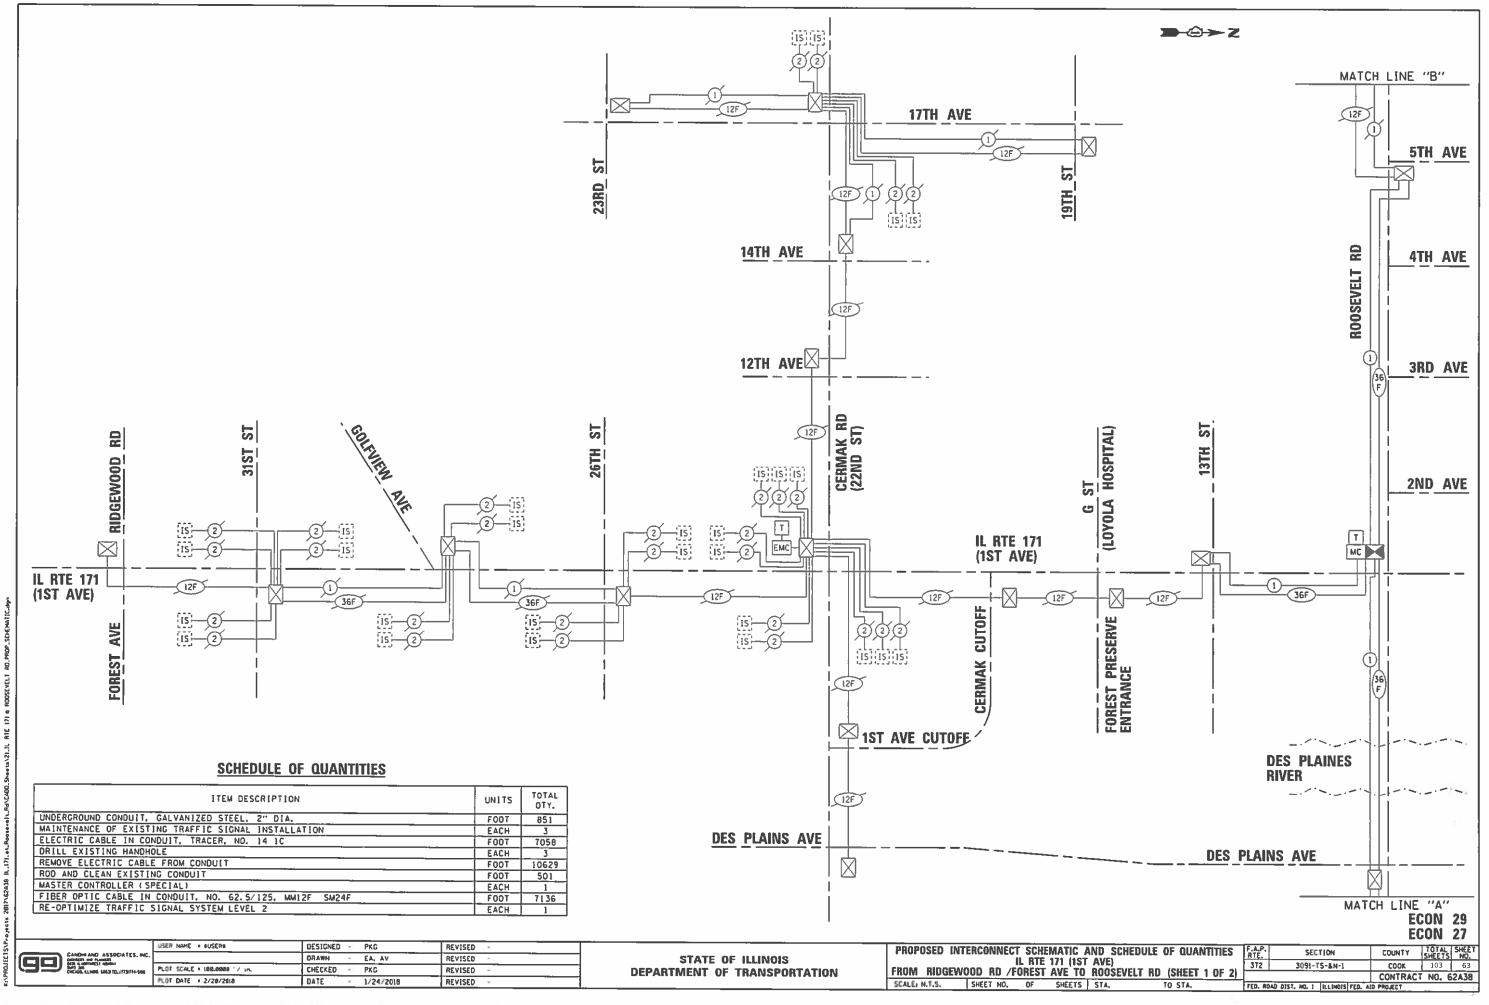
SCHEDULE OF QUANTITIES

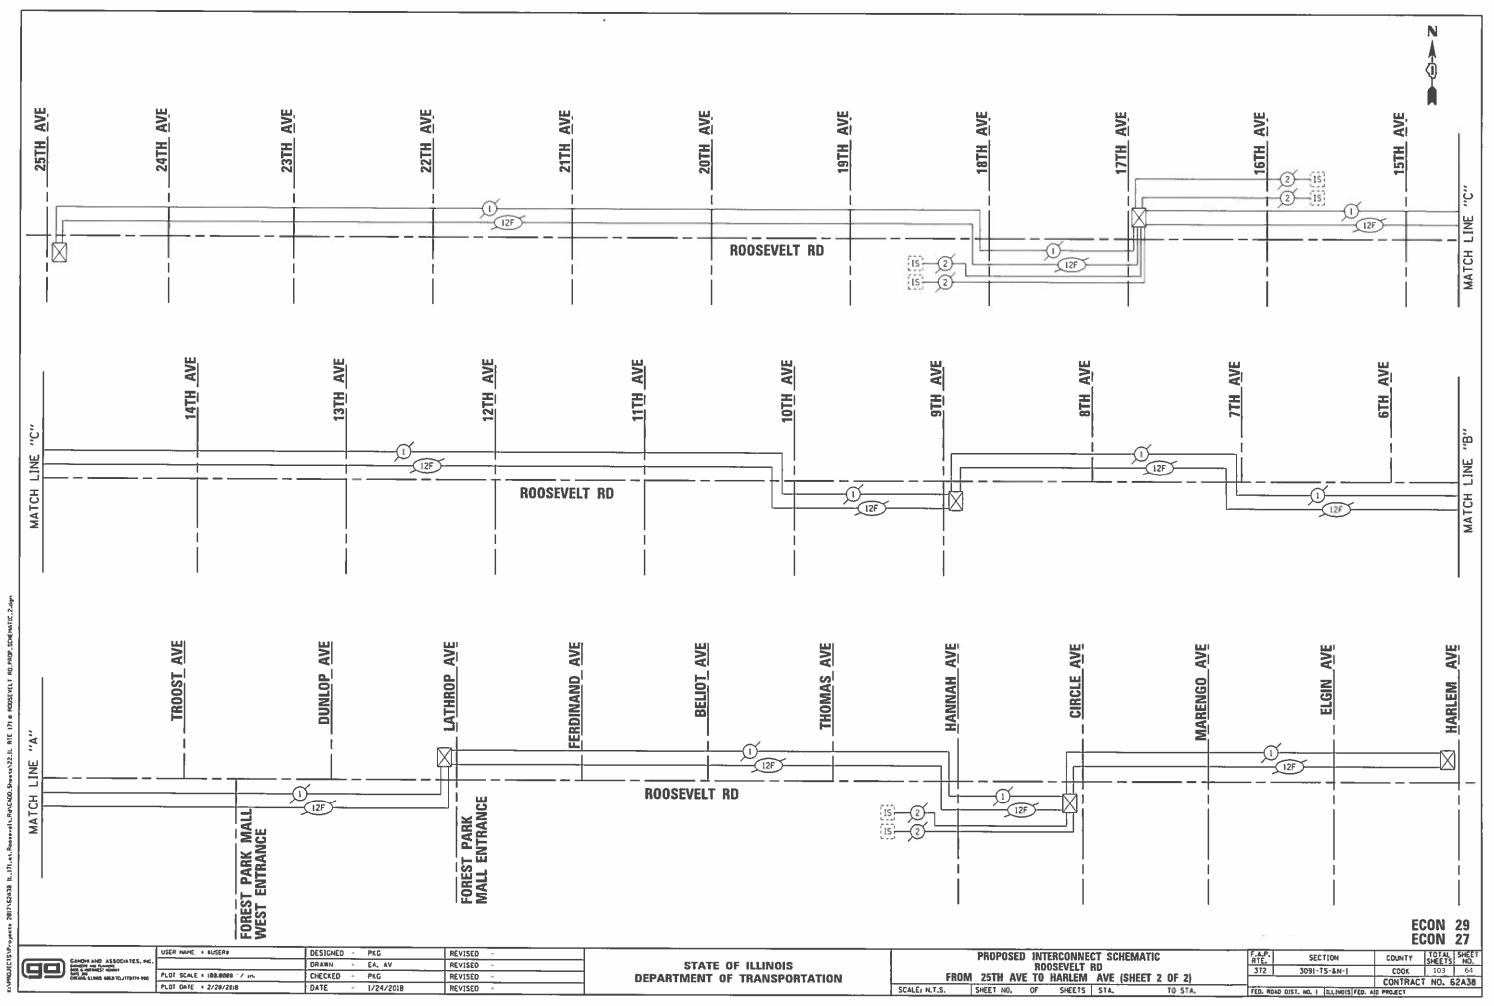
















= JAME =

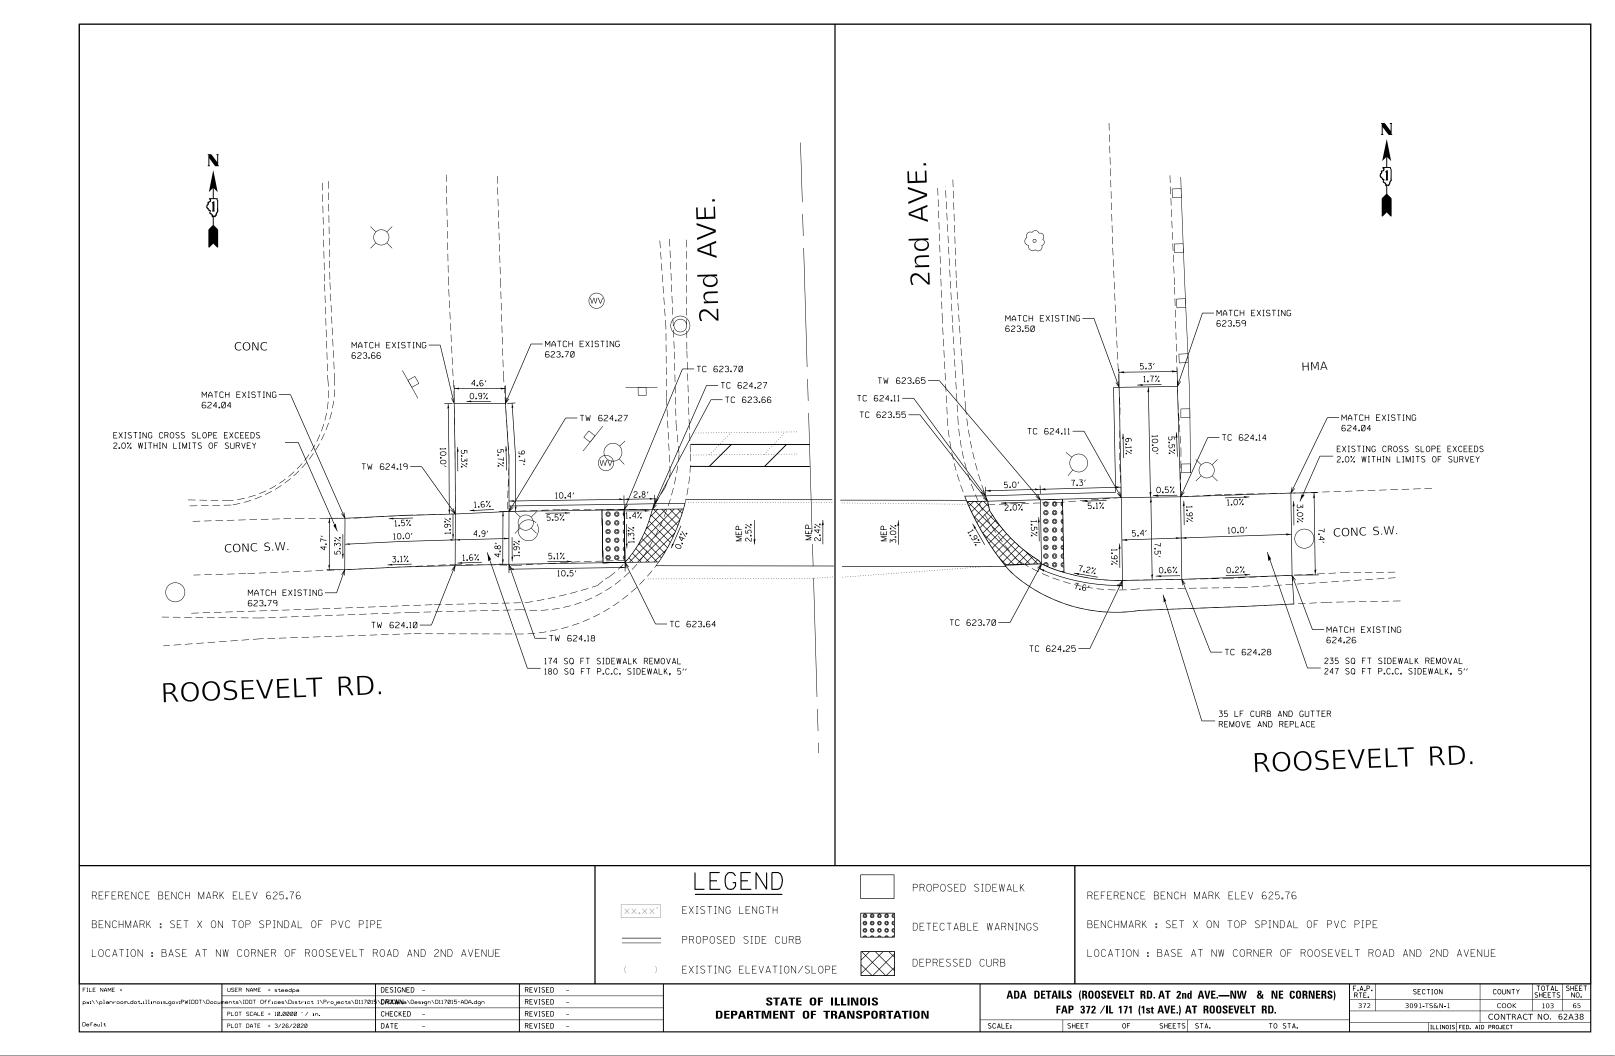

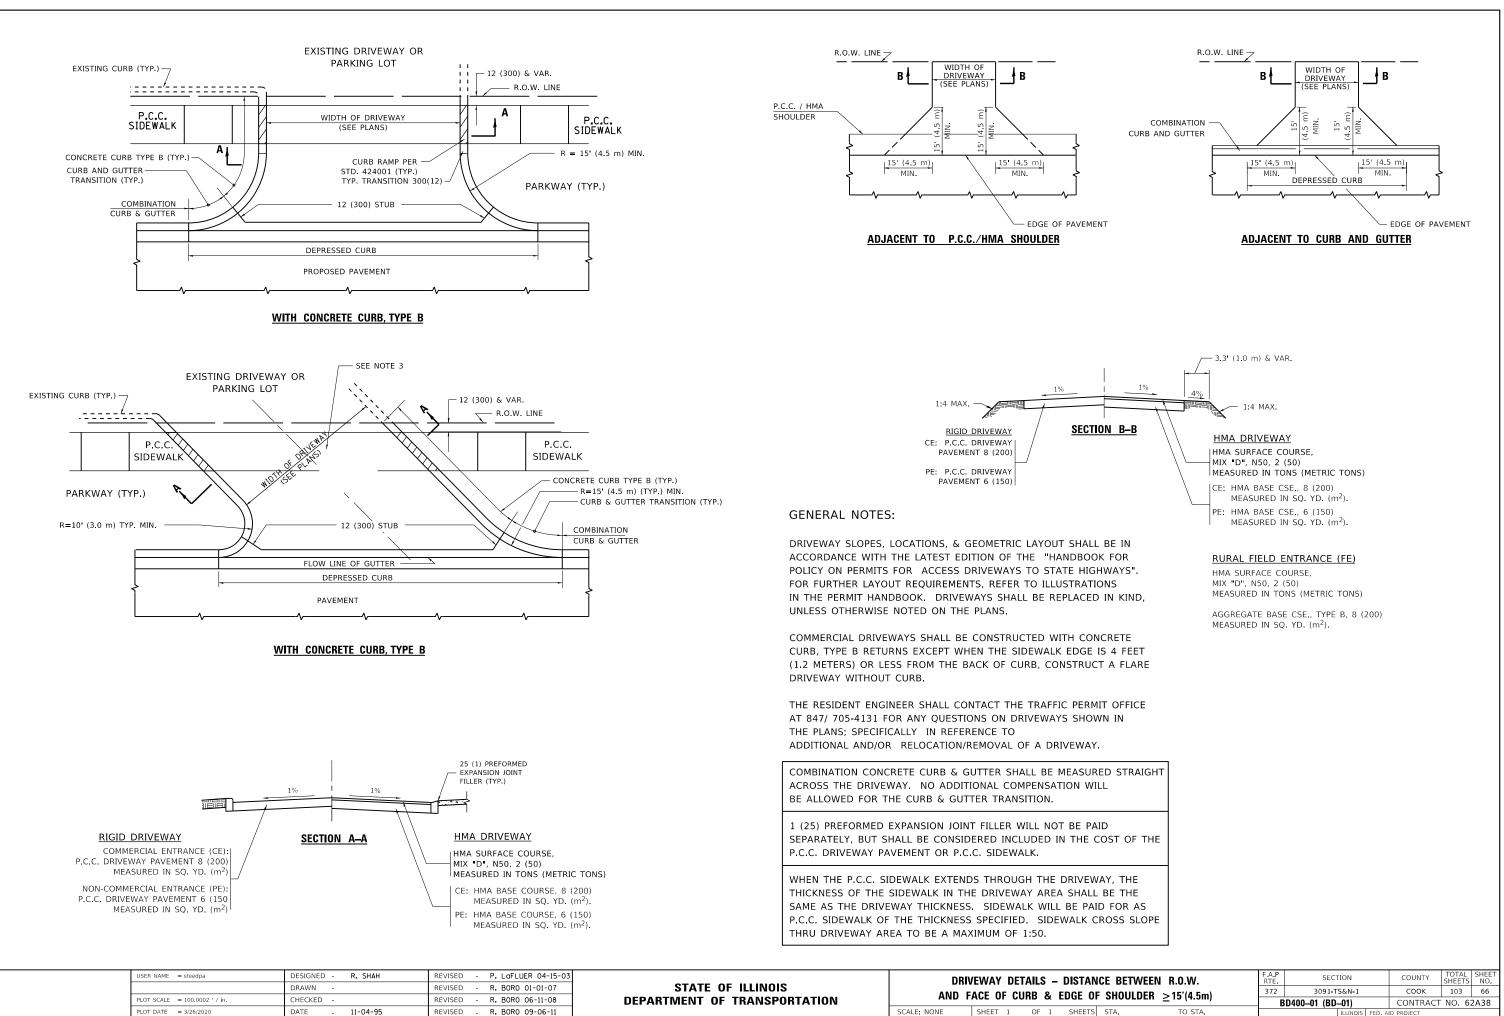

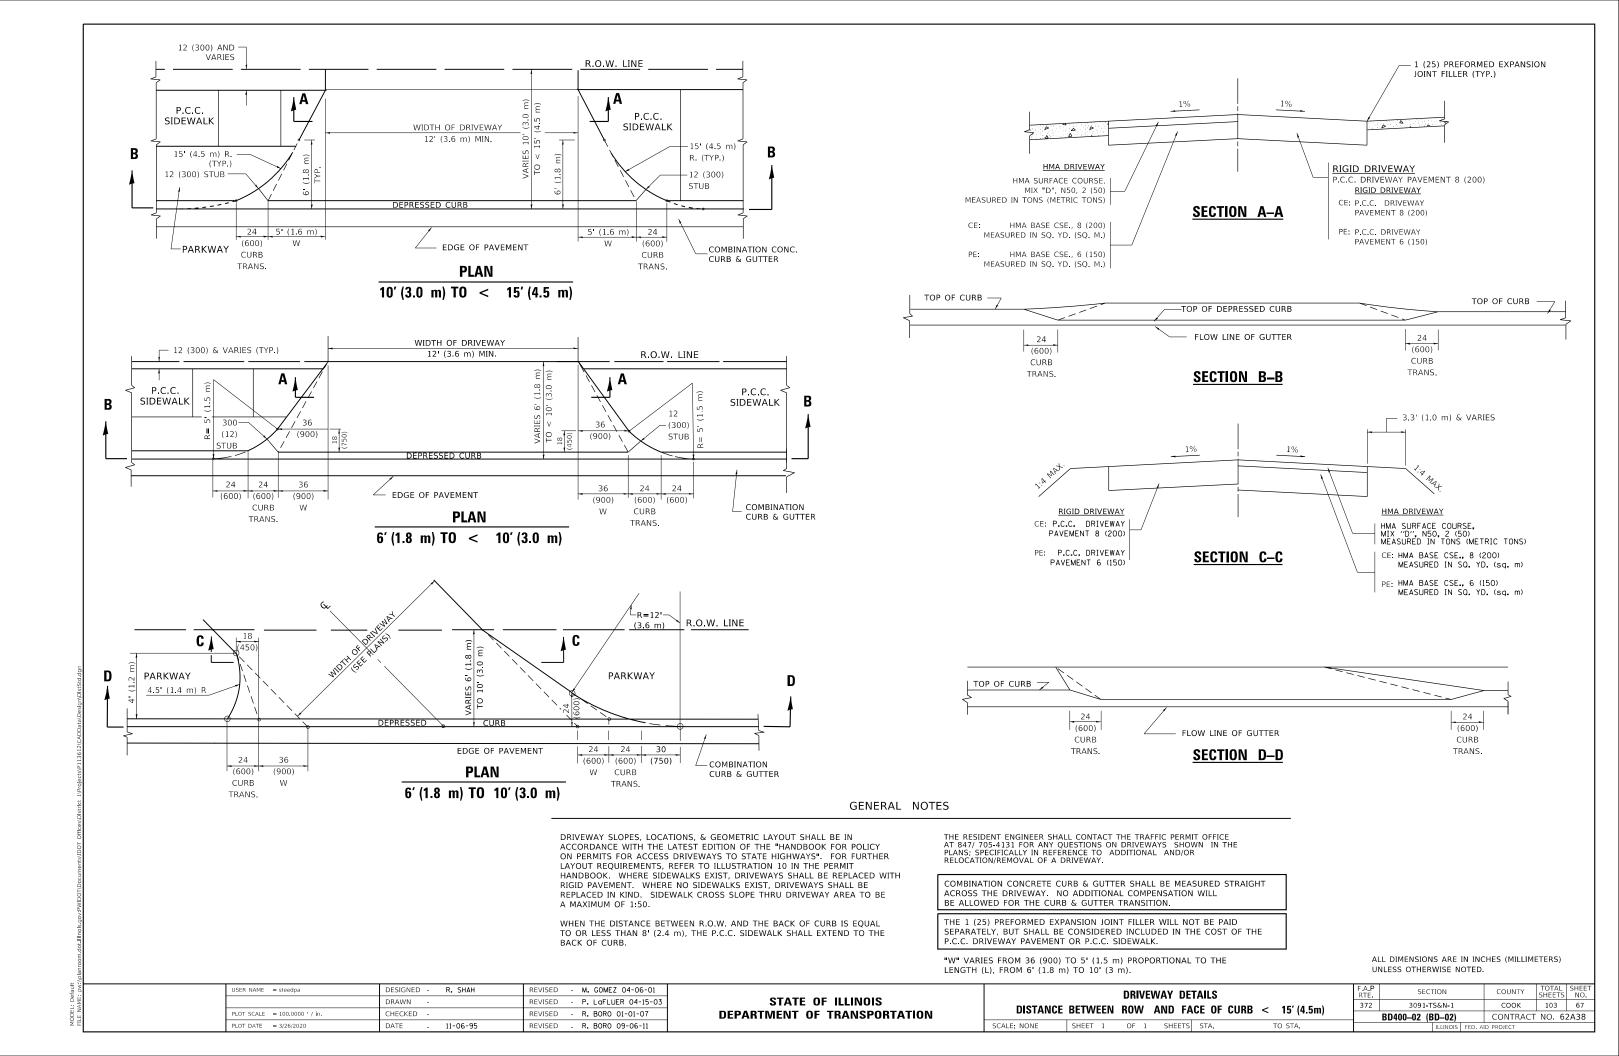

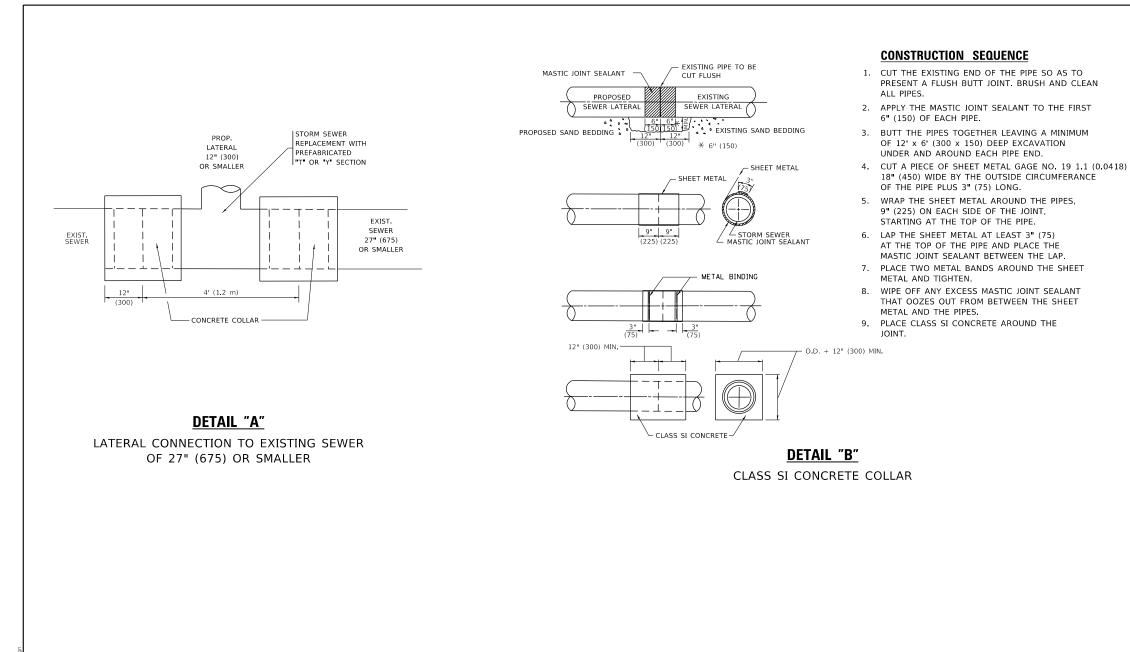

MATERIAL

MATERIAL USED FOR THE TEE OR WYE SECTION SHALL BE COMPATIBLE WITH THE EXISTING STORM SEWER OR THE PROPOSED STORM SEWER.

CONSTRUCTION METHODS

- I. THIS WORK SHALL BE CONSTRUCTED IN CONFORMANCE WITH THE APPLICABLE PORTIONS OF SECTION 550 OF THE STANDARD SPECIFICATIONS.
- II. CONNECTION TO AN EXISTING STORM SEWER SHALL BE BY EITHER OF THE FOLLOWING METHODS: A) PROPOSED STORM SEWER CONNECTION TO EXISTING SEWER OF 27" (675) OR SMALLER SEE DETAIL "A" AND "B"
 - B) PROPOSED STORM SEWER CONNECTION TO EXISTING SEWER OF 30" (750) OR LARGER SEE DETAIL "C".

IF THE EXISTING SEWER PIPE IS CRACKED, BROKEN OR OTHERWISE DAMAGED BY THE CONTRACTOR IN MAKING THE CIRCULAR OPENING, THE CONTRACTOR SHALL REPLACE THAT SECTION OF PIPE WITH PIPE EQUAL AND SIMILAR IN ALL RESPECTS TO THE PIPE IN THE EXISTING SEWER, IN A CAREFUL WORKMANLIKE MANNER, WITHOUT EXTRA COMPENSATION.

GENERAL

CARE MUST BE TAKEN TO PREVENT DEBRIS FROM ENTERING THE SEWER. ALL DEBRIS WHICH ENTERS THE SEWER MUST BE REMOVED. THE SEWER MUST BE LEFT CLEAN AND UNOBSTRUCTED UPON COMPLETION OF THE CONTRACT.

NOTES:

CARE MUST BE TAKEN TO PREVENT ANY PART OF THE NEW PIPE CONNECTION FROM PROJECTING INTO THE EXISTING SEWER.

BASIS OF PAYMENT


UNIT PRICE BID FOR THE WORK.

TRENCH BACKFILL, EXCAVATION IN ROCK AND REMOVAL AND REPLACEMENT OF UNSUITABLE MATERIAL BELOW PLAN BEDDING GRADE WILL BE PAID FOR SEPARATELY

STORM SEWER.

USER NAME = steedpa	DESIGNED - M. DE YONG	REVISED M. DE YONG 5-8-92		1	DETA	IL OF STOI	ew ci
	DRAWN -	REVISED - R. SHAH 09-09-94	STATE OF ILLINOIS	1			
PLOT SCALE = 100.0000 ' / in.	CHECKED -	REVISED - R SHAH 10-25-94	DEPARTMENT OF TRANSPORTATION	1	CONNECT	ION TO EA	XISTIN
PLOT DATE = 3/26/2020	DATE - 07-25-90	REVISED R SHAH 06-12-96		SCALE: NONE	SHEET 1 O	DF 1 SHEE	ETS STA

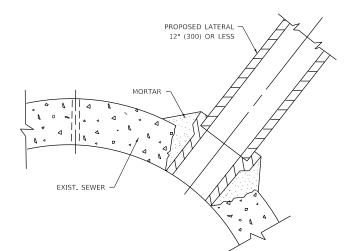***** ALL DIMENSIONS ARE IN INCHES (MILLIMETERS) UNLESS OTHERWISE SHOWN.




DETAIL "C" PROPOSED LATERAL CONNECTION TO EXISTING SEWER OF 30" (750) OR LARGER

TEE OR WYE CONNECTIONS SHALL BE PAID FOR AT THE CONTRACT UNIT PRICE EACH FOR STORM SEWER TEE OR WYE OF THE TYPE AND SIZE SPECIFIED IN THE PLANS, THIS PRICE SHALL INCLUDE ALL EXCAVATION OF THE TRENCH, REMOVAL OF THE EXISTING STORM SEWER, FURNISHING AND INSTALLING THE SPECIFIED TEE OR WYE SECTION, FURNISHING AND INSTALLING THE REQUIRED CONCRETE COLLAR, AND ALL OTHER MATERIAL NECESSARY TO COMPLETE THIS WORK AS SHOWN AND SPECIFIED.

REMOVAL AND REINSTALLATION OF EXISTING STORM SEWER ADJACENT TO THE PROPOSED TEE OR WYE SECTION, FOR THE PURPOSE OF FACILITATING THE INSTALLATION OF THE TEE OR WYE SECTION, WILL NOT BE PAID FOR SEPARATELY BUT SHALL BE INCLUDED IN THE

CONCRETE COLLAR FOR CONNECTING A PROPOSED STORM SEWER TO AN EXISTING STORM SEWER WILL NOT BE PAID PAID FOR SEPARATELY BUT SHALL BE INCLUDED IN THE COST OF THE PROPOSED

M SEWER STING SEWER		F.A. P RTE	SECTION			COUNTY	TOTAL SHEETS	SHEET NO.	
		372	3091-TS&N-1			соок	103	68	
STING SLWEN				BD500-01 (I	3D7)		CONTRACT	NO. 6	2A38
S	STA.	TO STA.		·	ILLINOIS	FED. A	ID PROJECT		

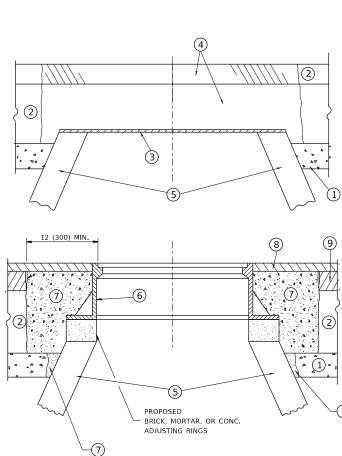

NOTES

EXISTING BROKEN FRAMES AND LIDS SHALL BE REMOVED AND DISPOSED OF BY THE CONTRACTOR AND SHALL BE REPLACED AS DIRECTED BY THE ENGINEER. REPLACEMENT FRAMES AND LIDS WILL BE PAID FOR IN ACCORDANCE WITH ARTICLE 109.04 OF THE STANDARD SPECIFICATIONS UNLESS A SEPARATE PAY ITEM HAS BEEN PROVIDED.

IF THE EXISTING LIDS ARE OPEN, THE FRAME WILL BE ADJUSTED TO THE ELEVATION OF THE MILLED PAVEMENT SURFACE PRIOR TO THE MILLING OPERATION. THE FRAME WILL NOT BE REMOVED AND COVERED BY THE METAL PLATE.

CITY OF CHICAGO CASTINGS ARE THE PROPERTY OF THE CITY AND THE CONTRACTOR SHALL NOTIFY THE CITY FOR REMOVAL AND DISPOSITION OF THE CASTINGS.

THE METAL PLATE USED TO COVER THE STRUCTURE SHALL REMAIN THE PROPERTY OF THE CONTRACTOR.

WHEN STRUCTURES ARE TO BE ADJUSTED OR RECONSTRUCTED. THE LOWERING AND RAISING OF THE FRAMES AND LIDS WILL NOT BE PAID FOR SEPARATELY BUT WILL BE INCLUDED IN THE COST OF THE CORRESPONDING PAY ITEM.

DETAILS FOR FRAMES AND LIDS ADJUSTMENT WITH MILLING

USER NAME = steedpa DESIGNED - R. SHAH	REVISED - R. WEDEMAN 05-14-04		DETAILS FOR	F.A.P SECTION	COUNTY TOTAL SHEET	ET
DRAWN -	REVISED - R. BORO 01-01-07	STATE OF ILLINOIS		372 3091-TS&N-1	СООК 103 69	<i>;</i>
PLOT SCALE = 100.0000 ' / in. CHECKED -	REVISED - R. BORO 03-09-11	DEPARTMENT OF TRANSPORTATION	FRAMES AND LIDS ADJUSTMENT WITH MILLING	BD600-03 (BD-8)	CONTRACT NO. 62A38	3
PLOT DATE = 3/26/2020 DATE - 10-25-94	REVISED - R. BORO 12-06-11	SC	SCALE: NONE SHEET 1 OF 1 SHEETS STA. TO STA.	ILLINOIS FEI	D. AID PROJECT	_

CONSTRUCTION PROCEDURES

STAGE 1 (BEFORE PAVEMENT MILLING)

- A) REMOVE A MINIMUM OF 12 (300) OF THE PAVEMENT FROM AROUND THE STRUCTURE.
- B) REMOVE THE EXISTING FRAME AND LID FROM THE STRUCTURE.
- C) COVER THE STRUCTURE OPENING WITH A 36 (900) DIAMETER METAL PLATE.
- D) BACKFILL WITH CRUSHED STONE AND A MINIMUM 1½ (40) THICK HMA SURFACE MIX APPROVED BY THE ENGINEER.

STAGE 2 (AFTER PAVEMENT MILLING)

- A) REMOVE THE HMA SURFACE MIX AND CRUSHED STONE.
- B) INSTALL THE FRAME AND LID; ADJUST THE FRAME TO ITS FINAL SURFACE ELEVATION.
- C) THE SURROUNDING SPACE SHALL BE FILLED WITH CLASS PP-1 * CONCRETE TO THE ELEVATION OF THE SURFACE OF THE EXISTING BASE COURSE OR THE BINDER COURSE.
- * UNLESS OTHERWISE SPECIFIED IN THE PLANS.

THE PROCEDURE EXPLAINED ABOVE SHALL CONFORM TO THE APPLICABLE PORTIONS OF SECTIONS 353, 406. 602, AND 603 OF THE STANDARD SPECIFICATIONS EXCEPT THAT THE CONTRACTOR SHALL ADJUST THE STRUCTURES TO THE FINISHED PAVEMENT ELEVATION NO MORE THAN 5 CALENDAR DAYS PRIOR TO PLACEMENT OF THE FINAL LIFT OF SURFACE UNLESS APPROVED BY THE ENGINEER.

LEGEND

1)	SUB-BASE GRANULAR MATERIAL	6 FRAME AND LID (SEE NOTES)
2)	EXISTING PAVEMENT	CLASS PP-1 *CONCRETE
3)	36 (900) DIAMETER METAL PLATE	(8) PROPOSED HMA SURFACE COURSE
4)	PROPOSED CRUSHED STONE AND HMA SURFACE MIX	9
5)	EXISTING STRUCTURE	9 proposed HMA BINDER COURSE

LOCATION OF STRUCTURES

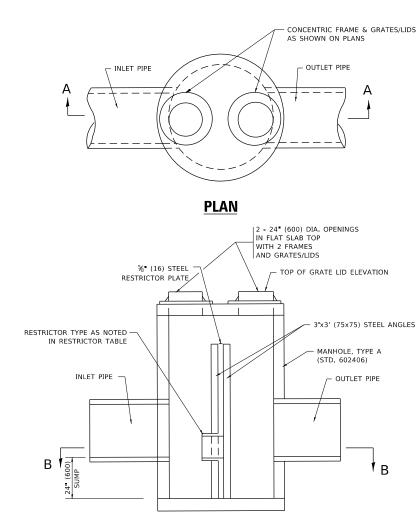
THE CONTRACTOR WILL BE REQUIRED TO KEEP A RECORD OF THE LOCATIONS OF THE BURIED STRUCTURES ACCORDING TO THE STATION AND DISTANCE LEFT OR RIGHT OF THE CENTERLINE OF PAVEMENT. UPON COMPLETION OF THE WORK, THE CONTRACTOR WILL DELIVER THE RECORD TO THE ENGINEER.

BASIS OF PAYMENT

REMOVING FRAMES AND LIDS ON DRAINAGE AND UTILITY STRUCTURES IN THE PAVEMENT PRIOR TO MILLING, AND ADJUSTING TO FINAL GRADE PRIOR TO PLACING THE SURFACE COURSE, WILL BE PAID FOR AT THE CONTRACT UNIT PRICE EACH FOR "FRAMES AND LIDS TO BE ADJUSTED (SPECIAL).

THIS WORK WILL NOT BE PAID FOR WHEN DRAINAGE AND UTILITY STRUCTURES ARE SPECIFIED FOR PAYMENT AS STRUCTURE RECONSTRUCTION. NEW FRAMES AND LIDS, WHEN SPECIFIED, WILL BE PAID FOR SEPARATELY.

ALL DIMENSIONS ARE IN INCHES (MILLIMETERS) UNLESS OTHERWISE SHOWN




SECTION A-A


MANHOLE DIAMETER	FRAME AND GRATE	RESTRICTOR TYPE	INSIDE RESTRICTOR TYPE DIAMETER in. (mm) (d)	INVERT OF RESTRICTOR TYPE	ELEVATION OF TOP OF PLA OVERFLOW
-				DIAMETER GRATE TYPE DIAMETER in. (mm)	DIAMETER GRATE TYPE DIAMETER RESTRICTOR DIAMETER TYPE in. (mm)

- 3'x3' (75x75) STEEL ANGLES г~ С - OUTLET PIPE INLET PIPE d 1.111 └**→** C

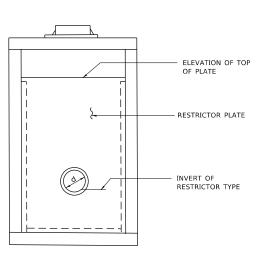
SECTION B-B



SECTION C-C

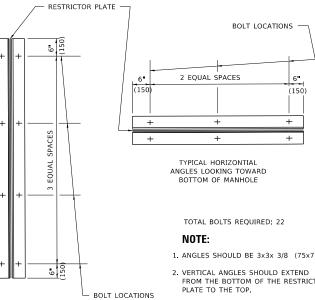

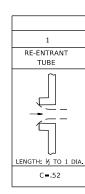TYPICAL VERTICAL ANGLES LOOKING TOWARD MANHOLE WALL



TOTAL BOLTS REQUIRED: 22

1. ANGLES SHOULD BE 3x3x 3/8 (75x75x75)

6"


(150)

+

FROM THE BOTTOM OF THE RESTRICTOR PLATE TO THE TOP.

3. HORIZONTIAL ANGLES SHOULD EXTEND FROM VERTICAL ANGLE TO VERTICAL ANGLE.

STEEL ANGLE BOLTING DETAILS									INCHES (MILLIMETE	RS) UNLESS
	USER NAME = steedpa	DESIGNED - R SHAH	REVISED - R. SHAH 10-25-94			MANHOLE WITH	F.A.P BTE	SECTION	COUNT	Y TOTAL SHEET
		DRAWN -	REVISED - E. GOMEZ 08-28-00	STATE OF ILLINOIS			372		соок	103 70
	PLOT SCALE = 100.0000 ' / in.	E = 100.0000 / In. CHECKED - REVISED - M. GOMEZ 01-08-01 DEPARTMENT OF TRANSPORTATION		RESTRICTOR PLATE		BD600-04 (BD-		ACT NO. 62A38		
	PLOT DATE = 3/26/2020	DATE - 09-09-94	REVISED -	SCALE: N	SCALE: NONE	SHEET 1 OF 1 SHEETS STA. TO STA.		ILLINO:	IS FED. AID PROJECT	

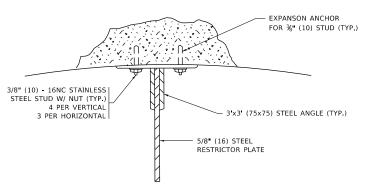


ANGLE FASTENER DETAIL

NOTES:

1. ALL STEEL ANGLES AND PLATES TO BE GALVANIZED AFTER FABRICATION.

2. ALL RESTRICTOR PLATES, ANGLES AND HARDWARE TO BE INCLUDED IN THE COST OF THE MANHOLE.

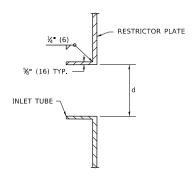
3. BASIS OF PAYMENT: MANHOLES, TYPE A, 6 FT. (1.8 m) DIAMETER, TYPE 1 FRAME, CLOSED LID, RESTRICTOR PLATE" EACH





	RESTRICTOR TYPE										
	2	3	4	5	6						
	SHARP EDGED	SQUARE EDGED	RE-ENTRANT TUBE	SQUARE EDGED	ROUNDED						
ι.		STREAM CLEARS SIDES	LENGTH: 2-½ DIA.								
	C=.61	C = .61	C = .73	C = .82	C=.98						

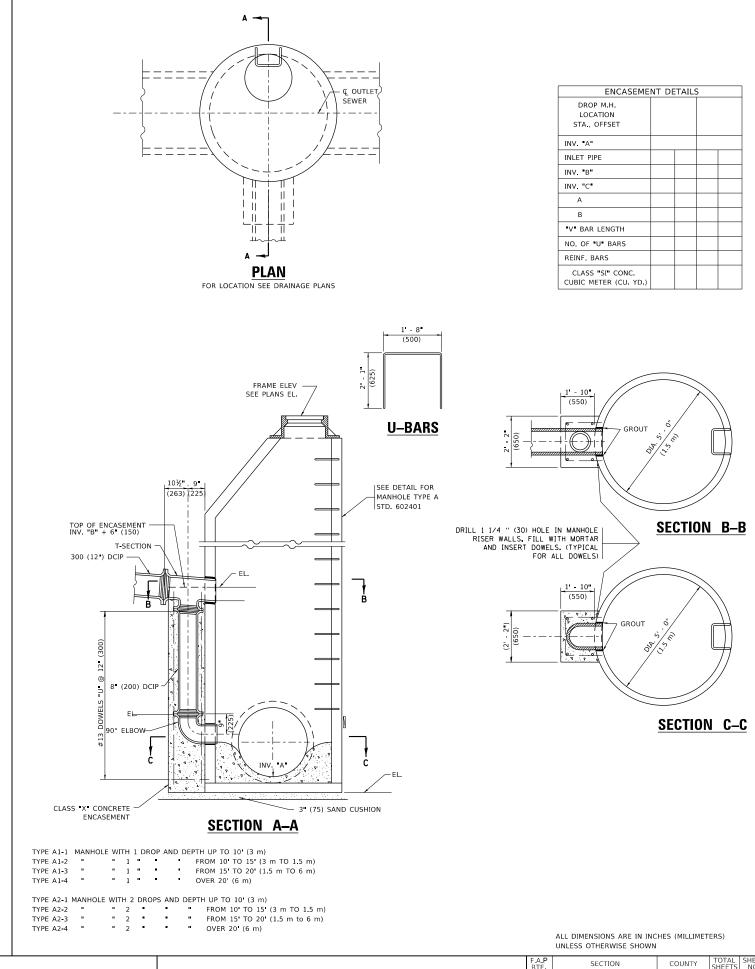
VALUES OF "C" FOR CIRCULAR AND SQUARE ORIFICES



USER NAME = steedpa	DESIGNED -	REVISED -						SECTION	COUNTY TOTAL SH	HEET
	DRAWN -	REVISED -	STATE OF ILLINOIS	DROP MANHOLE DETAILS			372 3	091-TS-&N-1	СООК 103 7	71
PLOT SCALE = 100.0000 ' / in.	LE = 100.0000 ' / in. CHECKED - REVISED -		DEPARTMENT OF TRANSPORTATION				BD600-05	(BD-16)	CONTRACT NO. 62A3	¥38
PLOT DATE = 3/26/2020	DATE - 10-18-02	REVISED -		SCALE: NONE	SHEET 1 OF 1 SHEETS STA.	TO STA.	ILLINOIS FED A		AID PROJECT	

ENCASEME	NT DE	TAIL	S	
DROP M.H. LOCATION STA., OFFSET				
INV. "A"				
INLET PIPE				
INV. B				
INV. C				
А				
В				
V BAR LENGTH				
NO. OF U BARS				
REINF. BARS				
CLASS "SI" CONC. CUBIC METER (CU. YD.)				

ALL DIMENSIONS ARE IN INCHES	(MILLIMETERS)
UNLESS OTHERWISE SHOWN	

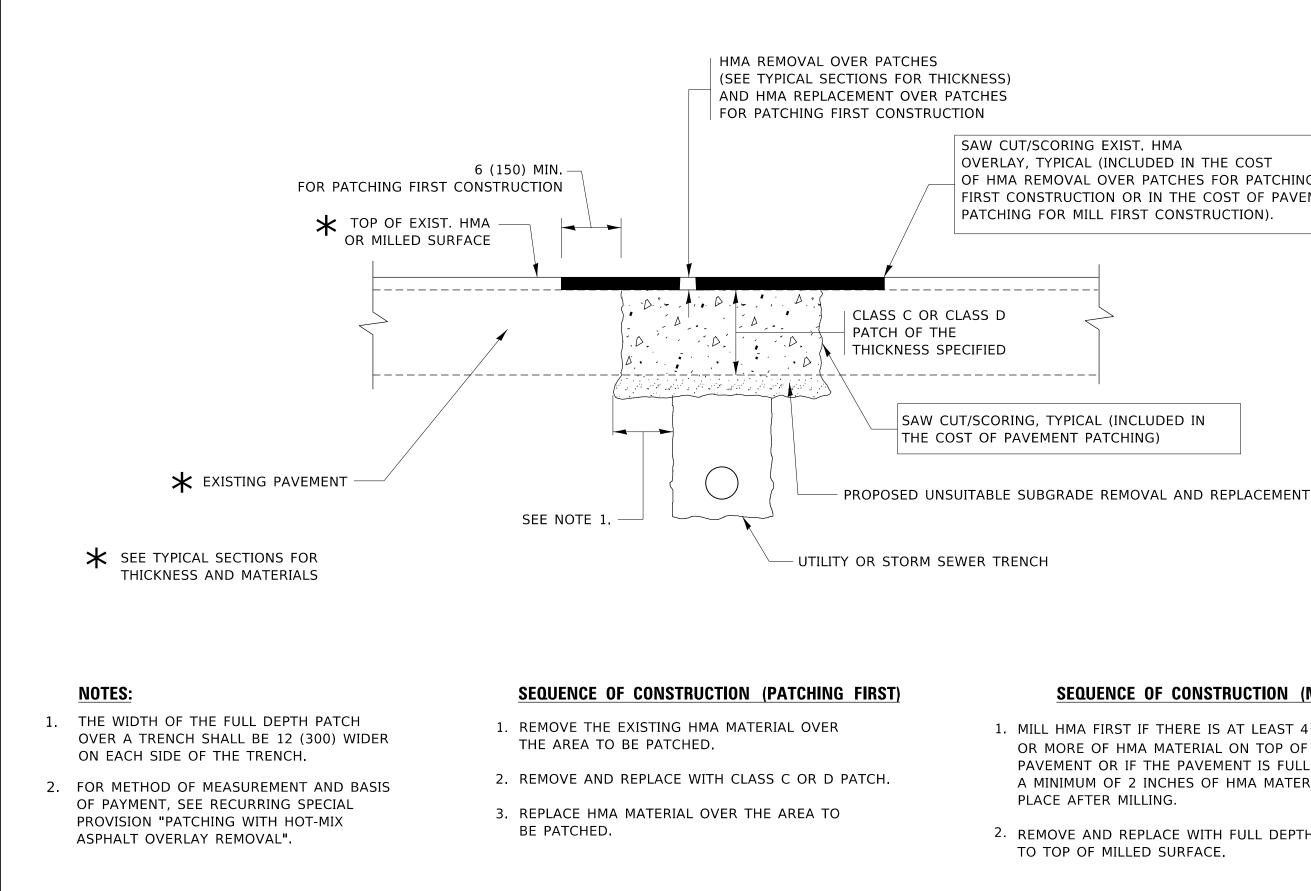

	USER NAME = steedpa	DESIGNED - R. SHAH	REVISED - A ABBAS 04-27-98	STATE OF ILLINOIS DEPARTMENT OF TRANSPORTATION	PAVEMENT PATCHING FOR			SECTION	COUNTY TOTAL SHEET SHEETS NO.
	PLOT SCALE = 100.0000 ' / in.	DRAWN - CHECKED -	REVISED - R. BORO 01-01-07 REVISED - R. BORO 09-04-07		HMA SURFACED PAVEMENT			BD400–04 (BD–22)	СООК 103 72 СОЛТRACT NO. 62А38
	PLOT DATE = 3/26/2020	DATE - 10-25-94	REVISED - K. ENG 10-27-08		SCALE: NONE SHEET 1	OF 1 SHEETS STA. TO STA.		ILLINOIS FED. A	ND PROJECT

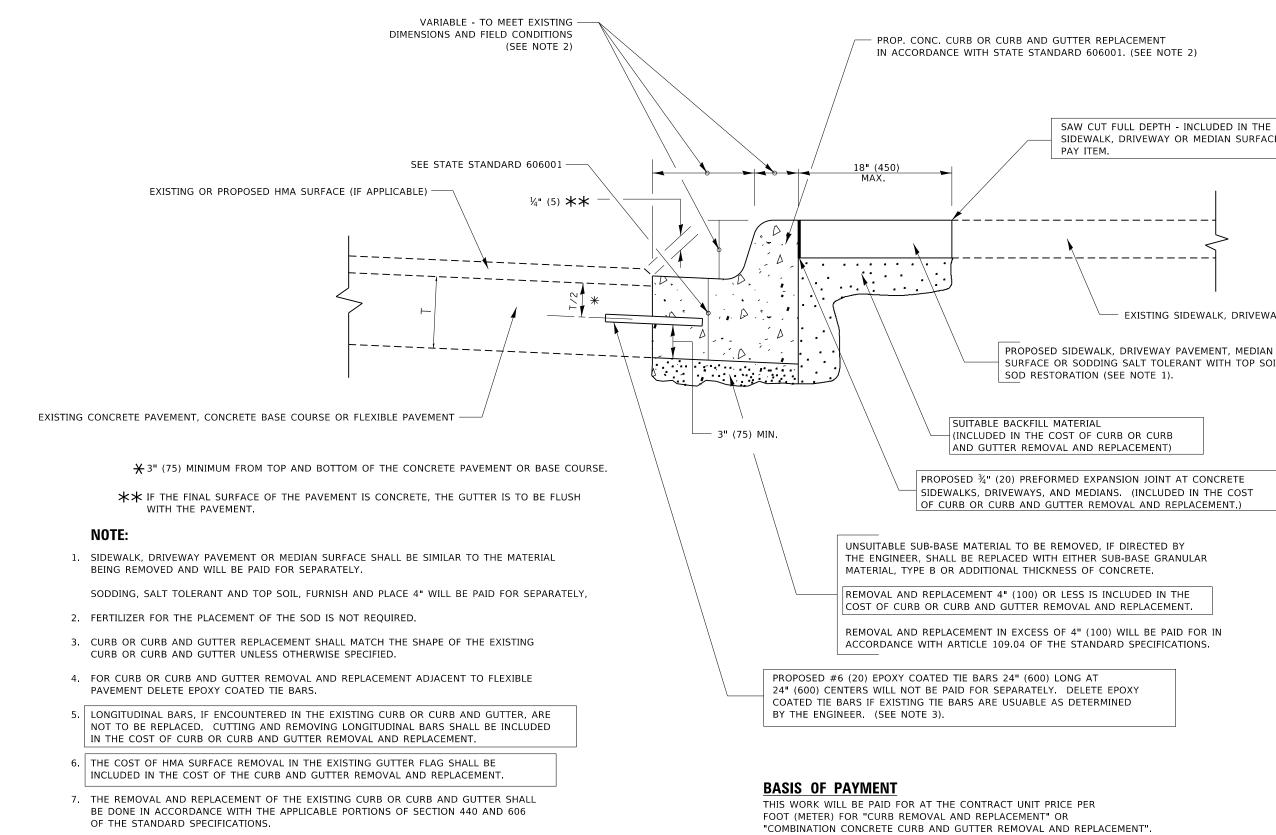
OVERLAY, TYPICAL (INCLUDED IN THE COST OF HMA REMOVAL OVER PATCHES FOR PATCHING FIRST CONSTRUCTION OR IN THE COST OF PAVEMENT PATCHING FOR MILL FIRST CONSTRUCTION).

SEQUENCE OF CONSTRUCTION (MILLING FIRST)

1. MILL HMA FIRST IF THERE IS AT LEAST $4\frac{1}{2}$ INCHES OR MORE OF HMA MATERIAL ON TOP OF THE EXISTING PAVEMENT OR IF THE PAVEMENT IS FULL DEPTH HMA. A MINIMUM OF 2 INCHES OF HMA MATERIAL SHALL BE IN

2. REMOVE AND REPLACE WITH FULL DEPTH CLASS D PATCHES TO TOP OF MILLED SURFACE.

> ALL DIMENSIONS ARE IN INCHES (MILLIMETERS) UNLESS OTHERWISE SHOWN.



8. THE LOCATIONS OF REMOVAL AND REPLACEMENT OF EXISTING CURB OR CURB AND GUTTER SHALL BE DETERMINED BY THE RESIDENT ENGINEER AT THE TIME OF CONSTRUCTION.

CURB OR CURB AND GUTTER REMOVAL AND REPLACEMENT

USER NAME = steedpa	DESIGNED A HOUSEH	REVISED - R SHAH 10-03-96			CURB OR CURB AND GUTTER	F.A.P SECTION	COUNTY TOTAL SHEET
	DRAWN -	REVISED A ABBAS 03-21-97	STATE OF ILLINOIS			372 3091-TS&N-1	СООК 103 73
PLOT SCALE = 100.0000 / in.	CHECKED -	REVISED - M. GOMEZ 01-22-01	DEPARTMENT OF TRANSPORTATION		REMOVAL AND REPLACEMENT	BD600–06 (BD–24)	CONTRACT NO. 62A38
PLOT DATE = 3/26/2020	DATE - 03-11-94	REVISED - R. BORO 12-15-09		SCALE: NONE	SHEET 1 OF 1 SHEETS STA. TO STA.	ILLINOIS FED.	AID PROJECT

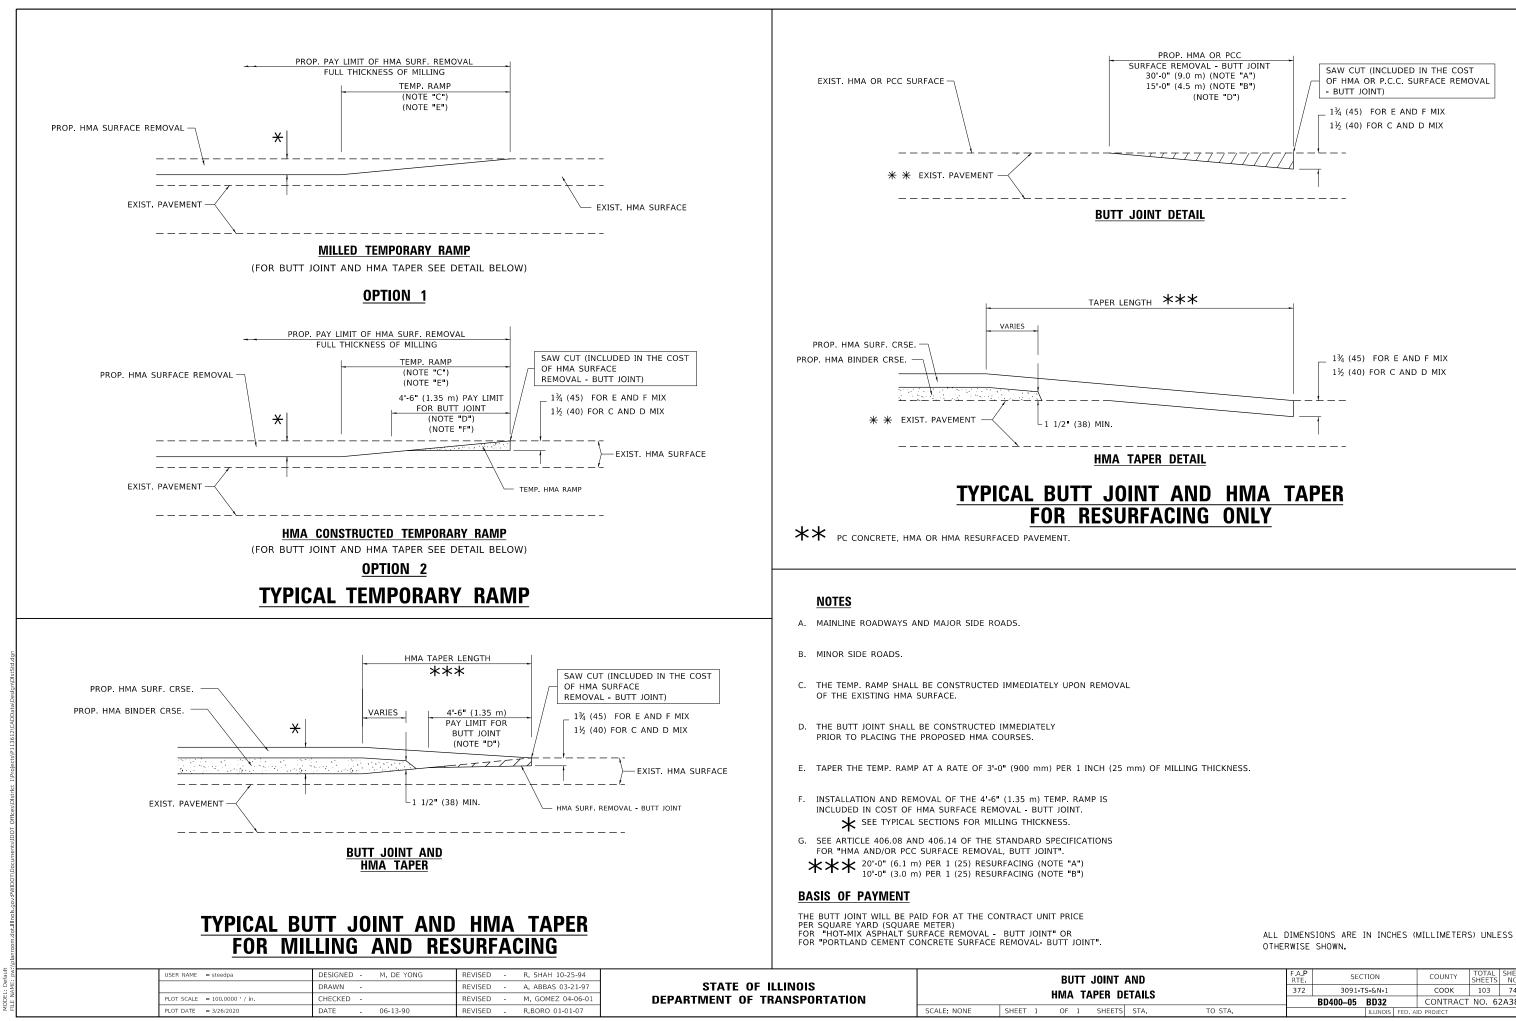
SAW CUT FULL DEPTH - INCLUDED IN THE COST OF SIDEWALK, DRIVEWAY OR MEDIAN SURFACE REMOVAL

EXISTING SIDEWALK, DRIVEWAY, MEDIAN SURFACE, SOD OR GROUND.


SURFACE OR SODDING SALT TOLERANT WITH TOP SOIL, 4" (100)




ALL DIMENSIONS ARE IN INCHES (MILLIMETERS) UNLESS OTHERWISE SHOWN.



AND	F.A.P RTE	F.A.P RTE SECTION			TOTAL SHEETS	SHEET NO.
DETAILS	372	3091 - TS	5-&N-1	СООК	103	74
		BD400-05	BD32	CONTRACT	NO. 6	2A38
TS STA. TO STA.			ILLINOIS FED.	AID PROJECT		

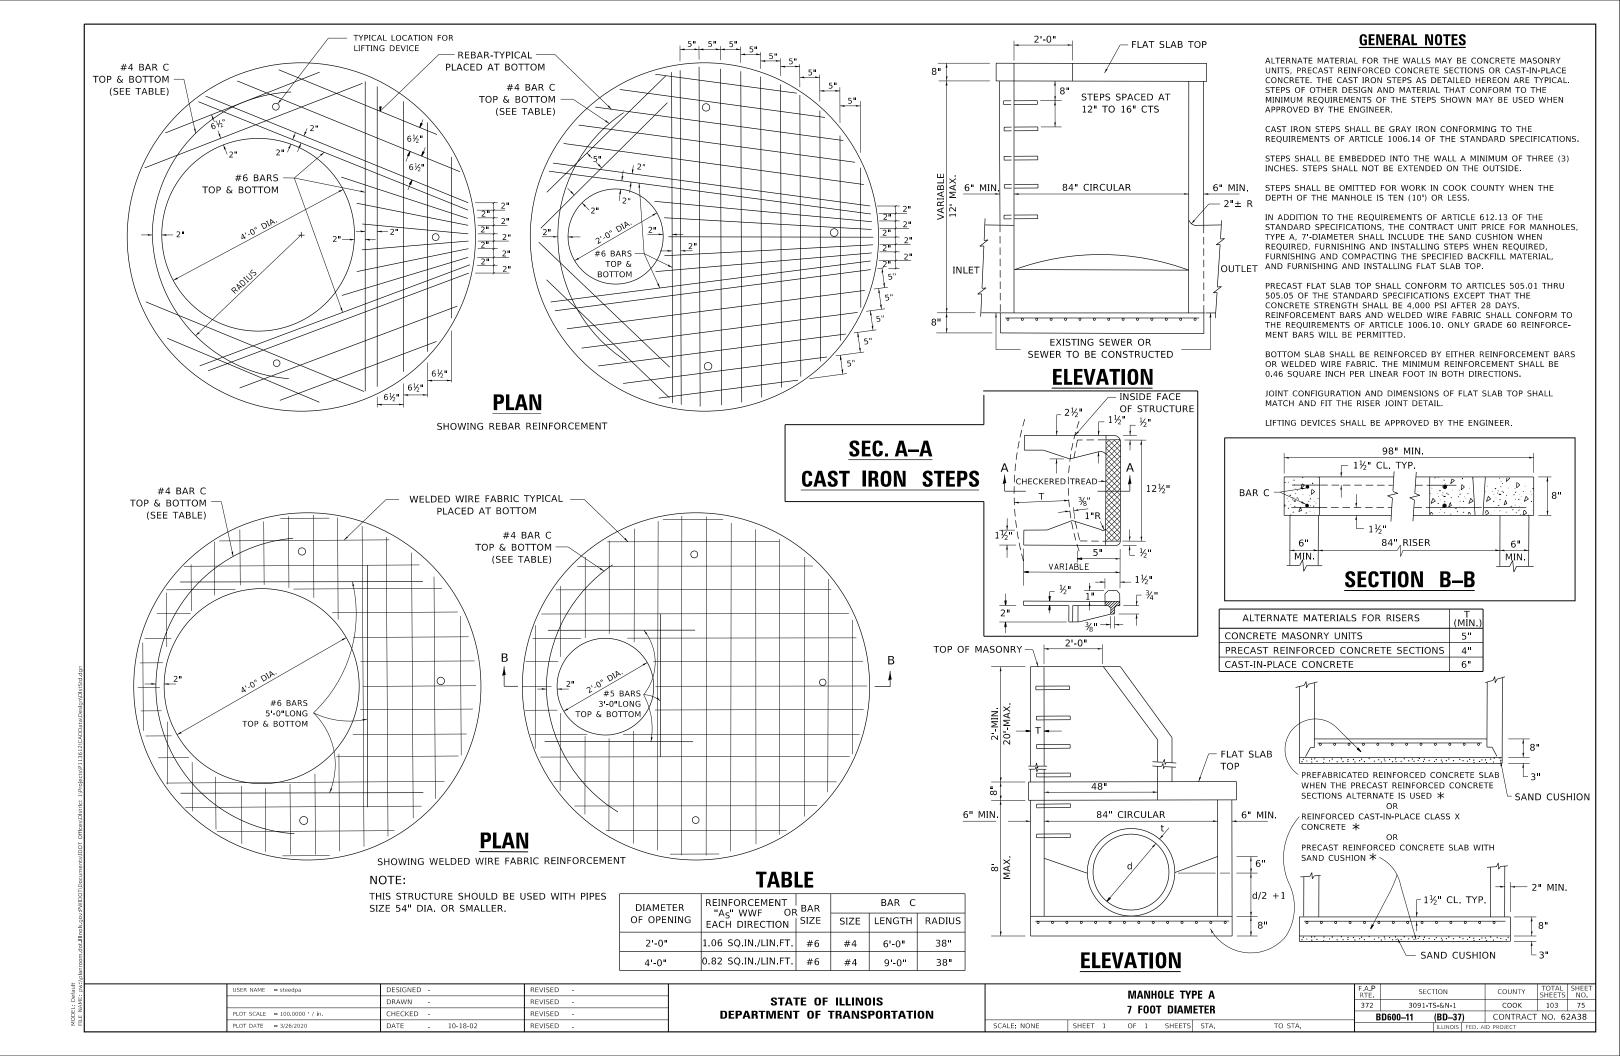

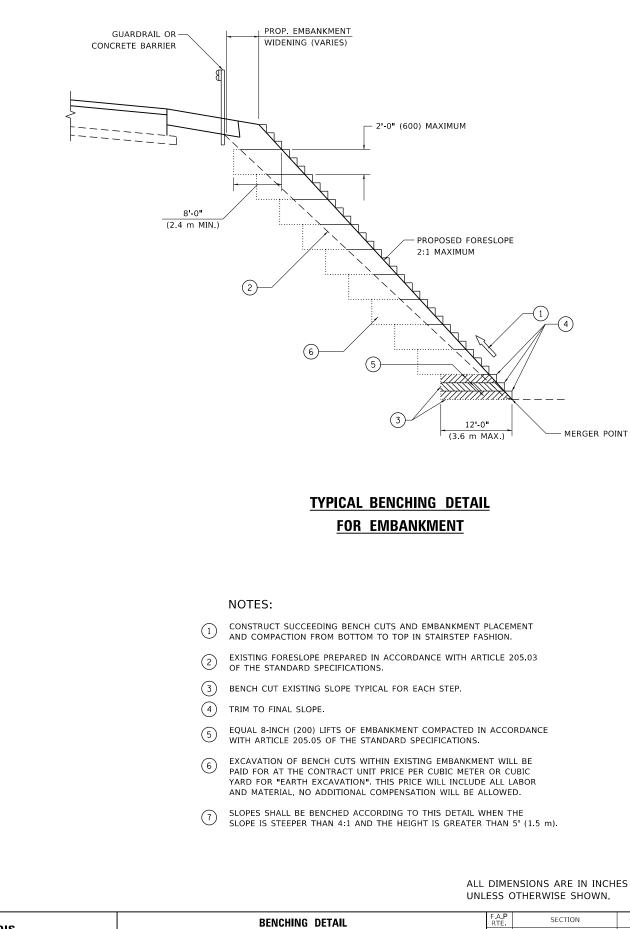


USER NAME = steedpa	DESIGNED -	REVISED -					BENCI	ны
	DRAWN - CADD	REVISED -	STATE OF II	LLINOIS	i i i i i i i i i i i i i i i i i i i			
PLOT SCALE = 100.0000 ' / in.	CHECKED S.E.B.	REVISED -	DEPARTMENT OF TR	ANSPORTATION	i i i i i i i i i i i i i i i i i i i	FUK	EMBAN	IKIV
PLOT DATE = 3/26/2020	DATE - 06-16-04	REVISED -			SCALE: NONE	SHEET 1	OF 1	SI

ALL DIMENSIONS ARE IN INCHES (MILLIMETERS)

HING DETAIL	F A.P SECTION		COUNTY	TOTAL SHEETS	SHEET NO.		
KMENT WIDENING	372	3091 - T	соок	103	76		
		BD51			CONTRACT	NO. 6	2A38
SHEETS STA. TO STA.			ILLINOIS	FED. A	ID PROJECT		

	- 0 = 113 mg	
	15 (380) 21 (530)	
		E STILLER STATES
		WORK AREA I
		* COLLECTOR * COLLECTOR SPEED LIMIT> 40 MPH (60 km/h)
		(+)
	NOTES:	
		IMIT OF 40 MPH (60 km/h) OR LESS AS AND AS DIRECTED BY THE ENGINEER:
	b) THE CLOSED PORTION C	TION AHEAD" SIGN 36 x 36 (900x900) WITH A FLA XIMATELY 200' (60 m) IN ADVANCE OF THE MAIN DF THE MAIN ROUTE SHALL BE PROTECTED BY
	THE CROSS SECTION OF	TYPE II OR TYPE III BARRICADES, 1/3 OF - THE CLOSED PORTION. JMIT GREATER THAN 40 MPH (60 km/h)
	AS SHOWN ON THE DRAWIN a) ONE "ROAD CONSTRUCT	IG AND AS DIRECTED BY THE ENGINEER: TION AHEAD" SIGN 48 x 48 (1.2 m x 1.2 m) WITH IT APPROXIMATELY 500' (150 m) IN ADVANCE
	OF THE MAIN ROUTE. THE CLOSED PORTION C	DF THE MAIN ROUTE SHALL BE PROTECTED BY I BARRICADES, 1/2 OF THE CROSS SECTION
	OF THE CLOSED PORTIO	
	WHEN THE SIDE ROAD LIES 4. SIGNING AND THE WORK ZO	BETWEEN THE BEGINNING OF THE MAINLINE DNE, A SINGLE HEADED ARROW (M6-1) SHALL DUBLE HEADED ARROW (M6-4).
STATE OF		TRAFFIC CONTROL AND PF SIDE ROADS, INTERSECTIONS,

USER NAME = steedpa	DESIGNED L.H.A.	REVISED - A. HOUSEH 10-15-96			TRAFFIC CONTROL AND PROTECTION FOR	F.A.P RTE	SECTION	COUNTY TO	JTAL SHEET IEETS NO.
	DRAWN -	REVISED - T. RAMMACHER 01-06-00	STATE OF ILLINOIS		SIDE ROADS, INTERSECTIONS, AND DRIVEWAYS	372	3091-TS&N-1	СООК 10	103 77
PLOT SCALE = 100.0000 / in	CHECKED -	REVISED - A. SCHUETZE 07-01-13	DEPARTMENT OF TRANSPORTATION	`	SIDE NUADS, INTERSECTIONS, AND DRIVEWATS		TC-10	CONTRACT NO	O. 62A38
PLOT DATE = 3/26/2020	DATE - 06-89	REVISED _ A. SCHUETZE 09-15-16		SCALE: NONE	SHEET 1 OF 1 SHEETS STA. TO STA.		ILLINOIS FED. A	ID PROJECT	

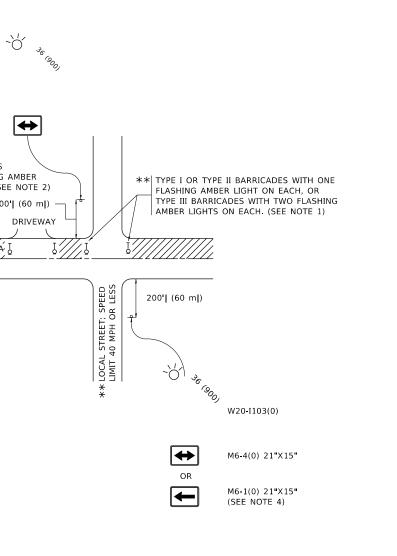


FLASHER IN ROUTE.

- 5. WHEN WORK IS BEING PERFORMED ON A SIDE ROAD OR DRIVEWAY, FOLLOW THE APPLICABLE STANDARD(S). THE DIRECTIONAL ARROW (M6-1 OR M6-4) SHALL BE COVERED OR REMOVED WHEN NO LONGER CONSISTENT WITH THE TRAFFIC CONTROL SET-UP.
- ADVANCE WARNING SIGNS ARE TO BE OMITTED ON DRIVEWAYS UNLESS OTHERWISE SPECIFIED IN THE PLANS OR BY THE ENGINEER.
- 7. THE TRAFFIC CONTROL AND PROTECTION FOR SIDE ROADS, INTERSECTIONS, AND DRIVEWAYS SHALL BE INCLUDED IN THE COST OF SPECIFIED TRAFFIC CONTROL STANDARDS OR ITEMS.

TH A


10)

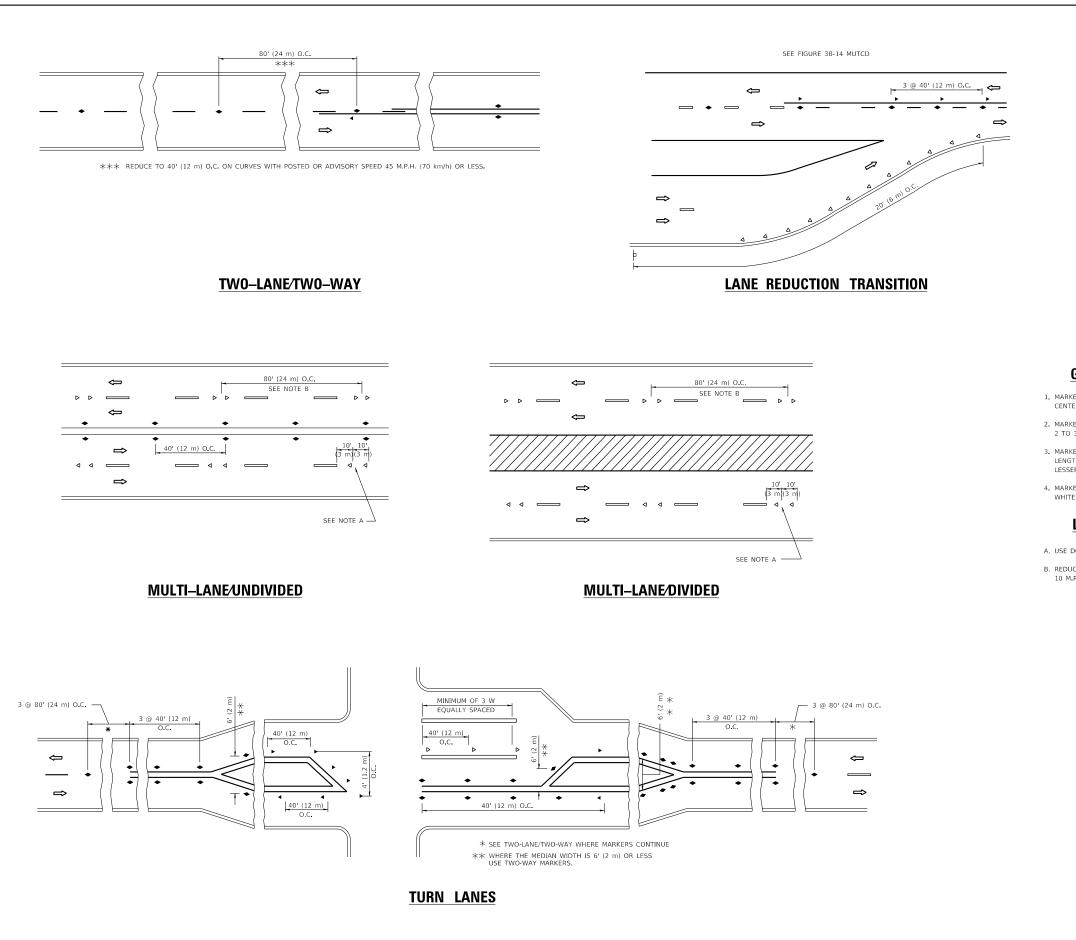All dimensions are in inches (millimeters) unless otherwise shown.



L	USER NAME = steedpa	DESIGNED -	REVISED - T. RAMMACHER 03-12-99			TYPICAL APPLICATIONS		F.A.P BTE	SECTION	COUNTY 5	OTAL SHEET HEETS NO.
		DRAWN -	REVISED -T. RAMMACHER 01-06-00	STATE OF ILLINOIS	RAISED REFL			372	3091-TS&N-1	СООК	103 78
	PLOT SCALE = 100.0000 / in	CHECKED -	REVISED - C. JUCIUS 09-09-09	DEPARTMENT OF TRANSPORTATION	RAISED REFL	LECTIVE PAVEMENT MARKERS (SNOW-	-PLUW RESISTANT)		TC-11	CONTRACT N	O. 62A38
	PLOT DATE = 3/26/2020	DATE -	REVISED C. JUCIUS 07-01-13		SCALE: NONE	SHEET 1 OF 1 SHEETS STA.	TO STA.		ILLINOIS FED.	AID PROJECT	

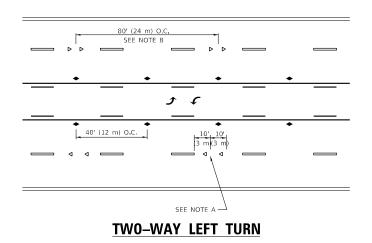LANE MARKER NOTES



GENERAL NOTES

- 1. MARKERS USED WITH DASHED LINES SHALL BE CENTERED IN THE GAP BETWEEN SEGMENTS.
- 2. MARKERS USED ADJACENT TO SOLID LINES SHALL BE OFFSET 2 TO 3 (50 TO 75) TOWARD TRAFFIC AS SHOWN.
- MARKERS THROUGH TANGENTS LESS THAN 500' (150 m) IN LENGTH BETWEEN CURVES SHALL BE INSTALLED AT THE LESSER OF THE TWO CURVE SPACINGS.
- 4. MARKERS ARE TO BE USED ADJACENT TO BOTH SOLID WHITE LINES IN DUAL LEFT TURN LANES

A. USE DOUBLE LANE LINE MARKERS SPACED AS SHOWN.

B. REDUCE TO 40' (12 m) O.C. ON CURVES WHERE ADVISORY SPEEDS ARE 10 M.P.H (20 km/h) LOWER THAN POSTED SPEEDS.

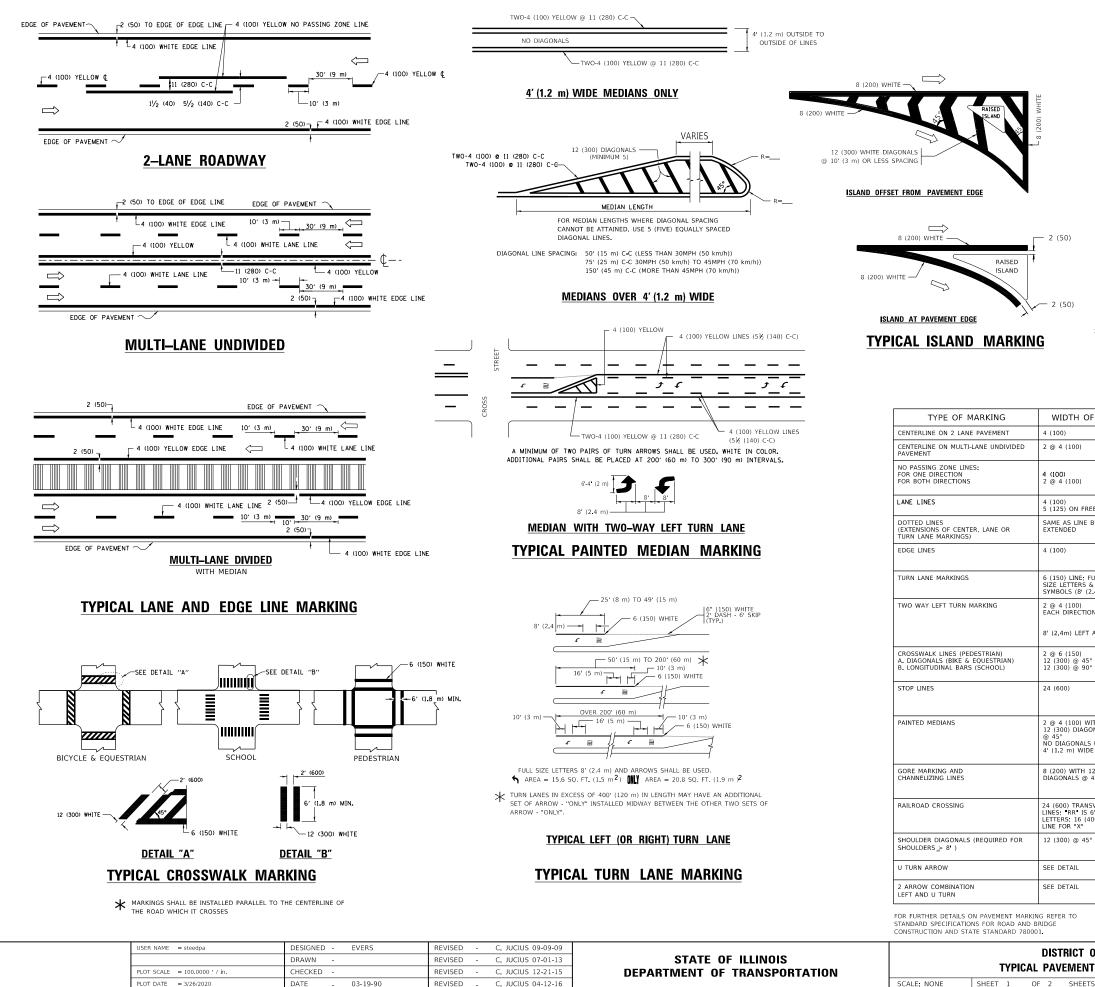
SYMBOLS

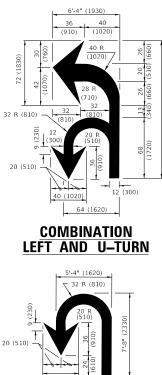
- ----- YELLOW STRIPE
- WHITE STRIPE
- ONE-WAY AMBER MARKER
- ONE-WAY CRYSTAL MARKER (W/O) ۵
- TWO-WAY AMBER MARKER ٠

DESIGN NOTES

- 1. DOUBLE LANE LINE MARKERS SHALL BE USED UNLESS SPECIFIED OTHERWISE.
- 2. EXCEPT AS SHOWN ON THE LANE REDUCTION TRANSITION AND FREEWAY EXIT RAMP DETAIL, MARKERS ARE NOT TO BE SPECIFIED ON RIGHT EDGE LINES.
- 3. THE EXACT MARKER LIMITS, SPACING, AND COLOR SHALL BE INCLUDED IN THE PLANS WHEN STANDARD SPECIFICATIONS ARE NOT BEING USED.
- 4. MARKERS SHOULD NOT BE USED ALONGSIDE CURBS EXCEPT FOR EXTREMELY SHORT SECTIONS OF CURBS WHERE NOT MORE THAN TWO MARKERS WOULD BE INVOLVED.


All dimensions are in inches (millimeters) unless otherwise shown.





(1020)

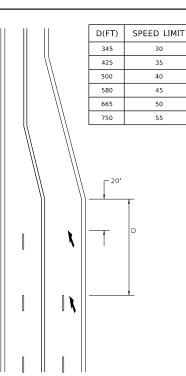U_TURN




LANE REDUCTION TRANSITION


★ LANE REDUCTION ARROWS REQUIRED AT SPEEDS OF 45 MPH OR GREATER OR WHEN SPECIFIED IN PLANS.

F LINE	PATTERN	COLOR	SPACING / REMARKS
	SKIP-DASH	YELLOW	10' (3 m) LINE WITH 30' (9 m) SPACE
	SOLID	YELLOW	11 (280) C-C
	SOLID SOLID	YELLOW YELLOW	5½ (140) C-C FROM SKIP-DASH CENTERLINE 11 (280) C-C OMIT SKIP-DASH CENTERLINE BETWEEN
EEWAYS	SKIP-DASH SKIP-DASH	WHITE WHITE	10'(3 m) LINE WITH 30'(9 m) SPACE
BEING	SKIP-DASH	SAME AS LINE BEING EXTENDED	2 (600) LINE WITH 6 (1.8 m) SPACE
	SOLID	YELLOW-LEFT WHITE-RIGHT	OUTLINE MEDIANS IN YELLOW
=ULL & 2.4m))	SOLID	WHITE	SEE TYPICAL TURN LANE MARKING DETAIL
ON ARROW	SKIP-DASH AND SOLID IN PAIRS	YELLOW	10' (3 m) LINE WITH 30' (9 m) SPACE FOR SKIP-DASH: 5½ (140) C-C BETWEEN SOLID LINE AND SKIP-DASH LINE SEE TYPICAL TWO-WAY LEFT TURN MARKING DETAIL
0	SOLID SOLID SOLID	WHITE WHITE WHITE	NOT LESS THAN 6' (1.8 m) APART 2' (600) APART 2' (600) APART SEE TYPICAL CROSSWALK MARKING DETAILS.
	SOLID	WHITE	PLACE 4' (1.2 m) IN ADVANCE OF AND PARALLEL TO CROSSWALK, IF PRESENT. OTHERWISE, PLACE AT DESIRED STOPPING POINT. PARALLEL TO CROSSROAD CENTERLINE, WHERE POSSIBLE
VITH ONALS 5 USED FOR 9E MEDIANS	SOLID	YELLOW: TWO WAY TRAFFIC WHITE: ONE WAY TRAFFIC	11 (280) C-C FOR THE DOUBLE LINE SEE TYPICAL PAINTED MEDIAN MARKING.
12 (300) 45°	SOLID	WHITE	DIAGONALS: 15 (4.5 m) C-C (LESS THAN 30MPH (50 km/h)) 20 (6 m) C-C 30MPH (50 km/h) TO 45MPH (70 km/h)) 30 (9 m) C-C (OVER 45MPH (70 km/h))
SVERSE 6' (1.8 m) 100)	SOLID	WHITE	SEE STATE STANDARD 780001 AREA OF: "R"=3.6 SQ. FT. (0.33 m ŽEACH "X"=54.0 SQ. FT. (5.0 m Ž
0	SOLID	WHITE - RIGHT YELLOW - LEFT	50' (15 m) C-C (LESS THAN 30MPH (50 km/h)) 75' (25 m) C-C (30 MPH (50 km/h) TO 45MPH (70 km/h)) 150' (45 m) C-C (OVER 45MPH (70 km/h))
	SOLID	WHITE	16.3 SF
	SOLID	WHITE	30.4 SF

All dimensions are in inches (millimeters) unless otherwise shown.


10	NE		F.A.P RTE	SECTION		COUNTY	TOTAL SHEETS	SHEET NO.
т	T MARKINGS			372 3091-TS&N-1			103	79
				TC-13		CONTRACT	NO. 6	2A38
ΓS	STA.	TO STA.		ILLING	IS FED. A	ID PROJECT		

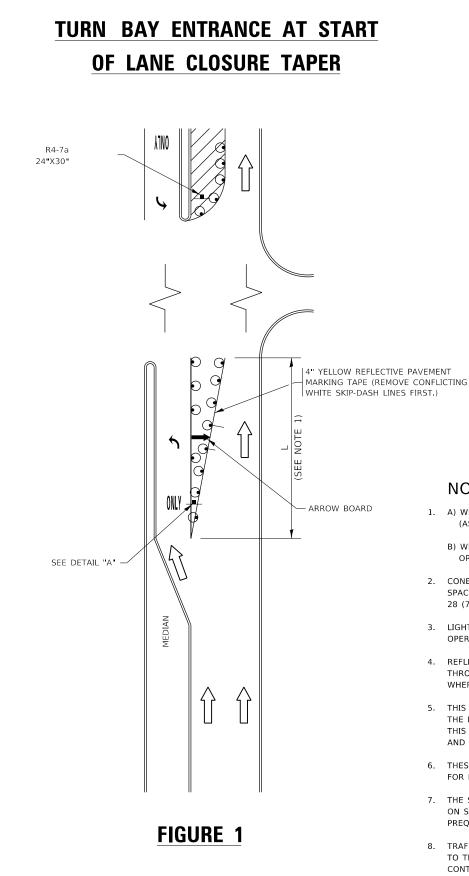

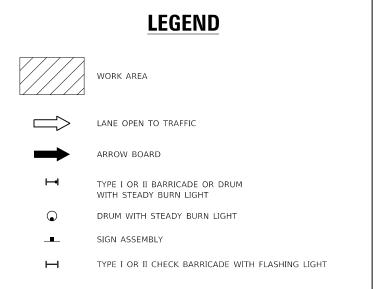


NOTES:

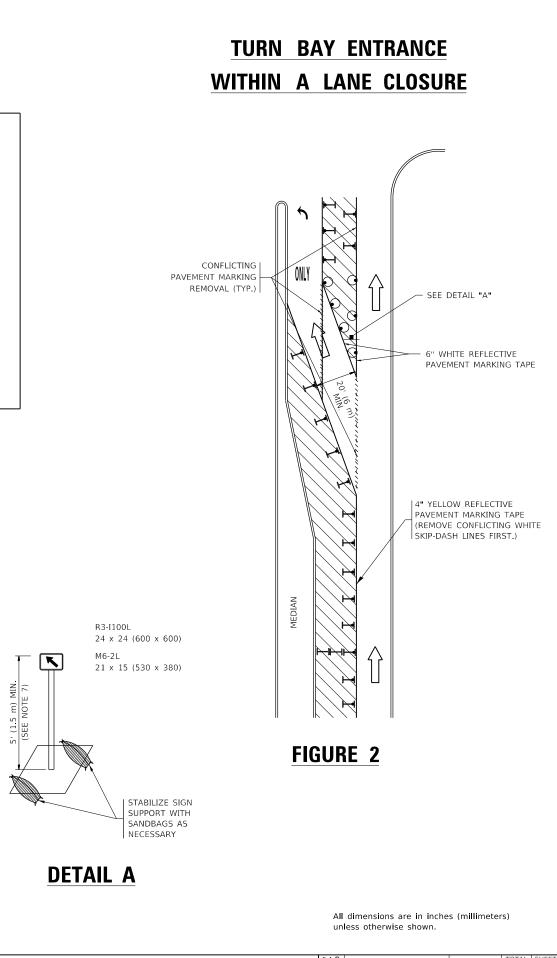- 1. A) WHEN "L" IS ≤ THE STORAGE LENGTH OF THE TURN LANE (AS SHOWN IN FIG. 1), USE FIGURE 1.
 - B) WHEN "L" IS > THE STORAGE LENGTH OF THE TURN LANE OR THE TURN LANE IS WITHIN THE LANE CLOSURE, USE FIGURE 2.
- 2. CONES MAY BE SUBSTITUTED FOR BARRICADES OR DRUMS AT HALF THE SPACING DURING DAY OPERATIONS. CONES SHALL BE A MINIMUM OF 28 (710) IN HEIGHT.
- 3. LIGHTS WILL NOT BE REQUIRED ON BARRICADES OR DRUMS FOR DAY OPERATIONS. ALL LIGHTS SHALL BE MONODIRECTIONAL.
- 4. REFLECTIVE TEMPORARY PAVEMENT MARKINGS SHALL BE PLACED THROUGHOUT THE BARRICADED AREAS OF EACH TURN BAY AS SHOWN WHERE THE CLOSURE TIME IS GREATER THAN FOURTEEN (14) DAYS.
- 5. THIS APPLICATION ALSO APPLIES WHEN WORK IS BEING PERFORMED IN THE RIGHT LANE(S) AND THE RIGHT TURN BAY IS TO REMAIN OPEN. UNDER THIS CONDITION, "RIGHT TURN LANE" R3-1100R 24 x 24 (600 x 600) AND M6-2R 21 x 15 (530 x 380) SHALL BE USED.
- 6. THESE CONTROLS SHALL SUPPLEMENT MAINLINE TRAFFIC CONTROL FOR LANE CLOSURES.
- 7. THE SIGNS SHALL BE MOUNTED ABOVE THE BARRICADES/DRUMS ON SEPARATE SIGN SUPPORTS THAT MEET NCHRP 350 OR MASH PREOUIREMENTS.
- 8. TRAFFIC CONTROL AND PROTECTION AT TURN BAYS (TO REMAIN OPEN TO TRAFFIC) SHALL BE INCLUDED IN THE COST OF SPECIFIED TRAFFIC CONTROL STANDARDS OR ITEMS.




USER NAME = steedpa	DESIGNED - T. RAMMACHER 09-08-94	REVISED - R. BORO 09-14-09		TRAFFIC CONTROL AND PROTECTION AT TURN BAYS	F.A.P BTE SECTION	COUNTY TOTAL SHEET
	DRAWN - A. HOUSEH 11-07-95	REVISED - A. SCHUETZE 07-01-13	STATE OF ILLINOIS		372 3091-TS&N-1	COOK 103 80
PLOT SCALE = 100.0000 ' / in.	CHECKED A. HOUSEH 10-12-96	REVISED - A. SCHUETZE 09-15-16	DEPARTMENT OF TRANSPORTATION	(TO REMAIN OPEN TO TRAFFIC)	TC-14	CONTRACT NO. 62A38
PLOT DATE = 3/26/2020	DATE -T. RAMMACHER 01-06-00	REVISED -		SCALE: NONE SHEET 1 OF 1 SHEETS STA. TO STA.	ILLINOIS FED	AID PROJECT

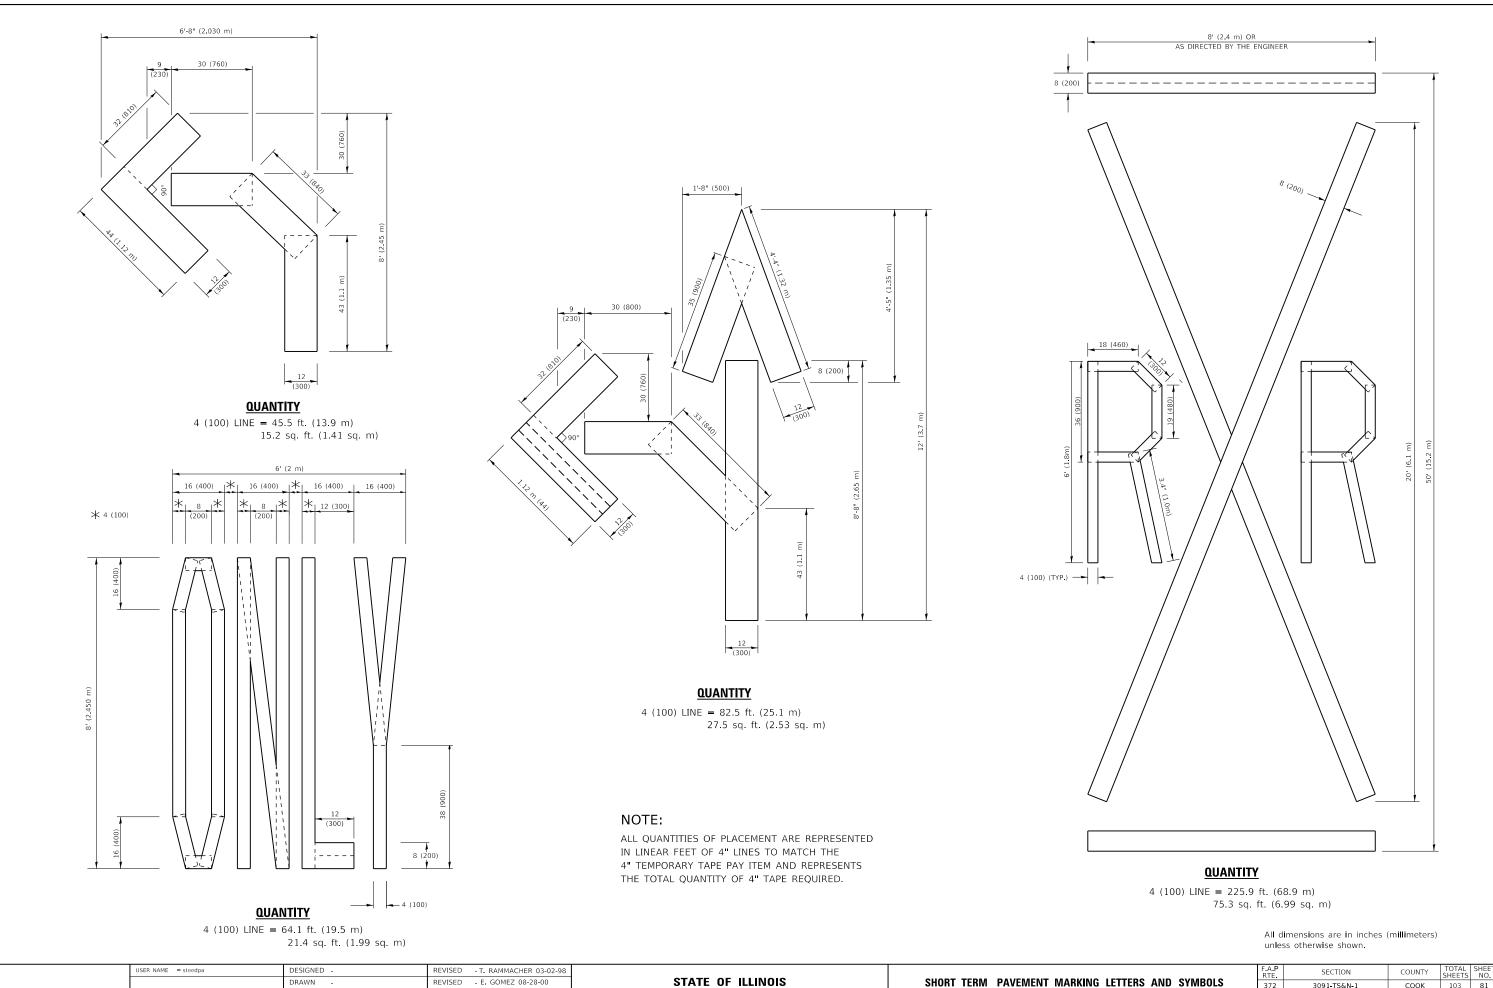


USER NAME = steedpa	DESIGNED -	REVISED - T. RAMMACHER 03-02-98				
	DRAWN -	REVISED - E. GOMEZ 08-28-00	STATE OF ILLINOIS	SHORT T	ERM PAV	EMENT MAP
PLOT SCALE = 100.0010 / In.	CHECKED -	REVISED - E. GOMEZ 08-28-00	DEPARTMENT OF TRANSPORTATION			
PLOT DATE = 3/26/2020	DATE - 09-18-94	REVISED - A. SCHUETZE 09-15-16		SCALE: NONE	SHEET 1	OF 1 S

MARKING	LETTERS A			F.A.P RTE	SECTION			TOTAL SHEETS	
WIANKING	LLIILNO A		STNIDULS	372 3091-TS&N-1		СООК	103	81	
					TC-16		CONTRACT	NO. 62	2A38
SHEETS	STA.	TO S	TA.		ILLINOI	S FED. A	ID PROJECT		

		WORK ZONE EXT DPENING
NOTE:		CONTROL SIGN
 ALL SIGNS SHALL BE REMOVED OR TURNED AWAY FROM TRAFFIC AND THE EXIT AND ENTRY OPENINGS SHALL BE REMOVED OR TURNED AWAY FROM TRAFFIC AND THE EXIT AND ENTRY OPENINGS SHALL BE CLOSED WHEN THE FLAGGING OPERATION CASES. NON OPERATION COSES. WORK ZONE OPENINGS SHALL BE A MINIMUM OF ON HALF MILE APART AND A MINIMUM OF ONE QUARTER MILE FROM ALL ENTRAINCE AND EXIT RAMPS. EXITING THE WORK ZONE AT ANY PLACE OTHER THAN AT A WORK ZONE EXIT OPENING WILL BE PROHIBITED. EXITING THE WORK ZONE AT ANY PLACE OTHER THAN AT A WORK ZONE EXIT OPENING WILL BE PROHIBITED. EXITING THE WORK ZONE AT ENTRY OPENINGS, USING THEIR TURN SUCHAS TO WARM MOTORISTS FLAGGERS SHALL NOT STOP TRAFFIC OR DIRECT TRAFFIC INTO AN ADJACENT LANE. EXITING THE WORK ZONE AT ENTRY OPENINGS, USING THEIR TURN SUCHAS TO WARM MOTORISTS FLAGGERS SHALL NOT STOP TRAFFIC OR DIRECT TRAFFIC INTO AN ADJACENT LANE. EXITING THE WORK ZONE AT ENTRY OPENINGS, USING FOR FLAGGING OPERATIONS AT WORK ZONE OPENINGS ON FREEWARY SERVICES ON FRAMEWORK ZONE AT INCHES (MILLWETER) (AT WORK ZONE OPENINGS ON FREEWARY SERVICES ON FRAMEWORK ZONE AT INCHES (MILLWETER) (AT WORK ZONE OPENINGS ON FREEWARY SERVICES ON FRAMEWORK ZONE AT INCHES (MILLWETER) (AT WORK ZONE OPENINGS ON FREEWARY SERVICES ON FRAMEWORK ZONE AT INCHES (MILLWETER) (AT WORK ZONE OPENINGS ON FREEWARY SERVICES ON FRAMEWORK ZONE AT INCHES (MILLWETER) (AT WORK ZONE OPENINGS ON FREEWARY SERVICES ON FRAMEWORK ZONE AT INCHES (MILLWETER) (NO. 64288 	113612/CADDatablestgenDitsStd.dgn	WATCH FOR SLOW TRAFFIC 500' (150m)
NON OPERATING EQUIPMENT SHALL COMPLY WITH ARTICLE 701.11 2. WORK ZONE OPENINGS SHALL BE A MINIMUM OF ONE HALF MILE APART AND A MINI	strict IJPPojects/P	1. ALL SIGNS SHALL BE REMOVED OR TURNED AWAY FROM TRAFFIC AND THE EXIT AND ENTRY L FLAGGER WITH 1. ALL SIGNS SHALL BE REMOVED OR TURNED AWAY FROM TRAFFIC AND THE EXIT AND ENTRY CONTROL SIGN
ALL DIMENSIONS ARE IN INCHES (MILLIMETERS) UNLESS OTHERWISE SHOLL NOT STOP TRAFFIC OR DIRECT TRAFFIC OR DIRECT TRAFFIC INTO AN ADJACENT LANE.	UDOT Offices/D	NON OPERATING EQUIPMENT SHALL COMPLY WITH ARTICLE 701.11 2. WORK ZONE OPENINGS SHALL BE A MINIMUM OF ONE HALF MILE APART AND A MINIMUM OF
	01/Documents	3. EXITING THE WORK ZONE AT ANY PLACE OTHER THAN AT A WORK ZONE EXIT OPENING WILL
Vigth regregation User NAMe = steedpa DESIGNED - ReVISED A.F. 02-06 FREEWAY / EXPRESSWAY SIGNING FOR FLAGGING OPERATIONS DRAWN - Free Section COUNTY Total SHEET Notest Notest Notest Notest <th< th=""><th>Li Alexandri Ale</th><th>4. ALL VEHICLES SHALL ENTER THE WORK ZONE AT ENTRY OPENINGS, USING THEIR TURN</th></th<>	Li Alexandri Ale	4. ALL VEHICLES SHALL ENTER THE WORK ZONE AT ENTRY OPENINGS, USING THEIR TURN
Image: Processing of the second of the se	planroom.dot.ll	ALL DIMENSIONS ARE IN INCHES (MILLIMETERS)
DUALE NUME LABELE NUME LABELE UN STA LUSTA LUMACECCA AD ADOLECT	Drawn Drawn - Deg grad PLOT SCALE = 100,0000 ' / in. CHECKED -	REVISED S.P.B. 01-07 STATE OF ILLINOIS AT WORK ZONE OPENINGS ON FREEWAYS / EXPRESSWAYS 372 3091-TS&N-1 COOK 103 82 REVISED S.P.B. 12-09 DEPARTMENT OF TRANSPORTATION AT WORK ZONE OPENINGS ON FREEWAYS / EXPRESSWAYS TC-18 CONTRACT NO. 62A38

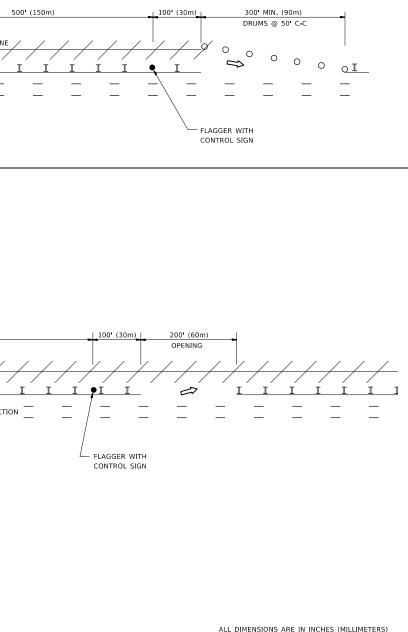

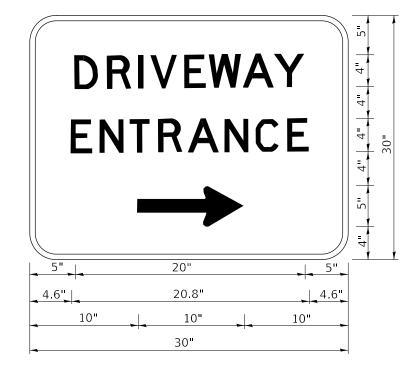

3.0" RADIUS, 0.5" BORDER, WHITE ON GREEN; REFLECTORIZED "DRIVEWAY" D; "ENTRANCE" D; STANDARD ARROW CUSTOM 12.0" x 5.0"

NOTES:

- 1. HALF OF THE SIGNS WILL REQUIRE A LEFT HAND FACING ARROW.
- 2. TWO SIGNS SHALL BE USED AT EACH COMMERCIAL ENTRANCE PLACED BACK-TO-BACK: ONE WITH A RIGHT HAND ARROW (SHOWN) SHALL BE PLACED ON THE NEAR RIGHT SIDE THE DRIVEWAY AND ONE WITH A LEFT HAND ARROW SHALL BE PLACED ON THE FAR LEFT SIDE OF THE DRIVEWAY.
- 3. SIGNS TO BE PAID FOR AS ITEM "TEMPORARY INFORMATION SIGNING".

USER NAME = steedpa	DESIGNED -	REVISED - C. JUCIUS 02-15-07					F.A.P RTE	SECTION	COUNTY	TOTAL SHEET SHEETS NO.
	DRAWN -	REVISED -	STATE OF ILLINOIS		DRIVEWAY ENTRANCE SIGNING		372	3091-TS&N-1	соок	103 83
PLOT SCALE = 100.0000 ' / in.	CHECKED -	REVISED -	DEPARTMENT OF TRANSPORTATION					TC26	CONTRACT	T NO. 62A38
PLOT DATE = 3/26/2020	DATE -	REVISED -		SCALE: NONE	SHEET 1 OF 2 SHEETS STA.	TO STA.		ILLINOIS FED.	AID PROJECT	

SIGN PANEL – TYPE 1 OR TYPE 2 60 3.75 35.25 11.125 3.875 Sample Rd 60 8.25 14.5 17 4.125 4.125 **Rte 123** Sample Rd 3.75 11.125 3.875 35.25 6 84 12 12 35.25 6 9.125 4.875 4.75 Sample St Sample Rd 3.75 3.875 35.25 6 11.125 12 12 DESIGN AREA SIGN PANEL SHEETING QTY. TYPE REQUIRED SERIES (SQ FT) TYPE D OR C 1 OR 2 ZZ **COMMON STREET NAME ABBREVIATIONS**

AND WIDTHS

NAME	ABBREVATION	WIDTH	(INCH)
INAME	ADDREVATION	SERIES "C"	SERIES "D"
AVENUE	Ave	15.000	18.250
BOULEVARD	Blvd	17.125	20.000
CIRCLE	Cir	11.125	13.000
COURT	Ct	8.250	9.625
DRIVE	Dr	8.625	10.125
HIGHWAY	Hwy	18.375	22.000
ILLINOIS	IL	7.000	8.250
LANE	Ln	9.125	10.750
PARKWAY	Pkwy	23.375	27.375
PLACE	ΡI	7.125	7.750
ROAD	Rd	9.625	11.125
ROUTE	Rte	12.625	14.500
STREET	St	8.000	9.125
TERRACE	Ter	12.625	14.625
TRAIL	Tr	7.750	9.125
UNITED STATES	US	10.375	12.250


GENERAL NOTES

- 1. WHERE MAST ARM MOUNTED STREET NAME SIGNS ARE SPECIFIED, THE MAST ARM ASSEMBLY AND POLES SHALL BE DESIGNED TO SUPPORT THE LOADINGS CALLED FOR ON STANDARDS 877001, 877002, 877006, 877011 AND 877012, AS APPLICABLE, PLUS TWO (2) SIGN PANELS 2-6" x 8-0" MOUNTED AS SHOWN. THE DESIGN SHALL BE IN ACCORDANCE WITH THE REQUIREMENTS OF THE CURRENT "STANDARD SPECIFICATIONS FOR STRUCTURAL SUPPORTS FOR HIGHWAY SIGNS, LUMINAIRES, AND TRAFFIC SIGNALS" AS PUBLISHED BY THE AMERICAN ASSOCIATION OF STATE HIGHWAY AND TRANSPORTATION OFFICIALS FOR 80 M.P.H. WIND VELOCITY.
- 2. ALL SIGNS SHALL CONSIST OF A WHITE LEGEND AND BORDER (TYPE ZZ SHEETING) ON A GREEN BACKGROUND (TYPE ZZ SHEETING)
- 3. THE SIGN LENGTH SHALL BE IN 6-INCH INCREMENTS, BUT THE OVERALL LENGTH SHALL NOT EXCEED 8'-0". ALL BORDERS IF POSSIBLE, BUT MAY BE REDUCED TO 5" WHEN SPACING IS CRITICAL. A MINIMUM OF 2-1/2" SHALL BE INCLUDED BETWEEN THE WORD AND THE RIGHT AND LEFT EDGES OF THE SIGN.
- 4. A PREFERRED METHOD FOR THE SIGN DESIGN IS TO USE SERIES "D" LETTER ON A ONE-LINE SIGN 18" IN HEIGHT AND A MAXIMUM OF 8-0" IN WIDTH. IF SERIES "D" DOES NOT FIT ON A 8"-0" SIGN, THEN SERIES "C" SHOULD BE TRIED. IF SERIES "C" DOES NOT FIT ON A 8-0" SIGN, A 30" HIGH TWO-LINE SIGN CAN BE USED. THE CROSSROAD DESIGNATION AS TO STREET, AVENUE, ETC. SHOULD BE SPELLED OUT ON THE SECOND LINE, IF THE ABBREVIATION CANNOT FIT ON THE FIRST LINE.
- LED ILLUMINATED STREET NAME SIGNS CAN BE USED IN PLACE OF REGULAR SIGN PANELS BUT ANY SPECIAL WORDING AND SYMBOLOGY MUST BE APPROVED BY THE DEPARTMENT. GENERAL DESIGN REQUIREMENT AS LISTED ABOVE (COLOR, FONT, SIZE, ETC.) MUST BE FOLLOWED.
- 6. SIGNFIX ALUMINUM CHANNEL FRAMING SYSTEM SHALL BE USED FOR ALL SIGNS ATTACHED TO SIGNAL POLES AND POSTS.


LOCAL SUPPLIERS:	PARTS LISTING:	
- J.O. HERBERT COMPANY, INC MIDLOTHIAN, VA	SIGN CHANNEL SIGN SCREWS	PART #HPN053 (MED. CHANNEL) 1/4" × 14 × 1" H.W.H. #3 SELF TAPPING WITH NEOPRENE WASHER
- WESTERN REMAC, INC. WOODRIDGE, IL	BRACKETS	PART #HPN034 (UNIVERSAL) CHANNEL CLAMPS WITH STAINLESS STEEL STRAPPING

OTHER BRANDS OF MOUNTING HARDWARE ARE ACCEPTABLE, BASED UPON THE DEPARTMENT'S APPROVAL AND COMPATIBILITY WITH THE CHANNEL/BRACKET OF THE ABOVE PRODUCT.

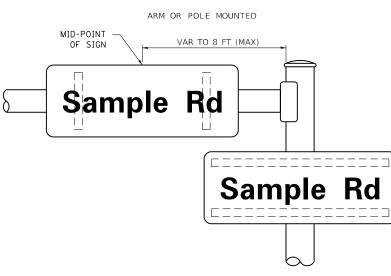
MOUNTING LOCATION



SUPPORTING CHANNELS

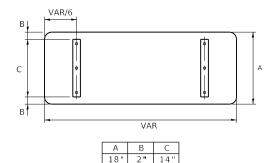

30" 2" 24"

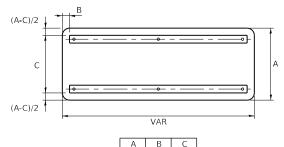

18" 2" 12"


30" 2"

USER NAME = steedpa	DESIGNED - LP/IP	REVISED - LP 07/01/2015				DIS	TRICT O	NE		F A P RTE	SECTION	COUNTY	TOTAL SHEET SHEETS NO.
	DRAWN - LP	REVISED -	STATE OF ILLINOIS	N					AME SIGNS	372	3091-TS&N-1	соок	103 84
PLOT SCALE = 100.0000 ' / in.	CHECKED - IP	REVISED -	DEPARTMENT OF TRANSPORTATION	IV IV	IAST ARIVI	WUUN	וובה אוו		AIVIE SIGNS		TS-02	CONTRACT	T NO. 62A38
PLOT DATE = 3/26/2020	DATE - 10/01/2014	REVISED -		SCALE:	SHEET	OF	SHEETS	STA.	TO STA.		ILLINOIS FED.	AID PROJECT	

STANDARD ALPHABETS SPACING CHART

(8") UPPER CASE AND (6") LOWER CASE

	FHWA SE	RIES "C"			FHWA SEI	RIES "D "	
HARACTER	LEFT SPACING (INCH)	WIDTH (INCH)	RIGHT SPACING (INCH)	CHARACTER	LEFT SPACING (INCH)	WIDTH (INCH)	RIGHT SPACING (INCH)
А	0.240	5.122	0.240	A	0.240	6.804	0.240
В	0.880	4.482	0.480	В	0.960	5.446	0.400
С	0.720	4.482	0.720	С	0.800	5.446	0.800
D	0.880	4.482	0.720	D	0.960	5.446	0.800
<u> </u>	0.880	4.082	0.480	E	0.960	4.962	0.400
F G	0.880	4.082	0.240	F	0.960	4.962 5.446	0.240
н	0.720	4.482	0. 120	H	0.800	5.446	0.800
I	0.880	1.120	0.880	I	0.960	1.280	0.960
J	0.240	4.082	0.880	J	0.240	5.122	0.960
ĸ	0.880	4.482	0.480	K	0.960	5.604	0.400
L	0.880	4.082	0.240	L	0.960	4.962	0.240
М	0.880	5.284	0.880	М	0.960	6.244	0.960
N	0.880	4.482	0.880	N	0.960	5.446	0.960
0	0.720	4.722	0.720	0	0.800	5.684	0.800
Р	0.880	4.482	0.720	Р	0.960	5.446	0.240
Q	0.720	4.722	0.720	Q	0.800	5.684	0.800
R	0.880	4.482	0.480	R	0.960	5.446	0.400
S	0.480	4.482	0.480	S	0.400	5.446	0.400
T	0.240	4.082	0.240	Т	0.240	4.962	0.240
U V	0.880	4.482	0.880	U V	0.960	5.446 6.084	0.960
	0.240	6.084	0.240	W	0.240	7.124	0.240
X	0.240	4.722	0.240	X X	0.240	5.446	0.240
Y	0.240	5.122	0.240	Y	0.240	6.884	0.240
Z	0.480	4.482	0.480	Z	0.400	5.446	0.400
a	0.320	3.842	0.640	a	0.400	4.562	0.720
b	0.720	4.082	0.480	b	0.800	4.802	0.480
С	0.480	4.002	0.240	с	0.480	4.722	0.240
d	0.480	4.082	0.720	d	0.480	4.802	0.800
е	0.480	4.082	0.320	е	0.480	4.722	0.320
f	0.320	2.480	0.160	f	0.320	2.882	0.160
g	0.480	4.082	0.720	g	0.480	4.802	0.800
<u>h</u>	0.720	4.082	0.640	h	0.800	4.722	0.720
1	0.720	1.120	0.720	i	0.800	1.280	0.800
j k	0.000	2.320	0.720	j k	0.000	2.642	0.800
	0.720	1.120	0.720	K I	0.800	1.280	0.180
m	0.720	6.724	0.640	m	0.800	7.926	0.720
n	0.720	4.082	0.640	n	0.800	4.722	0.720
0	0.480	4.082	0.480	0	0.480	4.882	0.480
P	0.720	4.082	0.480	р	0.800	4.802	0.480
q	0.480	4.082	0.720	q	0.480	4.802	0.800
r	0.720	2.642	0.160	r	0.800	3.042	0.160
S	0.320	3.362	0.240	S	0.320	3.762	0.240
+	0.080	2.882	0.080	t	0.080	3.202	0.080
U	0.640	4.082	0.720	u	0.720	4.722	0.800
V	0.160	4.722	0.160	V	0.160	5.684	0.160
w	0.160	7.524	0.160	W	0.160	9.046	0.160
×	0.000	5.202 4.962	0.000	X	0.000	6.244 6.004	0.000
y z	0.160	4.962 3.362	0.160	y z	0.160	4.002	0.160
1	0.240	1.680	0.240	1	0.240	2.000	0.960
2	0.480	4.482	0.480	2	0.800	5.446	0.800
3	0.480	4.482	0.480	3	1.440	5.446	0.800
4	0.240	4.962	0.720	4	0.160	6.004	0.960
5	0.480	4.482	0.480	5	0.800	5.446	0.800
6	0.720	4.482	0.720	6	0.800	5.446	0.800
7	0.240	4.482	0.720	7	0.560	5.446	0.560
8	0.480	4.482	0.480	8	0.800	5.446	0.800
0					0 900	E 440	0 000
9	0.480	4.482	0.480	9	0.800	5.446	0.800
	0.480 0.720 0.240	4.482 4.722 2.802	0.480	0	0.800	5.446 5.684 2.802	0.800

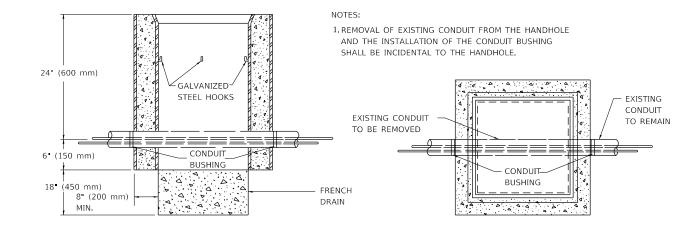

ELEVATION

USER NAME = steedpa	DESIGNED -	REVISED - 10-01-00							F.A.P BTE	SECTION	COUNTY TOTAL SHEET
	DRAWN -	REVISED -	STATE OF ILLINOIS		HANDHOLE	E TO INT	ERCEPT EXISTING	CONDUIT	372	3091-TS&N-1	COOK 103 85
PLOT SCALE = 100.0000 ' / in.	CHECKED -	REVISED -	DEPARTMENT OF TRANSPORTATION							TS-03	CONTRACT NO. 62A38
PLOT DATE = 3/26/2020	DATE -	REVISED -		SCALE:	SHEET	OF	SHEETS STA.	TO STA.		ILLINOIS FED.	AID PROJECT



<u>DETAIL</u>

HANDHOLE TO INTERCEPT EXISTING CONDUIT


TRAFFIC SIGNAL LEGEND

(NOT TO SCALE)


				(NOT TO SCALE)				
ITEM	<u>EXISTING</u>	PROPOSED	<u>ITEM</u>	EXISTING	PROPOSED	ITEM	EXISTING	PROPOSED
CONTROLLER CABINET	\boxtimes		HANDHOLE -SQUARE	\square		SIGNAL HEAD -(P) PROGRAMMABLE SIGNAL HEAD	R R	
COMMUNICATION CABINET	ECC	CC	-ROUND HEAVY DUTY HANDHOLE					R R Y Y G G 4 Y 4 Y 4 G 4 G
MASTER CONTROLLER	EMC	MC	-SQUARE -ROUND	H ®	H H		P	€ G € G P
MASTER MASTER CONTROLLER	EMMC	ММС	DOUBLE HANDHOLE			SIGNAL HEAD WITH BACKPLATE	RRR	
UNINTERRUPTABLE POWER SUPPLY	4	1	JUNCTION BOX	\bigcirc	0	-(P) PROGRAMMABLE SIGNAL HEAD -(RB) RETROREFLECTIVE BACKPLATE		R R Y G
SERVICE INSTALLATION -(P) POLE MOUNTED	^P	- ■ - ^P	RAILROAD CANTILEVER MAST ARM	X OZ X X	X CI X X			$ \begin{array}{ c c c } \hline R \\ \hline Y \\ \hline G \\ \hline \bullet Y \\ \hline \bullet G \\ \hline \end{array} \end{array} \begin{array}{ c c } \hline R \\ \hline Y \\ \hline G \\ \hline G \\ \hline \bullet Y \\ \hline \bullet G \\ \hline \end{array} \end{array} \begin{array}{ c c } \hline R \\ \hline Y \\ \hline G \\ \hline \bullet Y \\ \hline \bullet G \\ \hline \hline \bullet G \\ \hline \end{array} \end{array} $
SERVICE INSTALLATION	G GM	G GM	RAILROAD FLASHING SIGNAL	X o X	X+X		P RB	P RB
-(G) GROUND MOUNTED -(GM) GROUND MOUNTED METERED	$\boxtimes^{G} \boxtimes^{GM}$		RAILROAD CROSSING GATE RAILROAD CROSSBUCK	<u>xox</u> >	₩ ₽ ¥	PEDESTRIAN SIGNAL HEAD AT RAILROAD INTERSECTIONS) A	₩ <u>*</u>
TELEPHONE CONNECTION	ET	Т	RAILROAD CONTROLLER CABINET					
STEEL MAST ARM ASSEMBLY AND POLE	0	•	UNDERGROUND CONDUIT (UC),			PEDESTRIAN SIGNAL HEAD WITH COUNTDOWN TIMER	C C C	<pre> C C K D </pre>
ALUMINUM MAST ARM ASSEMBLY AND POLE	0		GALVANIZED STEEL			ILLUMINATED SIGN		•
STEEL COMBINATION MAST ARM ASSEMBLY AND POLE WITH LUMINAIRE	o-¤—	•*	TEMPORARY SPAN WIRE, TETHER WIRE, AND CABLE			"NO LEFT TURN"/"NO RIGHT TURN"		
SIGNAL POST -(BM) BARREL MOUNTED - TEMPORARY	0	• • BM	SYSTEM ITEM	S	SP	NUMBER OF CONDUCTORS, ELECTRIC CABLE NO. 14, UNLESS NOTED OTHERWISE. ALL DETECTOR LOOP CABLE TO BE SHIELDED	5	
WOOD POLE	\otimes	Θ	REMOVE ITEM		R	GROUND CABLE IN CONDUIT,		
GUY WIRE	\succ	\succ	RELOCATE ITEM		RL	NO. 6 SOLID COPPER (GREEN)		
SIGNAL HEAD		-	ABANDON ITEM		А	ELECTRIC CABLE IN CONDUIT, TRACER NO. 14 1/C	1	
SIGNAL HEAD WITH BACKPLATE	+1>	+►	CONTROLLER CABINET AND		RCF	COAXIAL CABLE	— <u>c</u>	—
SIGNAL HEAD OPTICALLY PROGRAMMED	$- \stackrel{P}{\triangleright} + \stackrel{P}{\triangleright}$	\rightarrow P \rightarrow P	FOUNDATION TO BE REMOVED MAST ARM POLE AND			VENDOR CABLE		
FLASHER INSTALLATION -(FS) SOLAR POWERED	ord F ord FS	•• ^F • • ^{FS}	FOUNDATION TO BE REMOVED		RMF	COPPER INTERCONNECT CABLE,		
		₽ ► ^F ₽ ► ^{FS}	SIGNAL POST AND FOUNDATION TO BE REMOVED		RPF	NO. 18, 3 PAIR TWISTED, SHIELDED		
PEDESTRIAN SIGNAL HEAD	-0	-1	DETECTOR LOOP, TYPE I	\Box \bigcirc	\Box \bigcirc	FIBER OPTIC CABLE -NO. 62.5/125, MM12F		-(12F)
PEDESTRIAN PUSH BUTTON -(APS) ACCESSIBLE PEDESTRIAN PUSH BUTTON			PREFORMED DETECTOR LOOP	P P	РР	-NO. 62.5/125, MM12F SM12F -NO. 62.5/125, MM12F SM24F	24F	24F)
RADAR DETECTION SENSOR	R	R	SAMPLING (SYSTEM) DETECTOR	s s	s s		36F	36F
VIDEO DETECTION CAMERA			INTERSECTION AND SAMPLING (SYSTEM) DETECTOR	IS (IS)	IS (IS)			
RADAR/VIDEO DETECTION ZONE			QUEUE AND SAMPLING (SYSTEM) DETECTOR	QS QS	QS QS	GROUND ROD -(C) CONTROLLER -(M) MAST ARM		$\stackrel{\underline{\dot{=}}}{\overset{\underline{-}}{\bullet}}^{C} \stackrel{\underline{\dot{=}}}{\overset{\underline{-}}{\bullet}}^{M} \stackrel{\underline{\dot{=}}}{\overset{\underline{-}}{\bullet}}^{P} \stackrel{\underline{\dot{=}}}{\overset{\underline{-}}{\bullet}}^{S}$
PAN, TILT, ZOOM (PTZ) CAMERA	PTZ	PTZ	WIRELESS DETECTOR SENSOR	6	®	-(P) POST -(S) SERVICE		
EMERGENCY VEHICLE LIGHT DETECTOR	\square	-	WIRELESS ACCESS POINT					
CONFIMATION BEACON	0(1	+1						
WIRELESS INTERCONNECT	↔ ++++	•++++++-						
WIRELESS INTERCONNECT RADIO REPEATER	ERR	RR						
USER NAME = steedpa	DESIGNED -					DISTRICT ONE	F.A.P RTE SECTIO	JILLIS NO.
PLOT SCALE = 100.0000 ' /	in. CHECKED -			ATE OF ILLINOIS IT OF TRANSPORTATION	OF ILLINOIS STANDARD TRAFFIC SIGNAL DESIGN DETAILS 372 3091-T5&N-1			N-1 COOK 103 86 CONTRACT NO. 62A38
PLOT DATE = 3/26/2020	DATE	9/29/2016 REVISED			SCALE: NONE S	HEET 1 OF 7 SHEETS STA. TO STA.		LINOIS FED. AID PROJECT

LOOP DETECTOR NOTES

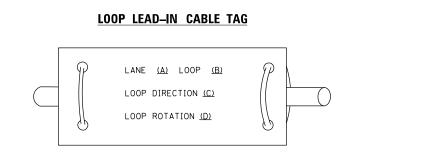- 1. EACH PAIR OF LOOP WIRES SHALL BE PLACED IN A SEPARATE EMPTY COILABLE NONMETALLIC CONDUIT FROM THE EDGE OF PAVEMENT TO THE HANDHOLE. SPACING BETWEEN THE HOLES DRILLED IN THE PAVEMENT SHALL NOT BE LESS THAN 6" (150 mm). EMPTY COILABLE NONMETALLIC CONDUIT SHALL BE INCLUDED IN THE COST OF THE LOOP WIRE.
- 2. THE NUMBER OF LOOP TURNS SHALL BE AS RECOMMENDED BY THE AMPLIFIER MANUFACTURER. ALL ADJACENT SIDES OF THE LOOPS SHALL BE INSTALLED IN SUCH A WAY THAT THE CURRENT FLOW IS IN THE SAME DIRECTION TO REINFORCE ITS MAGNETIC FIELDS FOR SMALL VEHICLE DETECTION.
- 3. EACH LOOP LEAD-IN SHALL BE IDENTIFIED AND PERMANENTLY TAGGED IN THE HANDHOLE. EACH LEAD-IN CABLE TAG SHALL INDICATE THE LOCATION OF THE LOOP, LOOP ROTATION (CLOCKWISE/COUNTERCLOCKWISE), LOOP LEAD-IN DIRECTION (IN OR OUT), LOOP CABLE NUMBER AND LOCATION IN CABINET, AND NUMBER OF TURNS IN THE DETECTOR LOOPS IN WATER PROOF INK AS INDICATED ON THE DISTRICT 1 STANDARD TRAFFIC SIGNAL DESIGN DETAIL. THE CONTRACTOR SHALL MARK LOOP LOCATIONS ON RECORD DRAWINGS AND PRESENT TO THE ENGINEER AFTER FINAL INSPECTION. LOOPS SHALL BE MARKED BY LANE AND LOOP NUMBER. SEE DETAIL BELOW.
- 4. ALL LOOP CABLE SHALL BE FASTENED WITH PLASTIC TIE WRAP TO THE HANDHOLE HOOKS.
- 5. IN ASPHALT PAVEMENT, LOOPS SHOULD BE PLACED IN THE BINDER AND DIVEHOLES MARKED AT THE CURB WITH A SAW-CUT. THE SAW-CUT SHALL BE CUT IN ACCORDANCE WITH LOCAL AND E.P.A. DUST CONTROL REQUIREMENTS. DETECTOR LOOP(S) SHALL NOT BE INSTALLED IN WET CONDITIONS AND THE SAW-CUTS MUST BE FREE OF DEBRIS AND RESIDUE SUCH AS DUST AND WATER WHICH IS TO BE ACHIEVED BY THE USE OF COMPRESSED AIR, WIRE BRUSHING AND HEAT DRYING ACCORDING TO SEALANT MANUFACTURER REQUIREMENTS. THE DETECTOR WIRE SHALL BE HELD IN PLACE BY THE USE OF FORM WEDGES. WEDGES SHALL BE SPACED NO MORE THAN 18" (450 mm) APART.
- 6. LOOP SPLICES SHALL BE SOLDERED USING A SOLDERING IRON. BLOW TORCHES OR OTHER DEVICES WHICH OXIDIZE COPPER CABLE SHALL NOT BE ALLOWED FOR SOLDERING OPERATIONS. SEE DETAIL BELOW RIGHT.
- 7. PREFORMED DETECTOR LOOPS SHALL BE USED, AS SHOWN ON THE PLANS, WHERE NEW CONCRETE PAVEMENT IS PROPOSED. THE INSTALLATION OF PREFORMED LOOPS SHALL BE IN ACCORDANCE WITH THE DISTRICT 1 SPECIFICATIONS OR AS DIRECTED BY THE ENGINEER




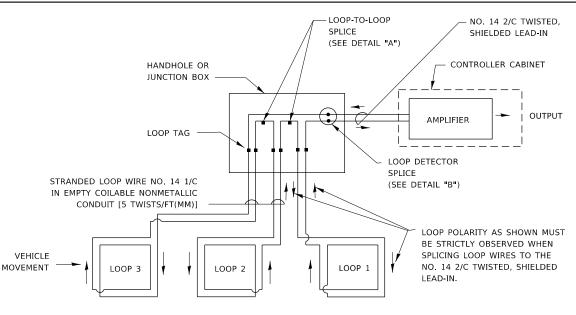- A. LANE 1 IS THE LANE CLOSEST TO THE CENTERLINE OF THE ROADWAY
- B. LOOP #1 IS THE LOOP IN THE LANE CLOSEST TO THE INTERSECTION.
- C. LABEL LOOP CABLE "IN" OR LOOP CABLE "OUT".
- D. LABEL LOOP CABLE CLOCKWISE OR LOOP CABLE COUNTERCLOCKWISE.




DETECTOR LOOP WIRING SCHEMATIC

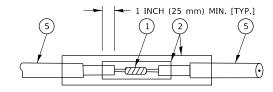- LOOPS SHALL BE SPLICED IN SERIES. SAW-CUTS SHALL BE A MINIMUM WIDTH OF 5/16" (8 mm).
- SAW-CUT DEPTHS SHALL BE 3" (75 mm). IF IN CONCRETE,
- THE SAW-CUT DEPTH SHALL BE TO THE TOP OF THE REINFORCEMENT.
- LOOP CORNERS SHALL BE DRILLED WITH A 2" (50 mm) DIAMETER CORE.




DETAIL "A" LOOP-TO-LOOP SPLICE

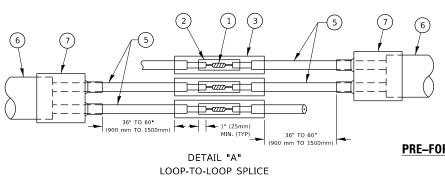

LOOP DETECTOR SPLICE


- (1) WESTERN UNION SPLICE SOLDERED WITH ROSIN CORE FLUX. ALL EXPOSED SURFACES OF THE SOLDER SHALL BE SMOOTH. THE WESTERN UNION SPLICES SHALL BE STAGGERED.
- (2) WCSMW 30/100 HEAT SHRINK TUBE, MINIMUM LENGTH 3" (75 mm), UNDERWATER GRADE
- (3) WCS 200/750 HEAT SHRINK TUBE, MINIMUM LENGHT 6" (150 mm), UNDERWATER GRADE.
- (4) NO. 14 2/C TWISTED, SHIELDED CABLE.

USER NAME = steedpa	DESIGNED -	REVISED -		DISTRICT ONE	F.A.P RTE. SEC	CTION	COUNTY TOTAL SHEET SHEETS NO.
	DRAWN -	REVISED -	STATE OF ILLINOIS	STANDARD TRAFFIC SIGNAL DESIGN DETAILS	372 3091-	-TS&N-1	СООК 103 87
PLOT SCALE = 100.0000 / in.	CHECKED -	REVISED -	DEPARTMENT OF TRANSPORTATION	STANDARD TRAFFIC SIGNAL DESIGN DETAILS	TS-0	5	CONTRACT NO. 62A38
PLOT DATE = 3/26/2020	DATE -	REVISED -		SCALE NONE SHEET 2 OF 7 SHEETS STA. TO STA.		ILLINOIS FED. A	ID PROJECT

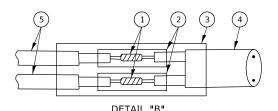

LOOP-TO-CONTROLLER SPLICE

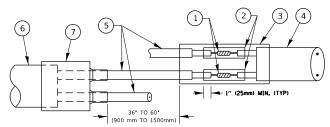
TYPE I LOOP




PRE-FORMED LOOP

DETAIL "B" LOOP-TO-CONTROLLER SPLICE

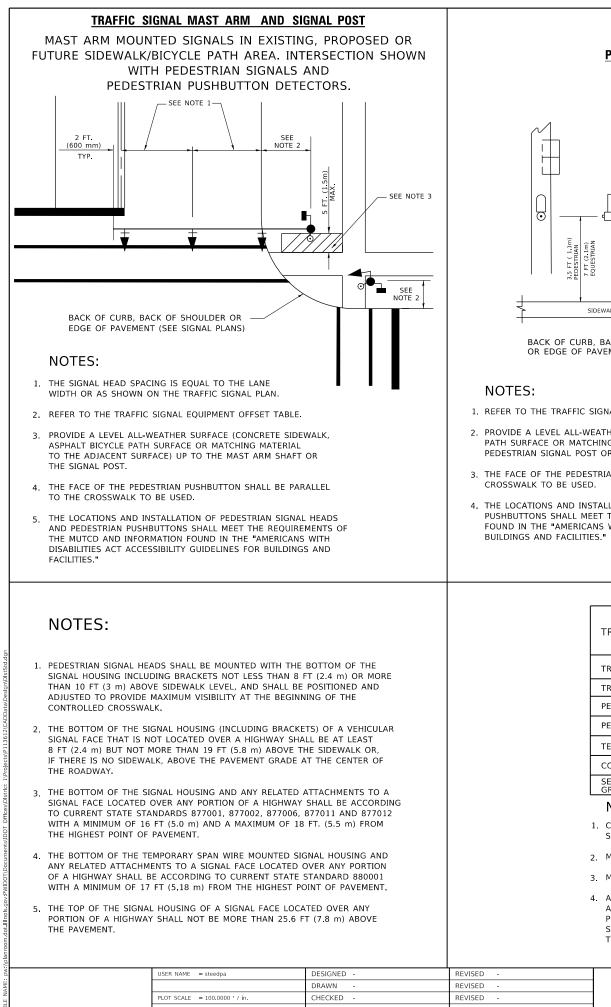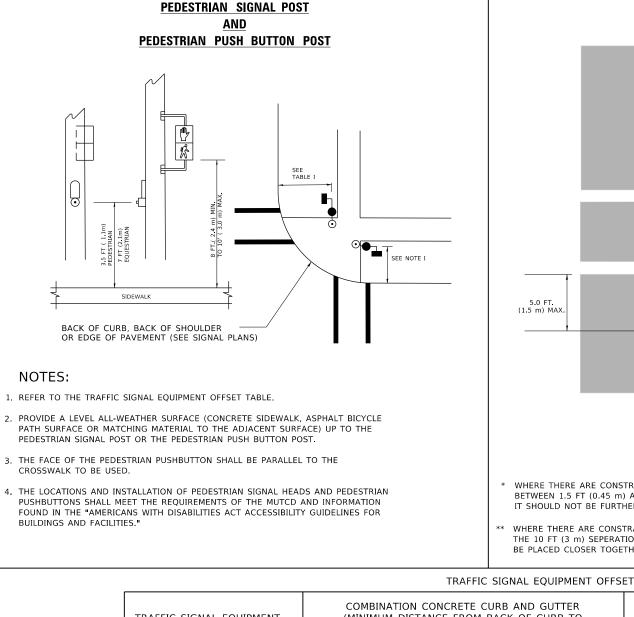- 5 LOOP CONDUCTOR WITH FLEXIBLE PLASTIC TUBE. PRE-FORMED LOOP
- (6) XL POLYOLEFIN 2 CONDUCTOR
- (7) BREAKOUT SEALS. TYCO CBR-2 OR APPROVED EQUAL





TRAFFIC SIGNAL EQUIPMENT	COMBINATION CONCRETE CURB AND GUTTER (MINIMUM DISTANCE FROM BACK OF CURB TO CENTERLINE OF FOUNDATION)	
TRAFFIC SIGNAL MAST ARM POLE	6 FT (1.8m)	SHOUL
TRAFFIC SIGNAL POST	4 FT (1.2m)	SHOUL
PEDESTRIAN SIGNAL POST	4 FT (1.2m)	SHOULD
PEDESTRIAN PUSHBUTTON POST	4 FT (1.2m)	SHOUL
TEMPORARY WOOD POLE	6 FT (1.8m)	SHOUL
CONTROLLER CABINET	6 FT (1.8m) MINIMUM DISTANCE SEE NOTE 2	SHOULD
SERVICE INSTALLATION, GROUND MOUNT	6 FT (1.8m) MINIMUM DISTANCE SEE NOTE 2	SHOULD

NOTES:


1. CONTACT THE "AREA TRAFFIC SIGNAL MAINTENANCE AND OPERATIONS ENGINEER" FOR ASSISTANCE IN LOCATING THE TRAFFIC SIGNAL EQUIPMENT WHEN THERE ARE CONFLICTS WITH DITCHES OR THE MINIMUM OFFSET DISTANCES CANNOT BE MET.


2. MINIMUM DISTANCE FROM THE BACK OF CURB TO THE ROADWAY SIDE OF THE FOUNDATION.

3. MINIMUM DISTANCE FROM THE EDGE OF PAVEMENT TOTHE ROADWAY SIDE OF THE FOUNDATION.


4. ANY CHANGES TO THE OFFSETS OF THE FOUNDATIONS, FROM THE MINIMUM DISTANCES LISTED IN THE "TRAFFIC SIGNAL EQUIPMENT OFFSET" CHART AND THE TRAFFIC SIGNAL INSTALLATION PLAN, COULD EFFECT THE PLACEMENT OF THE SIGNAL HEADS, PEDESTRIAN SIGNAL HEADS AND THE PEDESTRIAN PUSHBUTTONS. THE SIGNAL HEAD PLACEMENT ON THE MAST ARMS SHALL REMAIN AS PER THE TRAFFIC SIGNAL INSTALLATION PLAN AND THE "TRAFFIC SIGNAL MAST ARM AND SIGNAL POST" DETAIL ABOVE. THE PROPOSED MAST ARM LENGTHS MAY NEED TO BE REVISED TO MEET THE ABOVE REQUIREMENTS. THE PEDESTRIAN SIGNAL HEADS AND PEDESTRIAN PUSHBUTTONS MUST MEET THE REQUIREMENTS UNDER THE DETAILS ON THIS SHEET.

USER NAME = steedpa	DESIGNED -	REVISED -				דפות	RICT ON	J.F
	DRAWN -	REVISED -	STATE OF ILLINOIS					
PLOT SCALE = 100.0000 / in.	CHECKED -	REVISED -	DEPARTMENT OF TRANSPORTATION	5	TANDARD	TRAFFIC	SIGNAL	•
PLOT DATE = 3/26/2020	DATE -	REVISED -		SCALE: NONE	SHEET 3	OF 7	SHEETS	
								_

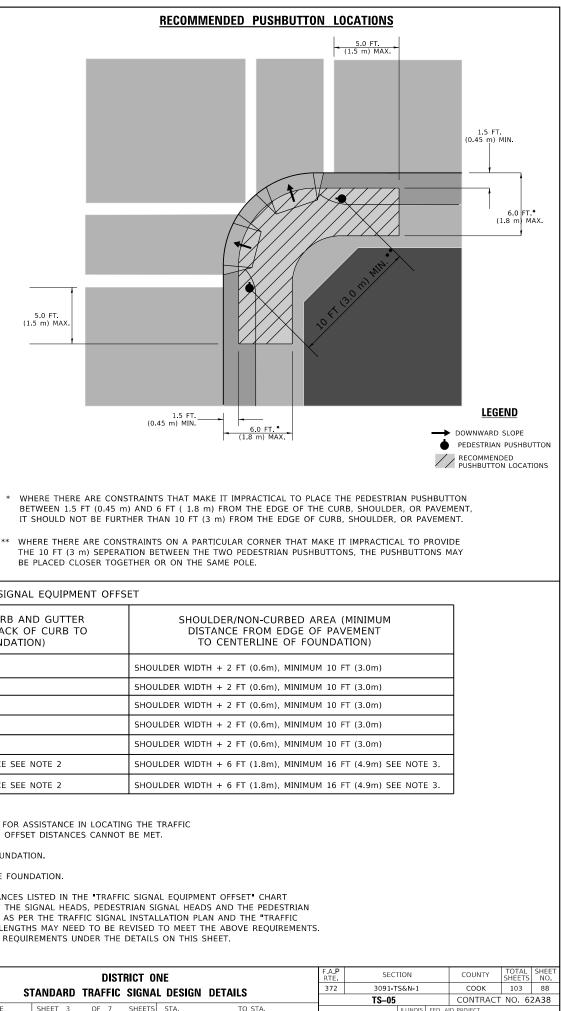

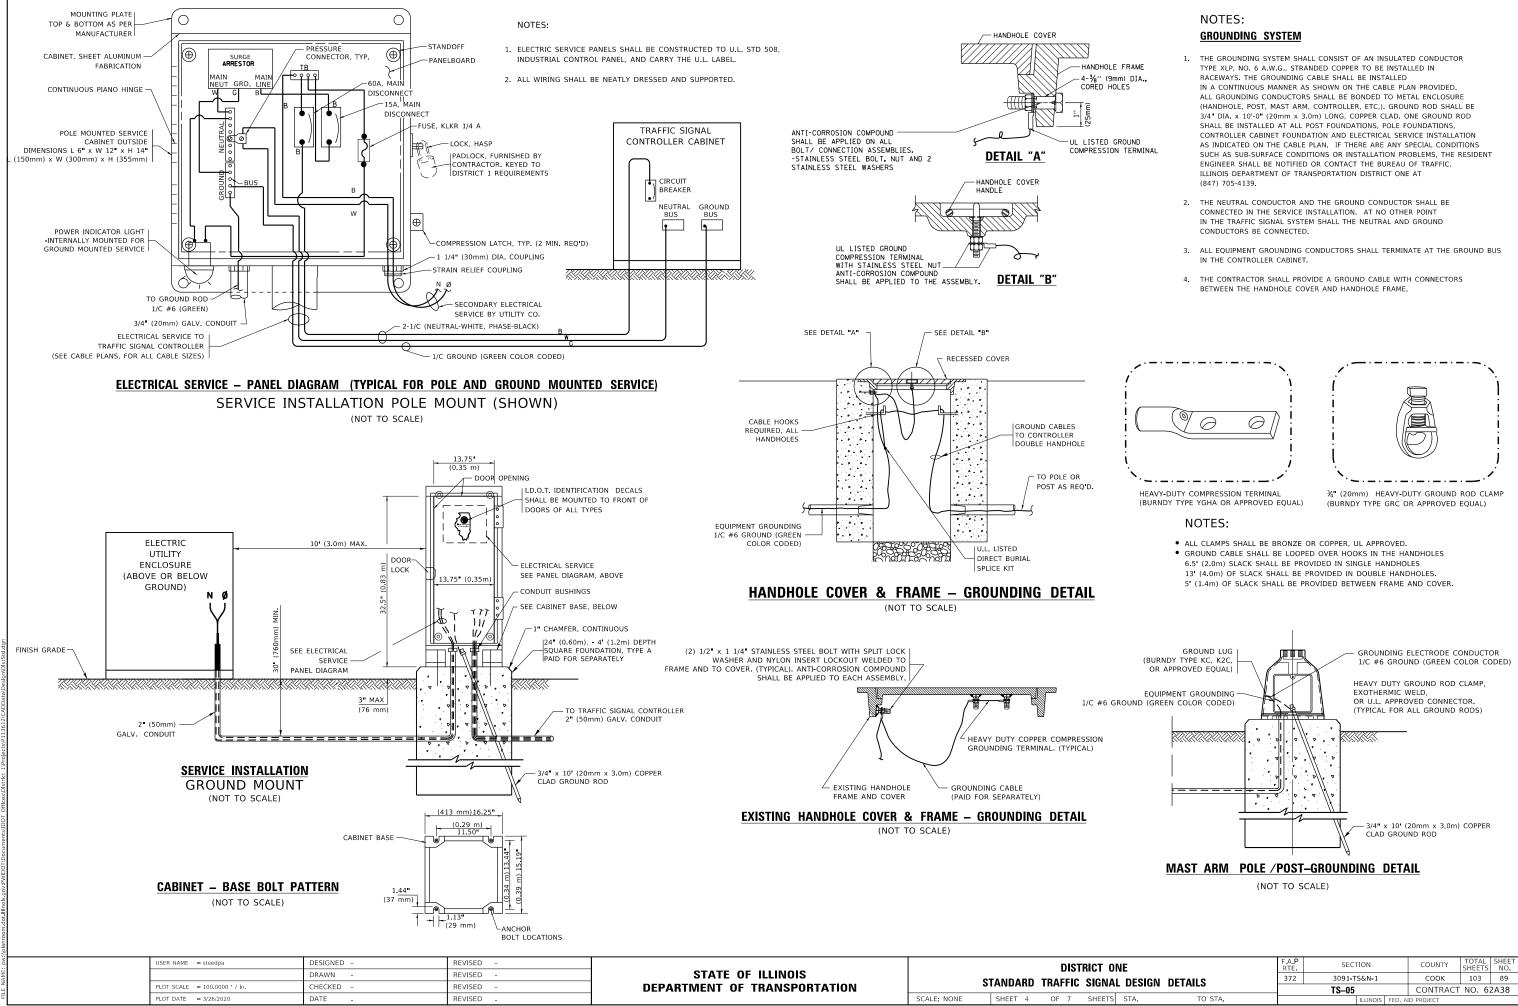

10	NE		F.A.P RTE	.P SECTION			COUNTY	TOTAL SHEETS	SHEET NO.
AL DESIGN DETAILS				3091 - T	S&N-1	соок	103	89	
	. DESIGN	DETAILS		TS05			CONTRACT	NO. 62	2A38
TS	STA.	TO STA.			ILLINOIS	FED. A	ID PROJECT		

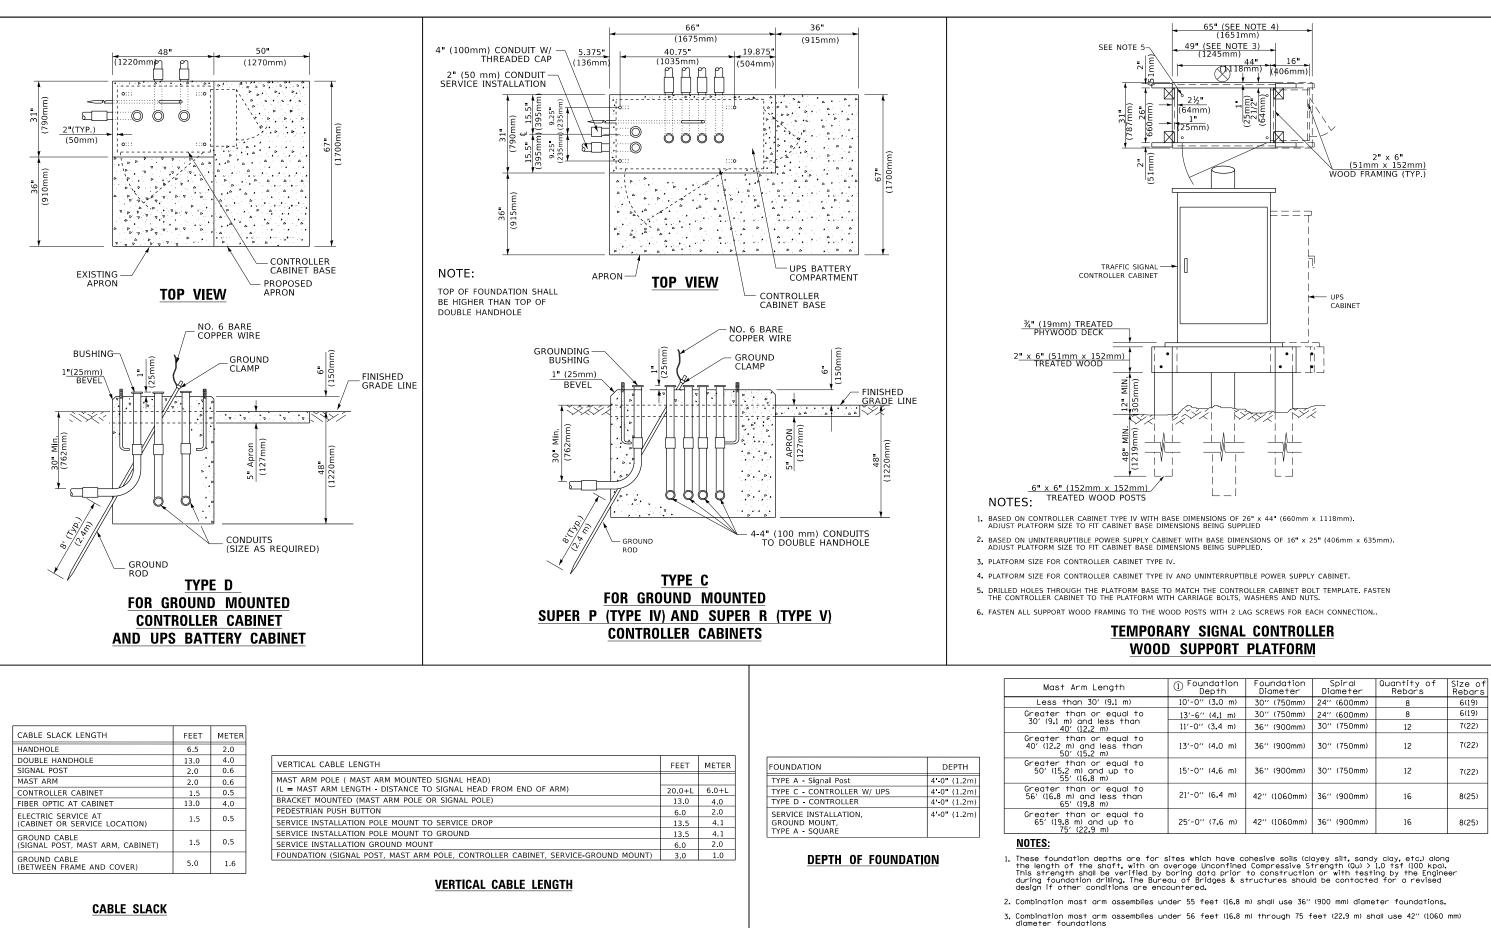


USER NAME = steedpa	DESIGNED -	REVISED -		DISTRICT ONE	F A P RTE	SECTION	COUNTY TOTAL SHEET SHEETS NO.
	DRAWN -	REVISED -	STATE OF ILLINOIS	STANDARD TRAFFIC SIGNAL DESIGN DETAILS	372	3091-TS&N-1	СООК 103 90
PLOT SCALE = 100.0000 ' / in.	CHECKED -	REVISED -	DEPARTMENT OF TRANSPORTATION	STANDAND MAINE SIGNAL DESIGN DETAILS		TS-05	CONTRACT NO. 62A38
PLOT DATE = 3/26/2020	DATE -	REVISED -		SCALE: NONE SHEET 5 OF 7 SHEETS STA. TO STA.		ILLINOIS FE	D. AID PROJECT

ength	① Foundation Depth	Foundation Diameter	Spiral Diameter	Quantity of Rebars	Size of Rebars
′ (9 . 1 m)	10'-0'' (3.0 m)	30" (750mm)	24'' (600mm)	8	6(19)
r equal to	13'-6'' (4.1 m)	30" (750mm)	24'' (600mm)	8	6(19)
less than m)	11'-0'' (3.4 m)	36'' (900mm)	30'' (750mm)	12	7(22)
r equal to less than m)	13'-0'' (4.0 m)	36'' (900mm)	30" (750mm)	12	7(22)
r equal to nd up to m)	15'-0'' (4.6 m)	36'' (900mm)	30'' (750mm)	12	7(22)
r equal to less than m)	21'-0'' (6.4 m)	42'' (1060mm)	36'' (900mm)	16	8(25)
r equal to nd up to m)	25'-0'' (7.6 m)	42'' (1060mm)	36'' (900mm)	16	8(25)


4. For mast arm assemblies with dual arms refer to state standard 878001.

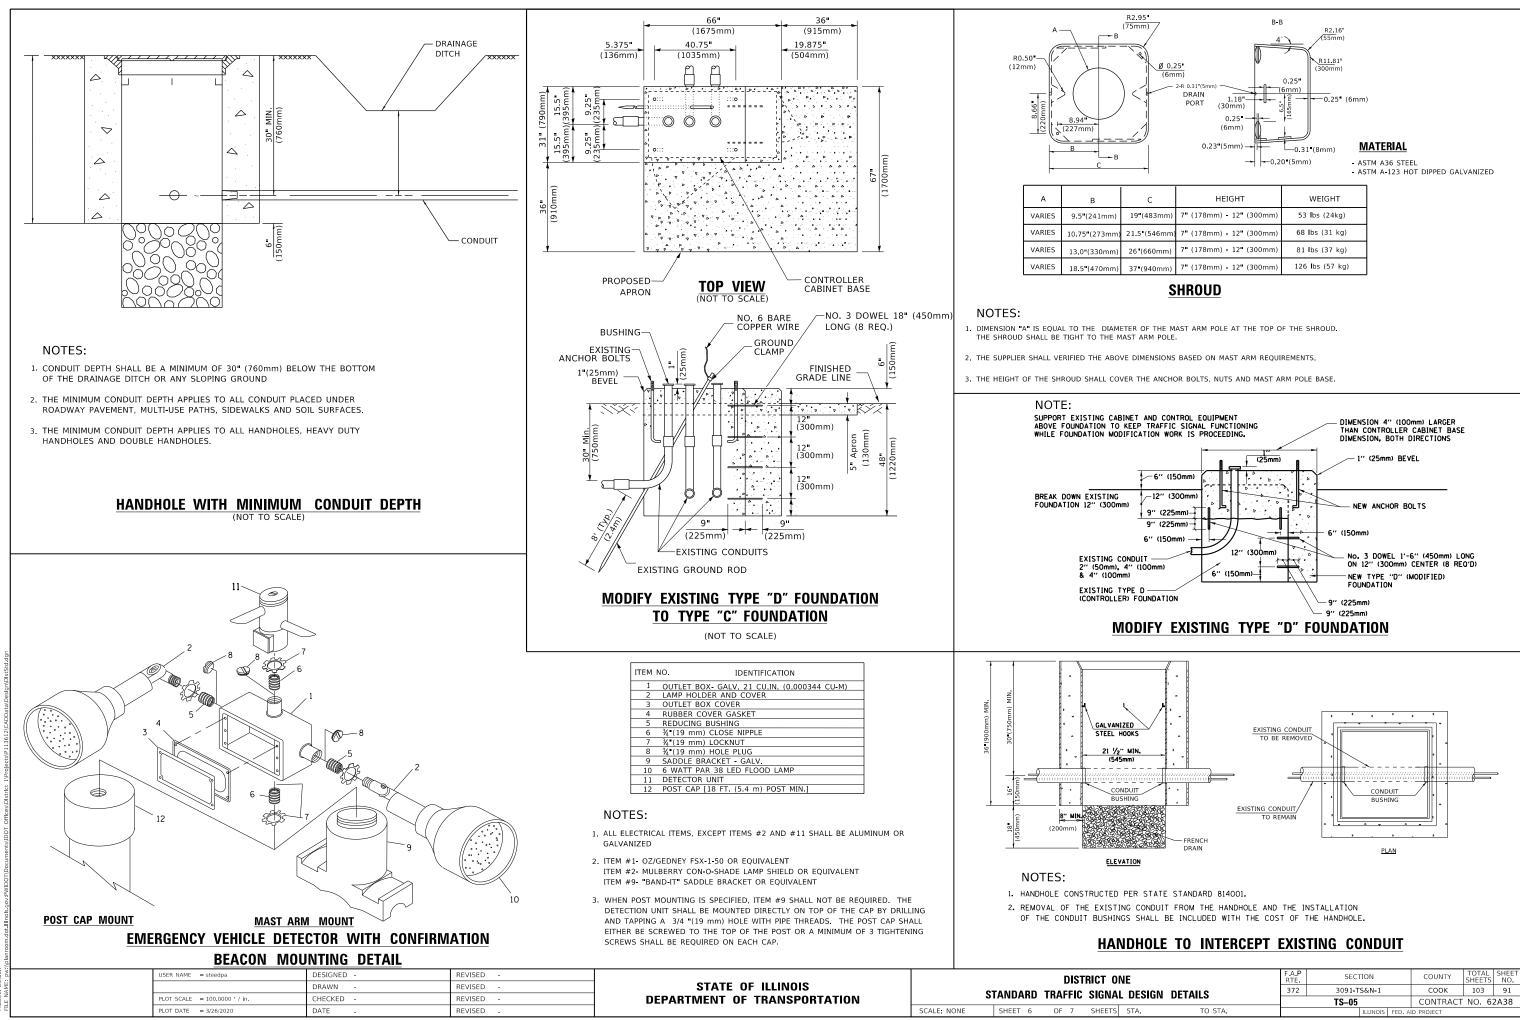DEPTH OF MAST ARM FOUNDATIONS, TYPE E




	с	HEIGHT	WEIGHT
n)	19 " (483mm)	7" (178mm) - 12" (300mm)	53 l bs (24kg)
m)	21.5"(546mm)	7" (178mm) - 12" (300mm)	68 lbs (31 kg)
n)	26"(660mm)	7" (178mm) - 12" (300mm)	81 lbs (37 kg)
m)	37 " (940mm)	7" (178mm) - 12" (300mm)	126 l bs (57 kg)
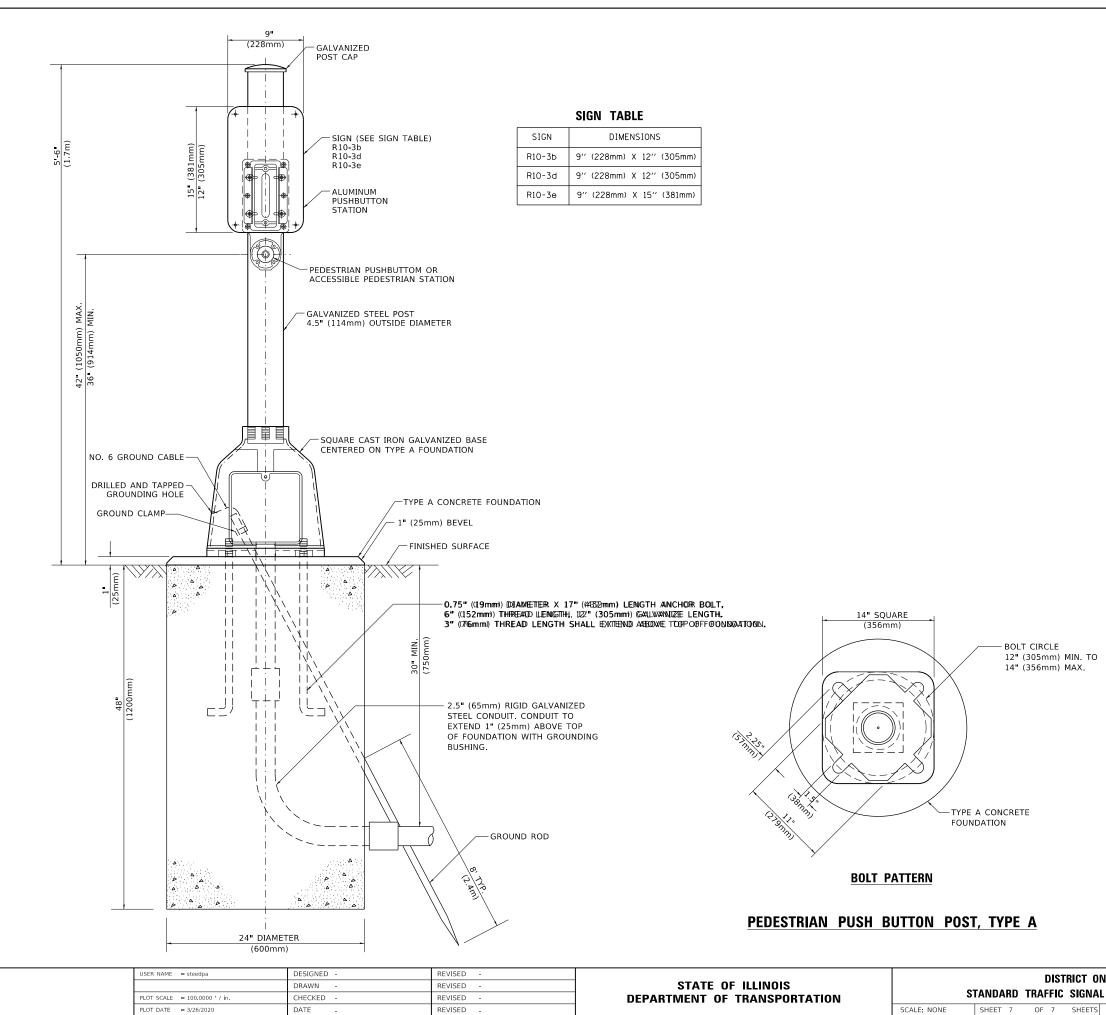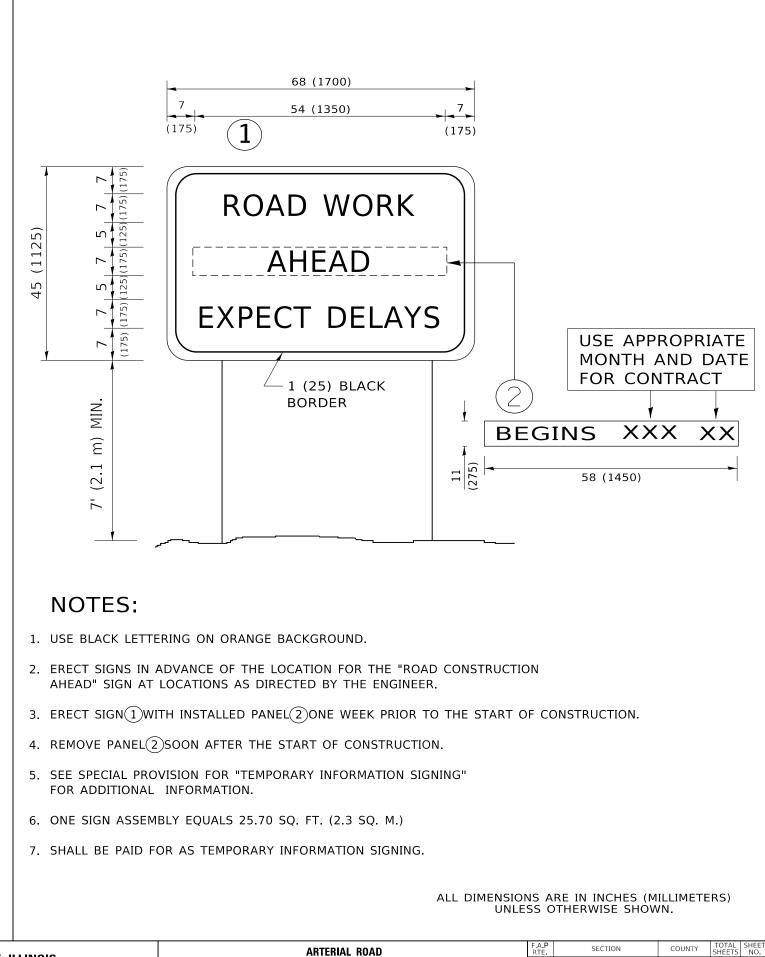
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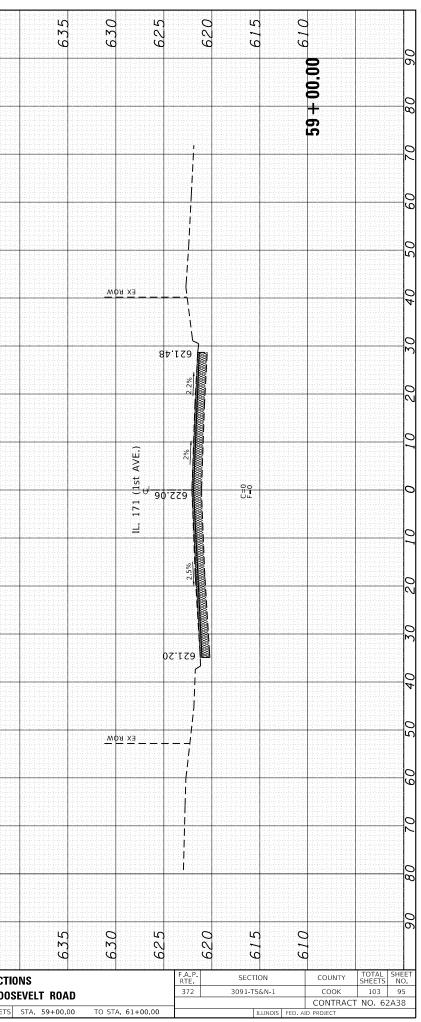


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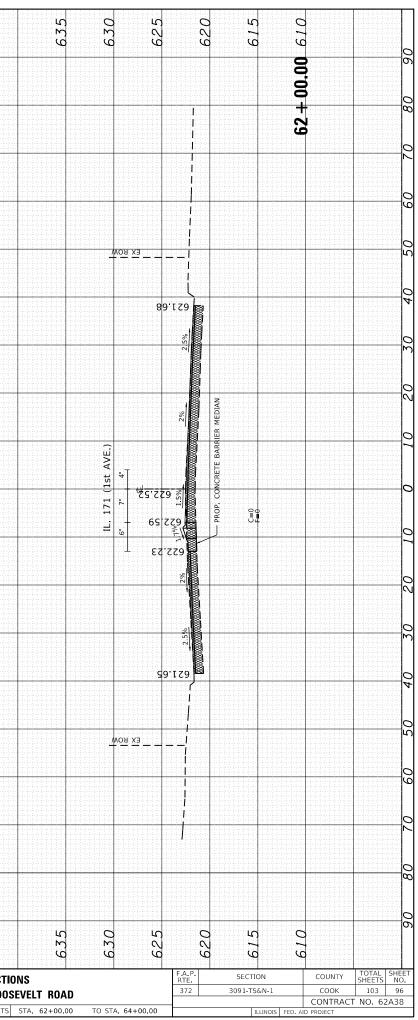
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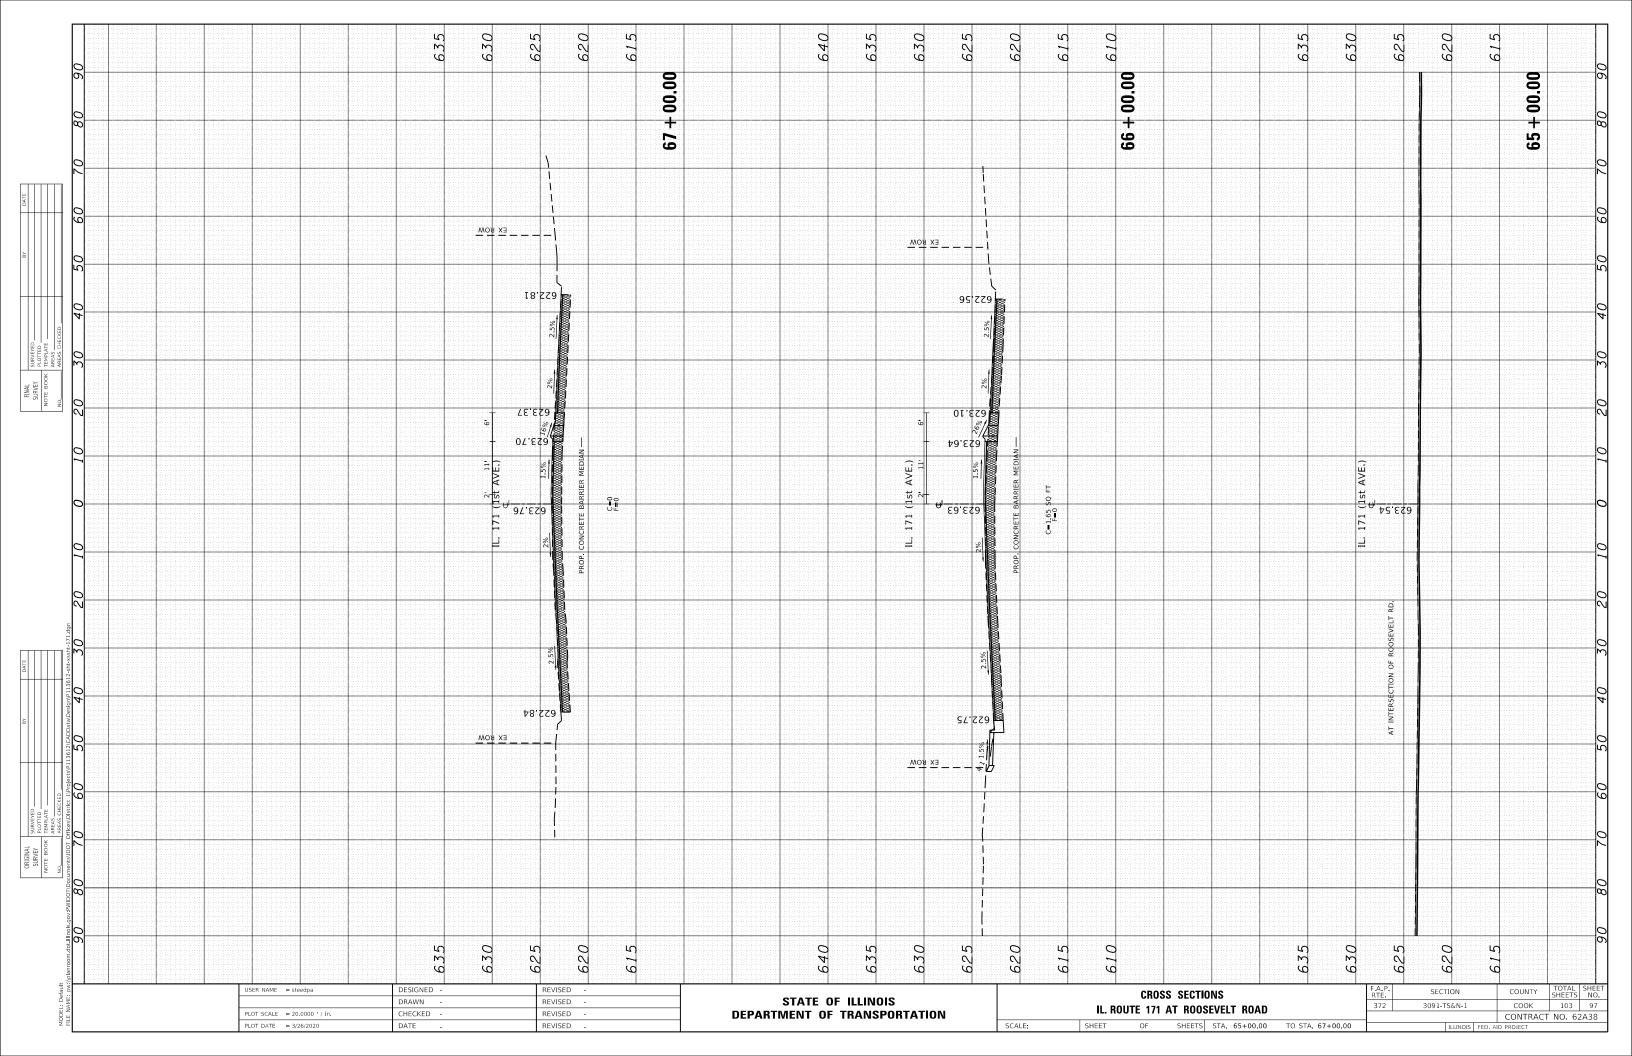
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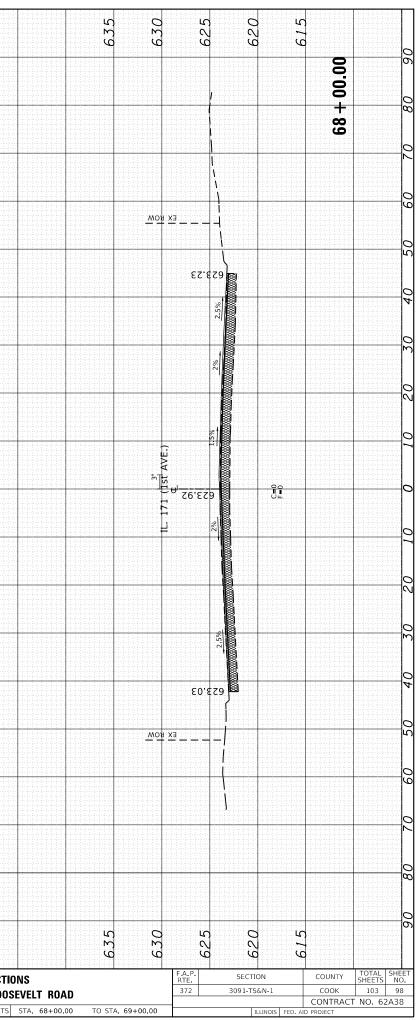


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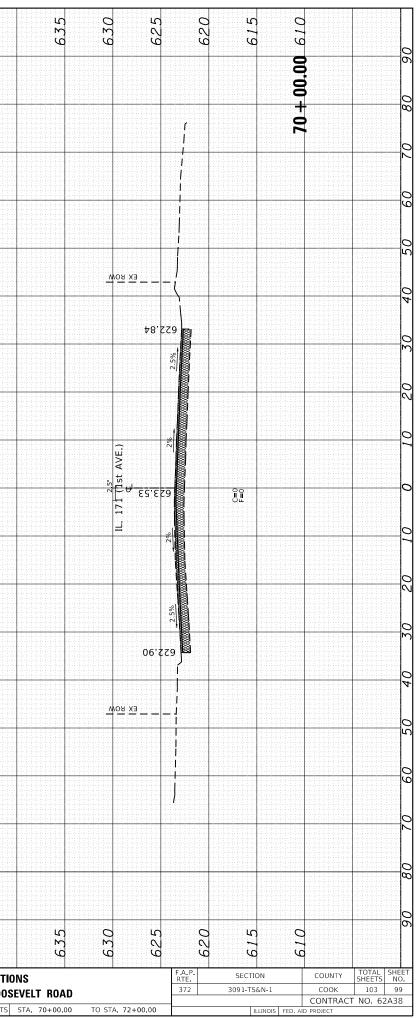


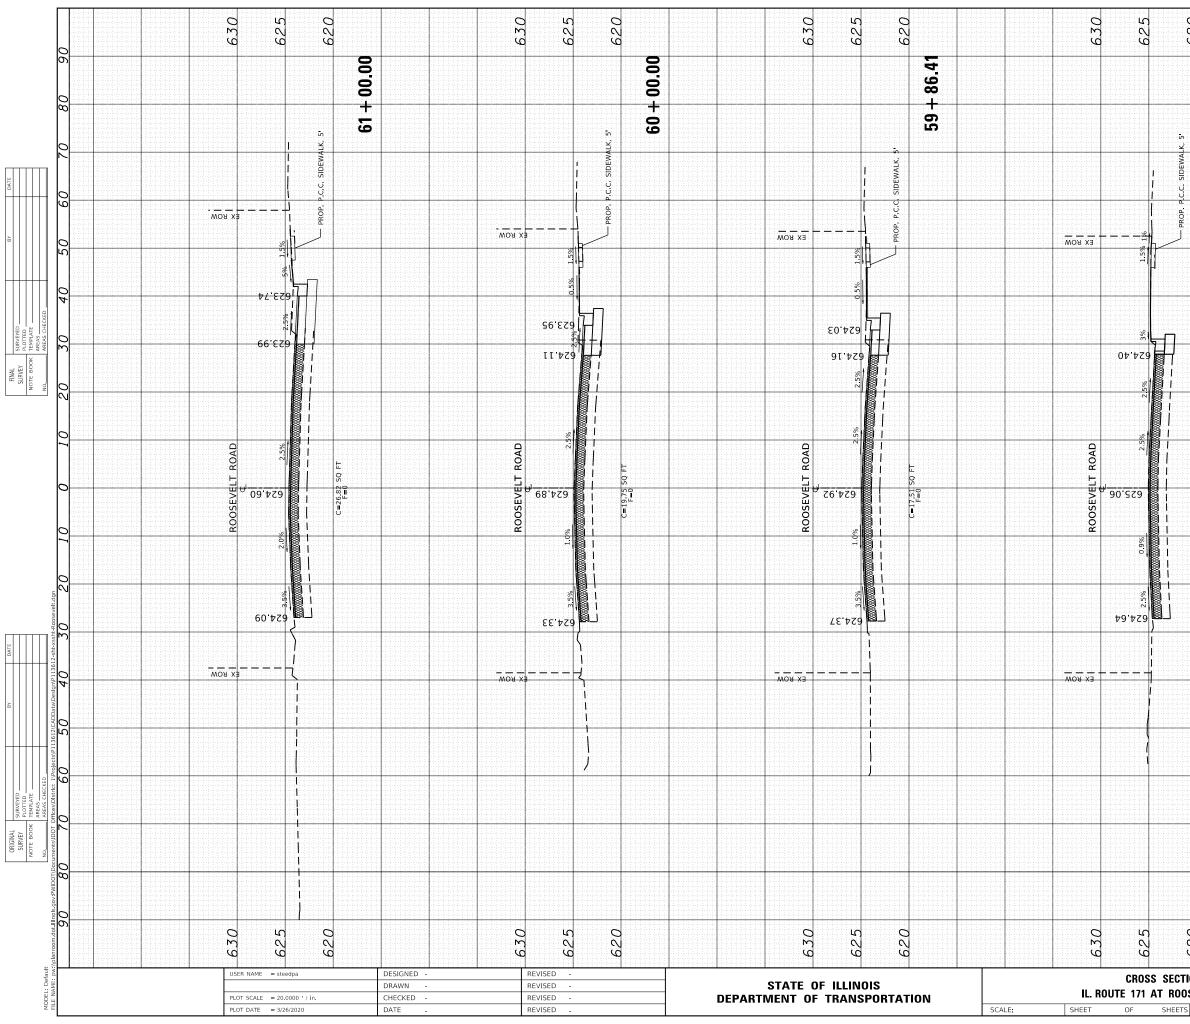


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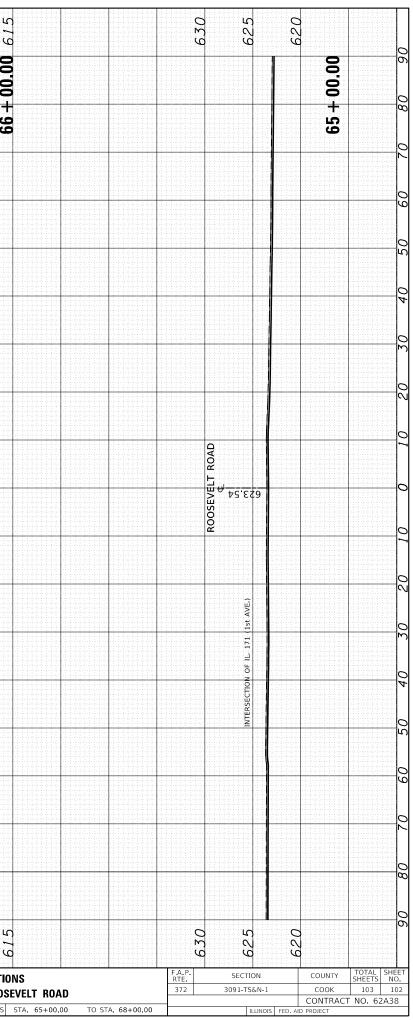
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