ALL WORK SHALL BE PERFORMED IN ACCORDANCE WITH APPLICABLE LAWS AND GOVERNMENT AGENCY REGULATIONS AND RULES; AUTHORITIES HAVING JURISDICTION; OSHA REGULATIONS AND RULES; AND ANY APPLICABLE RULES AND REGULATIONS OF THE STATE OF ILLINOIS OR COOK COUNTY AGENCIES. FURTHERMORE, AND AS RELATED TO THE WORK, THE CONTRACTOR SHALL GIVE NOTICES AND COMPLY WITH APPLICABLE LAWS, ORDINANCES, RULES, REGULATIONS, AND LAWFUL ORDERS OF ALL PUBLIC AUTHORITIES BEARING ON THE SAFETY OF PERSONS OR PROPERTY OR THEIR PROTECTION FROM DAMAGE, INJURY OR LOSS.

ALL TRAFFIC CONTROL AND OTHER ADVISORY SIGNS NEEDED FOR CONSTRUCTION ARE TO BE FURNISHED BY THE CONTRACTOR IN ACCORDANCE WITH SECTION 700 OF THE STANDARD SPECIFICATIONS.

UTILITIES

THE CONTRACTOR SHALL BE RESPONSIBLE FOR CONTACTING THE OWNERS OF ALL EXISTING FACILITIES SO THAT THE UTILITIES AND THEIR APPURTENANCES MAY BE LOCATED AND ADJUSTED OR MOVED, IF NECESSARY, PRIOR TO THE START OF CONSTRUCTION OPERATIONS. THE CONTRACTOR SHALL COOPERATE WITH ALL UTILITY OWNERS AS PROVIDED FOR IN THE STANDARD SPECIFICATIONS.

THE LOCATIONS OF EXISTING DRAINAGE STRUCTURES, STORM AND SANITARY SEWERS, WATER SERVICE LINES AND OTHER UTILITY LINES ARE APPROXIMATE, AND THE ENGINEER DOES NOT GUARANTEE THEIR ACCURACY, THEIR EXACT HORIZONTAL AND VERTICAL LOCATIONS ARE TO BE DETERMINED IN THE FIELD BY THE CONTRACTOR AT HIS OWN EXPENSE.

THE CONTRACTOR SHALL BE RESPONSIBLE FOR THE PROTECTION OF ALL UNDERGROUND OR SURFACE UTILITIES EVEN THOUGH THEY MAY NOT BE SHOWN ON THE PLANS. ANY UTILITY THAT IS DAMAGED DURING CONSTRUCTION SHALL BE REPAIRED OR REPLACED TO THE SATISFACTION OF THE ENGINEER. THIS WORK SHALL BE AT THE CONTRACTOR'S EXPENSE.

COORDINATION OF ALL UTILITY WORK INVOLVED IN THE CONSTRUCTION AREA WILL BE DISCUSSED AT THE PRECONSTRUCTION CONFERENCE.

BEFORE STARTING ANY EXCAVATION, THE CONTRACTOR SHALL CALL "JULIE" AT 800-892-0123 FOR FIELD LOCATIONS OF BURIED ELECTRIC, TELEPHONE, GAS AND CABLE TELEVISION FACILITIES. (48 HOURS NOTIFICATION IS REQUIRED.)

STAKING

UIII

THE CONTRACTOR SHALL PROTECT AND CAREFULLY PRESERVE ALL SECTION OR SUBSECTION MONUMENTS OR PROPERTY OR REFERENCE MARKERS UNTIL THE ENGINEER, HIS AGENT OR AN AUTHORIZED SURVEYOR HAS WITNESSED OR OTHERWISE REFERENCED THEIR LOCATIONS.

ALL RADII FOR PROPOSED CURB AND GUTTER ARE TO THE EDGE OF PAVEMENT UNLESS OTHERWISE NOTED, AND SHALL BE AS INDICATED ON THE PLANS, ELEVATIONS SHOWN AT POINT OF CURVE, ETC. IS EDGE OF PAVEMENT UNLESS OTHERWISE NOTED.

WATER, STORM SEWER AND SANITARY SEWER

WHENEVER DURING CONSTRUCTION OPERATIONS ANY LOOSE MATERIAL IS DEPOSITED IN THE FLOW LINE OF DRAINAGE STRUCTURES SUCH THAT THE NATURAL FLOW OF WATER IS OBSTRUCTED, IT SHALL BE REMOVED AT THE CLOSE OF EACH WORKING DAY. AT THE CONCLUSION OF CONSTRUCTION OPERATIONS, ALL UTILITY STRUCTURES SHALL BE FREE FROM DIRT AND DEBRIS. THE WORK SPECIFIED ABOVE WILL NOT BE PAID FOR SEPARATELY BUT SHALL BE COMPLETED PER ARTICLE 107.15 OF THE STANDARD SPECIFICATIONS.

ANY EXISTING OR PROPOSED STORM SEWER DAMAGED BY THE CONTRACTOR DURING CONSTRUCTION SHALL BE REPLACED BY THE CONTRACTOR AT THEIR EXPENSE.

THE CONTRACTOR SHALL NOT OPEN OR SHUT ANY WATER VALVES OR FIRE HYDRANTS WITHOUT PRIOR AUTHORIZATION FROM THE CITY WATER DEPARTMENT. UNAUTHORIZED USE SHALL SUBJECT THE OFFENDER TO ARREST AND PROSECUTION.

COST TO CONNECT EXISTING OR PROPOSED STORM SEWER TO EXISTING OR PROPOSED DRAINAGE STRUCTURE SHALL BE INCLUDED IN THE COST FOR STORM SEWER.

CONTRACTOR SHALL PROVIDE STRUCTURE LAYOUT INFORMATION TO THE ENGINEER PRIOR TO ORDERING ALL PROPOSED DRAINAGE STRUCTURES. THIS INFORMATION WILL BE DETERMINED IN THE FIELD WITH THE ENGINEER. COST TO DO THIS INVESTIGATIVE WORK SHALL BE INCLUDED IN THE COST FOR THE DRAINAGE STRUCTURE.

GENERAL NOTES

- THE CITY OF NORTHLAKE AND ENGINEER SHALL BE NOTIFIED BY THE CONTRACTOR IN WRITING AT LEAST (3) FULL WORKING DAYS PRIOR TO COMMENCEMENT OF CONSTRUCTION.
- 2. THE CONTRACTOR SHALL PROVIDE ALL NECESSARY PROTECTION FOR EXISTING UTILITIES IN CONFORMANCE WITH THE AFFECTED UTILITY COMPANIES' REQUIREMENTS AS MAY BE REQUIRED TO PERFORM THE WORK OF THIS CONTRACT.
- 3. BEFORE BEGINNING CONSTRUCTION, THE CONTRACTOR SHALL VERIFY THE LINE AND GRADES SHOWN ON THE CONTRACT DRAWINGS. IF THERE ARE ANY DISCREPANCIES FROM WHAT IS SHOWN ON THE CONTRACT DRAWINGS, THE CONTRACTOR SHALL IMMEDIATELY REPORT SAME TO THE ENGINEER PRIOR TO PERFORMING WORK. CONTRACTOR SHALL BE RESPONSIBLE FOR COORDINATION OF WORK AS REQUIRED.
- 4. THE CONTRACT DOCUMENTS ARE NOT INTENDED TO SHOW EVERY AND ALL DETAILS OF WORK TO BE PERFORMED OR EQUIPMENT TO BE SUPPLIED. THE INTENT OF THE CONTRACT DOCUMENTS IS TO ILLUSTRATE THE CONCEPTUAL DESIGN AND LAYOUT. THE CONTRACTOR SHALL BE KNOWLEDGEABLE AND REGULARLY ENGAGED IN THE TYPE OF WORK DESCRIBED BY THESE CONTRACT DOCUMENTS, AND SHALL BE RESPONSIBLE FOR UNDERSTANDING THEIR INTENT. ADDITIONAL WORK TO BE PERFORMED OR ITEM OF EQUIPMENT TO BE SUPPLIED WHICH IS NOT SPECIFICALLY CALLED FOR BY THESE CONTRACT DOCUMENTS BUT WHICH IS NECESSARY TO PROVIDE A COMPLETE AND SUCCESSFUL WORKING SYSTEM SHALL BE INCLUDED IN ACCORDANCE WITH ARTICLE 109.04.
- 5. IT IS THE CONTRACTOR'S RESPONSIBILITY TO DETERMINE ALL MATERIAL OUANTITIES AND APPRAISE HIMSELF/HERSELF OF ALL CONDITIONS. NO CLAIMS FOR ADDITIONAL COMPENSATION FOR INDIVIDUAL PAY ITEMS WILL BE RECOGNIZED DUE TO THE CONTRACTOR'S FAILURE TO UNDERSTAND THE SCOPE OF WORK.
- 6. THE WORK PERFORMED UNDER THIS CONTRACT SHALL IN NO WAY INTERFERE WITH THE NORMAL OPERATION OF ANY EXISTING UTILITY SERVICE. THE CONTRACTOR SHALL FURNISH ALL NECESSARY ITEMS OF EQUIPMENT REQUIRED TO MAINTAIN SUCH NORMAL OPERATION AT NO ADDITIONAL COST TO THE OWNER. THE COST ASSOCIATED FOR THIS WORK SHALL BE CONSIDERED INCLUDED IN THE COST OF THE CONTRACT.
- 7. CERTAIN INFORMATION SHOWN ON THESE DRAWINGS HAS BEEN OBTAINED FROM DRAWINGS OF RECORD. CONTRACTOR SHALL VERIFY SUCH INFORMATION PRIOR TO ACTUAL START OF WORK. WHERE DISCREPANCIES ARE DISCOVERED THE CONTRACTOR SHALL IMMEDIATELY NOTIFY THE ENGINEER. FAILURE BY THE CONTRACTOR TO IMMEDIATELY NOTIFY THE ENGINEER OF SUCH DISCREPANCIES SHALL RESULT IN THE CONTRACTOR BEARING THE FULL BURDEN OF ALL RISKS/COSTS ATTRIBUTED TO THE DISCOVERED DESCREPANCY.
- 8. SOIL EROSION PROTECTION SHALL BE IN ACCORDANCE WITH IEPA STANDARDS AND SPECIFICATIONS FOR SOIL EROSION AND SEDIMENT CONTROL. ALL DISTURBED AREAS (NOT IMPERVIOUS IN NATURE) SHALL BE FINE GRADED, TOPSOIL RESTORED (MIN 4 INCHES) AND SEED/MULCH APPLIED UNLESS OTHERWISE SPECIFIED ON THE PLANS.
- 9. ALL REMOVAL OR EXCAVATION ITEMS BEING DISPOSED OF AT AN UNCONTAMINATED SOIL FILL OPERATION OR CLEAN CONSTRUCTION AND DEMOLITION DEBRIS (CCDD) FILL SITE SHALL MEET THE REQUIREMENTS OF PUBLIC ACT 96-1416. ALL COSTS ASSOCIATED WITH MEETING THESE REQUIREMENTS SHALL BE INCLUDED IN THE UNIT PRICE COST FOR THE ASSOCIATED REMOVAL OR EXCAVATION ITEMS IN THE CONTRACT. THESE COSTS SHALL INCLUDE, BUT ARE NOT LIMITED TO, COMPLETING THE ILLINOIS ENVIRONMENTAL PROTECTION AGENCY FORM LPC 663, ALL REQUIRED TESTING, LAB ANALYSIS, CERTIFICATION BY A LICENSED PROFESSIONAL ENGINEER, AND STATE OR LOCAL TIPPING FEES.

MISCELLANEOUS

ACCESS: THE CONTRACTOR SHALL PROVIDE ACCESS TO ABUTTING PROPERTY AT ALL TIMES DURING THE CONSTRUCTION OF THIS PROJECT, EXCEPT FOR PERIODS OF SHORT DURATION. THE COST TO PROVIDE ACCESS SHALL BE PAID FOR AND INCLUDED IN THE PAY ITEM AGGREGATE FOR TEMPORARY ACCESS.

DIMENSIONS: IT SHALL BE THE CONTRACTOR'S RESPONSIBILITY TO VERIFY ALL DIMENSIONS AND CONDITIONS EXISTING IN THE FIELD PRIOR TO ORDERING MATERIALS AND BEGINNING CONSTRUCTION.

ALL SAWCUTTING SHALL BE INCLUDED TO REMOVAL ITEMS AND SHALL BE PERFORMED PRIOR TO BEGINNING REMOVAL. ANY ITEMS OF WORK REMOVED PRIOR TO SAWCUTTING WILL NOT BE MEASURED FOR PAYMENT.

DETECTABLE WARNINGS FOR THE DISABLED SHALL BE INSTALLED AT ALL INTERSECTING STREETS, COMMERCIAL DRIVEWAYS, AND ALLEYS AS SHOWN ON THE PLANS (SEE IDOT STD. 424201).

RELOCATING EXISTING SIGNS: EXISTING SIGNS WHICH ARE IN CONFLICT WITH PROPOSED IMPROVEMENTS SHALL BE REMOVED AND REINSTALLED UPON COMPLETION OF CONFLICTING IMPROVEMENTS IN ACCORDANCE WITH THE ILLINOIS DEPARTMENT OF TRANSPORTATION "MANUAL OF UNIFORM TRAFFIC CONTROL DEVICES" AND THE "STANDARD SPECIFICATIONS FOR ROAD AND BRIDGE CONSTRUCTION". STOP SIGNS, SPEED LIMIT SIGNS, AND STREET NAME SIGNS SHALL BE UP AND VISIBLE AT ALL TIMES. THIS WORK SHALL BE PERFORMED PER ARTICLE 107.25 OF THE STANDARD SPECIFICATIONS.

PER ARTICLE 107.20, MAILBOXES WHICH ARE IN CONFLICT WITH PROPOSED IMPROVEMENTS SHALL BE REMOVED, TEMPORARILY RELOCATED, AND REPLACED UPON COMPLETION OF THE PROPOSED IMPROVEMENTS AS DIRECTED BY THE ENGINEER.

PROPOSED CONCRETE CURB AND GUTTER SHALL BE TRANSITIONED TO EXISTING CURB AND GUTTER OVER A LENGTH OF 5 FEET. THIS WORK SHALL BE PAID FOR AT THE CONTRACT UNIT PRICE PER FOOT FOR COMBINATION CONCRETE CURB AND GUTTER. THE HMA SURFACE COURSE USED TO REPLACE DRIVEWAYS WILL BE PAID FOR PER TON.

PROTECTIVE COAT FOR ALL CONCRETE SURFACES SHALL BE CONSIDERED INCLUDED IN THE COST OF THE RESPECTIVE PAY ITEM.

ANY DEFACED WORK SHALL BE CORRECTED OR REPLACED BY THE CONTRACTOR AT HIS SOLE EXPENSE PRIOR TO FINAL PAYMENT. THE CITY WILL COOPERATE WITH THE CONTRACTOR TO MINIMIZE VANDALISM. BUT THE CONTRACTOR SHALL BE ULTIMATELY RESPONSIBLE TO CORRECT ANY DAMAGE PER CONDITIONS OF ARTICLE 107.30 OF THE STANDARD SPECIFICATIONS.

THE CONTRACTOR SHALL BE SOLELY RESPONSIBLE FOR JOB SITE SAFETY AS WELL AS SUPERVISION / DIRECTION AND MEANS / METHODS OF CONSTRUCTION.

THE CONTRACTOR SHALL CONTACT THE IDOT TRAFFIC CONTROL SUPERVISOR AT (847) 705-4470 A MINIMUM OF 72 HOURS IN ADVANCE OF BEGINNING WORK.

THE LANE CLOSURES ON IL 64 (NORTH AVENUE) WILL ONLY BE ALLOWED WHEN NECESSARY BETWEEN THE HOURS OF 9:00 A.M. AND 3:00 P.M.

THE GENERAL CONTRACTOR IS REQUIRED TO HIRE AN ENVIRONMENTAL FIRM TO CONTINUOUSLY MONITOR FOR WORKER SAFETY AND SOIL CONTAMINATION AT SEVERAL LOCATIONS. SEE SPECIAL PROVISION AND SUPPLEMENTAL SPECIFICATIONS FOR DETAILS.

DISTRICT ONE STANDARDS

- BD-22 PAVEMENT PATCHING FOR HMA SURFACED PAVEMENT
- TC-10 TRAFFIC CONTROL AND PROTECTION FOR SIDE ROADS, INTERSECTIONS, AND DRIVEWAYS
- TC-13 DISTRICT ONE TYPICAL PAVEMENT MARKINGS

- TC-22 ARTERIAL ROAD INFORMATION SIGN
- TS-05 STANDARD TRAFFIC SIGNAL DESIGN DETAILS
- TS-07 DETECTOR LOOP INSTALLATION DETAILS FOR ROADWAY RESURFACING
- BD-32 BUTT JOINT AND HMA TAPER DETAILS

HIGHWAY STANDARDS

- 000001-06 STANDARD SYMBOLS, ABBREVIATIONS, AND PATTERNS
- 424001-07 PERPENDICULAR CURB RAMPS FOR SIDEWALK
- 442201-03 CLASS C AND D PATCHES
- 602001-02 CATCH BASIN TYPE A
- 602011-02 CATCH BASIN TYPE C
- 604001-03 FRAME AND LIDS TYPE 1
- 606001-05 CONCRETE CURB TYPE B AND COMBINATION CONCRETE CURB AND GUTTER
- 701006-05 OFF-RD OPERATIONS, 2L, 2W, 15' (4.5M) TO 24" (600MM) FROM PAVEMENT EDGE
- 701101-04 OFF-RD OPERATIONS, MULTILANE, 15' (4.5M) TO 24" (600MM) FROM PAVEMENT EDGE
- 701301-04 LANE CLOSURE, 2L, 2W, SHORT TIME OPERATIONS
- 701311-03 LANE CLOSURE, 2L, 2W, MOVING OPERATIONS- DAY ONLY
- 701427-02 LANE CLOSURE, MULTILANE, INTERMITTEN OR MOVING OPER.,
- FOR SPEEDS 4 40 MPH
- 701501-06 URBAN LANE CLOSURE, 2L, 2W UNDIVIDED
- 701601-09 URBAN LANE CLOSURE, MULTILANE, 1W OR 2W, WITH NONTRAVERSABLE MEDIAN
- 701701-09 URBAN LANE CLOSURE, MULTILANE INTERSECTION
- 701801-05 SIDEWALK, CORNER OR CROSSWALK CLOSURE
- 701901-03 TRAFFIC CONTROL DEVICES
- 780001-04 TYPICAL PAVEMENT MARKINGS
- 886001-01 DETECTOR LOOP INSTALLATIONS
- 886006-01 TYPICAL LAYOUTS FOR DETECTION LOOPS

FILE NAME =	USER NAME = apufundt	DESIGNED -	REVISED - 6/2/14	
N:\NORTHLAKE\940032HR - Municipal Review	Projects\940032 HR 200's\940032HR219\Civil	NDRAWN032HR219.sht	REVISED -	
	PLOT SCALE = NOT TO SCALE	CHECKED ~	REVISED ~	
Default	PLOT DATE = 6/2/2014	DATE -	REVISED -	

STATE OF ILLINOIS
DEPARTMENT OF TRANSPORTATION

SCALE: N.T.S.

SHEET 2

GENERA	L NOTES	S AND		F.A.P. RTE.	SECTION	COUNTY	TOTAL	SHEET NO.
HIGHWA	V CTAN	DARDS		307	13-00085-00-CH	COOK	34	2
IIIdiivv	II STAIN	DANDS				CONTRACT	NO. 6	51A43
OF 34	SHEETS	STA.	TO STA.		ILLINOIS FED.	AID PROJECT		

SUMMARY OF QUANTITIES UNIT 20201200 REMOVAL AND DISPOSAL OF UNSUITABLE MATERIAL CU YD 20800150 TRENCH BACKFILL 21001000 GEOTECHNICAL FABRIC FOR GROUND STABILIZATION SQ YD 25000110 SEEDING, CLASS 1A 25000400 NITROGEN FERTILIZER NUTRIENT POUND 25000500 PHOSPHORUS FERTILIZER NUTRIENT POUND 25000600 POTASSIUM FERTILIZER NUTRIENT POUND 25100630 EROSION CONTROL BLANKET SQ YD 28000510 INLET FILTERS EACH 30300001 AGGREGATE SUBGRADE IMPROVEMENT CU YD 31101100 SUBBASE GRANULAR MATERIAL, TYPE B 35102000 AGGREGATE BASE COURSE, TYPE B 8" SQ YD 40201000 AGGREGATE FOR TEMPORARY ACCESS TON 40600400 MIXTURE FOR CRACKS, JOINTS, AND FLANGEWAYS TON 40600625 LEVELING BINDER (MACHINE METHOD), N50 TON 40600982 HOT-MIX ASPHALT SURFACE REMOVAL - BUTT JOINT 40603080 HOT-MIX ASPHALT BINDER COURSE, IL-19.0, N50 TON 40603335 HOT-MIX ASPHALT SURFACE COURSE, MIX "D", N50 TON 42400200 PORTLAND CEMENT CONCRETE SIDEWALK 5 INCH 42400400 PORTLAND CEMENT CONCRETE SIDEWALK 7 INCH

42400800 DETECTABLE WARNINGS

44000158 HOT-MIX ASPHALT SURFACE REMOVAL, 2 1/4"

44000500 COMBINATION CURB AND GUTTER REMOVAL

44201761 CLASS D PATCHES, TYPE I, 10 INCH

550A0040 STORM SEWERS, CLASS A, TYPE 1 10"

550A0430 STORM SEWERS, CLASS A, TYPE 2 30"

55100300 STORM SEWER REMOVAL 8"

55100400 STORM SEWER REMOVAL 10"

55100500 STORM SEWER REMOVAL 12"

55101400 STORM SEWER REMOVAL 30"

★ 56103000 DUCTILE IRON WATER MAIN 6"

★ 56400500 FIRE HYDRANTS TO BE REMOVED

44300100 AREA REFLECTIVE CRACK CONTROL TREATMENT

* 56400820 FIRE HYDRANT WITH AUXILIARY VALVE AND VALVE BOX

56500600 DOMESTIC WATER SERVICE BOXES TO BE ADJUSTED

60206905 CATCH BASINS, TYPE C, TYPE 1 FRAME, OPEN LID

60200105 CATCH BASINS, TYPE A, 4'-DIAMETER, TYPE 1 FRAME, OPEN LID

60221100 MANHOLES, TYPE A, 5'-DIAMETER, TYPE 1 FRAME, CLOSED LID

44000100 PAVEMENT REMOVAL

44000600 SIDEWALK REMOVAL

44201297 DOWEL BARS 1"

O B

SUMMARY OF QUANTITIES STP TOTAL QUANTITY CONSTRUCTION TYPE CODE 0004

690

55

1555

0.2

18

700

19

560

185

3562

300

100

111

38

945

505

4440

60

75

4060

2050

1890

5160

1250

140

5470

39

20

22

12

28

SQ FT

SQ YD

SQ YD

FOOT

SQ FT

EACH

SQ YD

SQ YD

FOOT

FOOT

FOOT

FOOT

FOOT

FOOT

FOOT

EACH

EACH

EACH

EACH

			SUMMARY OF QUANTITIES	
-	Τ	CODE NO.	ITEM	UNIT
E	1	60250400	CATCH BASINS TO BE ADJUSTED WITH NEW TYPE 1 FRAME, OPEN LID	EACH
E	+	60250500	CATCH BASINS TO BE ADJUSTED WITH NEW TYPE 1 FRAME, CLOSED LID	EACH
-		60252800	CATCH BASINS TO BE RECONSTRUCTED	EACH
F	+	60406000	FRAMES AND LIDS, TYPE 1, OPEN LID	EACH
F	Ŧ	60406100	FRAMES AND LIDS, TYPE 1, CLOSED LID	EACH
F	+	60603800	COMBINATION CONCRETE CURB AND GUTTER, TYPE B-6.12	FOOT
F	Ŧ	60605000	COMBINATION CONCRETE CURB AND GUTTER, TYPE B-6.24	FOOT
4	7	66900200	NON-SPECTAL WASTE DTSPOSAL MOBILIZATION	Cayo
¢	*	66900450	SPECIAL WASTE PLANS AND REPORTS TRAFFIC CONTROL AND PROTECTION, STANDARD 701501	LSUN
¢	1	66900530	SOIL DISPOSAL ANALYSIS TRAFFIC CONTROL AND PROTECTION, STANDARD 701801	EACH
þ	+			LSUN
t	+		TRAFFIC CONTROL AND PROTECTION, STANDARD 701701	LSUN
E	+		TRAFFIC CONTROL AND PROTECTION, STANDARD 701801	LSUN
E	+	70103815	TRAFFIC CONTROL SURVEILLANCE	CAL D
F	Ŧ	72000100	SIGN PANEL - TYPE 1	SQF
F	Ŧ	72900100	METAL POST - TYPE A	FOO'
F		78000200	THERMOPLASTIC PAVEMENT MARKING - LINE 4"	F00
F	*	78000400	THERMOPLASTIC PAVEMENT MARKING - LINE 6"	FOO
Ė	•	78000650	THERMOPLASTIC PAVEMENT MARKING - LINE 24"	F00
E		80400100	ELECTRIC SERVICE INSTALLATION	EACH
t	*	81028160	UNDERGROUND CONDUIT, GALVANIZED STEEL, 3/4" DIA.	FOO
E		81702450	ELECTRIC CABLE IN CONDUIT, 600V (XLP - TYPE USE) 3-1/C NO. 10	F001
~		85000200	MAINTENANCE OF EXISTING TRAFFIC SIGNAL INSTALLATION	EACH
E		87900200	DRILL EXISTING HANDHOLE	EACH
-	٠	88600600	DETECTOR LOOP REPLACEMENT	F001
-		89502300	REMOVE EXISTING CABLE FROM CONDUIT	F001
F		89502376	REBUILD EXISTING HANDHOLE	EACH
~		X0323710	REMOVE CONDUIT ATTACHED TO STRUCTURE	F001
-	F	X0696100	PARKING BLOCKS	EACH
-	-		TOPSOIL FURNISH AND PLACE, SPECIAL	CU YE
F	F		NON-TRACKING BITUMINOUS MATERIALS (PRIME COAT)	POUN
-	F		PORTLAND CEMENT CONCRETE SIDEWALK 5 INCH, SPECIAL	
-			WATER MAIN REMOVAL, 6"	SQ F
Ė				F001
Ē	*		SANITARY MANHOLES TO BE RECONSTRUCTED WITH NEW TYPE 1 FRAME, CLOSED LID	EACH
_		1/	CONCRETE BOLLARDS	EACH
_			BOLLARDS	EACH
H	-	Z0013798	CONSTRUCTION LAYOUT	L SUN
-	F	Z0018400	DRAINAGE STRUCTURES TO BE ADJUSTED	EACH
=	F	Z0018700	DRAINAGE STRUCTURES TO BE REMOVED	EACH
~	F	Z0030850	TEMPORARY INFORMATION SIGNING	SQ FT
~		Z0076600	TRAINEES	HOUR
~	+	Z0076604	TRAINEES TRAINING PROGRAM GRADUATE	HOUR

SCALE: N.T.S. SHEET 3

FILE NAME =	USER NAME = apufundt	DESIGNED -	REVISED - 6/2/14 A
N:\NORTHLAKE\940032HR - Municipal Review	Projects\940032 HR 200's\940032HR219\Civil	ODRAWN032HR219.sht	REVISED -
	PLOT SCALE = NOT TO SCALE	CHECKED -	REVISED -
Default	PLOT DATE = 4/10/2014	DATE -	REVISED -

STATE OF ILLINOIS DEPARTMENT OF TRANSPORTATION

	F.A.P. RTE.	SECTION	COUNTY	TOTAL	SHEET NO.
SUMMARY OF QUANTITIES	307	13-00085-00-CH	COOK	34	3
			CONTRACT	NO. 6	1A43
3 OF 34 SHEETS STA. TO STA.		TILL TNOTS FED	ATO PROJECT		

45

1000

1000

STP

TOTAL QUANTITY

CONSTRUCTION

TYPE CODE

0004

2450

1820)

105

1580

445

125

130

160

240


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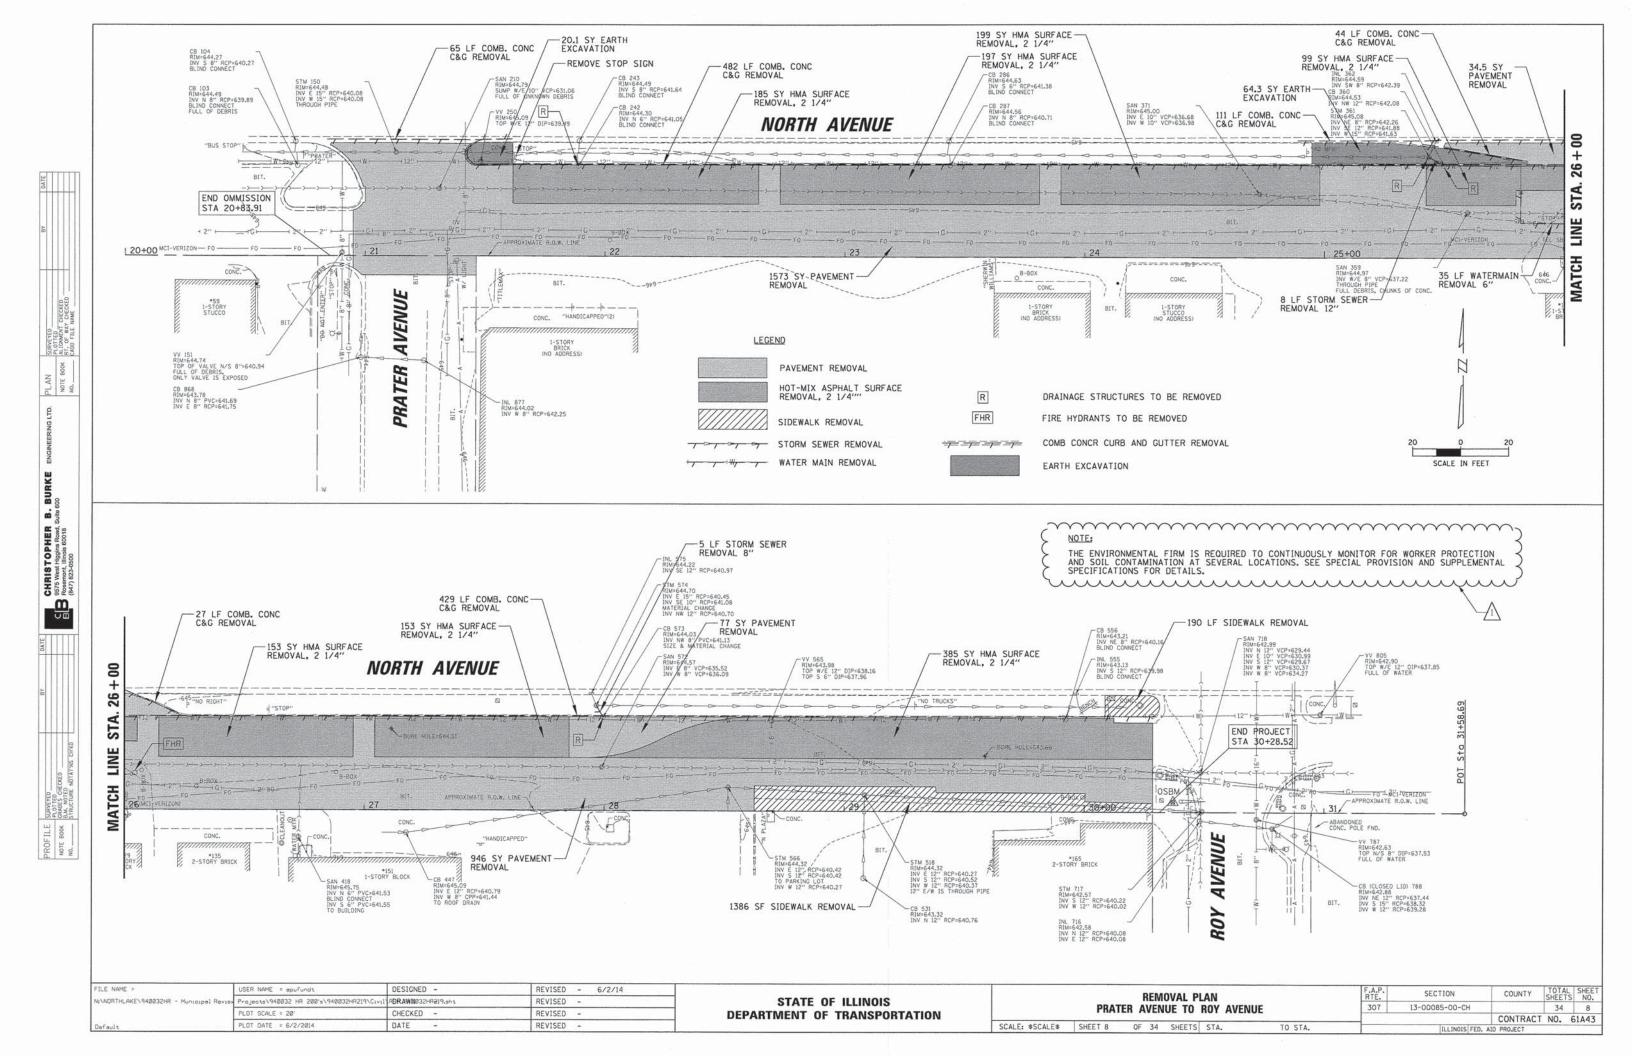
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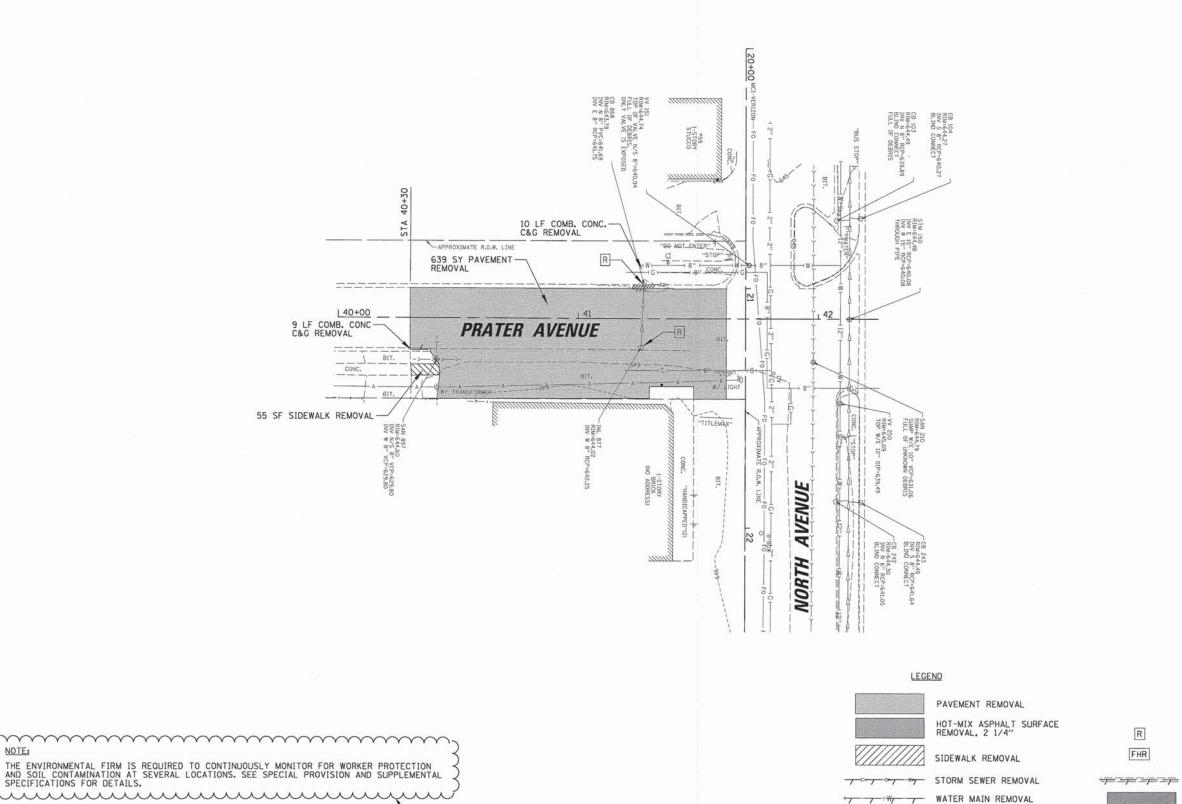
 $\rightarrow Z \rightarrow$ SCALE IN FEET

DRAINAGE STRUCTURES TO BE REMOVED

COMB CONC. CURB AND GUTTER REMOVAL

FIRE HYDRANTS TO BE REMOVED

EARTH EXCAVATION

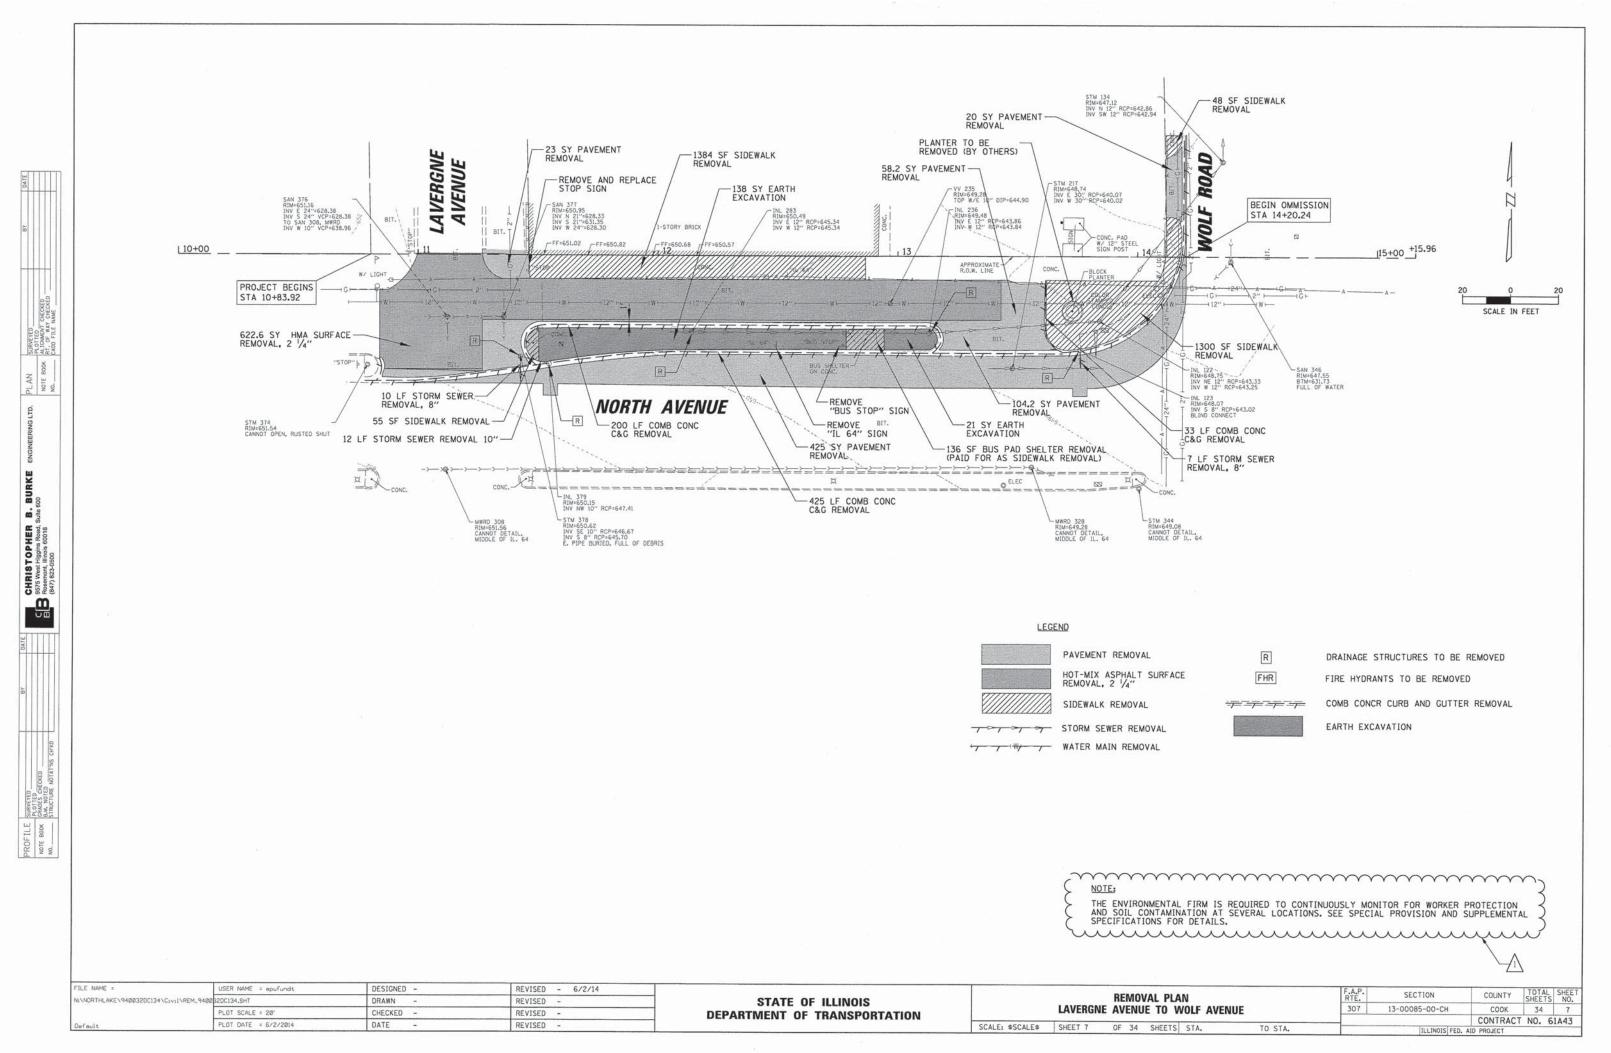



CHRISTOPHER B. BURKE 9575 West Higgins Road, Suite 600 Rosemont, Illinois 60018 (947) 823-0500


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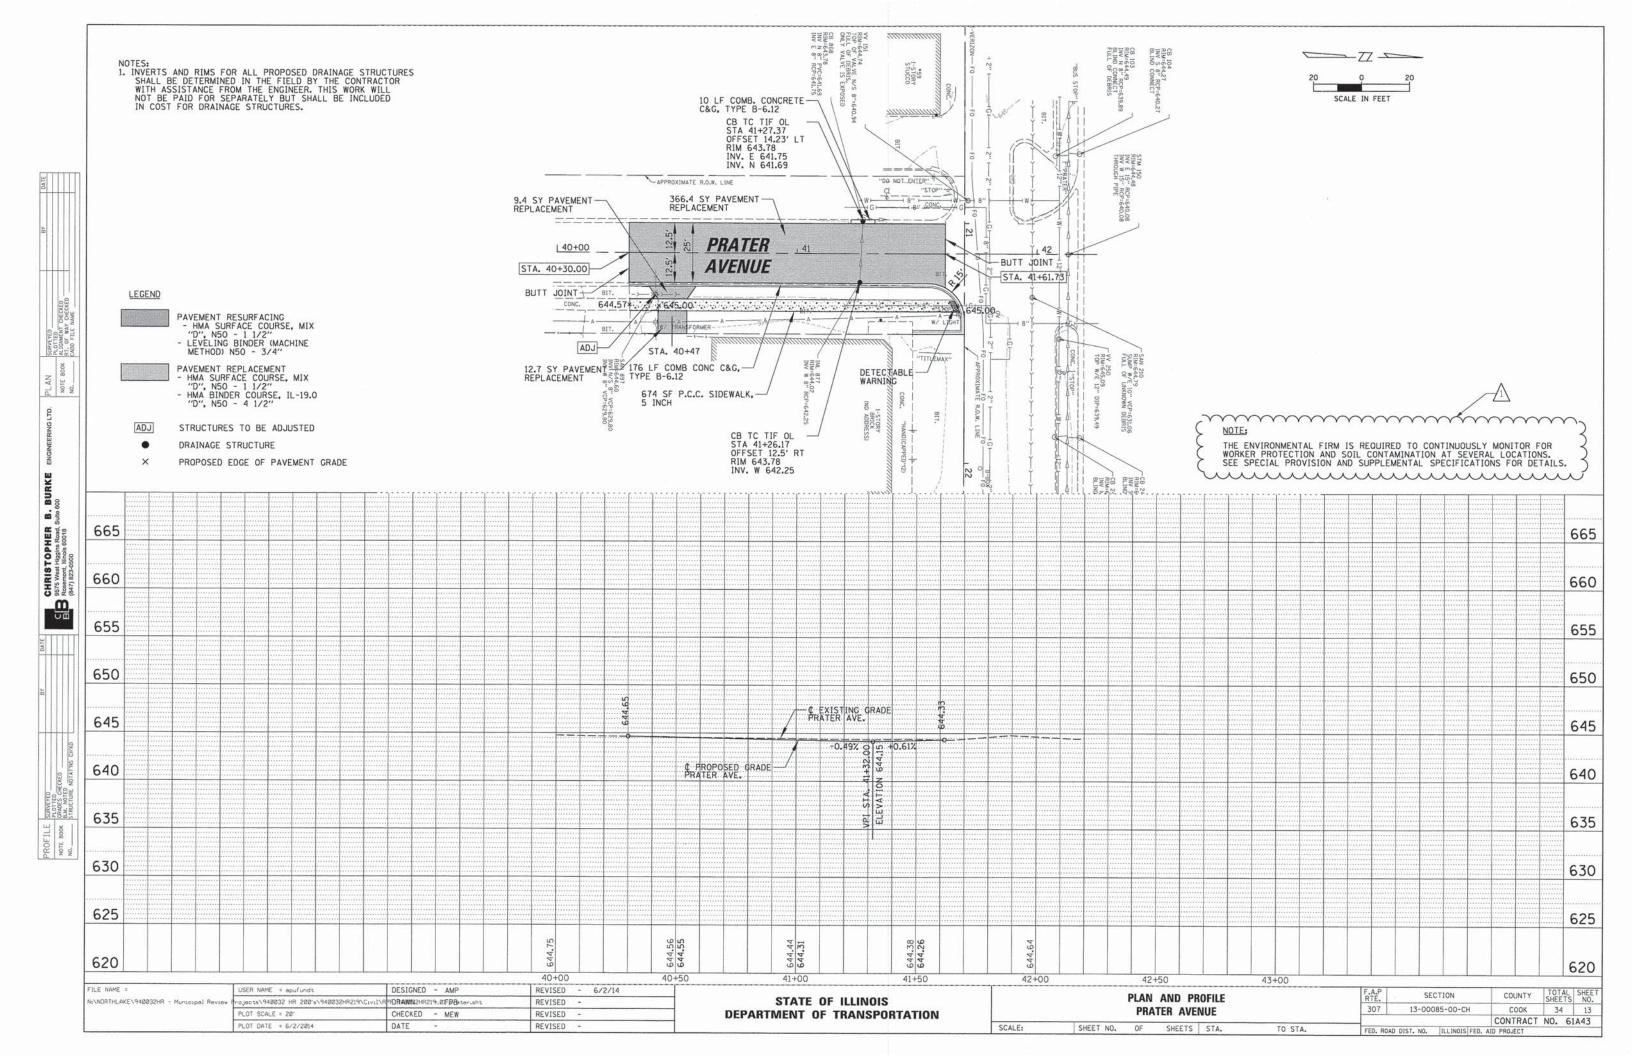
NOTE:

USER NAME = apufundt DESIGNED -REVISED - 6/2/14 COUNTY TOTAL SHEET NO. COOK 34 9 SECTION REMOVAL PLAN STATE OF ILLINOIS N:\NORTHLAKE\940032HR - Municipal Re-Projects\940032 HR 200's\940032HR219\Ci-RDRAWN032HR219-proter.sht REVISED -307 13-00085-00-CH PRATER AVENUE CHECKED -REVISED **DEPARTMENT OF TRANSPORTATION** CONTRACT NO. 61A43 PLOT DATE = 6/2/2014 DATE REVISED -SCALE: \$SCALE\$ SHEET 9 OF 34 SHEETS STA. TO STA.



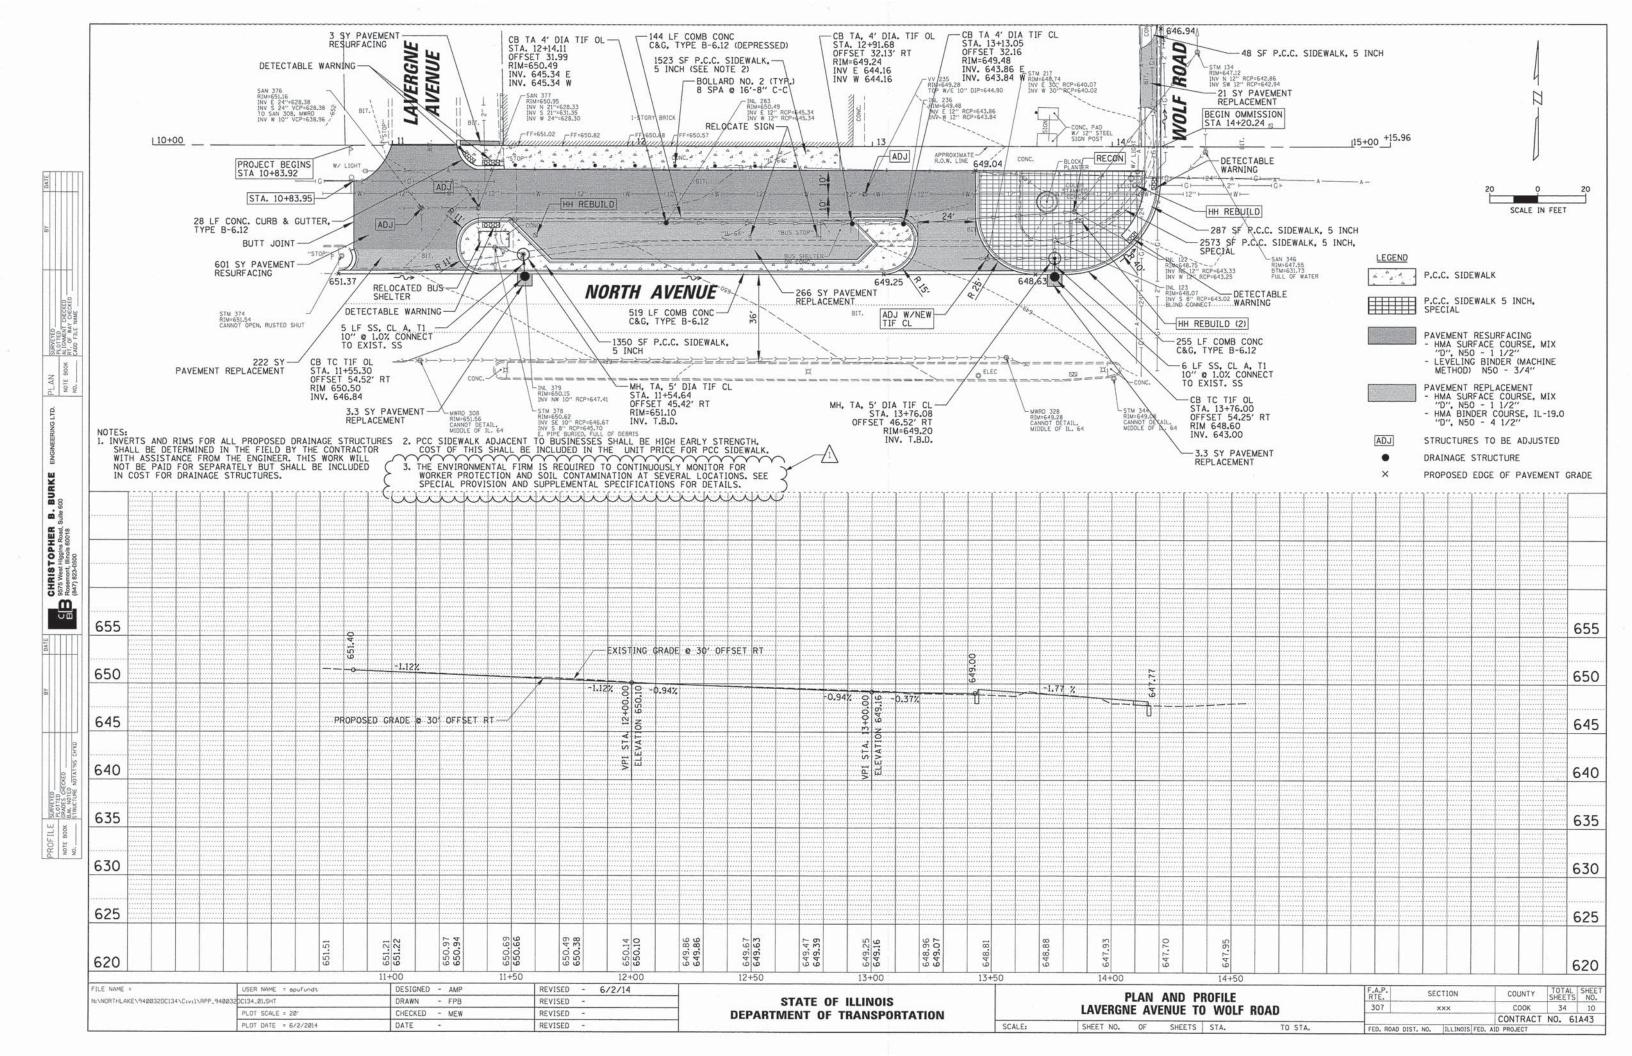


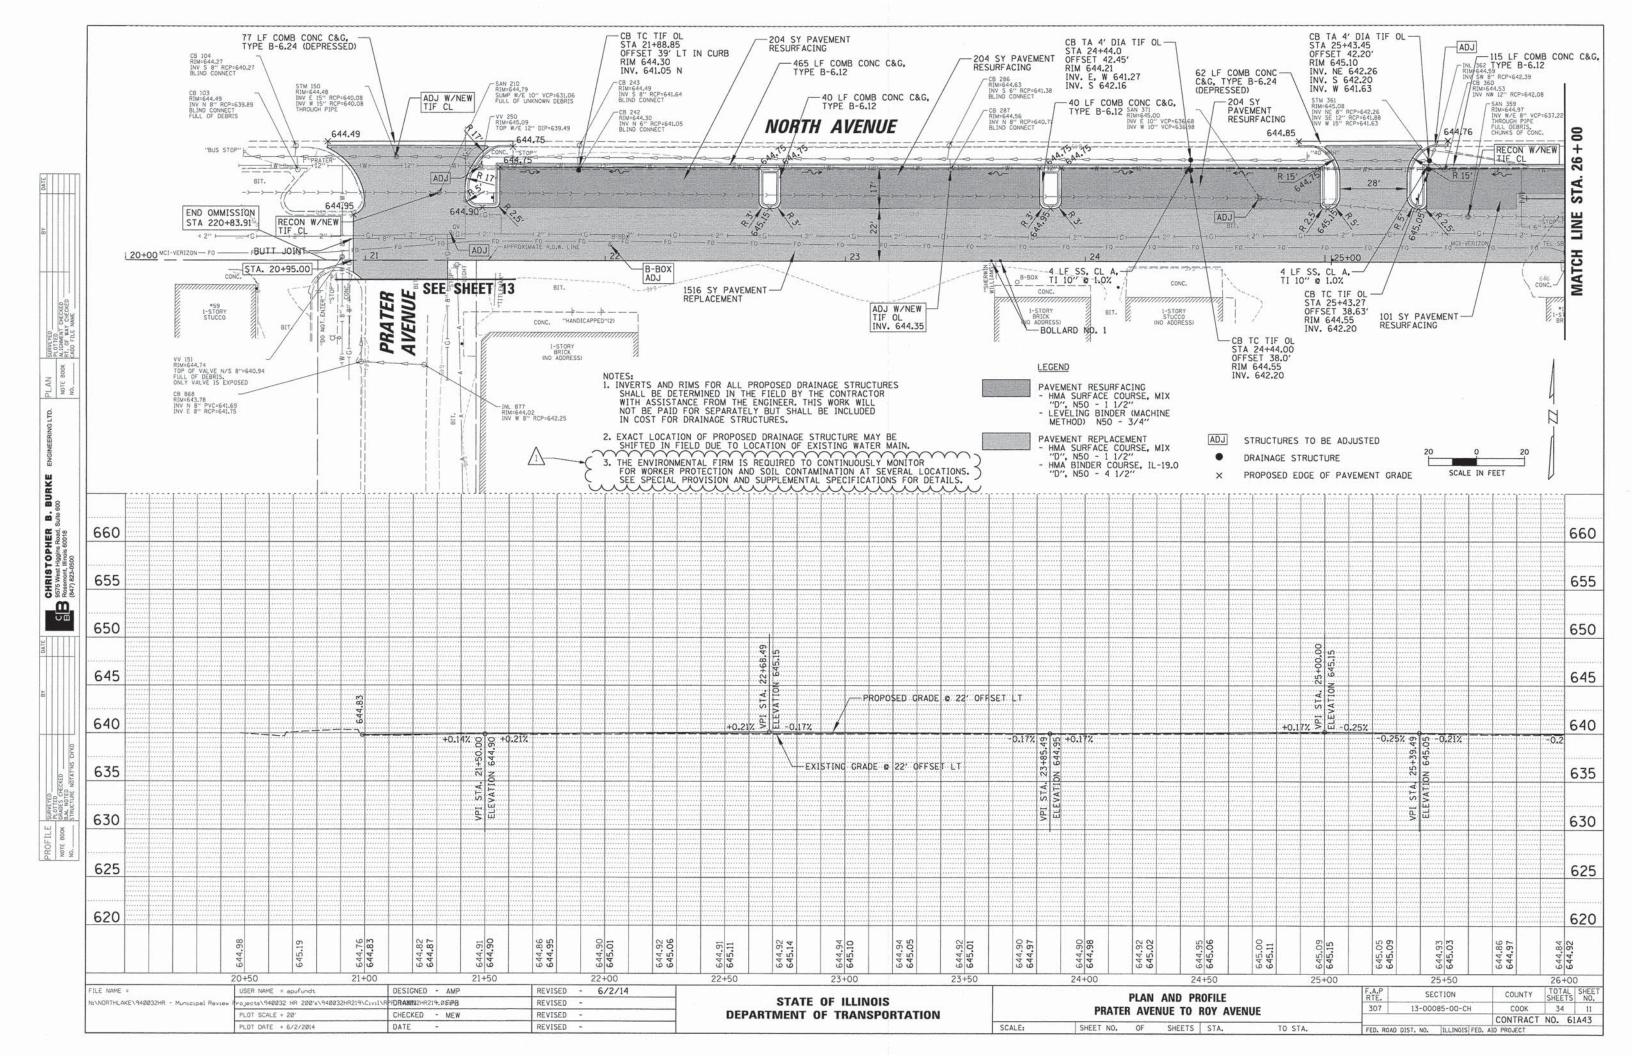


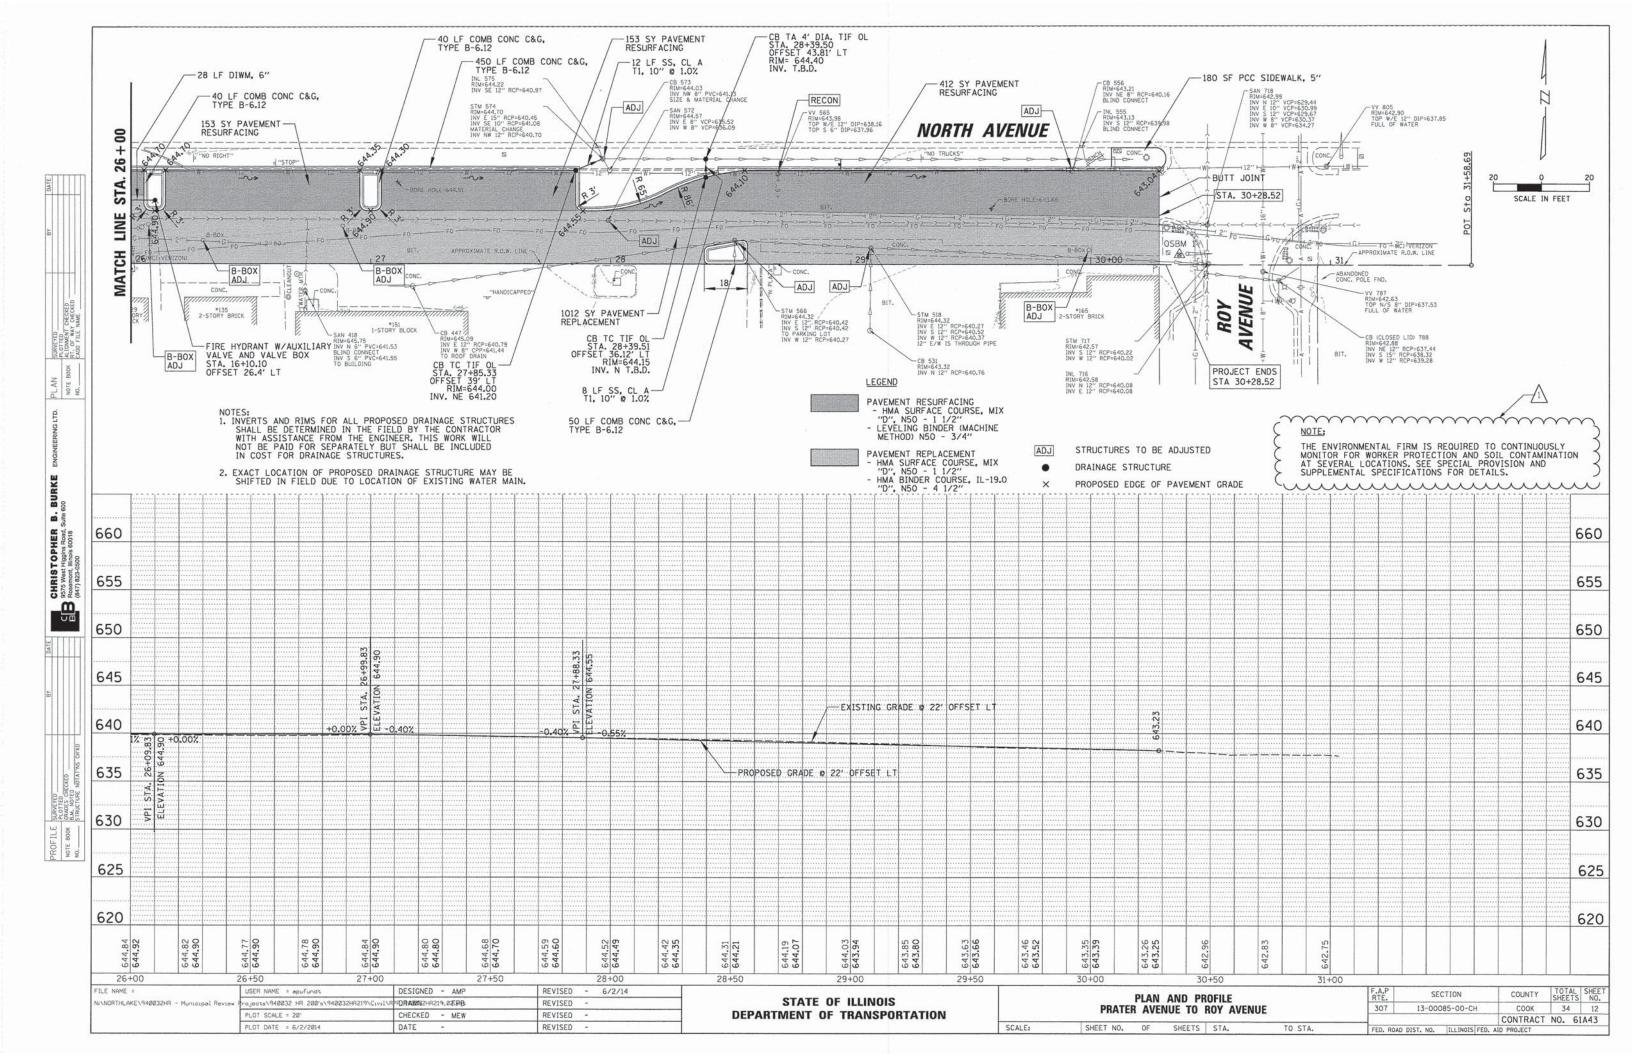

THIS PLAN IS FOR THE SOLE PURPOSE OF

DETECTOR LOOP REPLACEMENT

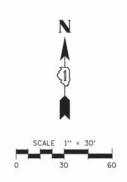

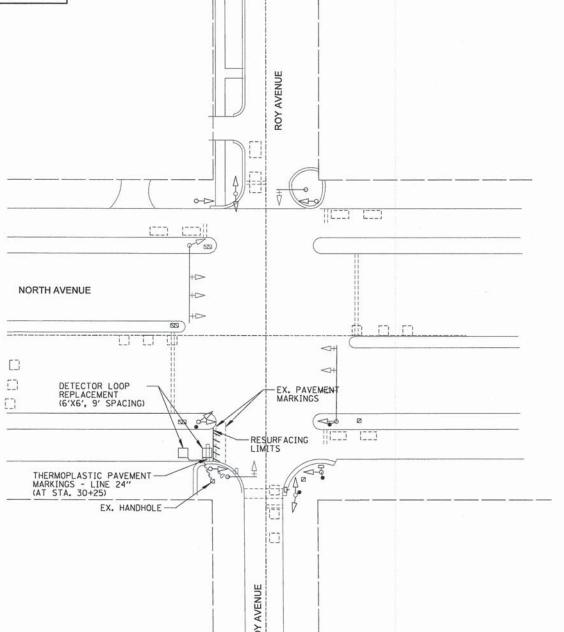

TRAFFIC SIGNAL LEGEND

ITEM	PROPOSED	EXISTING
SIGNAL HEAD WITH BACKPLATE		+
SIGNAL HEAD		
DETECTOR LOOP		[3]

NOTE:

THE ENVIRONMENTAL FIRM IS REQUIRED TO CONTINUOUSLY MONITOR FOR WORKER PROTECTION AND SOIL CONTAMINATION AT SEVERAL LOCATIONS. SEE SPECIAL PROVISION AND SUPPLEMENTAL SPECIFICATIONS FOR DETAILS.

REPLACE ALL DETECTOR LOOPS AS SHOWN (WITHIN THE RESURFACING LIMITS)

CODE	QUANTITY	UNIT	ITEM		
88600600	70	FOOT	DETECTOR LOOP REPLACEMENT		

FILE NAME =	USER NAME = apufundt	DESIGNED -	REVISED - 6/2/14				F.A.P.	SECTION	COUNTY	TOTAL SH
:\NORTHLAKE\940032HR - Municipel Review Proj	Projects\940032 HR 200's\940032HR219\Civil\LDBA	LDBRAWN0032HR219_detaht REVISED -	REVISED -	STATE OF ILLINOIS	DETECTOR LOOP REPLACEMENT PLAN				440000000000000000000000000000000000000	SHEETS
	PLOT SCALE = 30'	CHECKED -	REVISED -	DEPARTMENT OF TRANSPORTATION			307	13-00085-00-CH	CONTRAC	34 1
efoult	PLOT DATE = 6/2/2014	DATE -	REVISED -		SCALE: \$SCALE\$ SHEET 15 OF 34 SHEETS	STA. TO STA.		tu i motel eco	AID PROJECT	CT NO. 61A4