



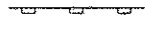
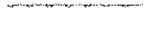


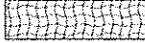

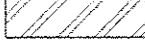


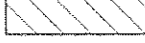



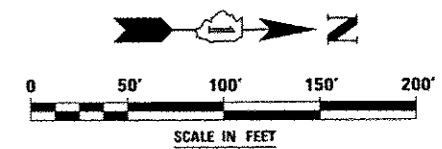
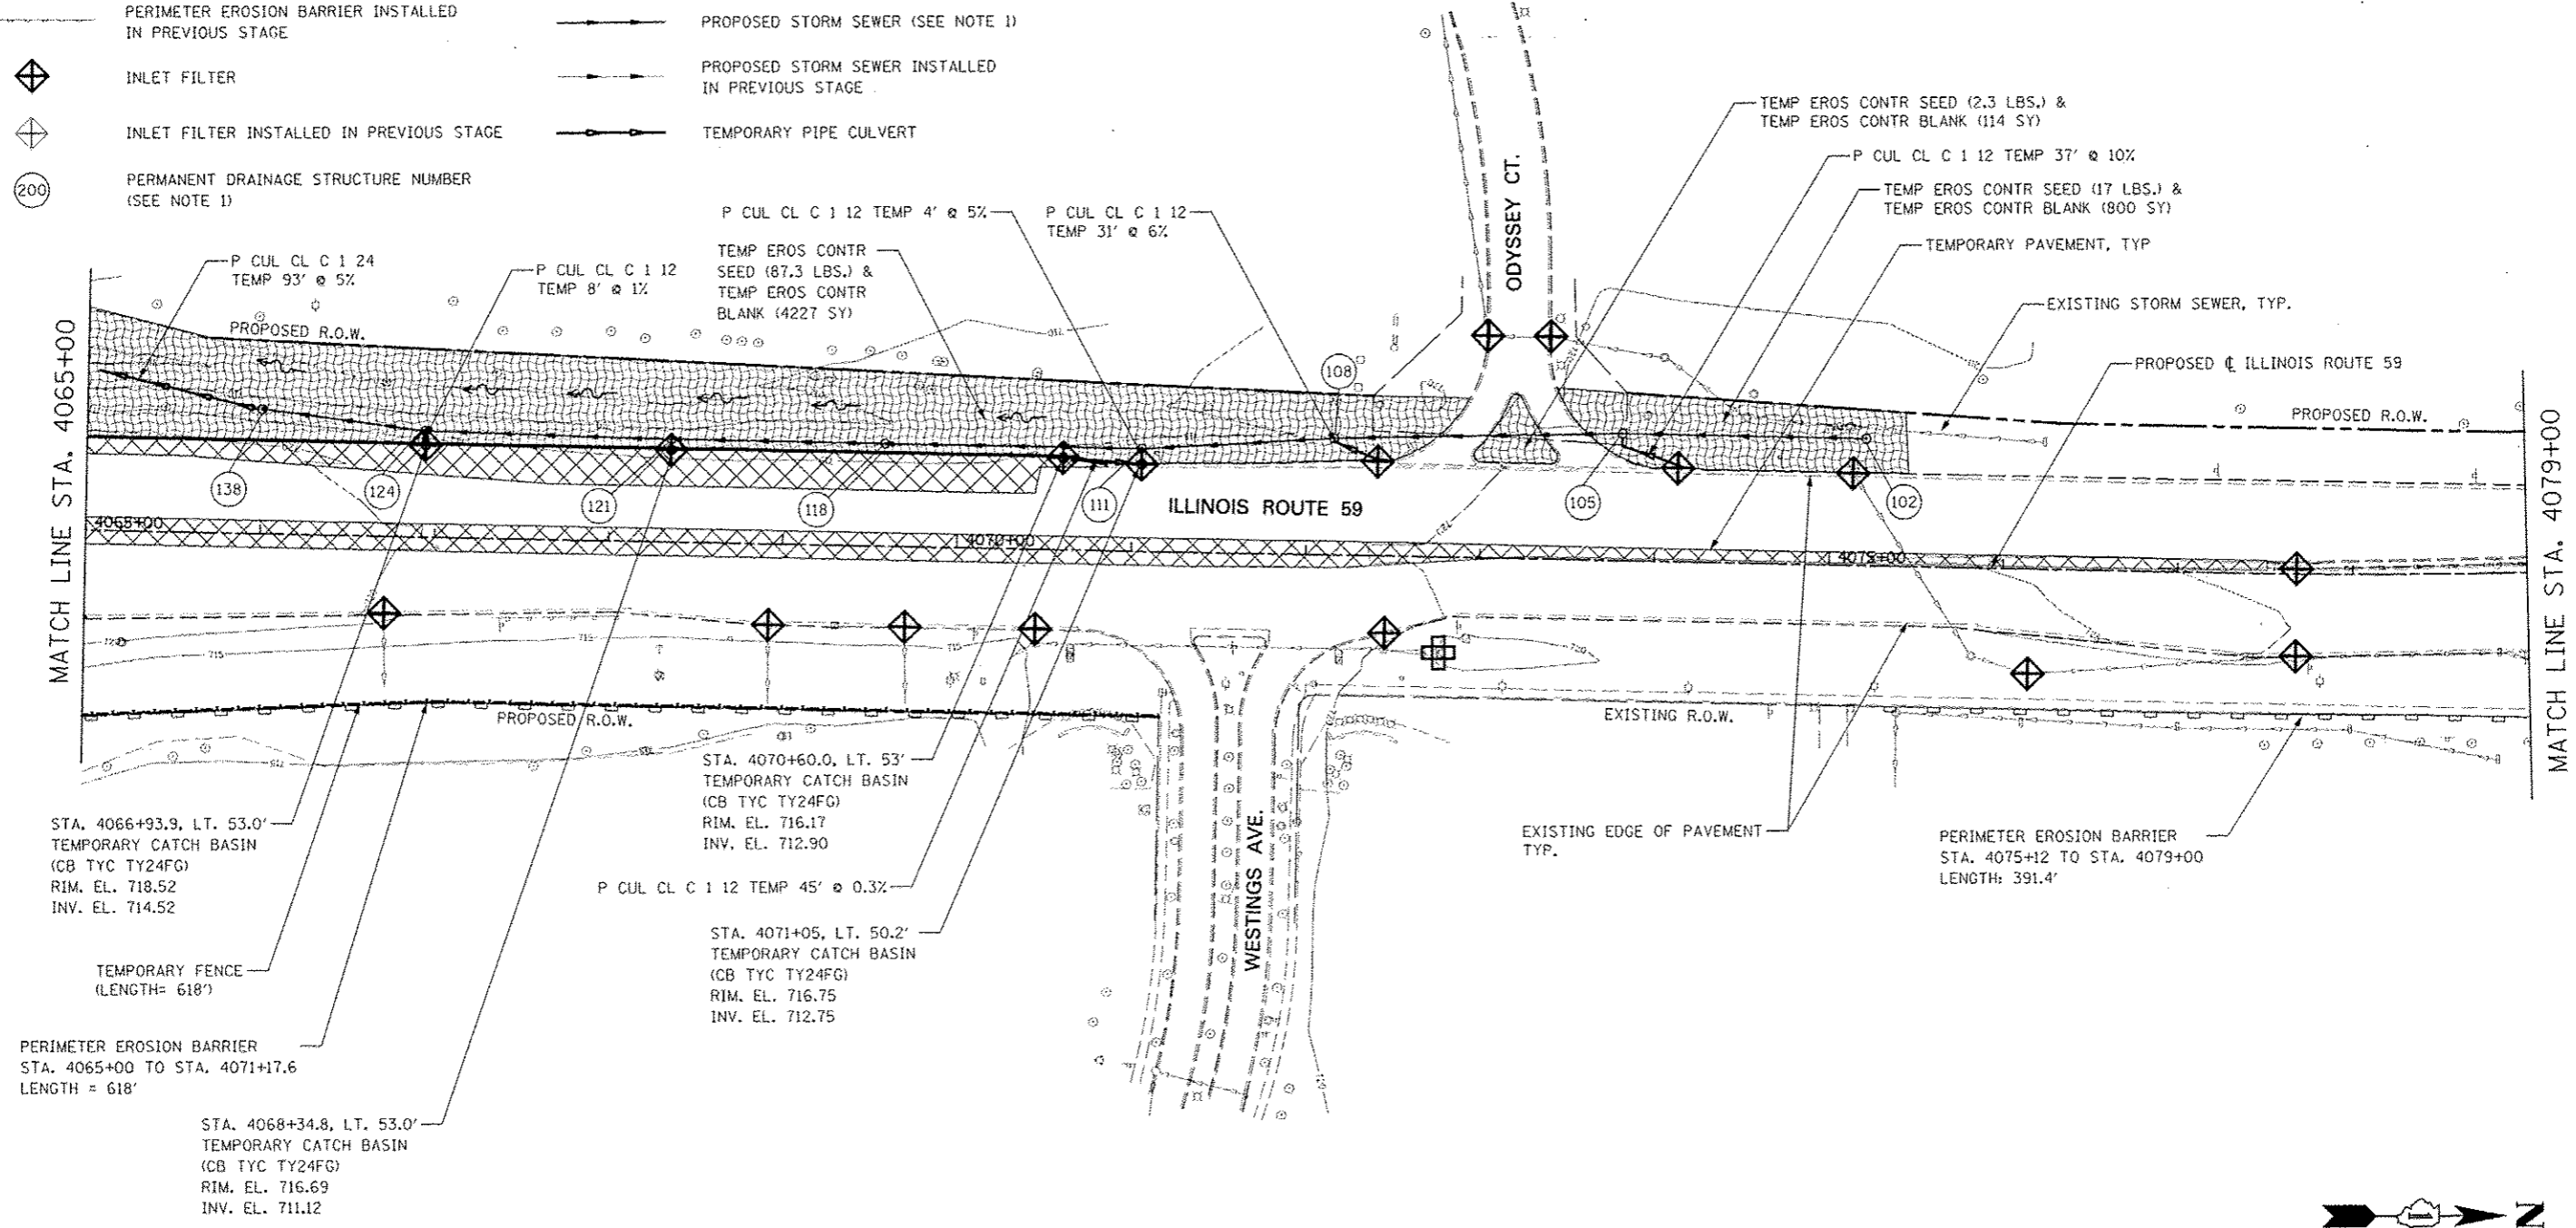


EROSION CONTROL LEGEND

-  TEMPORARY EROSION CONTROL SEEDING AND TEMPORARY EROSION CONTROL BLANKET
-  PERMANENT SEEDING (SEE NOTE 3)
-  TEMPORARY EROSION CONTROL SEEDING OR PERMANENT SEEDING INSTALLED IN A PREVIOUS STAGE
-  TEMPORARY PAVEMENT
-  PERIMETER EROSION BARRIER (SEE NOTE 2)
-  PERIMETER EROSION BARRIER INSTALLED IN PREVIOUS STAGE
-  INLET FILTER
-  INLET FILTER INSTALLED IN PREVIOUS STAGE
-  PERMANENT DRAINAGE STRUCTURE NUMBER (SEE NOTE 1)
-  TEMPORARY DITCH CHECK
-  TEMPORARY DITCH CHECK INSTALLED IN PREVIOUS STAGE
-  INLET & PIPE PROTECTION
-  INLET & PIPE PROTECTION INSTALLED IN PREVIOUS STAGE
-  FLOW DIRECTION (SEE NOTE 4)
-  PROPOSED STORM SEWER (SEE NOTE 1)
-  PROPOSED STORM SEWER INSTALLED IN PREVIOUS STAGE
-  TEMPORARY PIPE CULVERT

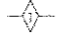NOTES

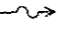1. SEE PROPOSED DRAINAGE PLANS FOR STORM SEWER INFORMATION
2. PERIMETER EROSION BARRIER SHALL BE ERECTED ADJACENT TO R.O.W., EASEMENT, AND CONSTRUCTION LIMITS AND AS DIRECTED BY THE ENGINEER.
3. SEE LANDSCAPING PLANS FOR LANDSCAPING REQUIREMENTS.
4. SEE PRE-STAGE CROSS SECTIONS FOR GRADING INFORMATION.



FILE NAME	USER NAME	DESIGNED	REVISED	STATE OF ILLINOIS DEPARTMENT OF TRANSPORTATION	EROSION CONTROL - PRESTAGE ILLINOIS ROUTE 59	F.A.P. RTE.	SECTION	COUNTY	TOTAL SHEETS	SHEET NO.
#FILEL4	BUSERR	PJO				338	(112 & 113) WRS-5	DUPAGE	963	479
PL07 SCALE = 1"=40'		CHECKED	REVISED			SCALE: SHEET NO. 4 OF 66 SHEETS STA. 4065+00 TO STA. 4079+00		CONTRACT NO. 60131		
PLD1 DATE = 8/24/12		DATE	REVISED			ILLINOIS FED. AID PROJECT				
		10/15/2012								