
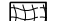



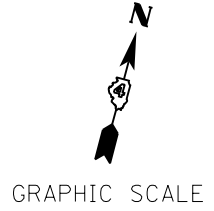
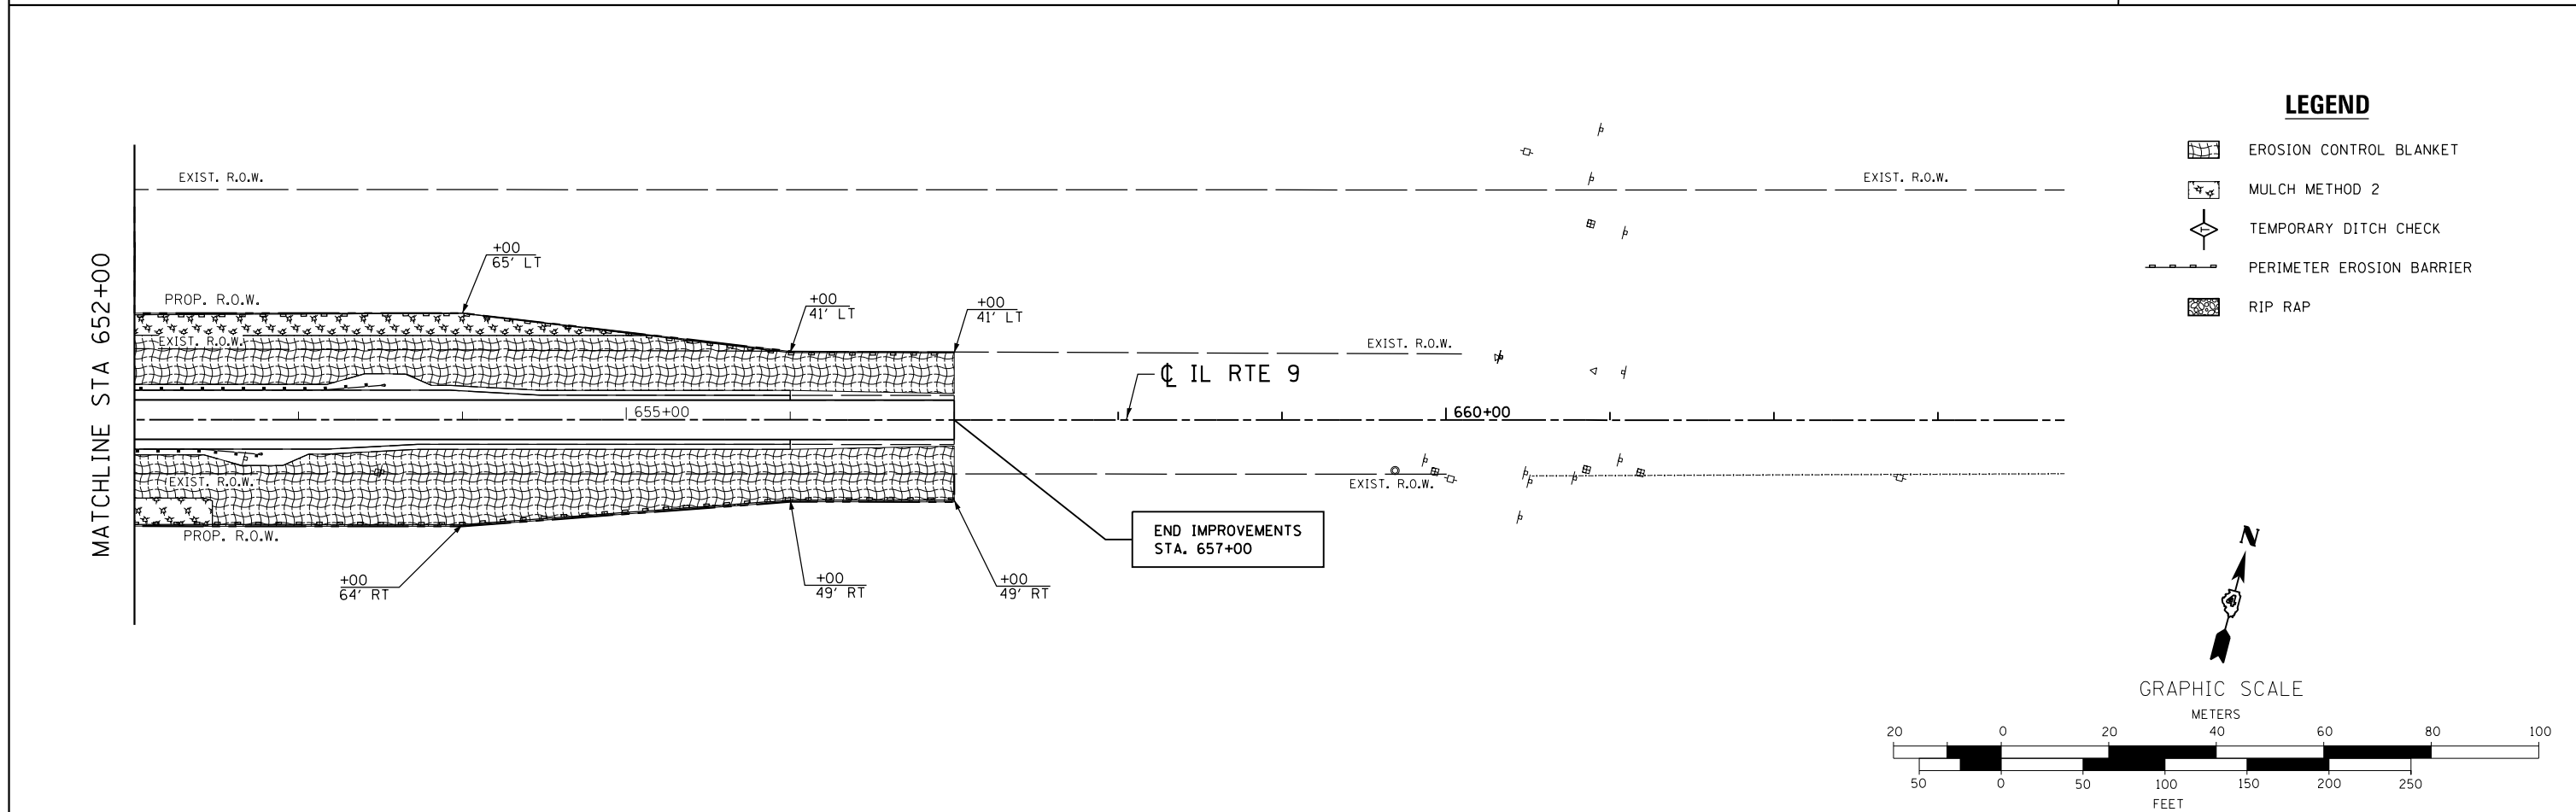


**NOTES:**  
SEE PROPOSED SCOUR PROTECTION AND SEEDING PLAN SHEET FOR RIPRAP AND SEEDING LIMITS.

**LEGEND**

-  EROSION CONTROL BLANKET
-  MULCH METHOD 2
-  TEMPORARY DITCH CHECK
-  PERIMETER EROSION BARRIER
-  RIP RAP

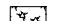

design firm  
no. 184001036



engineers + planners + land surveyors

USER NAME = *OPERATOR*	DESIGNED -	REVISED
FILE NAME = *FILES*	CHECKED -	REVISED
PLOT SCALE =	DRAWN -	REVISED
PLOT DATE = 3/19/2013	CHECKED - 03/20/2013	REVISED

**STATE OF ILLINOIS  
DEPARTMENT OF TRANSPORTATION**

**IL ROUTE 9 OVER MUD CREEK  
EROSION CONTROL PLAN**

SCALE: 1" = 50' SHEET NO. 1 OF 1 SHEETS STA. 643+00.00 TO STA. 657+00.00

F.A.P. RTE.	SECTION	COUNTY	TOTAL SHEETS	SHEET NO.
693	(119BR)BR	TAZEWELL	80	27
CONTRACT NO. 68757				
ILLINOIS FED. AID PROJECT				