022 0

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06-14-2019 LETTING ITEM 029

FOR INDEX OF SHEETS, SEE SHEET NO. 2

DESIGN DESIGNATION 750(40) LOCAL URBAN COLLECTOR 3.17 (HMA-20)

TRAFFIC DATA

ADT HANKES ROAD:	ADT IL 56:
5,200 (2011)	18,500 (2011)
21,000 (2040)	50,000 (2040)
P.V. = 97.9%	P.V. = 88.0%
S.U. = 1.7%	S.U. = 4.7%
M.U. = 0.38%	M.U. = 7.3%

SPEED LIMIT HANKES ROAD:SPEED LIMIT IL 56:35 / 45 MPH (POSTED)55 MPH (POSTED)50 MPH (DESIGN)70 MPH (DESIGN)

PROJECT LOCATED IN SUGAR GROVE TOWNSHIP AND THE VILLAGE OF SUGAR GROVE, KANE COUNTY



FULL SIZE PLANS HAVE BEEN PREPARED USING STANDARD ENGINEERING SCALES. REDUCED SIZED PLANS WILL NOT CONFORM TO STANDARD SCALES, IN MAKING MEASUREMENTS ON REDUCED PLANS, THE ABOVE SCALES MAY BE USED.

JULLE JOINT UTILITY LOCATION INFORMATION FOR EXCAVATION 1-600-892-0123 OR 811


PROJECT ENGINEER: MS. ANA ABREU PROJECT MANAGER: MS. SERIN KELLER, P.E.

CONTRACT NO. 62J22

STATE OF ILLINOIS DEPARTMENT OF TRANSPORTATION


PROPOSED HIGHWAY PLANS

FAP ROUTE 573 (IL ROUTE 56) SECTION 2019–044–BP&BR PROJECT: NHPP–HNW3(697) IL ROUTE 56 AT HANKES ROAD SHIELDING AND PAINTING KANE COUNTY

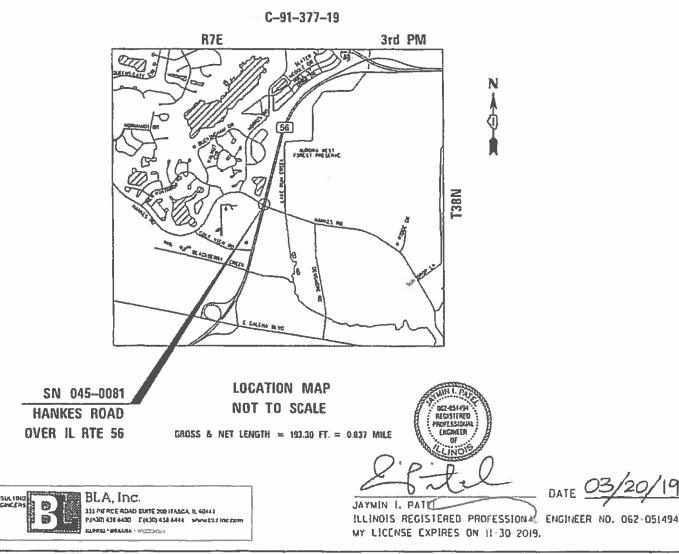

6

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INDEX OF SHEETS

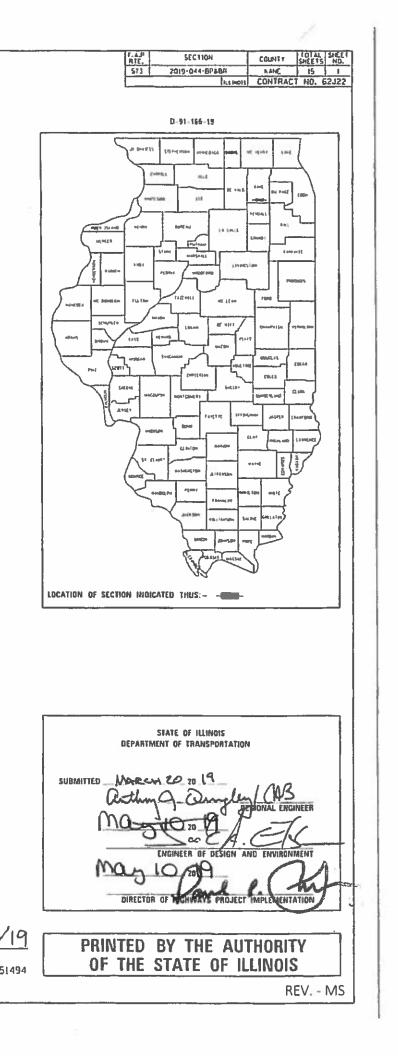- COVER SHEET 1
- INDEX, HIGHWAY STANDARDS, GENERAL NOTES AND COMMITMENTS 2
- 3-4 SUMMARY OF QUANTITIES
- 5-10 BRIDGE DETAILS - SN 045-0081
- DISTRICT DETAILS 11-15

DISTRICT ONE DETAILS

- TC-11 RAISED REFLECTIVE PAVEMENT MARKERS (SNOW PLOW RESISTANT)
- TC-13 DISTRICT ONE TYPICAL PAVEMENT MARKINGS
- TC-17 TRAFFIC CONTROL FOR FREEWAY SHOULDER CLOSURES AND PARTIAL RAMP CLOSURES
- TC-22 ARTERIAL ROAD INFORMATION SIGN

HIGHWAY STANDARDS

- 000001-07 STANDARD SYMBOLS, ABBREVIATIONS AND PATTERNS
- DECIMAL OF AN INCH AND OF A FOOT 001006
- 701101-05 OFF-ROAD OPERATIONS, MULTILANE, 15 FT. (4.5 m) TO 24 IN. (600 mm) FROM PAVEMENT EDGE
- 701106-02 OFF-ROAD OPERATIONS, MULTILANE, MORE THAN 15 FT. (4.5 m)
- LANE CLOSURE, 2L, 2W, SHORT TIME OPERATIONS 701301-04
- APPROACH TO LANE CLOSURE, FREEWAY / EXPRESSWAY 701400-09
- 701401-12 LANE CLOSURE, FREEWAY / EXPRESSWAY
- 701428-01 TRAFFIC CONTROL SETUP AND REMOVAL FREEWAY/EXPRESSWAY
- 701901-08 TRAFFIC CONTROL DEVICES
- 780001-05 TYPICAL PAVEMENT MARKINGS
- 781001-04 TYPICAL APPLICATIONS RAISED REFLECTIVE PAVEMENT MARKERS

GENERAL NOTES

- 1. ALL CONSTRUCTION SHALL BE DONE IN ACCORDANCE WITH THE STANDARD SPECIFICATIONS FOR ROAD AND BRIDGE CONSTRUCTION ADOPTED APRIL 1, 2016 (HEREIN AFTER REFERRED TO AS THE STANDARD SPECIFICATIONS; THE SUPPLEMENTAL SPECIFICATIONS AND RECURRING SPECIAL PROVISIONS ADOPTED JANUARY 1, 2019; THE LATEST EDITION OF THE ILLINOIS MANUAL ON UNIFORM TRAFFIC CONTROL DEVICES FOR STREETS AND HIGHWAYS; THE STANDARD SPECIFICATIONS FOR WATER & SEWER MAIN CONSTRUCTION IN ILLINOIS, SEVENTH EDITION; THE DETALLS IN THE PLANS; AND THE SPECIAL PROVISIONS INCLUDED IN THE CONTRACT DOCUMENTS.
- 2. ANY REFERENCE TO STANDARDS THROUGHOUT THE PLANS OR SPECIAL PROVISIONS SHALL BE INTERPRETED AS THE LATEST STANDARD OF THE ILLINOIS DEPARTMENT OF TRANSPORTATION.
- 3. THE CONTRACTOR SHALL BE RESPONSIBLE FOR CONTACTING THE OWNERS OF ALL UTILITIES PRIOR TO CONSTRUCTION TO DETERMINE THE LOCATION OF ALL EXISTING AND PROPOSED UTILITY EQUIPMENT. THE CONTRACTOR SHALL COOPERATE WITH ALL UTILITY OWNERS AS PROVIDED FOR IN THE STANDARD SPECIFICATIONS, IF UTILITY RELOCATION, ADJUSTMENT, OR PROTECTION IS NECESSARY.
- 4. BEFORE STARTING ANY EXCAVATION, THE CONTRACTOR SHALL CALL "J.U.L.I.E." AT (800) 892-0123 OR 811 FOR FIELD LOCATIONS OF BURIED ELECTRIC, TELEPHONE AND GAS UTILITIES. 48 HOURS NOTIFICATION IS REQUIRED.
- 5. THE CONTRACTOR SHALL COORDINATE CONSTRUCTION ACTIVITIES WITH UTILITY COMPANIES, THE VILLAGE, AND WITH LOCAL EMERGENCY SERVICES
- 6. THE CONTRACTOR WILL NOT BE ALLOWED TO SET UP A YARD OR FIELD OFFICE ON STATE PROPERTY WITHOUT WRITTEN PERMISSION FROM THE DEPARTMENT.
- 7. WHEN ARTIFICIAL LIGHTING IS UTILIZED IN NIGHT OPERATIONS THE CONTRACTOR SHALL EXERCISE THE UTMOST PRECAUTIONS IN PREVENTING ADVERSE VISIBILITY TO THE MOTORING PUBLIC AND ADJOINING RESIDENTIAL AREAS.
- THE RESIDENT ENGINEER SHALL CONTACT THE AREA TRAFFIC FIELD ENGINEER MR. DON CHIARUGI AT DON.CHIARUGI@ILLINOIS.GOV A MINIMUM OF 2 WEEKS PRIOR TO PLACEMENT OF PERMANENT PAVEMENT MARKINGS.
- 9. THE RESIDENT ENGINEER SHALL CONTACT THE ARTERIAL TRAFFIC CONTROL SUPERVISOR AT (847) 705-4470 A MINIMUM OF 72 HOURS PRIOR TO THE PLACEMENT OF ANY TEMPORARY TRAFFIC CONTROL DEVICES.
- 10. DO NOT SCALE PLANS FOR CONSTRUCTION DIMENSIONS.
- 11. THE CONTRACTOR SHALL BE RESPONSIBLE FOR ANY MEASUREMENTS NEEDED BEFORE THE ORDERING OF MATERIALS. ANY VARIATIONS FROM THE PLANS ARE NOT THE RESPONSIBILITY OF THE DEPARTMENT AND NO ADDITIONAL COMPENSATION WILL BE AWARDED.
- 12. THE CONTRACTOR SHALL TAKE CARE IN REMOVING OR EXCAVATING NEAR ALL EXISTING ITEMS WHICH WILL REMAIN, ANY DAMAGE DONE TO EXISTING ITEMS BY THE CONTRACTOR SHALL BE REPAIRED AT THE CONTRACTOR'S EXPENSE, ANYTHING DISTURBED OUTSIDE THE PROJECT LIMITS IS THE CONTRACTOR'S RESPONSIBILITY AND SHALL BE REPLACED IN KIND, NO ADDITIONAL COMPENSATION WILL BE AWARDED.
- 13. THE CONTRACTOR SHALL OBTAIN ALL NECESSARY PERMITS, AS REQUIRED, PRIOR TO COMMENCING WITH CONSTRUCTION. ANY COST ASSOCIATED WITH OBTAINING THESE PERMITS SHALL BE CONSIDERED INCLUDED IN THE CONTRACT UNIT PRICE FOR THE ITEMS BEING INSTALLED.
- 14. NO WORK SHALL COMMENCE UNTIL TRAFFIC CONTROL REQUIREMENTS ARE MET.
- 15. THE COST OF SAW CUTTING PRIOR TO THE REMOVAL OF ANY ITEM NOTED ON THE PLAN OR AS DIRECTED BY THE ENGINEER, (FULL DEPTH) SHALL BE INCLUDED IN THE UNIT PRICES FOR THE VARIOUS REMOVAL PAY ITEMS.
- 16. THE CONTRACTOR SHALL COORDINATE WITH THE VILLAGE OF SUGAR GROVE IN COMPLIANCE WITH LOCAL ORDINANCES.
- 17. THE CONTRACTOR SHALL SUBMIT TO THE ENGINEER A SATISFACTORY PROGRESS SCHEDULE AND CRITICAL PATH SCHEDULE WHICH SHALL SHOW THE PROPOSED SEQUENCE OF WORK AT THE TIME OF THE PRE-CONSTRUCTION CONFERENCE.
- 18. ALL ELEVATIONS ARE ON THE U.S.G.S. DATUM NAVD 88.
- 19. ALL OFFSET LOCATIONS GIVEN ON THE DETAILED PLANS FOR STRUCTURES, BACKS OF CURB, ETC. ARE FROM THE CENTERLINE AS SHOWN ON THE PLANS.
- 20. THE CONTRACTOR SHALL BE RESPONSIBLE FOR PROTECTING FRESH CONCRETE FROM DAMAGE AND VANDALISM. ANY DAMAGED OR VANDALIZED CONCRETE SHALL BE REMOVED AND REPLACED AT THE CONTRACTOR'S EXPENSE.
- 21. ALL DISTURBED AREAS WITHIN THE PROJECT THAT ARE NOT OTHERWISE SURFACED SHALL BE CLEANED, LAYERED WITH TOPSOIL, AND SEEDED AS SHOWN ON THE PLANS.

	MIXT	URE TYPE		AIF	R VOIDS	@ N DES	QMP
OVERLAY							
HMA SURFACE CO)URSE, MIX "	D", N50 (IL	-9.5mm),	1 3/4 11 2	% e 50	GYR.	QC/QA
QMP DESIGNATION	N: QUALITY C	ONTROL/QUAL	ITY ASSU	RANCE (QC	/QA)		

NOTES:

	USER NAME = WTeng	DESIGNED -	MTC	REVISED -		IL ROUTE 56 AT HANKES RD			SECTION	COUNTY	TOTAL SHEET SHEETS NO.
BLA, Inc.		DRAWN -	MTC	REVISED -	STATE OF ILLINOIS	INDEX, HIGHWAY STANDARDS, AND GENERAL NOTES		573	2019-044-BP&BR	KANE	15 2
ITASCA, ILLINOIS	PLOT SCALE = 100.0000 ' / in.	CHECKED -	JIP	REVISED -	DEPARTMENT OF TRANSPORTATION		INDEX, HIGHWAY STANDARDS, AND GENERAL NUTES			CONTRAC	T NO. 62J22
	PLOT DATE = 3/22/2019	DATE -	03/22/2019	REVISED -		SCALE: N.T.S.	SHEET 1 OF 2 SHEETS STA. N/A TO STA. N/A		ILLINOIS FED.	AID PROJECT	

GENERAL PAINT NOTES

CLEANING AND PAINTING OF THE EXISTING STRUCTURAL STEEL SHALL BE AS SPECIFIED IN THE SPECIAL PROVISIONS FOR "CLEANING AND PAINTING EXISTING STEEL STRUCTURES."

ALL ITEMS (SUCH AS, BUT NOT LIMITED TO: CONDUITS, BRACKETS AND DECK DRAINS) ATTACHED TO THE OUTSIDE OF THE FASCIA BEAMS SHOULD BE CLEANED AND PAINTED.

3. ALL BEAMS, BEARINGS, AND OTHER STRUCTURAL STEEL WITHIN FIVE (5) FT. (MEASURED ALONG THE BEAM) OF EITHER SIDE OF ALL DECK JOINTS SHALL BE CLEANED PER NEAR WHITE BLAST CLEANING SSPC-SP10. THE EXTERIOR SURFACES AND TOP AND BOTTOM OF THE BOTTOM FLANGE OF THE FASCIA BEAMS SHALL BE CLEANED PER NEAR WHITE BLAST CLEANING SSPC-SP10.

G. THESE AREAS SHALL BE PAINTED ACCORDING TO THE REQUIREMENTS OF PAINT SYSTEM 1 -OZ/E/U, THE COLOR OF THE FINAL FINISH COAT FOR ALL INTERIOR STEEL SURFACES SHALL BE GRAY, MUNSELL NO 5B 7/1. THE COLOR OF THE FINAL FINISH COAT FOR THE EXTERIOR AND BOTTOM FLANGE OF THE FASCIA BEAMS SHALL BE REDDISH BROWN, MUNSELL NO 2. 5YR 3/4.

4. A MINIMUM OF TWO (2) AIR MONITORS WILL BE REQUIRED TO MONITOR ABRASIVE BLASTING OPERATIONS. SEE SPECIAL PROVISIONS FOR "CONTAINMENT AND DISPOSAL OF LEAD PAINT CLEANING RESIDUES."

HOT-MIX ASPHALT MIXTURE REQUIREMENTS CHART

1. THE UNIT WEIGHT USED TO CALCULATE ALL HOT-MIX ASPHALT SURFACE MIXTURE QUANTITIES IS 112 LBS/SQ YD/IN.

2. THE AC TYPE FOR POLYMERIZED HMA MIXES SHALL BE SBS/SBR PG 76-22 AND FOR NON-POLYMERIZED HMA THE AC TYPE SHALL BE PG 64-22 UNLESS MODIFIED BY DISTRICT ONE SPECIAL PROVISIONS. FOR THE USE OF RECYCLED MATERIALS SEE DISTRICT ONE SPECIAL PROVISIONS.

QUALITY MANAGEMENT PROGRAM (QMP) IDENTIFIES THE PARTICULAR QUALITY CONTROL SPECIFICATION THAT APPLIES TO THE HMA MIXTURE.

			URBAN	
			80% FED 20% STATE	CONSTRUCTION
CODE NO.	ITEM	UNIT	TOTAL QUANTITY	BRIDGE 0047 S.N: 045-0
21101625	TOPSOIL FURNISH AND PLACE, 6"	SQ YD	7	7
25100635	HEAVY DUTY EROSION CONTROL BLANKET	SQ YD	7	7
40600985	PORTLAND CEMENT CONCRETE SURFACE REMOVAL - BUTT JOINT	SQ YD	25	25
40603335	HOT-MIX ASPHALT SURFACE COURSE, MIX "D", N50	TON	58	58
40800029	BITUMINOUS MATERIALS (TACK COAT)	POUND	266	266
Z0010501	CLEANING AND PAINTING STEEL BRIDGE NO. 1	L SUM	1	1
58600101	GRANULAR BACKFILL FOR STRUCTURES	CU YD	69	69
67000400	ENGINEER'S FIELD OFFICE, TYPE A	CAL MO	4	4
67100100	MOBILIZATION	L SUM	1	1
70100205	TRAFFIC CONTROL AND PROTECTION, STANDARD 701401	EACH	2	2
78000200	THERMOPLASTIC PAVEMENT MARKING - LINE 4"	FOOT	1040	1040
78100300	REPLACEMENT REFLECTOR	EACH	28	28
78300200	RAISED REFLECTIVE PAVEMENT MARKER REMOVAL	EACH	28	28

* SPECIALTY ITEM

	USER NAME = WTeng	DESIGNED - MTC	REVISED -		IL ROUTE 56 AT HANKES RD		F.A.P RTF.	SECTION	COUNTY TOTAL SHEET	
BLA, Inc.	-		REVISED -	STATE OF ILLINOIS		SUMMARY OF QUANTITIES		573	2019-044-BP&BR	KANE 15 3
ITASCA, ILLINOIS	PLOT SCALE = 100.0000 '/ in.		REVISED -	DEPARTMENT OF TRANSPORTATION					D: 33	CONTRACT NO. 62J22
	PLOT DATE = 3/22/2019	DATE - 03/22/2019	REVISED -	SCALE	SCALE: N.T.S.	SHEET 1 OF 2 SHEETS STA. N/A	TO STA. N/A		ILLINDIS FED. A	AID PROJECT




REV. - MS

			URBAN 80% FED 20% STATE	CONSTRUCTION CODE
CODE NO.	ITEM	UNIT	TOTAL QUANTITY	BRIDGE 0047 S.N: 045-0081
X5017305	PROTECTIVE SHIELD (PERMANENT)	SQ YD	220	220
Z0007112	CONTAINMENT AND DISPOSAL OF LEAD PAINT CLEANING RESIDUES	L SUM	1	1
Z0065700	SLOPE WALL REPAIR	SQ YD	60	60
X2300021	BRIDGE RAILING ERECTION	FOOT	25	25
			-	
				1

* SPECIALTY ITEM

	V RIA Inc USER NAME = WTeng DESIGNED - MTC REVISED - DRAWN - MTC REVISED - STATE OF ULLINOIS	IL ROUTE 56 AT HANKES RD	F.A.P SECTION	COUNTY TOTAL SHEET SHEETS NO.			
BLA, Inc.		DRAWN - MTC	REVISED -	STATE OF ILLINOIS	SUMMARY OF QUANTITIES	573 2019-044-BP&BR	KANE 15 4
ITASCA, ILLINOIS	PLOT SCALE = 100.0000 '/ 10.	CHECKED – JIP	REVISED -	DEPARTMENT OF TRANSPORTATION	SUMMART OF QUANTITIES		CONTRACT NO. 62J22
	PLOT DATE = 3/22/2019	DATE - 03/22/2019	REVISED -		SCALE: N.T.S. SHEET 2 OF 2 SHEETS STA. N/A TO STA. N/A	ILL INOIS FED. A	AID PROJECT

REV. - MS

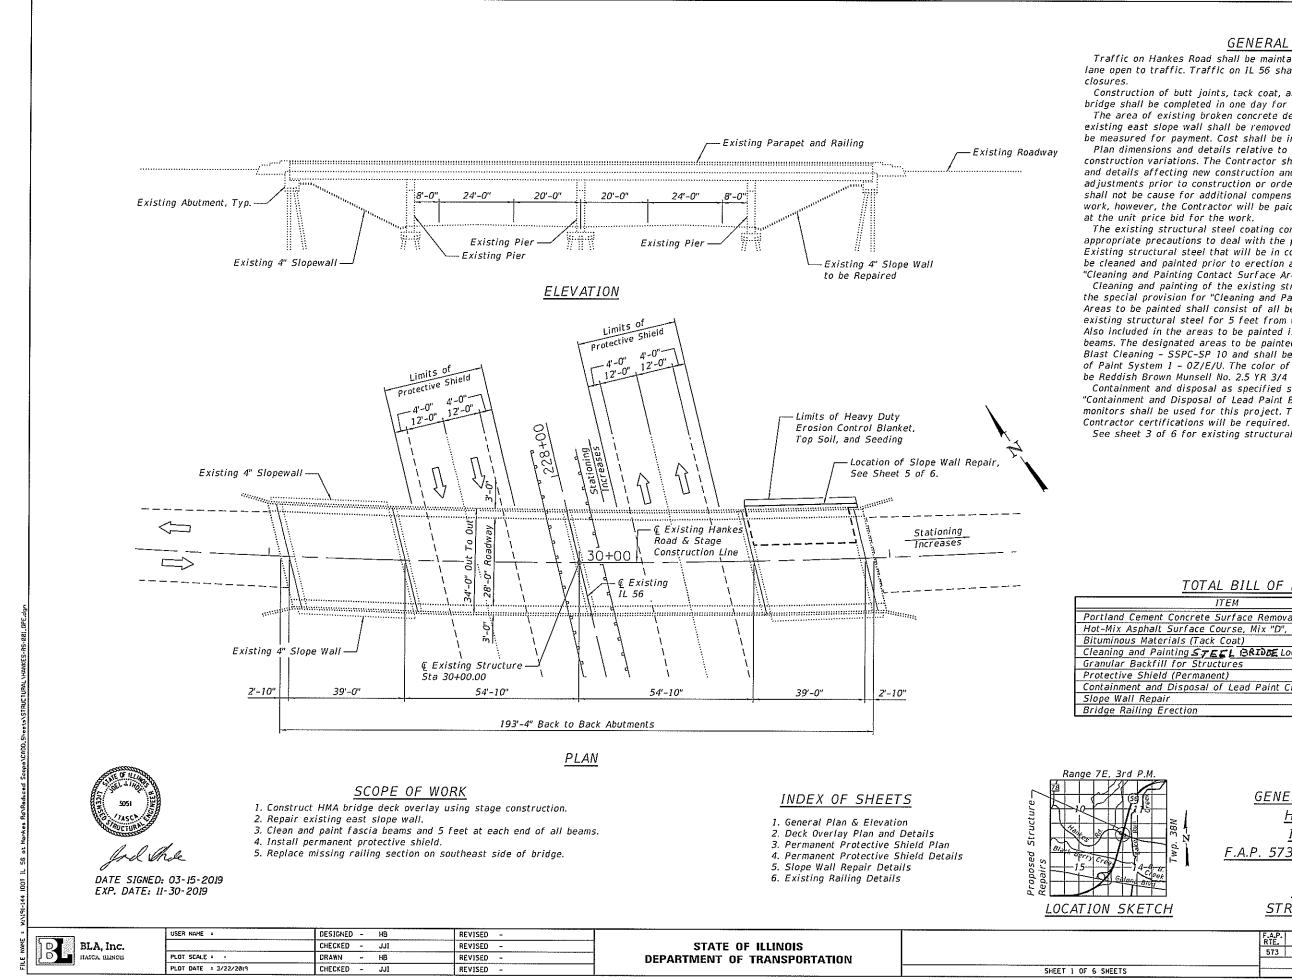

GENERAL NOTES

Traffic on Hankes Road shall be maintained using stage construction with one lane open to traffic. Traffic on IL 56 shall be maintained using daytime

Construction of butt joints, tack coat, and HMA overlay on the Hankes Road bridge shall be completed in one day for each stage of construction. The area of existing broken concrete debris along the north edge of the existing east slope wall shall be removed and disposed of. The area will not be measured for payment. Cost shall be included in Slopewall Repair. Plan dimensions and details relative to existing plans are subject to nominal construction variations. The Contractor shall field verify existing dimensions and details affecting new construction and make necessary approved adjustments prior to construction or ordering of materials. Such variations shall not be cause for additional compensation for a change in scope of the work, however, the Contractor will be paid for the quantity actually furnished The existing structural steel coating contains lead. The Contractor shall take appropriate precautions to deal with the presence of lead on this project. Existing structural steel that will be in contact with new structural steel shall be cleaned and painted prior to erection as required by the special provision

"Cleaning and Painting Ontact Surface Areas of Existing Steel Structures". Cleaning and painting of the existing structural steel shall be as specified in the special provision for "Cleaning and Painting Existing Steel Structures". Areas to be painted shall consist of all beam ends, end diaphragms, and all existing structural steel for 5 feet from the end of each beam at each abutment. Also included in the areas to be painted is the entire surface of the fascia beams. The designated areas to be painted shall be cleaned per Near White Blast Cleaning - SSPC-SP 10 and shall be painted according to the requirements of Paint System 1 - OZ/E/U. The color of the final finish coat for all areas shall

Containment and disposal as specified shall follow the special provision for "Containment and Disposal of Lead Paint Blast Residue". A minimum of two air monitors shall be used for this project. The SSPC-QPJ and SSPC-QP2 painting Contractor certifications will be required.


See sheet 3 of 6 for existing structural steel details.

TOTAL BILL OF MATERIAL

ITEM	UNIT	TOTAL
and Cement Concrete Surface Removal - Butt Joint	Sq. Yd.	25
Aix Asphalt Surface Course, Mix "D", N50	Ton	58
ninous Materials (Tack Coat)	Pound	266
ing and Painting STEEL ISRIDDE Location 1	L.S.	1
Ilar Backfill for Structures	Cu. Yd.	69
ctive Shield (Permanent)	Sq. Yd.	220
inment and Disposal of Lead Paint Cleaning Residues	L.S.	1
Wall Repair	Sq. Yd.	60
e Railing Erection	Foot	25

GENERAL PLAN & ELEVATION HANKES ROAD OVER ILLINOIS ROUTE 56 F.A.P. 573 SECTION 2019-044-BP&BR KANE COUNTY STATION 30+00.00 STRUCTURE NO. 045-0081

	F.A.P. RTE	SECTION	COUNTY	TOTAL SHEETS	SHEET ND.		
	573	2019-044-BP&BR	Kane	15	5		
			CONTRAC	T NO. 6	2J22		
EETS	ILLINOIS FED. AID PROJECT						

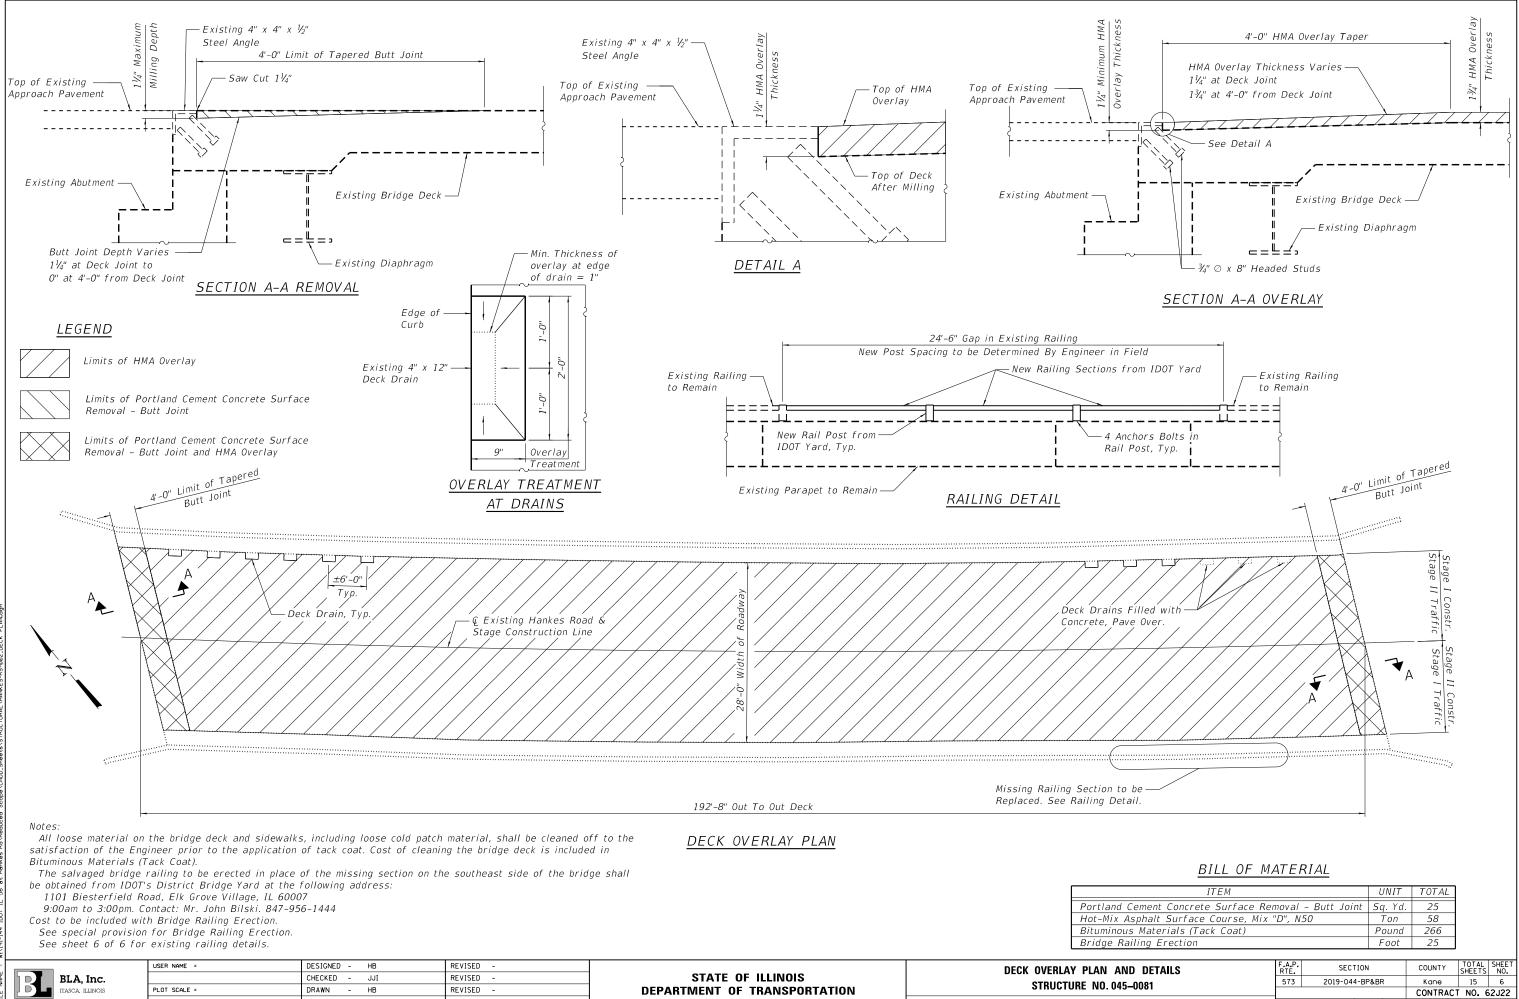


PLOT DATE = 3/22/2019


CHECKED – JJI

REVISED


0. 045–0081	573	2019-044-BI	P&BR		Kane	15
					CONTRACT	NO.
6 SHEETS		ILLI	INOIS F	ED. AI	D PROJECT	

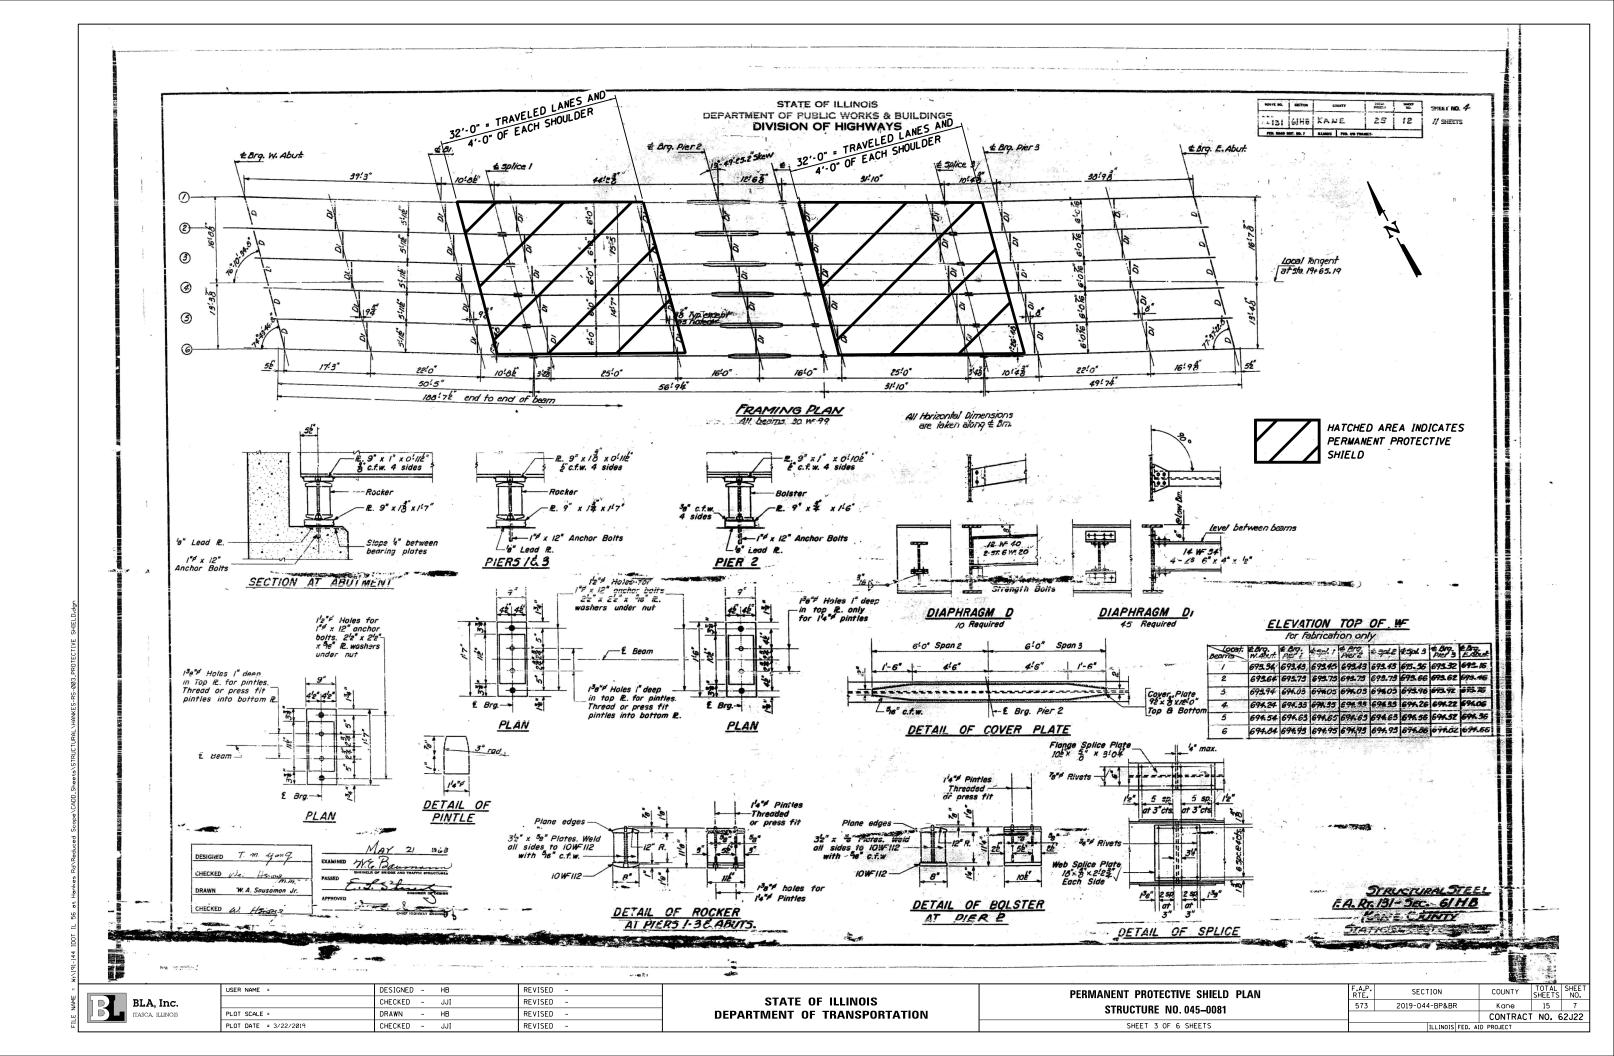

TIMBER SPACING

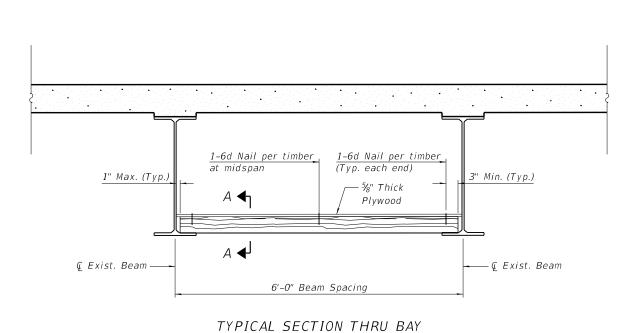

	T	imber Sizes (in	.)
Beam Spacing (ft.)	4" x 4" with min. Fb=775 psi Fv=135 psi	4" x 6" with min. Fb=775 psi Fv=135 psi	6" x 6" with min. Fb=575 psi Fv=125 psi
	Maximu	m Timber Spaci	ing (in.)
4.5	16	16	16
4.75	16	16	16
5.0	16	16	16
5.25	16	16	16
5.75	16	16	16
6.0	16	16	16
6.25	12	16	16
6.5	12	16	16
6.75	12	16	16
7.0	8	16	16
7.25	8	16	16
7.5	8	16	16
7.75	8	16	16
8.0	8	12	16
8.25	8	12	16
8.5	6	12	12
8.75	6	12	12
9.0	6	8	12

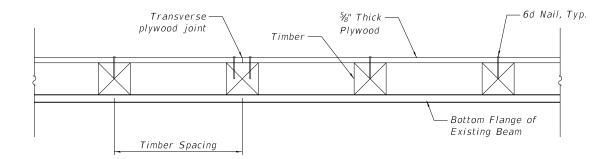

SECTION A-A

	USER NAME =	DESIGNED – HB	REVISED -		PERMANENT PROTECTIVE SHIELD DETAILS	F.A.P.	SECTION	COUNTY	TOTAL SHEET
BLA, Inc.		CHECKED – JJI	REVISED -	STATE OF ILLINOIS	STRUCTURE NO. 045–0081		2019-044-BP&BR	Kane	15 8
ITASCA, ILLINOIS	PLOT SCALE = DRAWN - HB REVISED -		DEPARTMENT OF TRANSPORTATION				CONTRAC	T NO. 62J22	
	PLOT DATE = 3/22/2019 CHECKED - JJI REVISED -		REVISED -		SHEET 4 OF 6 SHEETS		ILLINOIS FED. AI	AID PROJECT	

<u>BILL OF MATERIAL</u>							
ITEM	UNIT	TOTAL					
Protective Shield (Permanent)	Sq. Yd.	183					

<u>NOTES</u>

See special provision for Permanent Protective Shield System.

Timber sizes shown are nominal sizes. Rough sawn timber of the dimensions shown will also be considered acceptable.

The minimum Fb and Fv values shown are the tabulated design values given in the National Design Specification for Wood Construction for No. 2 Spruce-Pine-Fir without adjustment factors applied. Better grades or other species with equal or higher allowable stresses will also be considered acceptable.

The timber spacings shown have been determined using allowable stresses with all adjustment factors necessary for the anticipated service conditions.

All timber shall be treated.


Plywood shall be 5/8 " Exterior type plywood.

Plywood shall be placed such that the face grain is perpendicular to the timber supports. When less than a full sheet (4' width) of plywood is used, the width of the strip used shall not be less than 2'.

Transverse plywood joints shall be supported by timbers.


When 4" x 6" timbers are used, they shall be placed such that the wide face is horizontal and the narrow face is vertical.


Design load = 200 psf.

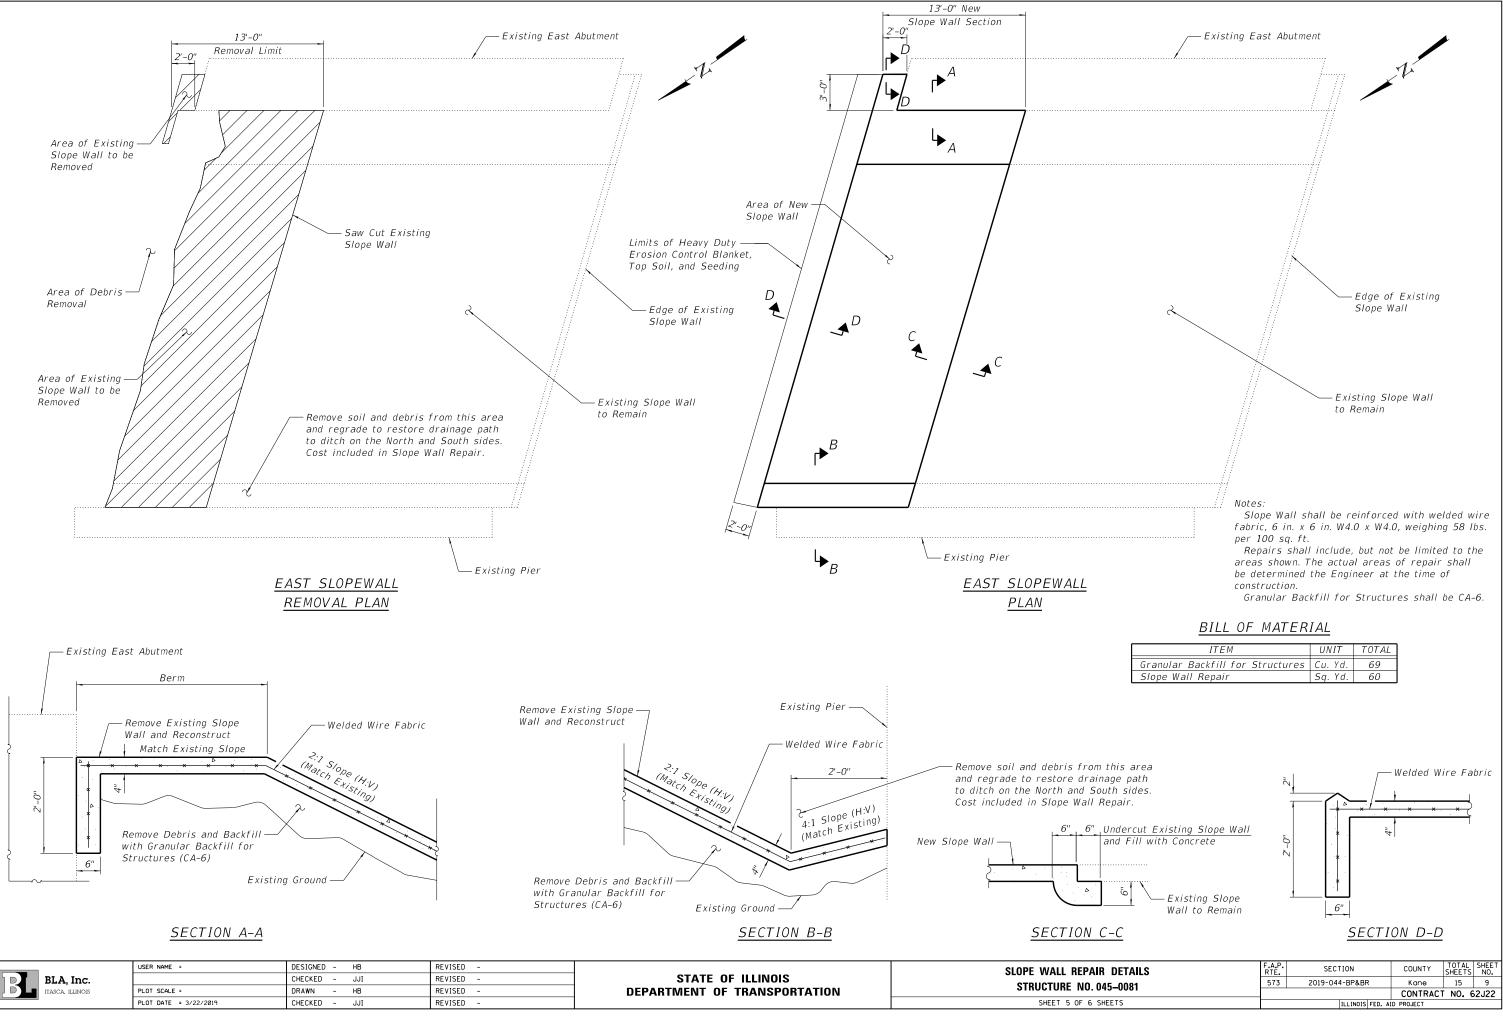


DILL OF MATLA	IAL	
ITEM	UNIT	TOTAL
Granular Backfill for Structures	Cu. Yd.	69
Slope Wall Repair	Sq. Yd.	60

AIR DETAILS		SECTION	COUNTY	TOTAL SHEETS	SHEET NO.	
. 045–0081	573	2019-044-BP&BR	Kane	15	9	
. 045-0001			CONTRACT	NO. 6	52J22	
5 SHEETS	ILLINOIS FED. AID PROJECT					

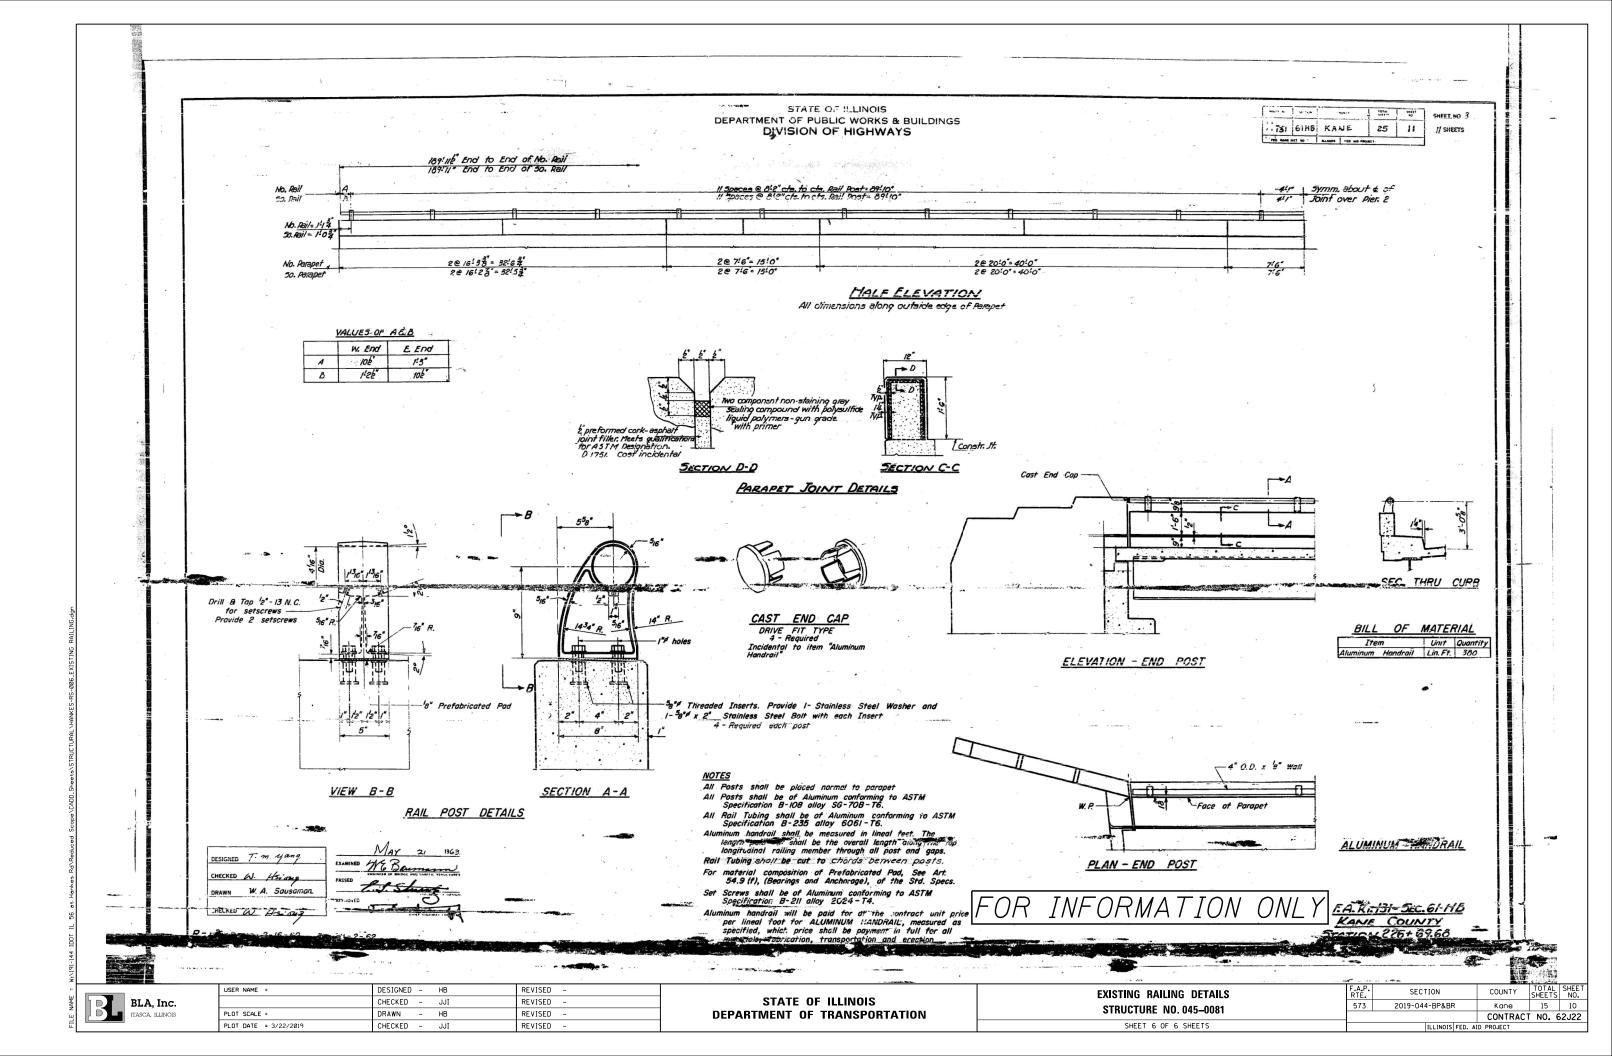

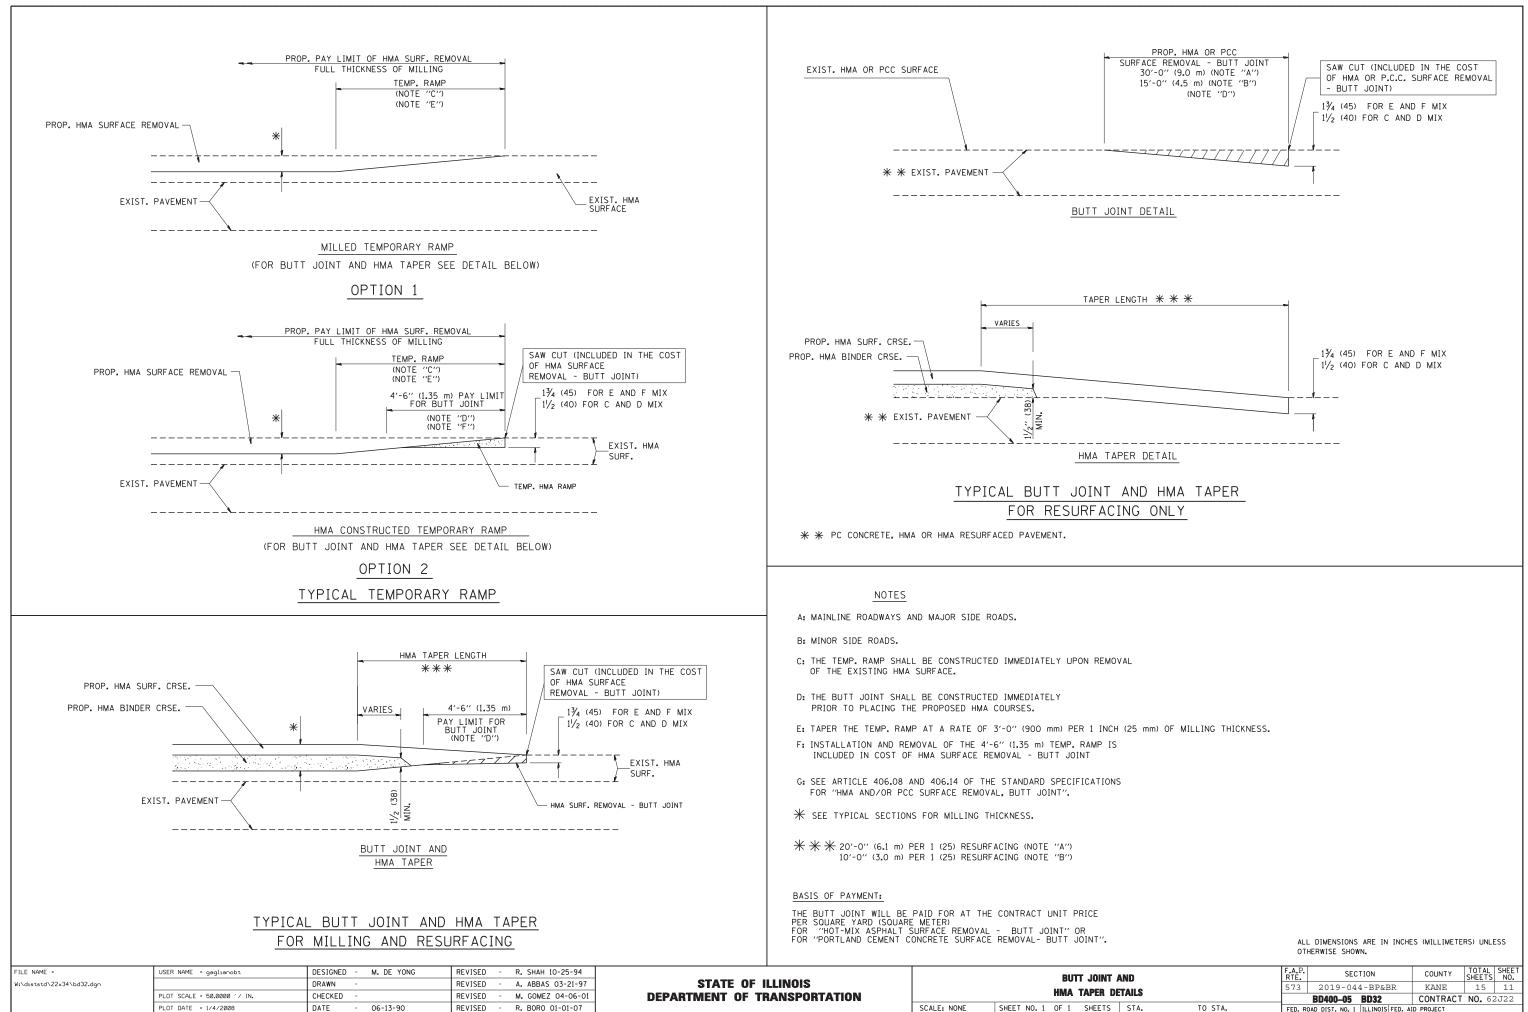


AND		F.A.P. RTE.	SECTION	COUNTY	TOTAL SHEETS	SHEET NO.			
		573	2019-044-BP&BR	KANE	15	11			
			BD400-05 BD32	CONTRACT	NO. 62	2J22			
	STA.	TO STA.	FED. RO	FED. ROAD DIST. NO. 1 ILLINOIS FED. AID PROJECT					

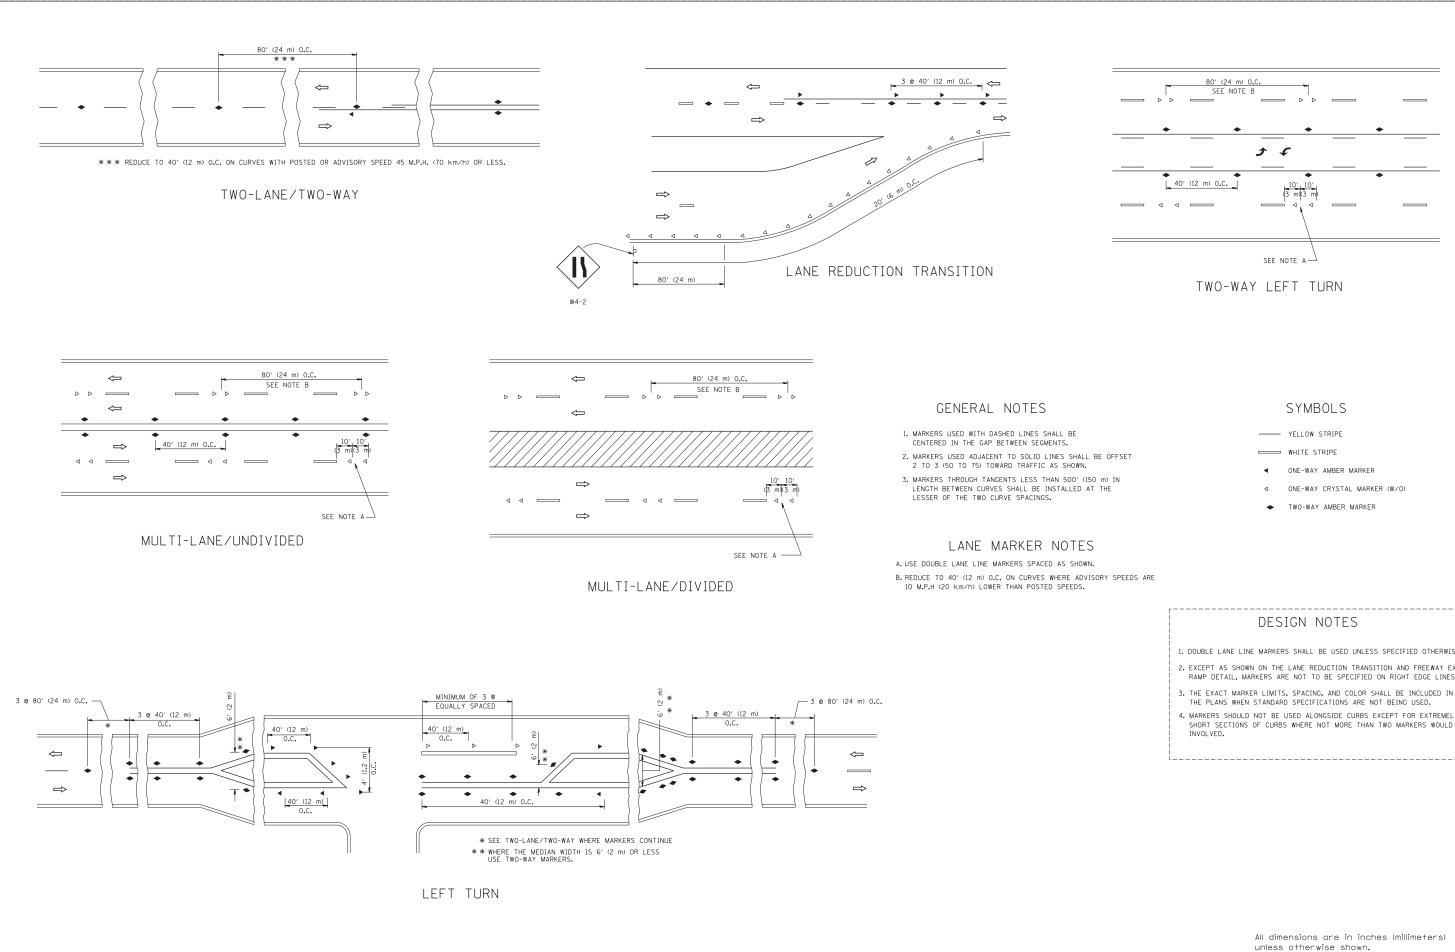


FILE NAME =	USER NAME = leysa	DESIGNED -	REVISED - T. RAMMACHER 09-19-94			TYPICAL APPLICATIONS	F.A.P. SECTION	COUNTY TOTAL SHEET
c:\pw_work\pwidot\leysa\d0108315\tc11.dgn		DRAWN -	REVISED - T. RAMMACHER 03-12-99	STATE OF ILLINOIS				KANE 15 12
	PLOT SCALE = 50.000 '/ IN.	CHECKED -	REVISED -T. RAMMACHER 01-06-00	DEPARTMENT OF TRANSPORTATION	RAISED	REFLECTIVE PAVEMENT MARKERS (SNOW-PLOW RESISTANT)	TC-11	CONTRACT NO. 62J22
	PLOT DATE = 3/2/2011	DATE -	REVISED - C. JUCIUS 09-09-09		SCALE: NONE	SHEET NO. 1 OF 1 SHEETS STA. TO STA.	FED. ROAD DIST. NO. 1 ILLINOIS FED.	AID PROJECT

1. DOUBLE LANE LINE MARKERS SHALL BE USED UNLESS SPECIFIED OTHERWISE. 2. EXCEPT AS SHOWN ON THE LANE REDUCTION TRANSITION AND FREEWAY EXIT RAMP DETAIL, MARKERS ARE NOT TO BE SPECIFIED ON RIGHT EDGE LINES. 3. THE EXACT MARKER LIMITS, SPACING, AND COLOR SHALL BE INCLUDED IN THE PLANS WHEN STANDARD SPECIFICATIONS ARE NOT BEING USED. 4. MARKERS SHOULD NOT BE USED ALONGSIDE CURBS EXCEPT FOR EXTREMELY SHORT SECTIONS OF CURBS WHERE NOT MORE THAN TWO MARKERS WOULD BE

unless otherwise shown.

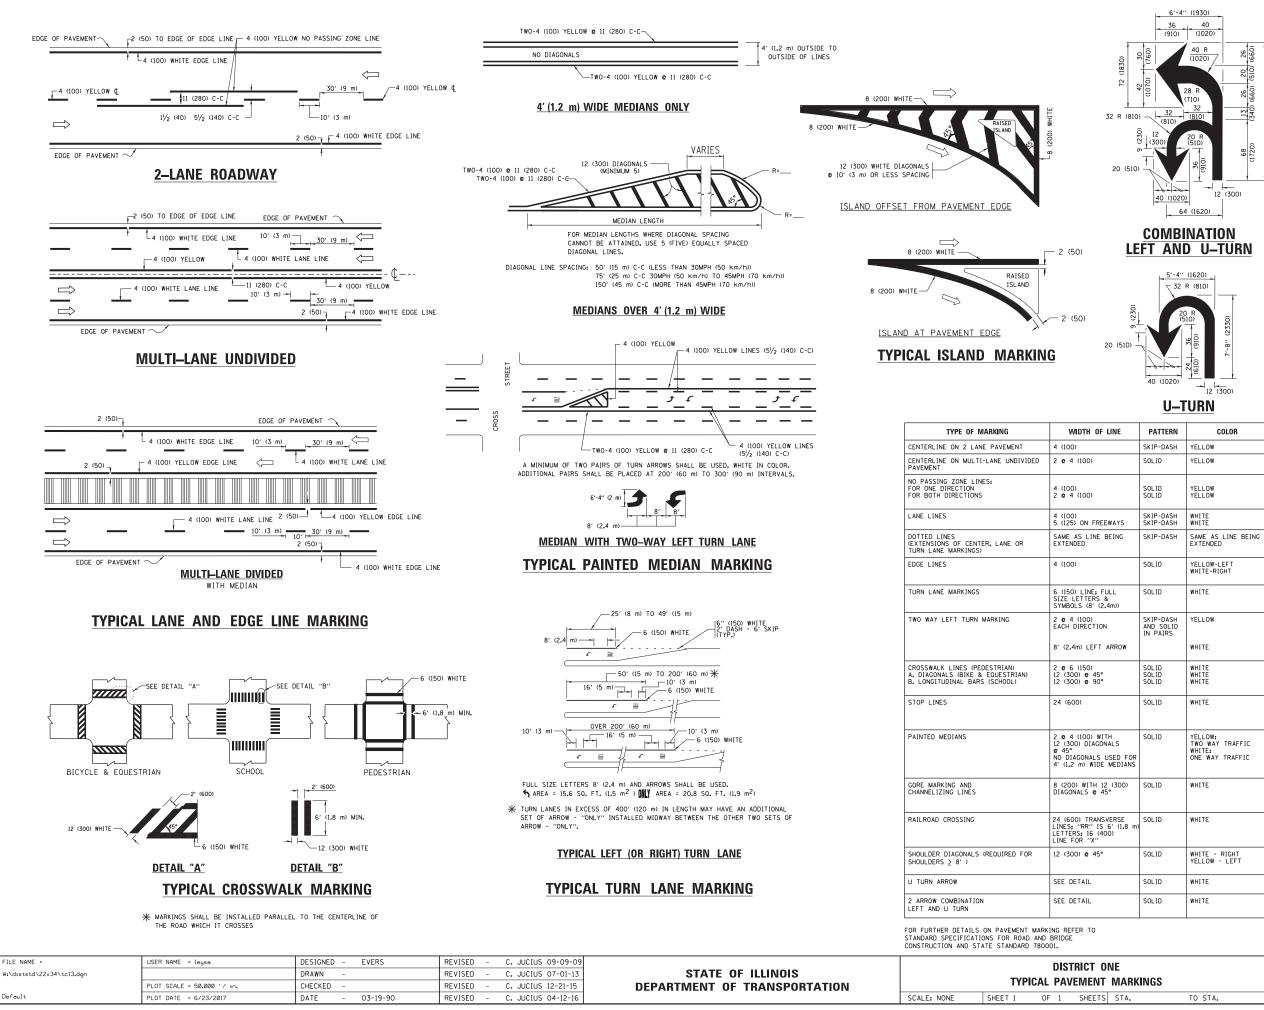

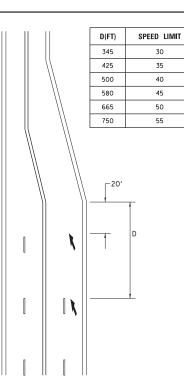


LANE REDUCTION TRANSITION

lane reduction arrows required at speeds of 45 MPH or greater or when specified in plans.


F LINE	PATTERN	COLOR	SPACING /REMARKS
	SKIP-DASH	YELLOW	10' (3 m) LINE WITH 30' (9 m) SPACE
	SOLID	YELLOW	11 (280) C-C
	SOLID SOLID	YELLOW YELLOW	5/2 (140) C-C FROM SKIP-DASH CENTERLINE 11 (280) C-C OMIT SKIP-DASH CENTERLINE BETWEEN
EEWAYS	SKIP-DASH SKIP-DASH	WHITE WHITE	10' (3 m) LINE WITH 30' (9 m) SPACE
BEING	SKIP-DASH	SAME AS LINE BEING EXTENDED	2' (600) LINE WITH 6' (1.8 m) SPACE
	SOLID	YELLOW-LEFT WHITE-RIGHT	OUTLINE MEDIANS IN YELLOW
FULL & 2.4m))	SOLID	WHITE	SEE TYPICAL TURN LANE MARKING DETAIL
ON ARROW	SKIP-DASH AND SOLID IN PAIRS	YELLOW	10' (3 m) LINE WITH 30' (9 m) SPACE FOR SKIP-DASH; 5½ (140) C-C BETWEEN SOLID LINE AND SKIP-DASH LINE SEE TYPICAL TWO-WAY LEFT TURN MARKING DETAIL
•	SOLID SOLID SOLID	WHITE WHITE WHITE	NOT LESS THAN 6' (1.8 m) APART 2' (600) APART 2' (600) APART SEE TYPICAL CROSSWALK MARKING DETAILS.
	SOLID	WHITE	PLACE 4' (1,2 m) IN ADVANCE OF AND PARALLEL TO CROSSWALK, IF PRESENT, OTHEWNISE, PLACE AT DESIRED STOPPING POINT: PARALLEL TO CROSSROAD CENTERLINE, WHERE POSSIBLE
ITH DNALS USED FOR E MEDIANS	SOLID	YELLOW: TWO WAY TRAFFIC WHITE: ONE WAY TRAFFIC	11 (280) C-C FOR THE DOUBLE LINE SEE TYPICAL PAINTED MEDIAN MARKING.
12 (300) 45°	SOLID	WHITE	DIAGONALS: 15' (4,5 m) C-C (LESS THAN 30MPH (50 km/h)) 20' (6 m) C-C 30MPH (50 km/h) TO 45MPH (70 km/h)) 30' (9 m) C-C (OVER 45MPH (70 km/h))
SVERSE 5 6' (1.8 m) 400)	SOLID	WHITE	SEE STATE STANDARD 780001 AREA OF: "R"=3.6 SO, FT. (0.33 m ²) EACH "X"=54.0 SO, FT. (5.0 m ²)
•	SOLID	WHITE - RIGHT YELLOW - LEFT	50' (15 m) C-C (LESS THAN 30MPH (50 km/h)) 75' (25 m) C-C (30 MPH (50 km/h) TO 45MPH (70 km/h)) 150' (45 m) C-C (0VER 45MPH (70 km/h))
	SOLID	WHITE	16.3 SF
	SOLID	WHITE	30.4 SF
		1	

All dimensions are in inches (millimeters) unless otherwise shown.

ONE IT MARKINGS		F.A.P RTE.	SECTION	COUNTY	TOTAL SHEETS	SHEET NO.					
		573	2019-044-BP&BR	KANE	15	13					
II WARKINGS				TC-13	CONTRACT	NO. 62	2J22				
ΤS	STA.	TO STA.		ILLINOIS FED. AID PROJECT							

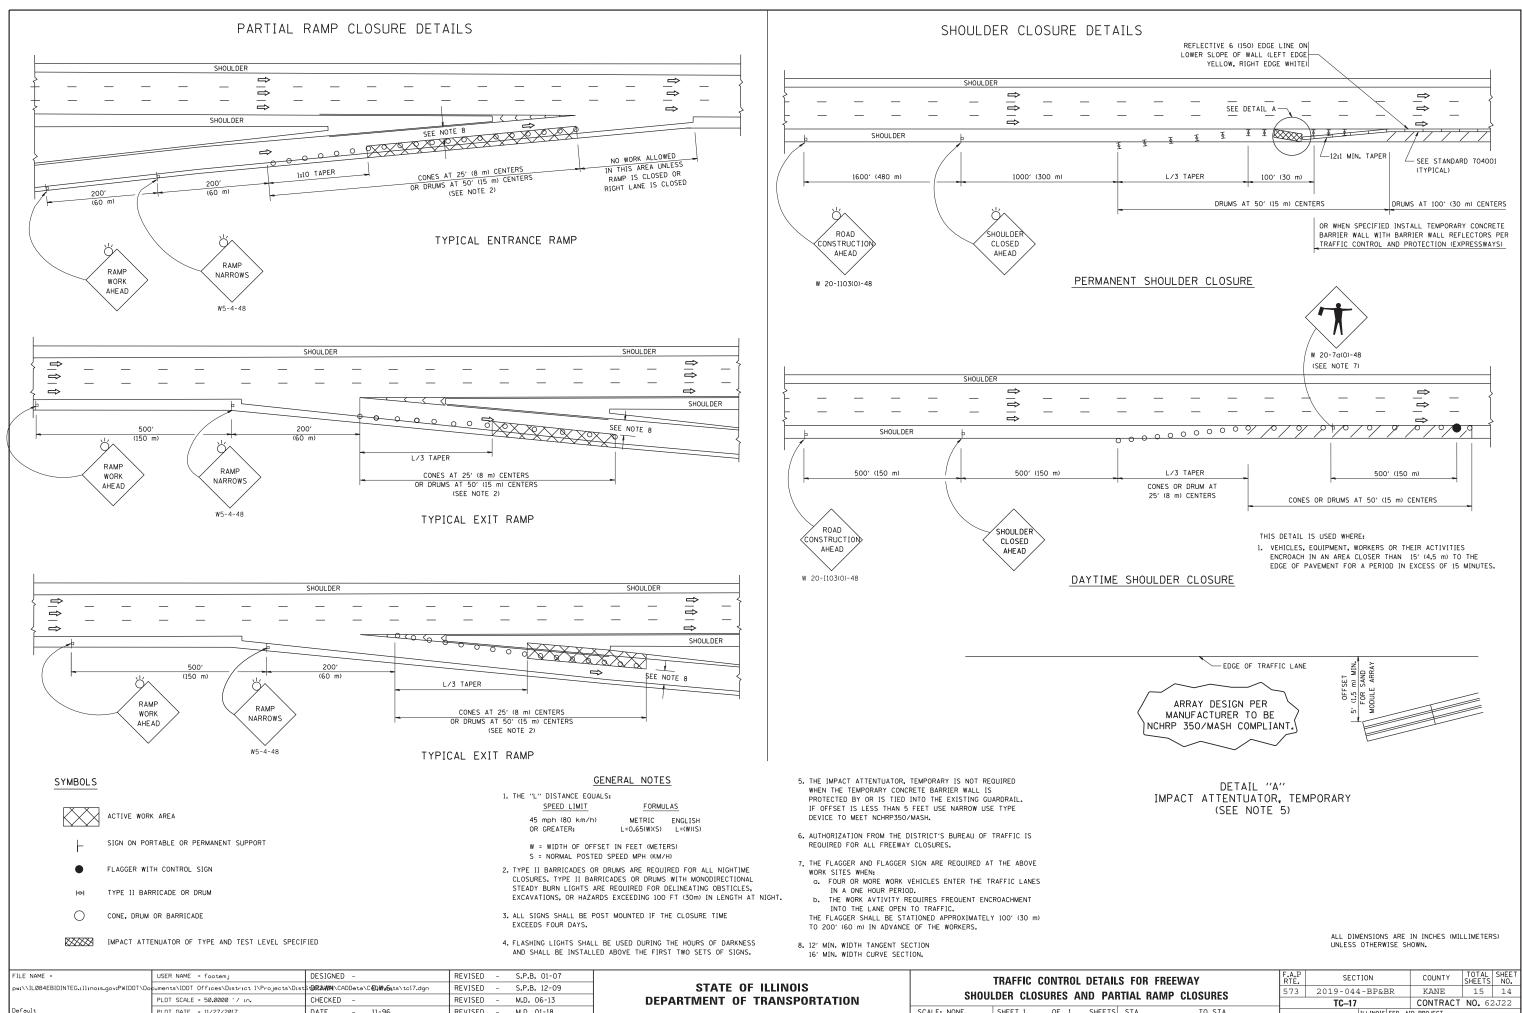

FILE NAME =	USER NAME = footemj	DESIGNED -	REVISED -	S.P.B. 01-07			TRAFFIC (CONTROL	L DETAILS FOR FR	EEWAY	F.A.P RTE	SECTION	COUNTY	TOTAL	SHEI
pw:\\IL084EBIDINTEG.1llinois.gov:PWIDOT\Do	cuments\IDOT_Offices\District_1\Projects\Dist	totORAWMINCADDeteNCADWigetsNtc17.dgn	REVISED -	S.P.B. 12-09	STATE OF ILLINOIS						573	2019-044-BP&BR	KANE	15	14
	PLOT SCALE = 50.0000 ' / in.	CHECKED -	REVISED -	M.D. 06-13	DEPARTMENT OF TRANSPORTATION	5800	LDER CLOS	SORES P	AND PARTIAL RAM	IP CLUSURES		TC-17	CONTRAC	T NO. 62	2J22
Default	PLOT DATE = 11/27/2017	DATE - 11-96	REVISED -	M.D. 01-18		SCALE: NONE	SHEET 1	OF 1	SHEETS STA.	TO STA.			AID PROJECT		
														-	-

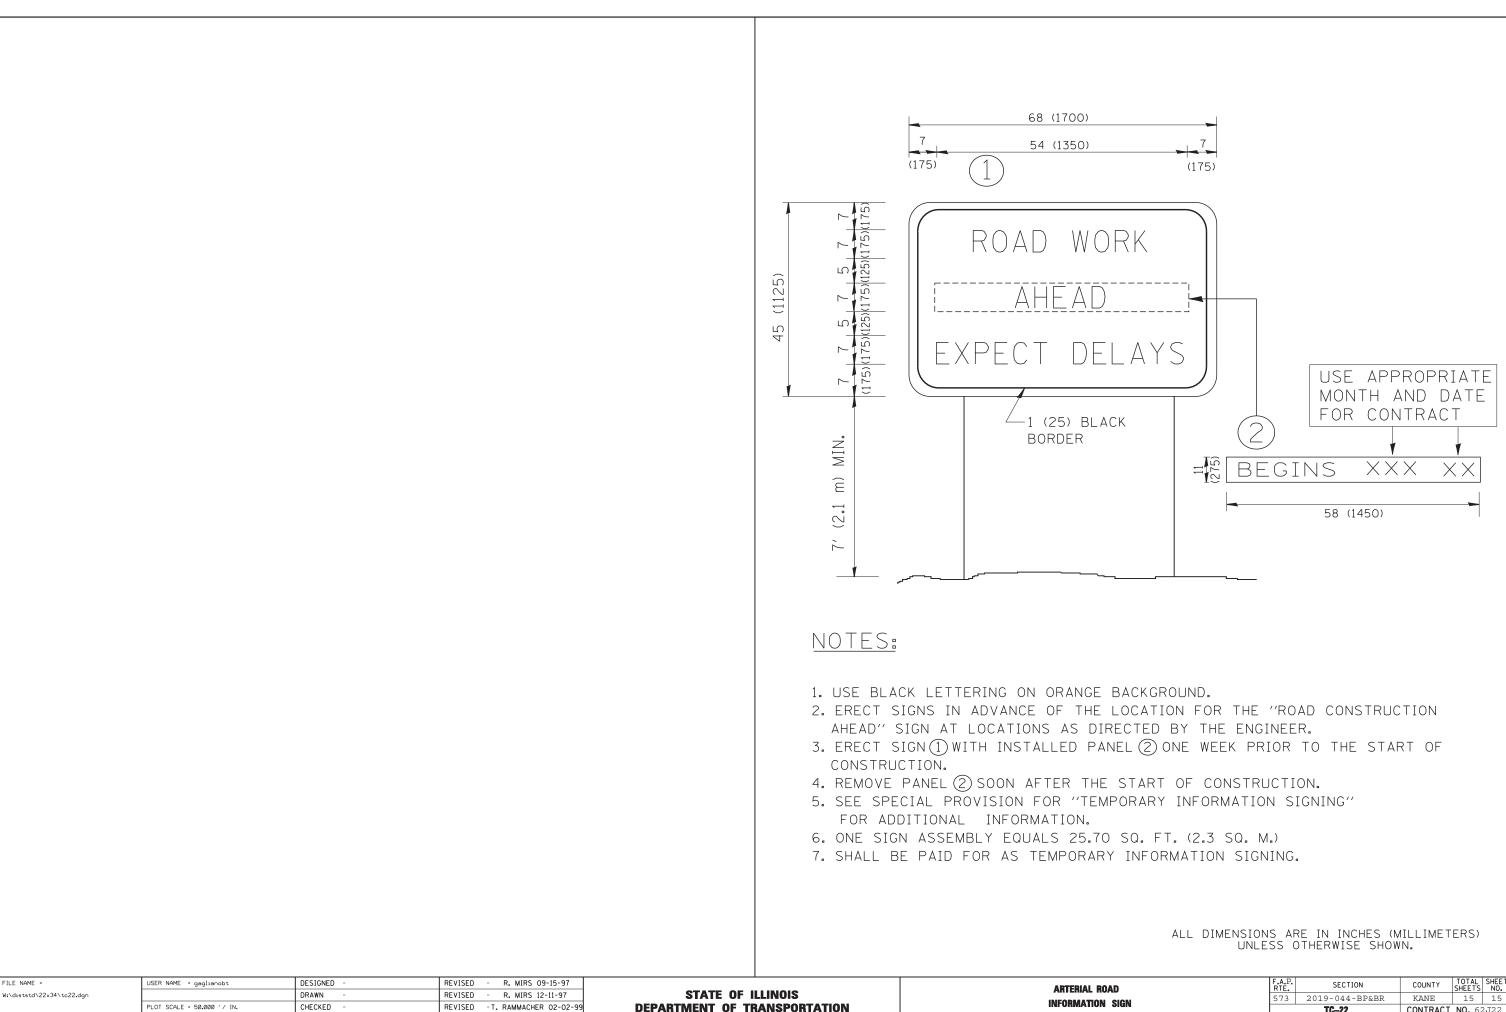

REVISED - C. JUCIUS 01-31-07

PLOT DATE = 1/4/2008

DATE

ROAD		F.A.P. RTE.	SECTION	COUNTY	TOTAL SHEETS	SHEET NO.			
N SIGN			573	2019-044-BP&BR	KANE	15	15		
N SIGN			TC-22	CONTRACT	NO. 62	2J22			
	STA.	TO STA.	FED. ROAD DIST. NO. 1 ILLINOIS FED. AID PROJECT						