06-14-2024 LETTING ITEM 117

FOR INDEX OF SHEETS, HIGHWAY STANDARDS, AND PR LEGEND SEE SHEET NO. 2

**MAIN STREET** 

DESIGN DESIGNATION
MAJOR COLLECTOR
DESIGN SPEED = 35 M.P.H.
POSTED SPEED = 30 M.P.H.
ADT (2018) = 900 VPD

0 100° 200° 300° 1°= 100° 0 10° 20° 30° 1°= 10° 0 50° 100° 1°= 50° 0 50° 100° 1°= 40° 0 50° 100° 1°= 30° 0 50° 100° 1°= 20°

FULL SIZE PLANS HAVE BEEN PREPARED USING STANDARD ENGINEERING SCALES. REDUCED SIZED PLANS WILL NOT CONFORM TO STANDARD SCALES. IN MAKING MEASUREMENTS ON REDUCED PLANS, THE ABOVE SCALES MAY BE USED.




**CONTRACT NO. 61K38** 

# STATE OF ILLINOIS DEPARTMENT OF TRANSPORTATION

# PLANS FOR PROPOSED FEDERAL-AID HIGHWAY

FAU 3899 (MAIN STREET)
700' N. OF IL ROUTE 47 TO CROSS STREET
ROADWAY RESURFACING
SECTION 23-00034-00-RS
PROJECT NUMBER: BLX9 (254)
VILLAGE OF SUGAR GROVE
KANE COUNTY
JOB NO. C-91-096-24

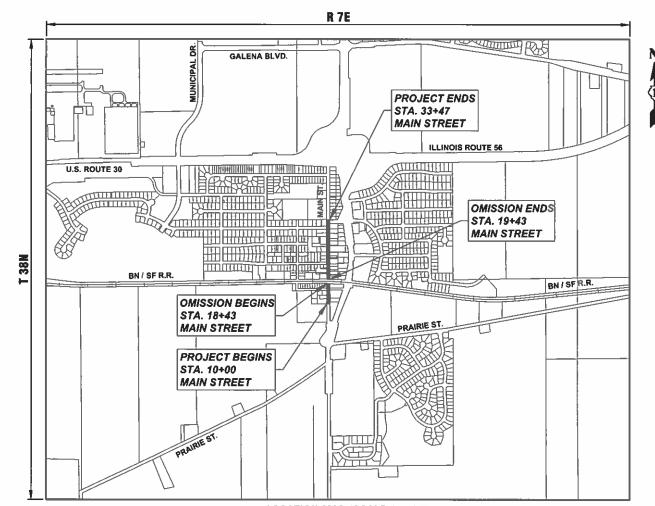


LOCATION MAP (SCALE 1"=1000')
SW 1/4 SECTION 2, T38N, R7E, SUGAR GROVE TOWNSHIP
GROSS LENGTH OF PROJECT = 2,347 FEET (0.445 MILES)
NET LENGTH OF PROJECT = 2,247 FEET (0.426 MILES)

F.A.U. RTÉ.	SECTION	COUNTY	TOTAL SHEETS	SHEET NO.
3899	23-00034-00-RS	KANE	21	1
		CONTRAC	T NO. 61	K38





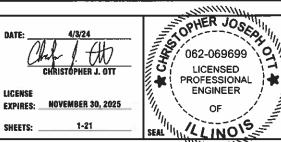



Engineering Enterprises, Inc. CONSULTING ENGINEERS 52 Wheeler Road Sugar Grove, Illinols 60554 Phone: (630) 466-6700

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AID

NO SUBSTITUTIONS OR VARIANCES WILL BE PERMITTED TO ANY STANDARD NOTES OR ORDINANCES UNLESS APPROVED OTHERWISE IN WRITING PRIOR TO COMMENCING CONSTRUCTION ACTIVITY.

ALL TRAFFIC CONTROL AND OTHER ADVISORY SIGNS NEEDED FOR CONSTRUCTION ARE TO BE FURNISHED BY THE CONTRACTOR IN ACCORDANCE WITH ARTICLE 107.14 OF THE STANDARD SPECIFICATIONS.

THE CONTRACTOR SHALL AT ALL TIMES PROVIDE PROTECTION FOR TRAFFIC AS CALLED FOR IN THE APPLICATION OF TRAFFIC CONTROL DEVICES, THE STANDARD SPECIFICATIONS, THE SPECIAL PROVISIONS AND THE PLANS

THE CONTRACTOR SHALL COOPERATE WITH THE OWNER IF ANY UTILITY IMPROVEMENTS ARE REQUIRED WITHIN THE

THE CONTRACTOR SHALL BE RESPONSIBLE FOR CONTACTING THE OWNERS OF ALL UTILITIES PRIOR TO CONSTRUCTION TO DETERMINE THE LOCATION OF ALL EXISTING AND PROPOSED UTILITY EQUIPMENT. THE CONTRACTOR SHALL COOPERATE WITH ALL UTILITY OWNERS AS PROVIDED FOR IN THE STANDARD SPECIFICATIONS IF UTILITY RELOCATION, ADJUSTMENT, OR PROTECTION IS NECESSARY.

THE LOCATION OF EXISTING DRAINAGE STRUCTURES, STORM SEWERS, WATER MAINS, SANITARY SEWERS, FIELD TILES AND ANY OTHER PUBLIC OR PRIVATE UTILITIES AS SHOWN ON THE PLANS IS APPROXIMATE AND NOT NECESSARY COMPLETE: THEIR EXACT LOCATION IS TO BE DETERMINED IN THE FIELD BY THE CONTRACTOR.

IF EXISTING UTILITY LINES OF ANY NATURE ARE ENCOUNTERED WHICH CONFLICT IN LOCATION WITH NEW CONSTRUCTION, THE CONTRACTOR SHALL NOTIFY THE ENGINEER SO THAT THE CONFLICT MAY BE RESOLVED.

UNDER NO CIRCUMSTANCES SHALL THE CONTRACTOR OPERATE ANY VALVES OR HYDRANTS.

#### STAKING

THE CONTRACTOR SHALL PROTECT AND CAREFULLY PRESERVE ALL SECTION OR SUBSECTION MONUMENTS, PROPERTY CORNERS, AND REFERENCE MARKERS UNTIL THE OWNER, THE OWNER'S AGENT, OR AN AUTHORIZED SURVEYOR HAS WITNESSED OR OTHERWISE REFERENCED THEIR LOCATIONS.

ALL OFFSET LOCATIONS GIVEN ON THE DETAILED PLANS ARE FROM THE CENTERLINE AS SHOWN ON THE PLANS.

#### MISCELL ANFOUS

THE THICKNESS OF ASPHALT MIXTURES SHOWN IN THE PLANS ARE NOMINAL. DEVIATIONS MAY OCCUR DUE TO IRREGULARITIES IN THE SURFACES OR BASES ON WHICH THE ASPHALT MIXTURES ARE TO BE PLACED.

IT IS THE CONTRACTOR'S RESPONSIBILITY TO ASCERTAIN EXISTING FIELD CONDITIONS BEFORE BIDDING ON THIS

WHERE NEW WORK MEETS EXISTING FEATURES TO REMAIN, THE CONTRACTOR SHALL FIELD CHECK ALL DIMENSIONS AND ELEVATIONS BEFORE PROCEEDING WITH CONSTRUCTION. IMMEDIATELY NOTIFY THE ENGINEER OF ANY

THE CONTRACTOR WILL BE REQUIRED TO COMPLY WITH ALL STATE REGULATIONS REGARDING AIR, WATER AND NOISE POLLUTION. THE CONTRACTOR IS PROHIBITED FROM BURNING ANY MATERIAL WITHIN OR ADJACENT TO THE

THE ENGINEER IS NOT RESPONSIBLE FOR THE CONSTRUCTION MEANS, METHODS, TECHNIQUES, SEQUENCES OR PROCEDURES, TIME OF PERFORMANCE, PROGRAMS OR FOR ANY SAFETY PRECAUTIONS USED BY THE CONTRACTOR. THE CONTRACTOR IS SOLELY RESPONSIBLE FOR EXECUTION OF THEIR WORK IN ACCORDANCE WITH THE CONTRACT DOCUMENTS AND SPECIFICATIONS.

FOR STABILIZATION, ALL TYPE III BARRICADES WILL REQUIRE A MINIMUM OF FOUR SAND BAGS PER BARRICADE.

THE CONTRACTOR SHALL MAINTAIN EXISTING SIDE STREET AND DRIVEWAY ACCESS TO EACH ABUTTING PROPERTY AT ALL TIMES DURING CONSTRUCTION OF THE PROJECT UNLESS OTHERWISE NOTED ON THE PLANS OR DIRECTED BY THE

THE CONTRACTOR SHALL DISPOSE OF AND REMOVE FROM THE SITE EACH DAY ALL CURB AND GUTTER, PAVEMENT AND ALL OTHER EXCAVATED MATERIAL NOT FOR SALVAGE

THE STORAGE OF EQUIPMENT AND/OR MATERIALS WITHIN THE RIGHT-OF-WAY OF ANY STREET AND/OR PARK

SIDEWALK REMOVAL AND REPLACEMENT AND COMBINATION CONCRETE CURB AND GUTTER REMOVAL AND REPLACEMENT AS SHOWN ON THE PLANS IS FOR INFORMATIONAL PURPOSES ONLY. ACTUAL LOCATIONS AND QUANTITIES ARE TO BE DETERMINED AND MARKED BY THE ENGINEER PRIOR TO CONSTRUCTION.

ALL EXISTING SIGNS (INCLUDING THOSE LOCATED ON UTILITY/LIGHT POLES) THAT DO NOT CONFLICT WITH THE IMPROVEMENTS SHALL REMAIN IN PLACE UNLESS DIRECTED BY THE ENGINEER.

CONTRACTOR SHALL TAKE PRECAUTION BY PRESERVING EXISTING TREES WITHIN THE RIGHT OF WAY. IF ANY DAMAGE OCCURS, TREES SHALL BE REPLACED IN KIND PER ARTICLE 201.07 REPAIR OR REPLACEMENT OF EXISTING PLANT MATERIAL REQUIREMENTS STATED HEREIN.

	IDOT HIGHWAY STANDARDS
000001-08	STANDARD SYMBOLS, ABBREVIATIONS, AND PATTERNS
280001-07	TEMPORARY EROSION CONTROL SYSTEMS
424001-11	PERPENDICULAR CURB RAMPS FOR SIDEWALKS
424006-05	DIAGONAL CURB RAMPS FOR SIDEWALKS
424011-04	CORNER PARALLEL CURB RAMPS FOR SIDEWALK
424016-05	MID-BLOCK CURB RAMPS FOR SIDEWALKS
424021-06	DEPRESSED CORNER FOR SIDEWALKS
442201-03	CLASS C AND D PATCHES
542301-03	PRECAST REINFORCED CONCRETE FLARED END SECTION
604001-05	FRAME AND LIDS TYPE 1
604006-05	FRAME AND GRATE TYPE 3
606001-08	CONCRETE CURB TYPE B AND COMBINATION CONCRETE CURB AND GUTTER
701001-02	OFF-RD OPERATIONS, 2L, 2W, MORE THAN 15' (4.5M) AWAY
701006-05	OFF-RD OPERATIONS, 2L, 2W, 15'(4.5M) TO 24" (600MM) FROM PAVEMENT EDGE
701011-04	OFF-RD MOVING OPERATIONS, 2L, 2W, DAY ONLY
701301-04	LANE CLOSURE, 2L, 2W, SHORT TIME OPERATIONS
701311-03	LANE CLOSURE, 2L, 2W, MOVING OPERATIONS - DAY ONLY
701501-06	URBAN LANE CLOSURE 2L, 2W, UNDIVIDED
701801-06	SIDEWALK, CORNER OR CROSSWALK CLOSURE
701901-09	TRAFFIC CONTROL DEVICES

SIGN PANEL MOUNTING DETAILS

SIGN PANEL ERECTION DETAILS

TYPICAL PAVEMENT MARKINGS

TELESCOPING STEEL SIGN SUPPORT

BASE FOR TELESCOPING STEEL SIGN SUPPORT

720001-01

720006-04

728001-01

731001-01

780001-05

#### **INDEX OF SHEETS**

COVER SHEET INDEX OF SHEETS, DETAILS, HIGHWAY STANDARDS, AND GENERAL NOTES 2.

3-6 SUMMARY OF QUANTITIES

7-8 TYPICAL SECTIONS SIGNING SCHEDULE

10-12 RESURFACING PLAN VILLAGE DETAILS

14-21 IDOT DISTRICT 1 DETAILS

#### IDOT DISTRICT ONE STD. SHEET. NO. 14. (BD-08) FRAMES AND LIDS ADJUSTMENT WITH MILLING (BD-22) PAVEMENT PATCHING FOR HMA SURFACED (BD-24) CURB OR CURB AND GUTTER REMOVAL AND REPLACEMENT 17. (BD-32) BUTT JOINT AND HMA TAPER DETAILS (TC-10) TRAFFIC CONTROL AND PROTECTION FOR 18.

(TC-13) TYPICAL PAVEMENT MARKINGS 19. (TC-16) SHORT TERM PAVEMENT MARKING LETTERS

SIDE ROADS, INTERSECTIONS, AND

AND SYMBOLS (TC-22) ARTERIAL ROAD INFORMATION SIGN

#### SUPPLEMENTAL LEGEND

PORTLAND CEMENT CONCRETE DRIVEWAY

HOT-MIX ASPHALT SURFACE REMOVAL, HOT-MIX ASPHALT DRIVEWAY REMOVAL

AND REPLACEMENT HOT-MIX ASPHALT SURFACE REMOVAL,

COMB CONC C&G REMOVAL AND REPLACEMENT

BUTT-JOINT

DRIVEWAY PAVEMENT REMOVAL

SIDEWALK REMOVAL AND PORTLAND CEMENT CONCRETE SIDEWALK, 5"

AGGREGATE WEDGE SHOULDER, TYPE B

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USER NAME = Kris Pung DESIGNED -REVISED DRAWN REVISED CHECKED REVISED PLOT DATE = April 3, 2024 @ 3:46 PM DATE REVISED

STATE OF ILLINOIS **DEPARTMENT OF TRANSPORTATION**  **GENERAL NOTES. HIGHWAY STANDARDS. LEGEND AND INDEX OF SHEETS** SHEET 1 OF 1 SHEETS STA. TO STA.

SCALE: N.T.S.

SECTION COUNTY 3899 23-00034-00-RS KANE CONTRACT NO. 6IK38 ILLINOIS FED. AID PROJECT

CH BACKFILL  DIL FURNISH AND PLACE, 4"  NG AND SHAPING DITCHES  NG, SALT TOLERANT  EMENTAL WATERING  DRARY EROSION CONTROL SEEDING	CU YD  SQ YD  FOOT  SQ YD  UNIT	11 630 180 630
NG AND SHAPING DITCHES  NG, SALT TOLERANT  EMENTAL WATERING	FOOT  SQ YD  UNIT	180 630
NG, SALT TOLERANT  EMENTAL WATERING	SQ YD UNIT	630
EMENTAL WATERING	UNIT	macomunication and a second
		10
DRARY EROSION CONTROL SEEDING	POUND	
	4	15
FILTERS	EACH	16
EGATE BASE COURSE, TYPE B	TON	17
INOUS MATERIALS (TACK COAT)	POUND	5,305
RE FOR CRACKS, JOINTS, AND FLANGEWAYS	TON	5
IIX ASPHALT SURFACE REMOVAL - BUTT JOINT	SQ YD	112
IIX ASPHALT BINDER COURSE, IL-9.5, N50	TON	665
IIX ASPHALT SURFACE COURSE, IL-9.5, MIX "D", N50	TON	665
AND CEMENT CONCRETE SIDEWALK 5 INCH	SQ FT	4,970
CTABLE WARNINGS	SQ FT	135
	RE FOR CRACKS, JOINTS, AND FLANGEWAYS  IIX ASPHALT SURFACE REMOVAL - BUTT JOINT  IIX ASPHALT BINDER COURSE, IL-9.5, N50  IIX ASPHALT SURFACE COURSE, IL-9.5, MIX "D", N50  AND CEMENT CONCRETE SIDEWALK 5 INCH	RE FOR CRACKS, JOINTS, AND FLANGEWAYS  TON  IX ASPHALT SURFACE REMOVAL - BUTT JOINT  SQ YD  IX ASPHALT BINDER COURSE, IL-9.5, N50  TON  IX ASPHALT SURFACE COURSE, IL-9.5, MIX "D", N50  TON  AND CEMENT CONCRETE SIDEWALK 5 INCH  SQ FT  CTABLE WARNINGS  SQ FT

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STATE OF ILLINOIS
DEPARTMENT OF TRANSPORTATION

	<b>611</b>						F.A.U. RTE.	SECTION	COUNTY	TOTAL	SHEE ND.
	SU.	MMAI	iy l	JF QUA	NTITIES	Ī	3899	23-00034-00-RS	KANE	2ì	3
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DEPARTMENT OF TRANSPORTATION

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									CONTRACT	NO. EIK	(38
SCALE: N.T.S.	SHEET 2	OF	4	SHEETS	STA.	TO STA.		LLINOIS FED. AL	PROJECT		

CODE NU	IMBER ITEM DESCRIPTION	UNIT	ROADWAY 75% FEDERAL 25% LOCAL 0005
44000	161 HOT-MIX ASPHALT SURFACE REMOVAL, 3"	SQ YD	7,860
44000	200 DRIVEWAY PAVEMENT REMOVAL	SQ YD	50
44000	500 COMBINATION CURB AND GUTTER REMOVAL	FOOT	580
44000	600 SIDEWALK REMOVAL	SQ FT	5,060
44201	745 CLASS D PATCHES, TYPE III, 8 INCH	SQ YD	40
44201	747 CLASS D PATCHES, TYPE IV, 8 INCH	SQ YD	80
48102	100 AGGREGATE WEDGE SHOULDER, TYPE B	. TON	30
50105	220 PIPE CULVERT REMOVAL	FOOT	128
542A0	PIPE CULVERTS, CLASS A, TYPE 1, 12"	FOOT	128
542136	PRECAST REINFORCED CONCRETE FLARED END SECTIONS, 12"	EACH	8
60255	500 MANHOLES TO BE ADJUSTED	EACH	14
60260	100 INLETS TO BE ADJUSTED	EACH	14
60266	600 VALVE BOXES TO BE ADJUSTED	EACH	3
60404	300 FRAME AND GRATES, TYPE 3	EACH	12
60605	000 COMBINATION CONCRETE CURB AND GUTTER, TYPE B-6.24	FOOT	585

Δ INDICATES SPECIALTY ITEM

	CODE NUMBER	ITEM DESCRIPTION	UNIT	75% FEDERAL 25% LOCAL 0005
Δ	66900200	NON-SPECIAL WASTE DISPOSAL	CU YD	11
Δ	66900530	SOIL DISPOSAL ANALYSIS	EACH	. 1
Δ	66901001	REGULATED SUBSTANCES PRE-CONSTRUCTION PLAN	L SUM	1
Δ	66901003	REGULATED SUBSTANCES FINAL CONSTRUCTION REPORT	L SUM	1
Δ	66901006	REGULATED SUBSTANCES MONITORING	CAL DA	3
	67100100	MOBILIZATION	L SUM	1
	70102620	TRAFFIC CONTROL AND PROTECTION, STANDARD 701501	L SUM	1
	70102640	TRAFFIC CONTROL AND PROTECTION, STANDARD 701801	L SUM	1
	70300100	SHORT TERM PAVEMENT MARKING	FOOT	1125
	70300150	SHORT TERM PAVEMENT MARKING REMOVAL	SQ FT	375
	70300221	TEMPORARY PAVEMENT MARKING - LINE 4" - PAINT	FOOT	1125
Δ	72000100	SIGN PANEL - TYPE 1	SQFT	131.5
	72400100	REMOVE SIGN PANEL ASSEMBLY - TYPE A	EACH	1
	72400200	REMOVE SIGN PANEL ASSEMBLY - TYPE B	EACH	3
	72400310	REMOVE SIGN PANEL, TYPE 1	SQFT	53
7 INI	DICATES SPECIALT	Y ITEM		

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SUMMARY OF QUANTITIES						3899	23-00034-00-RS	KANE	21	5		
										CONTRACT	NO. GII	K38
SCALE: N.T.S.	SHEET	3	OF	4	SHEETS	STA.	TO STA.		LLINOIS FED. AX	PROJECT		

ROADWAY

COD	DE NUMBER	ITEM DESCRIPTION	UNIT	ROADWAY 75% FEDERAL 25% LOCAL 0005
7	2800100	TELESCOPING STEEL SIGN SUPPORT	FOOT	75 .
, , ,	78000100	THERMORI ACTIO DAVEMENT MARKING, LETTERO A CVAROLO	20.57	400
7	8000100	THERMOPLASTIC PAVEMENT MARKING - LETTERS & SYMBOLS	SQ FT	132
7	8000200	THERMOPLASTIC PAVEMENT MARKING - LINE 4"	FOOT	7,044
7	78000400	THERMOPLASTIC PAVEMENT MARKING - LINE 6"	FOOT	95
7	8000600	THERMOPLASTIC PAVEMENT MARKING - LINE 12"	FOOT	550
7	8000650	THERMOPLASTIC PAVEMENT MARKING - LINE 24"	FOOT	135
X	(6026050	SANITARY MANHOLES TO BE ADJUSTED	EACH	1
X	X003435	PORTLAND CEMENT CONCRETE DRIVEWAY REMOVAL AND REPLACEMENT	SQ YD	20
×	X006947	HOT-MIX ASPHALT DRIVEWAY REMOVAL AND REPLACEMENT	SQ YD	876
Z	0030850	TEMPORARY INFORMATION SIGNING	SQ FT	51.4
Z	0048665	RAILROAD PROTECTIVE LIABILITY INSURANCE	L SUM	1

Δ INDICATES SPECIALTY ITEM


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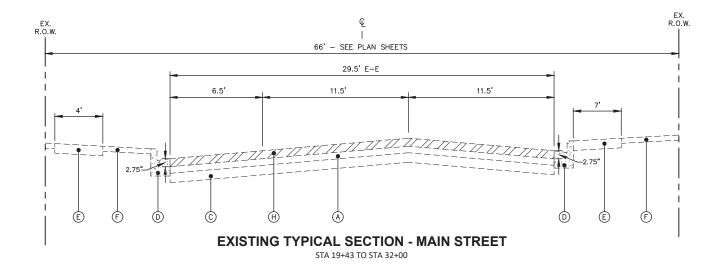
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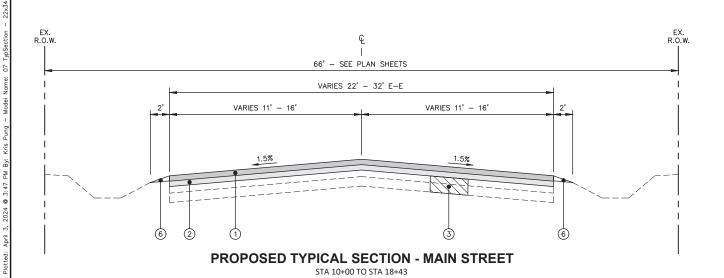
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DEPARTMENT OF TRANSPORTATION


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SUMMARY OF QUANTITIES				3899	23-00034-00-RS	KANE	21	6					
											CONTRACT	NO. 6IK	38
	SHEET	4	OF	4	SHEETS	STA.	TO	STA.		ELSHOIS FEO. A	O PROJECT		







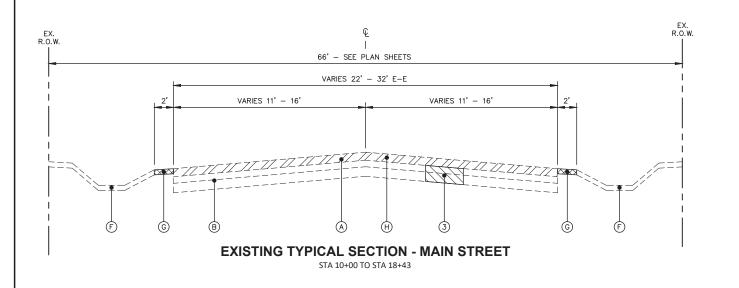
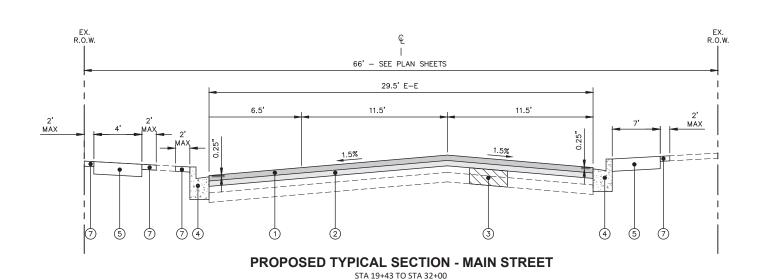
#### HOT-MIX ASPHALT MIXTURE REQUIREMENTS

# EXISTING LEGEND (A) EXISTING HOT-MIX ASPHALT PAVEMENT (4.25" - 11") (B) EXISTING CONCRETE BASE COURSE (0" - 6") (C) EXISTING AGGREGATE BASE COURSE (0" - 7") (D) EXISTING COMBINATION CONCRETE CURB & GUTTER. B6.24 (E) EXISTING PORTLAND CEMENT CONCRETE SIDEWALK (F) EXISTING PARKWAY (G) EXISTING AGGREGATE SHOULDER (H) HOT-MIX ASPHALT SURFACE REMOVAL, 3"

OPERATION	MIXTURE TYPE	AIR VOIDS NDES	QMP
PAVEMENT RESURFACING	HOT-MIX ASPHALT SURFACE COURSE, IL-9.5, MIX "D", N50, 1.5" HOT-MIX ASPHALT BINDER COURSE, IL-9.5, N50, 1.5"	4% @ 50 GYR. 4% @ 50 GYR.	LR1030-2 LR1030-2
CLASS D PATCHES	HOT-MIX ASPHALT BINDER COURSE, IL-19.0, N70, 8"	4% @ 70 GYR.	LR1030-2
HOT-MIX ASPHALT DRIVEWAY REMOVAL AND REPLACEMENT	HOT-MIX ASPHALT SURFACE COURSE, IL-9.5, MIX "D", N50, 2"	4% @ 50 GYR.	LR1030-2
	QMP DESIGNATION: QUALITY CONTROL/QUALITY ASSURANCE (QC/QA) PER LR 1030-2.		

THE UNIT WEIGHT TO CALCULATE ALL HMA SURFACE MIXTURE QUANTITIES IS 112 LBS/SQ YD/IN

THE "AC TYPE" FOR POLYMERIZED HMA MIXES SHALL BE "SBS/SBR PG 76-22" AND FOR NON-POLYMERIZED HMA THE "AC TYPE" SHALL BE "PG 64-22". UNLESS MODIFIED BY RECLAIMED MATERIALS SPECIFICATIONS.

SCALE: N.T.S.

#### PROPOSED LEGEND

- 1) HOT-MIX ASPHALT SURFACE COURSE, IL-9.5, MIX "D", N50, 1.5"
- 2 HOT-MIX ASPHALT BINDER COURSE, IL-9.5, N50, 1.5"
- (3) CLASS D PATCH, 8" (LOCATIONS TO BE DETERMINED BY ENGINEER)
- (4) COMBINATION CONCRETE CURB AND GUTTER REMOVAL AND REPLACEMENT (SPOT REMOVAL AND REPLACEMENT AS DIRECTED BY THE ENGINEER)
- 5 SIDEWALK REMOVAL AND PORTLAND CEMENT CONCRETE SIDEWALK, 5" (SPOT LOCATIONS AS DIRECTED BY ENGINEER)
- (6) AGGREGATE WEDGE SHOULDER, TYPE B
- 7) TOPSOIL AND SODDING, SALT TOLERANT

NOTES: THE PATCHING QUANTITIES HAVE BEEN ESTIMATED BASED ON FIELD OBSERVATIONS DURING DESIGN. ACTUAL QUANTITIES TO BE DETERMINED DURING CONSTRUCTION.

NO PROPOSED WORK WILL TAKE PLACE OUTSIDE OF THE R.O.W. STA 18+43 TO STA 19+43 IS OMITTED FOR BNSF R.O.W.


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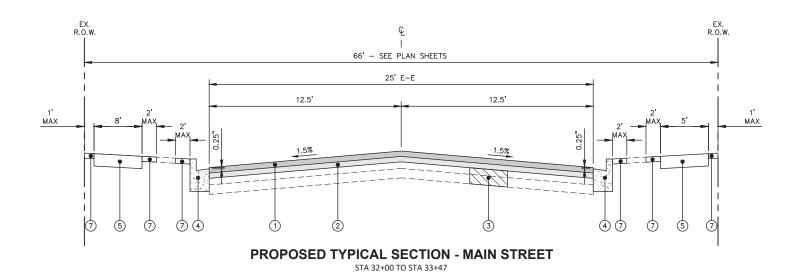
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PLOT SCALE =	CHECKED -	REVISED -
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STATE OF ILLINOIS
DEPARTMENT OF TRANSPORTATION

TYPICAL SECTIONS									
I TPICAL SEC	IION2		3899						
SHEET 1 OF 2 SHEET	TC CTA	AT2 OT		_					

.U.	SECTION	COUNTY	TOTAL SHEETS	SHEET NO.
99	23-00034-00-RS	KANE	21	7
		CONTRACT N	IO. 6IK	38



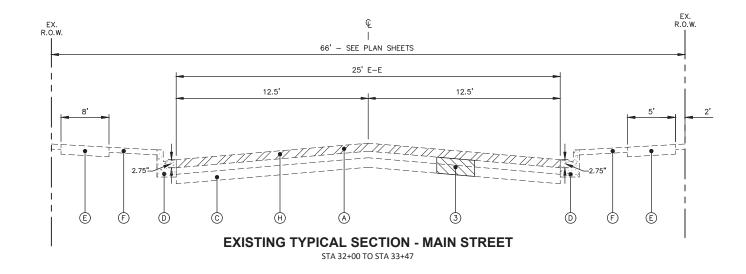

#### **EXISTING LEGEND**

- A EXISTING HOT-MIX ASPHALT PAVEMENT (4.25" 11")
- B EXISTING CONCRETE BASE COURSE (0" 6")
- © EXISTING AGGREGATE BASE COURSE (0" 7")
- (D) EXISTING COMBINATION CONCRETE CURB & GUTTER. B6.24
- E EXISTING PORTLAND CEMENT CONCRETE SIDEWALK
- F EXISTING PARKWAY
- - G EXISTING AGGREGATE SHOULDER
  - H) HOT-MIX ASPHALT SURFACE REMOVAL, 3"

#### PROPOSED LEGEND

- 1) HOT-MIX ASPHALT SURFACE COURSE, IL-9.5, MIX "D", N50, 1.5"
- 2 HOT-MIX ASPHALT BINDER COURSE, IL-9.5, N50, 1.5"
- (3) CLASS D PATCH, 8" (LOCATIONS TO BE DETERMINED BY ENGINEER)
- (4) COMBINATION CONCRETE CURB AND GUTTER REMOVAL AND REPLACEMENT (SPOT REMOVAL AND REPLACEMENT AS DIRECTED BY THE ENGINEER)
- (5) SIDEWALK REMOVAL AND PORTLAND CEMENT CONCRETE SIDEWALK, 5" (SPOT LOCATIONS AS DIRECTED BY ENGINEER)
- (6) AGGREGATE WEDGE SHOULDER, TYPE B
- 7) TOPSOIL AND SODDING, SALT TOLERANT

NOTES: THE PATCHING QUANTITIES HAVE BEEN ESTIMATED BASED ON FIELD OBSERVATIONS DURING DESIGN. ACTUAL QUANTITIES TO BE DETERMINED DURING CONSTRUCTION.

NO PROPOSED WORK WILL TAKE PLACE OUTSIDE OF THE R.O.W.

STA 18+43 TO STA 19+43 IS OMITTED FOR BNSF R.O.W.

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CONSULTING ENGINEERS	Γ
52 Wheeler Road Sugar Grove, Illinois 60554	Г
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ı	USER NAME = Kris Pung	DESIGNED -	REVISED -
		DRAWN -	REVISED -
	PLOT SCALE =	CHECKED -	REVISED -
	PLOT DATE = April 3, 2024 @ 3:47 PM	DATE -	REVISED -

STATE OF ILLINOIS
DEPARTMENT OF TRANSPORTATION

TYPICAL SECTIONS									
SCALE: N.T.S.	SHEET	2	OF	2	SHEETS	STA.	TO STA.		


	Main Street											
						Signing Sc	hedule					
			72000100	72400100	72400200	72400310	72800100					
Station	O/S	Sign Dimensions	SIGN PANEL - TYPE 1	REMOVE SIGN PANEL ASSEMBLY - TYPE A		REMOVE SIGN PANEL, TYPE 1	TELESCOPING STEEL SIGN SUPPORT	MUTCD Designation	Description			
			(Sq Ft)	(Each)	(Each)	(Sq Ft)	(Ft)					
14+50	15' RT	36"x36", 30"x24"	14	0	1	0	15	W10-1, W10-9P	Grade Crossing Advance Warning, No Train Horn Plaque			
20+00	25' RT	24"x24"	4	0	0	4	0	R8-3	No Parking			
20+65	25' RT	36"x36", 24"x12"	11	1	0	0	15	S1-1, W16-9P	School Crossing, Ahead			
21+15	25' LT	12"x18"	1.5	0	0	0	15	R7-8	Handicap Parking			
22+50	16' LT	36"X36", 30"X24"	14	0	1	0	15	W10-1, W10-9P	Grade Crossing Advance Warning, No Train Horn Plaque			
22+75	25' RT	36"x36", 24"x12"	11	0	0	6.25	0	S1-1, W16-7P	School Crossing, Diagonal Arrow			
23+14	16' LT	36"x36", 24"x12"	11	0	0	6.25	0	S1-1, W16-7P	School Crossing, Diagonal Arrow			
24+30	25' RT	24"x24"	4	0	0	4	0	R8-3	No Parking			
24+75	17' LT	36"x36", 24"x12"	11	0	1	0	15	S1-1, W16-9P	School Crossing, Ahead			
26+00	25' RT	36"x36", 24"x12"	11	0	0	6.25	0	S1-1, W16-9P	School Crossing, Ahead			
27+95	25' RT	24"x48", 24"x24"	12	0	0	8	0	S4-I100, R2-6	School Zone Speed Limit (20 MPH), Fines Higher Plaque			
30+25	25' RT	36"x36", 24"x12", 24"x24"	15	0	0	10.25	0	S1-1, W16-7P, R8-3	School Crossing, Diagonal Arrow, No Parking			
33+25	15' RT	24"x48", 24"x24"	12	0	0	8	0	S4-I100, R2-6	School Zone Speed Limit (20 MPH), Fines Higher Plaque			
		Total:	131.5	1	3	53	75					


Engineering Enterprises, Inc.	Ū
CONSULTING ENGINEERS	Г
52 Wheeler Road Sugar Grove, Illinois 60554	F
630.466.6700 / www.eeiweb.com	F


USER NAME = Kris Pung	DESIGNED -	REVISED -
	DRAWN -	REVISED -
PLOT SCALE =	CHECKED -	REVISED -
PLOT DATE = April 3, 2024 @ 3:47 PM	DATE -	REVISED -

STATE OF ILLINOIS
DEPARTMENT OF TRANSPORTATION

		CI	CNI	NC	COLLEG			F.A.U. RTE.	SECTION	COUNTY	TOTAL SHEETS	SHEET NO.
SIGNING SCHEDULE							3899	23-00034-00-RS	KANE	21	9	
										CONTRACT	NO. 6IK	38
SCALE: N.T.S. SHEET 1 OF 1 SHEETS STA. TO STA.							ILLINOIS FED. A	ID PROJECT		+50		
	SCALE: N.T.S.	SCALE: N.T.S. SHEET					SCALE: N.T.S. SHEET 1 OF 1 SHEETS STA.		SIGNING SCHEDULE 3899	SIGNING SCHEDULE 3899 23-00034-00-RS	SIGNING SCHEDULE  3899 23-00034-00-RS KANE CONTRACT	SIGNING SCHEDULE         RTE.         SECTION         COUNTY   SHEETS           3899         23-00034-00-RS         KANE         21           CONTRACT NO.         61K

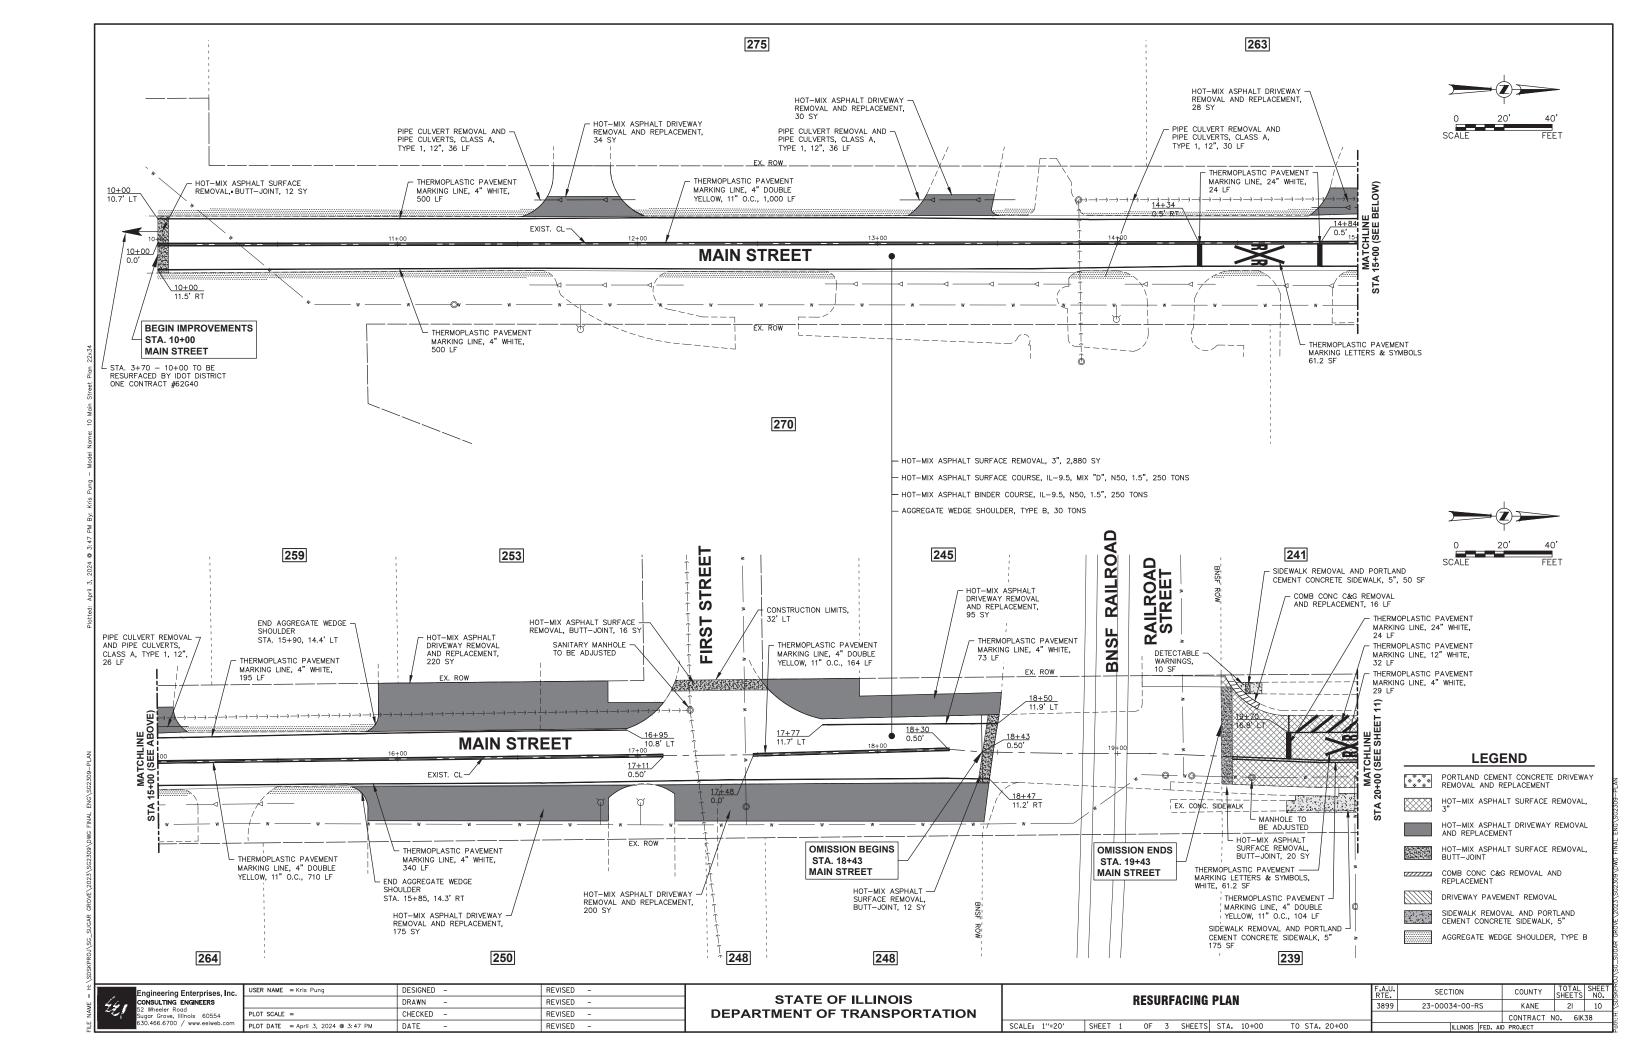

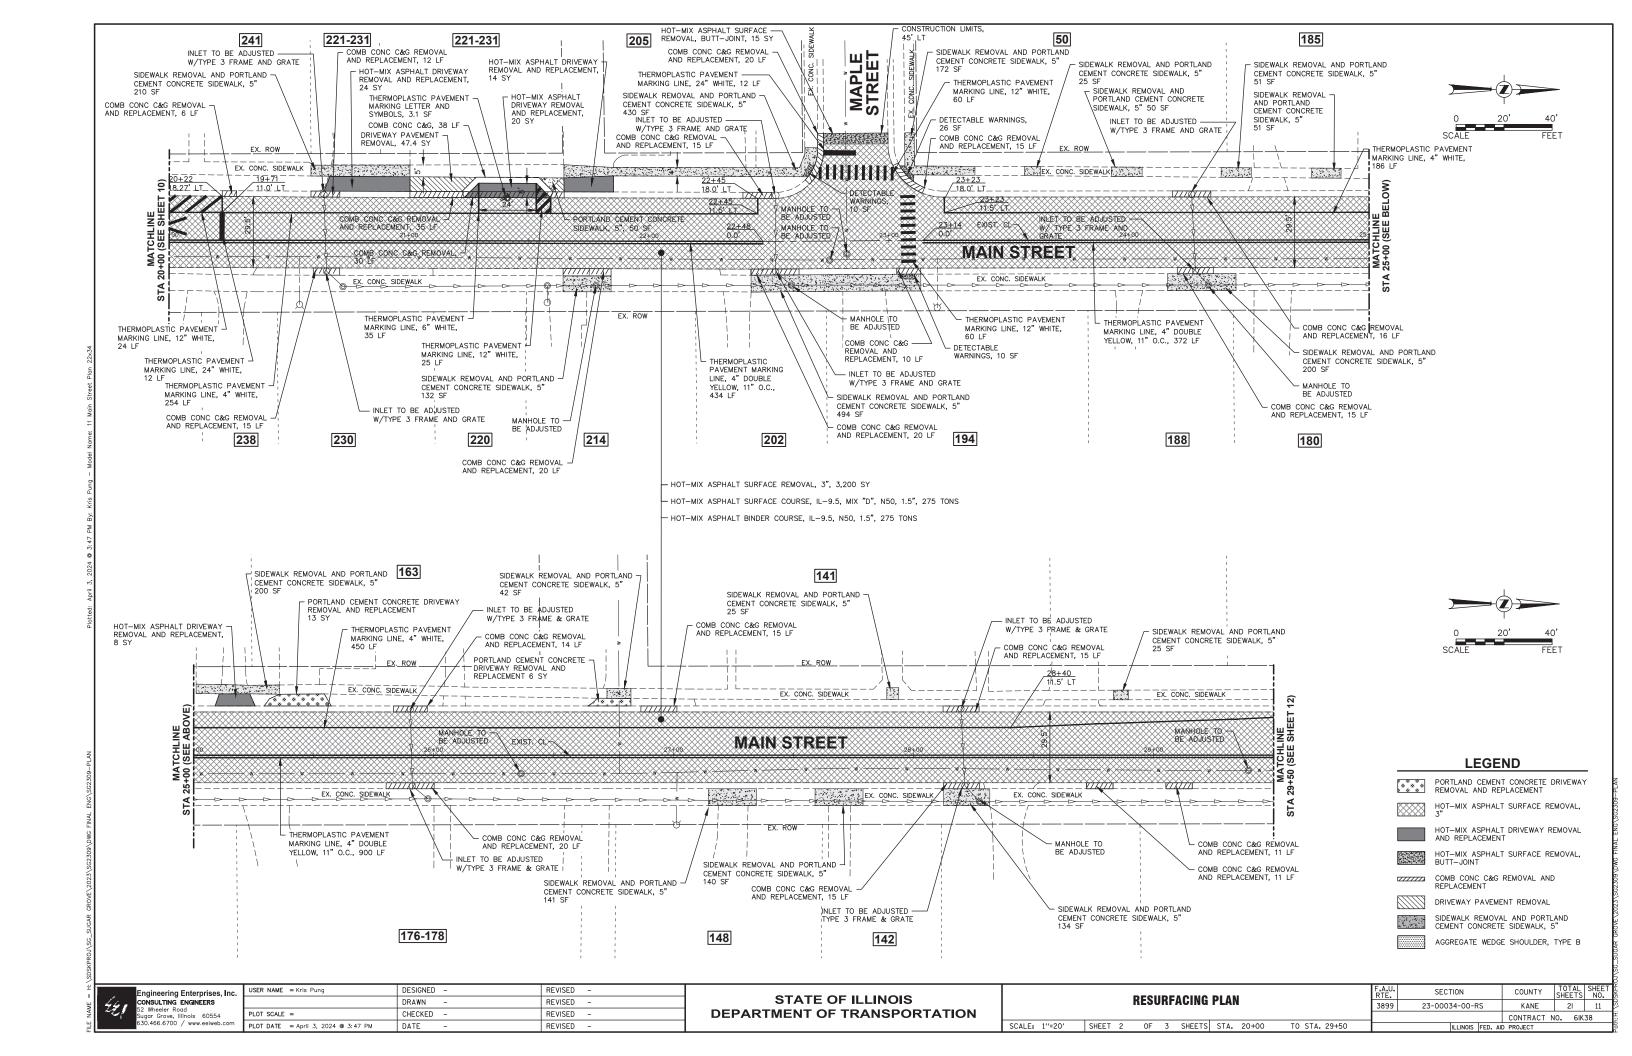

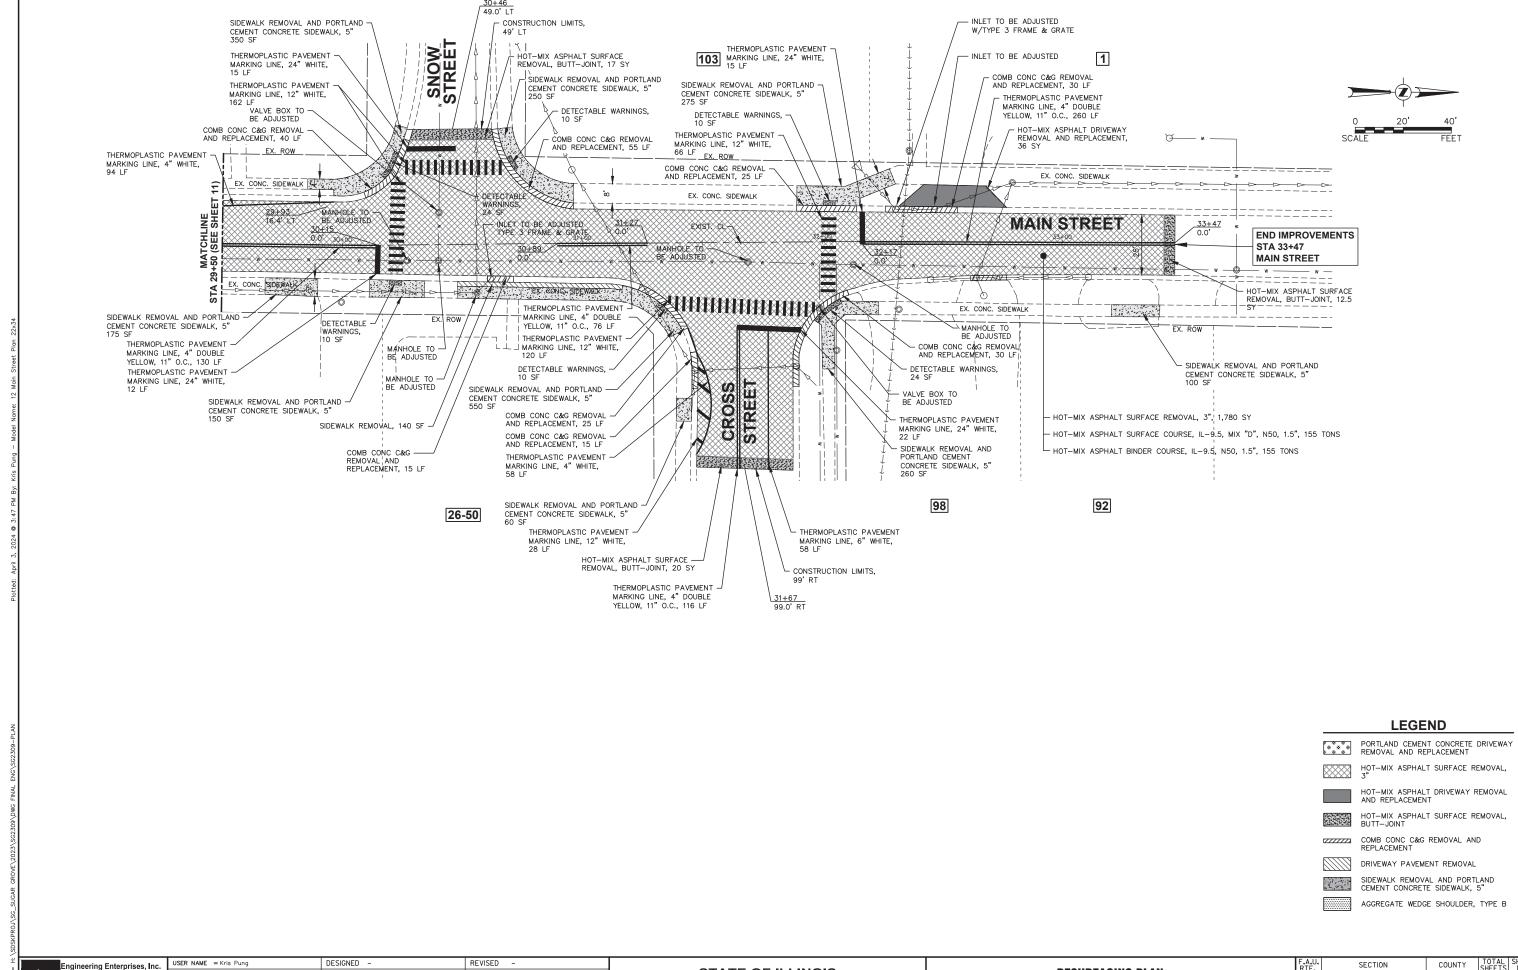


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STATE OF ILLINOIS
DEPARTMENT OF TRANSPORTATION

RESURFACING PLAN

SCALE: 1"=20' SHEET 3 OF 3 SHEETS STA. 29+50 TO STA. 33+47

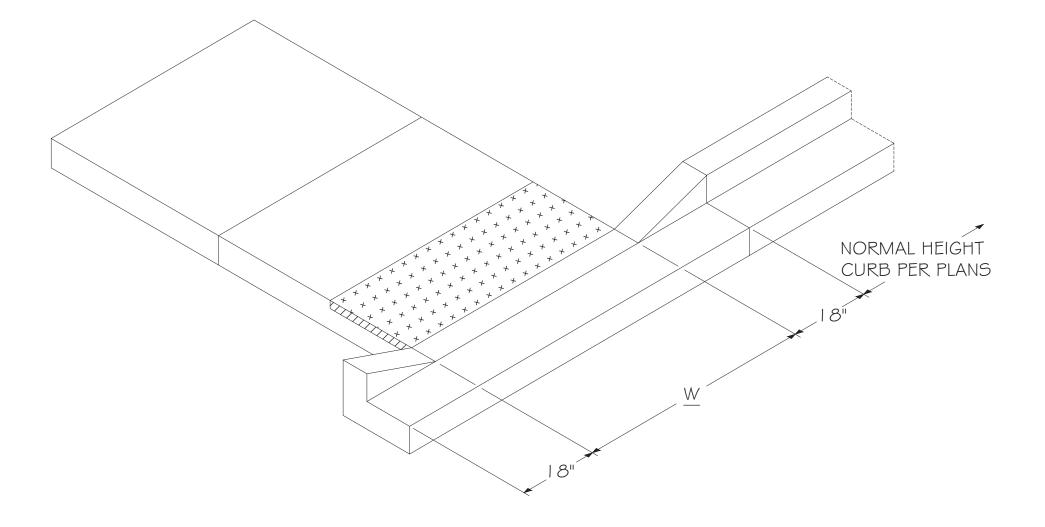

#### NOTES:

- I. PLACEMENT OF DETECTABLE
  WARNING TILES SHALL ADHERE TO
  LOCATIONS

  \$ SETBACKS AS SHOWN IN IDOT
  HIGHWAY STANDARDS INCLUDING
  424001, 424006, 424016,
  424021, AND 424026 FOR
  VARIOUS FIELD CONDITIONS.
  SIDEWALK RAMP WIDTH (W) AND
  LAYOUT SHALL BE ACCORDING TO
  THESE IDOT HIGHWAY STANDARDS,
  EXCEPT A SIDE CURB SHALL NOT BE
  CONSTRUCTED IN LANDSCAPED
  AREAS.
- 2. DETECTABLE WARNING TILES SHALL BE BRICK RED AND MANUFACTURED BY ADA SOLUTIONS, INC.
- 3. TILES SHALL BE INSTALLED PER MANUFACTURER INSTRUCTIONS.
- 4. THE COLORING AND STAMPING OF CONCRETE WILL NOT BE ALLOWED.



### **Village of Sugar Grove**

SCALE: N.T.S.

10 Municipal Drive Sugar Grove, Illinois 60554 Phone: (630) 466-4507 CURB HEAD TAPER AT PEDESTRIAN RAMPS FOR SIDEWALK IN LANDSCAPED AREAS

SCALE: N.T.S.

DATE: 11/15/22

DETAIL NUMBER
MONT. E:\DETAILS\

DRAWN: KKP

REVISED: \_\_\_


Engineering Enterprises, Inc.
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52 Wheeler Road
Sugar Grove, Illinois 60554
630.466.6700 / www.eeiweb.com

DRAWN         -         REVISED         -           PLOT SCALE         -         CHECKED         -         REVISED         -           PLOT DATE         -         April 3, 2024 © 3:47 PM         DATE         -         REVISED         -	USER NAME = Kris Pung	DESIGNED -	REVISED -
		DRAWN -	REVISED -
PLOT DATE = April 3, 2024 @ 3:47 PM	PLOT SCALE =	CHECKED -	REVISED -
	PLOT DATE = April 3, 2024 @ 3:47 PM	DATE -	REVISED -

STATE OF ILLINOIS	
DEPARTMENT OF TRANSPORTATION	

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		ILLINOIS	FED.	AID	PROJECT	_		

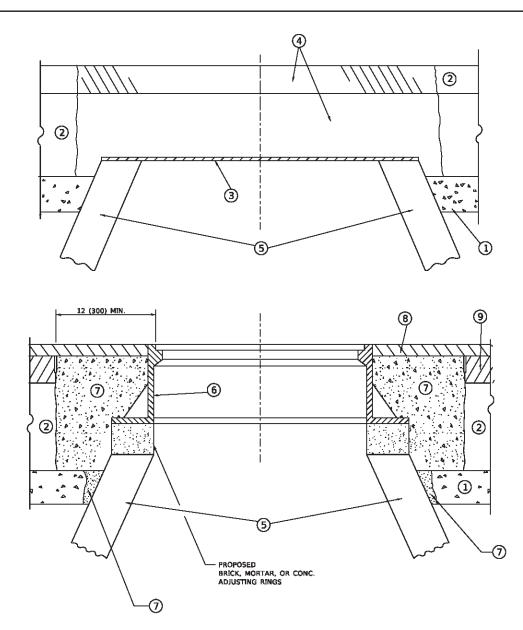

#### DETAILS FOR FRAMES AND LIDS ADJUSTMENT WITH MILLING

#### NOTES

- 1. EXISTING BROKEN FRAMES AND LIDS SHALL BE REMOVED AND DISPOSED OF BY THE CONTRACTOR AND SHALL BE REPLACED AS DIRECTED BY THE ENGINEER. REPLACEMENT FRAMES AND LIDS WILL BE PAID FOR IN ACCORDANCE WITH ARTICLE 109.04 OF THE STANDARD SPECIFICATIONS UNLESS A SEPARATE PAY ITEM HAS BEEN PROVIDED.
- 2. IF THE EXISTING LIDS ARE OPEN, THE FRAME WILL BE ADJUSTED TO THE ELEVATION OF THE MILLED PAVEMENT SURFACE PRIOR TO THE MILLING OPERATION. THE FRAME WILL NOT BE REMOVED AND COVERED BY THE METAL PLATE.
- CITY OF CHICAGO CASTINGS ARE THE PROPERTY OF THE CITY AND THE CONTRACTOR SHALL NOTIFY THE CITY FOR REMOVAL AND DISPOSITION OF THE CASTINGS.
- THE METAL PLATE USED TO COVER THE STRUCTURE SHALL REMAIN THE PROPERTY OF THE CONTRACTOR.
- THE CONTRACTOR SHALL REMOVE ALL TRAFFIC CONTROL DEVICES BY THE END OF EACH WORK SHIFT.

#### **CONSTRUCTION PROCEDURES**

#### STAGE 1 (BEFORE PAVEMENT MILLING)

- A) REMOVE A MINIMUM OF 12 (300) OF THE PAVEMENT FROM AROUND THE STRUCTURE.
- B) REMOVE THE EXISTING FRAME AND LID FROM THE STRUCTURE.
- C) COVER THE STRUCTURE OPENING WITH A 36 (900) DIAMETER METAL PLATE.
- D) BACKFILL WITH CRUSHED STONE AND HMA SURFACE MIX APPROVED BY THE ENGINEER. (MIN. 3 (80) HMA TO REMAIN AFTER MILLING).

#### STAGE 2 (AFTER PAVEMENT MILLING)

- A) REMOVE THE HMA SURFACE MIX AND CRUSHED STONE.
- B) INSTALL THE FRAME AND LID; ADJUST THE FRAME TO ITS FINAL SURFACE ELEVATION.
- C) THE SURROUNDING SPACE SHALL BE FILLED WITH CLASS PP-2\* CONCRETE TO THE ELEVATION OF THE SURFACE OF THE EXISTING BASE COURSE OR THE BINDER COURSE.
- \*UNLESS OTHERWISE SPECIFIED IN THE PLANS.

THE PROCEDURE EXPLAINED ABOVE SHALL CONFORM TO THE APPLICABLE PORTIONS OF SECTIONS 353, 406, 602, AND 603 OF THE STANDARD SPECIFICATIONS EXCEPT THAT "THE CONTRACTOR SHALL ADJUST THE STRUCTURES TO THE FINISHED PAVEMENT ELEVATION NO MORE THAN 5 CALENDAR DAYS PRIOR TO PLACEMENT OF THE FINAL LIFT OF SURFACE UNLESS APPROVED BY THE ENGINEER."

#### **LEGEND**

- 1 SUB-BASE GRANULAR MATERIAL
- (6) FRAME AND LID (SEE NOTES)
- 2 EXISTING PAVEMENT
- (7) CLASS PP-2\* CONCRETE
- 3 36 (900) DIAMETER METAL PLATE
- (8) PROPOSED HMA SURFACE COURSE
- 4 PROPOSED CRUSHED STONE AND HMA SURFACE MIX
- (5) EXISTING STRUCTURE
- 9 PROPOSED HMA BINDER COURSE

#### **LOCATION OF STRUCTURES**

THE CONTRACTOR WILL BE REQUIRED TO KEEP A RECORD OF THE LOCATIONS OF THE BURIED STRUCTURES ACCORDING TO THE STATION AND DISTANCE LEFT OR RIGHT OF THE CENTERLINE OF PAVEMENT. UPON COMPLETION OF THE WORK, THE CONTRACTOR WILL DELIVER THE RECORD TO THE ENGINEER.

#### BASIS OF PAYMENT

- 1. REMOVING FRAMES AND LIDS ON DRAINAGE AND UTILITY STRUCTURES IN THE PAVEMENT PRIOR TO MILLING, AND ADJUSTING TO FINAL GRADE PRIOR TO PLACING THE SURFACE COURSE, WILL BE PAID FOR AT THE CONTRACT UNIT PRICE EACH FOR "FRAMES AND LIDS TO BE ADJUSTED (SPECIAL)."
- 2. THIS WORK WILL NOT BE PAID FOR WHEN DRAINAGE AND UTILITY STRUCTURES ARE SPECIFIED FOR PAYMENT AS STRUCTURE RECONSTRUCTION.
- NEW FRAMES AND LIDS, WHEN SPECIFIED, WILL BE PAID FOR SEPARATELY.
- 4. WHEN STRUCTURES ARE TO BE ADJUSTED OR RECONSTRUCTED, THE LOWERING AND RAISING OF THE FRAMES AND LIDS WILL NOT BE PAID FOR SEPARATELY BUT WILL BE INCLUDED IN THE COST OF THE CORRESPONDING PAY ITEM.

ALL DIMENSIONS ARE IN INCHES (MILLIMETERS) UNLESS OTHERWISE SHOWN

Engineering Enterprises, Inc. CONSULTING ENGINEERS 52 Wheeler Road Sugar Grove, Illinois 60554 630.466.6700 / www.eeiweb.com

 USER NAME
 = Lawrence.DeMarche
 DESIGNED
 R. SHAH
 REVISED
 R. BORO 03-09-11

 DRAWN
 REVISED
 R. BORO 12-05-11

 PLOT SCALE
 = 100.0000 ' / in.
 CHECKED
 REVISED
 K. SMITH 11-18-22

 PLOT DATE
 = 9/15/2023
 DATE
 10-25-94
 REVISED
 K. SMITH 09-15-23

STATE OF ILLINOIS
DEPARTMENT OF TRANSPORTATION

DETAILS FOR
FRAMES AND LIDS ADJUSTMENT WITH MILLING


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#### **METHOD OF MEASUREMENT**

REFER TO SECTION 442 OF THE STANDARD SPECIFICATIONS FOR ROAD AND BRIDGE CONSTRUCTION AND THE RECURRING SPECIAL PROVISION "PATCHING WITH HOT-MIX ASPHALT OVERLAY REMOVAL."

#### **BASIS OF PAYMENT**

- 1. REFER TO SECTION 442 OF THE STANDARD SPECIFICATIONS FOR ROAD AND BRIDGE CONSTRUCTION AND THE RECURRING SPECIAL PROVISION "PATCHING WITH HOT-MIX ASPHALT OVERLAY REMOVAL."
- SAW CUT/SCORING OF EXISTING HMA OVERLAY IS INCLUDED IN THE COST OF PAVEMENT PATCHING.
- 3. SAW CUT/SCORING OF EXISTING PAVEMENT IS INCLUDED IN THE COST OF PAVEMENT PATCHING.

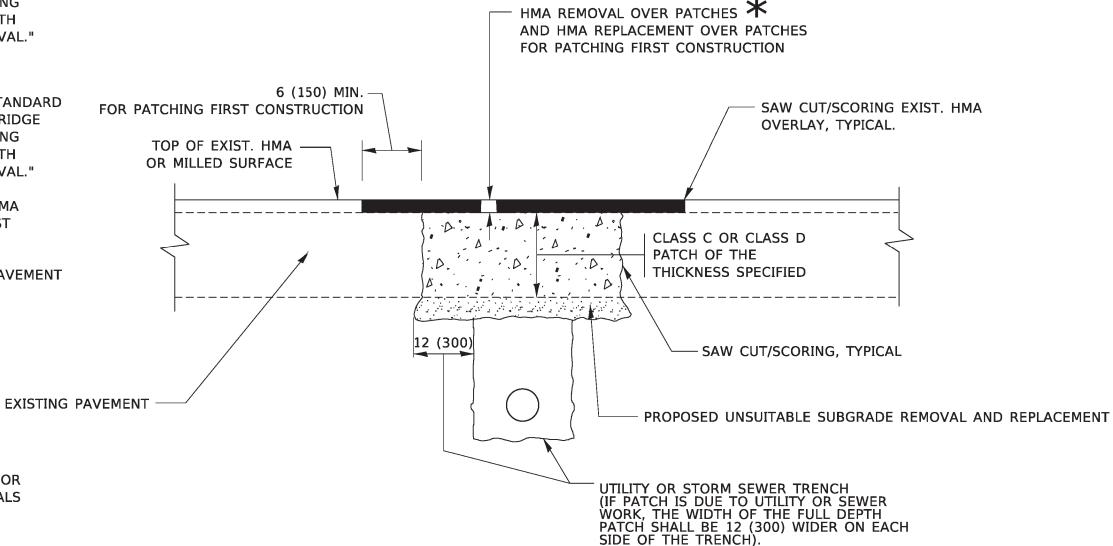

#### **SEQUENCE OF CONSTRUCTION (PATCHING FIRST)**

1. REMOVE THE EXISTING HMA MATERIAL OVER THE AREA TO BE PATCHED.

SEE TYPICAL SECTIONS FOR

THICKNESS AND MATERIALS

- 2. REMOVE AND REPLACE WITH CLASS C OR D PATCH.
- 3. REPLACE HMA MATERIAL OVER THE AREA TO BE PATCHED.

#### **SEQUENCE OF CONSTRUCTION (MILLING FIRST)**

- 1. MILL HMA FIRST IF THERE IS AT LEAST 4½ INCHES OR MORE OF HMA MATERIAL ON TOP OF THE EXISTING PAVEMENT OR IF THE PAVEMENT IS FULL DEPTH HMA. A MINIMUM OF 2 INCHES OF HMA MATERIAL SHALL BE IN PLACE AFTER MILLING.
- 2. REMOVE AND REPLACE WITH FULL DEPTH CLASS D PATCHES TO TOP OF MILLED SURFACE.

ALL DIMENSIONS ARE IN INCHES (MILLIMETERS) UNLESS OTHERWISE SHOWN.

46.	Engineering Enterprises, Inc.	L
المراح الما	52 Wheeler Road Sugar Grove, Illinois 60554 630.466.6700 / www.eeiweb.com	F

USER NAME = Lawrence.DeManche	DESIGNED	-	R. SHAH	REVISED	-	R. BORO 01-01-07
	DRAWN	-		REVISED	-	R. BORO 09-04-07
PLOT SCALE = 100.0000 ' / in.	CHECKED	-		REVISED	-	K. ENG 10-27-08
PLOT DATE = 11/18/2022	DATE	-	10-25-94	REVISED	-	K. SMITH 11-18-22


STATI	E OF	ILLINOIS
DEPARTMENT	0F	TRANSPORTATION

AVEMENT PATCHING FOR			SECTION	COUNTY	TOTAL SHEETS	SHEET NO.
MA SURFACED PAVEMENT		899	23-00034-00-RS	KANE	21	15
			BD400-04 (BD-22)	CONTRACT	NO. 61	K38
OF 1 SHEETS STA. T	O STA.		TILINOIS FED AT	D BBOIECT		

HI

SHEET 1

SCALE: NONE

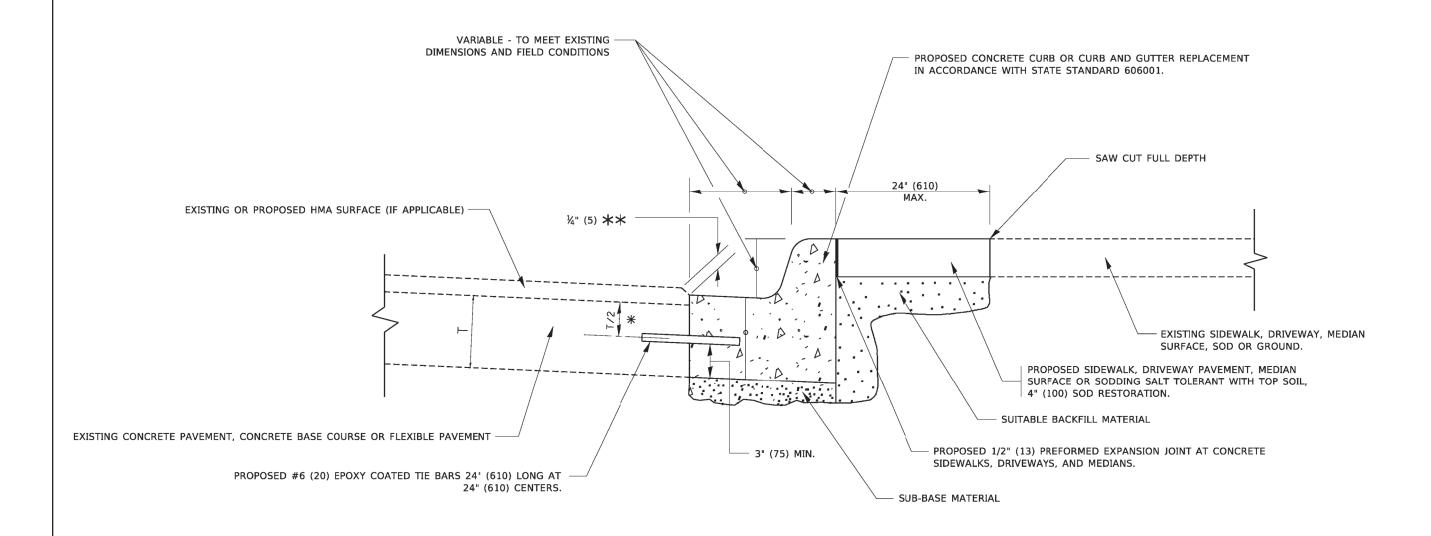

- $\divideontimes$  3" (75) MINIMUM FROM TOP AND BOTTOM OF THE CONCRETE PAVEMENT OR BASE COURSE.
- \*\* IF THE FINAL SURFACE OF THE PAVEMENT IS CONCRETE, THE GUTTER IS TO BE FLUSH WITH THE PAVEMENT.

## CURB OR CURB AND GUTTER REMOVAL AND REPLACEMENT

ALL DIMENSIONS ARE IN INCHES (MILLIMETERS) UNLESS OTHERWISE SHOWN.


241	Engineering Enterprises, Inc.	USER NAME = footemj	DESIGNED - A. HOUSEH	REVISED -	A. ABBAS 03-21-97
	CONSULTING ENGINEERS 52 Wheeler Road Sugar Grove, Illinois 60554 630.466.6700 / www.eeiweb.com		DRAWN -	REVISED -	M. GOMEZ 01-22-01
		PLOT SCALE = 50.0000 ' / in.	CHECKED -	REVISED -	R. BORO 12-15-09
		PLOT DATE = 7/11/2019	DATE - 03-11-94	REVISED -	K. SMITH 07-11-19

STATE OF ILLINOIS
DEPARTMENT OF TRANSPORTATION

	CURB	OR	CL	JRB AN	D GUTTE	R	F	.A RT
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	REMOVAL AND REPLACEMENT							
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#### OPTION 1

(FOR BUTT JOINT AND HMA TAPER SEE DETAIL BELOW)

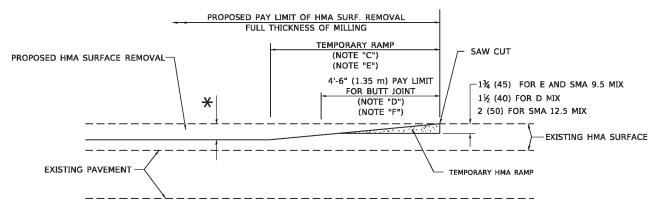


#### HMA CONSTRUCTED TEMPORARY RAMP


(FOR BUTT JOINT AND HMA TAPER SEE DETAIL BELOW)


#### OPTION 2

#### **TYPICAL TEMPORARY RAMP**

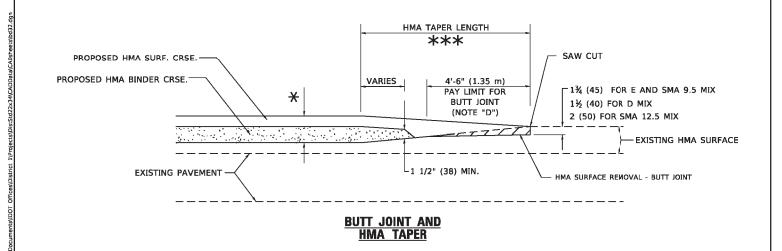

# TYPICAL BUTT JOINT AND HMA TAPER FOR MILLING AND RESURFACING

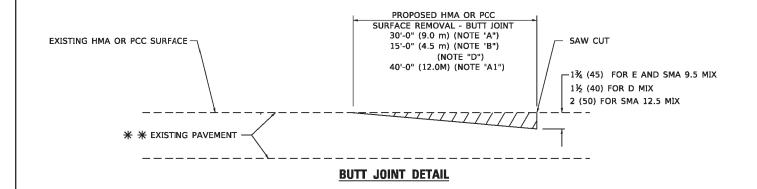

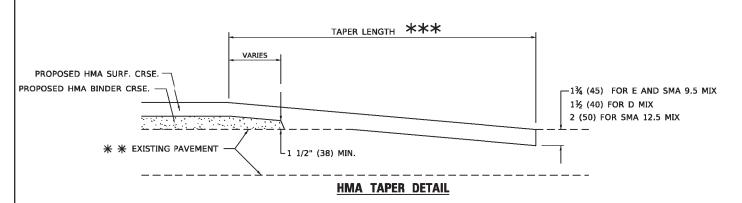

#### TYPICAL BUTT JOINT AND HMA TAPER FOR RESURFACING ONLY

\*\* PC CONCRETE, HMA OR HMA RESURFACED PAVEMENT.

#### **GENERAL NOTES**

- A. MAINLINE ARTERIAL ROADWAYS AND MAJOR SIDE ROADS.
- A1. INTERSTATES
- B. MINOR SIDE ROADS.
- THE TEMP. RAMP SHALL BE CONSTRUCTED IMMEDIATELY UPON REMOVAL OF THE EXISTING HMA SURFACE.
- D. THE BUTT JOINT SHALL BE CONSTRUCTED IMMEDIATELY PRIOR TO PLACING THE PROPOSED HMA COURSES.
- E. TAPER THE TEMP. RAMP AT A RATE OF 3' 4" (1.02m) PER 1 INCH (25 mm) OF MILLING THICKNESS.
  - \* SEE TYPICAL SECTIONS FOR MILLING THICKNESS.
- F. SEE ARTICLE 406.08 AND 406.14 OF THE STANDARD SPECIFICATIONS FOR "HMA AND/OR PCC SURFACE REMOVAL, BUTT JOINT".
- \*\*\* 20'-0" (6.1 m) PER 1 (25) RESURFACING (NOTE "A") 10'-0" (3.0 m) PER 1 (25) RESURFACING (NOTE "B")

#### **BASIS OF PAYMENT**

- THE BUTT JOINT WILL BE PAID FOR AT THE CONTRACT UNIT PRICE PER SQUARE YARD (SQUARE METER) FOR "HOT-MIX ASPHALT SURFACE REMOVAL BUTT JOINT" OR FOR "PORTLAND CEMENT CONCRETE SURFACE REMOVAL- BUTT JOINT".
- THE TEMPORARY RAMP AND SAW CUT SHALL BE INCLUDED IN THE UNIT COST FOR HMA OR PCC SURFACE REMOVAL-BUTT JOINT.

SCALE: NONE

ALL DIMENSIONS ARE IN INCHES (MILLIMETERS) UNLESS OTHERWISE SHOWN.

DNSULTING ENGINEERS


DESIGNED - M. DE YONG USER NAME = Lawrence.DeManche REVISED - A. ABBAS 03-21-97 DRAWN REVISED M. GOMEZ 04-06-01 PLOT SCALE = 100.0000 ' / in. CHECKED REVISED R. BORO 01-01-07 PLOT DATE = 11/18/2022 DATE 06-13-90 REVISED K. SMITH 11-18-22

**BUTT JOINT AND HMA TAPER DETAILS** OF 1 SHEETS STA. SHEET 1

TO STA

SECTION COUNTY 3899 23-00034-00-RS KΔNF BD400-05 BD-32 CONTRACT NO. 6IK38

**STATE OF ILLINOIS DEPARTMENT OF TRANSPORTATION** 

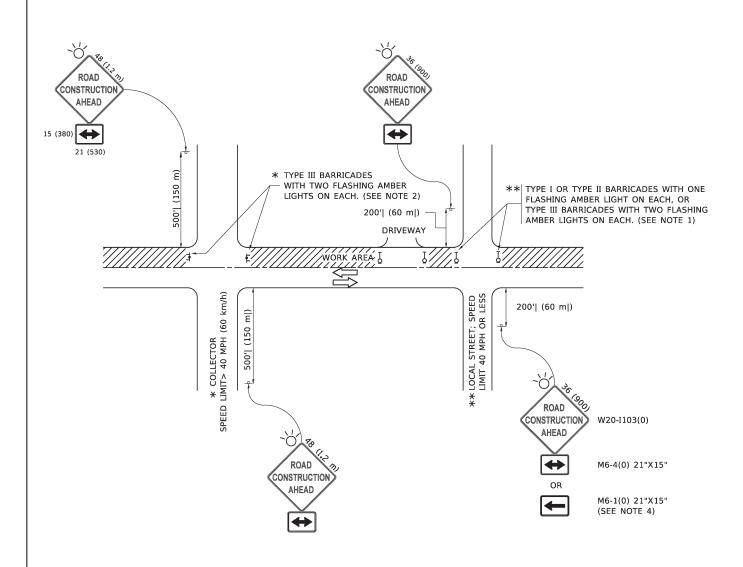

#### NOTES:

- 1. SIDE ROAD WITH A SPEED LIMIT OF 40 MPH (60 km/h) OR LESS AS SHOWN ON THE DRAWING AND AS DIRECTED BY THE ENGINEER:
- a) ONE "ROAD CONSTRUCTION AHEAD" SIGN 36 x 36 (900x900) WITH A FLASHER MOUNTED ON IT APPROXIMATELY 200' (60 m) IN ADVANCE OF THE MAIN ROUTE.
- b) THE CLOSED PORTION OF THE MAIN ROUTE SHALL BE PROTECTED BY BLOCKING WITH TYPE I, TYPE II OR TYPE III BARRICADES, 1/3 OF THE CROSS SECTION OF THE CLOSED PORTION.
- SIDE ROAD WITH A SPEED LIMIT GREATER THAN 40 MPH (60 km/h) AS SHOWN ON THE DRAWING AND AS DIRECTED BY THE ENGINEER:
- a) ONE "ROAD CONSTRUCTION AHEAD" SIGN 48 x 48 (1.2 m x 1.2 m) WITH A FLASHER MOUNTED ON IT APPROXIMATELY 500' (150 m) IN ADVANCE OF THE MAIN ROUTE.
- THE CLOSED PORTION OF THE MAIN ROUTE SHALL BE PROTECTED BY
  b) BLOCKING WITH TYPE III BARRICADES, 1/2 OF THE CROSS SECTION
  OF THE CLOSED PORTION.
- 3. CONES MAY BE SUBSTITUTED FOR BARRICADES OR DRUMS AT HALF THE SPACING DURING DAY OPERATIONS. CONES SHALL BE A MINIMUM OF 28 (710)
- WHEN THE SIDE ROAD LIES BETWEEN THE BEGINNING OF THE MAINLINE
  4. SIGNING AND THE WORK ZONE, A SINGLE HEADED ARROW (M6-1) SHALL
  BE USED IN LIEU OF THE DOUBLE HEADED ARROW (M6-4).


- WHEN WORK IS BEING PERFORMED ON A SIDE ROAD OR DRIVEWAY, FOLLOW THE APPLICABLE STANDARD(S). THE DIRECTIONAL ARROW (M6-1 OR M6-4) SHALL BE COVERED OR REMOVED WHEN NO LONGER CONSISTENT WITH THE TRAFFIC CONTROL SET-UP.
- 6. ADVANCE WARNING SIGNS ARE TO BE OMITTED ON DRIVEWAYS UNLESS OTHERWISE SPECIFIED IN THE PLANS OR BY THE ENGINEER
- 7. THE TRAFFIC CONTROL AND PROTECTION FOR SIDE ROADS, INTERSECTIONS, AND DRIVEWAYS SHALL BE INCLUDED IN THE COST OF SPECIFIED TRAFFIC CONTROL STANDARDS OR ITEMS.

All dimensions are in inches (millimeters) unless otherwise shown.


组	Engineering Enterprises, Inc.	USER NAME = footemj	DESIGNED - L.H.A.	REVISED - A. HOUSEH 10-15-96
	CONSULTING ENGINEERS 52 Wheeler Road Sugar Grove, Illinois 60554		DRAWN -	REVISED - T. RAMMACHER 01-06-00
		PLOT SCALE = 50.0000 ' / in.	CHECKED -	REVISED - A. SCHUETZE 07-01-13
	630.466.6700 / www.eeiweb.com	DIOT DATE 2/4/2010	DATE 06.00	DEVICED A SCHUETZE 00-15-16

STATE OF ILLINOIS DEPARTMENT OF TRANSPORTATION	TRAFFIC CONTROL A SIDE ROADS, INTERSEC	
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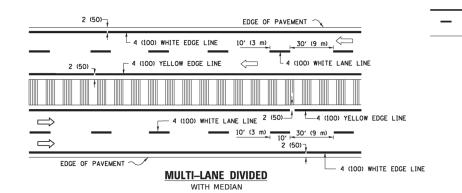
TRAFFIC CONTROL AND PROTECTION FOR						F.A. SECTION			COUNTY	TOTAL SHEETS	SHEE NO.	
SIDE ROADS, INTERSECTIONS, AND DRIVEWAYS				3899	23-00034-00-R	KANE	21	18				
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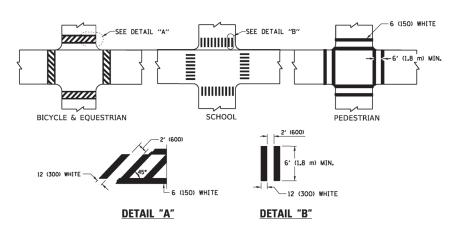
#### 2-LANE ROADWAY

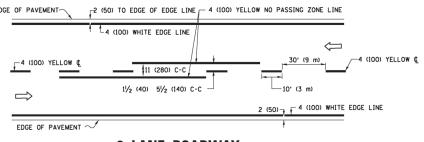

#### **MULTI-LANE UNDIVIDED**

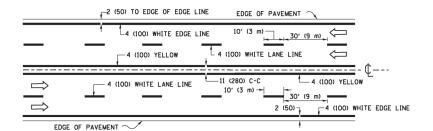

#### TYPICAL LANE AND EDGE LINE MARKING




#### TYPICAL CROSSWALK MARKING

 $m{\star}$  MARKINGS SHALL BE INSTALLED PARALLEL TO THE CENTERLINE OF THE ROAD WHICH IT CROSSES


#### TWO-4 (100) YELLOW @ 11 (280) C-C 4' (1.2 m) OUTSIDE TO NO DIAGONALS -TWO-4 (100) YELLOW @ 11 (280) C-C

#### 4' (1.2 m) WIDE MEDIANS ONLY

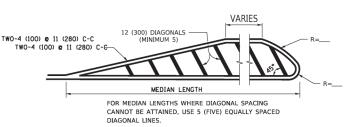


DIAGONAL LINE SPACING: 50' (15 m) C-C (LESS THAN 30MPH (50 km/h)) 75' (25 m) C-C 30MPH (50 km/h) TO 45MPH (70 km/h)) 150' (45 m) C-C (MORE THAN 45MPH (70 km/h))

#### MEDIANS OVER 4' (1.2 m) WIDE

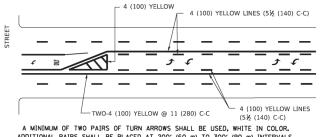


ADDITIONAL PAIRS SHALL BE PLACED AT 200' (60 m) TO 300' (90 m) INTERVALS.

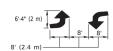

#### MEDIAN WITH TWO-WAY LEFT TURN LANE


#### TYPICAL PAINTED MEDIAN MARKING

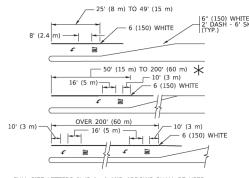

\* TURN LANES IN EXCESS OF 400' (120 m) IN LENGTH MAY HAVE AN ADDITIONAL SET OF ARROW - "ONLY" INSTALLED MIDWAY BETWEEN THE OTHER TWO SETS OF


#### TYPICAL LEFT (OR RIGHT) TURN LANE

#### TYPICAL TURN LANE MARKING

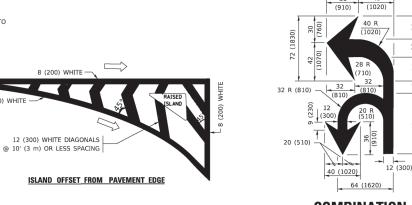

#### 8 (200) WHITE **—** 2 (50) RAISED ISLAND 8 (200) WHITE -**ISLAND AT PAVEMENT EDGE**

#### TYPICAL ISLAND MARKING

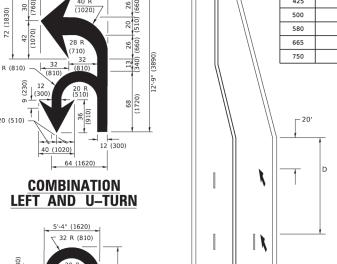

#### LANE REDUCTION TRANSITION

SPEED LIMIT

40

45

50

55

D(FT)

\* LANE REDUCTION ARROWS REQUIRED AT SPEEDS OF 45 MPH OR GREATER OR WHEN SPECIFIED IN PLANS.

		<u> </u>	Oilli	
TYPE OF MARKING	WIDTH OF LINE	PATTERN	COLOR	SPACING / REMARKS
CENTERLINE ON 2 LANE PAVEMENT	4 (100)	SKIP-DASH	YELLOW	10' (3 m) LINE WITH 30' (9 m) SPACE
CENTERLINE ON MULTI-LANE UNDIVIDED PAVEMENT	2 @ 4 (100)	SOLID	YELLOW	11 (280) C-C
NO PASSING ZONE LINES: FOR ONE DIRECTION FOR BOTH DIRECTIONS	4 (100) 2 @ 4 (100)	SOLID SOLID	YELLOW YELLOW	5½ (140) C-C FROM SKIP-DASH CENTERLINE 11 (280) C-C OMIT SKIP-DASH CENTERLINE BETWEEN
LANE LINES	4 (100) 5 (125) ON FREEWAYS	SKIP-DASH SKIP-DASH	WHITE WHITE	10' (3 m) LINE WITH 30' (9 m) SPACE
DOTTED LINES (EXTENSIONS OF CENTER, LANE OR TURN LANE MARKINGS)	SAME AS LINE BEING EXTENDED	SKIP-DASH	SAME AS LINE BEING EXTENDED	2' (600) LINE WITH 6' (1.8 m) SPACE
EDGE LINES	4 (100)	SOLID	YELLOW-LEFT WHITE-RIGHT	OUTLINE MEDIANS IN YELLOW
TURN LANE MARKINGS	6 (150) LINE; FULL SIZE LETTERS & SYMBOLS (8' (2.4m))	SOLID	WHITE	SEE TYPICAL TURN LANE MARKING DETAIL
TWO WAY LEFT TURN MARKING	2 @ 4 (100) EACH DIRECTION 8' (2.4m) LEFT ARROW	SKIP-DASH AND SOLID IN PAIRS	YELLOW	10' (3 m) LINE WITH 30' (9 m) SPACE FOR SKIP-DASH; 5½ (140) C-C BETWEEN SOLID LINE AND SKIP-DASH LINE SEE TYPICAL TWO-WAY LEFT TURN MARKING DETAIL
CROSSWALK LINES (PEDESTRIAN) A. DIAGONALS (BIKE & EQUESTRIAN) B. LONGITUDINAL BARS (SCHOOL)	2 @ 6 (150) 12 (300) @ 45° 12 (300) @ 90°	SOLID SOLID SOLID	WHITE WHITE WHITE	NOT LESS THAN 6' (1.8 m) APART 2' (600) APART 2' (600) APART SEE TYPICAL CROSSWALK MARKING DETAILS.
STOP LINES	24 (600)	SOLID	WHITE	PLACE 4' (1.2 m) IN ADVANCE OF AND PARALLEL TO CROSSWALK, IF PRESENT. OTHERWISE, PLACE AT DESIRED STOPPING POINT. PARALLEL TO CROSSROAD CENTERLINE, WHERE POSSIBLE
PAINTED MEDIANS	2 @ 4 (100) WITH 12 (300) DIAGONALS @ 45° NO DIAGONALS USED FOR 4' (1.2 m) WIDE MEDIANS	SOLID	YELLOW: TWO WAY TRAFFIC WHITE: ONE WAY TRAFFIC	11 (280) C-C FOR THE DOUBLE LINE SEE TYPICAL PAINTED MEDIAN MARKING.
GORE MARKING AND CHANNELIZING LINES	8 (200) WITH 12 (300) DIAGONALS @ 45°	SOLID	WHITE	DIAGONALS: 15' (4.5 m) C-C (LESS THAN 30MPH (50 km/h)) 20' (6 m) C-C 30MPH (50 km/h) TO 45MPH (70 km/h)) 30' (9 m) C-C (OVER 45MPH (70 km/h))
RAILROAD CROSSING	24 (600) TRANSVERSE LINES; "RR" IS 6' (1.8 m) LETTERS; 16 (400) LINE FOR "X"	SOLID	WHITE	SEE STATE STANDARD 780001 AREA OF: "R"=3.6 SQ. FT. (0.33 m ZEACH "X"=54.0 SQ. FT. (5.0 m Z
SHOULDER DIAGONALS (REQUIRED FOR SHOULDERS > 8')	12 (300) @ 45°	SOLID	WHITE - RIGHT YELLOW - LEFT	50' (15 m) C-C (LESS THAN 30MPH (50 km/h)) 75' (25 m) C-C (30 MPH (50 km/h) TO 45MPH (70 km/h)) 150' (45 m) C-C (OVER 45MPH (70 km/h))
U TURN ARROW	SEE DETAIL	SOLID	WHITE	16.3 SF
2 ARROW COMBINATION LEFT AND U TURN	SEE DETAIL	SOLID	WHITE	30.4 SF

**U-TURN** 

FOR FURTHER DETAILS ON PAVEMENT MARKING REFER TO STANDARD SPECIFICATIONS FOR ROAD AND BRIDGE CONSTRUCTION AND STATE STANDARD 780001.

SCALE: NONE

All dimensions are in inches (millimeters) unless otherwise shown.


Engineering Enterprises, Inc. CONSULTING ENGINEERS Grove, Illinois 60554

DESIGNED -EVERS USER NAME = footemi REVISED -C. JUCIUS 09-09-09 DRAWN REVISED C. JUCIUS 07-01-13 CHECKED REVISED C. JUCIUS 12-21-15 PLOT SCALE = 50.0000 ' / in DATE 03-19-90 REVISED C. JUCIUS 04-12-16

**STATE OF ILLINOIS DEPARTMENT OF TRANSPORTATION** 


DISTRICT ONE TYPICAL PAVEMENT MARKINGS TC-13 OF 2 SHEETS STA. SHEET 1 TO STA.

SECTION 23-00034-00-RS KΔNF CONTRACT NO. 6IK38

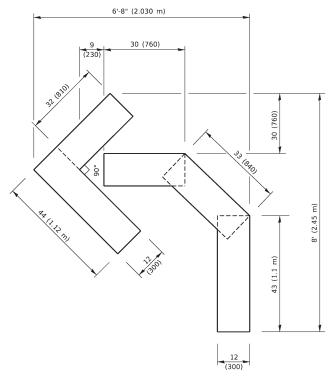


#### QUANTITY

4 (100) LINE = 45.5 ft. (13.9 m) 15.2 sq. ft. (1.41 sq. m)

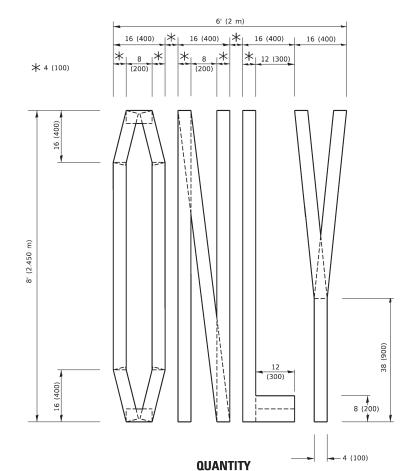

4 (100) LINE = 64.1 ft. (19.5 m) 21.4 sq. ft. (1.99 sq. m)

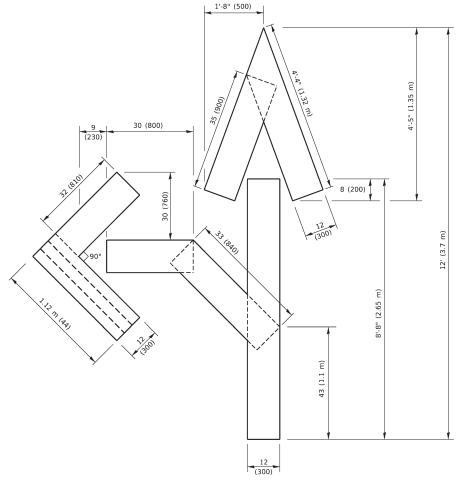


#### QUANTITY

4 (100) LINE = 82.5 ft. (25.1 m) 27.5 sq. ft. (2.53 sq. m)

#### NOTE:

ALL QUANTITIES OF PLACEMENT ARE REPRESENTED IN LINEAR FEET OF 4" LINES TO MATCH THE 4" TEMPORARY TAPE PAY ITEM AND REPRESENTS THE TOTAL QUANTITY OF 4" TAPE REQUIRED.

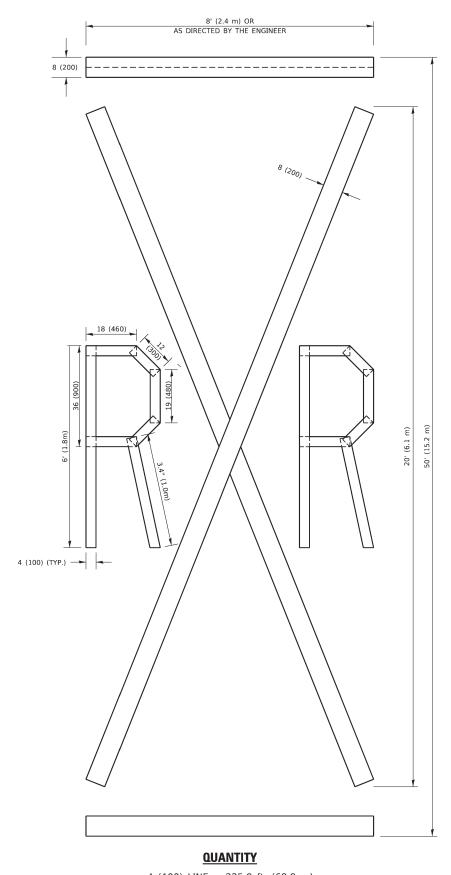

4 (100) LINE = 225.9 ft. (68.9 m) 75.3 sq. ft. (6.99 sq. m)

> F.A. RTE. 3899


All dimensions are in inches (millimeters) unless otherwise shown.

	Engineering Enterprises, Inc.	USER NAME = footemj	DESIGNED -	REVISED	- T. RAMMACHER 03-02-98
CONSULTING ENGINEERS 52 Wheeler Road Sugar Grove, Illinois 60554 630.466.6700 / www.eeiweb.con			DRAWN -	REVISED	- E. GOMEZ 08-28-00
	Sugar Grove, Illinois 60554	PLOT SCALE = 50.0068 ' / in.	CHECKED -	REVISED	- E. GOMEZ 08-28-00
	PLOT DATE = 3/4/2019	DATE - 09-18-94	REVISED	- A. SCHUFTZF 09-15-16	

STATE OF ILLINOIS DEPARTMENT OF TRANSPORTATION

SHORT TE	RM	PAV	EMENT	MARKING	LETTERS	AND SYMBOLS
SCALE: NONE	SHEET	1	OF 1	SHEETS	STA.	TO STA.

23-00034-00-RS KANE 2I 2						
	SECT	ΠON		COUNTY		SHEE
TC-16 CONTRACT NO. 6IK38	23-0003	34-00-R	S	KANE	21	2
CONTINUED NO. OILO	TC-16			CONTRACT	NO. 6	K38
ILLINOIS FED. AID PROJECT		ILLINOIS	FED. Al	ID PROJECT		

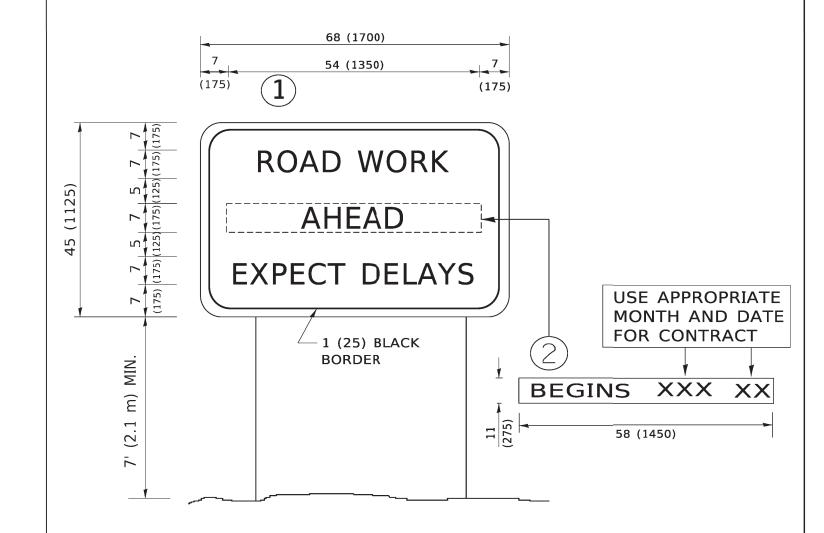

#### **NOTES:**

- 1. USE BLACK LETTERING ON ORANGE BACKGROUND.
- 2. ERECT SIGNS IN ADVANCE OF THE LOCATION FOR THE "ROAD CONSTRUCTION AHEAD" SIGN AT LOCATIONS AS DIRECTED BY THE ENGINEER.
- 3. ERECT SIGN 1 WITH INSTALLED PANEL 2 ONE WEEK PRIOR TO THE START OF CONSTRUCTION.
- 4. REMOVE PANEL 2 SOON AFTER THE START OF CONSTRUCTION.
- 5. SEE SPECIAL PROVISION FOR "TEMPORARY INFORMATION SIGNING" FOR ADDITIONAL INFORMATION.

SHEET 1

- 6. ONE SIGN ASSEMBLY EQUALS 25.70 SQ. FT. (2.3 SQ. M.)
- 7. SHALL BE PAID FOR AS TEMPORARY INFORMATION SIGNING.

SCALE: NONE

ALL DIMENSIONS ARE IN INCHES (MILLIMETERS) UNLESS OTHERWISE SHOWN.

	Engineering Enterprises, Inc.	USER NAME = footemj	DESIGNED -	REVISED	- R. MIRS 09-15-97	
41	CONSULTING ENGINEERS		DRAWN -	REVISED	- R. MIRS 12-11-97	
	52 Wheeler Road Sugar Grove, Illinois 60554	PLOT SCALE = 50.0000 ' / in.	CHECKED -	REVISED	-T. RAMMACHER 02-02	2-6
	630.466.6700 / www.eeiweb.com	PLOT DATE = 3/4/2019	DATE	REVISED	C ILICIUS 01-31-0	17

STATI	E 01	F ILLINOIS
DEPARTMENT	<b>OF</b>	<b>TRANSPORTATION</b>

ARTE	RIAL RO	F.A. RTE.	SECTION		
INFORM		3899	23-00034-00-RS		
1141 01111	IAHON	SIGN			TC-22
OF 1	SHEETS	STA	TO STA		ILLINOIS EED

 
 F.A. RTE.
 SECTION
 COUNTY
 TOTAL SHEETS
 SHEET NO.

 3899
 23-00034-00-RS
 KANE
 21
 21

 TC-22
 CONTRACT
 NO.
 6lK38

NDocuments/IDOT Offices\District 1\Projects\Di