#### 06-14-2024 LETTING ITEM 194

#### **INDEX OF SHEETS**

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- LOCATION MAP
- 4-11 SUMMARY OF QUANTITIES
- 12-14 TYPICAL SECTIONS
- 15-26 SCHEDULE OF QUANTITIES
- 27-32 PLAN DETAILS


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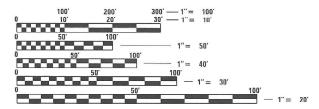
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- CURB RAMP DETAILS
- 36-39 MAINTENANCE OF TRAFFIC
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FULL SIZE PLANS HAVE BEEN PREPARED USING STANDARD ENGINEERING SCALES. REDUCED SIZED PLANS WILL NOT CONFORM TO STANDARD SCALES. IN MAKING MEASUREMENTS ON REDUCED PLANS, THE ABOVE SCALES MAY BE USED.

J.U.L.I.E. JOINT UTILITY LOCATION INFORMATION FOR EXCAVATORS 1-800-892-0123 OR 811

PROJECT ENGINEER: BILLIE OWEN PROJECT MANAGER: MEIWU AN

CONTRACT NO. 76L11

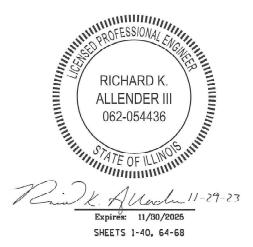


## STATE OF ILLINOIS

## DEPARTMENT OF TRANSPORTATION

# **PROPOSED** HIGHWAY PLANS

FAS ROUTE 2701 /FAU 8565 (IL 37) **SECTION** (105, 106) RS-3 PROJECT STP-HSIP-HZ4M(416) **RESURFACING — DESIGNED OVERLAY** & ADA IMPROVEMENT **MARION COUNTY** C-98-159-18

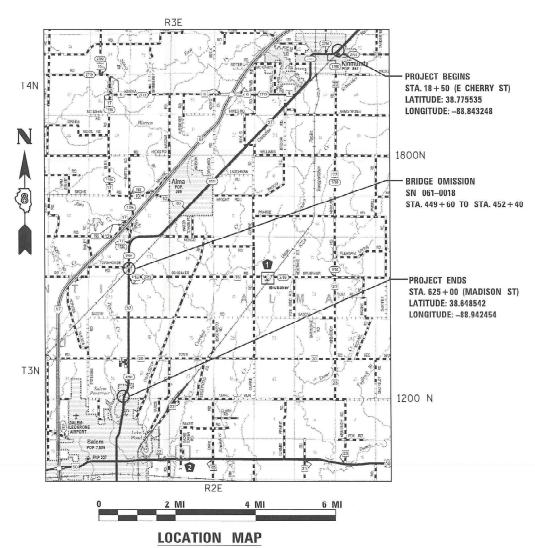

TOTAL LENGTH = 60,650.00 FEET (11.487 MI)

NET LENGTH = 60,650.00 FEET (11.487 MI)

F.A.S. RTE.	SECTION	COUNTY	TOTAL SHEETS	SHEET NO.
22	(105, 106) RS-3	MARION	68	1
	HIING	5 CONTRAC	T NO.76	L11


\* F.A.S 2701 & F.A.U. 8565

#### D-98-019-18



#### **FUNCTIONAL CLASSIFICATION MINOR ARTERIAL**

STA. 18+50 TO STA. 120+57 STA. 120+57 TO STA. 416+81 STA. 416+81 TO STA. 624+69 2022 ADT = 2,450 (ACTUAL) 2022 ADT = 2,050 (ACTUAL) 2022 ADT = 3,500 (ACTUAL) 2024 ADT = 2,100 (EST) 2024 ADT-3,550 (EST) 2024 ADT = 2.500 (EST) 2044 ADT = 2,700 (EST) 2044 ADT = 2,300 (EST) 2044 ADT = 3,900 (EST) SII = 3.3%SII = 2.9% SH = 4.0%MU = 3.3%MU = 3.4%MU = 2.9%

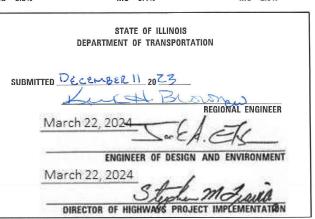

PRINTED BY THE AUTHORITY OF THE STATE OF ILLINOIS

#### **GENERAL NOTES**

1. UTILITIES KNOWN TO HAVE FACILITIES WITHIN THE PROJECT AREA:
VILLAGE OF ALMA - WATER AND SANITARY SEWER

AMEREN ILLINOIS - ELECTRIC

AT&T ILLINOIS - COMMUNICATIONS

CHARTER COMMUNICATIONS, INC - CABLE TV

ENERGY TRANSFER CRUDE OIL COMPANY, LLC - PIPELINE

VILLAGE OF KINMUNDY - WATER AND SANITARY SEWER

LIBERTY UTILITIES - GAS

MARATHON PIPE LINE LLC - PIPELINE

NORTHEAST MARION COUNTY WATER COMPANY - WATER

CITY OF SALEM - WATER AND SANITARY SEWER

CITY OF SALEM - GAS

TRI-COUNTY ELECTRIC COOPERATIVE INC - ELECTRIC


WINDSTREAM KDL INC - COMMUNICATIONS

- 2. ALL EXISTING AND PROPOSED RIGHT-OF-WAY LINES AND PROPERTY LINES SHOWN ON THE ROADWAY PLAN SHEETS ARE GRAPHICAL REPRESENTATIONS AND SHALL NOT BE USED AS A MEANS TO ESTABLISH OWNERSHIP. IN ALL MATTERS RELATING TO RIGHT-OF-WAY, THE PLAT OF HIGHWAYS SHALL BE THE CONTROLLING DOCUMENT.
- 3. ALL PATCHING ON THIS PROJECT SHALL BE COMPLETED PRIOR TO BITUMINOUS SURFACE REMOVAL
- 4. ALL CURB, GUTTER, AND CURB AND GUTTER ON THIS PROJECT SHALL BE COMPLETED PRIOR TO THE BITUMINOUS SURFACE BEING PLACED.
- 5. NO SURVEY WAS PERFORMED FOR THIS PROJECT EXCEPT AT PORTIONS OF ADA CURB RAMPS.
  THE PLANS WERE CREATED USING MOSTLY MICROFILM, AERIALS, AND FIELD MEASUREMENTS.
- 6. FOUR (4) CHANGEABLE MESSAGE SIGNS SHALL BE REQUIRED FOR THIS PROJECT AND SHALL BE PLACED TWO (2) WEEKS PRIOR TO ANY LANE CLOSURE. THE CHANGEABLE MESSAGE SIGNS SHALL BE PLACED IN THE FOLLOWING LOCATIONS:
- 1 SOUTHBOUND IL 37 JUST NORTH OF CHERRY ST IN KINMUNDY, IL.
- 2 NORTHBOUND IL 37 JUST SOUTH OF MADISON ST IN SALEM, IL.
- 3 EASTBOUND KINOKA ROAD JUST WEST OF IL 37.
- 4 WESTBOUND KINLOU ROAD JUST EAST OF IL 37.
- 7. THE INTENT OF THE MILLING IS TO REMOVE THE HMA SURFACE ONLY. THE UNDERLYING CONCRETE SHALL NOT BE DISTURBED.
- 8. THE RESIDENT ENGINEER SHALL VERIFY THE EXISTENCE OF HIGHWAY LIGHTING,INTELLIGENT TRANSPORTATION SYSTEMS (I.T.S.) UTILITIES, AND/OR ELECTRICAL CABLES ASSOCIATED WITH TRAFFIC SIGNALS WITHIN THE PROJECT LIMITS. IF ANY OF THESE EXIST WITHIN THE PROJECT LIMITS, AND IF THESE ITEMS REQUIRE LOCATING, THE CONTRACTOR SHALL BE DIRECTED TO DO SO ACCORDING TO SECTION 803 OF THE STANDARD SPECIFICATIONS. THIS WORK SHALL BE PAID FOR ACCORDING TO ARTICLE 109.04 OF THE STANDARD SPECIFICATIONS.
- 9. THE USE OF VIBRATORY ROLLERS WILL NOT BE PERMITTED WITHIN THE CITY LIMITS OF SALEM, ALMA & KINMUNDY. THIS DOES NOT RELIEVE THE CONTRACTOR OF DENSITY REQUIREMENTS FOR THE CONSTRUCTION OF THE BITUMINOUS PAVEMENTS AS SPECIFIED IN SECTIONS 406 & 407 OF THE STANDARD SPECIFICATIONS.
- 10. IF THE CONTRACTOR, FOR HIS CONSTRUCTION ACTIVITY, REMOVES TREES WITHIN THE RIGHT-OF-WAY LIMITS WHICH ARE NOT DESIGNATED ON THE PLANS FOR REMOVAL, I. E. IN ORDER TO GAIN ACCESS TO THE PROJECT SITE; IT WILL BE HIS RESPONSIBILITY TO REPLACE THE TREES AT A 1:1 RATIO. THE TREES WILL BE REPLACED WITH A 1 GALLON NATIVE ILLINOIS TREE SPECIES AND SHALL BE APPROVED BY THE ENGINEER. THE TREE REMOVAL AND TREE REPLACEMENT WILL BE AT THE CONTRACTOR'S EXPENSE, AND NO ADDITIONAL COMPENSATION WILL BE ALLOWED.
- 11. THE CONTRACTOR SHALL BE AWARE THAT THERE ARE MANHOLES & VALVES LOCATED WITHIN THE RESURFACING LIMITS. CARE SHALL BE TAKEN IN THESE LOCATIONS DURING MILLING OPERATIONS.
- 12. ALL MILLED AREAS SHALL BE RESURFACED WITH THE BINDER COURSE PRIOR TO OPENING THE LANE TO TRAFFIC.

#### **GENERAL NOTES (CONTINUED)**

- 13. THE FOLLOWING STRUCTURES CAN BE CROSSED WITH AN EMPTY MTD 40 TONS MAXIMUM GROSS WEIGHT RESTRICTIONS: 061-0018, 061-2421, 061-2422, 061-2423, 061-2424, 061-2425, 061-2427
- 14. THE PROPOSED PAVEMENT MARKING SHALL MATCH THE LOCATIONS OF THE EXISTING PAVEMENT MARKING, AS DIRECTED BY THE ENGINEER.
- 15. THE CONTRACTOR SHALL PROVIDE POSITIVE AND ADEQUATE DRAINAGE AT ALL TIMES.
- 16. THE DISTRICT LAND ACQUISITION SECTION SHALL BE CONTACTED IF DIFFERENCES ARE IDENTIFIED BETWEEN ANY PROPOSED RIGHT-OF-WAY OR EASEMENT SHOWN ON THE ENGINEERING PLAN SHEETS AS COMPARED TO THE SAME PROPOSED RIGHT-OF-WAY OR EASEMENT SHOWN ON THE PLAT OF HIGHWAYS. QUESTIONS OR CONCERNS REGARDING THESE ITEMS SHOULD BE DIRECTED TO CLINT MARSHALL AT (618) 346-3124.
- 17. ALL EXISTING AND PROPOSED RIGHT-OF-WAY LINES AND PROPERTY LINES SHOWN ON THE ROADWAY PLAN SHEETS ARE GRAPHICAL REPRESENTATIONS AND SHALL NOT BE USED AS A MEANS TO ESTABLISH OWNERSHIP. IN ALL MATTERS RELATING TO RIGHT-OF-WAY, THE PLAT OF HIGHWAYS SHALL BE THE CONTROLLING DOCUMENT.
- 18. IF ANY SECTION OR SUB-SECTION MONUMENT (I.E. STONE, BRASS PLUG, ALUMINUM DISK, IRON PIPE OR PIN, MAG NAIL, CROSS, ETC.), IS ENCOUNTERED, THE ENGINEER SHALL BE NOTIFIED BEFORE SUCH MONUMENT IS REMOVED OR RESURFACED OVER. THE CONTRACTOR SHALL PROTECT AND CAREFULLY PRESERVE THE MONUMENT IN PLACE UNTIL AN ILLINOIS PROFESSIONAL LAND SURVEYOR WITH A DEPARTMENT PREQUALIFICATION IN "SPECIAL SERVICES SURVEYING" HAS REFERENCED ITS LOCATION.
- 19. ALL SECTION CORNER, RIGHT-OF-WAY AND PROPERTY CORNER MONUMENTS SHALL BE SET BY AN ILLINOIS

  PROFESSIONAL LAND SURVEYOR WITH A DEPARTMENT PREOUALIFICATION IN "SPECIAL SERVICES SURVEYING."
- 20. THE RIGHT-OF-WAY OR PROPERTY CORNER IS MONUMENTED WITH A 5/8" IRON ROD, THIRTY INCHES (30")
  IN LENGTH, WITH AN IDOT ALUMINUM CAP, OR OTHER PRE-EXISTING CORNER MONUMENT, WHICH SHALL
  NOT BE REMOVED, DAMAGED OR DISTURBED WHEN SETTING THE RIGHT-OF-WAY MARKER. THE
  RIGHT-OF-WAY MARKER SHALL BE INSTALLED SO THAT THE BACK OF THE POST IS TWELVE INCHES (12") INSIDE
  THE RIGHT-OF-WAY BOUNDARY. THE RIGHT-OF-WAY MARKER SHALL BE A WITNESS TO THE MONUMENT.
- 21. THE CONTRACTOR WILL BE REQUIRED TO SUBMIT A WORK PLAN TO THE RAILROAD FOR REVIEW WHICH SHOWS
  THE CONTAINMENT METHOD UTILIZED DOES NOT ALLOW PAINT AND OTHER DEBRIS TO FALL ONTO THE IC-CNRR
  PROPERTY BELOW. ADDITIONALLY, ALL FALSEWORK AND/OR CONTAINMENT MEANS ARE LOCATED OUTSIDE THE
  "MINIMUM CONSTRUCTION CLEARANCE ENVELOPE" AT ALL TIMES.

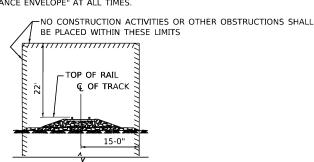

#### MINIMUM CONSTRUCTION CLEARANCE ENVELOPE

#### **COMMITMENTS**

THIS PROJECT HAS NO COMMITMENTS.

#### **APPLICATION RATES FOR QUANTITY CALCULATION:**

AGGREGATE (SURFACE/BASE/SUBBASE/BACKFILL 1.80 TON/CU YD RIPRAP 1.50 TON/CU YD

#### **STANDARDS**

0171110711	
000001-08	STANDARD SYMBOLS, ABBREVIATIONS AND PATTERNS
001006	DECIMAL OF AN INCH AND OF A FOOT
420001-10	PAVEMENT JOINTS
424001-11	PERPENDICULAR CURB RAMPS FOR SIDEWALKS
442101-09	CLASS B PATCHES
482001-02	HMA SHOULDER ADJACENT TO FLEXIBLE PAVEMENT
542301-03	PRECAST REINFORCED CONCRETE FLARED END SECTION
630001-13	STEEL PLATE BEAM GUARDRAIL
630101-11	STRONG POST GUARDRAIL ATTACHED TO CULVERT
630106-02	LONG-SPAN GUARDRAIL OVER CULVERT
630301-09	SHOULDER WIDENING FOR TYPE 1 (SPECIAL) GUARDRAIL TERMINALS
631031-18	TRAFFIC BARRIER TERMINAL, TYPE 6
642006-01	SHOULDER RUMBLE STRIPS, 8 IN.
701006-05	OFF-ROAD OPERATIONS, 2L, 2W, 15' (4.5 M) TO 24" (600 MM) FROM PAVEMENT EDGE
701201-05	LANE CLOSURE, 2L, 2W, DAY ONLY, FOR SPEEDS > 45 MPH
701301-04	LANE CLOSURE, 2L, 2W, SHORT TIME OPERATIONS
701306-04	LANE CLOSURE, 2L, 2W, SLOW MOVING OPERATIONS DAY ONLY, FOR SPEEDS > 45 M

TO1301-04 LANE CLOSURE, 2L, 2W, SHORT TIME OPERATIONS
 TO1306-04 LANE CLOSURE, 2L, 2W, SLOW MOVING OPERATIONS DAY ONLY, FOR SPEEDS > 45 MPH
 TO1311-03 LANE CLOSURE, 2L, 2W, MOVING OPERATIONS - DAY ONLY
 LANE CLOSURE, 2L, 2W, BRIDGE REPAIR WITH BARRIER

701326-04 LANE CLOSURE, 2L, 2W, PAVEMENT WIDENING, FOR SPEEDS > 45 MPH 701501-06 URBAN LANE CLOSURE, 2L, 2W, UNDIVIDED

701801-06 SIDEWALK, CORNER OR CROSSWALK CLOSURE 701901-09 TRAFFIC CONTROL DEVICES

704001-08 TEMPORARY CONCRETE BARRIER
720006-04 SIGN PANEL ERECTION DETAILS
720011-01 METAL POSTS FOR SIGNS, MARKERS AND DELINEATORS

725001-01 OBJECT AND TERMINAL MARKERS
728001-01 TELESCOPING STEEL SIGN SUPPORT

729001-01 APPLICATIONS OF TYPES A AND B METAL POSTS (FOR SIGNS & MARKERS)
780001-05 TYPICAL PAVEMENT MARKINGS

781001-04 TYPICAL APPLICATIONS RAISED REFLECTIVE PAVEMENT MARKERS
782006-01 GUARDRAIL AND BARRIER WALL REFLECTOR MOUNTING DETAILS

001006 DECIMAL OF AN INCH AND OF A FOOT
406201-01 MAIL BOX TURNOUT

420701-03 PAVEMENT WELDED WIRE REINFORCEMENT

610001-09 SHOULDER INLET WITH CURB 666001-01 RIGHT-OF-WAY MARKERS

#### **MIX DESIGN INFORMATION**

LOCATION:			IL 37		
MIXTUDE LICE(C).	SURFACE	BINDER	INCIDENTAL	SHOULDER (LOWER)	SHOULDER (SURFACE)
MIXTURE USE(S):	MAIN	ILINE		SHOULDER <	8 FEET WIDE
AC/PG:	PG 64 <b>-</b> 22	PG 64-22	PG 64 <b>-</b> 22	PG 64-22	PG 64 <b>-</b> 22
DESIGN AIR VOIDS:	4% @ Ndes=70	4% @ Ndes=70	4% @ Ndes=70	4% @ Ndes=30	4% @ Ndes=30
MIXTURE COMPOSITION	IL 9.5	IL 19.0	IL 9,5	IL 19.0L	IL 9.5L
(GRADATION)					
FRICTION AGGREGATE:	MIXTURE "D"	MIXTURE "B"	MIXTURE "D"		
QUALITY MANAGEMENT:	QCP	QCP	QC/QA	QC/QA	QC/QA
MTD:	YES	YES	NO	NO	NO

SURFACE COURSE

TACK COAT

TOP LIFT BINDER

TACK COAT

IL 37

MAINLINE

REV. - MS


PLANQUANTITIES FOR HOT-MIXASPHALT ITEMS ARE CALCULATED USING A UNIT WEIGHT OF 112 LB/SQ YD/IN (59.8 KG/SQ M/25 MM THICKNESS).

ANY QCP PAY ITEM THAT HAS A QUANTITY OF 1600 TONS OR LESS WILL HAVE TWO SUBLOTS EACH OF WHICH WILL BE HALF OF THE PLAN QUANTITY OR HALF OF THE ADJUSTED QUANTITY BY THE RESIDENT ENGINEER/TECHNICIA



U'SER NAME = bjohnson	DESIONED	-	LNJ	REVISED -
	DRAWN	-	GSJ	REVISED -
PLOT SCALE = 100.0000 ' / in.	CHECKED	-	RKA	REVISED -
PLOT DATE = 12/8/2023	DATE	-	12/8/2023	REVISED -

,	TIS EACH OF WHICH WILL BE HALF OF THE PLAN QUANTITY OR HALF OF THE ADJUSTED QUANT	HYBY	THE RESIDENT ENGINEER	TECHNICIAN		
	GENERAL NOTES AND COMMITMENTS	F.A.S. RTE.	SECTION	COUNTY	TOTAL SHEETS	SHEE NO.
	FAS ROUTE 2701 /FAU 8565 (IL 37) RESURFACING	*	(105, 106) RS-3	MARION	68	2
	TAS HOOTE 2701/TAO 8303 (IE 37/ HESONI AGINA			CONTRACT	NO.76	L11
	SCALE: 1" = 50'   SHEET 1 OF 1 SHEETS   STA. TO STA.		ILLINOIS FED. A	ID PROJECT		

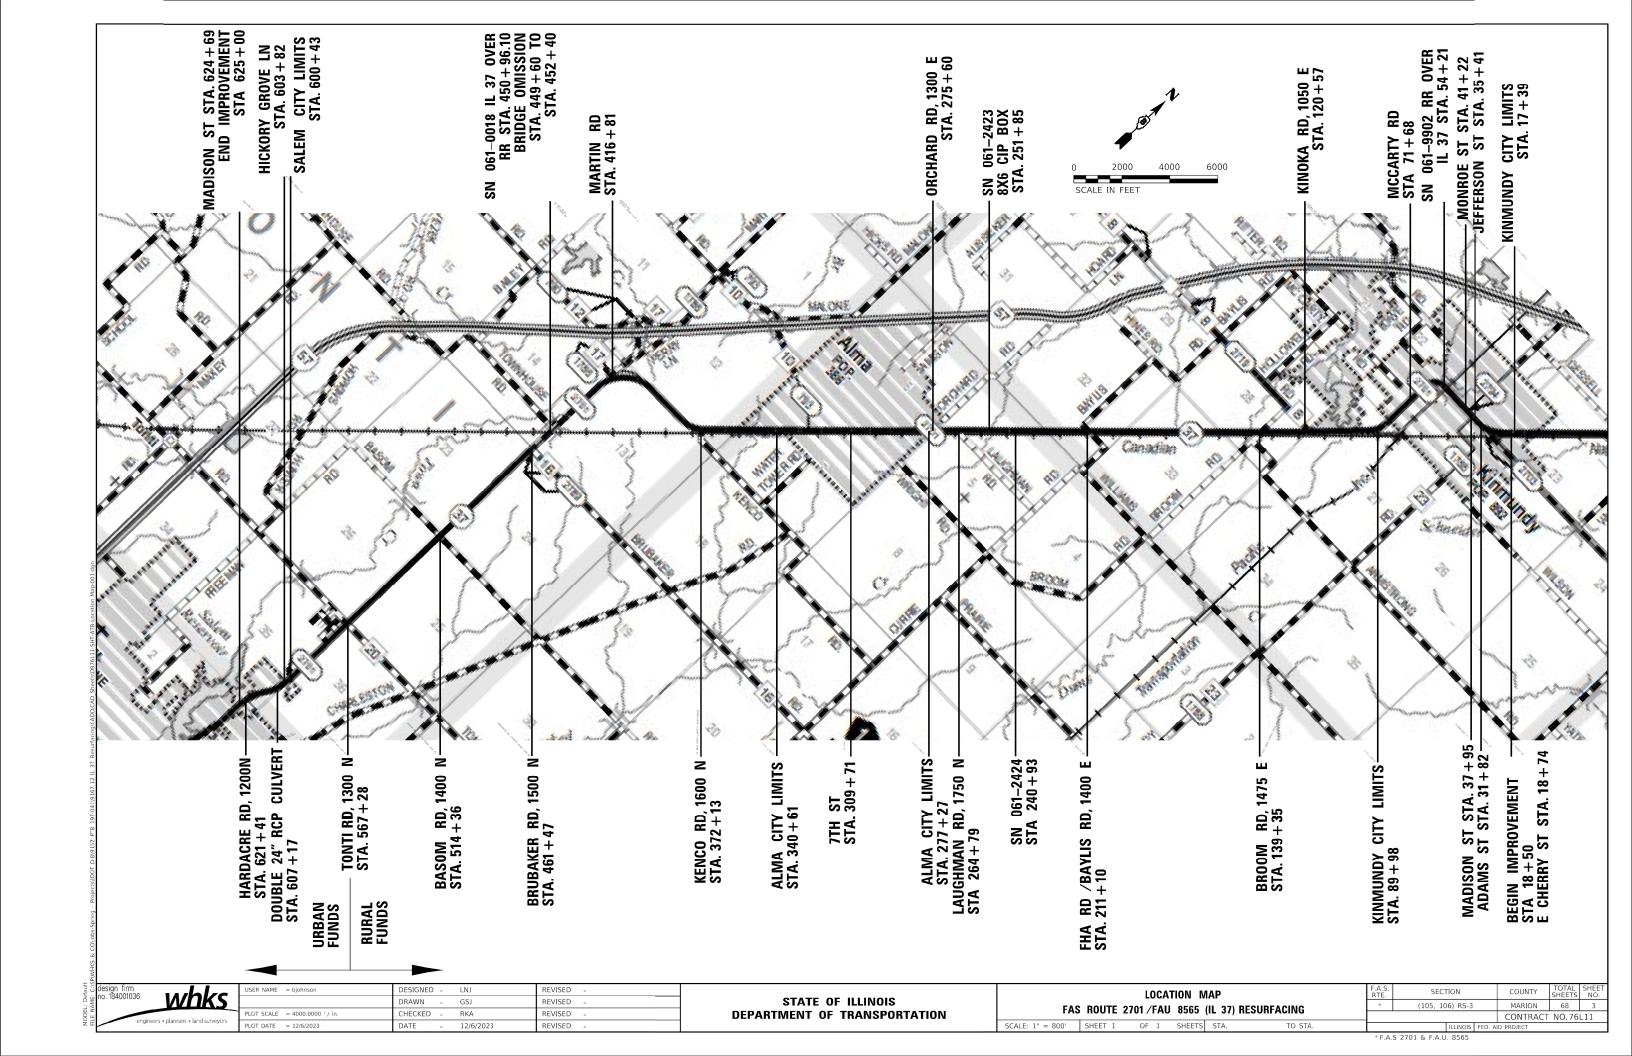

					80% FEDERAL	_ / 20% STATE		90% FEDERA	_ / 10% STATE
					S	TP		н	SIP
				ROADWAY	BRIDGE	SAFETY	ROADWAY	SAFETY	SAFETY
CODE			TOTAL	0005	0047	0021	0005	0021	0021
NO.	ITEM	UNIT	QUANTITY	RURAL	RURAL	RURAL	URBAN	RURAL	URBAN
20200100	EARTH EXCAVATION	CU YD	15			15			
20200600	EXCAVATING AND GRADING EXISTING SHOULDER	UNIT	643					616	27
21400100	GRADING AND SHAPING DITCHES	FOOT	50			50			
25000210	SEEDING, CLASS 2A	ACRE	0.25	0.25					
25000400	NITROGEN FERTILIZER NUTRIENT	POUND	25	25					
25000500	PHOSPHORUS FERTILIZER NUTRIENT	POUND	25	25					
25000600	POTASSIUM FERTILIZER NUTRIENT	POUND	25	25					
25100115	MULCH, METHOD 2	ACRE	0.25	0.25					
28100205	STONE RIPRAP, CLASS A3	TON	9			9			
28100207	STONE RIPRAP, CLASS A4	TON	80	80					
28100707	STONE DUMPED RIPRAP, CLASS A4	SQ YD	24		24				
28200200	FILTER FABRIC	SQ YD	84			84			
28400100	GABIONS	CU YD	60	60					
40600290	BITUMINOUS MATERIALS (TACK COAT)	POUND	12176	10990			1186		

 USER NAME
 = bjohnson
 DESIGNED
 LNJ
 REVISED

 DRAWN
 GSJ
 REVISED

 PLOT SCALE
 = 100:0.0000 % / in.
 CHECKED
 RKA
 REVISED

 PLOT DATE
 = 12/19/2023
 DATE
 12/19/2023
 REVISED

STATE OF ILLINOIS DEPARTMENT OF TRANSPORTATION 
 SUMMARY
 OF QUANTITIES

 FAS
 ROUTE
 2701 / FAU
 8565 (IL 37) RESURFACING

 SCALE:
 1" = 50"
 SHEET 1
 OF 8
 SHEETS
 STA.
 TO STA.

CONSTRUCTION CODE

 
 F.A.S. RTE.
 SECTION
 COUNTY
 TOTAL SHEETS
 SHEETS NO.

 \*
 (105, 106) RS-3
 MARION
 68
 4

 CONTRACT
 NO.76L11
 NO.76L11
 NO.76L11

					80% FEDERAL	_ / 20% STATE		90% FEDERAI	L / 10% STATE
					S	TP		H	SIP
				ROADWAY	BRIDGE	SAFETY	ROADWAY	SAFETY	SAFETY
CODE			TOTAL	0005	0047	0021	0005	0021	0021
NO.	ITEM	UNIT	QUANTITY	RURAL	RURAL	RURAL	URBAN	RURAL	URBAN
40600370	LONGITUDINAL JOINT SEALANT	FOOT	60370	54598			5772		
				0.1000			0,7,2		
40600982	HOT-MIX ASPHALT SURFACE REMOVAL - BUTT JOINT	SQ YD	1678	1435			243		
40600990	TEMPORARY RAMP	SQ YD	3111	2192			919		
40002005	HOT MIV ACRUALT DINDED COURSE II 10.0 NZO	TON	10046	17160			1770		
40603085	HOT-MIX ASPHALT BINDER COURSE, IL-19.0, N70	TON	18946	17168			1778		
40604062	HOT-MIX ASPHALT SURFACE COURSE, IL-9.5, MIX "D", N70	TON	12628	11443			1185		
40800029	BITUMINOUS MATERIALS (TACK COAT)	POUND	756	646			110		
40800050	INCIDENTAL HOT-MIX ASPHALT SURFACING	TON	190	163			27		
42300200	PORTLAND CEMENT CONCRETE DRIVEWAY PAVEMENT, 6 INCH	SQ YD	7			7			
			,			,			
42400100	PORTLAND CEMENT CONCRETE SIDEWALK 4 INCH	SQ FT	915			915			
42400800	DETECTABLE WARNINGS	SQ FT	60			60			
44000200	DRIVEWAY PAVEMENT REMOVAL	SQ YD	7			7			
44000200	DIVEWAL PAVENTINI REMOVAE	30 10	,			,			
44000600	SIDEWALK REMOVAL	SQ FT	600			600			
44200050	WELDED WIRE REINFORCEMENT	SQ YD	348	348					
44201031	CLASS B PATCHES, TYPE II, 15 INCH	SQ YD	49	49					

whks

DESIGNED - LNJ REVISED DRAWN - GSJ REVISED PLOT SCALE = 100:0.0000 ':" / in.

PLOT DATE = 12/19/2023 RKA CHECKED -REVISED 12/19/2023 REVISED

STATE OF ILLINOIS
DEPARTMENT OF TRANSPORTATION

SUMMARY OF QUANTITIES FAS ROUTE 2701 /FAU 8565 (IL 37) RESURFACING SCALE: 1" = 50' SHEET 2 OF 8 SHEETS STA.

CONSTRUCTION CODE

COUNTY TOTAL SHEET NO.

MARION 68 5 SECTION (105, 106) RS-3 CONTRACT NO.76L11

						L / 20% STATE			L / 10% STATE
					S	TP		H:	SIP
				ROADWAY	BRIDGE	SAFETY	ROADWAY	SAFETY	SAFETY
CODE			TOTAL	0005	0047	0021	0005	0021	0021
NO.	ITEM	UNIT	QUANTITY	RURAL	RURAL	RURAL	URBAN	RURAL	URBAN
44201035	CLASS B PATCHES, TYPE III, 15 INCH	SQ YD	44	44					
44201037	CLASS B PATCHES, TYPE IV, 15 INCH	SQ YD	304	304					
44201294	CLASS B PATCH - EXPANSION JOINT	FOOT	24	24					
44201299	DOWEL BARS 1 1/2"	EACH	320	320					
44213200	SAW CUTS	FOOT	810	810					
44213204	TIE BARS 3/4"	EACH	37	37					
48102100	AGGREGATE WEDGE SHOULDER, TYPE B	TON	3838					3520	318
48203029	HOT-MIX ASPHALT SHOULDERS, 8"	SQ YD	28520					27358	1162
48203100	HOT-MIX ASPHALT SHOULDERS	TON	4695					3766	929
50102400	CONCRETE REMOVAL	CU YD	30.7		30.7				
30102400	CONCRETE REMOVAL	COTE	30.7		30.7				
50105220	PIPE CULVERT REMOVAL	FOOT	5			5			
50300100	FLOOR DRAINS	EACH	12		12				
50300255	CONCRETE SUPERSTRUCTURE	CU YD	54.7		54.7				
50800205	REINFORCEMENT BARS, EPOXY COATED	POUND	8450		8450				

design firm
no. 184001036 whks
crigneers + planners + land surveyors

 USER NAME
 = bjohnson
 DESIGNED
 LNJ
 REVISED

 DRAWN
 GSJ
 REVISED

 PLOT SCALE
 = 100:0.0000 ':" / in.
 CHECKED
 RKA
 REVISED

 PLOT DATE
 = 12/19/2023
 DATE
 12/19/2023
 REVISED

STATE OF ILLINOIS
DEPARTMENT OF TRANSPORTATION

 SUMMARY OF QUANTITIES

 FAS
 ROUTE
 2701 /FAU
 8565 (IL 37) RESURFACING

 SCALE:
 1" = 50'
 SHEET 3
 OF 8
 SHEETS
 STA.
 TO STA.

CONSTRUCTION CODE

90% FEDERAL / 10% STATE

80% FEDERAL / 20% STATE

 
 F.A.S. RTE.
 SECTION
 COUNTY
 TOTAL SHEETS
 SHEETS NO.

 \*
 (105, 106) RS-3
 MARION
 68
 6

 CONTRACT
 NO.76L11

						000/ 5505041	CONSTRUC	ETION COBE	000/ 5555	
							_ / 20% STATE TP			L / 10% STATE
Г					ROADWAY	BRIDGE	SAFETY	ROADWAY	SAFETY	SAFETY
	CODE			TOTAL	0005	0047	0021	0005	0021	0021
	NO.	ITEM	UNIT	QUANTITY	RURAL	RURAL	RURAL	URBAN	RURAL	URBAN
	50800515	BAR SPLICERS	EACH	60		60				
r										
	5.42.12.660	DEFENCE DELIVED CONCERTS IN ADEA FIVE CENTRALS AS II	FACIL							
L	54213660	PRECAST REINFORCED CONCRETE FLARED END SECTIONS 15"	EACH	1			1			
	54261712	STEEL FLARED END SECTIONS 12"	EACH	4		4				
l										
r	5.125.020		5007				0.7			
L	542D0220	PIPE CULVERTS, CLASS D, TYPE 1 15"	FOOT	27			27			
	60100945	PIPE DRAINS 12"	FOOT	318		318				
ŀ										
	61000050	CONCRETE THRUST BLOCKS	EACH	4		4				
	61000335	TYPE G INLET BOX, STANDARD 610001	EACH	4		4				
ŀ										
L										
	63000001	STEEL PLATE BEAM GUARDRAIL, TYPE A, 6 FOOT POSTS	FOOT	1684	1684					
l	63000030	STRONG POST GUARDRAIL ATTACHED TO CULVERT	FOOT	79	79					
ŀ										
	63000350	LONG-SPAN GUARDRAIL OVER CULVERT, 12 FT 6 IN SPAN	FOOT	37.5				37.5		
	63100085	TRAFFIC BARRIER TERMINAL, TYPE 6	EACH	4.0	4.0					
L	63100167	TRAFFIC BARRIER TERMINAL, TYPE 1 (SPECIAL) TANGENT	EACH	11	9			2		
ľ	63200310	GUARDRAIL REMOVAL	FOOT	2197	2081			116		
ŀ										
-										-
L	64200108	SHOULDER RUMBLE STRIPS, 8 INCH	FOOT	82702					77165	5537
•	PECIALTY	ITEM	1				1	1	1	

 USER NAME
 bighnson
 DESIGNED
 LNJ
 REVISED

 PLOT SCALE
 = 100:0.0000 '\*' / in.
 CHECKED
 RKA
 REVISED

 PLOT DATE
 = 12/19/2023
 DATE
 12/19/2023
 REVISED

STATE OF ILLINOIS DEPARTMENT OF TRANSPORTATION 
 SUMMARY
 OF QUANTITIES

 FAS
 ROUTE
 2701 / FAU
 8565 (IL 37) RESURFACING

 SCALE:
 1" = 50'
 SHEET 4
 OF 8
 SHEETS
 STA.
 TO STA.

CONSTRUCTION CODE

							L / 20% STATE TP			L / 10% STATI SIP
Г					ROADWAY	BRIDGE	SAFETY	ROADWAY	SAFETY	SAFETY
	CODE			TOTAL	0005	0047	0021	0005	0021	0021
	NO.	ІТЕМ	UNIT	QUANTITY	RURAL	RURAL	RURAL	URBAN	RURAL	URBAN
	66201120	CONCRETE SHOULDER CURB	FOOT	36		36				
		CONCRETE STRONGER COND		30						
	66900200	NON-SPECIAL WASTE DISPOSAL	CU YD	40	40					
	66900530	SOIL DISPOSAL ANALYSIS	EACH	6	6					
	66901001	REGULATED SUBSTANCES PRE-CONSTRUCTION PLAN	L SUM	1	1					
	66901003	REGULATED SUBSTANCES FINAL CONSTRUCTION REPORT	L SUM	1	1					
	66001006	DECLIFATED CURSTANCES MONITORING	CALDA		6					
	66901006	REGULATED SUBSTANCES MONITORING	CAL DA	6	6					
	67000400	ENGINEER'S FIELD OFFICE, TYPE A	CAL MO	12	11			1		
	67100100	MOBILIZATION	L SUM	1	0.9			0.1		
	70100405	TRAFFIC CONTROL AND PROTECTION, STANDARD 701321	EACH	1		1				
	70100450	TRAFFIC CONTROL AND PROTECTION, STANDARD 701201	L SUM	1	1					
	70100460	TRAFFIC CONTROL AND PROTECTION, STANDARD 701306	L SUM	1	1					
	70100500	TRAFFIC CONTROL AND PROTECTION, STANDARD 701326	L SUM	1	1					
	704555			_						
	70102620	TRAFFIC CONTROL AND PROTECTION, STANDARD 701501	L SUM	1				1		
	70102640	TRAFFIC CONTROL AND PROTECTION, STANDARD 701801	L SUM	1				1		

whks

 USER NAME
 = bjohnson
 DESIGNED
 LNJ
 REVISED

 DRAWN
 GSJ
 REVISED

 PLOT SCALE
 = 100:0.0000 ':" / in.
 CHECKED
 RKA
 REVISED

 PLOT DATE
 = 12/19/2023
 DATE
 12/19/2023
 REVISED

STATE OF ILLINOIS
DEPARTMENT OF TRANSPORTATION

 SUMMARY
 OF QUANTITIES

 FAS
 ROUTE
 2701 / FAU
 8565 (IL 37) RESURFACING

 SCALE:
 1" = 50'
 SHEET 5
 OF 8
 SHEETS
 STA.
 TO STA.

CONSTRUCTION CODE

 
 F.A.S. RTE.
 SECTION
 COUNTY
 TOTAL SHEETS
 SHEETS NO.

 \*
 (105, 106) RS-3
 MARION
 68
 8

 CONTRACT
 NO.76L11

					80% FEDERAL	_ / 20% STATE	LITON CODE	90% FEDERA	L / 10% STATE
						TP			SIP
				ROADWAY	BRIDGE	SAFETY	ROADWAY	SAFETY	SAFETY
CODE			TOTAL	0005	0047	0021	0005	0021	0021
NO.	ITEM	UNIT	QUANTITY	RURAL	RURAL	RURAL	URBAN	RURAL	URBAN
70103815	TRAFFIC CONTROL SURVEILLANCE	CAL DA	10	9			1		
70106500	TEMPORARY BRIDGE TRAFFIC SIGNALS	EACH	1		1				
70106700	TEMPORARY RUMBLE STRIPS	EACH	6		6				
70107025	CHANGEABLE MESSAGE SIGN	CAL DA	56	28			28		
70300100	SHORT TERM PAVEMENT MARKING	FOOT	5514	4990			524		
70300150	SHORT TERM PAVEMENT MARKING REMOVAL	SQ FT	1838	1664			174		
70300241	TEMPORARY PAVEMENT MARKING - LINE 6"- PAINT	FOOT	153409					141033	12376
70300281	TEMPORARY PAVEMENT MARKING - LINE 24"- PAINT	FOOT	144			144			
,0300201		1001	111						
70400100	TEMPORARY CONCRETE BARRIER	FOOT	562.5		562.5				
70400200	RELOCATE TEMPORARY CONCRETE BARRIER	FOOT	562.5		562.5				
70600251	IMPACT ATTENUATORS, TEMPORARY (NON- REDIRECTIVE, NARROW), TEST LEVEL 3	EACH	2		2				
70600352	IMPACT ATTENUATORS, RELOCATE (NON- REDIRECTIVE, NARROW), TEST LEVEL 3	EACH	2		2				
72400100	REMOVE SIGN PANEL ASSEMBLY - TYPE A	EACH	4			4			
72400500	RELOCATE SIGN PANEL ASSEMBLY - TYPE A	EACH	1			1			
SPECIALT	YITEM			1		ı			

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STATE OF ILLINOIS
DEPARTMENT OF TRANSPORTATION

 SUMMARY
 OF QUANTITIES

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 ROUTE
 2701 / FAU
 8565 (IL 37) RESURFACING

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 1" = 50'
 SHEET 6
 OF 8
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 TO STA.

CONSTRUCTION CODE

 
 F.A.S. RTE.
 SECTION
 COUNTY
 TOTAL SHEETS
 SHEETS NO.

 \*
 (105, 106) RS-3
 MARION
 68
 9

 CONTRACT
 NO.76L11

				80% FEDERAL / 20% STATE		90% FEDERAL / 10% STATE			
					9	STP	Н	ISIP	
				ROADWAY	BRIDGE	SAFETY	ROADWAY	SAFETY	SAFETY
	CODE		TOTAL	0005	0047	0021	0005	0021	0021
	NO.	ITEM UNIT	QUANTITY	RURAL	RURAL	RURAL	URBAN	RURAL	URBAN
	72501000	TERMINAL MARKER - DIRECT APPLIED EACH	11	9			2		
	78000400	THERMOPLASTIC PAVEMENT MARKING - LINE 6" FOOT	153409					141033	12376
	70000400	THE WAS EASILE PARENT MANAGE EINE S	133403					141033	12370
	78000650	THERMOPLASTIC PAVEMENT MARKING - LINE 24" FOOT	144			144			
	78100100	RAISED REFLECTIVE PAVEMENT MARKER EACH	826	741			85		
	78200005	GUARDRAIL REFLECTORS, TYPE A EACH	32	28			4		
	78300200	RAISED REFLECTIVE PAVEMENT MARKER REMOVAL EACH	826	741			85		
	78300202	PAVEMENT MARKING REMOVAL - WATER BLASTING SQ FT	76994			288		70518	6188
	X1200030	FILLING INLETS, TEMPORARY EACH	2		2				
	X1400326	RECTANGULAR RAPID FLASHING BEACON ASSEMBLY (COMPLETE)  EACH	6	6					
	X5870015	BRIDGE DECK CONCRETE SEALER SQ FT	9266		9266				
	X6010003	PIPE DRAIN REMOVAL FOOT	316		316				
	X6050700	REMOVE INLET BOX EACH	4		4				
	X6660445	RIGHT OF WAY AND PROPERTY CORNERS EACH	2	2					
	X7200201	WIDTH RESTRICTION SIGNING L SUM	1		1				
L	PECIALTY								

REV. - MS

n firm 134001036 Whks engineers + planners + land surveyors

STATE OF ILLINOIS
DEPARTMENT OF TRANSPORTATION

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 FAS
 ROUTE
 2701 / FAU
 8565 (IL 37) RESURFACING

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 1" = 50'
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 OF 8
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 STA.
 TO STA.

CONSTRUCTION CODE

				80% FEDERAL / 20% STATE			ZHON CODE	90% FEDERAL / 10% STATE		
						ТР			SIP	
				ROADWAY	BRIDGE	SAFETY	ROADWAY	SAFETY	SAFETY	
CODE			TOTAL	0005	0047	0021	0005	0021	0021	
NO.	ITEM	UNIT	QUANTITY	RURAL	RURAL	RURAL	URBAN	RURAL	URBAN	
70001495	BRIDGE APPROACH SHOULDER REMOVAL	SQ YD	39		39					
20001433	BIBBLE AT HOACH SHOULDER REPOVAL	30 15	]		]					
Z0001903	STRUCTURAL STEEL REMOVAL	POUND	3340		3340					
Z0007101	CONTAINMENT AND DISPOSAL OF LEAD PAINT CLEANING RESIDUES NO. 1	L SUM	1		1					
Z0010501	CLEANING AND PAINTING STEEL BRIDGE NO. 1	L SUM	1		1					
			<u> </u>							
Z0013798	CONSTRUCTION LAYOUT	L SUM	1	0.9			0.1			
		1								
Z0016001	DECK SLAB REPAIR (FULL DEPTH, TYPE I)	SQ YD	1.3		1.3					
Z0016200	DECK SLAB REPAIR (PARTIAL)	SQ YD	11		11					
Z0034105	MATERIAL TRANSFER DEVICE	TON	31574	28611			2963			
70040665	BALL DOAD, DROTECTIVE LIADULITY INCLIDANCE	I CUM			1					
20048665	RAILROAD PROTECTIVE LIABILITY INSURANCE	L SUM	1		1					
Z0076600	TRAINEES	HOUR	4000	4000						
Z0076604	TRAINEES TRAINING PROGRAM GRADUATE	HOUR	4000	4000						
		1	1	1	<u> </u>	l	1	l .	l .	

REV. - MS

engineers + planners + land surveyor

Ø 0042

 USER NAME
 = bjohnson
 DESIGNED
 LNJ
 REVISED

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 GSJ
 REVISED

 PLOT SCALE
 = 100:0.0000 %" / in.
 CHECKED
 RKA
 REVISED


 PLOT DATE
 = 12/19/2023
 DATE
 12/19/2023
 REVISED

STATE OF ILLINOIS DEPARTMENT OF TRANSPORTATION 
 SUMMARY OF QUANTITIES

 FAS
 ROUTE
 2701 / FAU
 8565 (IL 37) RESURFACING


 SCALE:
 1" = 50'
 SHEET 8
 OF 8
 SHEETS STA.
 TO STA.

CONSTRUCTION CODE

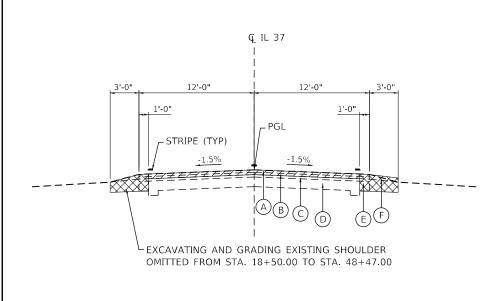


#### **EXISTING TYPICAL SECTION**

STA. 18+50.00 TO STA. 303+33.00 STA. 304+71.00 TO STA. 307+53.00 STA, 310+68,00 TO STA, 357+46,00 STA, 611+88.00 TO STA, 625+00.00

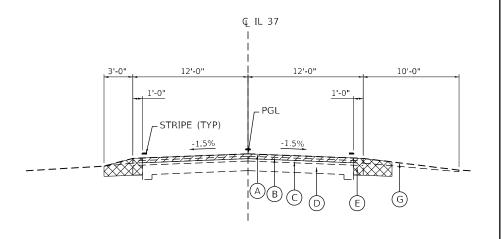

#### **EXISTING TYPICAL SECTION**


STA. 303+33.00 TO STA. 304+71.00 STA, 307+53,00 TO STA, 310+68,00

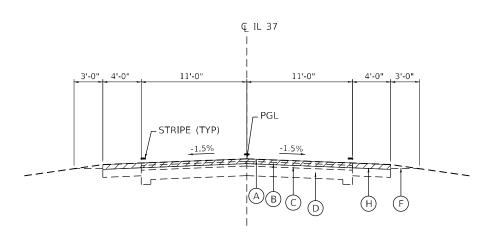

#### **EXISTING TYPICAL SECTION**


STA. 357+46.00 TO STA. 400+19.00 STA. 425+45.00 TO STA. 602+00.00

**BRIDGE OMISSION SN 061-0018** STA. 449 + 60.00 TO STA. 452 + 40.00

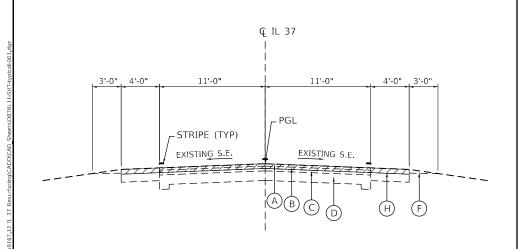

#### **EXISTING TYPICAL SECTION**

STA. 400+19.00 TO STA. 425+45.00 STA. 602+00.00 TO STA. 609+87.00

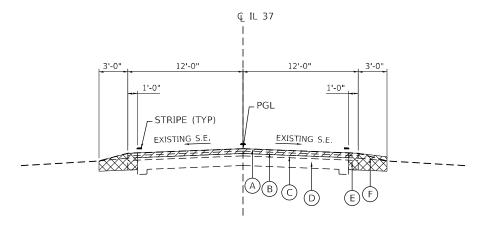

#### **EXISTING TYPICAL SECTION**

STA. 609+87.00 TO STA. 611+88.00

#### **LEGEND**

- ME MATCH EXISTING
- SE SUPERELEVATION
- EXISTING BITUMINOUS CONCRETE SURFACE COURSE, SUPERPAVE, MIX "C", N50 (1½")
- EXISTING BINDER COURSE, 1½"
- EXISTING BITUMINOUS RESURFACING
- EXISTING PCC PAVEMENT 9-6-9
- EXISTING BASE COURSE WIDENING, 9"
- EXISTING AGGREGATE SHOULDERS
- EXISTING BITUMINOUS SHOULDERS
- EXISTING HMA SHOULDERS 8"



HOT-MIX ASPHALT SURFACE REMOVAL ,  $3\frac{3}{4}$ "



EXCAVATING AND GRADING EXISTING SHOULDER

whks


REVISED DRAWN GSJ REVISED HECKED BJJ REVISED PLOT DATE = 12/6/2023 REVISED 12/6/2023

STATE OF ILLINOIS **DEPARTMENT OF TRANSPORTATION** 

TYPICAL SECTIONS FAS ROUTE 2701 /FAU 8565 (IL 37) RESURFACING SCALE: 1" = 5' SHEET 1 OF 3 SHEETS STA.


SECTION (105, 106) RS-3 MARION 68 12 CONTRACT NO.76L11

\* F.A.S 2701 & F.A.U. 8565

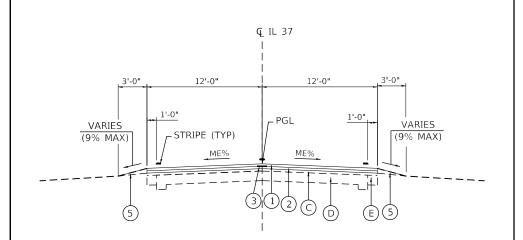


#### PROPOSED TYPICAL SECTION

STA. 18+50.00 TO STA. 48+47.00

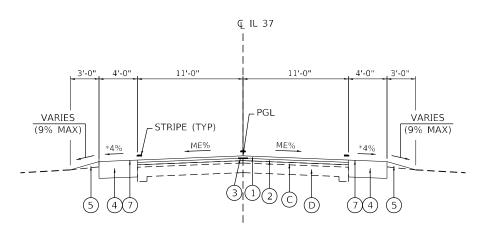


#### PROPOSED TYPICAL SECTION

STA. 48+47.00 TO STA. 303+33.00 STA. 304+71.00 TO STA. 307+53.00 STA. 310+68.00 TO STA. 357+46.00 STA, 611+88,00 TO STA, 625+00,00 SEE SHOULDER WIDENING DETAIL FOR TREATMENT OF SIDE ROADS AND ENTRANCES.

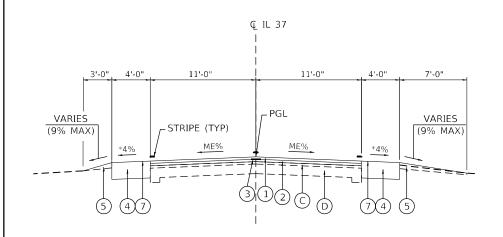

#### PROPOSED TYPICAL SECTION


STA. 303+33.00 TO STA. 304+71.00 STA, 307+53,00 TO STA, 310+68,00 SEE SHOULDER WIDENING DETAIL FOR TREATMENT OF SIDE ROADS AND ENTRANCES.

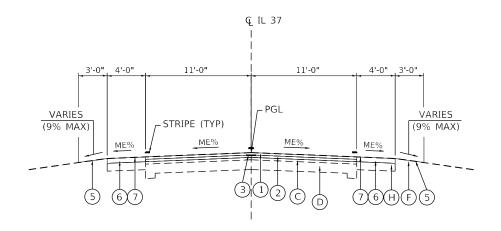

#### PROPOSED TYPICAL SECTION

STA. 357+46.00 TO STA. 400+19.00 STA. 425+45.00 TO STA 447+50.00 STA 454+50 TO STA, 602+00,00

SEE SHOULDER RESURFACING DETAIL FOR TREATMENT OF SIDE ROADS AND ENTRANCES.

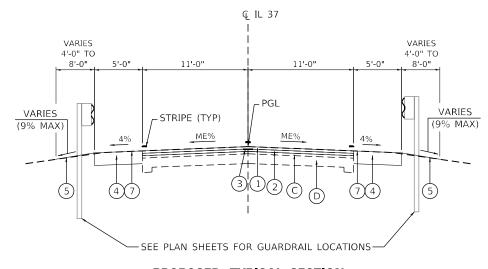

#### PROPOSED TYPICAL SECTION

STA. 447+50.00 TO STA. 454+50.00

**BRIDGE OMISSION SN 061-0018** STA. 449 + 60.00 TO STA. 452 + 40.00

#### **LEGEND**

ME MATCH EXISTING

SEE HIGHWAY STANDARD 482001 FOR SHOULDER SLOPE IN SUPERELEVATED AREAS

SEE GENERAL NOTES SHEET FOR LIFT THICKNESS AND TACK COAT APPLICATIONS

EXISTING BITUMINOUS CONCRETE SURFACE COURSE, SUPERPAVE, MIX "C", N50 (1½")

EXISTING BINDER COURSE, 1½"

EXISTING BITUMINOUS RESURFACING

EXISTING PCC PAVEMENT 9-6-9

EXISTING BASE COURSE WIDENING, 9"

EXISTING AGGREGATE SHOULDERS

EXISTING BITUMINOUS SHOULDERS

EXISTING HMA SHOULDERS 8"

PROPOSED HMA SURFACE COURSE, IL-9.5, MIX "D", N70 (1½")

PROPOSED HMA BINDER COURSE, IL-19.0, N70 (21/4")

LONGITUDINAL JOINT SEALANT

\*\* (4) PROPOSED HMA SHOULDER, 8"

PROPOSED AGGREGATE WEDGE SHOULDER, TYPE B

PROPOSED HMA SHOULDER (3¾")

PROPOSED SHOULDER RUMBLE STRIPS, 8 INCH SEE PAVEMENT MARKING DETAILS SHEET FOR LOCATIONS

esign firm 5. 18400103	
. 1840010.	whks
	engineers + planners + land surveyors

USER NAME = gjameson	DESIGNED	-	MRL	REVISED -	
	DRAWN	-	GSJ	REVISED -	
PLOT SCALE = 10.0000 / in.	CHECKED	-	BJJ	REVISED -	
PLOT DATE = 1/24/2024	DATE	-	1/24/2024	REVISED -	

STATE OF ILLINOIS **DEPARTMENT OF TRANSPORTATION** 


		TYPICA	L SECTI	IONS		F.A.S. RTE	SECT	ION
FΔS	ROUTE 2	701 / <b>F</b> ΔII	8565	(II 37) R	ESURFACING	*	(105, 10	6) RS
170	HOUTE 2	7017170	0303 (	(IL 37) II	LUUIII AUIIIU			
SCALE: 1" = 5'	SHEET 2	OF 3	SHEETS	STA.	TO STA.			ILLING

, 106) RS-3 CONTRACT NO.76L11

MARION

68 13

\* F.A.S. 2701 & F.A.U. 8565

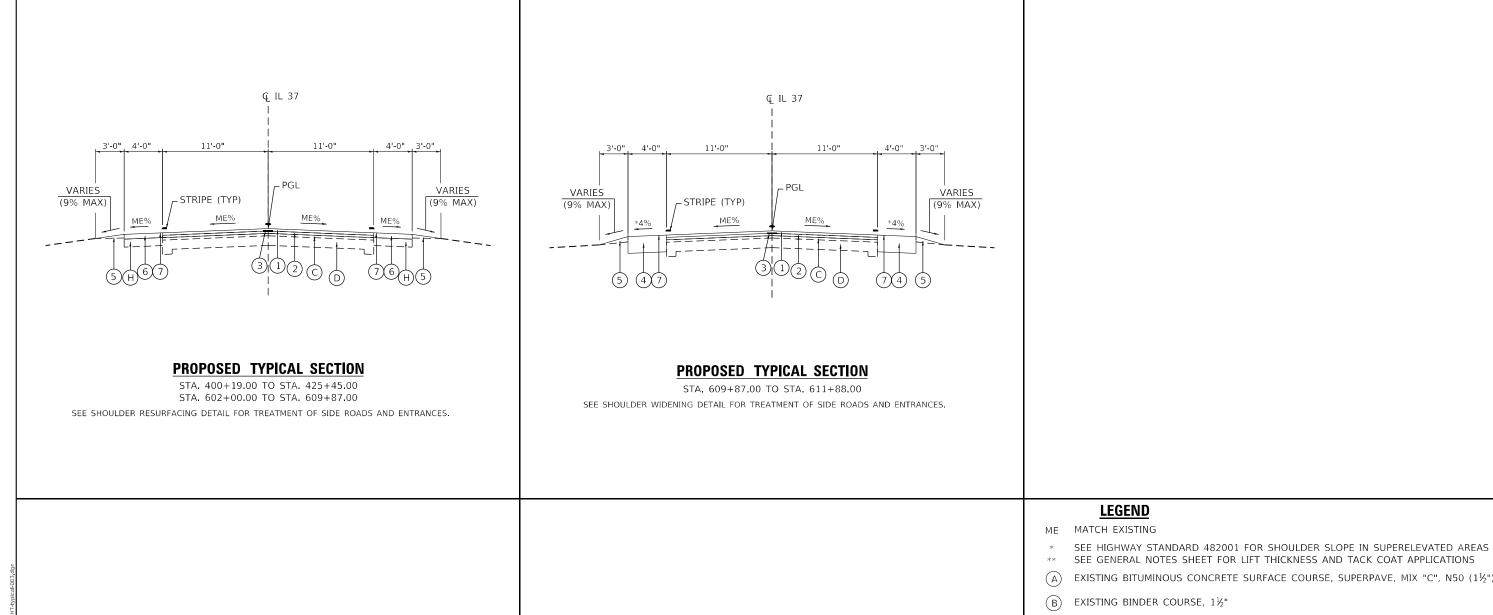

A	EXISTING BITUMINOUS CONCRETE SURFACE COURSE, SUPERPAVE, MIX "C", N50 (1 $\frac{1}{2}$ ")
В	EXISTING BINDER COURSE, 1½"
C	EXISTING BITUMINOUS RESURFACING
D	EXISTING PCC PAVEMENT 9-6-9
E	EXISTING BASE COURSE WIDENING, 9"
F	EXISTING AGGREGATE SHOULDERS
G	EXISTING BITUMINOUS SHOULDERS
H	EXISTING HMA SHOULDERS 8"
1	PROPOSED HMA SURFACE COURSE, IL-9.5, MIX "D", N70 (1½")
2	PROPOSED HMA BINDER COURSE, IL-19.0, N70 (2½")
3	LONGITUDINAL JOINT SEALANT
4	PROPOSED HMA SHOULDER, 8"

PROPOSED AGGREGATE WEDGE SHOULDER, TYPE B

SEE PAVEMENT MARKING DETAILS SHEET FOR LOCATIONS

PROPOSED SHOULDER RUMBLE STRIPS, 8 INCH

design firm
no. 184001036 whks

engineers + planners + land surveyors

STATE OF ILLINOIS
DEPARTMENT OF TRANSPORTATION

 TYPICAL SECTIONS

 FAS
 ROUTE
 2701 /FAU
 8565 (IL 37) RESURFACING

 SCALE: 1" = 5'
 SHEET 3
 OF 3
 SHEETS
 STA.
 TO STA.

\*  $\bigcirc$  PROPOSED HMA SHOULDER (3 $\frac{3}{4}$ ")

\* F.A.S 2701 & F.A.U. 8565

PAVEMENT SCHEDULE								
				BITUMINOUS	LONGITUDINAL	HOT-MIX ASPHALT	HOT-MIX ASPHALT	MATERIAL
START	START	END	LENGTH	MATERIALS	JOINT	BINDER COURSE,	SURFACE COURSE,	TRANSFER
LOCATION	STATION	STATION		(TACK COAT)	SEALANT	IL-19.0, N70	IL-9.5, MIX "D", N70	DEVICE
			FT	POUND	FOOT	TON	TON	TON
MAINLINE								
CHERRY ST (KINMUNDY	18+50.00	48+47.00	2997	1245	2997	1007	671	1678
START SHLD WIDEN	48+47.00	71+68.00	2321	431	2321	715	477	1192
MCCARTY RD	71+68.00	120+57.00	4889	908	4889	1506	1004	2510
KINOKA RD	120+57.00	211+10.00	9053	1682	9053	2788	1859	4647
BAYLIS RD	211+10.00	275+60.00	6450	1199	6450	1987	1324	3311
ORCHARD RD	275+60.00	309+71.00	3411	633	3411	1051	700	1751
7TH ST (ALMA)	309+71.00	372+13.00	6242	1160	6242	1923	1282	3205
KENCO RD	372+13.00	416+81.00	4468	830	4468	1376	917	2293
MARTIN RD	416+81.00	449+60.00	3279	610	3279	1010	673	1683
BRIDGE OMISSION	449+60.00	452+40.00	280	51		86	57	143
	452+40.00	461+47.00	907	169	907	279	186	465
BRUBAKER RD	461+47.00	514+36.00	5289	982	5289	1629	1086	2715
BASOM RD	514+36.00	567+28.00	5292	983	5292	1630	1087	2717
SIDE ROADS								
KINLOU WYE				41		70	46	116
MARTIN RD				66		111	74	185
		RURAL	SUBTOTAL	10990	54598	17168	11443	28611
MAINLINE								
TONTI RD	567+28.00	603+82.00	3654	788	3654	1125	750	1875
HICKORY GROVE LN	603+82.00	624+69.00	2087	391	2087	643	429	1072
MADISON ST (SALEM)	624+69.00	625+00.00	31	7	31	10	6	16
	1	URBAN S	SUBTOTAL	1186	5772	1778	1185	2963
					1			
			TOTAL	12176	60370	18946	12628	31574

PAVEMENT PA	TCHING	SCHEDUL	<u> </u>									
					CLASS B	CLASS B	CLASS B	WELDED WIRE	CLASS B PATCH-	DOWEL	SAW	TIE
STATION	LANE	OFFSET	LENGTH	WIDTH	PATCHES,	PATCHES,	PATCHES,	REINFORCEMENT	EXPANSION	BARS	CUTS	BARS
					TYPE II, 15 INCH	TYPE III, 15 INCH	TYPE IV, 15 INCH		JOINT	1 1/2"		3/4"
		LT / RT	FT	FT	SQ YD	SQ YD	SQ YD	SQ YD	FOOT	EACH	FOOT	EACH
54+76.39	NB	LT	114	12			152	152	12	90	252	37
54+76.39	SB	RT	114	12			152	152	12	90	252	
66+10.39	NB	LT	15	12		20		20		20	54	
218+44.39	SB	RT	6	12	8					20	36	
221+08.39	SB	RT	10	12	14					20	44	
223+72.39	SB	RT	8	12	11					20	40	
292+36.39	NB	LT	6	12	8					20	36	
292+36.39	SB	RT	6	12	8					20	36	
392+68.39	NB	LT	18	12		24		24		20	60	
			RURAL S	UBTOTAL	49	44	304	348	24	320	810	37
			URBAN S	UBTOTAL								
	<u> </u>			TOTAL	49	44	304	348	24	320	810	37

esign firm o. 184001036 **WhKS** cngincers + planners + land surveyors

USER NAME = bjohnson	DESIGNED	-	LNJ	REVISED -
	DRAWN	-	GSJ	REVISED -
PLOT SCALE = 100:0.0000 ':" / in.	CHECKED	-	RKA	REVISED -
PLOT DATE = 12/6/2023	DATE	-	12/6/2023	REVISED -

STATI	E OI	F ILLINOIS
DEPARTMENT	0F	TRANSPORTATION

	S	CHEDU	LE O	F QUA	ANTITIES		F.A.S. RTE	SECTION		COUNTY	TOTAL SHEETS	SHEET NO.
FAS	BOILTE '	2701 /F	AII :	8565 /	II 37\ RES	SURFACING	*	(105, 106) RS	-3	MARION	68	15
IAU	HOUTE A	270171	AU (	0303 (	IL 37) ILL	John Aufrid				CONTRACT	NO.76	L11
SCALE: 1" = 50'	SHEET 1	OF :	12 5	SHEETS	STA.	TO STA.		ILLING	IS FED.	AID PROJECT		

SIDEWALK AND O	CURB RAMP SCH	EDULE								
		EARTH	PORTLAND CEMENT	PORTLAND CEMENT	DETECABLE	DRIVEWAY	SIDEWALK	PIPE	PRECAST REINFORCED	PIPE CULVERTS,
LOCATION	STATION	EXCAVATION	CONCRETE DRIVEWAY	CONCRETE	WARNINGS	PAVEMENT	REMOVAL	CULVERT	CONCRETE FLARED END	CLASS D, TYPE 1
			PAVEMENT, 6 INCH	SIDEWALK 4 INCH		REMOVAL		REMOVAL	SECTIONS 15"	15"
		CU YD	SQ YD	SQ FT	SQ FT	SQ YD	SQ FT	FOOT	EACH	FOOT
ADAMS ST	31+82.00	2.2		280	20		170			
MADISON ST	37+95.00		7	385	20	7	220			
MONROE ST	41+22.00	12.8		250	20		210	5	1	27
SN 061-9902	54+00.00									
RU	JRAL SUBTOTAL	15	7	915	60	7	600	5	1	27
UR	BAN SUBTOTAL									
	TOTAL	15	7	915	60	7	600	5	1	27

SHOULDER SCHEDULE								
				EXCAVATING AND	AGGREGATE	HOT-MIX	HOT-MIX	SHOULDER
START	START	END	LENGTH	GRADING EXISTING	WEDGE SHOULDER,	ASPHALT	ASPHALT	RUMBLE STRIPS
LOCATION	STATION	STATION		SHOULDER	TYPE B	SHOULDERS, 8"	SHOULDERS	8 INCH
			FT	UNIT	TON	SQ YD	TON	FOOT
MAINLINE								
CHERRY ST (KINMUNDY	18+50.00	48+47.00	2997		189			
START SHLD WIDEN	48+47.00	71+68.00	2321	42	139	1887		
MCCARTY RD	71+68.00	120+57.00	4889	96	311	4269		
KINOKA RD	120+57.00	211+10.00	9053	181	593	8048		35381
BAYLIS RD	211+10.00	275+60.00	6450	129	421	5734		33301
ORCHARD RD	275+60.00	309+71.00	3411	66	207	2947		
7TH ST (ALMA)	309+71.00	372+13.00	6242	96	387	4245	269	
KENCO RD	372+13.00	416+81.00	4468		297		827	20810
MARTIN RD	416+81.00	449+60.00	3279	3	213	114	597	20010
BRIDGE OMISSION	449+60.00	452+40.00	280		19			
	452+40.00	461+47.00	907	3	61	114	170	
BRUBAKER RD	461+47.00	514+36.00	5289		335		936	20974
BASOM RD	514+36.00	567+28.00	5292		348		967	
SIDE ROADS								
KINLOU WYE								
MARTIN RD								
		RURAL S	SUBTOTAL	616	3520	27358	3766	77165
MAINLINE								
TONTI RD	567+28.00	603+82.00	3654		205		574	5507
HICKORY GROVE LN	603+82.00	624+69.00	2087	26	110	1134	355	5537
MADISON ST (SALEM)	624+69.00	625+00.00	31	1	3	28		
	•	URBAN S	UBTOTAL	27	318	1162	929	5537
			TOTAL	643	3838	28520	4695	82702

5	i .
i	design firm no. 184001036
il.	no. 184001036 <b>WNKS</b>
771	engineers + planners + land surveyors

USER NAME = bjohnson	DESIGNED	-	LNJ	REVISED	-
	DRAWN	-	GSJ	REVISED	-
PLOT SCALE = 100:0.0000 ':" / in.	CHECKED	-	RKA	REVISED	-
PLOT DATE = 12/6/2023	DATE	-	12/6/2023	REVISED	-

STATE OF ILLINOIS							
DEPARTMENT	0F	TRANSPORTATION					

		F.A.S. RTE	SEC.	TION		COUNTY	TOTAL SHEETS						
	FAS	ROUTE	2701 /FAI	2255	/II 37\ RF	SHREVCING	*	(105, 10	06) RS-3		MARION	68	16
	FAS ROUTE 2701 /FAU 8565 (IL 37) RESURFACING										CONTRACT	NO.76	L11
S	CALE: 1" = 50'	SHEET 2	OF 12	SHEETS	STA.	TO STA.			ILLINOIS	FED. A	ID PROJECT		

PAVEMENT MARKING SCHEDULE							
				THERMOPLASTIC	THERMOPLASTIC	RAISED	RAISED REFLECTIVE
START	START	END	LENGTH	PAVEMENT	PAVEMENT	REFLECTIVE	PAVEMENT
LOCATION	STATION	STATION		MARKING - LINE 6"	MARKING - LINE 24"	PAVEMENT MARKER	MARKER REMOVAL
			FT	FOOT	FOOT	EACH	EACH
MAINLINE							
CHERRY ST (KINMUNDY	18+50.00	71+68.00	5318.00	13,765	144	100	100
MCCARTY RD	71+68.00	120+57.00	4889.00	14,052		65	65
KINOKA RD	120+57.00	211+10.00	9053.00	23,487		115	115
BAYLIS RD	211+10.00	275+60.00	6450.00	15,208		82	82
ORCHARD RD	275+60.00	309+71.00	3411.00	7,386		44	44
7TH ST (ALMA)	309+71.00	372+13.00	6242.00	13,936		82	82
KENCO RD	372+13.00	416+81.00	4468.00	15,831		60	60
MARTIN RD	416+81.00	461+47.00	4466.00	13,622		44	44
BRUBAKER RD	461+47.00	514+36.00	5289.00	11,916		81	81
BASOM RD	514+36.00	567+28.00	5292.00	11,830		68	68
		RURAL S	UBTOTAL	141,033	144	741	741
MAINLINE							
TONTI RD	567+28.00	603+82.00	3654.00	7,860		49	49
HICKORY GROVE LN	603+82.00	624+69.00	2087.00	4,446		34	34
MADISON ST (SALEM)	624+69.00	625+00.00	31.00	70		2	2
		URBAN S	UBTOTAL	12,376		85	85
			TOTAL	153,409	144	826	826

TEMPORARY PAVEMENT M	ARKING SCHEI	DULE				
				TEMPORARY	TEMPORARY	PAVEMENT MARKING
START	START	END	LENGTH	PAVEMENT MARKING	PAVEMENT MARKING	REMOVAL -
LOCATION	STATION	STATION		LINE 6" - PAINT	LINE 24" - PAINT	WATER BLASTING
			FT	FOOT	FOOT	SQ FT
MAINLINE						
CHERRY ST (KINMUNDY	18+50.00	71+68.00	5318.00	13,765	144	7,171
MCCARTY RD	71+68.00	120+57.00	4889.00	14,052		7,026
KINOKA RD	120+57.00	211+10.00	9053.00	23,487		11,744
BAYLIS RD	211+10.00	275+60.00	6450.00	15,208		7,604
ORCHARD RD	275+60.00	309+71.00	3411.00	7,386		3,693
7TH ST (ALMA)	309+71.00	372+13.00	6242.00	13,936		6,968
KENCO RD	372+13.00	416+81.00	4468.00	15,831		7,916
MARTIN RD	416+81.00	461+47.00	4466.00	13,622		6,811
BRUBAKER RD	461+47.00	514+36.00	5289.00	11,916		5,958
BASOM RD	514+36.00	567+28.00	5292.00	11,830		5,915
		RURAL S	UBTOTAL	. 141,033	144	70,806
MAINLINE						
TONTI RD	567+28.00	603+82.00	3654.00	7,860		3,930
HICKORY GROVE LN	603+82.00	624+69.00	2087.00	4,446		2,223
MADISON ST (SALEM)	624+69.00	625+00.00	31.00	70		35
		URBAN S	SUBTOTAL	. 12,376		6,188
			TOTAL	. 153,409	144	76,994

design firm
no. 184001036 whks

engineers + planners + land surveyors

JSER NAME = bjohnson	DESIGNED - LNJ	REVISED -
	DRAWN - GSJ	REVISED -
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PLOT DATE = 12/6/2023	DATE - 12/6/2023	REVISED -

STATE	0F	ILLINOIS
DEPARTMENT	OF	TRANSPORTATION

SCALE: 1" = 50'

	SCHEDULE OF QUANTITIES AS ROUTE 2701 /FAU 8565 (IL 37) RESURFACING    SHEET 3 OF 12 SHEETS STA. TO STA.	S	F.A.S. RTE	SEC	TION		COUNTY	TOTAL SHEETS				
FΛC	ROUTE	2701 /FAII	8565 /	II 37\ E	RESTIBENCING	*	(105, 10	06) RS-3		MARION	68	17
ואט	HOULE	2701 / I AU	0303 (	IL 37/ I	ILJUIII AUJIVU					CONTRAC	Γ NO.76	L11
50'	SHEET 3	OF 12	SHEETS	STA.	TO STA.			ILLINOIS	FED. AI	D PROJECT		

EROSION CONTR	OL										
		GRADING AND	SEEDING, CLASS	NITROGEN	PHOSPHORUS	POTASSIUM	MULCH, METHOD 2	STONE	STONE RIPRAP,	FILTER FABRIC	GABIONS
LOCATION	STATION	SHAPING DITCHES	2A	FERTILIZER	FERTILIZER	FERTILIZER		RIPRAP,	CLASS A4		
				NUTRIENT	NUTRIENT	NUTRIENT		CLASS A3			
		FOOT	ACRE	POUND	POUND	POUND	ACRE	TON	TON	SQ YD	CU YD
ADAMS ST	31+82.00		0.05	5	5	5	0.05				
MADISON ST	37+95.00		0.05	5	5	5	0.05				
MONROE ST	41+22.00	50	0.05	5	5	5	0.05	9		9	
SN 061-2423	240+93.00		0.05	5	5	5	0.05		33	30	
SN 061-2423	251+85.00		0.05	5	5	5	0.05		47	45	60
RU	JRAL SUBTOTAL	50	0.25	25	25	25	0.25	9	80	84	60
UF	RBAN SUBTOTAL										
	TOTAL	50	0.25	25	25	25	0.25	9	80	84	60

SIGN SCHEDULE					
		REMOVE SIGN	RELOCATE SIGN	RECTANGULAR RAPID	
LOCATION	STATION	PANEL ASSEMBLY -	PANNEL ASSEMBLY	FLASHING BEACON	
		TYPE A	TYPE A	ASSEMBLY (COMPLETE)	
		EACH	EACH	EACH	
ADAMS ST	31+82.00	2		2	
MADISON ST	37+95.00		1	2	
MONROE ST 41+22.00				2	
SN 061-9902	54+00.45				
7TH ST	309+71.00	2			
RUP	RAL SUBTOTAL	4	1	6	
URB	AN SUBTOTAL				
	TOTAL	4	1	6	
	,		•	•	

R.O.W. AND PROPERTY CORNER SCHEDULE									
DESCRIPTION/	RIGHT-OF-WAY AND								
LOCATION	STATION	OFFSET	PROPERTY CORNER						
IL 37 - KINMUNDY	38+20.53	30.83 LT	1						
IL 37 - KINMUNDY	38+20.81	29.17 RT	1						
	2								

design firm no. 184001036 **whks** engineers + planners + land surveyors

USER NAME = gjameson	DESIGNED	-	LNJ	REVISED -
	DRAWN	-	GSJ	REVISED -
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PLOT DATE = 1/24/2024	DATE	-	1/24/2024	REVISED -

STATE OF ILLINOIS
DEPARTMENT OF TRANSPORTATION

SCHEDULE OF QUANTITIES FAS ROUTE 2701 /FAU 8565 (IL 37) RESURFACING										
	SCALE: 1" = 50'	SHEET 4	OF	12	SHEETS	STA.	TO STA.			

SHOW! IEKIM	PAVEMENT MA	100000	TEMPORARY	SHORT TERM	SHORT TERM
CTATION	CTATION	LENGTH			
STATION	STATION	LENGTH	RAMP	PAVEMENT	PAVEMENT
			60 VD	MARKING	MARKING REMOVA
010 - 50 00	010.71.00	FT	SQ YD	FOOT	SQ FT
018+50.00	018+74.00	24	13	2	1
018+74.00	031+82,00	1308	53	119	40
031+82,00	035+41.00	359		33	11
035+41.00	037+95.00	254	68	23	8
037+95.00	041+22.00	327	68	30	10
041+22.00	049+19.00	797		72	24
049+19.00	054+21.00	502		46	15
054+21.00	065+44.00	1123	139	102	34
065+44.00	069+60.00	416		38	13
069+60.00	071+68.00	208	102	19	6
071+68.00	076+40.00	472		43	14
076+40.00	084+82.00	842	118	77	26
084+82.00	089+98.00	516		47	16
089+98.00	091+50.00	152		14	5
091+50.00	102+70.00	1120		102	34
102+70.00	119+60.00	1690	44	154	51
119+60.00	120+57.00	97		9	3
120+57.00	135+73.00	1516	34	138	46
135+73.00	139+35.00	362		33	11
139+35.00	179+00.00	3965	45	360	120
179+00,00	185+14.00	614		56	19
185+14.00	189+24.00	410		37	12
189+24.00	195+31.00	607		55	18
195+31,00	203+68,00	837		76	25
203+68.00	211+10.00	742	120	67	22
211+10.00	220+83.00	973		88	29
220+83.00	240+93.00	2010		183	61
240+93.00	251+85.00	1092		99	33
251+85.00	264+79.00	1294		118	39
264+79.00	275+60.00	1081	37	98	33
275+60.00	277+27,00	167		15	5
277+27.00	309+71.00	3244	325	295	98
309+71.00	340+61,00	3090	411	281	94
340+61.00	368+57.00	2796	711	254	85
368+57.00	372+13.00	356	29	32	11
					12
372+13.00	376+07.00	394		36	
376+07.00	384+83.00	876		80	27
384+83.00	394+06.00	923		84	28
394+06.00	395+81.00	175		16	5
395+81.00	404+75.00	894	4.5	81	27
404+75.00	416+81.00	1206	46	110	37
416+81.00	420+20.00	339		31	10

SHORT TERM	PAVEMENT MA	ARKING SO	CHEDULE		
			TEMPORARY	SHORT TERM	SHORT TERM
STATION	STATION	LENGTH	RAMP	PAVEMENT	PAVEMENT
				MARKING	MARKING REMOVAL
		FT	SQ YD	FOOT	SQ FT
420+20.00	429+45.00	925		84	28
	TABLE S	UBTOTAL	1,652	3737	1246
429+45.00	439+95.00	1050		95	32
439+95.00	449+87.00	992	50	90	30
449+87.00	452+04.00	217		20	7
452+04.00	461+47.00	943	49	86	29
461+47.00	462+23.00	76		7	2
462+23.00	514+36.00	5213	257	474	158
514+36.00	567+28,00	5292	184	481	160
	RURAL S	UBTOTAL	2,192	4990	1664
567+28.00	600+43.00	3315	350	301	100
600+43.00	603+82.00	339	105	31	10
603+82.00	607+17.00	335	55	30	10
607+17.00	621+41.00	1424	350	129	43
621+41.00	624+69.00	328	46	30	10
624+69.00	625+00.00	31	13	3	1
	URBAN S	UBTOTAL	919	524	174
		TOTAL	3,111	5,514	1,838

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:	design firm no 184001036	· · · blea
MAINE.	110. 104001030	wnks
N L	onginoom	+ planners + land surveyors
Ī	digilicos	+ plainieis + lana sarveyors

USER NAME = bjohnson	DESIGNED	-	LNJ	REVISED	-
	DRAWN	-	GSJ	REVISED	-
PLOT SCALE = 100:0.0000 ':" / in.	CHECKED	-	RKA	REVISED	-
PLOT DATE = 12/6/2023	DATE	-	12/6/2023	REVISED	-

STATE OF ILLINOIS DEPARTMENT OF TRANSPORTATION

	SCHEDULE OF QUANTITIES								
FAS	FAS ROUTE 2701 /FAU 8565 (IL 37) RESURFACING								
SCALE: 1" = 50'	SCALE: 1" = 50' SHEET 5 OF 12 SHEETS STA. TO STA.								

COUNTY SHEETS NO.

MARION 68 19

CONTRACT NO.76L11

MAINTENANCE OF	TRAFFIC SCHE	DULE							
				TEMPORARY	TEMPORARY	RELOCATE	IMPACT ATTENUATORS,	IMPACT ATTENUATORS,	FILLING INLETS,
STATION	STATION	OFFSET	STAGE	RUMBLE STRIPS	CONCRETE BARRIER	TEMPORARY	TEMPORARY (NON-	RELOCATE (NON-	TEMPORARY
						CONCRETE BARRIER	REDIRECTIVE,	REDIRECTIVE,	
							NARROW), TEST LEVEL 3	NARROW), TEST LEVEL 3	
		LT / RT		EACH	FOOT	FOOT	EACH	EACH	EACH
429+54.00	439+54.00	RT	1	3					
448+13.00	453+75.00	LT / RT	1		562.5		2		2
462+55.00	472+55.00	LT	1	3					
448+25.00	453+88.00	LT / RT	2			562.5		2	
		RUR	AL SUBTOTAL	6	562.5	562.5	2	2	2
	URBAN SUBTOTA								
			TOTAL	6	562.5	562.5	2	2	2

GUARDRAIL S	CHEDULE									
			STEEL PLATE BEAM	STRONG POST	LONG-SPAN	TRAFFIC BARRIER	TRAFFIC BARRRIER	GUARDRAIL	TERMINAL	GUARDRAIL
STATION	STATION	OFFSET	GUARDRAIL, TYPE A,	GUARDRAIL ATTACHED	GUARDRAIL OVER	TERMINAL,	TERMINAL, TYPE 1	REMOVAL	MARKER-	REFLECTORS,
			6 FOOT POSTS	TO CULVERT	CULVERT, 12FT 6 IN	TYPE 6	(SPECIAL) TANGENT		DIRECT APPLIED	TYPE A
		LT / RT	FOOT	FOOT	FOOT	EACH	EACH	FOOT	EACH	EACH
53+00.56	54+00.56	LT	12.5	37.5			1		1	4
250+10.81	252+60.81	RT	134	16			2		2	4
251+06.20	253+68.70	-	137.5	25			2	543	2	4
444+98.56	449+60.46	LT	375			1	1		1	4
445+33.55	449+95.45	RT	375			1	1	1538	1	4
452+00.21	457+12.11	LT	475			1	1	1556	MARKER- DIRECT APPLIED EACH 1	4
452+35.04	454+96.94	RT	175			1	1		1	4
	RURAL S	SUBTOTAL	1684	78.5		4	9	2081	9	28
606 : 47.05	607.04.55	D.T.			27.5		2	116		4
606+47.05					37.5		2	116		4
	URBAN S	SUBTOTAL			37.5		2	116	2	4
		TOTAL	1684	78.5	37.5	4	11	2197	11	32

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USER NAME = bjohnson	DESIGNED	-	LNJ	REVISED -
	DRAWN	-	GSJ	REVISED -
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PLOT DATE = 12/6/2023	DATE	-	12/6/2023	REVISED -

STATE OF	ILLINOIS
DEPARTMENT OF	TRANSPORTATION

	F.A.S. RTE.	SECT	LION						
FAS	*	(105, 10	6) RS-3						
ine									
SCALE: 1" = 50'	SHEET 6	OF 12	SHEETS	STA.	TO STA.			ILLINOIS	FED.

COUNTY TOTAL SHEET NO.

MARION 68 20

						PAVED	PAVED	BITUMINOUS	HOT-MIX-ASPHALT	INCIDENTAL HOT
ROAD	ENTRANCE	ENTRANCE	STATION	OFFSET	WIDTH	LENGTH	AREA	MATERIALS	SURFACE REMOVAL-	MIX ASPHALT
NAME	TYPE	MATERIAL			AT EOP			(TACK COAT)	BUTT JOINT	SURFACING
				LT / RT	FT	FT	SQ FT	POUND	SQ YD	TON
E CHERRY ST	SR	AGG	18+74.00	RT	61					
	RE	AGG	21+30.00	RT	94					
N GOODWIN ST	SR	AGG	22+57.00	RT	79					
E SYCAMORE ST	SR	AGG	24+49.00	RT	116					
	FE	AGG	25+70.00	RT	55					
	FE	AGG	26+53.00	RT	54					
	FE	AGG	27+50.00	RT	43					
	CE	НМА	28+41.00	LT						
KINLOU ST / E 1ST ST	SR	НМА	29+60.00	LT						
KINLOU ST / E 1ST ST	SR	НМА	31+05.00	LT						
N ADAMS ST	SR	BIT	31+82.00	RT	52	10	438			
ADAMS ST	SR	BIT	31+82.00	LT	44	10	621			
	RE	AGG	32+89.00	RT	27					
	RE	НМА	33+14.00	LT						
	RE	AGG	33+49.00	RT	34					
	RE	AGG	33+90.00	RT	48					
N JEFFERSON ST	SR	BIT	35+41.00	RT						
S JEFFERSON ST	SR	НМА	35+41.00	LT						
	CE	НМА	36+32.00	LT						
N MADISON ST	SR	віт	37+95.00	RT	57	10	466			
S MADISON ST	SR	BIT	37+95.00	LT	65	24	1560			
	CE	НМА	39+35.00	LT						
	RE	AGG	39+56.00	RT	36					
S MONROE ST	SR	BIT	41+22.00	LT	57	10	455			
N MONROE ST	SR	BIT	41+22.00	RT	65	10	536			
	RE	AGG	42+20.00	RT	20					
	FE	НМА	42+87.00	LT						
	RE	AGG	43+48.00	RT	34					
	RE	НМА	44+38.00	RT						
	CE	AGG	45+07.00	LT	49					
S EAGAN ST	SR	BIT	45+75.00	LT						
	RE	AGG	46+05.00	RT	24					
S LINCOLN ST	SR	BIT	48+23.00	LT						
N LINCOLN ST	SR	BIT	48+32.00	RT						
	RE	AGG	50+03.00	RT	20	4	80			
	CE	AGG	55+09.00	RT	170	4	680			
LOWE RD	SR	НМА	56+88.00	RT	174	10	1069			
		AGG	60+68.00	RT	137	4	548			
	CE	НМА	64+83.00	LT	76	10	621	23	51	6
	CE	PCC	65+92.00	LT	117					
	CE	PCC	66+82.00	LT	107					
	RE	AGG	69+72.00	LT	65	4	260			
	RE	AGG	71+34.00	LT	68	4	272			

AGG = AGGREGATE WIDTH = DISTANCE ALONG EDGE OF PAVEMENT
BIT = BITUMINOUS TREATED / CHIP SEAL LENGTH = DISTANCE PERPENDICULAR TO EDGE OF PAVEMENT

USER NAME = bjohnson	DESIGNED	-	LNJ	REVISED	-
	DRAWN	-	GSJ	REVISED	-
PLOT SCALE = 100:0.0000 ':" / in.	CHECKED	-	RKA	REVISED	-
PLOT DATE = 12/6/2023	DATE	-	12/6/2023	REVISED	-

STATE OF ILLINOIS **DEPARTMENT OF TRANSPORTATION** 

SCHEDULE OF QUA	ANTITIES	F.A.S. RTE.	SEC.	TION		COUNTY	TOTAL SHEETS	SHEET NO.
FAS ROUTE 2701 /FAU 8565 (	II 37) RESUREACING	*	(105, 10	06) RS-3		MARION	68	21
1A3 11001E 270171A0 0303 (	IL 37/ ILSOIII AGIIVG					CONTRACT	NO.76	L11
SCALE: 1" = 50' SHEET 7 OF 12 SHEETS	STA. TO STA.			ILLINOIS	FED. AI	D PROJECT		

SIDE ROAD / ENTRANCE	SCHEDULE									
ROAD NAME	ENTRANCE TYPE	ENTRANCE MATERIAL	STATION	OFFSET	WIDTH AT EOP FT	PAVED LENGTH FT	PAVED AREA SQ FT	BITUMINOUS MATERIALS (TACK COAT) POUND	HOT-MIX-ASPHALT SURFACE REMOVAL- BUTT JOINT SQ YD	INCIDENTAL HOT- MIX ASPHALT SURFACING TON
MCCARTY RD	SR	BIT	71+68.00	RT	77	10	630	23	51	6
I-ree/ii(TT-ree		BIT	71100.00	101		TABLE S		46	102	12
W 4TH ST	SR	BIT	71+68.00	LT	107	10	564	32	71	8
	RE	AGG	73+09.00	LT	57	4	228		, ,	
	RE	AGG	73+22.00	RT	33	4	132			
	RE	AGG	73+76.00	RT	32	4	128			
	RE	AGG	74+47.00	LT	90	4	360			
	RE	AGG	74+97.00	RT	35	4	140			
	RE	AGG	76+14.00	LT	51	4	204			
	RE	AGG	77+65.00	RT	28	4	112			
	RE	НМА	80+16.00	LT	66	10	561	20	44	5
	RE	AGG	80+68.00	RT	27	4	108			
	RE	НМА	82+26.00	LT	67	10	532	20	45	5
	CE	НМА	83+56.00	LT	80	10	667	24	53	6
	RE	AGG	84+03.00	RT	22	4	88			
	RE	AGG	84+85.00	LT	50	4	200			
	RE	AGG	85+30.00	LT	71	4	284			
	FE	AGG	85+31.00	RT	39	4	156			
	RE	AGG	86+78.00	LT	61	4	244			
	FE	AGG	93+03.00	LT	36	4	144			
	RE	AGG	96+71.00	RT	63	4	252			
	RE	AGG	98+34.00	RT	60	4	240			
	RE	AGG	99+16.00	RT	66	4	264			
	RE	AGG	104+32.00	RT	58	4	232			
	CE	НМА	112+60.00	RT	79	10	649	24	53	6
KINOKA RD	SR	PCC	120+57.00	RT	173					
	FE	AGG	120+61.00	LT	66	4	264			
	CE	НМА	126+71.00	RT	62	10	525	19	41	5
COUNTY ROAD 1475 E	SR	AGG	139+35.00	RT	86	4	344			
COUNTY ROAD 1475 E	SR	AGG	139+35.00	LT	115	4	460			
	FE	AGG	145+89.00	RT	37	4	148			
	RE	AGG	163+39.00	RT	49	4	196			
	FE	НМА	165+51.00	LT	43	10	369			
	FE	AGG	165+59.00	RT	57	4	228			
	RE	AGG	168+27.00	RT	47	4	188			
	RE	AGG	169+77.00	RT	42	4	168			
	RE	AGG	171+59.00	RT	44	4	176			
	FE	НМА	174+09.00	LT	38	10	308			
	RE	AGG	174+40.00	RT	69	4	276			
	RE	AGG	203+16.00	RT	63	4	252			
	FE	AGG	209+29.00	RT	38	4	152			
BAYLIS RD	SR	BIT	211+10.00	LT	112	10	933	34	75	8
FHA RD	SR	BIT	211+10.00	RT	105	10	874	32	70	8

AGG = AGGREGATE WIDTH = DISTANCE ALONG EDGE OF PAVEMENT
BIT = BITUMINOUS TREATED / CHIP SEAL LENGTH = DISTANCE PERPENDICULAR TO EDGE OF PAVEMENT

USER NAME = bjohnson	DESIGNED	-	LNJ	REVISED -
	DRAWN	-	GSJ	REVISED -
PLOT SCALE = 100:0.0000 ':" / in.	CHECKED	-	RKA	REVISED -
PLOT DATE = 12/6/2023	DATE	-	12/6/2023	REVISED -

STATE OF ILLINOIS
DEPARTMENT OF TRANSPORTATION

		CHEDULE	OF QU	ANTITIES		F.A.S. RTE.	SECT	ПОИ		COUNTY	TOTAL SHEETS
FΛC	POLITE	2701 /FAII	8565	(II 37) RE	ESURFACING	*	(105, 10	6) RS-3		MARION	68
170	HOUIL	27017170	0303	(IL 37) III	LOOM AUNT					CONTRACT	NO.76
SCALE: 1" = 50'	SHEET 8	OF 12	SHEETS	STA.	TO STA.			ILLINOIS	FED. A	ID PROJECT	

						PAVED	PAVED	BITUMINOUS	HOT-MIX-ASPHALT	INCIDENTAL HOT-
ROAD	ENTRANCE	ENTRANCE	STATION	OFFSET	WIDTH	LENGTH	AREA	MATERIALS	SURFACE REMOVAL-	MIX ASPHALT
NAME	TYPE	MATERIAL			AT EOP			(TACK COAT)	BUTT JOINT	SURFACING
				LT / RT	FT	FT	SQ FT	POUND	SQ YD	TON
	CE	AGG	243+31.00	RT	74	4	296			
	RE	AGG	249+44.00	RT	48	4	192			
	CE	AGG	254+28.00	RT	50	4	200			
		1	L		1	TABLE S	JBTOTAL	203	452	51
	CE	AGG	256+89.00	RT	57	4	228			
LAUGHMAN RD	SR	AGG	264+79.00	LT	91	4	364			
	RE	НМА	270+68.00	RT	66	10	541	20	44	5
ORCHARD RD	SR	AGG	275+60.00	RT	83	4	332			
	FE	AGG	284+30.00	RT	44	4	176			
	RE	НМА	290+05.00	RT	27	10	202	8	18	2
	CE	PCC	293+01.00	LT	76					
	CE	НМА	293+42.00	RT	37	10	294	11	25	3
	CE	AGG	296+52.00	RT	68	4	272			
	CE	AGG	297+99.00	RT	68	4	272			
	CE	НМА	298+28.00	LT	59	10	481	18	39	4
	CE	AGG	299+35.00	RT	64	4	256			
	CE	AGG	300+55.00	RT	68	4	272			
	CE	AGG	301+86.00	LT	76	4	304			
8TH ST	SR	PCC	302+15.00	RT	66					
	CE	AGG	302+59.00	LT	97	4	388			
	CE	AGG	303+46.00	LT	75	4	300			
	CE	PCC	303+48.00	RT	50					
	RE	AGG	303+89.00	RT	27	4	108			
	CE	AGG	304+96.00	LT	76	4	304			
	CE	AGG	305+35.00	RT	42	4	168			
BROADWAY AVE	SR	BIT	305+98.00	RT	62	10	524	19	41	5
	CE	AGG	306+66.00	LT	59	4	236			
	CE	НМА	306+89.00	RT	156	10	1444	47	104	12
	CE	AGG	307+14.00	LT	60	4	240			
	CE	НМА	307+93.00	RT	82	10	682	25	55	6
7TH ST	SR	BIT	309+71.00	LT	98	10	765	29	65	5
7TH ST	SR	BIT	309+71.00	RT	63	10	525	19	42	7
	CE	AGG	310+49.00	RT	93	4	372			
6TH ST	SR	BIT	313+23.00	RT	54	10	418	16	36	4
	CE	НМА	316+02.00	RT	87	10	702	26	58	6
5TH ST	SR	BIT	316+82.00	RT	83	10	670	25	55	6
	RE	AGG	317+74.00	RT	59	4	236			
	RE	AGG	319+25.00	RT	46	4	184			
	CE	AGG	319+86.00	LT	182	4	728			
4TH ST	SR	BIT	320+50.00	RT	75	10	606	23	50	6
	RE	AGG	320+91.00	RT	60	4	240			
	RE	AGG	322+13.00	RT	55	4	220			
3RD ST	SR	BIT	324+09.00	RT	66	10	529	20	44	5

AGG = AGGREGATE WIDTH = DISTANCE ALONG EDGE OF PAVEMENT
BIT = BITUMINOUS TREATED / CHIP SEAL LENGTH = DISTANCE PERPENDICULAR TO EDGE OF PAVEMENT

DESIGNED - LNJ REVISED DRAWN -GSJ REVISED LOT SCALE = 100:0.0000 ':" / in. CHECKED -RKA REVISED PLOT DATE = 12/6/2023 DATE REVISED

STATE OF ILLINOIS **DEPARTMENT OF TRANSPORTATION** 

SECTION COUNTY SCHEDULE OF QUANTITIES (105, 106) RS-3 MARION 68 23 FAS ROUTE 2701 /FAU 8565 (IL 37) RESURFACING CONTRACT NO.76L11 SCALE: 1" = 50' SHEET 9 OF 12 SHEETS STA.

						PAVED	PAVED	BITUMINOUS	HOT-MIX-ASPHALT	INCIDENTAL HOT
ROAD	ENTRANCE	ENTRANCE	STATION	OFFSET	WIDTH	LENGTH	AREA	MATERIALS	SURFACE REMOVAL-	MIX ASPHALT
NAME	TYPE	MATERIAL			AT EOP			(TACK COAT)	BUTT JOINT	SURFACING
				LT / RT	FT	FT	SQ FT	POUND	SQ YD	TON
	CE	НМА	326+45.00	RT	47	10	379	14	31	4
	CE	НМА	327+20.00	RT	51	10	413	15	34	4
2ND ST	SR	BIT	327+68.00	RT	77	10	629	23	51	6
	FE	НМА	328+72.00	RT	66	10	545			
	CE	НМА	329+82.00	RT	75	10	610	23	50	6
						TABLE S	UBTOTAL	380	842	96
IST ST	SR	BIT	331+35.00	RT	58	10	655	17	39	4
	CE	AGG	331+66.00	RT	41	4	164			
	CE	AGG	334+75.00	RT	71	4	284			
	FE	AGG	340+03.00	RT	56	4	224			
	FE	AGG	351+06.00	RT	68	4	272			
	FE	AGG	358+65.00	RT	42	4	168			
	FE	AGG	369+98.00	RT	30	4	120			
KENCO ROAD	SR	BIT	372+13.00	LT	52	4	208			
	CE	AGG	383+21.00	LT	55	4	220			
	FE	AGG	383+46.00	RT	77	4	308			
	CE	AGG	385+27.00	LT	52	4	208			
	FE	AGG	389+24.00	RT	95	4	380			
	FE	AGG	389+26.00	LT	61	4	244			
	FE	AGG	395+40.00	RT	43	4	172			
	FE	AGG	395+43.00	LT	41	4	164			
UNNAMED ROAD	SR	AGG	405+04.00	RT	79	4	316			
MARTIN RD	SR	BIT	416+81.00	RT	82	4	328			
	FE	AGG	428+31.00	RT	43	4	172			
	FE	AGG	442+89.00	LT	78	4	312			
TOWNHOUSE RD	SR	BIT	442+96.00	RT	90	4	360			
	FE	AGG	458+89.00	RT	36	4	144			
	FE	AGG	459+46.00	LT	113	4	452			
BRUBAKER RD	SR	BIT	461+47.00	LT	88	4	352			
	RE	НМА	463+69.00	RT	68	4	272			
	RE	НМА	468+59.00	RT	46	4	184			
	CE	AGG	469+74.00	LT	54	4	216			
	RE	НМА	471+53.00	RT	46	4	184			
	RE	НМА	472+49.00	RT	36	4	144			
	RE	AGG	474+62.00	RT	26	4	104			
	CE	НМА	476+22.00	RT	72	4	288			
	RE	НМА	484+58.00	RT	42	4	168			
	RE	НМА	487+05.00	RT	47	4	188			
	RE	AGG	488+44.00	RT	58	4	232			
	FE	AGG	490+47.00	RT	41	4	164			
	RE	AGG	490+01.00	RT	36	4	144			
	RE	НМА	493+05.00	RT	56	4	224			
	RE	НМА	493+91.00	RT	49	4	196			

AGG = AGGREGATE WIDTH = DISTANCE ALONG EDGE OF PAVEMENT
BIT = BITUMINOUS TREATED / CHIP SEAL LENGTH = DISTANCE PERPENDICULAR TO EDGE OF PAVEMENT

JSER NAME = bjohnson	DESIGNED	-	LNJ	REVISED	-
	DRAWN	-	GSJ	REVISED	-
PLOT SCALE = 100:0.0000 ':" / in.	CHECKED	-	RKA	REVISED	-
PLOT DATE = 12/6/2023	DATE	-	12/6/2023	REVISED	-

STATE OF ILLINOIS
DEPARTMENT OF TRANSPORTATION

	S	CHEDULE	OF QU	ANTITIES		F.A.S. RTE	SEC <sup>-</sup>	TION		COUNTY	TOTAL SHEETS	SHEE NO.
FΔS	ROUTE 2	701 /FΔII	2565	(II 37) R	ESURFACING	*	(105, 10	)6) RS-3		MARION	68	24
170	, HOUTE 2	.701 / I AU	0303	(IL 37) III	LOOM AUNO					CONTRACT	NO.76	L11
SCALE: 1" = 50'	SHEET 10	OF 12	SHEETS	STA.	TO STA.			ILLINOIS	FED. AI	ID PROJECT		

SIDE ROAD / ENTRA	NCE SCHEDULE	:	I			DAVED	חאיירט	DITUMINOUS	LIOT MIV ACDUALT	INCIDENTAL LIOT
DOAD			CTATION	OFFCET	WIDTH	PAVED	PAVED	BITUMINOUS	HOT-MIX-ASPHALT	INCIDENTAL HOT-
ROAD	ENTRANCE		STATION	OFFSET			AREA	MATERIALS (TACK COAT)	SURFACE REMOVAL-	MIX ASPHALT
NAME	TYPE	MATERIAL		LT / DT	AT EOP		CO ET	(TACK COAT) POUND	BUTT JOINT	SURFACING
	CE	AGG	499+91.00	LT / RT	FT 65	FT 4	SQ FT 260	POUND	SQ YD	TON
	CE	AGG								
	RE	AGG	501+53.00	LT	62	4	248			
	FE	AGG	502+15.00 504+43.00	RT RT	51 36	4	204 144			
BASOM RD	SR	AGG		RT	62		248			
	SR	BIT	514+36.00		77	4	308			
BASOM RD	FE	AGG	514+38.00	LT		4	88			
	rc	AGG	519+78.00	LT	22	TABLE SU		17	39	Л
	FE	1	F 10 + 70 00	DT	26	1		17	39	4
	FE	AGG AGG	519+79.00	RT	26	4	104			
			527+44.00	LT	29	4	116			
	FE	AGG	527+45.00	RT	32	4	128			
	FE	AGG	532+07.00	LT	41	4	164			
	FE	AGG	532+11.00	RT	33	4	132			
	FE	AGG	532+90.00	LT	38	4	152			
	FE	AGG	540+90.00	LT	28	4	112			
	FE	AGG	541+64.00	RT	34	4	136			
	CE	AGG	548+61.00	LT	67	4	268			
	CE	HMA	550+68.00	LT	53	4	212			
	CE	AGG	552+11.00	LT	63	4	252			
	RE	HMA	553+69.00	LT	39	4	156			
	FE	AGG	558+93.00	LT	30	4	120			
	FE	AGG	564+57.00	LT	37	4	148			
						RURAL SI	JBIOTAL	646	1435	163
TONTI RD	SR	НМА	567+28.00	RT	71	4	284			
TONTI RD	SR	BIT	567+28.00	LT	92	4	368			
TONTI RD	RE	НМА	568+62.00		44		176			
	CE			RT		4				
	RE	HMA	570+57.00	LT	76	4	304			
CYCAMORE CT	SR	HMA BIT	571+03.00	RT	42 58	4	168 232			
SYCAMORE ST			572+42.00			4				
	RE RE	HMA	573+53.00	RT	30	4	120			
	RE	HMA	575+68.00 576+93.00	RT	38	4	152			
		HMA		RT	40	4	160			
CAKINOOD ST	RE	AGG	578+33.00	RT	26	4	104			
OAKWOOD ST	SR	BIT	578+70.00	RT	53	4	212			
	CE	HMA	580+62.00	RT	79	4	316			
	RE	AGG	582+36.00	RT	50	4	200			
	RE	HMA	583+41.00	RT	42	4	168			
	FE	HMA	583+38.00	LT	36	4	144			
	CE	НМА	585+24.00	RT	44	4	176			
	CE	HMA	586+93.00	RT	44	4	176			
	CE	PCC	588+64.00	RT	84	4	336			
	CE	PCC	590+46.00	RT	85	4	340			

SIDE ROAD / ENTRANCE SCHEDULE

AGG = AGGREGATE WIDTH = DISTANCE ALONG EDGE OF PAVEMENT
BIT = BITUMINOUS TREATED / CHIP SEAL LENGTH = DISTANCE PERPENDICULAR TO EDGE OF PAVEMENT

DESIGNED - LNJ REVISED DRAWN -GSJ REVISED LOT SCALE = 100:0.0000 ':" / in. CHECKED -RKA REVISED

STATE OF ILLINOIS **DEPARTMENT OF TRANSPORTATION** 

SCHEDULE OF QUANTITIES FAS ROUTE 2701 /FAU 8565 (IL 37) RESURFACING SCALE: 1" = 50' SHEET 11 OF 12 SHEETS STA.

SECTION COUNTY (105, 106) RS-3 MARION 68 25 CONTRACT NO.76L11


						PAVED	PAVED	BITUMINOUS	HOT-MIX-ASPHALT	INCIDENTAL HOT
ROAD	ENTRANCE	ENTRANCE	STATION	OFFSET	WIDTH	LENGTH	AREA	MATERIALS	SURFACE REMOVAL-	MIX ASPHALT
NAME	TYPE	MATERIAL			AT EOP			(TACK COAT)	BUTT JOINT	SURFACING
				LT / RT	FT	FT	SQ FT	POUND	SQ YD	TON
	CE	AGG	593+62.00	RT	60	4	240			
	FE	AGG	593+80.00	LT	52	4	208			
	FE	AGG	595+90.00	RT	60	4	240			
	RE	НМА	597+65.00	RT	50	4	200			
	RE	AGG	600+60.00	RT	58	4	232			
	CE	PCC	600+93.00	LT	50	4	200			
	RE	НМА	602+38.00	RT	41	4	164			
	CE	НМА	603+36.00	LT	59	4	236			
HICKORY GROVE LN	SR	BIT	603+82.00	RT	88	4	352			
	'		•			TABLE S	JBTOTAL			
	RE	НМА	606+07.00	RT	54	4	216			
	RE	НМА	606+66.00	LT	45	4	180			
	RE	НМА	607+66.00	LT	52	4	208			
	RE	НМА	609+51.00	LT	68	4	272			
	CE	НМА	609+75.00	RT	74	4	296			
	RE	НМА	611+27.00	LT	48	10	363	14	32	4
	RE	НМА	612+58.00	LT	46	10	770	14	31	3
	CE	НМА	612+86.00	LT	63	10	718	19	42	5
	CE	AGG	613+75.00	LT	110	4	440			
ANNER DR	SR	BIT	614+86.00	RT	96	10	789	29	64	7
	RE	AGG	615+23.00	LT	42	4	168			
	RE	AGG	616+33.00	LT	37	4	148			
	RE	AGG	616+54.00	RT	40	4	160			
	RE	НМА	617+15.00	LT	33	10	277	10	22	2
	RE	НМА	617+47.00	LT	32	10	258	10	21	2
	RE	AGG	617+00.00	RT	38	4	152			
	RE	AGG	619+15.00	RT	39	4	156			
	RE	AGG	619+17.00	LT	55	4	220			
	RE	AGG	619+60.00	RT	48	4	192			
	RE	НМА	621+35.00	RT	47	10	359	14	31	4
HARDACRE RD	SR	НМА	621+41.00	LT	71	10	581			
		AGG	622+90.00	RT	56	4	224			
		AGG	623+05.00	LT	33	4	132			
MADISON ST	SR	НМА	624+69.00	RT	83	10	675			
	1	1	1	Į.	1					
						TABLE SI	JBTOTAL	110	243	27
						RURAL SI	JBTOTAL	646	1435	163
						URBAN SI	JBTOTAL	110	243	27
							TOTAL	756	1678	190

AGG = AGGREGATE WIDTH = DISTANCE ALONG EDGE OF PAVEMENT
BIT = BITUMINOUS TREATED / CHIP SEAL LENGTH = DISTANCE PERPENDICULAR TO EDGE OF PAVEMENT

JSER NAME = bjohnson	DESIGNED	-	LNJ	REVISED	-
	DRAWN	-	GSJ	REVISED	-
PLOT SCALE = 100:0.0000 ':" / in.	CHECKED	-	RKA	REVISED	-
PLOT DATE = 12/6/2023	DATE	-	12/6/2023	REVISED	-


STATE OF ILLINOIS **DEPARTMENT OF TRANSPORTATION** 

Ī						F.A.S. RTE	SECTION	COUNTY	TOTAL SHEETS	SHEET NO.	
ı	FAS ROUTE 2701 /FAU 8565 (JL 37) RESURFACING					*	(105, 106) RS-3	MARION	68	26	
ļ	ותפ	HOUTE 2	/UI / I A	, 0303	(IL 37) ILS	OIII AUIIIU			CONTRACT	NO.76	L11
l	SCALE: 1" = 50'	SHEET 12	OF 12	SHEETS	STA.	TO STA.		ILLINOIS FED. A	ID PROJECT		

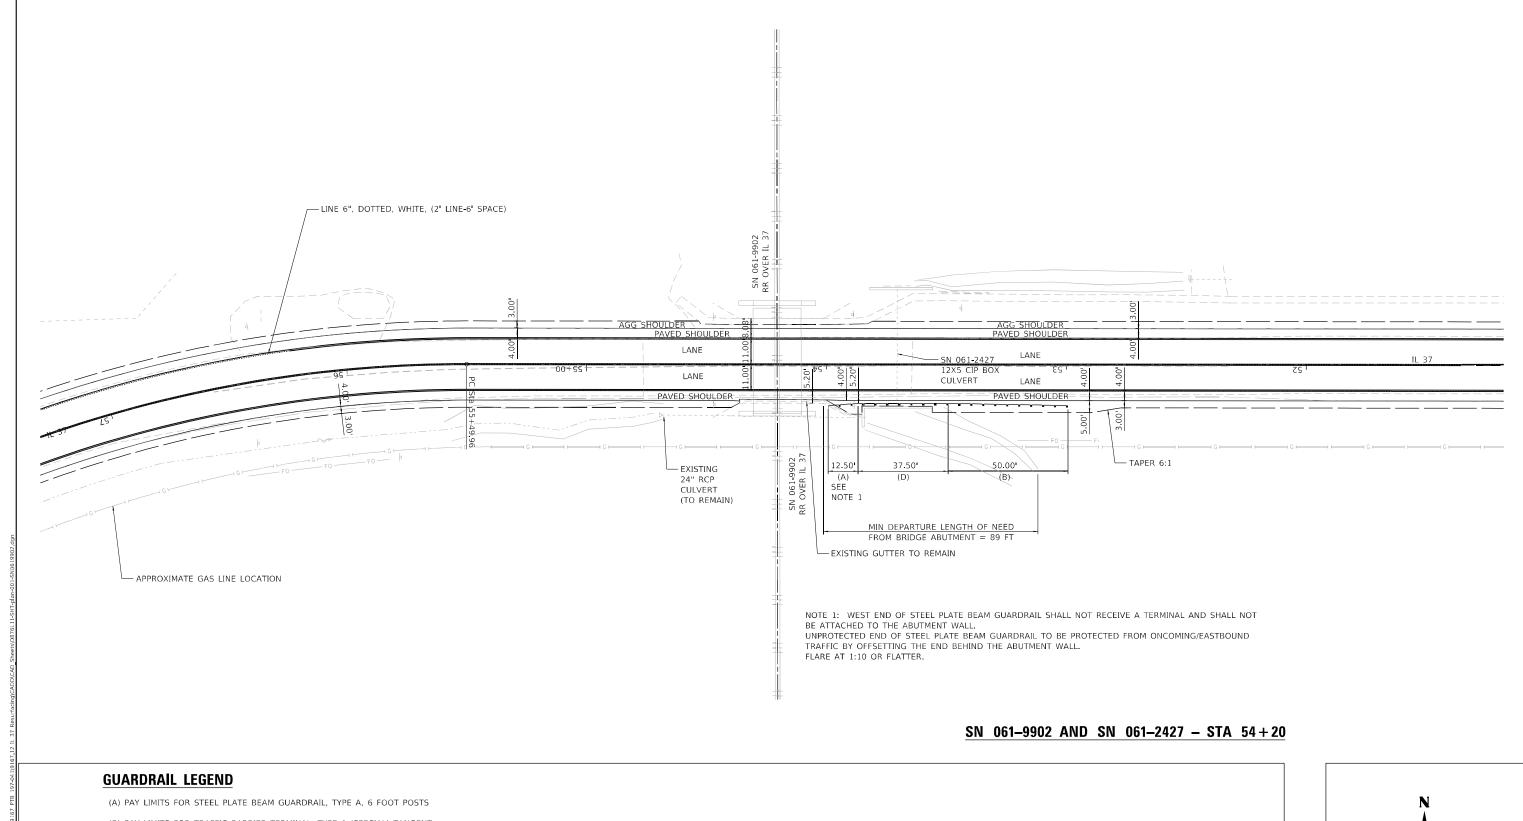

- (B) PAY LIMITS FOR TRAFFIC BARRIER TERMINAL, TYPE 1 (SPECIAL) TANGENT
- (C) PAY LIMITS FOR TRAFFIC BARRIER TERMINAL, TYPE 6
- (D) PAY LIMITS FOR STRONG POST GUARDRAIL ATTACHED TO CULVERT
- (E) PAY LIMITS FOR LONG-SPAN GUARDRAIL OVER CULVERT. 12 FT 6 IN SPAN

GUARDRAIL REFLECTORS SHALL BE INSTALLED PER HIGHWAY STANDARD 782006 GUARDRAIL AND BARRIER WALL REFLECTOR MOUNTING DETAILS.

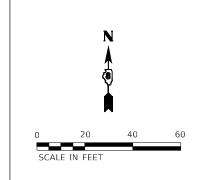

esign firm o. 18400103	whks
	engineers + planners + land surveyors

	USER NAME = bjohnson	DESIGNED	-	LNJ	REVISED	-
		DRAWN	-	GSJ	REVISED	-
_	PLOT SCALE = 40.0000 / in.	CHECKED	-	RKA	REVISED	-
5	PLOT DATE = 12/6/2023	DATE	-	12/6/2023	REVISED	-

STATE OF ILLINOIS
DEPARTMENT OF TRANSPORTATION


 PLAN DETAILS

 FAS ROUTE 2701 / FAU 8565 (IL 37) RESURFACING

 SCALE: 1" = 20'
 SHEET 1
 OF 6
 SHEETS STA.
 TO STA.

A.S. RTE		SEC <sup>-</sup>	ΓΊΟΝ		COUNTY	TOTAL SHEETS	SHEE
*		(105, 10	6) RS-3		MARION	68	27
·					CONTRACT	NO.76	L11
			ILLINOIS	FED. A	D PROJECT		

EXISTING STRUCTURE: S.N. 061-2424 CONSISTS OF A SINGLE BARREL 6X5 CAST-IN-PLACE CONCRETE BOX CULVERT WITH NO SKEW. EXISTING GROUND -

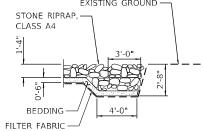

SECTION A-A

EX ROW

LAYOUT OF THE SCOUR MITIGATION SYSTEM MAY BE VARIED TO SUIT GROUND CONDITIONS IN THE FIELD AS DIRECTED BY THE ENGINEER.

AT THE WINGWALLS, NO EXCAVATION SHALL BE ALLOWED BELOW THE TOP OF THE FOOTING (IF PRESENT) OR BOTTOM OF CONCRETE ENCASEMENT (IF PRESENT).

CONTRACTOR TO LOCATE EXISTING UNDERGROUND UTILITIES. WHERE EXISTING UNDERGROUND UTILITIES CONFLICT WITH THE GABION PLACEMENT, THE CONTRACTOR SHALL ADJUST THE LAYOUT AS DIRECTED BY THE ENGINEER.

00+077 EX ROW EX ROW

### SN 061-2424 - STA 240+93

#### **GUARDRAIL LEGEND**

- (A) PAY LIMITS FOR STEEL PLATE BEAM GUARDRAIL, TYPE A, 6 FOOT POSTS
- (B) PAY LIMITS FOR TRAFFIC BARRIER TERMINAL, TYPE 1 (SPECIAL) TANGENT
- (C) PAY LIMITS FOR TRAFFIC BARRIER TERMINAL, TYPE 6
- (D) PAY LIMITS FOR STRONG POST GUARDRAIL ATTACHED TO CULVERT
- (E) PAY LIMITS FOR LONG-SPAN GUARDRAIL OVER CULVERT. 12 FT 6 IN SPAN

GUARDRAIL REFLECTORS SHALL BE INSTALLED PER HIGHWAY STANDARD 782006 GUARDRAIL AND BARRIER WALL REFLECTOR MOUNTING DETAILS.


#### **EROSION CONTROL LEGEND**

STONE RIPRAP, CLASS A4 WITH FILTER FABRIC

EX ROW

GABIONS



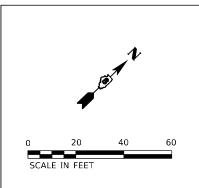

USER NAME = bjohnson	DESIGNED	-	LNJ	REVISED -
	DRAWN	-	GSJ	REVISED -
PLOT SCALE = 40:0.0000 ':" / in.	CHECKED	-	RKA	REVISED -
PLOT DATE = 12/6/2023	DATE	-	12/6/2023	REVISED -


STATE OF ILLINOIS


		PLAN	DETA	ILS	
FAS	ROUTE	2701 /FAU	8565	(IL 37) F	RESURFACING
SCALE: 1" = 50'	SHEET 2	OF 6	SHEETS	STA.	TO STA.

- A.S. RTE	SEC <sup>-</sup>	TION		COUNTY	TOTAL SHEETS	SHEE
*	(105, 106) RS-3			MARION	68	28
				CONTRACT	NO.76	L11
		ILLINOIS	FED Δ	ID PROJECT		

\* F.A.S 2701 & F.A.U. 8565

**DEPARTMENT OF TRANSPORTATION** 

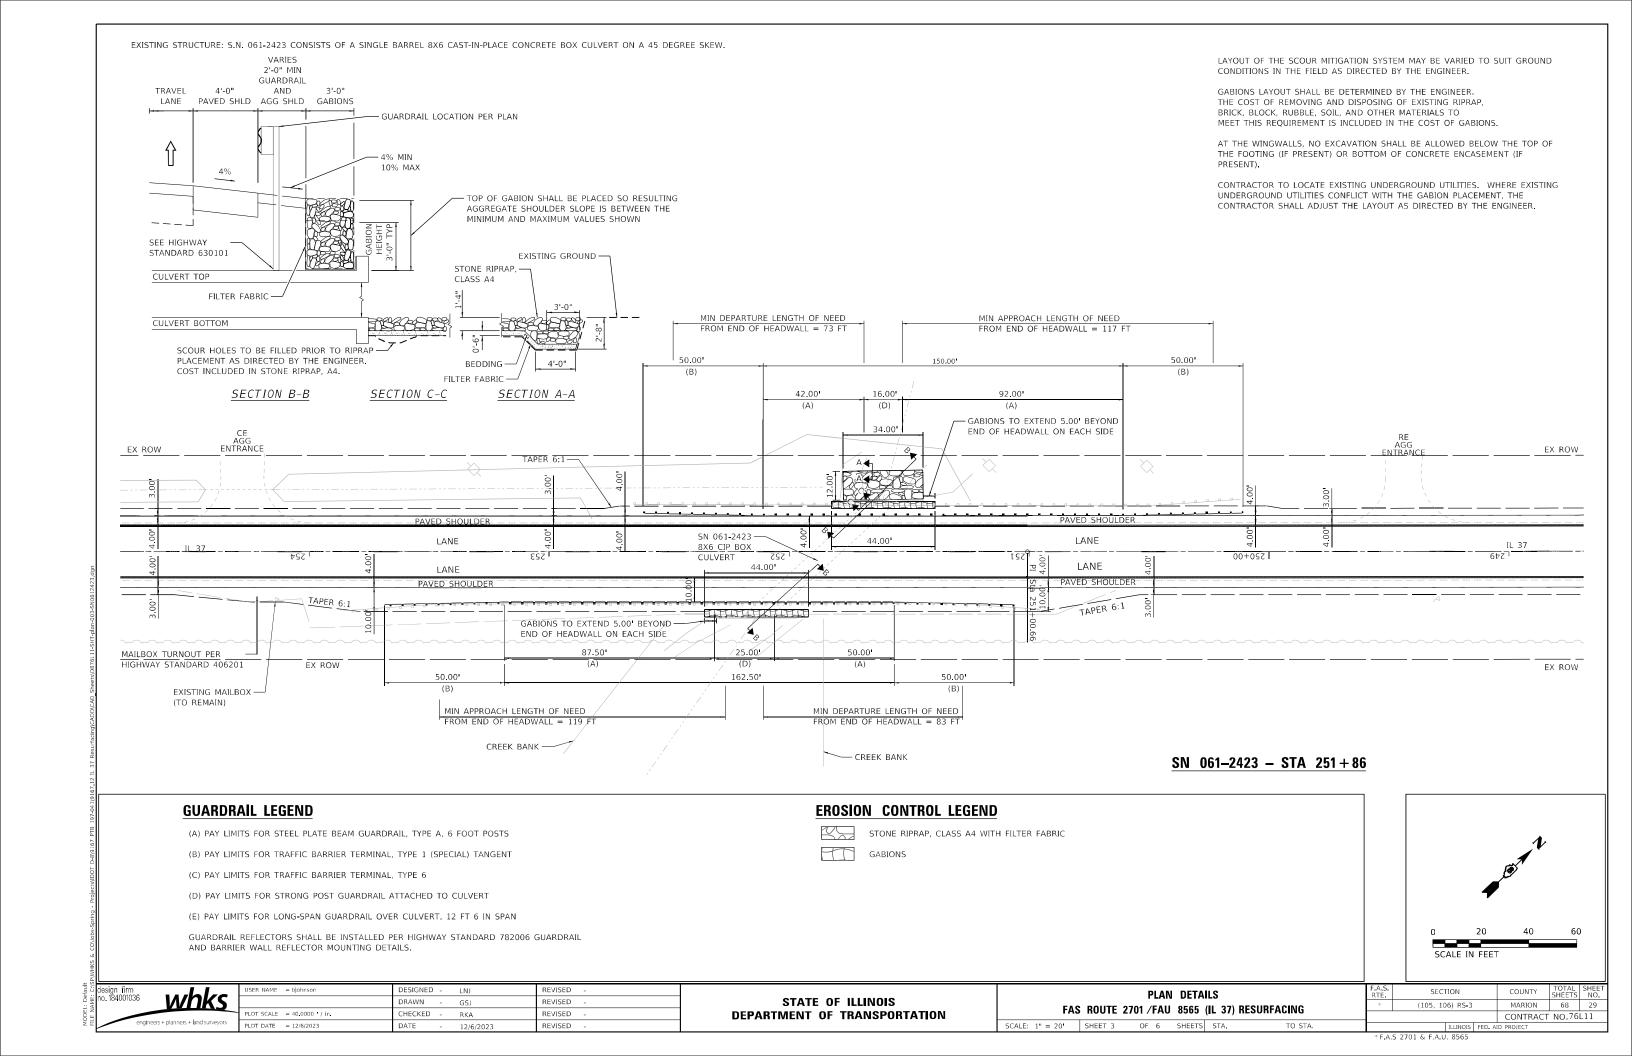

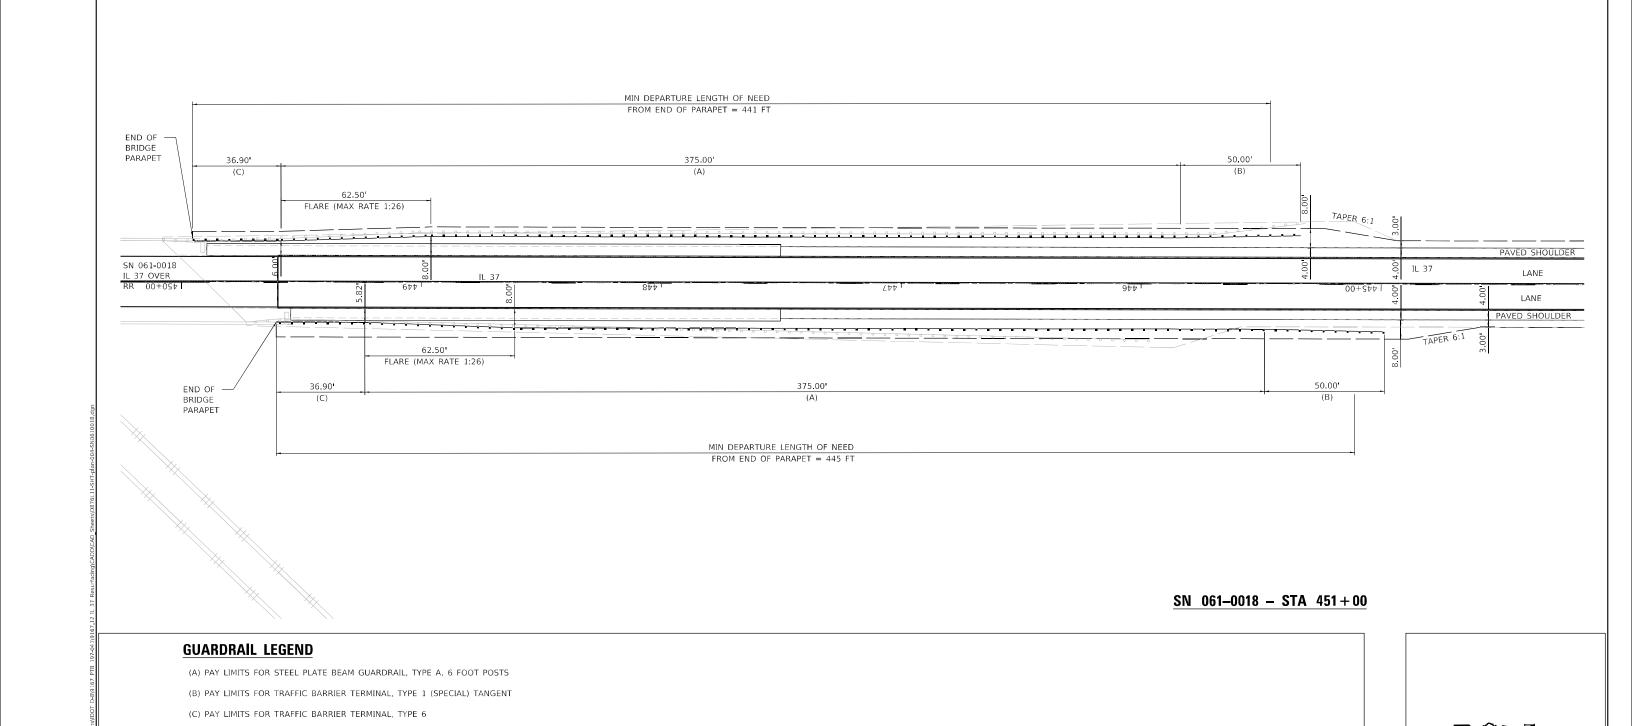

STATE OF ILLINOIS

**DEPARTMENT OF TRANSPORTATION** 

SECTION

(105, 106) RS-3

\*F.A.S 2701 & F.A.U. 8565

MARION

CONTRACT NO.76L11

68 30

PLAN DETAILS

FAS ROUTE 2701 /FAU 8565 (IL 37) RESURFACING

SCALE: 1" = 20' SHEET 4 OF 6 SHEETS STA.

MODEL: Default FILE NAME: C:SP\WHKS & CO\Le

whks

(D) PAY LIMITS FOR STRONG POST GUARDRAIL ATTACHED TO CULVERT

(E) PAY LIMITS FOR LONG-SPAN GUARDRAIL OVER CULVERT. 12 FT 6 IN SPAN

AND BARRIER WALL REFLECTOR MOUNTING DETAILS.

PLOT DATE = 12/6/2023

GUARDRAIL REFLECTORS SHALL BE INSTALLED PER HIGHWAY STANDARD 782006 GUARDRAIL

DESIGNED -

CHECKED

DRAWN


LNJ

RKA

REVISED

REVISED


REVISED

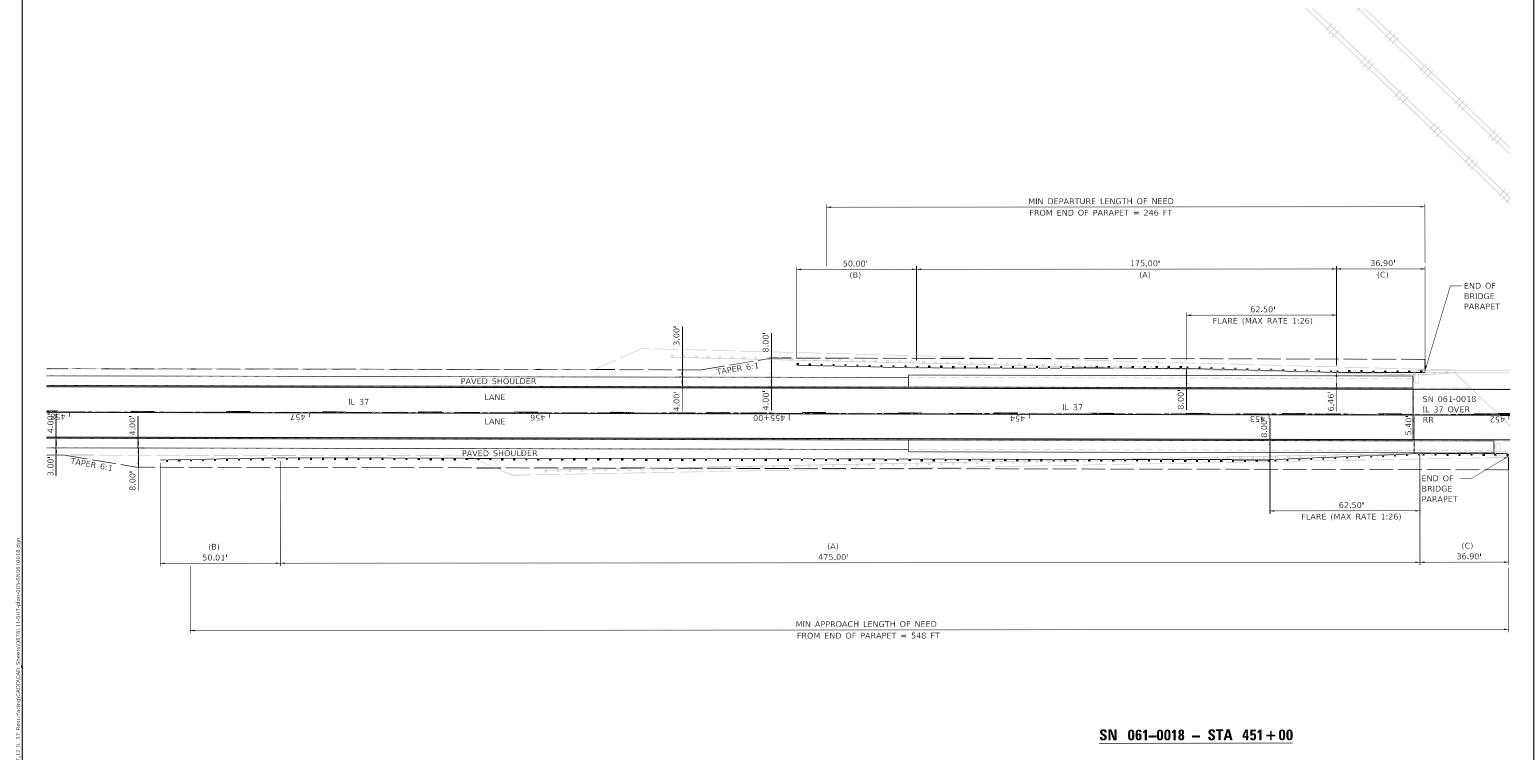

#### **GUARDRAIL LEGEND**

- (A) PAY LIMITS FOR STEEL PLATE BEAM GUARDRAIL, TYPE A, 6 FOOT POSTS
- (B) PAY LIMITS FOR TRAFFIC BARRIER TERMINAL, TYPE 1 (SPECIAL) TANGENT
- (C) PAY LIMITS FOR TRAFFIC BARRIER TERMINAL, TYPE 6
- (D) PAY LIMITS FOR STRONG POST GUARDRAIL ATTACHED TO CULVERT
- (E) PAY LIMITS FOR LONG-SPAN GUARDRAIL OVER CULVERT. 12 FT 6 IN SPAN

GUARDRAIL REFLECTORS SHALL BE INSTALLED PER HIGHWAY STANDARD 782006 GUARDRAIL AND BARRIER WALL REFLECTOR MOUNTING DETAILS.

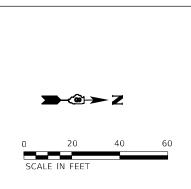

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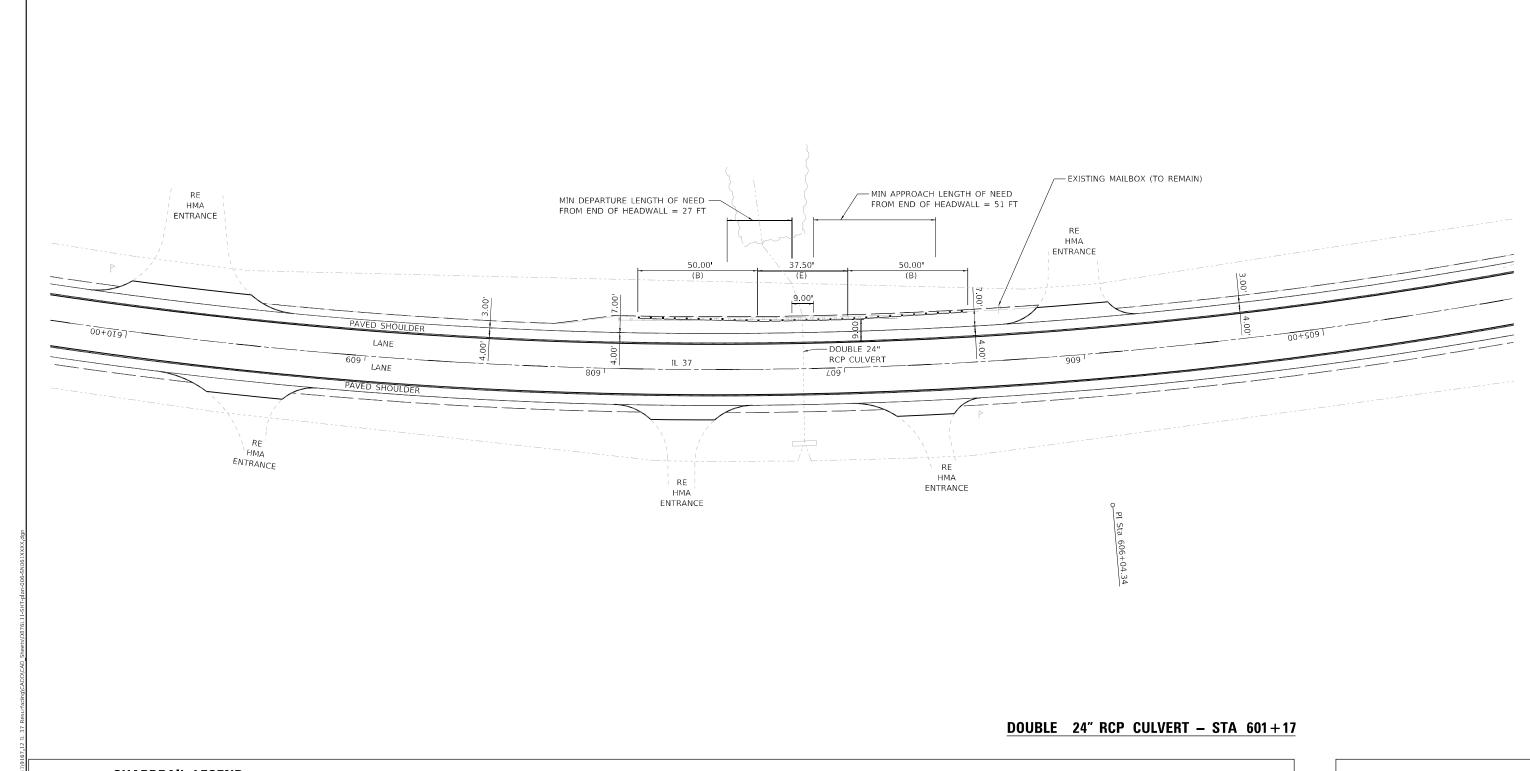
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PLOT DATE = 12/6/2023	DATE - 12/6/2023	REVISED -

STATE OF ILLINOIS **DEPARTMENT OF TRANSPORTATION** 

PLAN DETAILS FAS ROUTE 2701 /FAU 8565 (IL 37) RESURFACING SCALE: 1" = 20' SHEET 5 OF 6 SHEETS STA.

SECTION (105, 106) RS-3 MARION 68 31 CONTRACT NO.76L11


\*F.A.S 2701 & F.A.U. 8565



#### **GUARDRAIL LEGEND**

- (A) PAY LIMITS FOR STEEL PLATE BEAM GUARDRAIL, TYPE A, 6 FOOT POSTS
- (B) PAY LIMITS FOR TRAFFIC BARRIER TERMINAL, TYPE 1 (SPECIAL) TANGENT
- (C) PAY LIMITS FOR TRAFFIC BARRIER TERMINAL, TYPE 6
- (D) PAY LIMITS FOR STRONG POST GUARDRAIL ATTACHED TO CULVERT
- (E) PAY LIMITS FOR LONG-SPAN GUARDRAIL OVER CULVERT. 12 FT 6 IN SPAN

GUARDRAIL REFLECTORS SHALL BE INSTALLED PER HIGHWAY STANDARD 782006 GUARDRAIL AND BARRIER WALL REFLECTOR MOUNTING DETAILS.

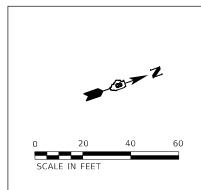


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USER NAME = bjohnson	DESIGNED	-	LNJ	REVISED	-
	DRAWN	-	GSJ	REVISED	-
PLOT SCALE = 40.0000 / in.	CHECKED	-	RKA	REVISED	-
PLOT DATE = 12/6/2023	DATE	-	12/6/2023	REVISED	-

STATE OF ILLINOIS **DEPARTMENT OF TRANSPORTATION** 


PLAN DETAILS FAS ROUTE 2701 /FAU 8565 (IL 37) RESURFACING SCALE: 1" = 20' SHEET 6 OF 6 SHEETS STA.

SECTION (105, 106) RS-3 CONTRACT NO.76L11

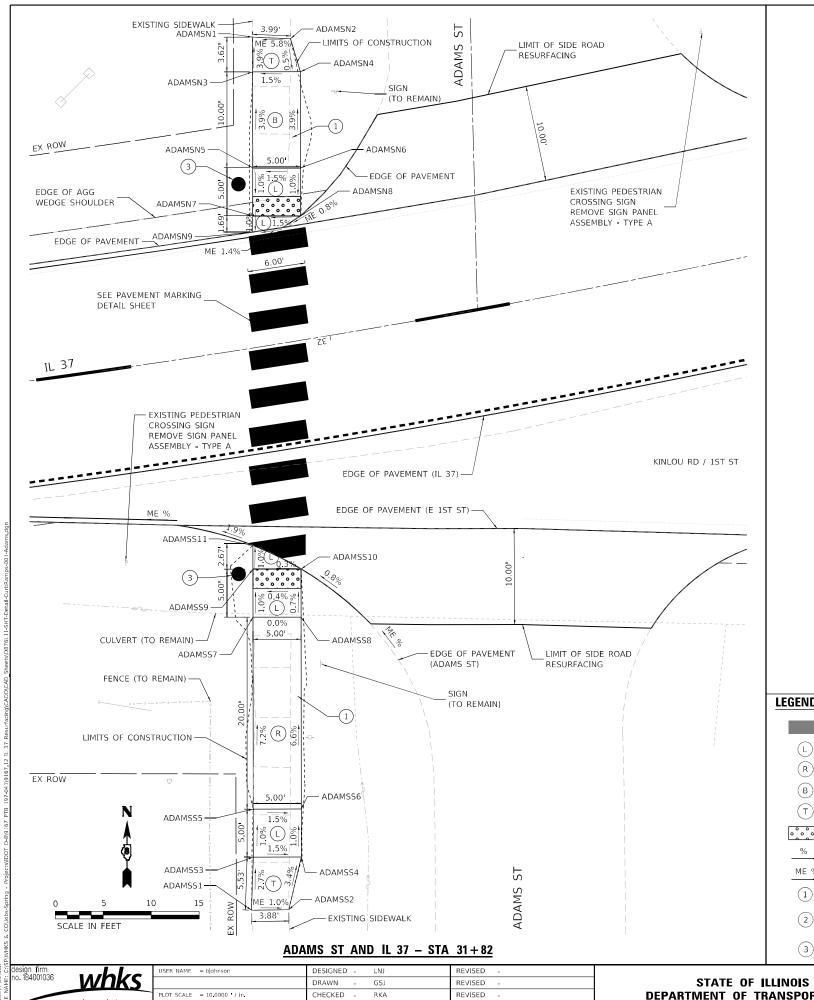

NORTH CURB RAMP									
POINT	STATION	OFFSET	ELEVATION						
ADAMSN1	32+02.94	31.99	603.67						
ADAMSN2	31+98.91	31.18	603.90						
ADAMSN3	32+03.53	28.41	603.81						
ADAMSN4	31+98.46	27.60	603.97						
ADAMSN5	32+05.15	18.54	604.19						
ADAMSN6	32+00.13	17.73	604.27						
ADAMSN7	32+05.96	13.60	604.14						
ADAMSN8	32+00.96	12.80	604.22						
ADAMSN9	32+06.23	11.93	604.12						
ADAMSN10	32+02.81	11.89	604.17						


	SOUTH CURB RAMP									
POINT	STATION	OFFSET	ELEVATION							
ADAMSS1	32+16.97	-57.86	607.56							
ADAMSS2	32+13.33	<b>-</b> 58.40	607.53							
ADAMSS3	32+16.01	<b>-</b> 52.42	607.41							
ADAMSS4	32+11.31	-53.18	607.34							
ADAMSS5	32+15.30	-47.48	607.36							
ADAMSS6	32+10.58	-48.24	607.29							
ADAMSS7	32+12.40	-27.71	605.93							
ADAMSS8	32+07.59	<b>-</b> 28.48	605.98							
ADAMSS9	32+11.65	-22.76	605.88							
ADAMSS10	32+06.82	<b>-</b> 23.54	605.90							
ADAMSS11	32+11.28	-20.31	605.86							

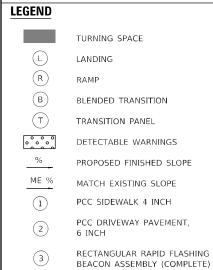

**DEPARTMENT OF TRANSPORTATION** 

SECTION **CURB RAMP DETAILS** (105, 106) RS-3 FAS ROUTE 2701 /FAU 8565 (IL 37) RESURFACING CONTRACT NO.76L11 SCALE: 1" = 5' SHEET 1 OF 3 SHEETS STA.

MARION 68 33

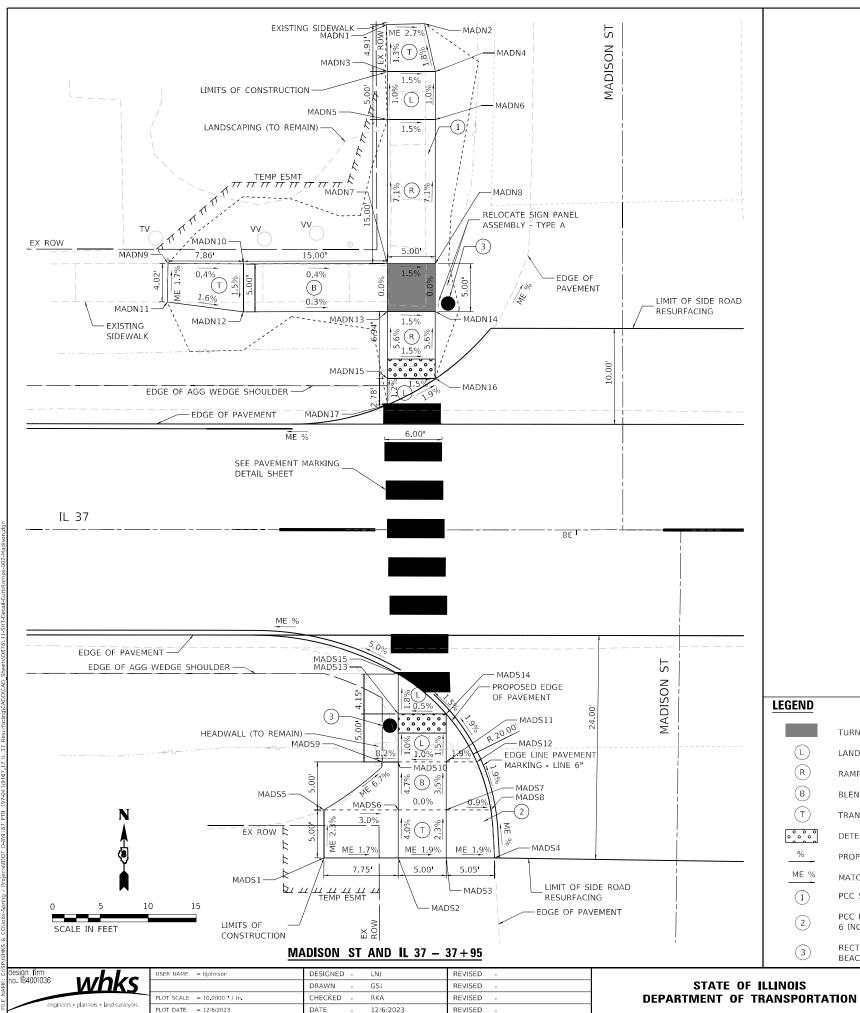

DATE


12/6/2023


NORTH CURB RAMP								
POINT	STATION	OFFSET	ELEVATION					
MADN1	38+19.83	52.64	593.68					
MADN2	38+15.89	52.74	593.58					
MADN3	38+19.74	47.73	593.75					
MADN4	38+14.74	47.75	593.67					
MADN5	38+19.74	42.73	593.80					
MADN6	38+14.74	42.75	593.72 594.87					
MADN7	38+19.73	27.73						
MADN8	38+14.73	27.75	594.79					
MADN9	38+42.59	27.71	594.96					
MADN10	38+34.73	27.69	594.93					
MADN11	38+42.64	23.69	595.03					
MADN12	38+34.73	22.69	594.86					
MADN13	38+19.73	22.73	594.87					
MADN14	38+14.73	22.75	594.79					
MADN15	38+19.72	15.78	595.25					
MADN16	38+14.73	15.79	595.18					
MADN17	38+19.73	13.00	595.29					


SOUTH CURB RAMP									
POINT	STATION	OFFSET	ELEVATION						
MADS1	38+26.27	-34.20	596.26						
MADS2	38+18.52	-34.19	596.12						
MADS3	38+13.52	-34.19	596.03						
MADS4	38+08.48	-34.18	595.93						
MADS5	38+26.28	-29.20	596.16						
MADS6	38+18.53	-29.19	595.92						
MADS7	38+13.53	-29.19	595.91 595.87 595.55						
MADS8	38+08.87	<b>-</b> 29.18							
MADS9	38+20.21	-24.19							
MADS10	38+18.53	-24.19	595.69						
MADS11	38+13.53	-24.19	595.74						
MADS12	38+10.35	-24.18	595.80						
MADS13	38+18.54	-19.19	595.64						
MADS14	38+13.54	-19.19	595.66						
MADS15	38+18.54	-15.04	595.57						


LEGEND				
	TURNING SPACE			
L	LANDING			
R	RAMP			
В	BLENDED TRANSITION			
T	TRANSITION PANEL			
0000	DETECTABLE WARNINGS			
<u></u> %	PROPOSED FINISHED SLOPE			
ME %	MATCH EXISTING SLOPE			
1	PCC SIDEWALK 4 INCH			
2	PCC DRIVEWAY PAVEMENT, 6 INCH			
3	RECTANGULAR RAPID FLASHING BEACON ASSEMBLY (COMPLETE)			

3L,	(COMPLETE)												
CURB RAMP DETAILS						F.A.S. RTE	SECTION		COUNTY	TOTAL SHEETS	SHEET NO.		
	FAS ROUTE 2701 /FAU 8565 (JL 37) RESURFACING					*	(105, 106) RS-3		MARION	68	34		
TAS HOUTE 2701/TAG 0303 (IE 37) HESONI AGING								CONTRACT	NO.76	L11			
	SCALE: 1" = 5'	SHEET	2 OF	3	SHEETS	STA.	TO STA.	ILLINOIS FED. AID PROJECT					

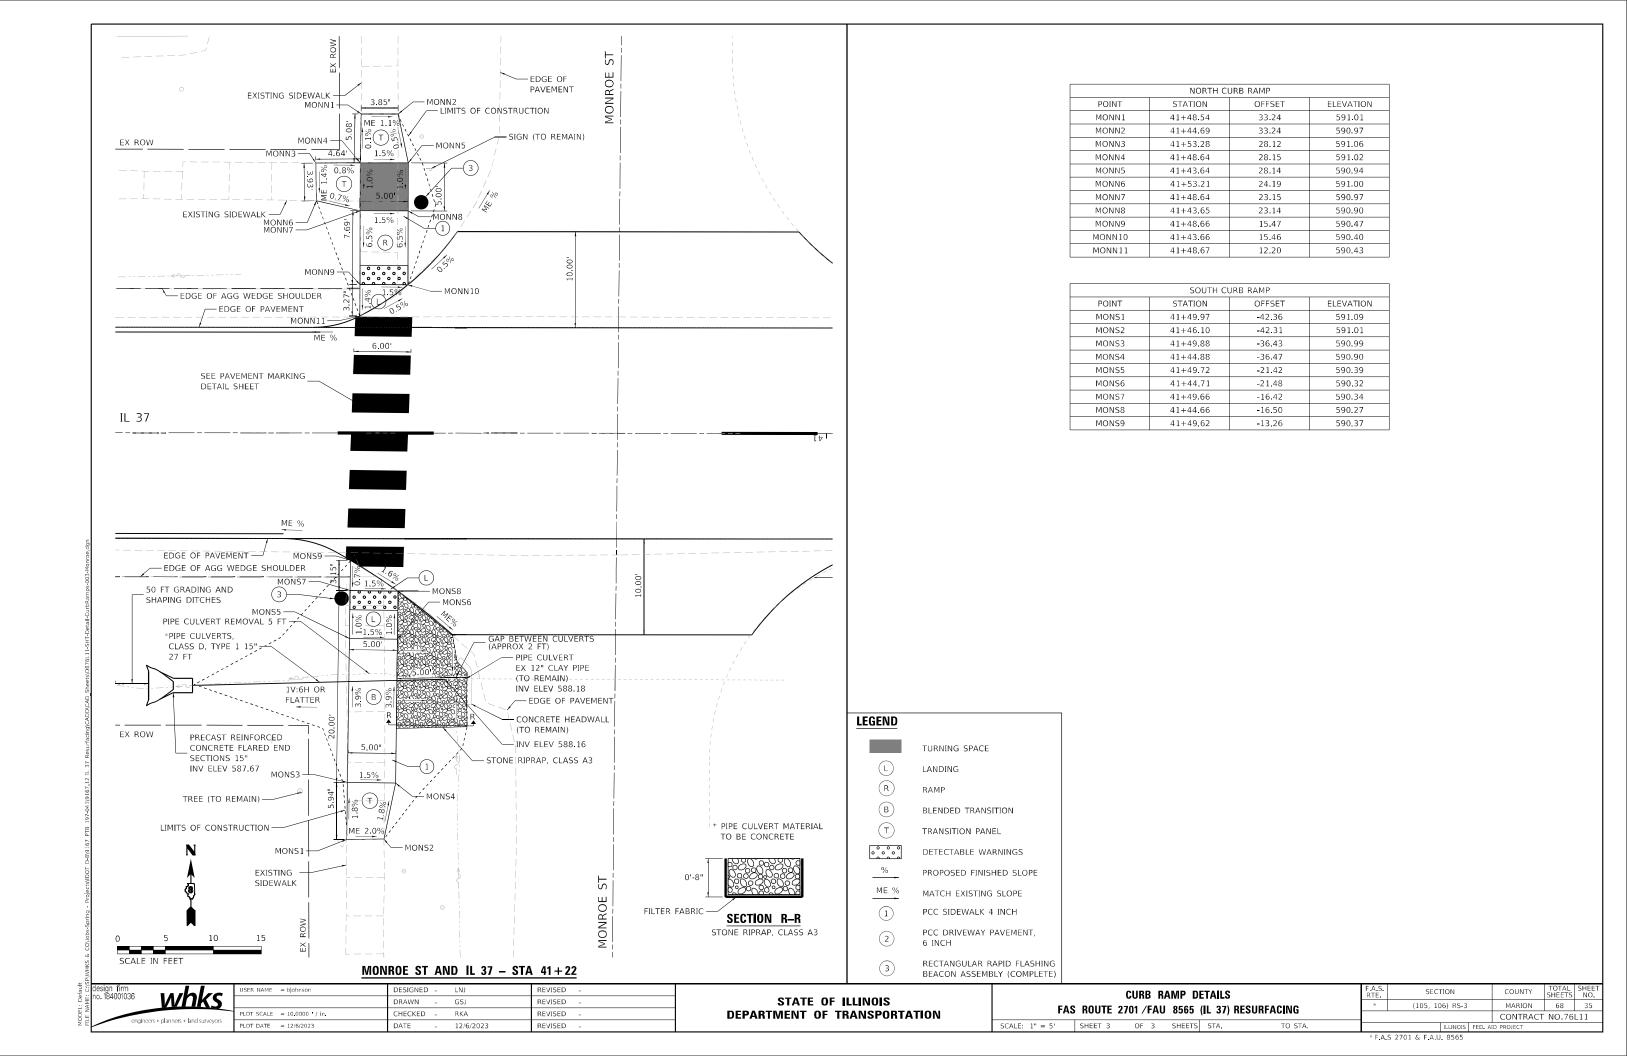

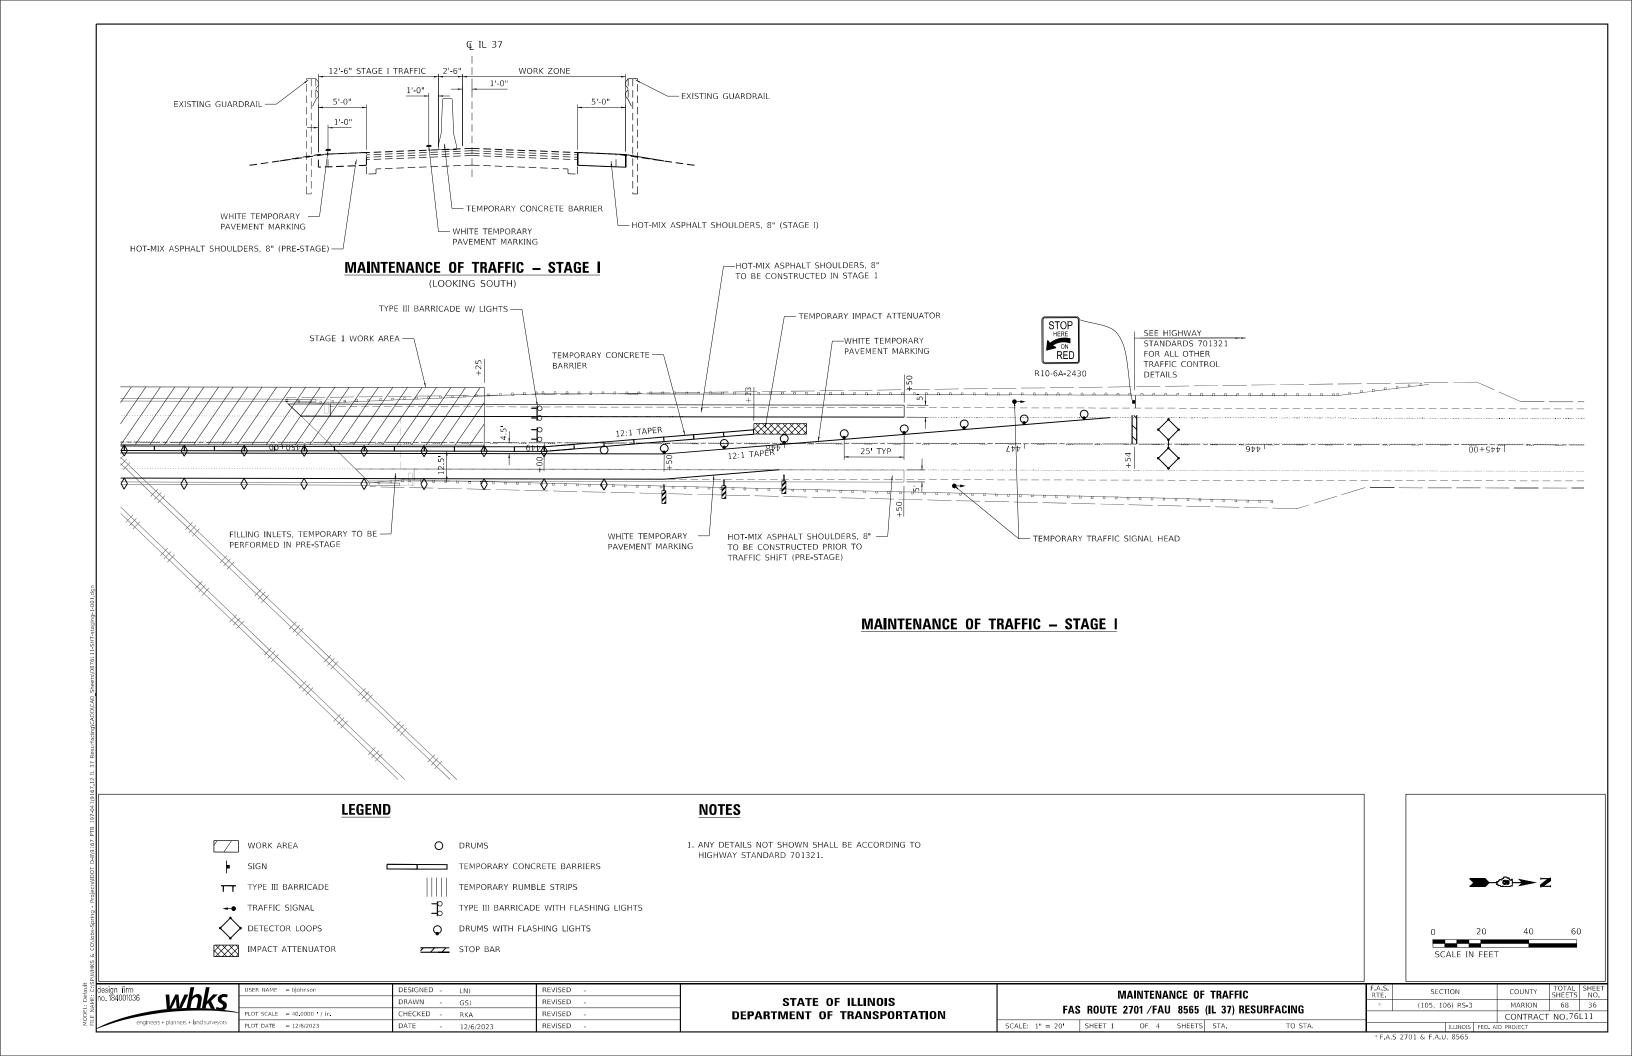


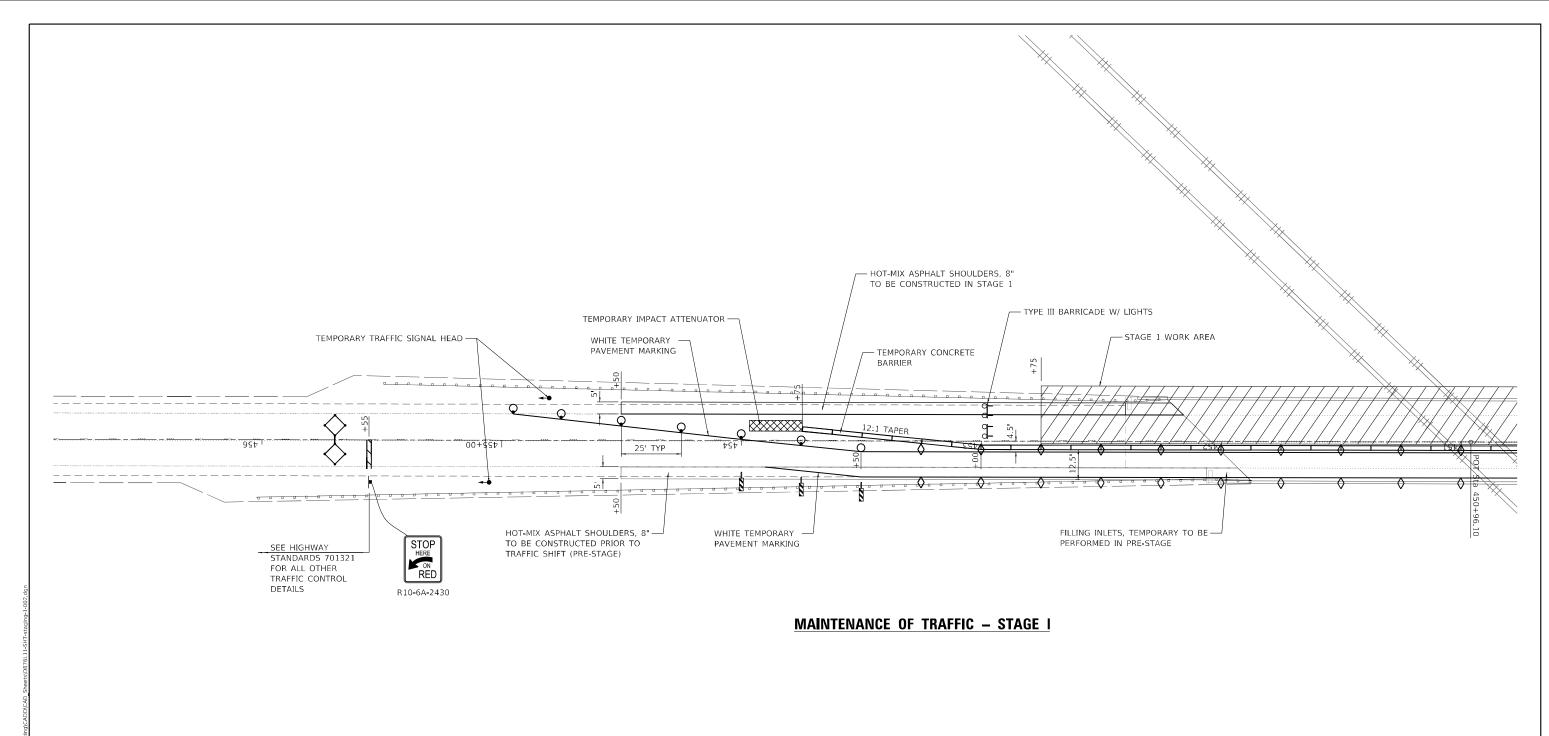


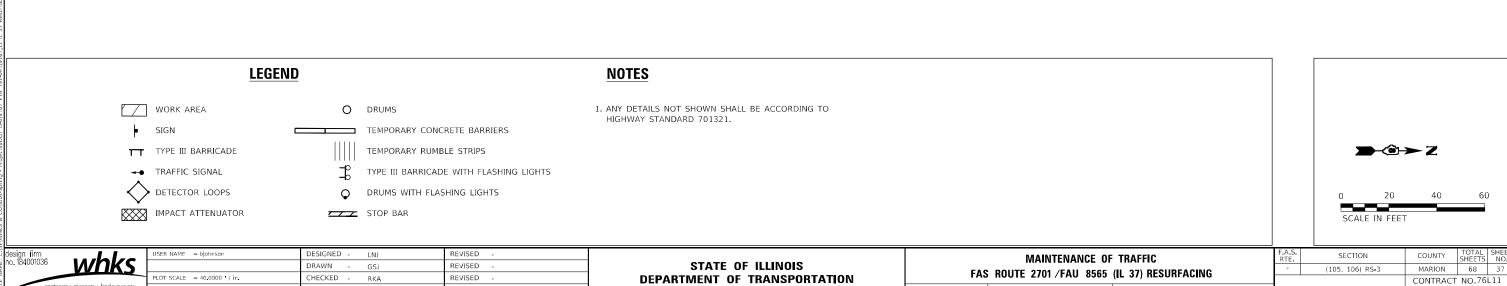

SCALE: 1" = 20' SHEET 2 OF 4 SHEETS STA.

\*F.A.S 2701 & F.A.U. 8565

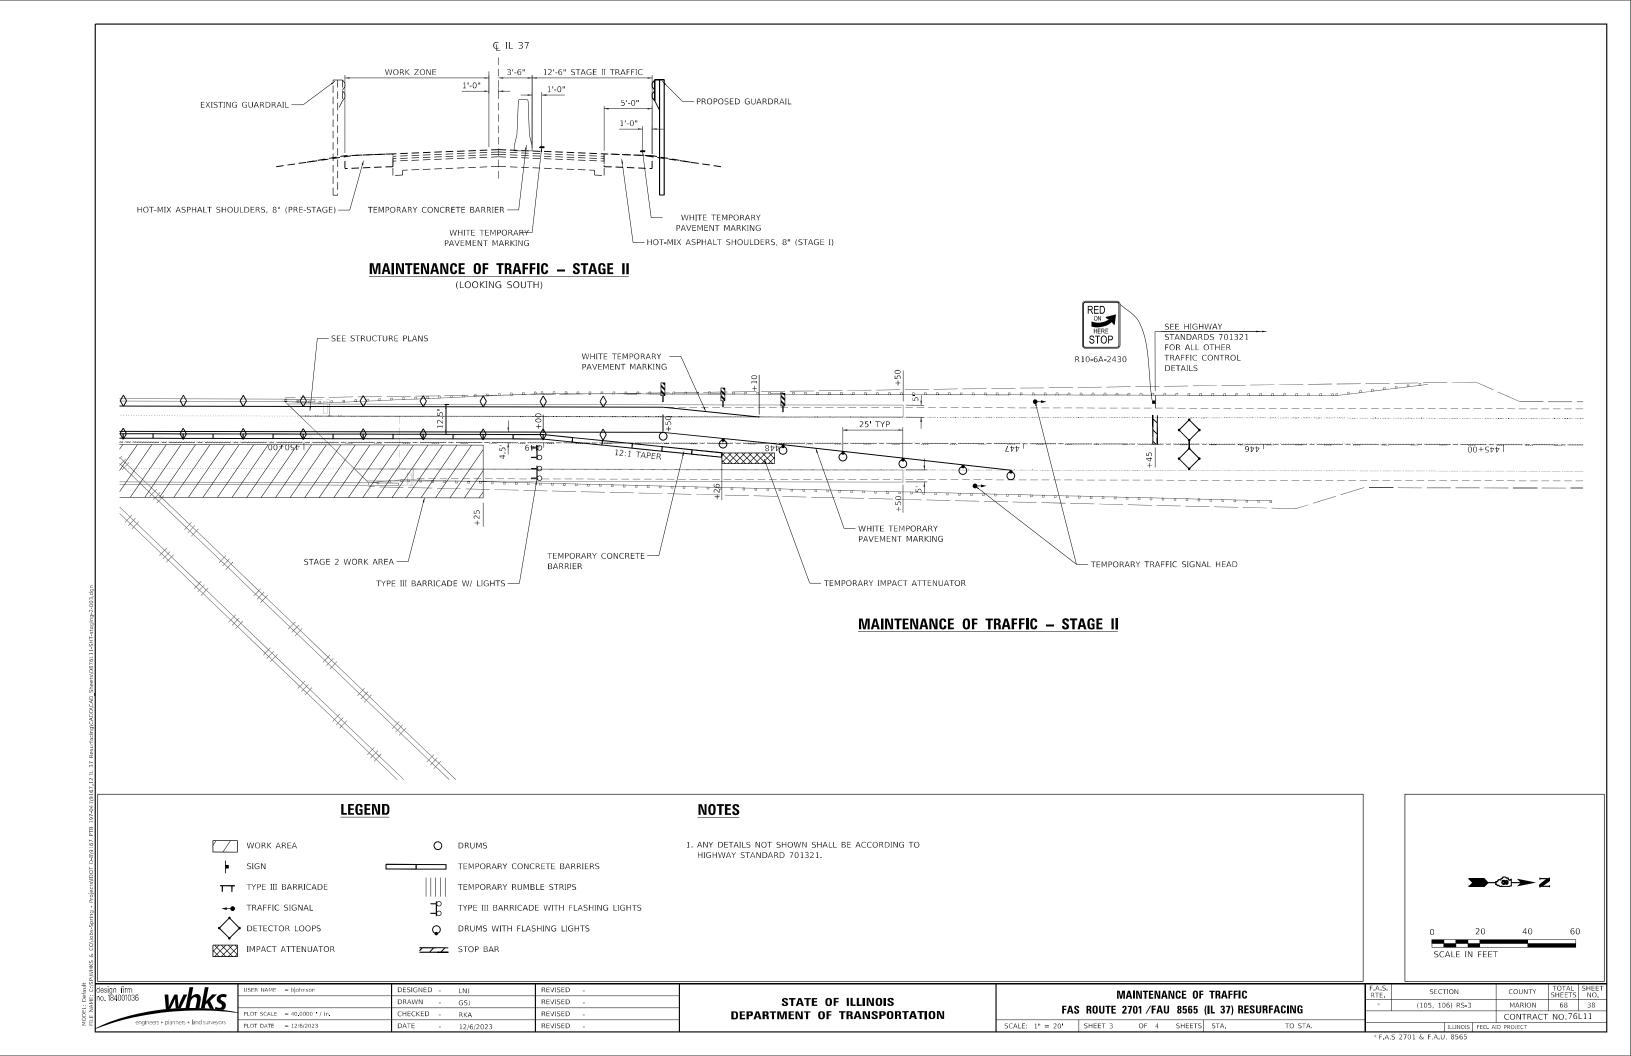

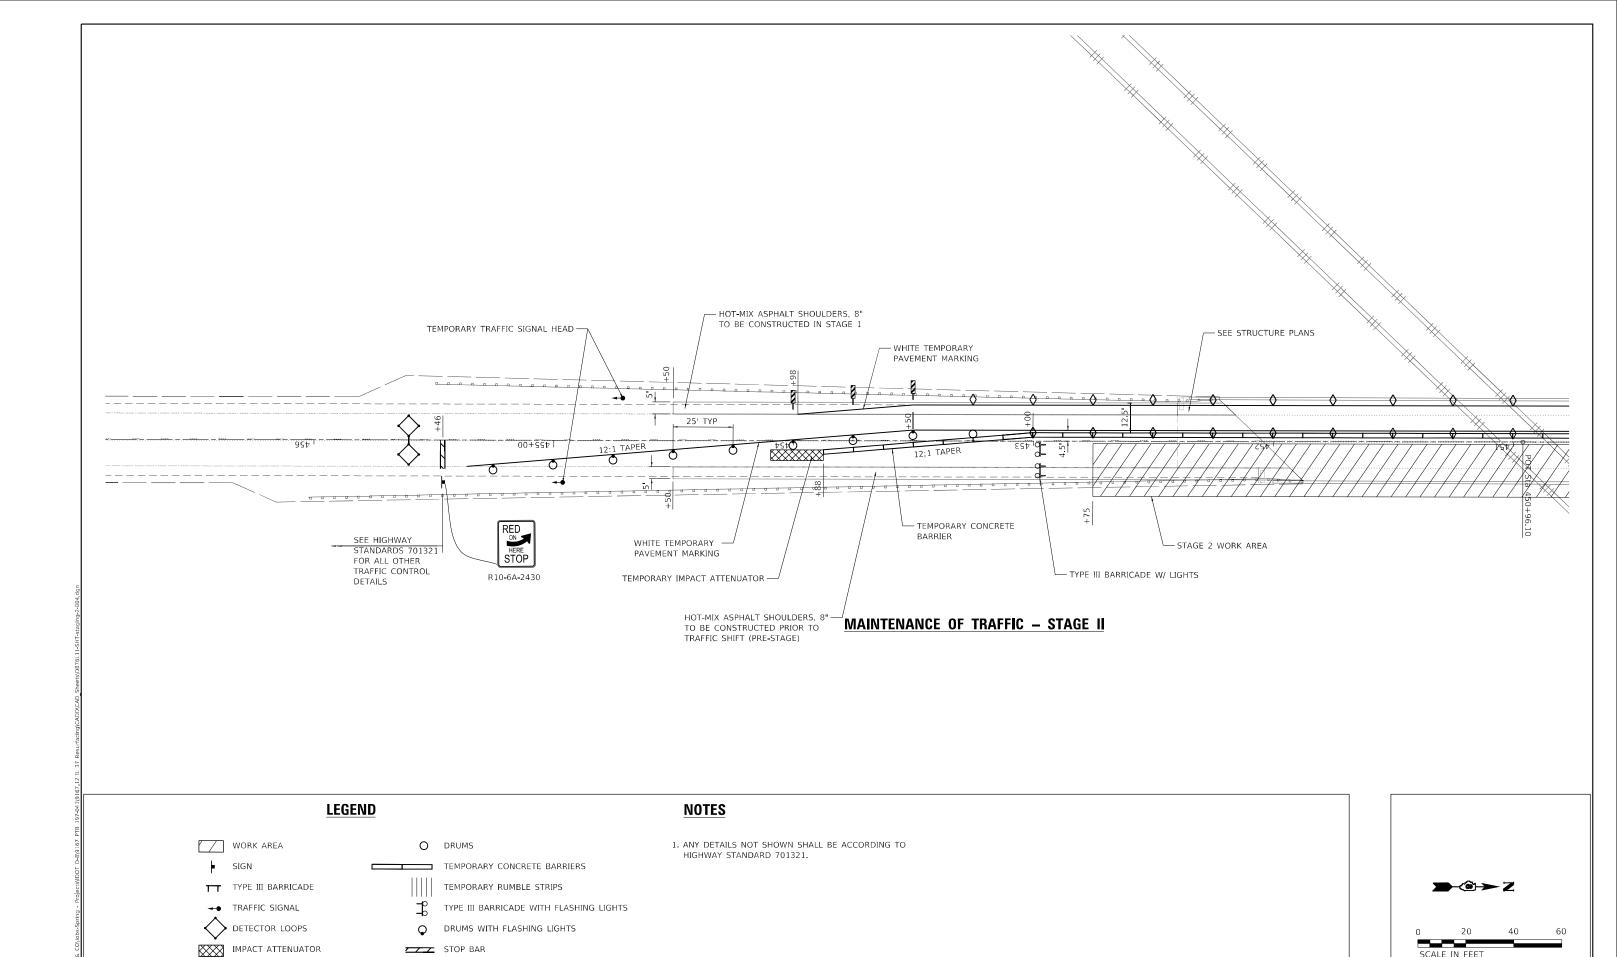



 USER NAME
 = bjohnson
 DESIGNED
 LNJ
 REVISED

 DRAWN
 GSJ
 REVISED

 PLOT SCALE
 = 40,0000 / in
 CHECKED
 RKA
 REVISED

 PLOT DATE
 = 12/6/2023
 DATE
 12/6/2023
 REVISED

STATE OF ILLINOIS
DEPARTMENT OF TRANSPORTATION

 MAINTENANCE OF TRAFFIC

 FAS ROUTE 2701 /FAU 8565 (IL 37) RESURFACING

 SCALE: 1" = 20'
 SHEET 4
 OF 4
 SHEETS STA.
 TO STA.


F.A.S. SECTION COUNTY TOTAL SHEETS NO.

\* (105, 106) RS-3 MARION 68 39

CONTRACT NO.76L11

| ILLINOIS | FED. AID PROJECT


\* F.A.S 2701 & F.A.U. 8565

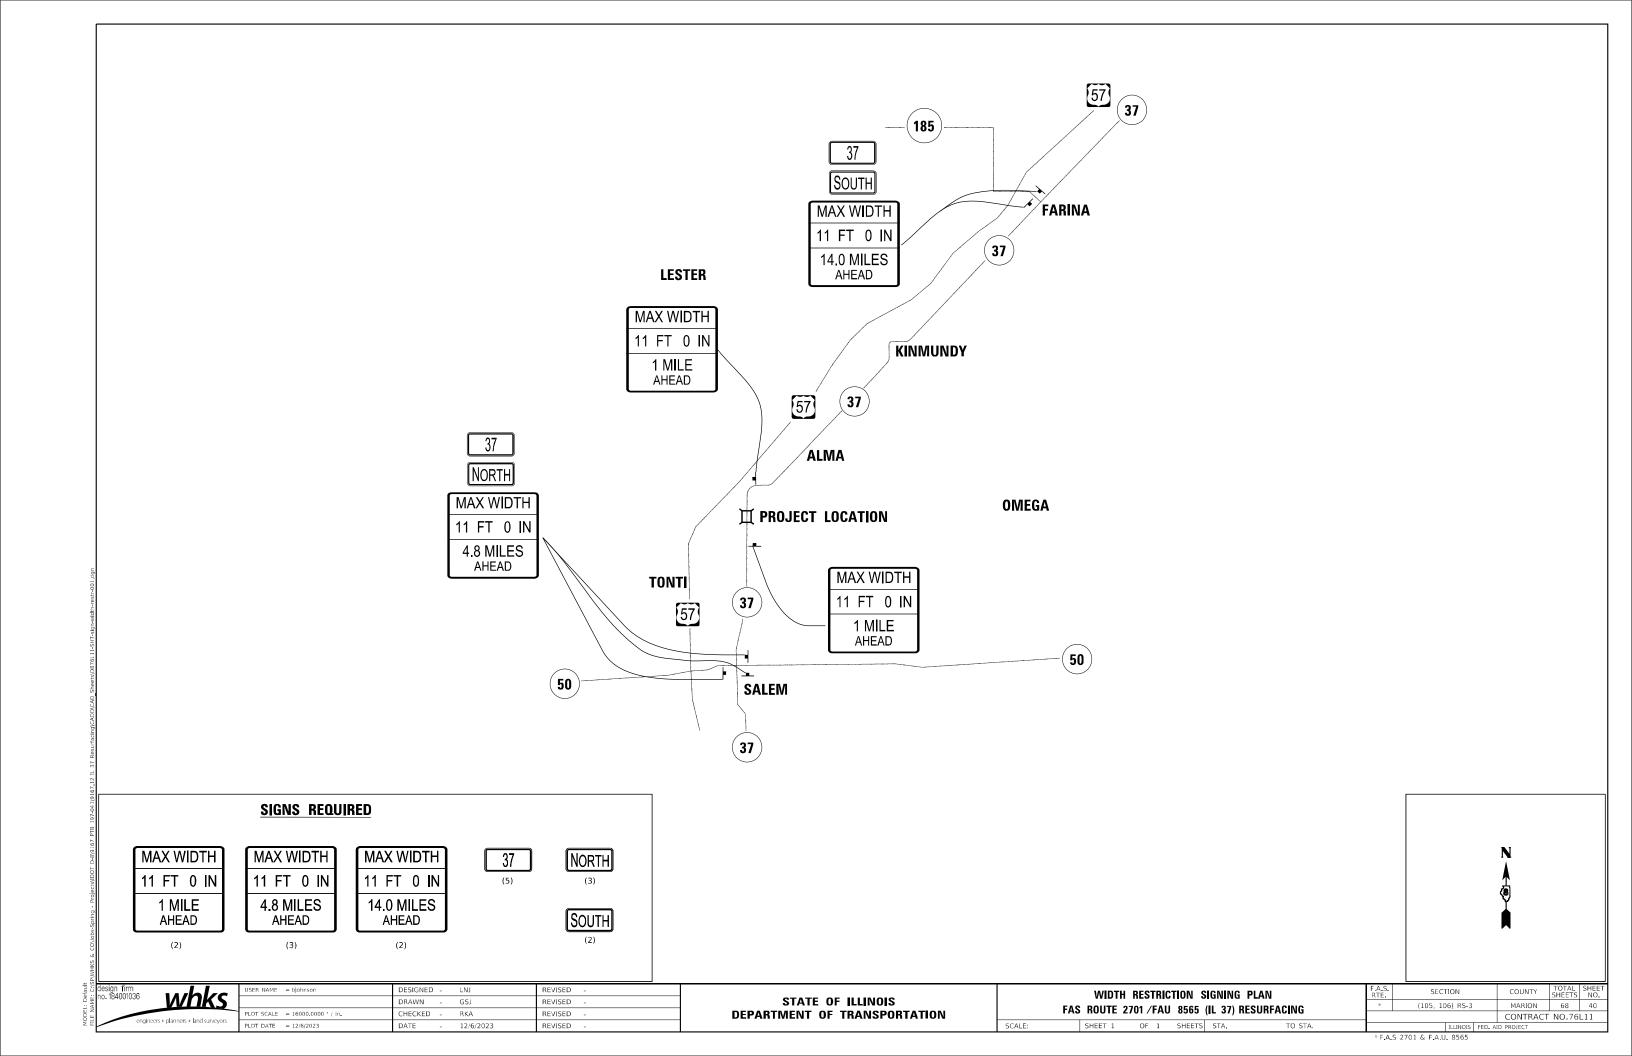


Existing Structure: 061-0018 was built in 1930 under SBI Route 142, Sec 106V-B&C. This bridge consisted of 3 simple spans. In 1983 the superstructure was replaced with 3 span continuous wide flange & the caps were reconstructed under FAS Route 2789, Sec 106VBR.

The deck ends, mudwalls and approach ends shall be removed and replaced solid. Before replacing solid, the beam ends shall be cleaned, painted and existing diaphragms at abutments removed. The deck shall be partial depth patched. The drains in spans 1 & 3 shall be replaced with full depth patches.

Stage Construction shall be used.

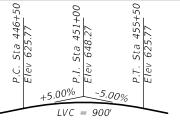

EX. PROFILE GRADE

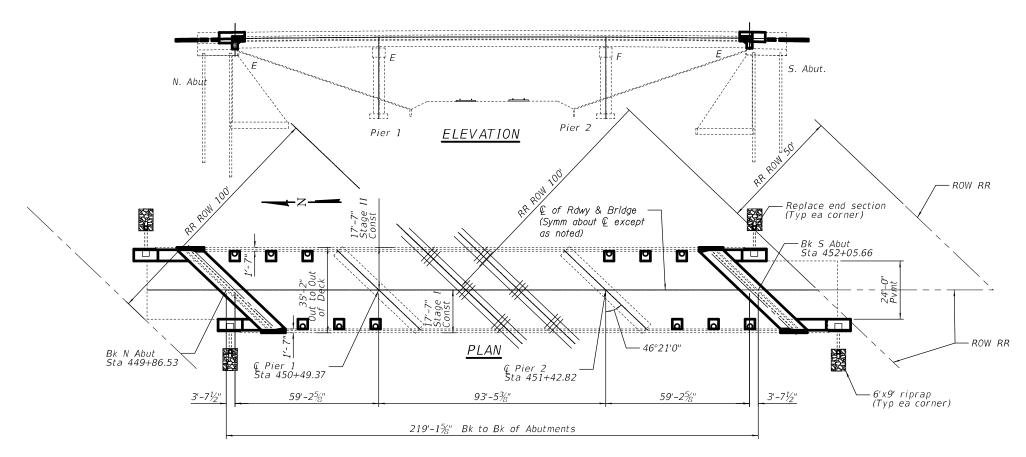

-SN 061-0018

### INSTALL FLOOR DRAINS

Concrete to be removed & replaced with 6" (12 Req'd) circular drains and full depth patch (See sheet 12 of 17 for details.



EXPIRES 11-30-2024

# Tont (50) (37)

### LOCATION SKETCH

### TOTAL BILL OF MATERIAL

ITEM	UNIT	TOTAL
Stone Dumped Riprap, Class A4	Sq. Yd.	24
Concrete Removal	Cu. Yd.	30.7
Floor Drains	Each	12
Concrete Superstructure	Cu. Yd.	54.7
Reinforcement Bars, Epoxy Coated	Pound	8450
Bar Splicers	Each	60
Pipe Drain 12"	Foot	318
Bridge Approach Shoulder Removal	Sq. Yd.	39
Structural Steel Removal	Pound	3340
Containment & Disposal of Lead Paint Cleaning Residues No. 1	L Sum	1
Cleaning and Painting Steel Bridge, No. 1	L. Sum	1
Deck Slab Repair (Full Depth, Type I)	Sq. Yd.	1.3
Remove Inlet Box	Each	4
Deck Slab Repair (Partial)	Sq. Yd.	11
Bridge Deck Concrete Sealer	Sq. Ft.	9266
Steel Flared End Sections 12"	Each	4
Type G Inlet Box, Standard 610001	Each	4
Pipe Drain Removal	Foot	316
Concrete Shoulder Curb	Foot	36
Concrete Thrust Blocks	Each	4

### GENERAL NOTES

Reinforcement bars designated (E) shall be epoxy coated.

Prior to pouring the new concrete deck, all heavy or loose rust, loose mill scale, and other loose or potentially detrimental foreign material shall be removed from the surfaces in contact with concrete. Tightly adhered paint may remain unless otherwise noted. Removal shall be accomplished by methods that will not damage the steel and the cost will be included in the pay item covering removal of the existing concrete.

As directed by the Engineer, existing construction accessories welded to the top flange of beams and girders shall be removed. The weld areas shall be ground flush and inspected for cracks using magnetic particle testing (MT) or dye penetrant testing (PT) by qualified personnel approved by the Engineer.

Any cracks that cannot be removed by grinding  $\frac{1}{4}$  inch deep shall be identified and reported to the Bureau of Bridges and Structures for further disposition. The cost of removing welded accessories, grinding and inspecting weld areas and grinding cracks will be paid for according to Article 109.04 of the Standard Specifications.

Plan dimensions and details relative to existing plans are subject to nominal construction variations. The Contractor shall field verify existing dimensions and details affecting new construction and make necessary approved adjustments prior to construction or ordering of materials. Such variations shall not be cause for additional compensation for a change in scope of the work, however, the Contractor will be paid for the quantity actually furnished at the unit price bid for the work.

The existing structural steel coating contains lead. The Contractor shall take appropriate precautions to deal with the presence of lead on this project.

Existing reinforcement extending into removal area shall be cleaned, straightened and incorporated into the new construction. Any reinforcement bars that are damaged during concrete removal operations shall be repaired or replaced using an approved bar splicer or anchorage system. Cost included with "Concrete Removal".

Bridge deck concrete sealer shall be placed on top/inside faces of parapets full length, wingwalls & on the entire deck surface after patching. In addition, place sealer on top of new Bridge Approach Shoulder Pavement.

Cleaning and painting of the existing structural steel shall be as specified in the special provision for "Cleaning and Painting Existing Steel Structures". After removal of deck ends and end diaphragms, but prior to encasement of the steel beams, all beams, bearings and other structural steel within 7' (measured along the beam) of the deck joints shall be cleaned per Near White Blast

The designated areas cleaned per Near White Blast Cleaning shall be painted according to the requirements of paint system 1- OZ/E/U. The color of the final finish coat for all steel surfaces shall be Reddish Brown (Munsell No. 2.5 YR 3/4).

Area of deck repairs shown are estimated. The engineer shall show actual locations of deck repairs on as-built plans.

The concrete at joints shall have its final finish tined according to Article 420.09(e)(1) of the Standard Specifications. Cost included with "Concrete Superstructure".

SSPC QP1 and SSPC QP2 Certification is required for Contract.

A minimum of 2 air monitors will be required to monitor abrasive blasting operations at this site. See special provisions for "Containment and Disposal of Lead Paint Cleaning Residues.

### SHEET INDEX

Cleaning- SSPC-SP10.

- 1) General Plan and Elevation
- 2) Deck Section
- 3) Joint Removal
- 4) Joint Replacement (N. Abut.)
- 5) Joint Replacement (S. Abut.)
- 6) X-Sec (Appr Removal & Replacement) (N. Abut.)
- 7) X-Sec (Appr Removal & Replacement) (S. Abut.)
- 8) Existing Joint Details
- 9) Proposed Joint Details
- 10) Diaphragm at N. Abutment 11) Diaphragm at S. Abutment
- 12) Drain Details
- 13) Temporary Concrete Barrier

- 14) Bar Splicers
- 15) Bridge Appr Shld Rem Detail
- 16) Shoulder Inlet w/Curb (Sh 1 of 2)
- 17) Shoulder Inlet w/Curb (Sh 2 of 2)

### **DESIGN STRESSES** FIELD UNITS

f'c = 4.000 psify = 60,000 psi (Reinforcement)

								-			
OTATE OF HUMOIO	GENERAL PLAN & ELEVATION (IL 37 over IC RR)					FAS/FAU RTE.	SECTION	COUNTY	TOTAL SHEETS	SHEET NO.	
STATE OF ILLINOIS	SN 061-0018				2701/8565	(105, 106)RS-3	MARION	68	41		
DEPARTMENT OF TRANSPORTATION							CONTRACT NO. 76L11		5L11		
	SCALE:	SHEET 1	OF 17	SHEETS	STA.	TO STA.		ILLINOIS FED	AID PROJECT		

Anthony Y. Vinson DESIGNED -REVISED DRAWN Anthony Y. Vinson REVISED HECKED REVISED REVISED

### DECK SECTION AWAY FROM ABUTMENTS


(Looking South)


COUNTY TOTAL SHEET NO.


MARION 68 42


CONTRACT NO. 76L11

USER NAME = Anthony.Vinson	DESIGNED - AYV	REVISED -		DECK CROSS SECTION SN 061-0018					FAS/FAU RTF	SECTION		
	DRAWN - AYV	REVISED -	STATE OF ILLINOIS					2701/8565	(105, 106)RS-3	3		
PLOT SCALE = 2:6.0000 ':" / in.	CHECKED -	REVISED -	DEPARTMENT OF TRANSPORTATION			21/1	001-00	10				
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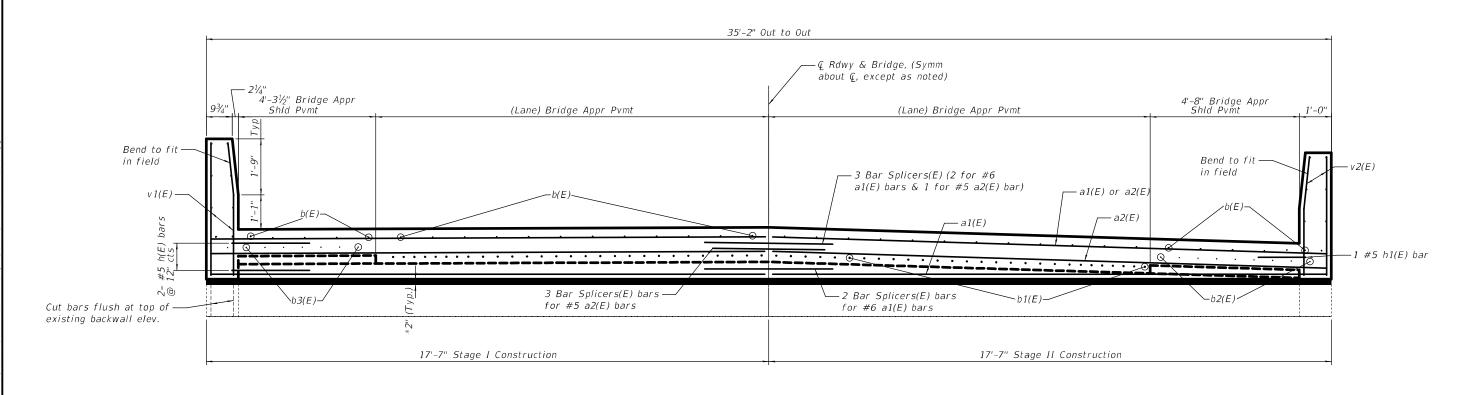


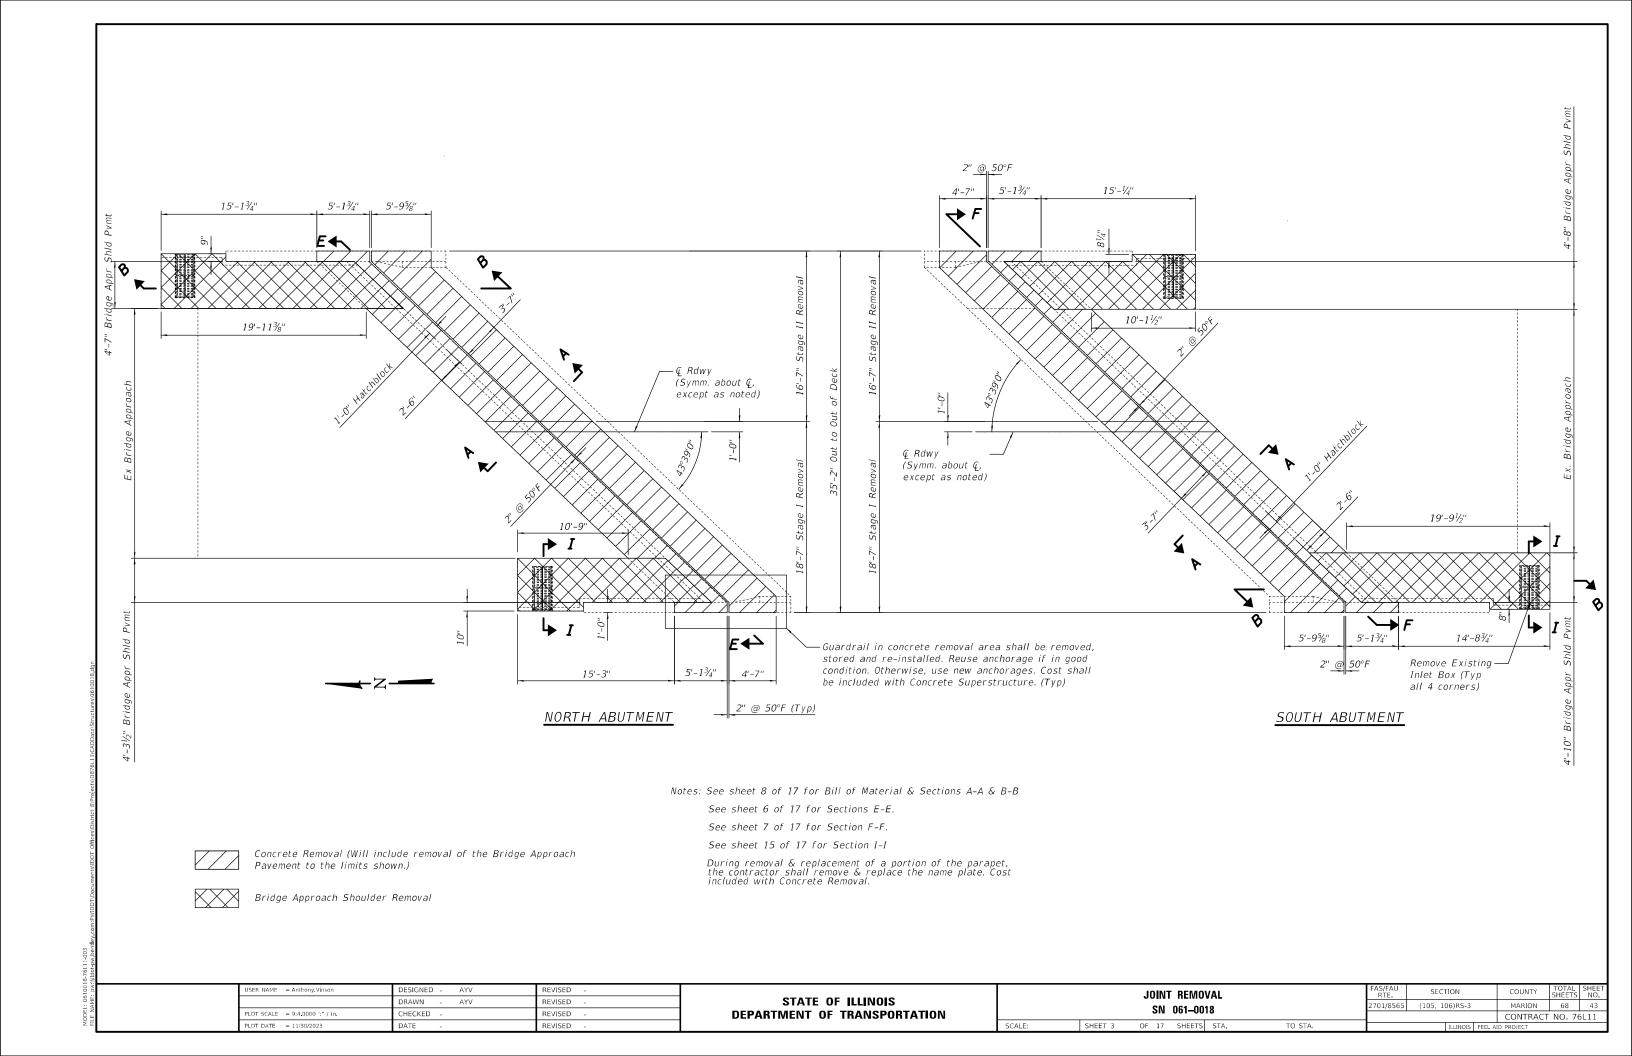

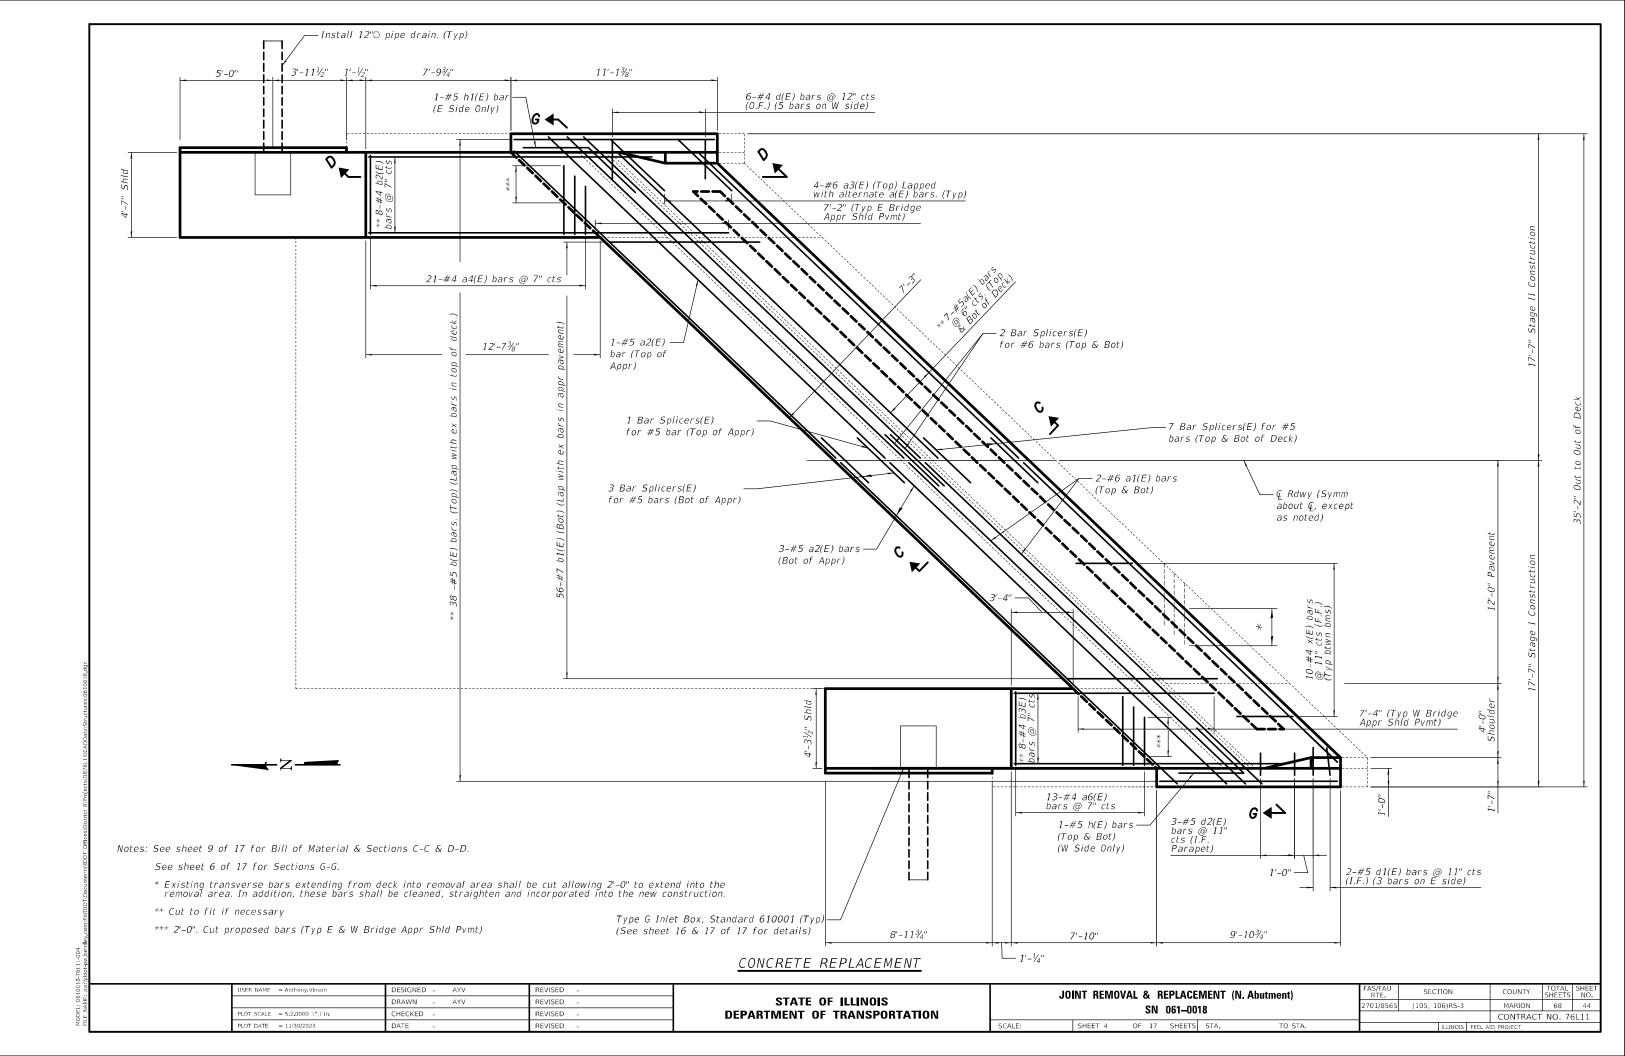

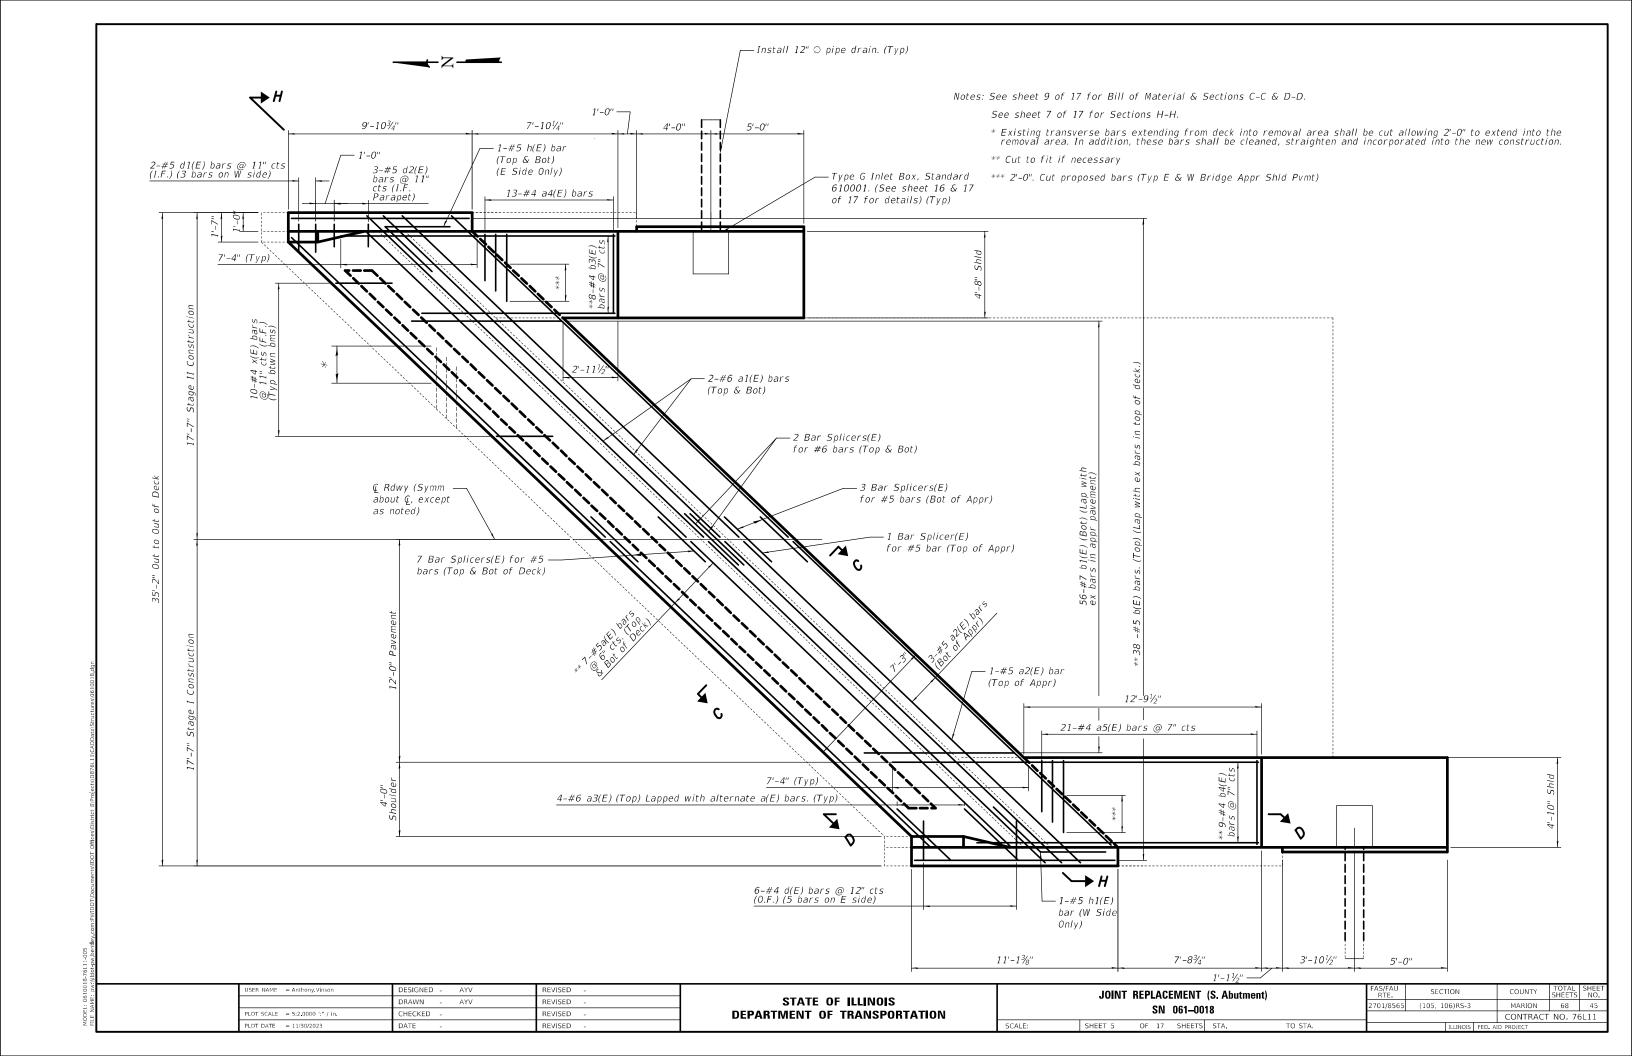
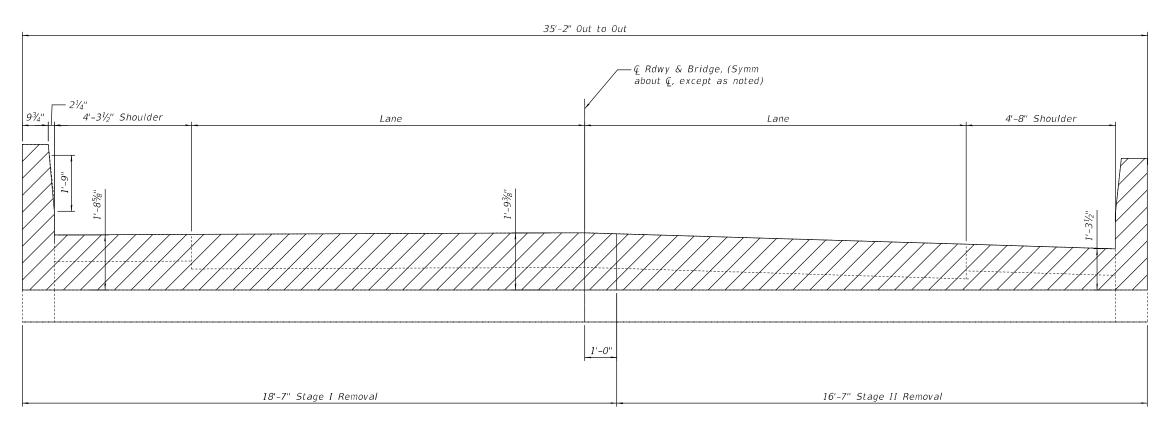
### SECTION E-E




SECTION G-G


\* Preformed Flexible Foam Expansion Joint Filler (Cost included with Concrete Superstructure)

USER NAME = Anthony.Vinson	DESIGNED - AYV	REVISED -		CROSS SECTION (Appr Rem & Repl) (N Abut) SN 061–0018		FAS/FAU RTF	SECTION	COUNTY	TOTAL SHEET			
	DRAWN - AYV	REVISED -	STATE OF ILLINOIS			2701/8565	(105, 106) RS-3	MARION	68 46			
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PLOT DATE = 11/30/2023	DATE -	REVISED -		SCALE: SHEET 6	OF 17	7 SHEETS	STA.	TO STA.		ILLINOIS FED.	AID PROJECT	

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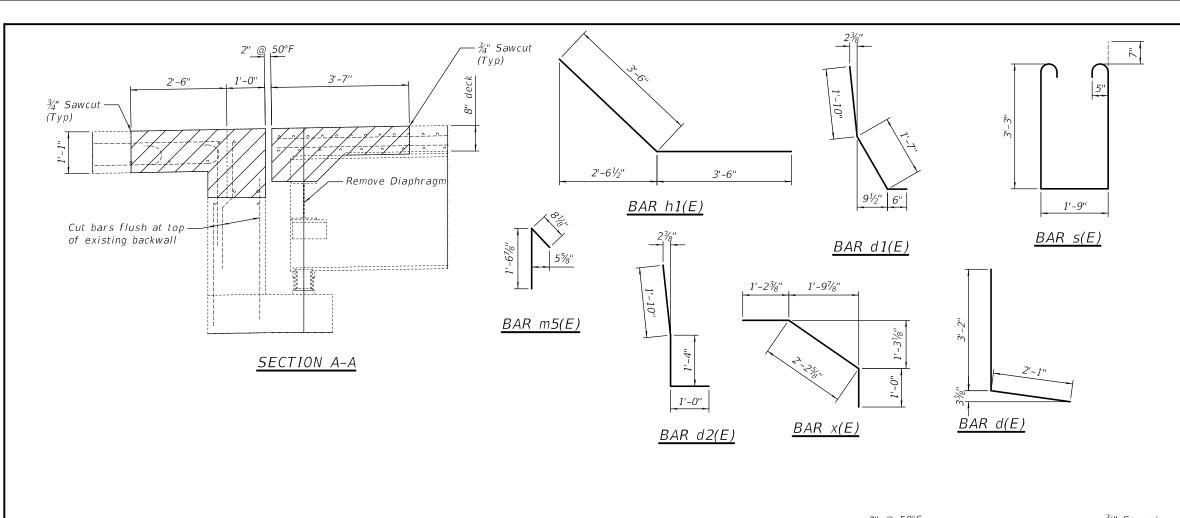
### SECTION F-F

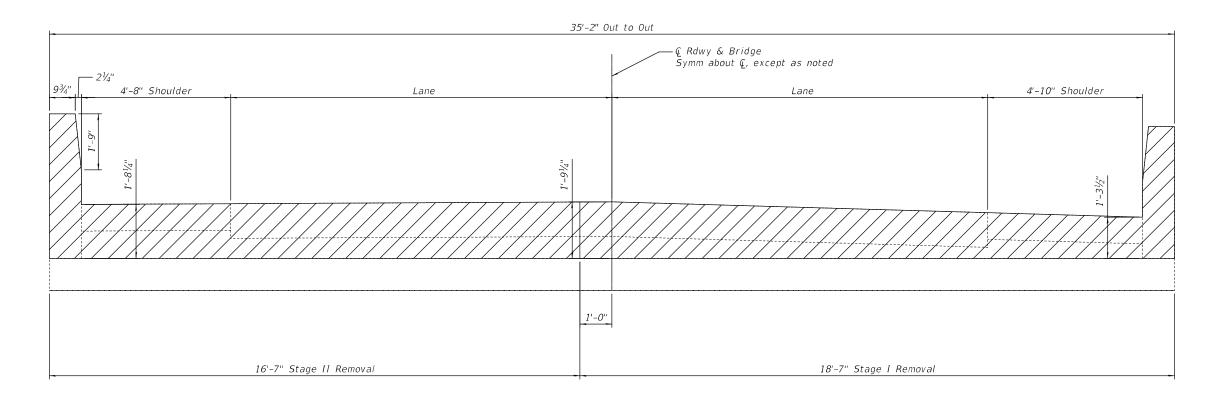


### SECTION H-H

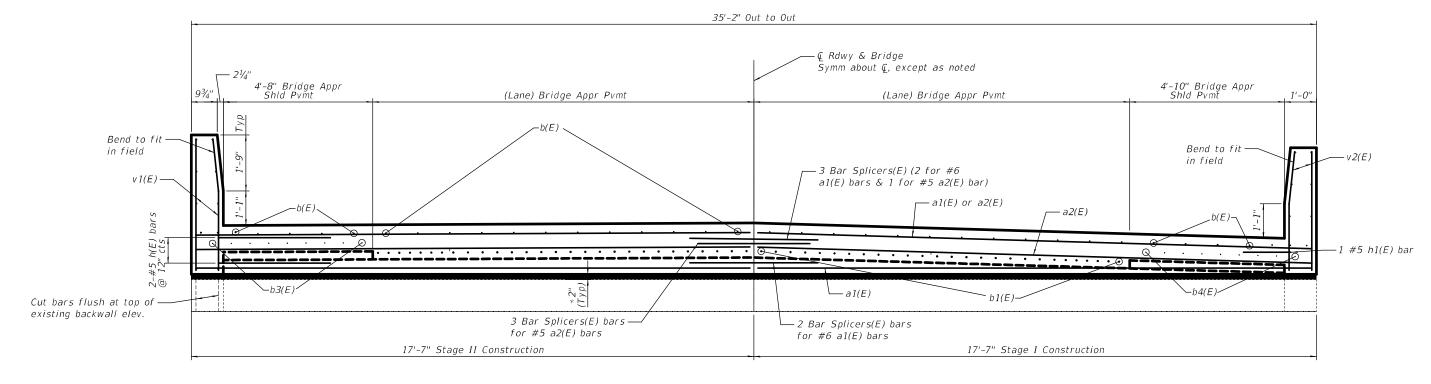\* Preformed Flexible Foam Expansion Joint Filler (Cost included with Concrete Superstructure)

USER NAME = Anthony, Vinson	DESIGNED - AYV	REVISED -		CROSS SECTION (Appr Rem & Repl) (S Abut) SN 061–0018		FAS/FAU RTE.	SECTION	COUNTY	TOTAL	SHEET NO.		
	DRAWN - AYV	REVISED -	STATE OF ILLINOIS			2701/8565	(105, 106) RS-3	MARION	68	47		
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PLOT DATE = 11/30/2023	DATE -	REVISED -		SCALE:	SHEET 7 OF 17 SH	HEETS STA.	TO STA.		ILLINOIS FED. A	ID PROJECT		
						<u> </u>		•				



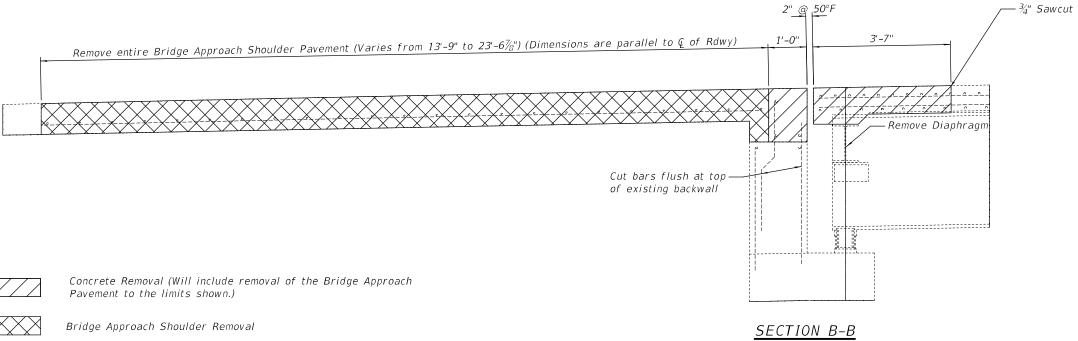

71/8"  BAR m6(E)	2'-63%"
	3'-6"

### BAR h(E)

### BILL OF MATERIAL

Bar	No.	Size	Length	Shape
a(E)	56	#5	23'-9"	Shape
a(L) a1(E)	16	#6	25'-9''	
a2(E)	16	#5	25'-0"	
a3(E)	16	#6	4'-0"	
a4(E)	34	#4	4'-3"	
a5(E)	21	#4	4'-6"	
a5(E)	13	#4	3'-11"	
<i>a</i> 0( <i>E</i> )	13	#4	3-11	
b/E)	76	45	101 011	
b(E)	76	#5 #7	10'-0"	
b1(E)	112		8'-1"	
b2(E)	8	#4	19'-4" 14'-9"	
b3(E)	16	#4		
b4(E)	9	#4	19'-8"	
d/ F \	22	41	<b>-</b> ,	
d(E)	22	#4	5'-3"	Ļ
d1(E)	10	#5	3'-11"	<u> </u>
d2(E)	12	#5	4'-2"	L
			=,	
h(E)	4	#5	7'-0"	
h1(E)	2	#5	7'-0"	
(5)	20		4.5/ 5//	
m(E)	20	#6	13'-5"	
m1(E)	12	#6	23'-11"	
m2(E)	20	#6	6'-6"	
m3(E)	8	#6	1'-8"	
m4(E)	8	#6	4'-10"	
m5(E)	8	#6	2'-3"	
m6(E)	8	#6	1'-4"	
,				
s(E)	59	#5	9'-5"	<u> </u>
(5)				
v(E)	110	#8	1'-8"	
v1(E)	24	#4	4'-1"	
v2(E)	24	#4	3'-8"	
				_
x(E)		#4	4'-5"	
	te Remo	oval	Cu. Yd.	30.7
Concre			Cu. Yd.	54.7
	tructur			
	rcement		Pound	8450
Ероху	Coated			
Structi	ural St	eel	Pound	3340
Remov	al		1 04114	2240


USER NAME = Anthony, Vinson DE	ESIGNED - AYV	REVISED -
DR	RAWN - AYV	REVISED -
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PLOT DATE = 11/30/2023 DA	ATE -	REVISED -

STATE OF ILLINOIS
DEPARTMENT OF TRANSPORTATION

See sheets 3 & 15 of 17 for Inlet Box Removal & locations.

All dimensions are at Rt. \( \Lambda s\), except as noted.

EXISTING JOINT DETAILS				FAS/FAU SECTION		COUNTY	TOTAL SHEETS	SHEET NO.				
SN 061-0018				2701/8565	(105, 106)	)RS-3		MARION	68	48		
311 001-0010										CONTRACT	NO. 76	5L11
	SHEET 8	OF 17	SHEETS	STA.	TO STA.		ILI	LINOIS FE	ED. AI	D PROJECT		

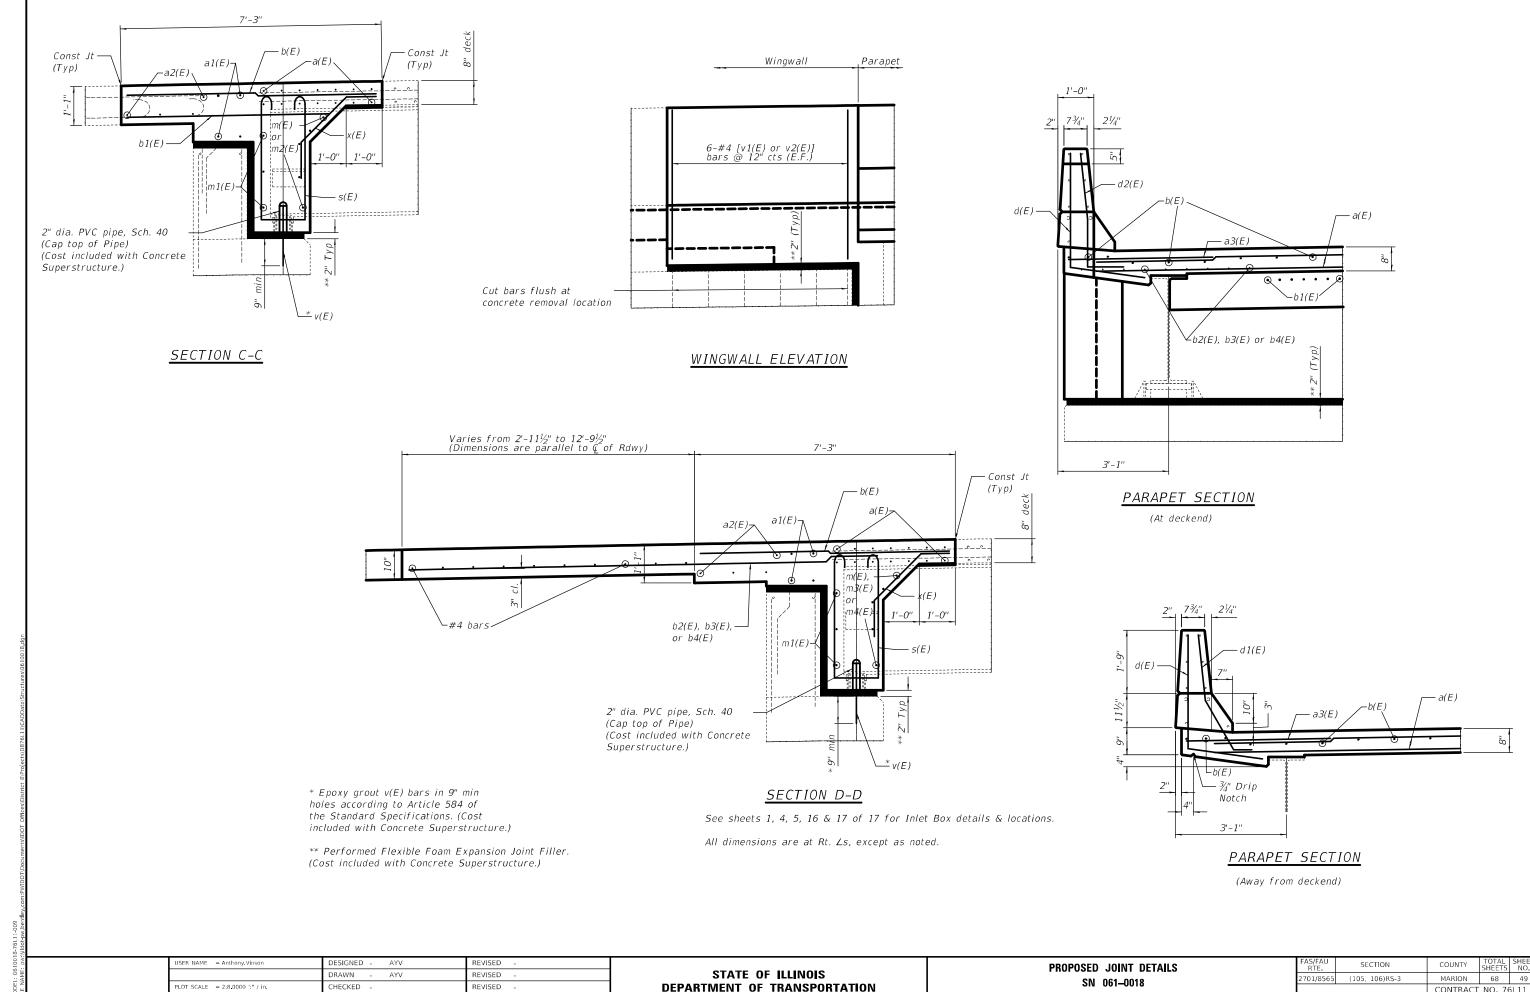

LOT DATE = 11/30/2023


DATE

**DEPARTMENT OF TRANSPORTATION** 

REVISED

701/8565 SN 061-0018 SHEET 9 OF 17 SHEETS STA. TO STA.

(105, 106)RS-3 MARION 68 49 CONTRACT NO. 76L11

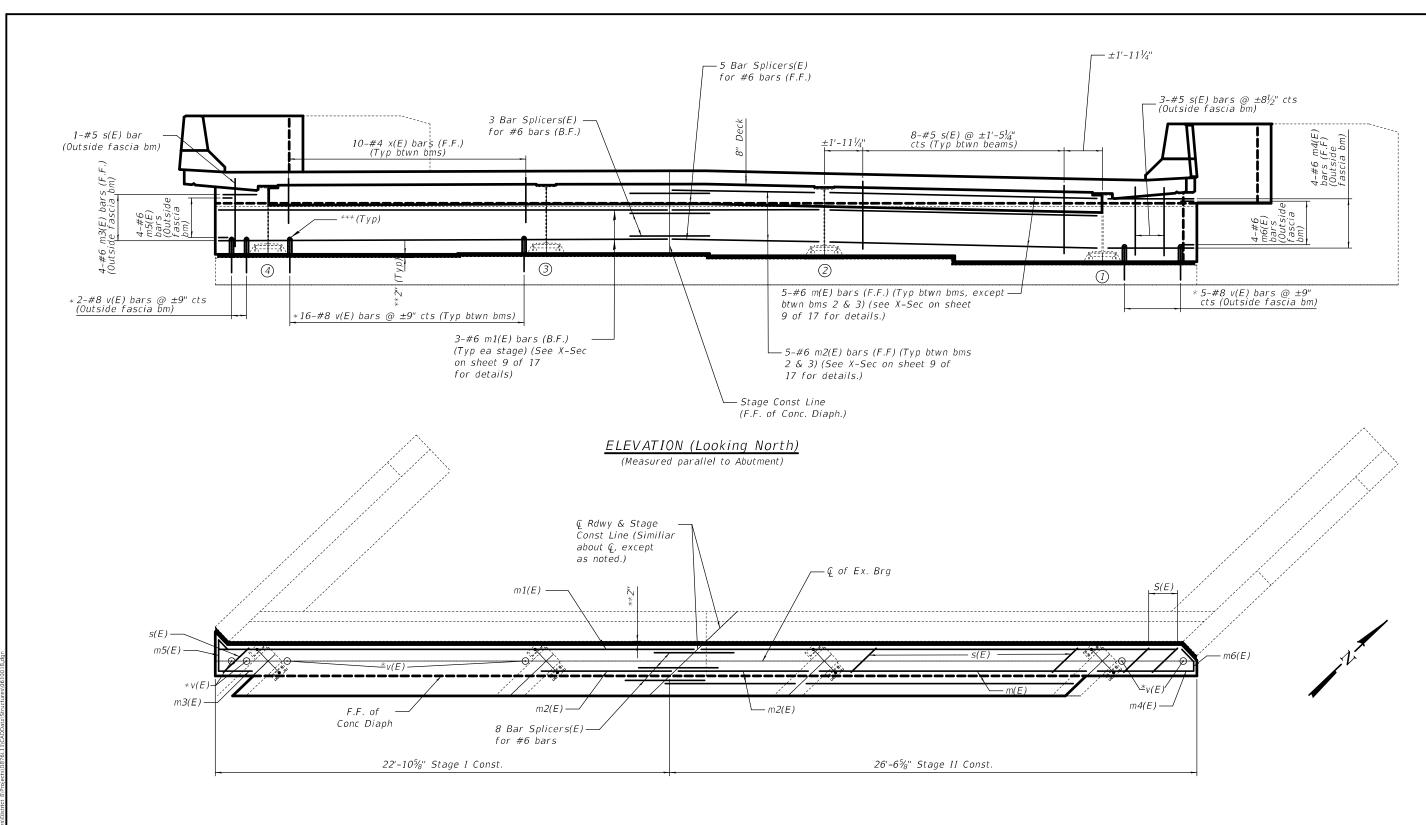

### PLAN VIEW THRU DIAPHRAGM

\* Epoxy grout v(E) bars in 9" min holes according to Article 584 of the Standard Specifications. (Cost included with Concrete Superstructure)

\*\* Preformed Flexible Foam Expansion Joint Filler. (Cost included with Concrete Superstructure.)


\*\*\* 2" diam. PVC Pipe, Sch. 40 (Cap top of pipe.) (Cost included w/Conc Superstructure.)


USER NAME = Anthony, Vinson	DESIGNED - AYV	REVISED -	i
	DRAWN - AYV	REVISED -	İ
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PLOT DATE = 11/30/2023	DATE -	REVISED -	

STATE OF ILLINOIS
DEPARTMENT OF TRANSPORTATION

DIAPHR	NENT	FAS/FAU RTE.	SECTION		
	2701/8565	(105, 106)RS-3			
	SN	061-0018			
SHEET 10	OF 17	SHEETS STA.	TO STA.		TI LINOIS E

MODEL: 0610018-76L11-010

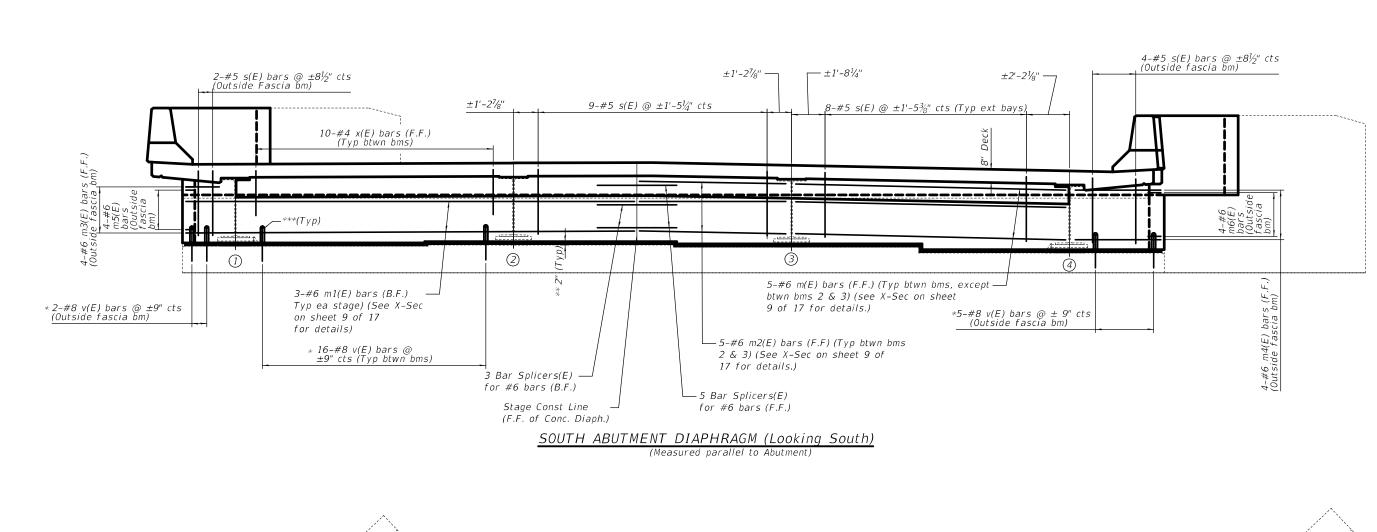

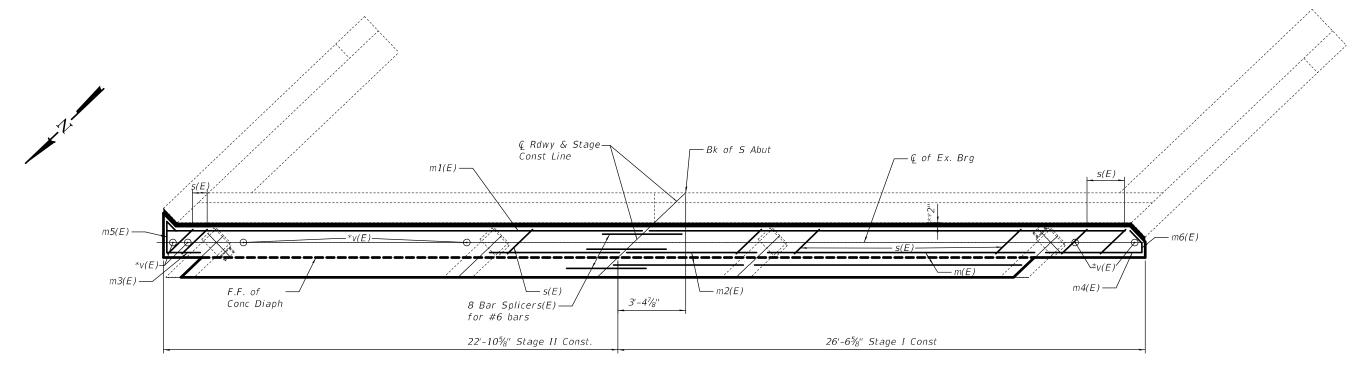

### PLAN VIEW THRU DIAPHRAGM

\*\*\* 2" diam. PVC Pipe, Sch. 40 (Cap top of pipe.) (Cost included w/Conc Superstructure.)

\*\* Preformed Flexible Foam Expansion Joint Filler. (Cost included with Concrete Superstructure)

USER NAME = Anthony.Vinson	DESIGNED - AYV	REVISED -
	DRAWN - AYV	REVISED -
PLOT SCALE = 4:10.0000 ":" / in.	CHECKED -	REVISED -
PLOT DATE = 11/30/2023	DATE -	REVISED -


\* Epoxy grout v(E) bars in 9" min. holes according to Article 584 of the Standard

Superstructure.)


Specifications. (Cost included with Concrete

STATE OF ILLINOIS	
DEPARTMENT OF TRANSPORTATION	

	DIAPHRAGM AT SOUTH ABUTMENT						SEC <sup>-</sup>	TION		COUNTY	TOTAL SHEETS	SHEET NO.
SN 061-0018					2701/8565	(105, 10	06) RS-3		MARION	68	51	
21/1 001-0019				10						CONTRACT	NO. 76	5L11
	SHEET 11	OF 17	SHEETS	STA.	TO STA.			ILLINOIS	FED. A	ID PROJECT		

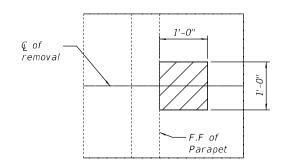


### PLAN-REMOVAL OF EXISTING CONCRETE

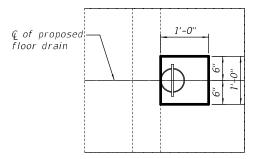


PLAN-PROPOSED FLOOR DRAIN & FULL DEPTH PATCH


(See sheet 1 of 17 for locations to replace concrete with floor drain & full depth patch.)

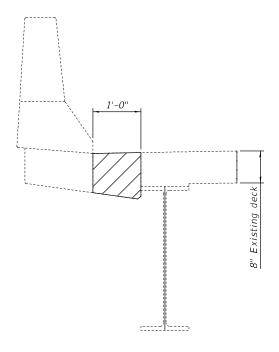

### SECTION - REMOVAL OF EXISTING CONCRETE

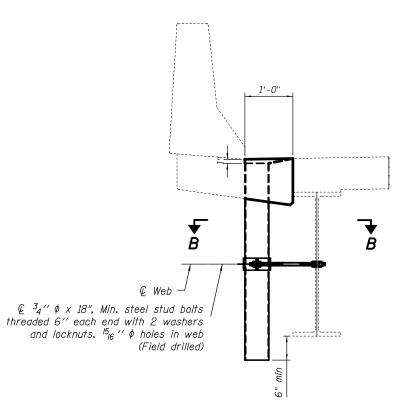

SECTION - PROPOSED FLOOR DRAIN & FULL DEPTH PATCH

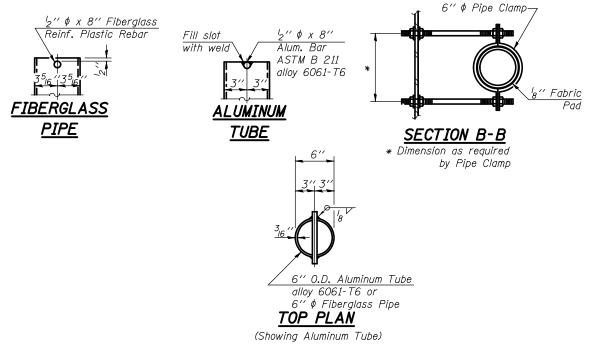


Fiberglass pipe shall conform to ASTM D 2996, with short-time rupture strength hoop tensile strees of 30,000 p.s.i. minimum.


Cost of Concrete Removal and replacement and removal of existing drains is included in cost of Deck Slab Repair (Full Depth, Type I)


USER NAME = Anthony, Vinson	DESIGNED - AYV	REVISED -
	DRAWN - AYV	REVISED -
PLOT SCALE = 2:0.0000 ':" / in.	CHECKED -	REVISED -
PLOT DATE = 11/30/2023	DATE -	REVISED -

STATE OF ILLINOIS **DEPARTMENT OF TRANSPORTATION** 

DRAIN DETAILS						SEC.	TION		COUNTY	TOTAL SHEETS	
	CVI	061_00	1Ω		2701/8565	(105, 1	06)RS-3		MARION	68	52
SN 061-0018									CONTRAC	T NO. 70	5L11
SHEET 12	OF 17	SHEETS	STA.	TO STA.			ILLINOIS	FED. A	ID PROJECT		

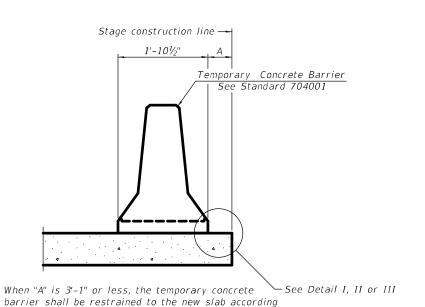

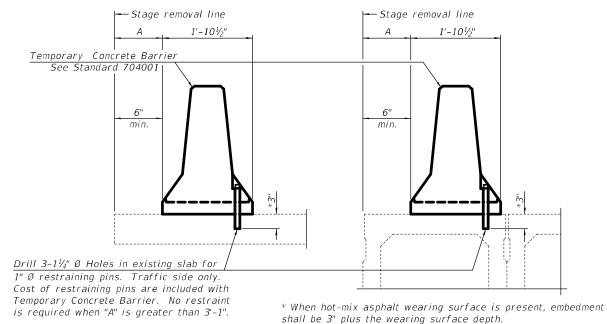

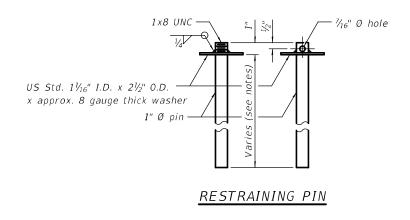

NEW SLAB OR NEW DECK BEAM


to Detail I, II or III. No restraint is required


when "A" is greater than 3'-1".


EXISTING SLAB

EXISTING DECK BEAM

### SECTIONS THRU SLAB OR DECK BEAM

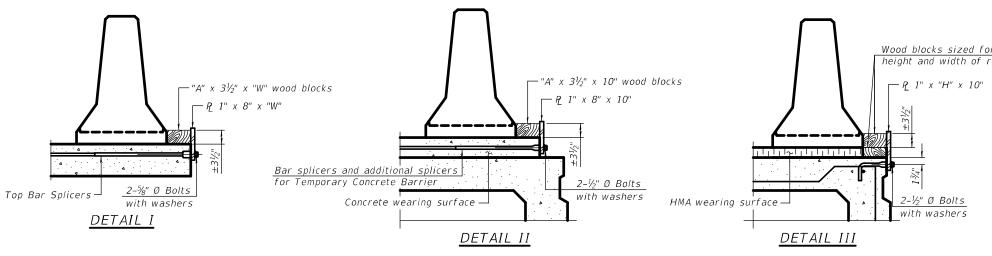

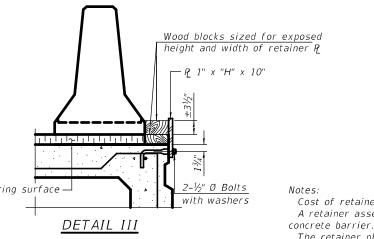

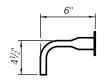

BAR SPLICER FOR #4 BAR - DETAIL III

Detail I Detail II 2" Top bars Spa., 2" Detail I Detail II — Ç ¾" Ø Holes

STEEL RETAINER P 1" x 8" x "W"

(Detail I and II)

← Ç ¾" Ø Holes

### STEEL RETAINER P 1" x "H" x 10" (Detail III)

stage is ready to be poured. For Detail III applications the retainer plate shall not be removed until just prior to placing the adjacent beam.

the shear key clamping device. Detail I - Installation for a new bridge deck or bridge slab.

Cost of retainer assembly is included with Temporary Concrete Barrier.

A retainer assembly shall be located at the approximate Q of each temporary

The retainer plate shall not be removed until the concrete on the adjacent

When the 'A' dimension is less than  $1\frac{1}{2}$ ", the wood block shall be omitted

and the barrier shall be placed in direct contact with the steel retainer plate. For deck beam applications the minimum required 'A' distance is 6" to accommodate

Detail II - Installation for a new deck beam with an initial concrete wearing surface. Additional bar splicers shall be provided at 6'-0" centers and paired with the bar splicers of the concrete wearing surface reinforcement to accommodate the installation of the retainer assemblies. The cost of the additional bar splicers is included with the concrete wearing surface.

Detail III - Installation for a new deck beam with no initial wearing surface or with an initial hot-mix asphalt (HMA) wearing surface present. The deck beam directly beneath the temporary concrete barrier shall be fabricated with bar splicer inserts in the side of the beam, as detailed, to accommodate the installation of the retainer assemblies. A pair of bar splicers, 6" apart, shall be placed at 6'-0" centers along the length of the beam. The cost of the bar splicers is included with the deck beam.

### RAILING CRITERIA

NCHRP 350 Test Level Railing Weight (plf)

R-27 10-12-2021

USER NAME = Anthony.Vinson	DESIGNED - AYV	REVISED -
	DRAWN - AYV	REVISED -
PLOT SCALE = 0:2.0000 ':" / in.	CHECKED -	REVISED -
PLOT DATE = 11/30/2023	DATE -	REVISED -

### STATE OF ILLINOIS **DEPARTMENT OF TRANSPORTATION**

TEI	TEMPORARY CONCRETE BARRIER						FAS/FAU RTE.	SECTION		COUNTY	TOTAL SHEETS	SHEET NO.
	STR	пст	ПR	ENO (	061_0018		2701/8565	(105, 106)RS-3		MARION	68	53
	STRUCTURE NO. 061-0018									CONTRACT	NO. 76	5L11
HEET	EET 13 OF 17 SHEETS STA. TO STA.							TLUNOIS	FED. AI	D PROJECT		


### STANDARD BAR SPLICER ASSEMBLY PLAN

Only bar splicer assemblies as presented on the approved QPL list may be used.

Threaded splicer bar length = min. lap length +  $1\frac{1}{2}$ " + thread length

\* Epoxy not required on Bar Splicer Assembly components used in conjunction with black bars.

Location	Bar size	No. assemblies required	Minimum Iap length
Abutments	#5	36	3'-6"
Abutments	#6	24	4'-0"

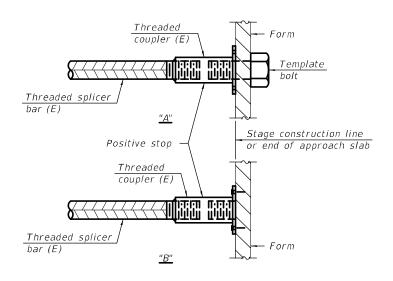

### INSTALLATION AND SETTING METHODS

"A": Set bar splicer assembly by means of a template bolt

"B": Set bar splicer assembly by nailing to wood forms or cementing to steel forms.

(E): Indicates epoxy coating.

Stage line
if applicable

Stage I construction

Mechanical
splicer (E)

Reinforcement bar

### STANDARD MECHANICAL SPLICER

Location	Bar size	No. assemblies required

Notes:

Splicer bars shall be deformed with threaded ends and have a minimum 60 ksi yield strength.

All reinforcement shall be lapped and tied to the splicer bars.

Bar splicer assemblies shall be epoxy coated according to the requirements for reinforcement bars. See Section 508 of the Standard Specifications.

See approved list of bar splicer assemblies and mechanical splicers for alternatives.

BSD-1

2-1-2023


USER NAME =	DESIGNED - AYV	REVISED -
	CHECKED - AYV	REVISED -
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PLOT DATE =	CHECKED -	REVISED -

STATE OF ILLINOIS
DEPARTMENT OF TRANSPORTATION

BAR SPLICER ASSEMBLY AND MECHANICAL SPLICER DETAILS
STRUCTURE NO. 061–0018

SHEET 14 OF 17 SHEETS

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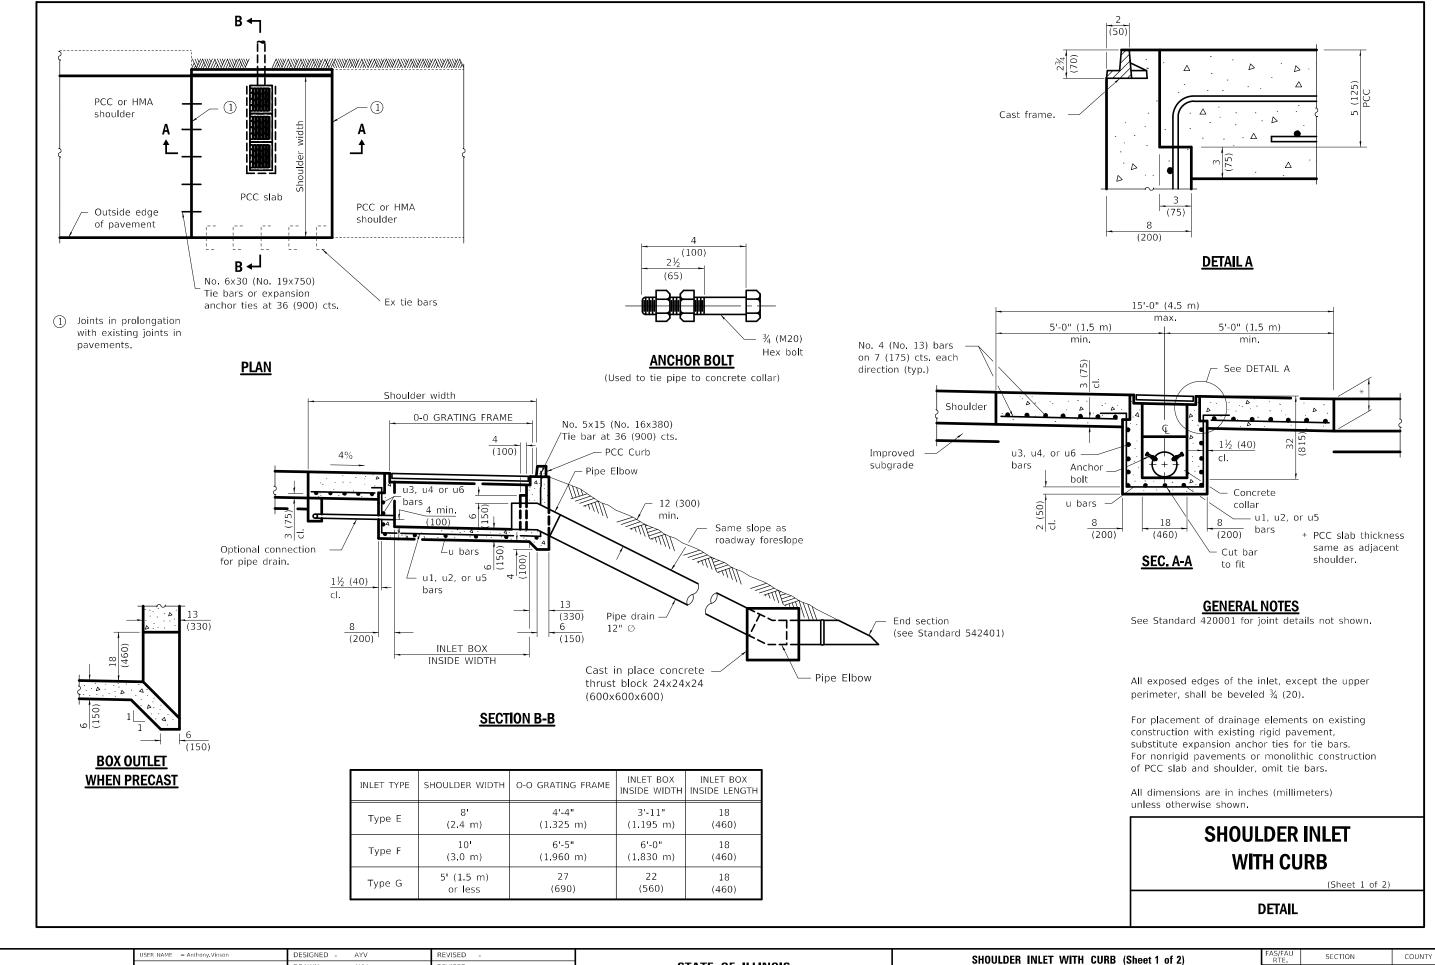
STATE OF ILLINOIS
DEPARTMENT OF TRANSPORTATION

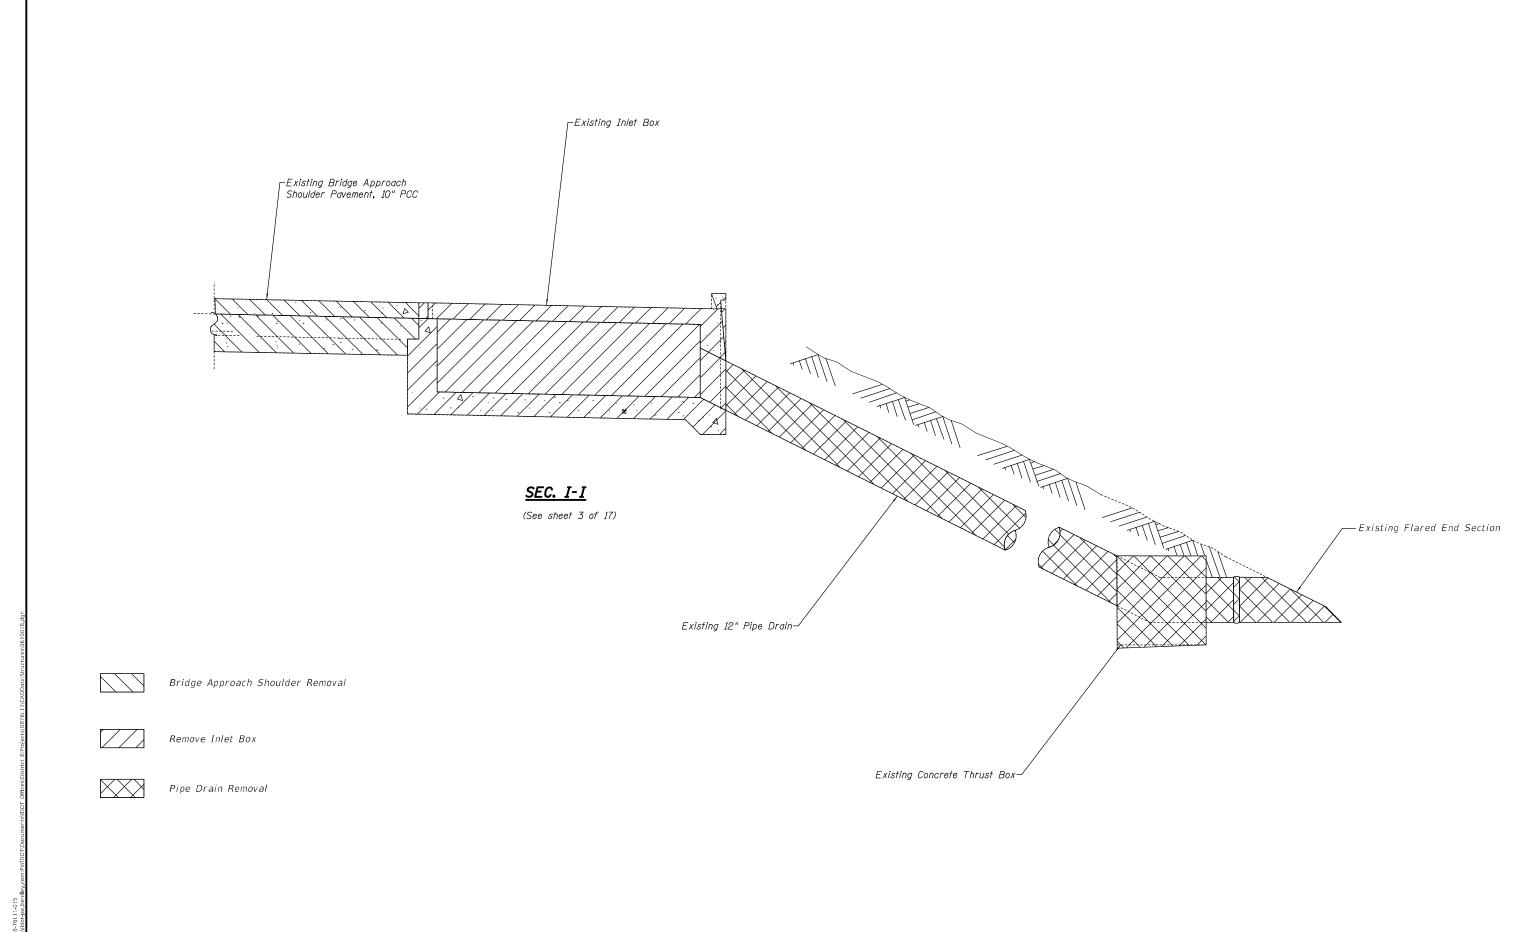 BRIDGE APPROACH SHOULDER REMOVAL DETAIL
 FAS/FAU RTE.
 SECT

 SN 061-0018
 2701/8565
 (105, 10

 SHEET 15
 OF 17
 SHEETS STA.
 TO STA.


| FAS/FAU | SECTION | COUNTY | TOTAL | SHEET | STATE | STATE |



FILE NAME: pw:\\ildot-pw.bentley

STATE OF ILLINOIS
DEPARTMENT OF TRANSPORTATION

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SHEET 16	OF	17	SHEETS	STA	. TO STA

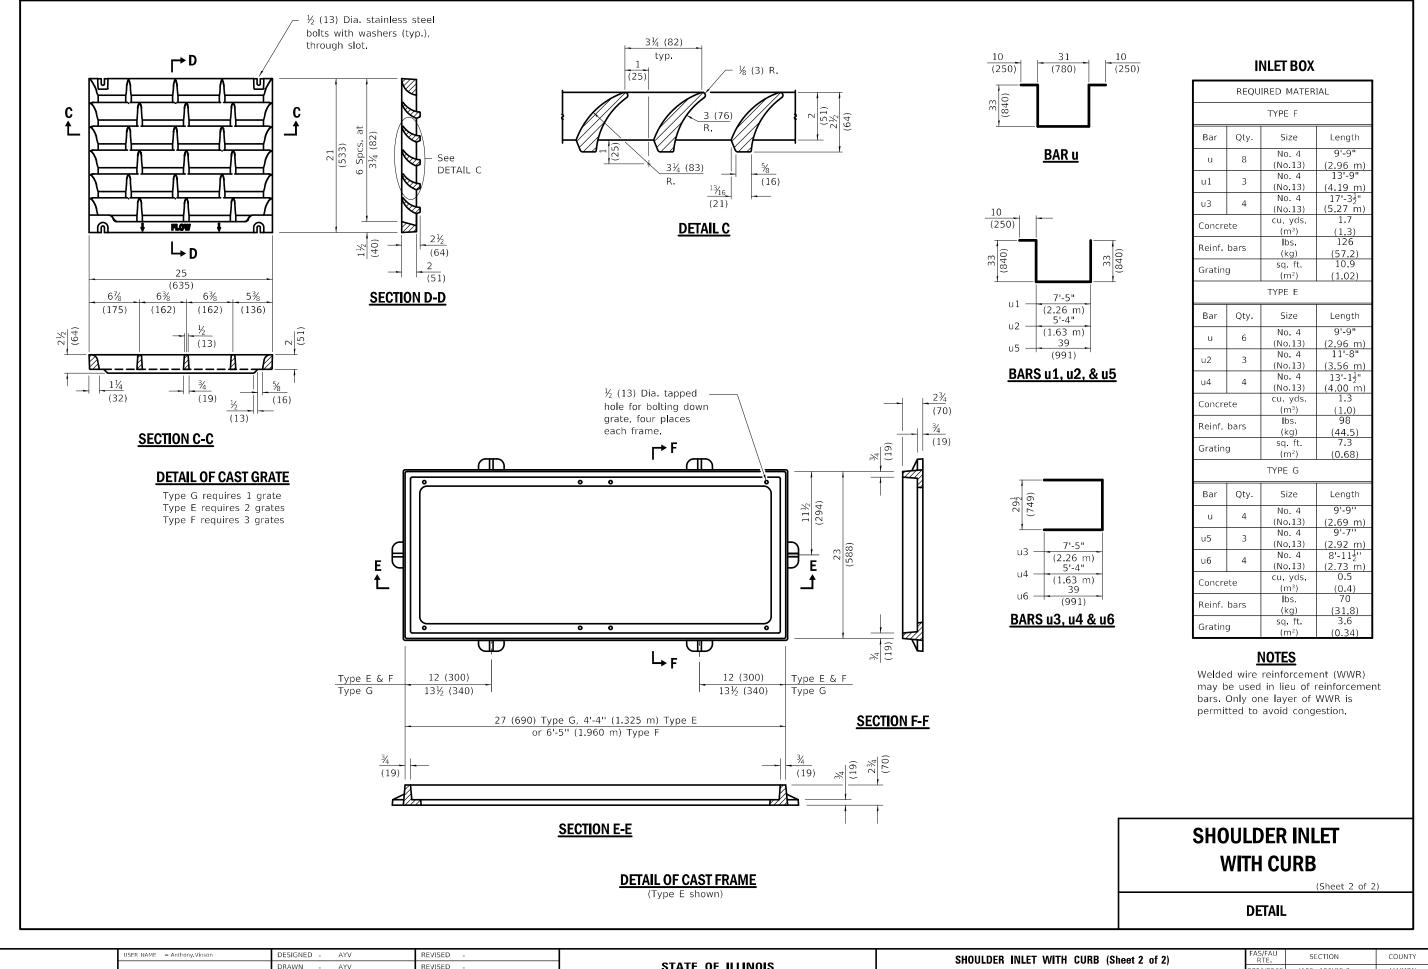

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DATE

REVISED

STATE OF ILLINOIS
DEPARTMENT OF TRANSPORTATION

SHOULDER INLET WITH CURB (Sheet 2 of 2)

SN 061-0018

SHEET 17 OF 17 SHEETS STA. TO ST

# STATE OF ILLINOIS DEPARTMENT OF TRANSPORTATION OFFICE OF HIGHWAYS PROJECT IMPLEMENTATION

RECEIVED: 11-30-23


SPACE RESERVED FOR RECORDING OFFICER

## **PLAT OF HIGHWAYS**


	SHEET	INDEX
SHEET NO.	STATION to STATION	DESCRIPTION
1		COVER SHEET
2		LEGEND/NOTE SHEET
3	28+98.68 to 38+00.00	
4	38+00.00 to 48+66.07	PAR. 8307043TE & 8307042TE
5	305+48.67 to 313+57.42	EXIST. ROW IN ALMA
6		CONTROL TIES

FAS ROUTE 2701 (IL 37) SECTION (105,106)RS-3 MARION COUNTY JOB NO. R-98-007-23



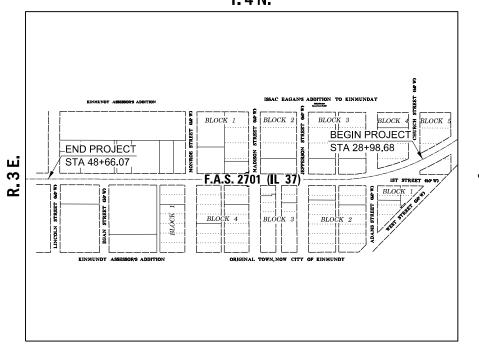

PROJECT LENGTH = 1,967 LIN. FT. = 0.37 MILES

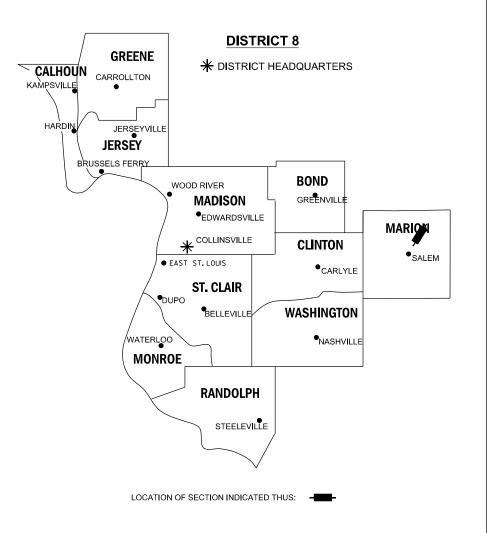

### PREPARED BY:

CIVIL DESIGN,ING. 307 E. WASHINGTON AVE. EFFINGHAM, IL 62401

PH. 217-342-2025 IL DESIGN FIRM #184.003222



DANIEL J. HOLLAND, IPLS #3907 EXPIRATION DATE 11/30/2024 SHEET 1 OF 6

OFFICE OF HIGHWAYS PROJECT IMPLEMENTATION/REGION 5/DISTRICT 8 1102 EASTPORT PLAZA DRIVE COLLINSVILLE, ILLINOIS 62234-6198								
S.	SECTION			COUNTY	TOTAL SHEETS	SHEET NO.		
1	(105,106)RS-3			MARION	68	58		
CONTRACT NO. 76L11					76L11			
ROAD DIST NO ILLINOI		S FED. AID PROJECT			CT			

ILLINOIS DEPARTMENT OF TRANSPORTATION

### LECEND FOR EVICTING TODOGRAPHIC CVMPOLC

LEGEND FOR EXISTING TOPOGRAPHIC SYMBOLS								
TRAFFIC SIGNAL GULFBOX	TRAFFIC SIGNAL GULFBOX O DRAINAGE FLOW LINE ¥							
TRAFFIC SIGNAL HANDHOLE		RIP RAP	MONOCOM					
TRAFFIC SIGNAL SIGNAL POST	0	HEADWALL	-					
TRAFFIC SIGNAL STEEL MAST ARM	0	CULVERT END SECTION	⊲					
TRAFFIC SIGNAL PEDESTRIAN PUSH BUTTON	•	DRAINAGE MANHOLE	0					
TRAFFIC SIGNAL WOODEN POLE	⊗	INLET	0					
TRAFFIC SIGNAL VEHICLE DETECTION PRIORITY	⋖	ROADWAY DITCH FLOW	<b>-</b> ∼>					
TRAFFIC SIGNAL VEHICLE DETECTION MAGNET	<b>—</b>	VEGETATION LINE	~~~					
TRAFFIC SIGNAL JUNCTION BOX	•	STUMP	M					
TRAFFIC SIGNAL CONTROLLER	$\boxtimes$	SHRUB	0					
TRAFFIC SIGNAL HEAVY DUTY HANDHOLE	H	EVERGREEN TREE	o					
RAILROAD CANTILEVER MAST ARM	XOX X	DECIDUOUS TREE	0					
RAILROAD CROSSBUCK	<b>⊁</b>	WOODS/BUSH LINE	,,,,,,,,,,,,,,,,,,,,,,,,,,,,,,,,,,,,,,					
RAILROAD TRACK		TRAFFIC SIGN	þ					
RAILROAD TRACK (ABANDONED)	#=	GUARDRAIL POST	0					
RAILROAD CROSSGATE	<del>⊻0∑&gt;</del>	GUARDRAIL	0 0 0 0					
RAILROAD CONTROL BOX	⊠	FIELD LINE	E					
RAILROAD FLASHING SIGNAL	Xex	LEVEE/NOISE BARRIER						
UTILITY TELEPHONE SPLICE BOX	⊞	FENCE	-1-1-1-1-1-					
UTILITY POWER POLE	-0-	MAIL BOX	P					
UTILITY TRAFFIC SIGNAL	Ф	ADVERTISING SIGN	þ					
UTILITY LIGHT POLE	¤	MARSH	يسلس					
UTILITY FIRE HYDRANT	α	LIGHTING HANDHOLE						
UTILITY MANHOLE	0	LIGHTING POWER POLE	-0-					
UTILITY TELEPHONE POLE	-0-	LIGHTING JUNCTION BOX	0					
UTILITY GUY ANCHOR	←	LIGHTING HEAVYDUTY HANDHOLE	H					
UTILITY PIPELINE WARNING SIGN	þ	LIGHTING CONTROLLER	⊠					
UTILITY HANDHOLE		LIGHTING PULL POINT	P					
UTILITY SPLICE BOX	B	HIGHWAY LIGHTING ELECTRICAL GROUND	<b>→</b>					
UTILITY JUNCTION BOX	•	HIGHWAY LIGHTING SINGLE UNIT	$\bigcirc$					
UTILITY HEAVY DUTY HANDHOLE	H	HIGHWAY LIGHTING DOUBLE UNIT	$\bigcirc$					
UTILITY DOUBLE HANDHOLE		EXISTING CONCRETE BARRIER						
UTILITY CONTROLLER	⊠	EXISTING CREEK OR DITCH						
UTILITY WATER METER	0	EXISTING EDGE OF PAVEMENT						

### **BASIS OF COORDINATE & BEARING STATEMENT**

COORDINATES AND BEARINGS SHOWN HEREON ARE BASED ON THE SURVEY CONTROL DATA AS PROVIDED BY THE ILLINOIS DEPARTMENT OF TRANSPORTATION.

LOW DISTORTION PROJECTION - MARION COUNTY

BASIS OF BEARINGS AND COORDINATES: ALL DISTANCES AND BEARING SHOWN HEREON ARE GRID VALUES BASED ON THE FOLLOWING PROJECTION DEFINITION. THE PROJECTION WAS DEFINED SUCH THAT GRID DISTANCES ARE EQUIVALENT TO "GROUND" DISTANCES.

LINEAR UNIT: US SURVEY FEET GEODETIC DATUM: VAD 1983 (2011) - EPOCH: 2010 VERTICAL DATUM: NAVD 1988 PROJECTIONS: Lamber Conformal Conic (Single Parallel) LATIDUE OF ORIGIN: 38°39'00"N CENTRAL MERIDIAN: 88°55'00"W FALSE NORTHING: 65,000 SFT FALSE EASTING: 70,000 SFT CM SCALE FACTOR: 1.00001913

THE SURVEY WAS REFERENCED TO THE NATIONAL SPACIAL REFERENCE. SYSTEM BY DIRECT CONNECTION TO THE FOLLOWING NGS MONUMENTS.

CONTROL: NO. 5

LATITUDE: N38°47'16.73397' LONGITUDE: W88°48'28.38052" ELLIPSOIDAL HEIGHT: 485.0334 SFT

NORTHING: 115273.1041 SFT EASTING: 101009.6521 SFT ORTHO HT.: 588.2050 SFT (GEOID 12B)


CONTROL: NO. 6

LATITUDE: N38°45'05.67677" LONGITUDE: W88°48'29.89537" ELLIPSOIDAL HEIGHT: 480.9243 SFT NORTHING: 102013.7451 SFT EASTING: 100905.3637 SFT

ORTHO HT.: 583.8361 SFT (GEOID 12B)

### **PREPARED BY:**

CIVIL DESIGN.INC 307 E. WASHINGTON AVE EFFINGHAM, IL 62401

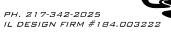



DANIEL J. HOLLAND, IPLS #3907 EXPIRATION DATE 11/30/2024

### RIGHT-OF-WAY LEGEND



SECTION CORNERS



QUARTER CORNERS

— – EXISTING CENTERLINE — — EXISTING RIGHT-OF-WAY LINE —— FORMER RIGHT-OF-WAY LINE

---- EXISTING IDOT EASEMENT LINE 7/////// EXISTING EASEMENT LINE ---- BUILDING SETBACK LINE

—— EXISTING ACCESS CONTROL LINE EXISTING RIGHT-OF-WAY & PROPOSED ACCESS CONTROL LINE PROPOSED ACCESS CONTROL LINE 

- - - PROPOSED RIGHT-OF-WAY LINE 77 77 77 77 77 77 PROPOSED TEMPORARY EASEMENT LINE PROPOSED PERMANENT EASEMENT LINE - - - SECTION LINE

— - - — QUARTER SECTION LINE — - — QUARTER QUARTER SECTION LINE — PROPERTY LINE (TITLE) — RECORDED PLAT/DEED LINE — APPARENT PROPERTY LINE

SAME OWNERSHIP 121.45' MEASURED DIMENSION (121.45') RECORDED DIMENSION FOUND STONE FOUND IRON PIPE OR IRON ROD AT

SET 5/8 INCH IRON ROD WITH PLASTIC CAP IDENTIFIED BY SURVEYORS LICENSE NUMBER AT CORNER UNLESS OTHERWISE

CORNER UNLESS OTHERWISE NOTED

PERMANENT SURVEY MONUMENT, I.D.O.T. STD. 667101

(TO BE SET BY OTHERS) SET 5/8 INCH IRON ROD AS SURVEY CONTROL UNLESS OTHERWISE NOTED

FOUND CUT CROSS SET CUT CROSS

STAKING OF PROPOSED RIGHT-OF-WAY AND PERMANENT EASEMENT CORNERS. SET 5/8 INCH METAL ROD WITH DIVISION OF HIGHWAY SURVEY ALUMINUM CAP TO MONUMENT THE POSITION SHOWN. IDENTIFIED BY INSCRIPTION DATA AND SURVEYORS LICENSE NUMBER

STAKING OF PROPOSED RIGHT-OF-WAY AND PERMANENT EASEMENT CORNERS IN CULTIVATED AREA. A MINIMUM OF 20 INCHES BELOW THE GROUND SURFACE, SET 5/8 INCH METAL ROD WITH DIVISION OF HIGHWAY SURVEY ALUMINUM CAP TO MONUMENT THE POSITION SHOWN. IDENTIFIED BY INSCRIPTION DATA AND SURVEYORS LICENSE NUMBER.

IRON PIN WITH ALUM, CAP

### **IDOT PROVIDED ALIGNMENT FAS ROUTE 2701 (IL 37)**

COORDINATES PROVIDED BY THE ILLINOIS DEPARTMENT OF TRANSPORTATION JOB NO. R-98-007-23 / CONTRACT NO. 76L11								
PNT#/DESC.	STATION	OFFSET	NORTH (FEET)	EAST (FEET)				
POINT 338 P.O.T	14+20.96	0.00'	111,056.0024	91,244.7234				
CURVE 1- PC	22+70.25	0.00'	110,441.7247	90,658.2461				
PCC	28+89.38	0.00'	110,074.8732	90,163.2412				
CURVE 2 - PT	33+71.04	0.00'	109,964.9967	89,698.8147				
CURVE 3 - PC	55+49.96	0.00'	109,970.2184	87,519.8966				
CURVE 7 - PT	292+32.55	0.00'	92,093.5775	73,096.6452				
POINT 321 PI	325+46.69	0.00'	89,700.1990	70,804.2083				

### **IDOT PROVIDED SURVEY CONTROL** COORDINATES PROVIDED BY THE ILLINOIS DEPARTMENT OF TRANSPORTATION JOB NO. R-98-007-23 / CONTRACT NO. 76L11 NORTHING EASTING DESCRIPTION IRON PIN WITH PLASTIC CAP 109.995.2756 88.994.1730 IRON PIN WITH PLASTIC CAP 109,948.6198 89,330,3995 109,983,1061 IRON PIN WITH PLASTIC CAP 89.567.7485 109,993.2283 89,851.3290 IRON PIN WITH PLASTIC CAP 101,009.6521 IRON PIN WITH PLASTIC CAP 102,013.7451

79,823.8767

112,651.5377

### **LEGEND FOR ABBREVIATIONS**

ACCESS CONTROL

	ACCESS CONTROL
AC	ACRE
AVE	AVENUE
BK	BOOK
BLVD	BOULEVARD
<b>φ</b>	CENTERLINE
CAB	CABINET
СН	COUNTY HIGHWAY
Ch	CHAIN
CP	CONTROL POINT
CPS	COTTON PICKER SPINDLE
DB	DEED BOOK
E	EAST
EX	EXISTING
FA	FEDERAL AID
FAI	FEDERAL AID INTERSTATE
FAP	FEDERAL AID PRIMARY
FAS	FEDERAL AID SECONDARY
FAU	FEDERAL AID URBAN
FND	FOUND
ha	HECTARE
IP	IRON PIPE
IR	IRON ROD
LT	LEFT
m	METER
m <sup>2</sup>	SQUARE METERS
N	NORTH
N/F	NOW OR FORMERLY
N & BC	NAIL AND BOTTLE CAP
N & C	NAIL AND CAP
N & W	NAIL AND WASHER
NE	NORTHEAST
NW	NORTHWEST
PB	PLAT BOOK
PG	PAGE
	PAGE
POB	POINT OF BEGINNING
POB POC	POINT OF BEGINNING POINT OF COMMENCEMENT
POB	POINT OF BEGINNING
POB POC POT	POINT OF BEGINNING POINT OF COMMENCEMENT
POB POC POT P	POINT OF BEGINNING POINT OF COMMENCEMENT POINT ON TANGENT PROPERTY LINE
POB POC POT L PR	POINT OF BEGINNING POINT OF COMMENCEMENT POINT ON TANGENT PROPERTY LINE PROPOSED
POB POC POT L PR R	POINT OF BEGINNING POINT OF COMMENCEMENT POINT ON TANGENT PROPERTY LINE PROPOSED RANGE
POB POC POT L PR	POINT OF BEGINNING POINT OF COMMENCEMENT POINT ON TANGENT PROPERTY LINE PROPOSED
POB POC POT L PR R	POINT OF BEGINNING POINT OF COMMENCEMENT POINT ON TANGENT PROPERTY LINE PROPOSED RANGE
POB POC POT PL PR R RD	POINT OF BEGINNING POINT OF COMMENCEMENT POINT ON TANGENT PROPERTY LINE PROPOSED RANGE ROAD RECORD
POB POC POT PL PR R RD REC ROW	POINT OF BEGINNING POINT OF COMMENCEMENT POINT ON TANGENT PROPERTY LINE PROPOSED RANGE ROAD RECORD RIGHT-OF-WAY
POB POC POT E PR R R RD REC ROW RR	POINT OF BEGINNING POINT OF COMMENCEMENT POINT ON TANGENT PROPERTY LINE PROPOSED RANGE ROAD RECORD RIGHT-OF-WAY RAILROAD
POB POC POT P PR R RD REC ROW RR RRS	POINT OF BEGINNING POINT OF COMMENCEMENT POINT ON TANGENT PROPERTY LINE PROPOSED RANGE ROAD RECORD RIGHT-OF-WAY RAILROAD SPIKE
POB POC POT E PR R R RD REC ROW RR	POINT OF BEGINNING POINT OF COMMENCEMENT POINT ON TANGENT PROPERTY LINE PROPOSED RANGE ROAD RECORD RIGHT-OF-WAY RAILROAD
POB POC POT P PR R RD REC ROW RR RRS	POINT OF BEGINNING POINT OF COMMENCEMENT POINT ON TANGENT PROPERTY LINE PROPOSED RANGE ROAD RECORD RIGHT-OF-WAY RAILROAD SPIKE
POB POC POT P PR R RD REC ROW RR RRS RT RTE	POINT OF BEGINNING POINT OF COMMENCEMENT POINT ON TANGENT PROPERTY LINE PROPOSED RANGE ROAD RECORD RIGHT-OF-WAY RAILROAD RAILROAD SPIKE RIGHT ROUTE
POB POC POT PL PR R RD REC ROW RR RRS RT RTE S	POINT OF BEGINNING POINT OF COMMENCEMENT POINT ON TANGENT PROPERTY LINE PROPOSED RANGE ROAD RECORD RIGHT-OF-WAY RAILROAD RAILROAD SPIKE RIGHT ROUTE SOUTH
POB POC POT PL PR R RD REC ROW RR RRS RT RTE S SBI	POINT OF BEGINNING POINT OF COMMENCEMENT POINT ON TANGENT PROPERTY LINE PROPOSED RANGE ROAD RECORD RIGHT-OF-WAY RAILROAD RAILROAD SPIKE RIGHT ROUTE SOUTH STATE BOND ISSUE
POB POC POT PL PR R RD REC ROW RR RRS RT RTE S	POINT OF BEGINNING POINT OF COMMENCEMENT POINT ON TANGENT PROPERTY LINE PROPOSED RANGE ROAD RECORD RIGHT-OF-WAY RAILROAD RAILROAD SPIKE RIGHT ROUTE SOUTH
POB POC POT PL PR R RD REC ROW RR RRS RT RTE S SBI	POINT OF BEGINNING POINT OF COMMENCEMENT POINT ON TANGENT PROPERTY LINE PROPOSED RANGE ROAD RECORD RIGHT-OF-WAY RAILROAD RAILROAD SPIKE RIGHT ROUTE SOUTH STATE BOND ISSUE
POB POC POT P P R R R REC ROW RR RRS RT RTE S SBI SE SEC	POINT OF BEGINNING POINT OF COMMENCEMENT POINT ON TANGENT PROPERTY LINE PROPOSED RANGE ROAD RECORD RIGHT-OF-WAY RAILROAD RAILROAD SPIKE RIGHT ROUTE SOUTH STATE BOND ISSUE SOUTHEAST SECTION
POB POC POT P PR R RD REC ROW RR RRS RT RTE S SBI SE SEC SQ FT	POINT OF BEGINNING POINT OF COMMENCEMENT POINT ON TANGENT PROPERTY LINE PROPOSED RANGE ROAD RECORD RIGHT-OF-WAY RAILROAD RAILROAD SPIKE RIGHT ROUTE SOUTH STATE BOND ISSUE SOUTHEAST SECTION SQUARE FEET
POB POC POT P PR R RD REC ROW RR RRS RT RTE S SBI SE SEC SQ FT SR	POINT OF BEGINNING POINT OF COMMENCEMENT POINT ON TANGENT PROPERTY LINE PROPOSED RANGE ROAD RECORD RIGHT-OF-WAY RAILROAD SPIKE RIGHT ROUTE SOUTH STATE BOND ISSUE SOUTHEAST SECTION SQUARE FEET STATE ROUTE
POB POC POT P PR R RD REC ROW RR RRS RT RTE S SBI SE SEC SQ FT	POINT OF BEGINNING POINT OF COMMENCEMENT POINT ON TANGENT PROPERTY LINE PROPOSED RANGE ROAD RECORD RIGHT-OF-WAY RAILROAD SPIKE RIGHT ROUTE SOUTH STATE BOND ISSUE SOUTHEAST SECTION SQUARE FEET STATE ROUTE STREET
POB POC POT P PR R RD REC ROW RR RRS RT RTE S SBI SE SEC SQ FT SR	POINT OF BEGINNING POINT OF COMMENCEMENT POINT ON TANGENT PROPERTY LINE PROPOSED RANGE ROAD RECORD RIGHT-OF-WAY RAILROAD SPIKE RIGHT ROUTE SOUTH STATE BOND ISSUE SOUTHEAST SECTION SQUARE FEET STATE ROUTE
POB POC POT P PR R RD REC ROW RR RRS RT RTE S SBI SE SEC SQ FT SR ST	POINT OF BEGINNING POINT OF COMMENCEMENT POINT ON TANGENT PROPERTY LINE PROPOSED RANGE ROAD RECORD RIGHT-OF-WAY RAILROAD SPIKE RIGHT ROUTE SOUTH STATE BOND ISSUE SOUTHEAST SECTION SQUARE FEET STATE ROUTE STREET
POB POC POT P PR R RD REC ROW RR RRS RT RTE S SBI SE SEC SQ FT SR ST STA SMK	POINT OF BEGINNING POINT OF COMMENCEMENT POINT ON TANGENT PROPERTY LINE PROPOSED RANGE ROAD RECORD RIGHT-OF-WAY RAILROAD SPIKE RIGHT ROUTE SOUTH STATE BOND ISSUE SOUTHEAST SECTION SQUARE FEET STATE ROUTE STREET STATION SURVEY MARKER
POB POC POT PL PR R RD REC ROW RR RRS RT RTE S SBI SE SEC SQ FT SR ST STA SMK SW	POINT OF BEGINNING POINT OF COMMENCEMENT POINT ON TANGENT PROPERTY LINE PROPOSED RANGE ROAD RECORD RIGHT-OF-WAY RAILROAD SPIKE RIGHT ROUTE SOUTH STATE BOND ISSUE SOUTHEAST SECTION SQUARE FEET STATE ROUTE STATE ROUTE STREET STATION SURVEY MARKER SOUTHWEST
POB POC POT P P R R R REC ROW RR RRS RT RTE S SBI SE SEC SQ FT SR ST STA SMK SW T	POINT OF BEGINNING POINT OF COMMENCEMENT POINT ON TANGENT PROPERTY LINE PROPOSED RANGE ROAD RECORD RIGHT-OF-WAY RAILROAD SPIKE RIGHT ROUTE SOUTH STATE BOND ISSUE SOUTHEAST SECTION SQUARE FEET STATE ROUTE STATE ROUTE STATE ROUTE STATE STATION SURVEY MARKER SOUTHWEST TOWNSHIP
POB POC POT PL PR R RD REC ROW RR RRS RT RTE S SBI SE SEC SQ FT SR ST STA SMK SW	POINT OF BEGINNING POINT OF COMMENCEMENT POINT ON TANGENT PROPERTY LINE PROPOSED RANGE ROAD RECORD RIGHT-OF-WAY RAILROAD SPIKE RIGHT ROUTE SOUTH STATE BOND ISSUE SOUTHEAST SECTION SQUARE FEET STATE ROUTE STATE ROUTE STREET STATION SURVEY MARKER SOUTHWEST
POB POC POT P P R R R REC ROW RR RRS RT RTE S SBI SE SEC SQ FT SR ST STA SMK SW T	POINT OF BEGINNING POINT OF COMMENCEMENT POINT ON TANGENT PROPERTY LINE PROPOSED RANGE ROAD RECORD RIGHT-OF-WAY RAILROAD SPIKE RIGHT ROUTE SOUTH STATE BOND ISSUE SOUTHEAST SECTION SQUARE FEET STATE ROUTE STATE ROUTE STATE ROUTE STATE STATION SURVEY MARKER SOUTHWEST TOWNSHIP

### TOPOGRAPHIC STATEMENT

THE TOPOGRAPHY SHOWN HEREON WAS PROVIDED TO THE SURVEYOR BY THE ILLINOIS DEPARTMENT OF TRANSPORTATION. THE SURVEYOR VISUALLY FIELD VERIFIED THE EXISTENCE OF THE TOPOGRAPHY SHOWN HEREON. IN ADDITION THE SURVEYOR PHYSICALLY LOCATED IN THE FIELD THE FOLLOWING ITEMS ON 06/30/23:

- 1. BUILDINGS
- 2. SIDEWALK
- 3. COMMERICAL SIGNS

### TOTAL HOLDING AREA SOURCE TABLE

7 AREA ACCORDING TO OTHER RECORDS, SEE NOTE ON THE PLAT OF HIGHWAYS

	TOTAL HOLDING AREA GOORGE TABLE
1	AREA ACCORDING TO THE SURVEY PERFORMED BY THE CONSULTANT.
2	AREA LISTED IN RECORDED DEED.
3	AREA ACCORDING TO A RECORDED SUBDIVISION PLAT.
4	AREA ACCORDING TO A PLAT OF SURVEY.
5	AREA CALCULATED FROM RECORDED DEEDS OR TITLE COMMITMENTS - NOT SURVEYED.
6	AREA ACCORDING TO COUNTY TAX MAPS AND COUNTY ASSESSMENT RECORDS.

### RECEIVED: 11-30-23

SPACE RESERVED FOR RECORDING OFFICER

### PROPOSED PARCEL NUMBER LEGEND



PROPOSED FEE SIMPLE ACQUISITION PROPOSED PERMANENT EASEMENT PROPOSED TEMPORARY EASEMENT PROPOSED DEDICATION PROPOSED ACCESS CONTROL LINE

### **CURVE ABBREVIATIONS**

PC	POINT OF CURVATURE
PI	POINT OF INTERSECTION
PT	POINT OF TANGENCY
PRC	POINT OF REVERSE CURVE
PCC	POINT OF COMPOUND CURVE
R	RADIUS OF CURVE
L	LENGTH OF CURVE
CB	CHORD BEARING
С	CHORD LENGTH
D	DEGREE OF CURVE
E	EXTERNAL ORDINATE
7	CENTRAL ANGLE


### ILLINOIS DEPARTMENT OF TRANSPORTATION PLAT OF HIGHWAYS


FAS 2701 (IL 37) SECTION (105,106)RS-3 MARION COUNTY JOB NO. R-98-007-23 STATION 28+98.68 TO STATION 48+66.07


& STATION 305+48.67 TO STATION 313+57.42

ILLINOIS DEPARTMENT OF TRANSPORTATION OFFICE OF HIGHWAYS PROJECT IMPLEMENTATION/REGION 5/DISTRICT 8 1102 EASTPORT PLAZA DRIVE COLLINSVILLE, ILLINOIS 62234-6198


F.A.S. RTE	SECTION		-	COUNTY	TOTAL SHEETS	SHEET NO.
2701	(105,106)RS-3	3	N	MARION	68	59
·				CONTRA	CT NO.	76L11
FED. ROAD DIST. NO. ILLINOIS		FED. AID PROJECT				

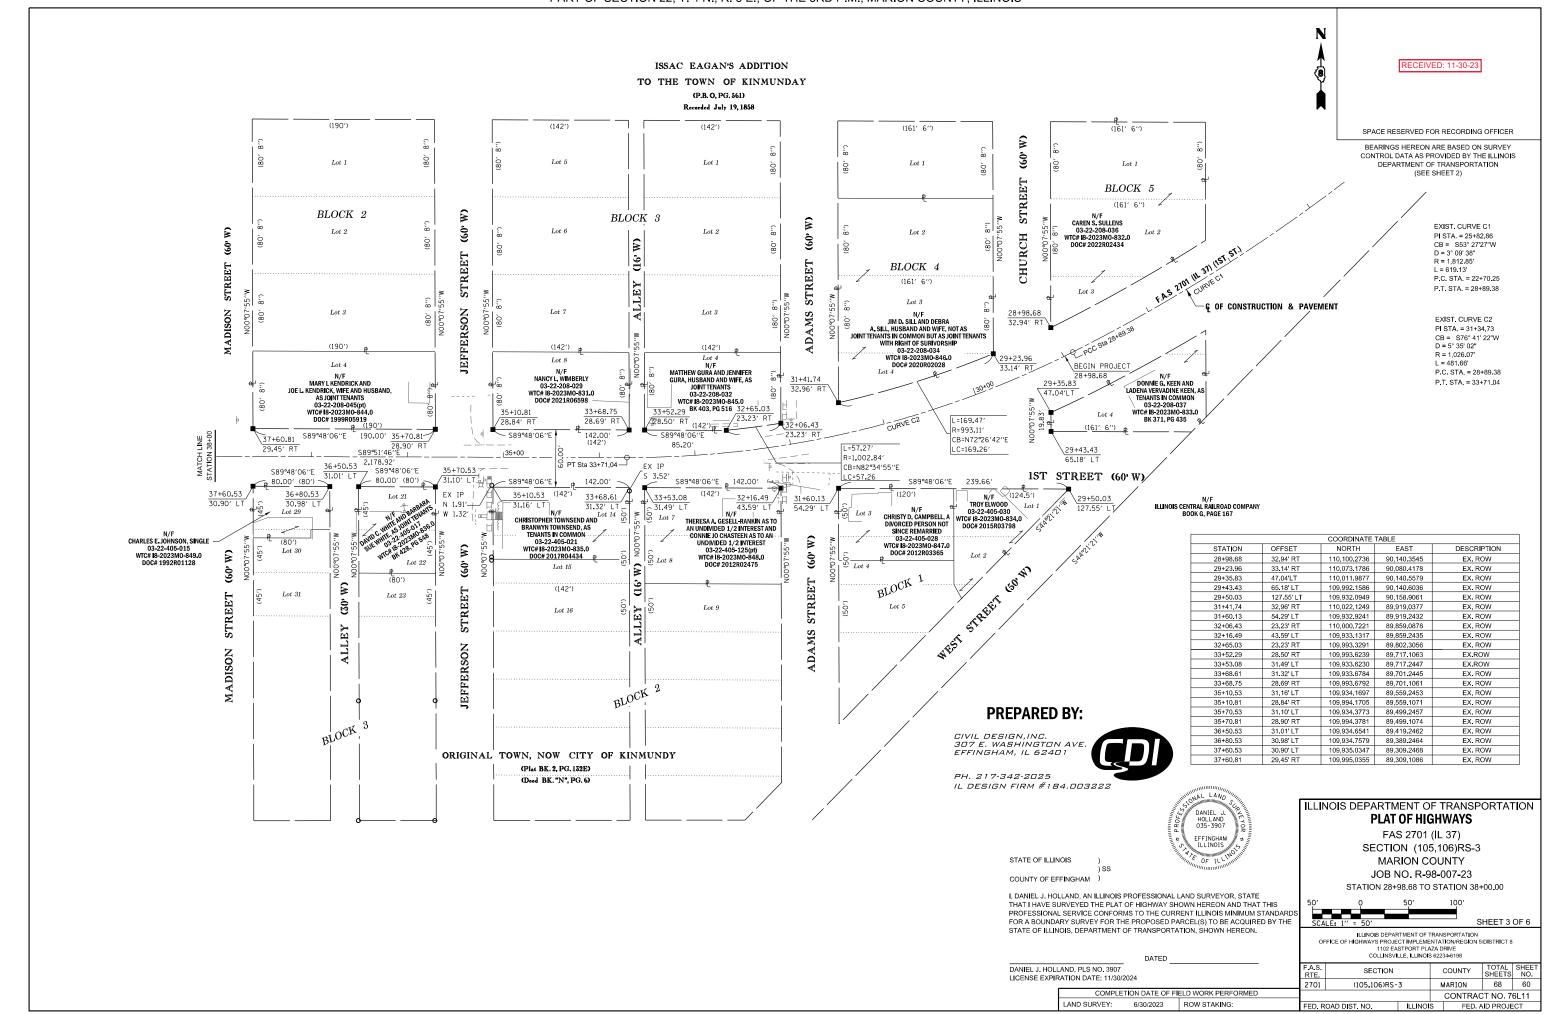


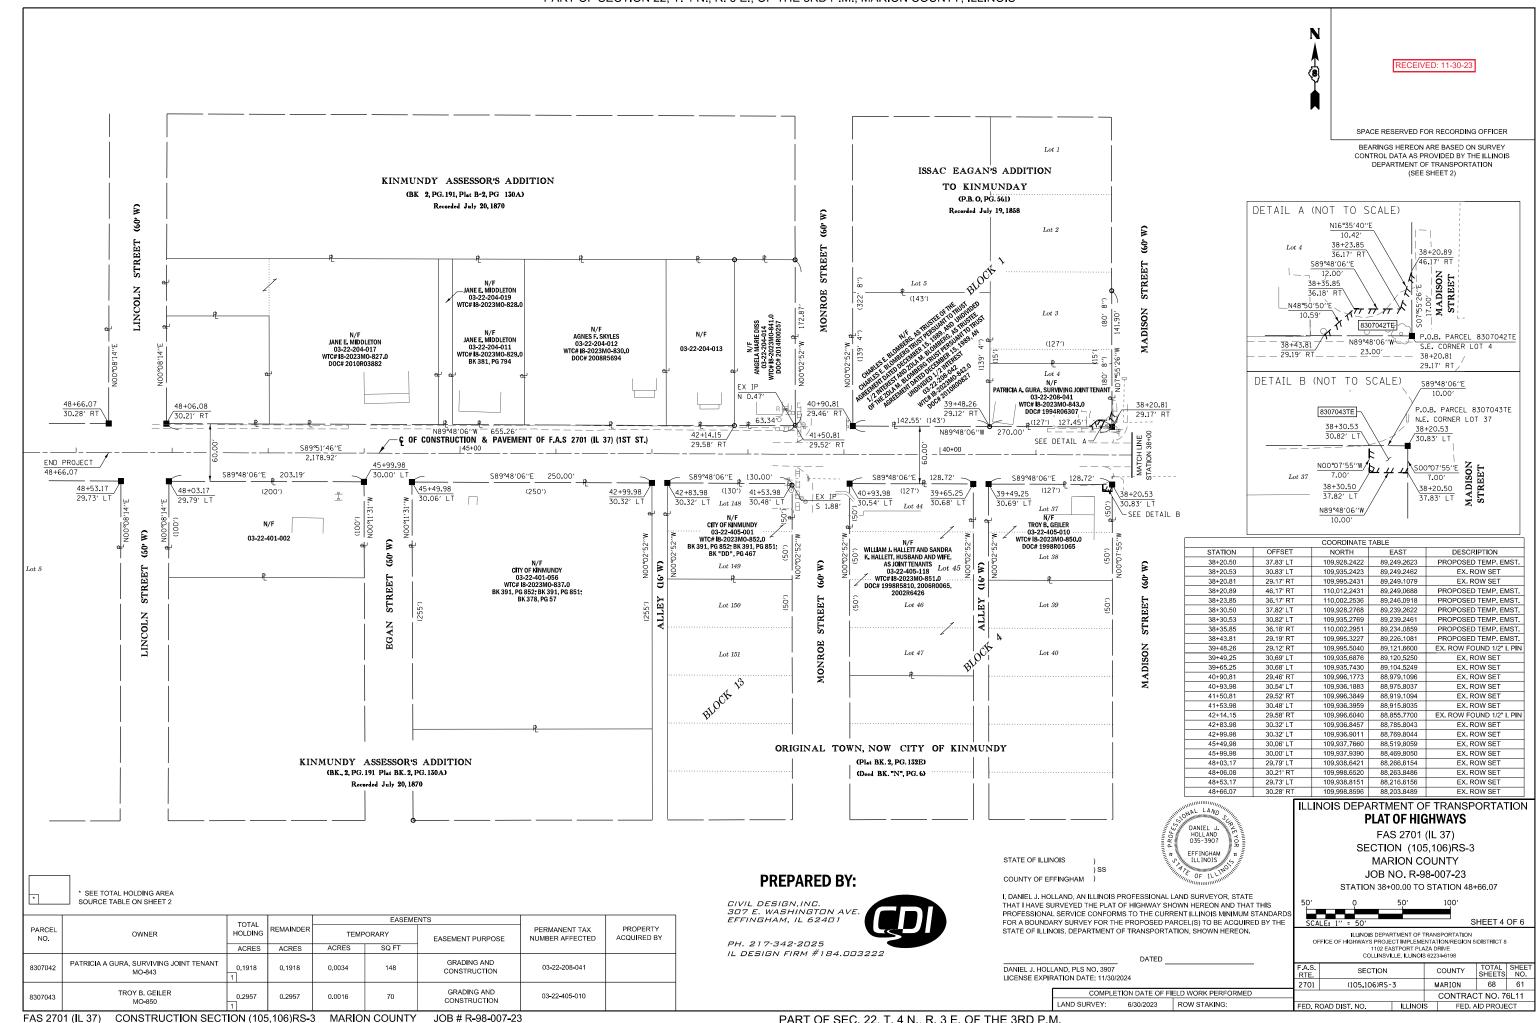

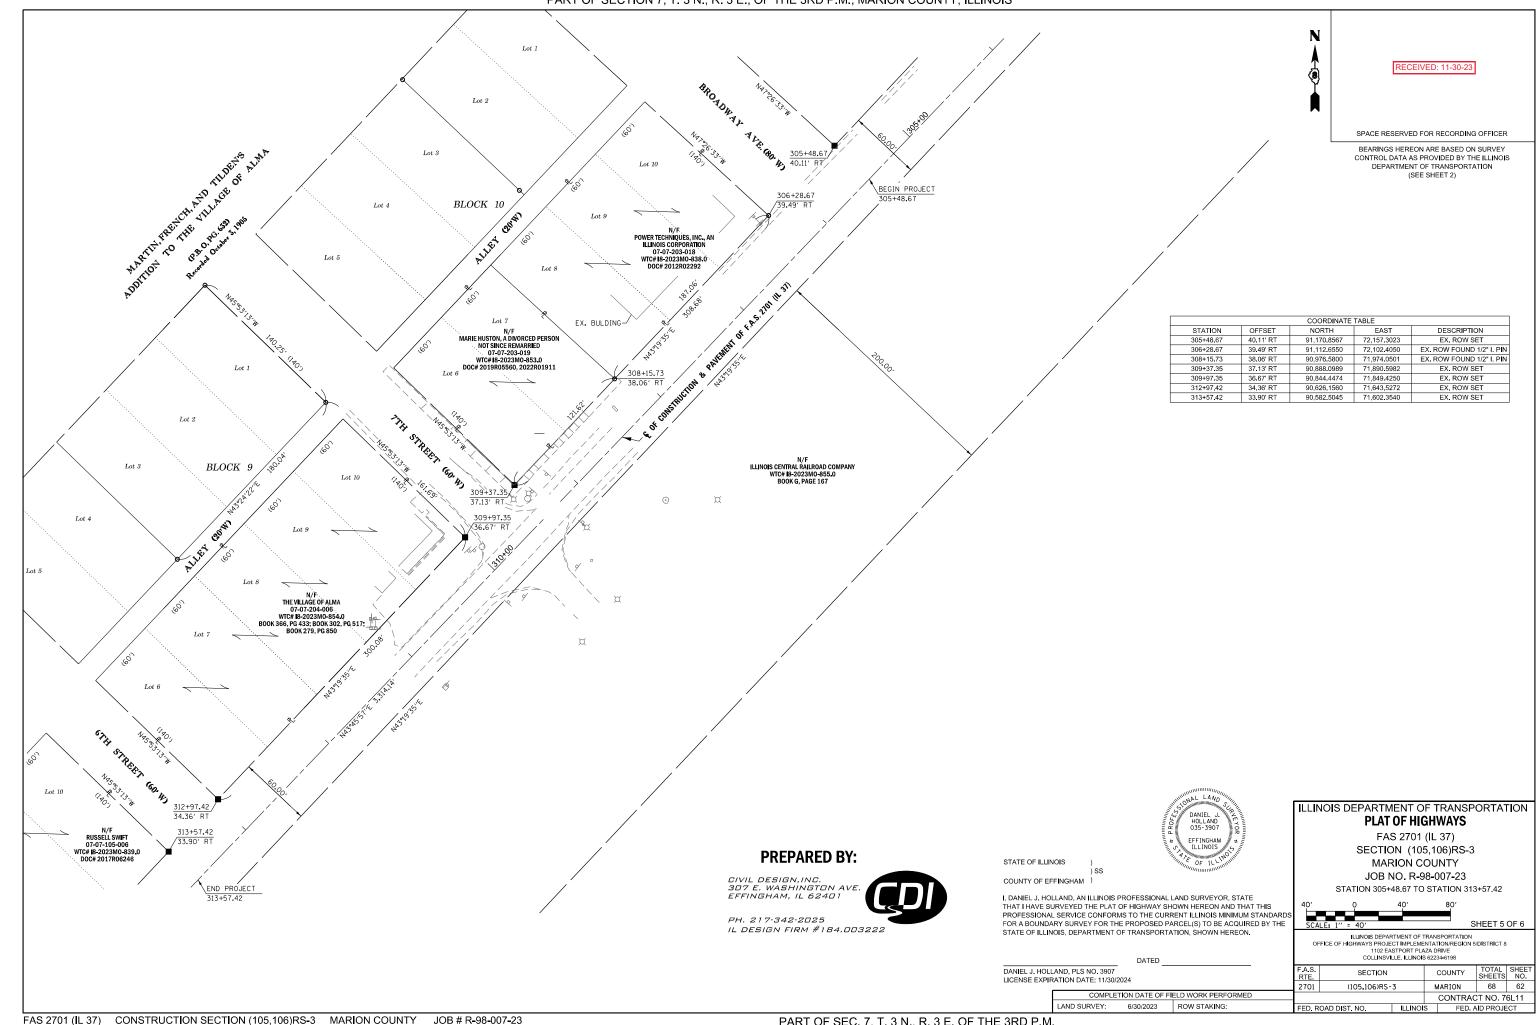

### CONTROL TIE SHEET

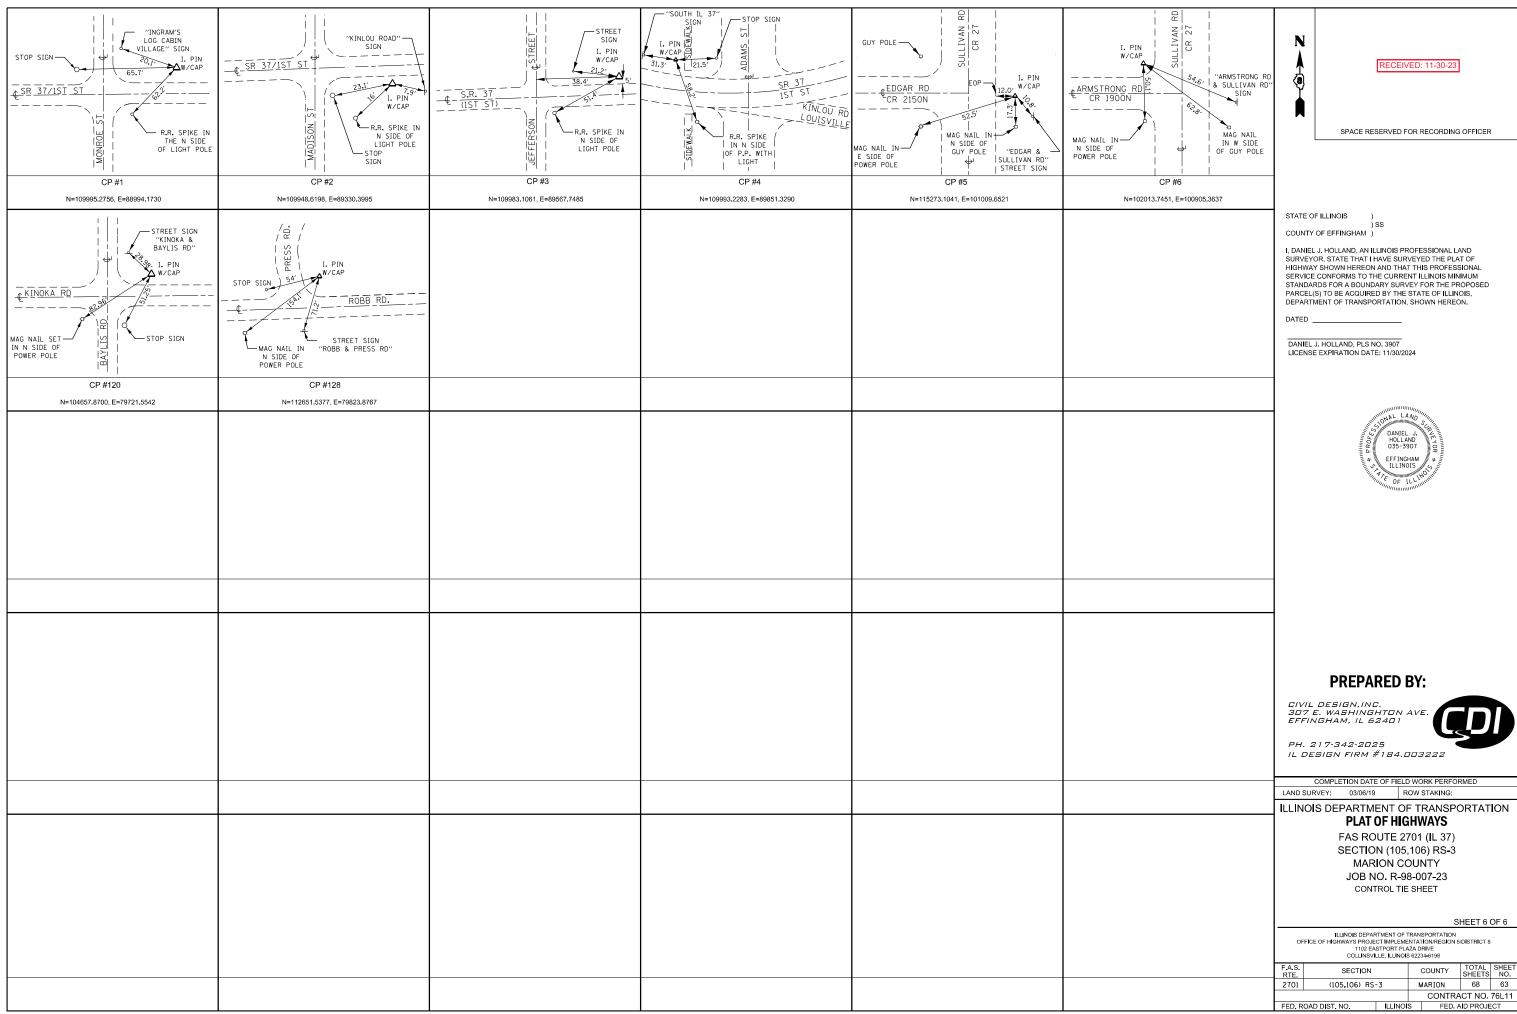

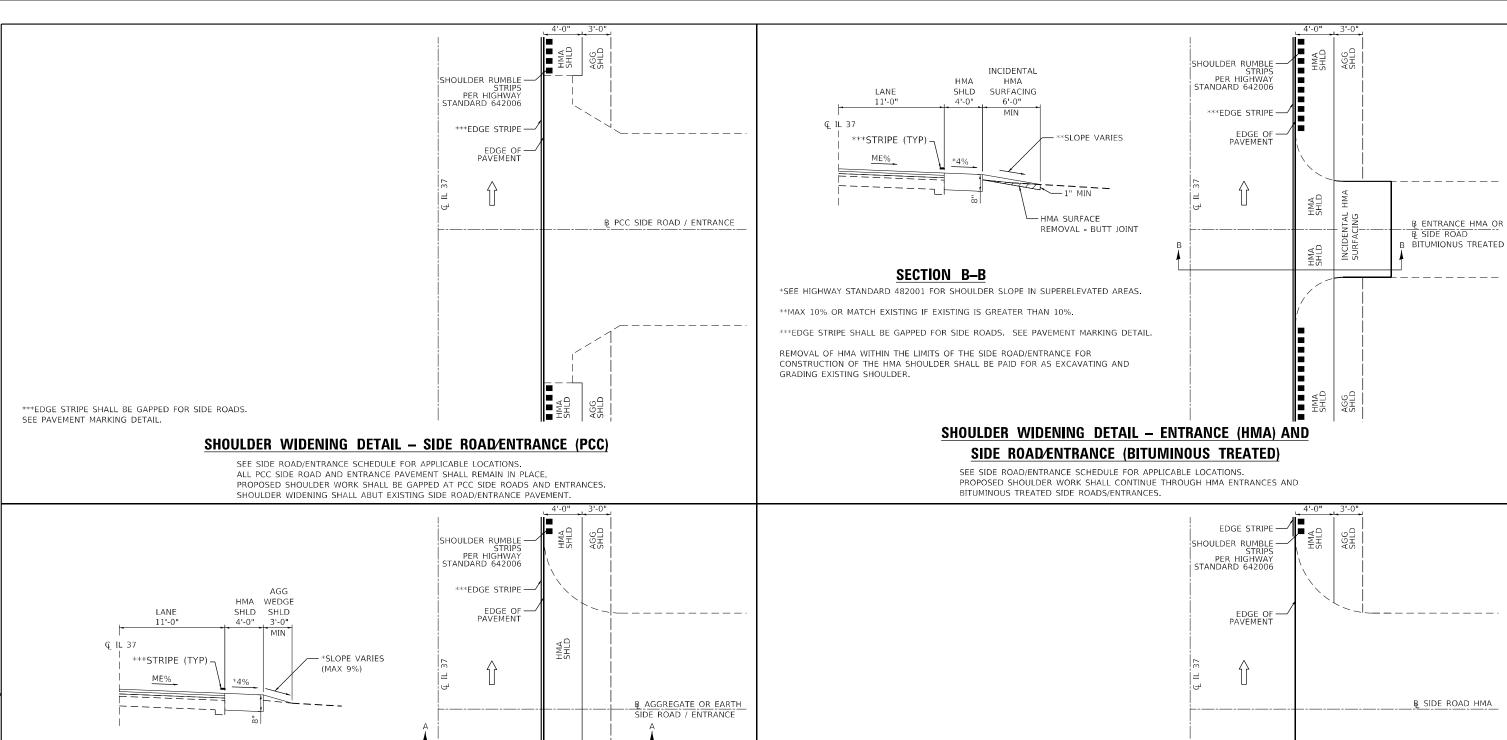

### SECTION A-A

whks

\*SEE HIGHWAY STANDARD 482001 FOR SHOULDER SLOPE IN SUPERELEVATED AREAS.

\*\*\*EDGE STRIPE SHALL BE GAPPED FOR SIDE ROADS. SEE PAVEMENT MARKING DETAIL.

REMOVAL OF AGGREGATE OR EARTH WITHIN THE LIMITS OF THE SIDE ROAD/ENTRANCE FOR CONSTRUCTION OF THE HMA SHOULDER SHALL BE PAID FOR AS EXCAVATING AND GRADING EXISTING SHOULDER.

PLOT DATE = 12/6/2023

## SHOULDER WIDENING DETAIL -

SEE SIDE ROAD/ENTRANCE SCHEDULE FOR APPLICABLE LOCATIONS. PROPOSED SHOULDER WIDENING SHALL CONTINUE THROUGH

BJJ

12/6/2023

REVISED

REVISED

## SIDE ROAD/ENTRANCE (AGGREGATE OR EARTH)

AGGEGATE OR EARTH SIDE ROADS/ENTRANCES DESIGNED REVISED DRAWN GSJ REVISED

HECKED

DATE

### STATE OF ILLINOIS **DEPARTMENT OF TRANSPORTATION**

DETAILS		SECTION	COUNTY	TOTAL
FAS ROUTE 2701 /FAU 8565 (JL 37) RESURFACING	*	(105, 106) RS-3	MARION	68
TAS HOUTE 2701/TAG 0303 (IE 37) HESOHI AGINA			CONTRACT	Γ NO.76
SCALE: 1" = 5'   SHEET 1 OF 5 SHEETS   STA. TO ST	Α.	ILLINOIS FEE	AID PROJECT	

SHOULDER WIDENING DETAIL - SIDE ROAD (HMA)

PROPOSED SHOULDER WIDENING WORK SHALL BE GAPPED AT HMA SIDE ROADS.


SEE SIDE ROAD/ENTRANCE SCHEDULE FOR APPLICABLE LOCATIONS.


SHOULDER WIDENING SHALL ABUT EXISTING SIDE ROAD PAVEMENT.


₿ ENTRANCE HMA OR


₽ SIDE ROAD HMA

B SIDE ROAD

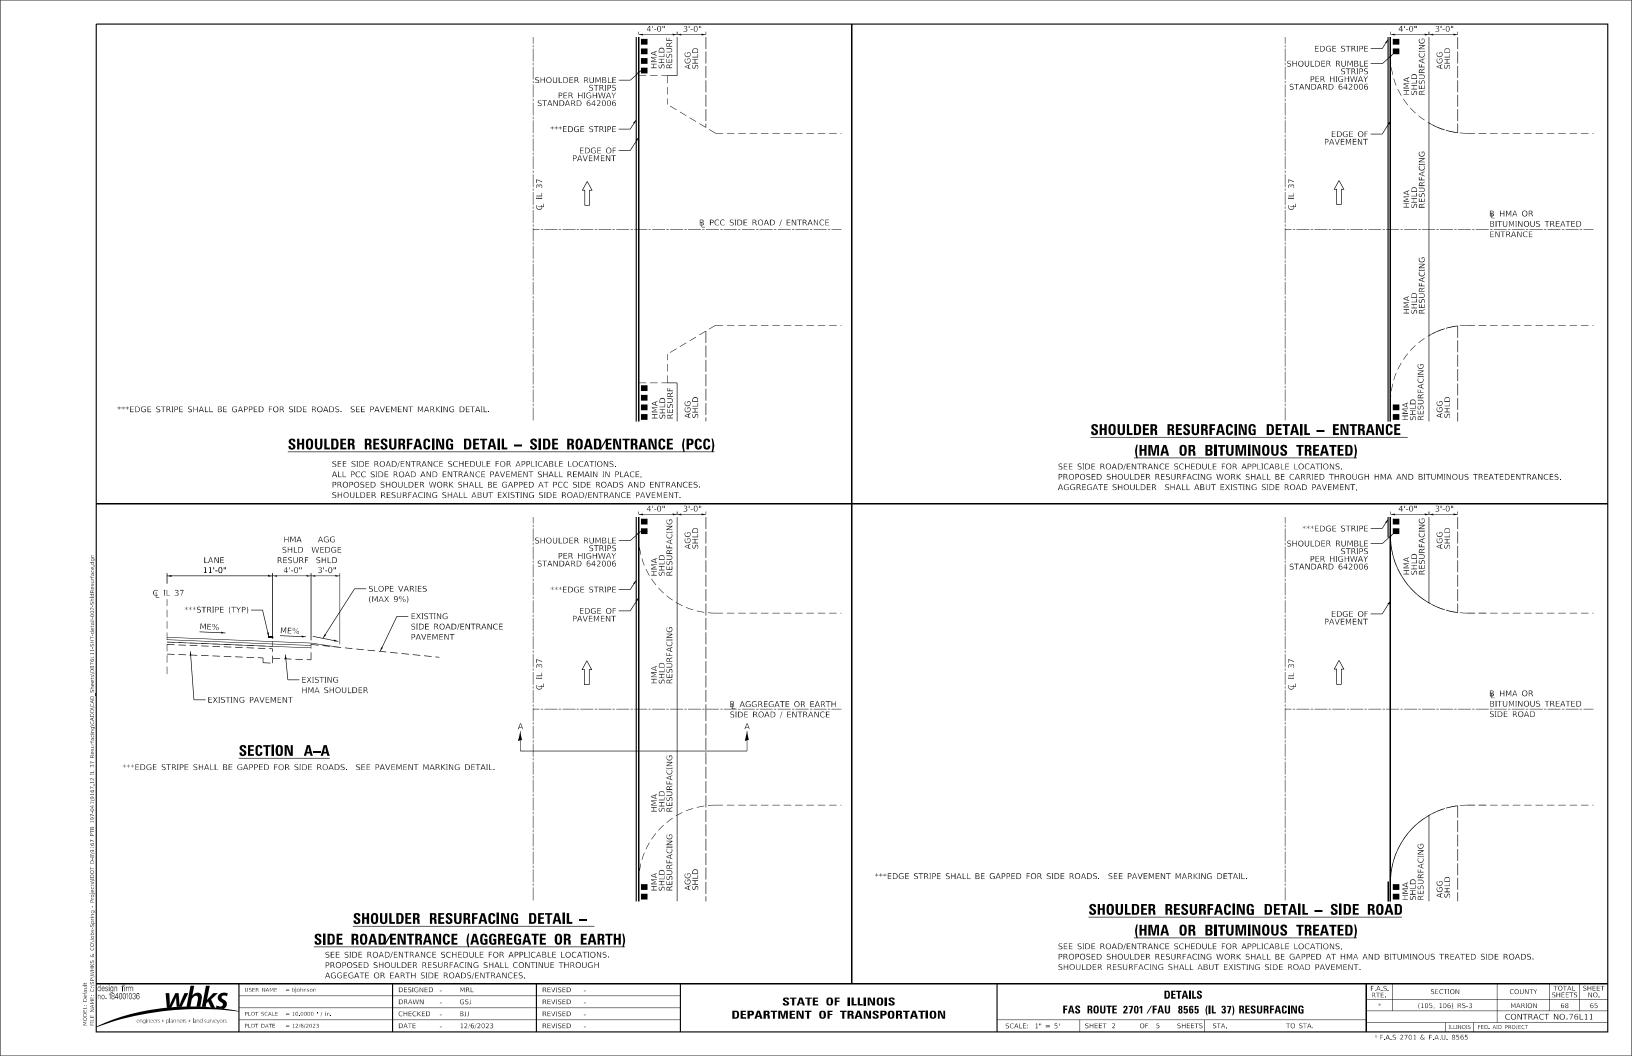

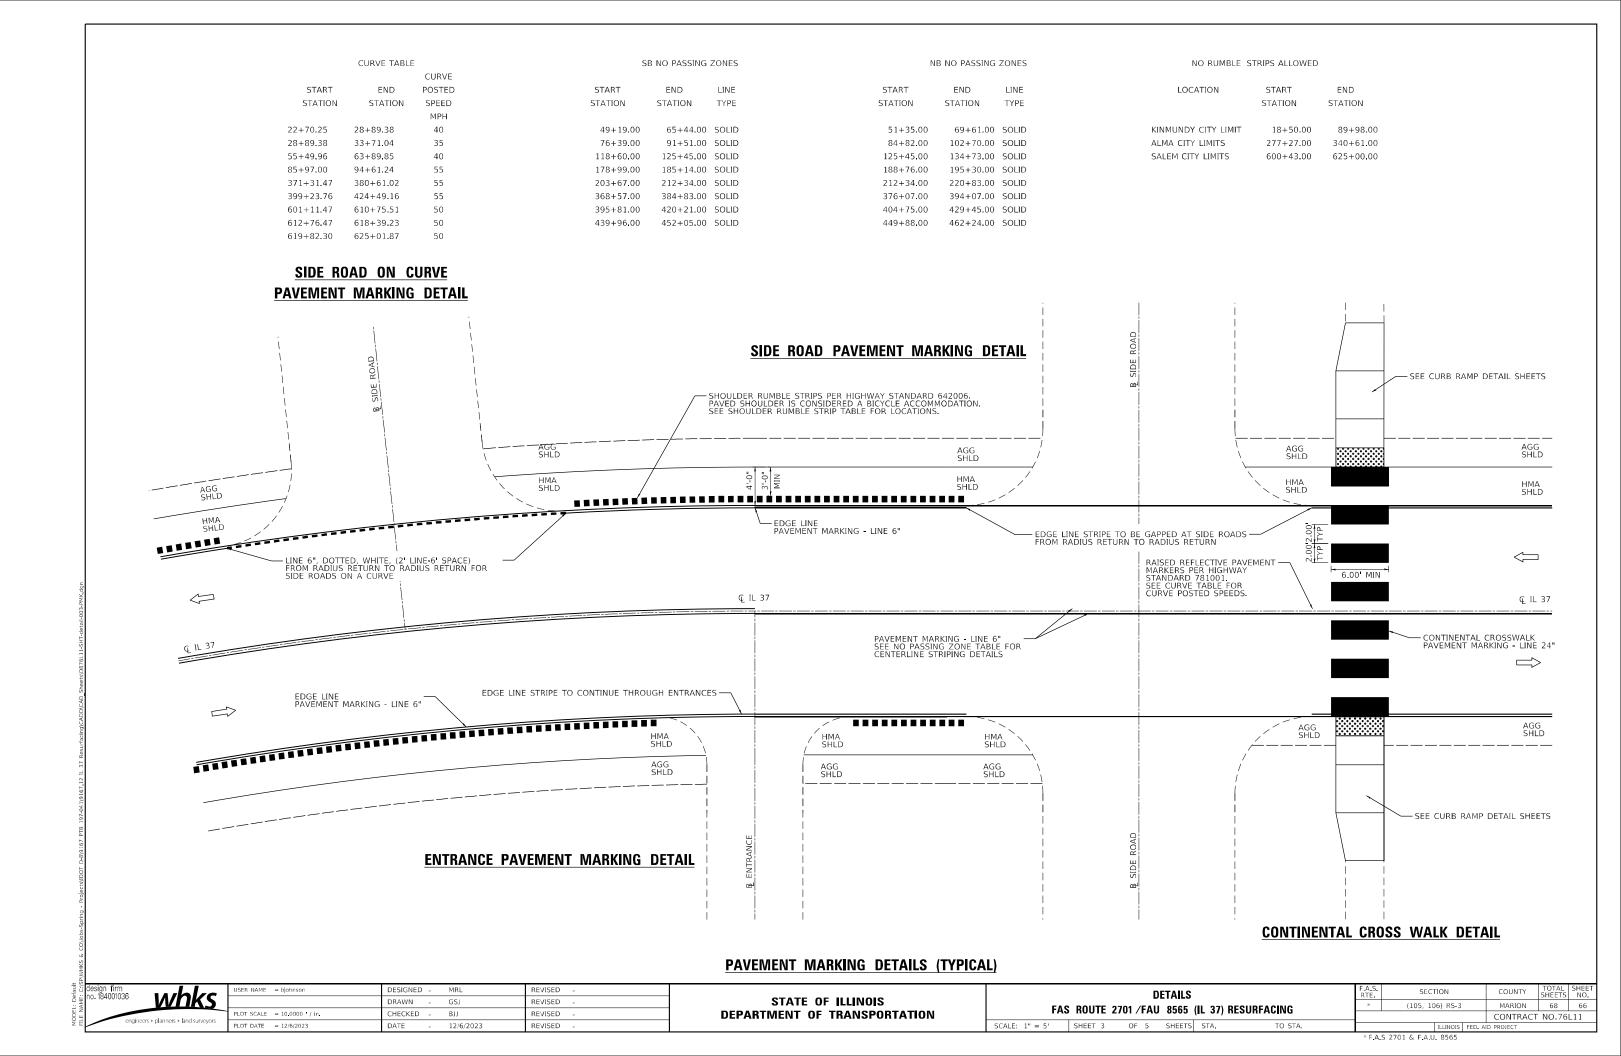

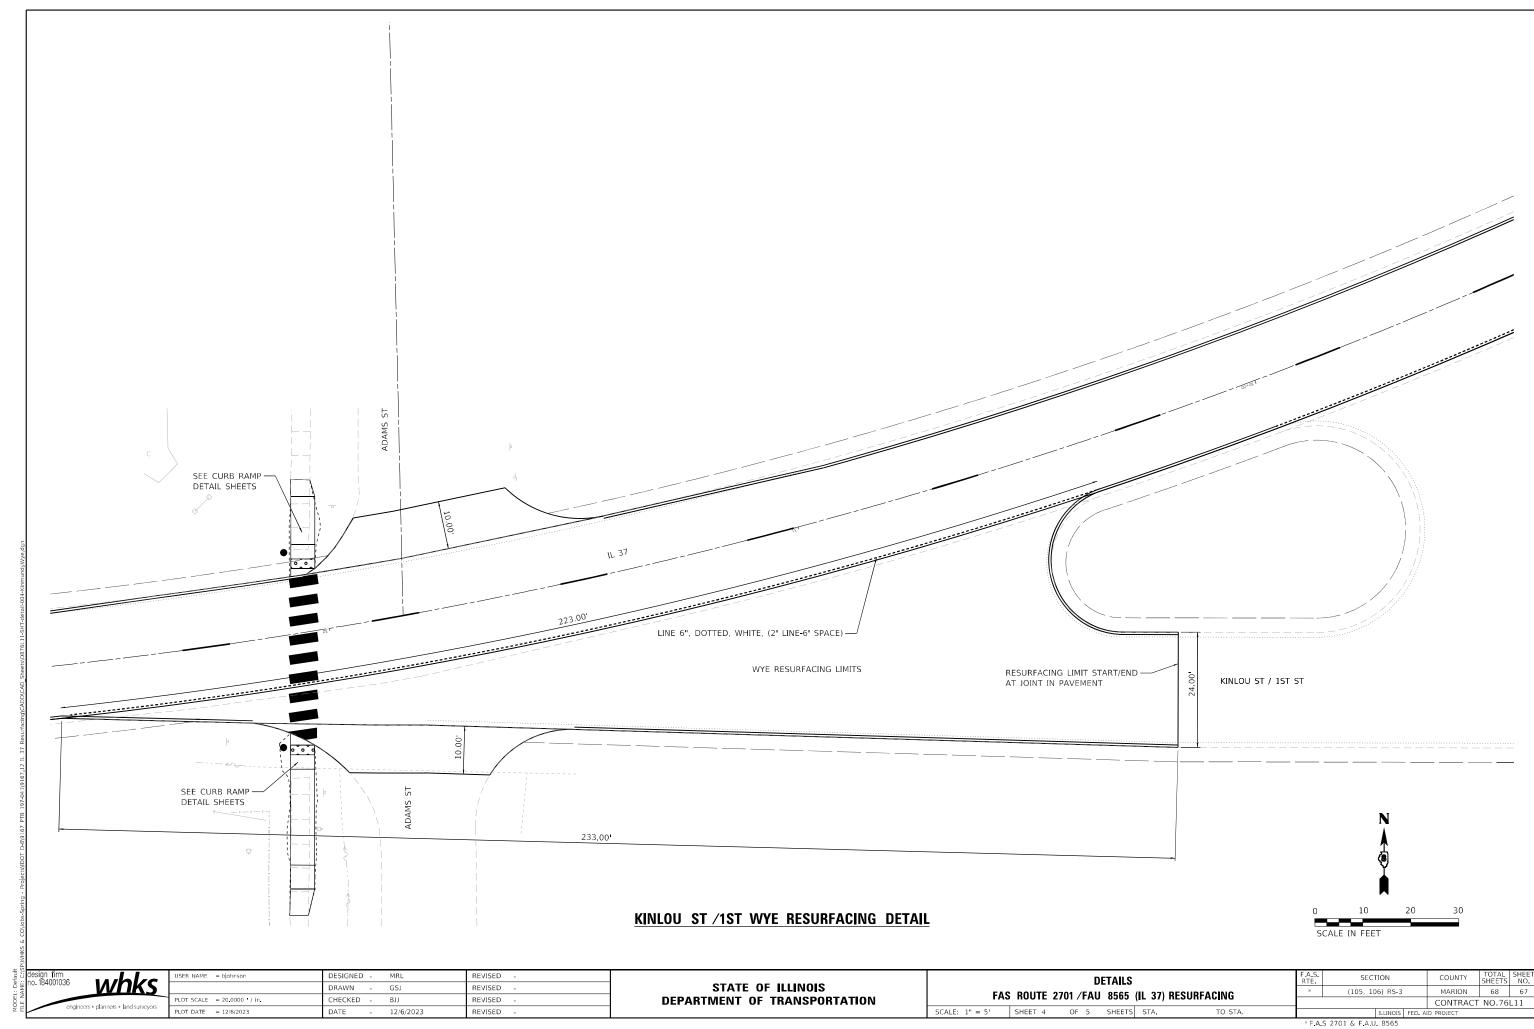

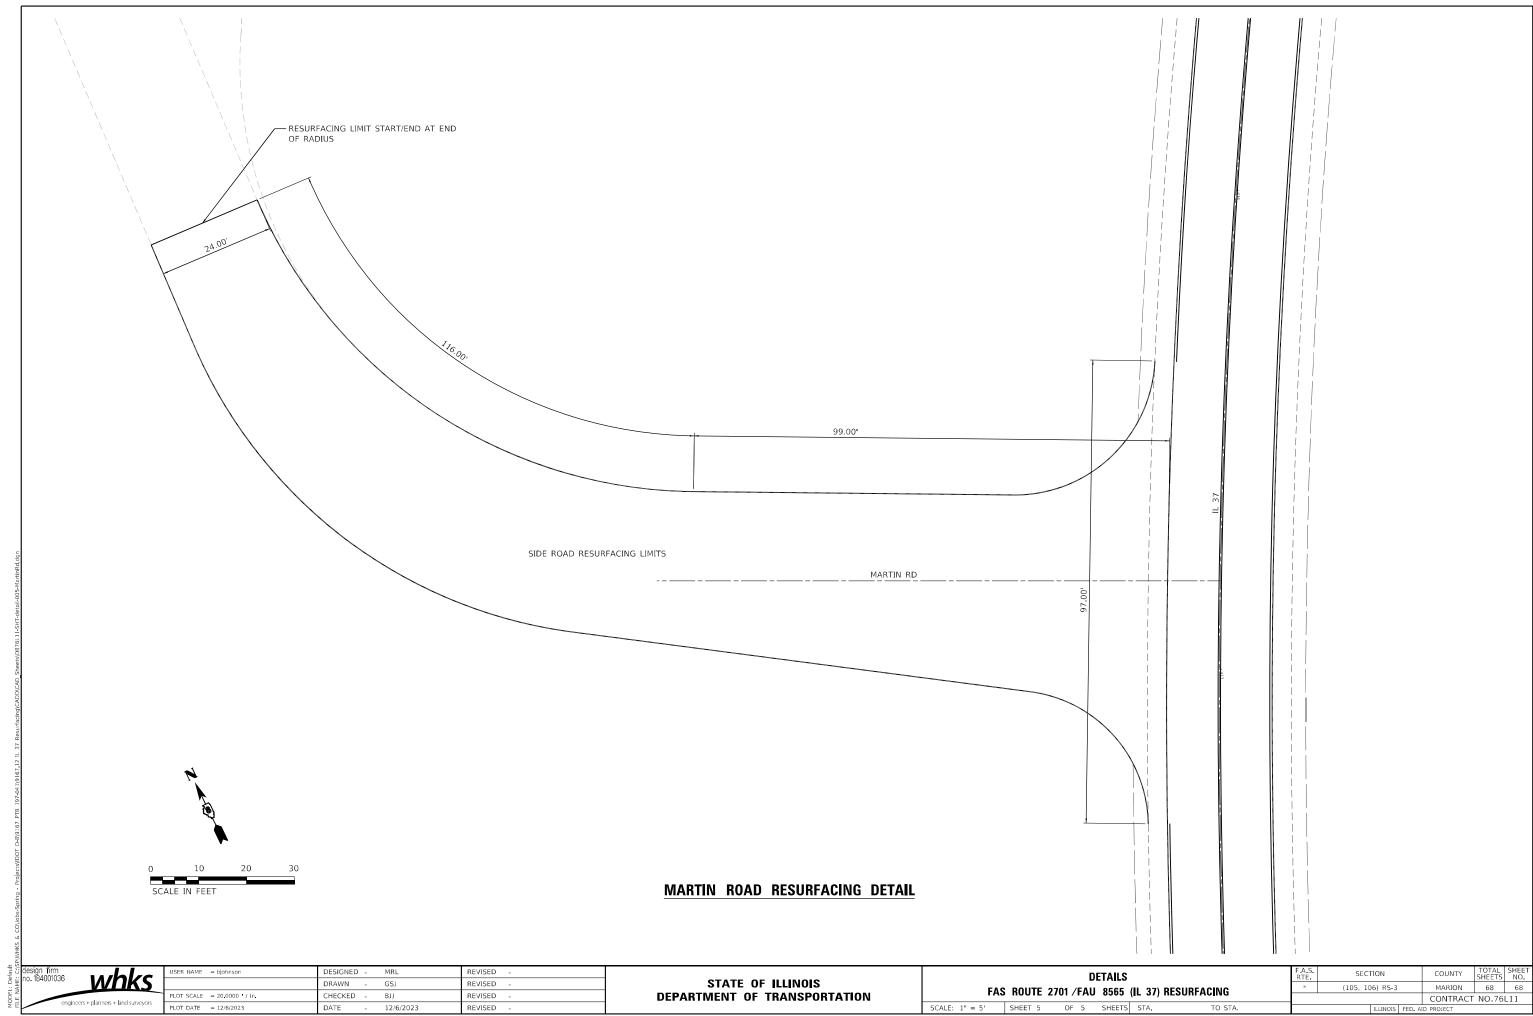

\* F.A.S 2701 & F.A.U. 8565