
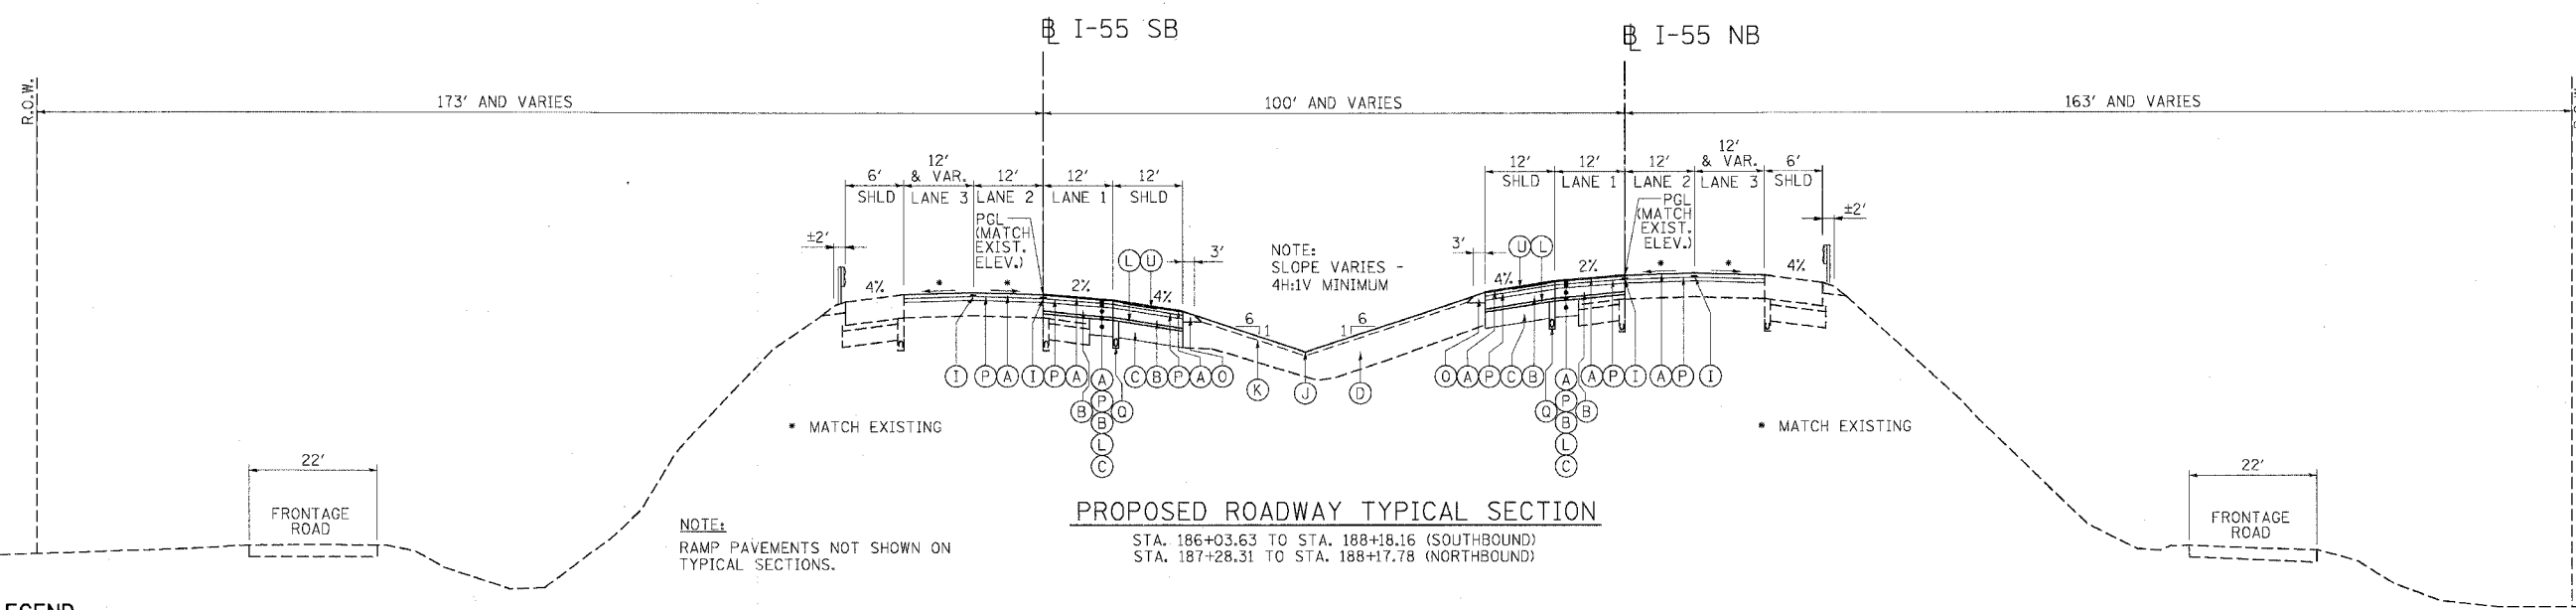


F.A.I. RTE.	SECTION	COUNTY	TOTAL SHEETS	SHEET NO.
55	99 (1&2) WRS	WILL	334	9
STA.		TO STA.		
FED. ROAD DIST. NO.		ILLINOIS FED. AID PROJECT		

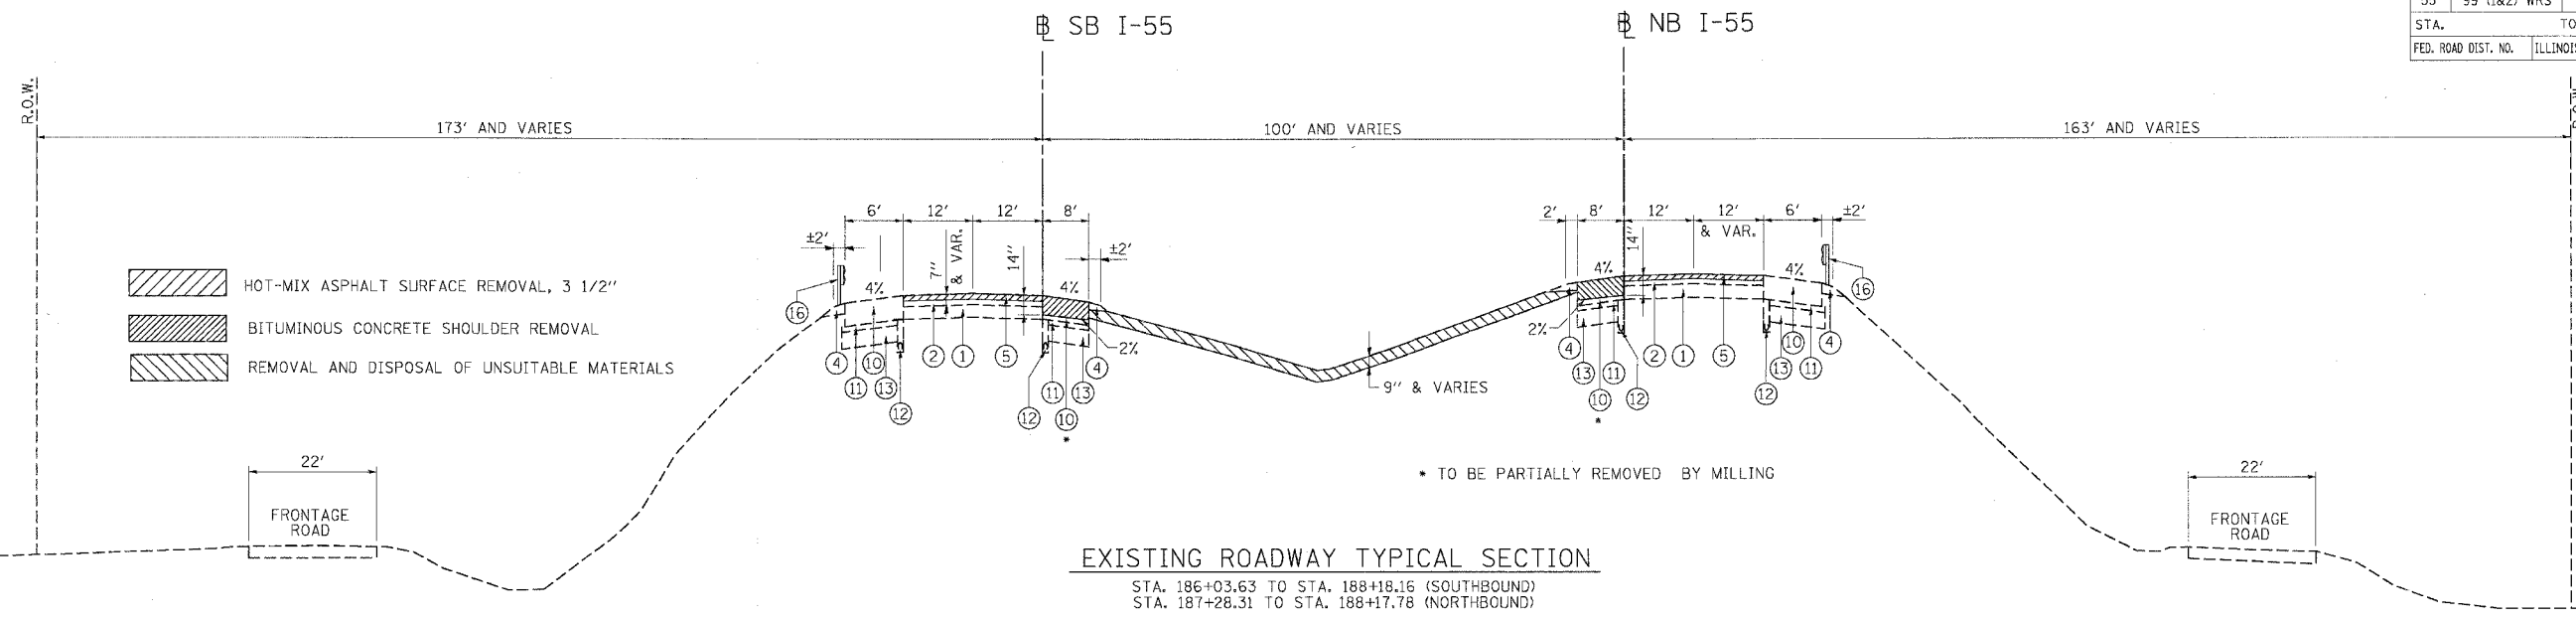

EXISTING LEGEND

- ① P.C.C. PAVEMENT, 10"
- ② BITUMINOUS RESURFACING 7"
- ③ BITUMINOUS SHOULDER 10" (NOT USED)
- ④ AGGREGATE SHOULDER
- ⑤ HOT-MIX ASPHALT SURFACE REMOVAL, 3 1/2"
- ⑥ NOT USED
- ⑦ HOT-MIX ASPHALT SURFACE REMOVAL, VARIABLE DEPTH
- ⑧ POLYMERIZED BITUMINOUS CONCRETE SURFACE COURSE, SUPERPAVE, IL-19, N90 2" (NOT USED)
- ⑨ BITUMINOUS CONCRETE BINDER COURSE, SUPERPAVE, IL-19, N90, 15" (NOT USED)
- ⑩ BITUMINOUS SHOULDERS, SUPERPAVE, 17"
- ⑪ STABILIZED SUB-BASE 4"
- ⑫ PIPE UNDERDRAINS 6"
- ⑬ AGGREGATE SUBGRADE 12"
- ⑭ NOT USED
- ⑮ BITUMINOUS SHOULDER (NOT USED)
- ⑯ SPBGR (SEE PLANS FOR LOCATIONS)

PROPOSED LEGEND

- (A) POLYMERIZED HOT-MIX ASPHALT SURFACE COURSE, STONE MATRIX ASPHALT, N80; 1 3/4"
- (B) HOT-MIX ASPHALT BASE COURSE, 8"
- (C) AGGREGATE SUBGRADE, 12"
- (D) EMBANKMENT
- (E) CONCRETE BARRIER, DOUBLE FACE, 42" HEIGHT (NOT USED)
- (F) BARRIER BASE (NOT USED)
- (G) TRENCH BACKFILL (NOT USED)
- (H) STORM SEWER (NOT USED)
- (I) STRIP REFLECTIVE CRACK CONTROL TREATMENT
- (J) TOPSOIL FURNISH AND PLACE, 6"
- (K) SEEDING, CLASS 2A
- (L) HOT-MIX ASPHALT BASE COURSE, 2 1/2"
- (M) NOT USED
- (N) NOT USED
- (O) AGGREGATE SHOULDERS, TYPE B, 8"
- (P) POLYMERIZED HOT-MIX ASPHALT BINDER COURSE, STONE MATRIX ASPHALT, N80; 1 3/4"
- (Q) PIPE UNDERDRAINS 6" (SEE DRAINAGE PLANS FOR LOCATIONS)
- (R) NOT USED
- (S) HOT-MIX ASPHALT SURFACE COURSE, MIX "D", N 70; 1 3/4" (NOT USED)
- (T) AGGREGATE SHOULDERS, TYPE B (SPECIAL) (NOT USED)
- (U) SHOULDER RUMBLE STRIP

REVISIONS	
NAME	DATE

ILLINOIS DEPARTMENT OF TRANSPORTATION
 FAI ROUTE 55 (I-80 TO BLACK ROAD)
 WIDENING AND RESURFACING

TYPICAL SECTIONS
 STA. 186+03.63 TO STA. 188+18.16 SB
 STA. 187+28.31 TO STA. 188+17.78 NB

SCALE: N.T.S. DATE: 02/23/07
 DRAWN BY: AG/GF CHECKED BY: DDH

TENG TENG & ASSOCIATES, INC.
 ENGINEERS/ARCHITECTS/PLANNERS
 CHICAGO, ILLINOIS

PLOT DATE = 02/23/07
 FILE NAME = 022307.DWG
 PLOT SCALE = 1/8"=1'-0"
 USER NAME = JLS/RSB