
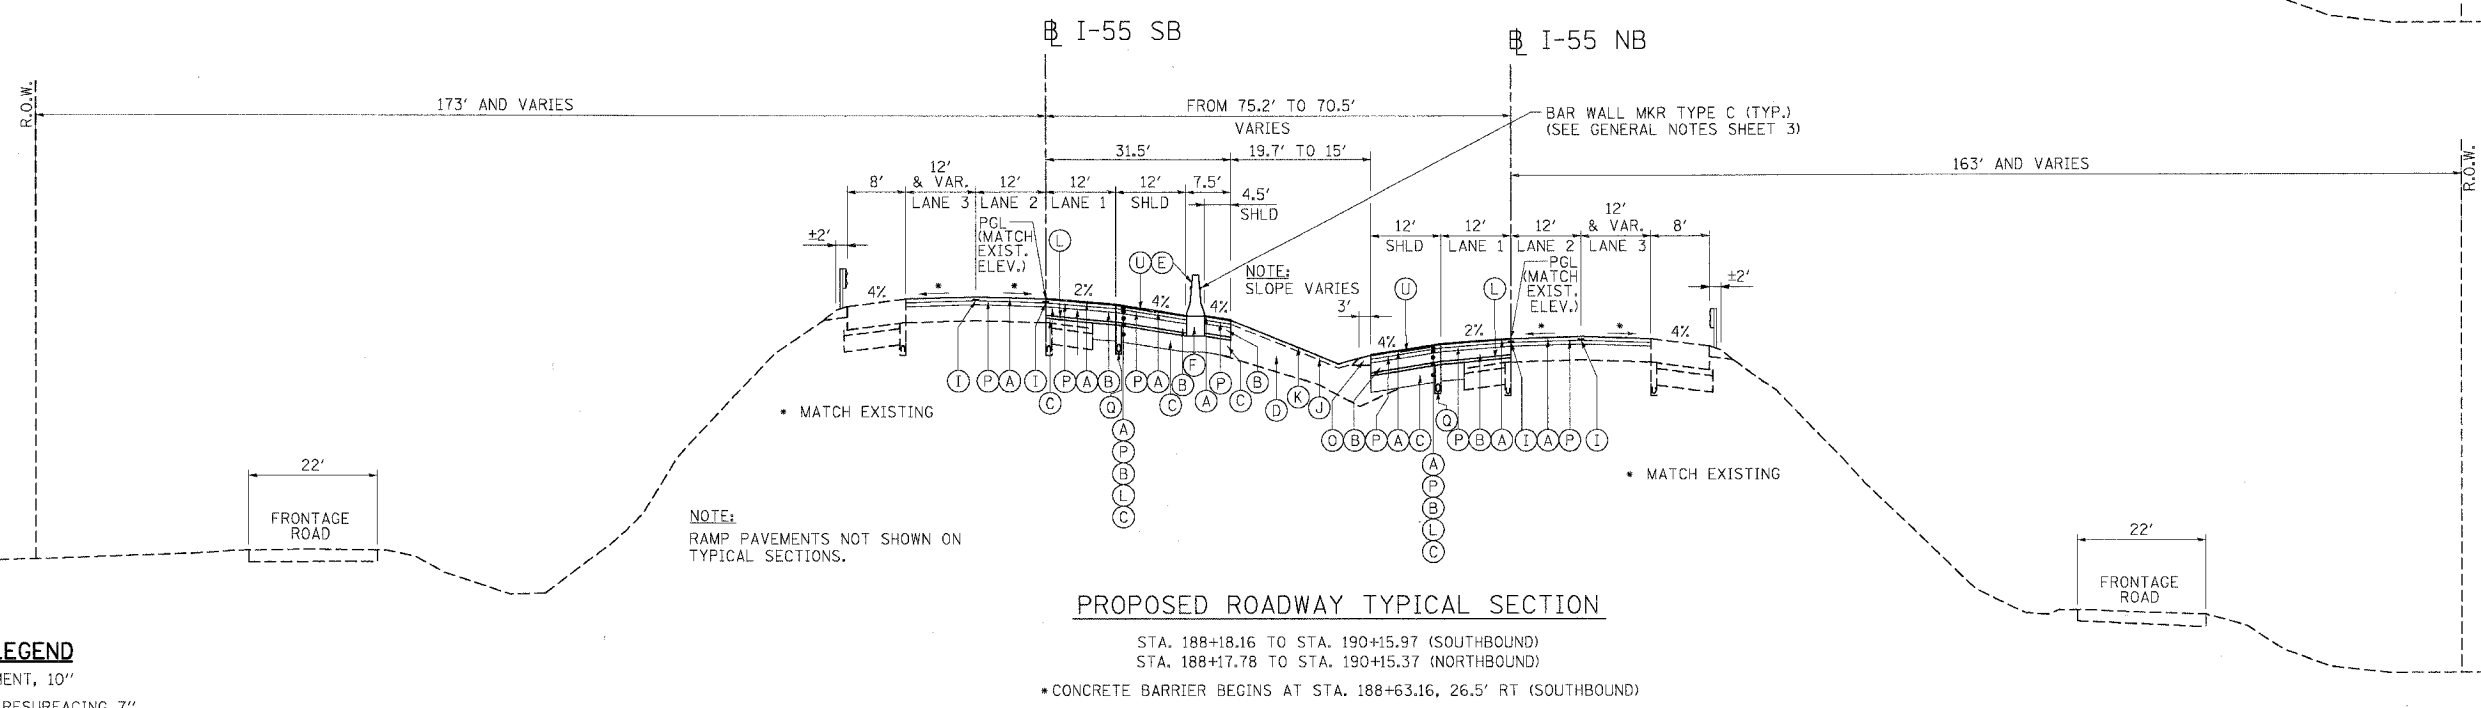


F.A.I. RTE.	SECTION	COUNTY	TOTAL SHEET NO.
55	99 (1&2) WRS	WILL	334
STA.		TO STA.	
FED. ROAD DIST. NO.		ILLINOIS FED. AID PROJECT	

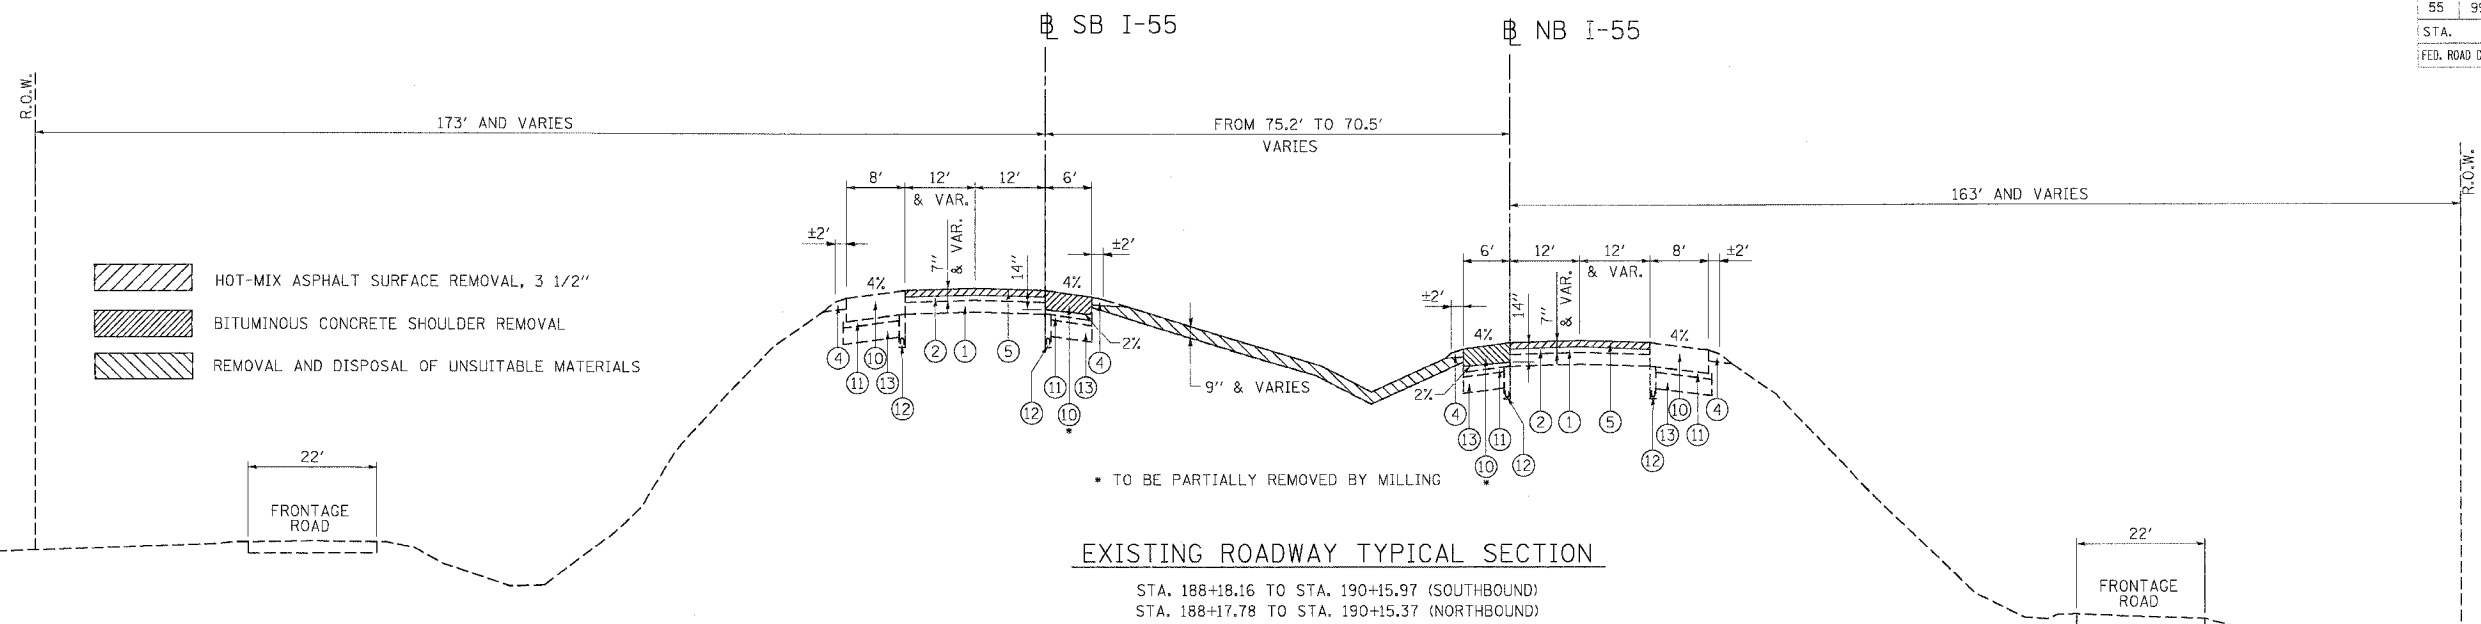

**EXISTING LEGEND**

- ① P.C.C. PAVEMENT, 10"
- ② BITUMINOUS RESURFACING 7"
- ③ BITUMINOUS SHOULDER 10" (NOT USED)
- ④ AGGREGATE SHOULDER
- ⑤ HOT-MIX ASPHALT SURFACE REMOVAL, 3 1/2"
- ⑥ NOT USED
- ⑦ HOT-MIX ASPHALT SURFACE REMOVAL, VARIABLE DEPTH
- ⑧ POLYMERIZED BITUMINOUS CONCRETE SURFACE COURSE, SUPERPAVE, IL-19, N90 2" (NOT USED)
- ⑨ BITUMINOUS CONCRETE BINDER COURSE, SUPERPAVE, IL-19, N90, 15" (NOT USED)
- ⑩ BITUMINOUS SHOULDERS, SUPERPAVE, 17"
- ⑪ STABILIZED SUB-BASE 4"
- ⑫ PIPE UNDERDRAINS 6"
- ⑬ AGGREGATE SUBGRADE 12"
- ⑭ NOT USED
- ⑮ BITUMINOUS SHOULDER (NOT USED)
- ⑯ SPBGR (SEE PLANS FOR LOCATIONS) (NOT USED)

**PROPOSED LEGEND**

- Ⓐ POLYMERIZED HOT-MIX ASPHALT SURFACE COURSE, STONE MATRIX ASPHALT, N80; 1 3/4"
- Ⓑ HOT-MIX ASPHALT BASE COURSE, 8"
- Ⓒ AGGREGATE SUBGRADE, 12"
- Ⓓ EMBANKMENT
- Ⓔ CONCRETE BARRIER, DOUBLE FACE, 42" HEIGHT
- Ⓕ BARRIER BASE
- Ⓖ TRENCH BACKFILL (NOT USED)
- Ⓗ STORM SEWER (NOT USED)
- Ⓘ STRIP REFLECTIVE CRACK CONTROL TREATMENT
- Ⓚ SEEDING, CLASS 2A
- Ⓛ HOT-MIX ASPHALT BASE COURSE, 2 1/2"
- Ⓜ NOT USED
- Ⓝ NOT USED
- Ⓞ AGGREGATE SHOULDERS, TYPE B, 8"
- Ⓟ POLYMERIZED HOT-MIX ASPHALT BINDER COURSE, STONE MATRIX ASPHALT, N80; 1 3/4"
- Ⓠ PIPE UNDERDRAINS 6" (SEE DRAINAGE PLANS FOR LOCATIONS)
- Ⓡ NOT USED
- Ⓢ HOT-MIX ASPHALT SURFACE COURSE, MIX "D", N 70; 1 3/4" (NOT USED)
- Ⓣ AGGREGATE SHOULDERS, TYPE B (SPECIAL) (NOT USED)
- Ⓤ SHOULDER RUMBLE STRIP

PLOT DATE = 02/23/07  
 FILE NAME = #SCALE#  
 PLOT SCALE = #SCALE#  
 USER NAME = #USER#

REVISIONS	
NAME	DATE

ILLINOIS DEPARTMENT OF TRANSPORTATION  
 FAI ROUTE 55 (I-80 TO BLACK ROAD)  
 WIDENING AND RESURFACING

**TYPICAL SECTIONS**  
**STA. 188+18.16 TO STA. 190+15.97 SB**  
**STA. 188+17.78 TO STA. 190+15.37 NB**

SCALE: N.T.S. DRAWN BY AG/GF  
 DATE 02/23/07 CHECKED BY DDH

**TENG** TENG & ASSOCIATES, INC.  
 ENGINEERS/ARCHITECTS/PLANNERS  
 CHICAGO, ILLINOIS