


TREE REMOVAL		
STA.	OFFSET	SIZE
75+03	22'	30"

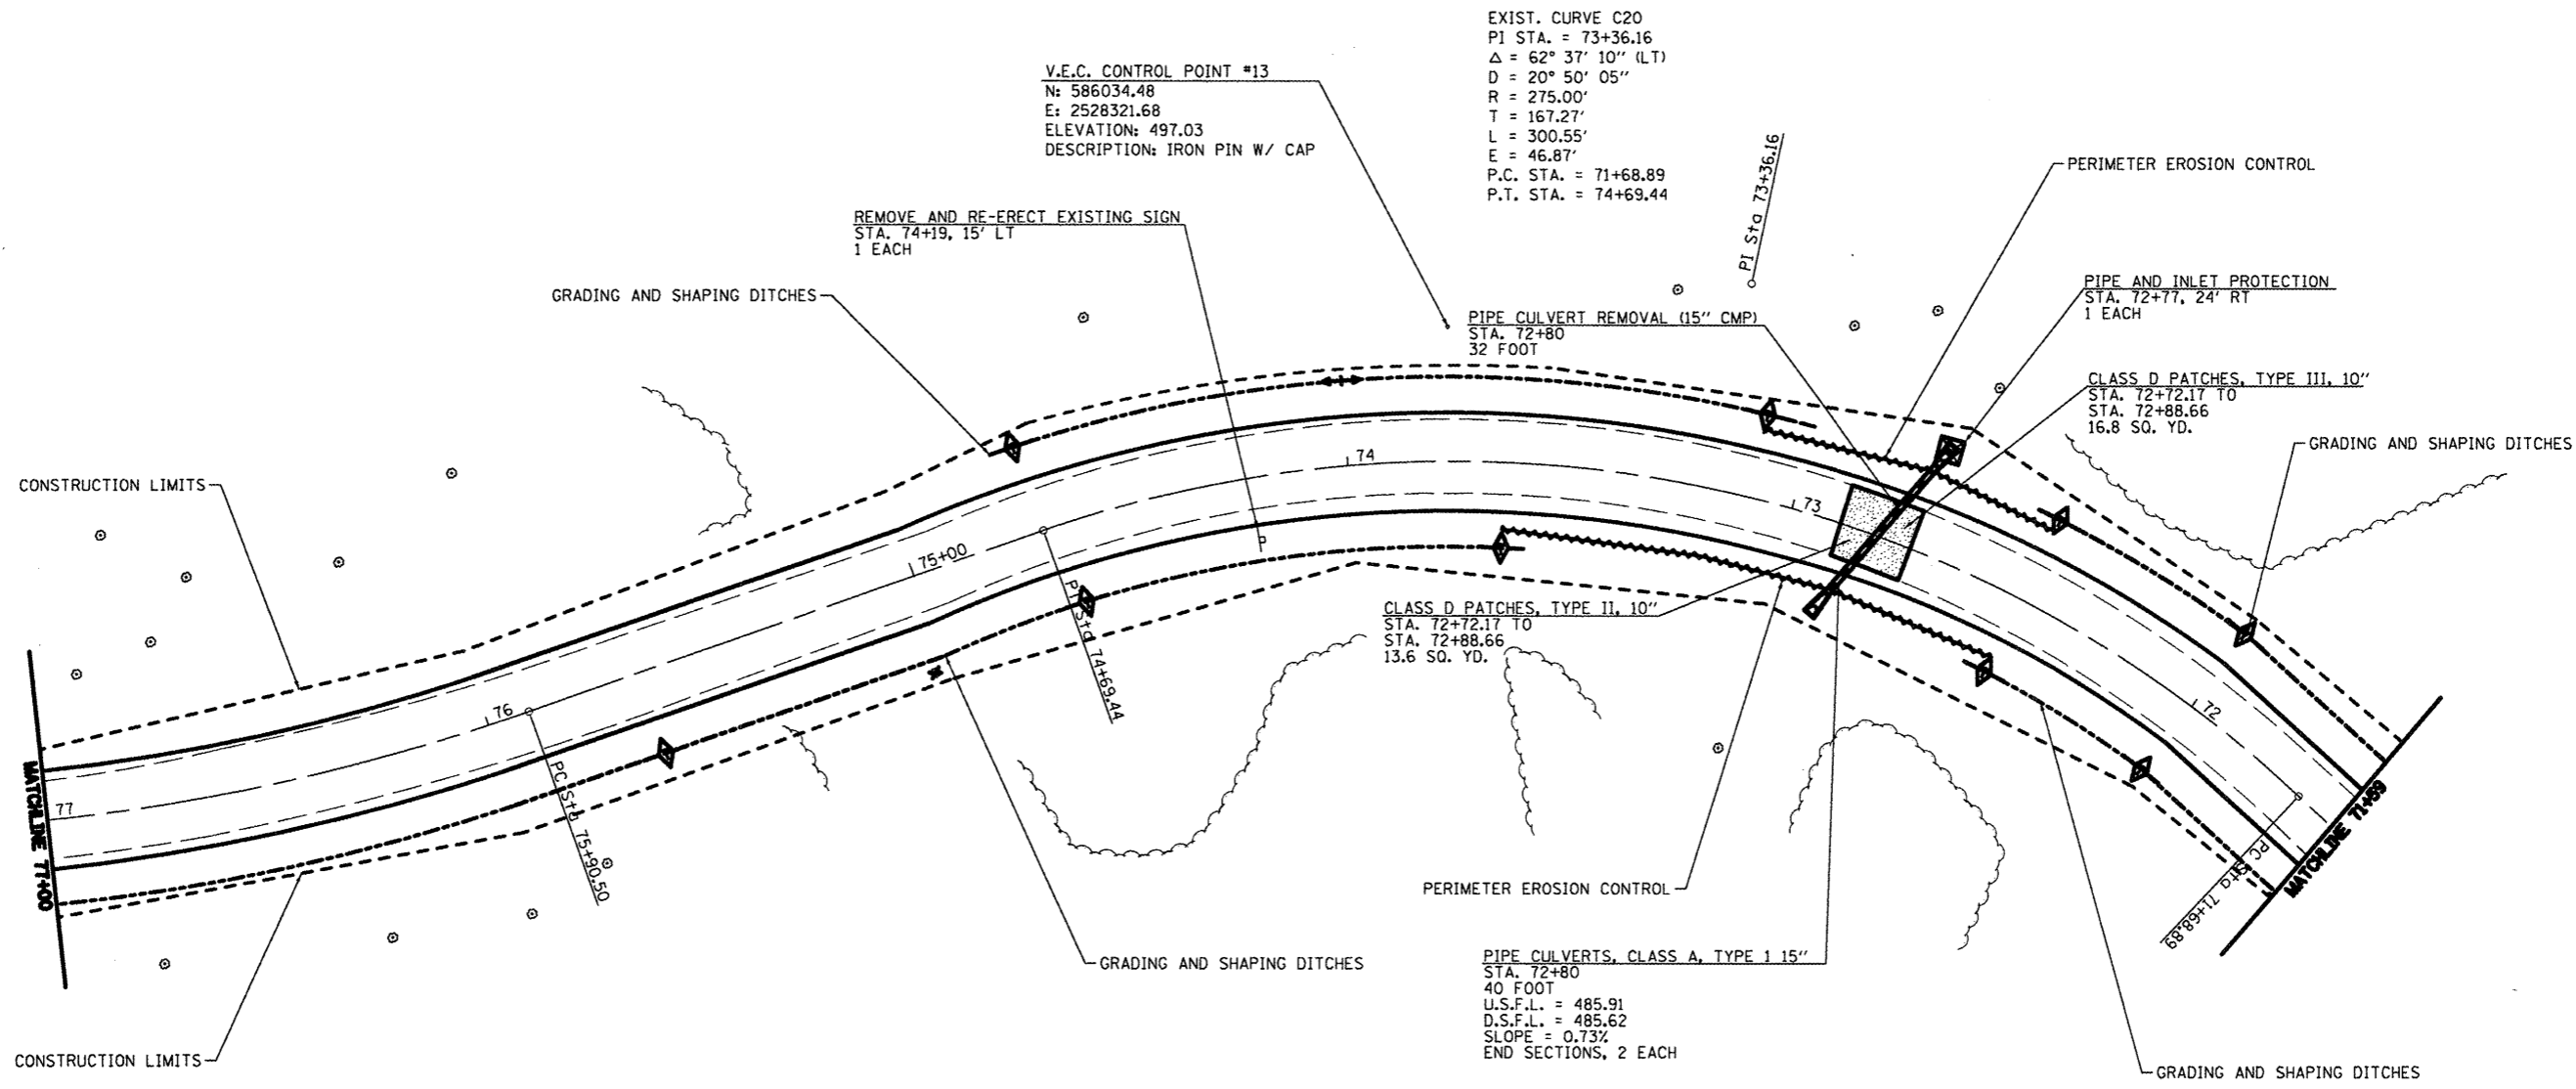

TEMPORARY DITCH CHECKS	
STA.	L.F.
RT 72+00	6
LT 72+45	6
RT 72+45	6
RT 73+10	6
LT 73+65	6
RT 74+70	6
LT 74+65	6
LT 75+65	6

GRADING AND SHAPING DITCHES	
STA.	L.F.
RT 71+59 - RT 72+50	91
LT 71+59 - LT 72+50	91
RT 73+00 - RT 74+75	175
LT 73+60 - LT 77+00	340

PERIMETER EROSION BARRIER	
STA.	L.F.
LT 72+45 - LT 73+65	120
RT 72+45 - RT 73+10	65

- TEMPORARY DITCH CHECK
- INLET AND PIPE PROTECTION
- PERIMETER EROSION CONTROL
- PROPOSED RIPRAP
- PAVEMENT PATCHING

FILE NAME =	USER NAME = *USER*	DESIGNED - R.H.D.	REVISED -	STATE OF ILLINOIS DEPARTMENT OF TRANSPORTATION	WASHINGTON COUNTY CONSERVATION AREA MAIN ALIGNMENT	SCALE: 1" = 20'	SHEET NO. 29 OF 112 SHEETS	STA. 71+00 TO STA. 77+00
#FILE#		DRAWN - J.T.T.	REVISED -	WASHINGTON COUNTY				
		CHECKED - R.H.D.	REVISED -	TOTAL SHEETS 112				
		DATE - 4/4/12	REVISED -	CONTRACT NO. 46223				
				ILLINOIS FED. AID PROJECT				

JOB NO. 250-06-W VASCONECLES ENGINEERING CORP. DESIGN FIRM REGISTRATION NUMBER 04-00007