


PLAN	SURVEYED	DATE
	PLOTTED	BY
	ALIGNED	CHECKED
	FILED	NO.
	FILE NAME	

- 100 STA 3958+39.5, 68.1 LT EXISTING HEADWALL INV EL 690.70 (N) 36"
- 101 STA 3958+45.4, 62.5 LT MANHOLE TYPE A, 5' DIA. TYPE 1 FRAME, CLOSED LID RIM EL 696.00 INV EL 691.00 (N) 36" INV EL 691.00 (SW) 36"
- 102 STA 3958+72.9, 83.5 LT MANHOLE TYPE A, 6' DIA. TYPE 1 FRAME, CLOSED LID RIM EL 697.00 INV EL 691.03 (N) 48" INV EL 691.03 (SE) 36"
- 103 STA 3962+96.1, 73.0 LT MANHOLE TYPE A, 7' DIA. TYPE 1 FRAME, OPEN LID RIM EL 699.70 INV EL 691.51 (NW) 48" INV EL 691.51 (S) 48"
- 104 STA 3963+04.0, 92.0 LT TEMP MANHOLE TYPE A, 6' DIA. TYPE 1 FRAME, CLOSED LID RIM EL 698.90 INV EL 691.53 (NW) 48" INV EL 691.53 (SE) 48"
- 105 STA 3963+59.5, 107.5 LT TEMP MANHOLE TYPE A, 6' DIA. TYPE 1 FRAME, CLOSED LID RIM EL 701.50 INV EL 691.60 (N) 48" INV EL 691.60 (SE) 48"
- 106 STA 3964+09.4, 107.5 LT TEMP MANHOLE TYPE A, 7' DIA. TYPE 1 FRAME, CLOSED LID RIM EL 703.00 INV EL 691.66 (N) 30" INV EL 691.66 (E) 36" INV EL 691.66 (S) 48"
- 107 STA 3964+22.7, 107.5 LT TEMP MANHOLE TYPE A, 6' DIA. TYPE 1 FRAME, CLOSED LID RIM EL 701.90 INV EL 691.67 (E) 30" INV EL 691.67 (S) 30"
- 108 STA 3964+25.0, 70.4 LT TEMP MANHOLE TYPE A, 6' DIA. TYPE 1 FRAME, CLOSED LID RIM EL 699.00 INV EL 691.41 (N) 30" INV EL 691.72 (E) 30"
- 109 STA 3964+09.5, 90.2 LT EXISTING MANHOLE RIM EL 699.23 INV EL 694.30 (W) 36"
- 102 29' - 36" SS CLASS B, TYPE 2 @ 0.12%
- 103 413' - 48" SS CLASS A, TYPE 2 @ 0.12%
- 104 14' - 48" P CUL CL C TY 2 TEMP @ 0.13%
- 105 52' - 48" P CUL CL C TY 2 TEMP @ 0.13%
- 106 43' - 48" P CUL CL C TY 2 TEMP @ 0.13%
- 107 7' - 30" P CUL CL C TY 2 TEMP @ 0.13%
- 108 31' - 30" P CUL CL C TY 2 TEMP @ 0.13%
- 109 12' - 36" P CUL CL C TY 2 TEMP @ 0.13%

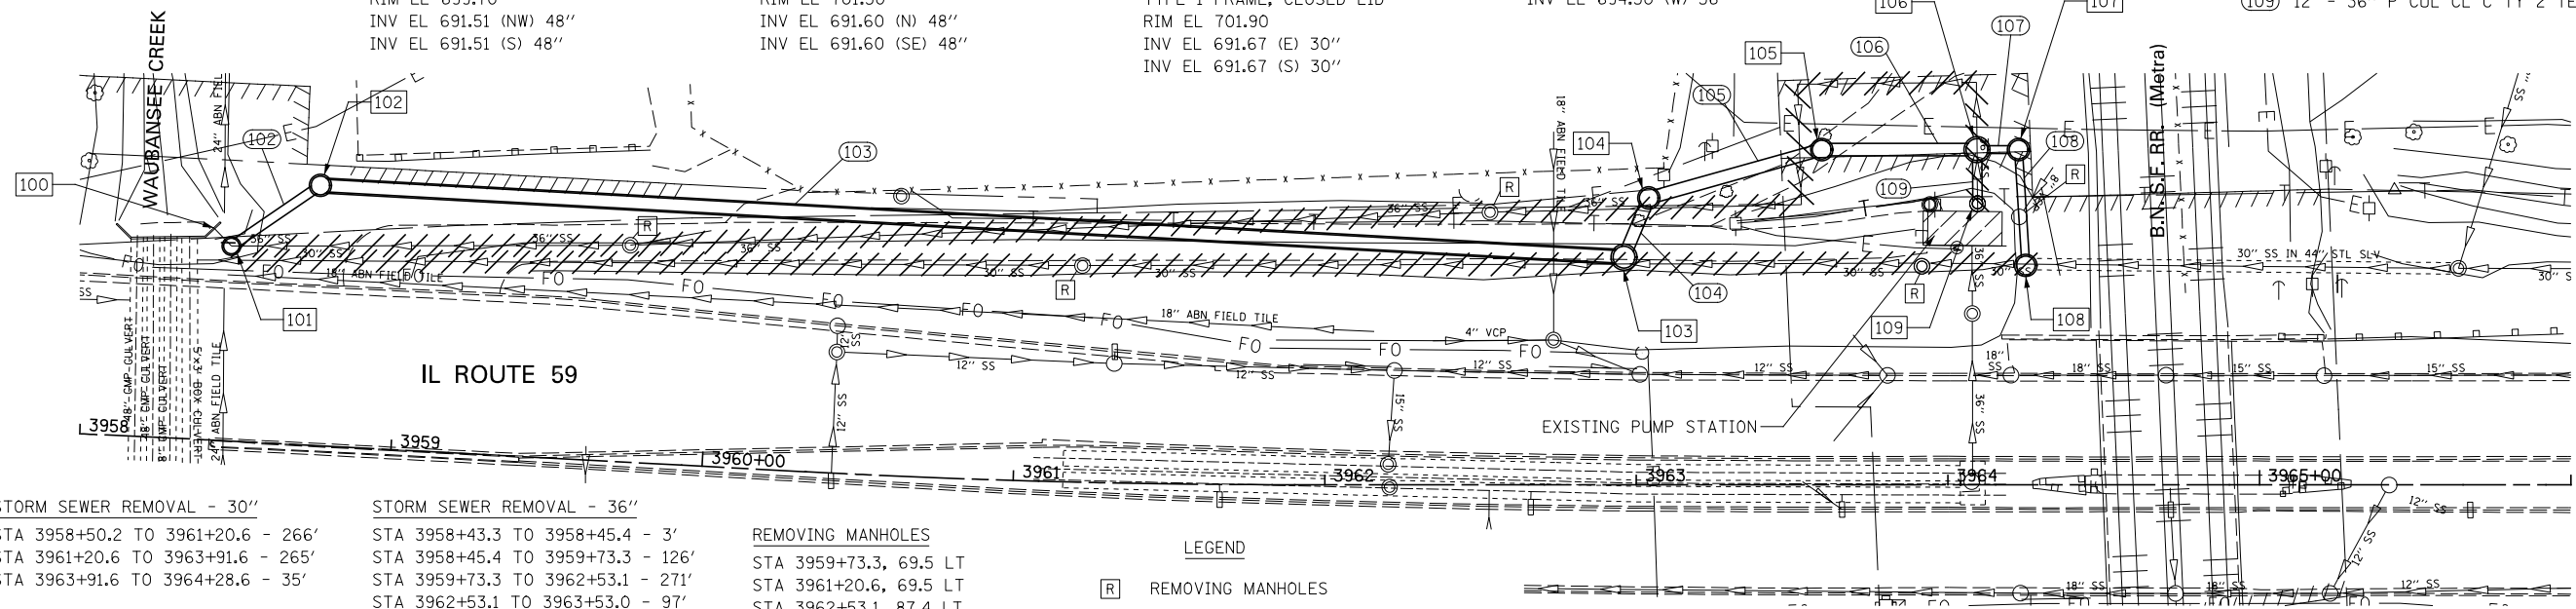

STORM SEWER REMOVAL - 30"
 STA 3958+50.2 TO 3961+20.6 - 266'
 STA 3961+20.6 TO 3963+91.6 - 265'
 STA 3963+91.6 TO 3964+28.6 - 35'


STORM SEWER REMOVAL - 36"
 STA 3958+43.3 TO 3958+45.4 - 3'
 STA 3958+45.4 TO 3959+73.3 - 126'
 STA 3959+73.3 TO 3962+53.1 - 271'
 STA 3962+53.1 TO 3963+53.0 - 97'
 STA 3963+53.0 TO 3963+51.7 - 39'
 STA 3963+51.7 TO 3964+09.2 - 57'
 STA 3964+09.2 TO 3964+09.5 - 41'

REMOVING MANHOLES
 STA 3959+73.3, 69.5 LT
 STA 3961+20.6, 69.5 LT
 STA 3962+53.1, 87.4 LT
 STA 3963+91.6, 70.1 LT
 STA 3964+22.9, 85.9 LT

LEGEND
 [R] REMOVING MANHOLES
 [F] FILLING MANHOLES
 --- STORM SEWER REMOVAL



PROFILE	SURVEYED	DATE
	PLOTTED	BY
	GRADES CHECKED	CHECKED
	STRUCTURE NOTATIONS CHKD	NO.

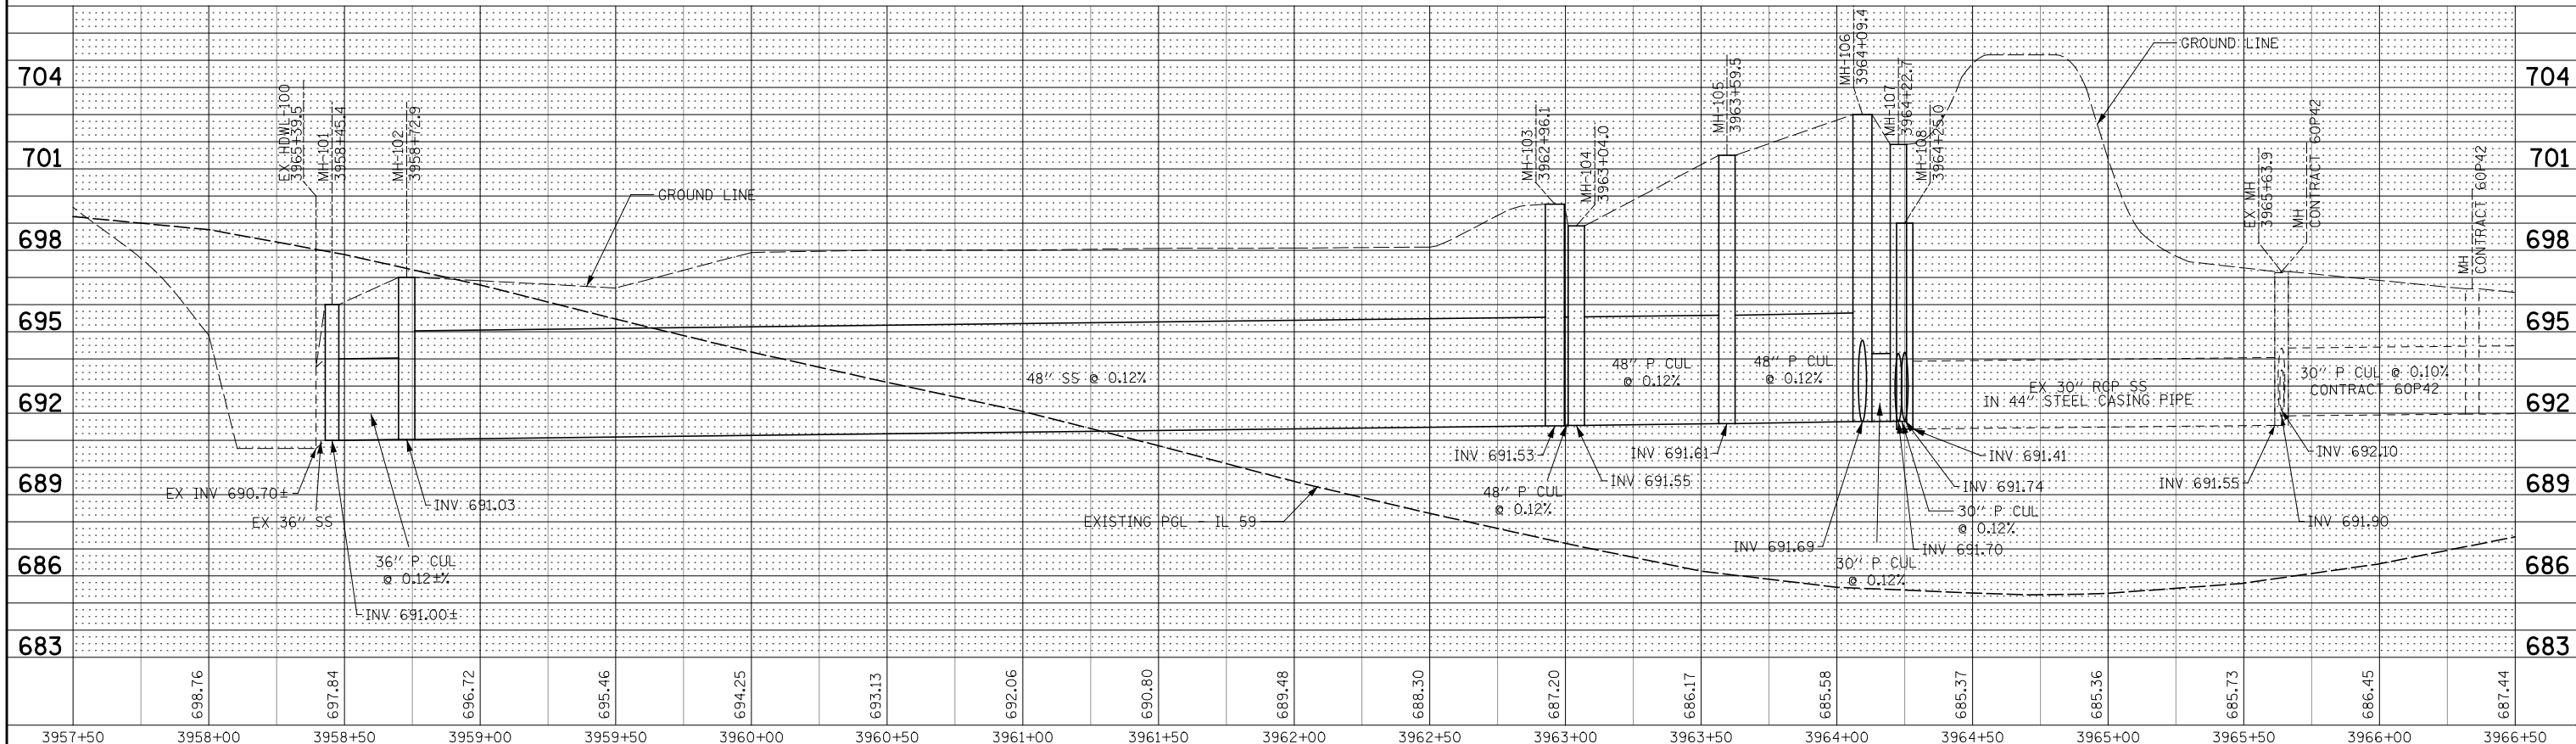

FILE NAME =	USER NAME = *USER*	DESIGNED - DMS	REVISED -	F.A.P. RTE.	SECTION	COUNTY	TOTAL SHEETS	SHEET NO.
FILEL		DRAWN - KEA	REVISED -	338/IL 59	2011-035-1	DUPAGE	181	20
	PLOT SCALE = *SCALE*	CHECKED - PJO	REVISED -	CONTRACT NO. 60P41				
	PLOT DATE = *DATE*	DATE - 12-14-11	REVISED -	FED. ROAD DIST. NO. ILLINOIS FED. AID PROJECT				

STATE OF ILLINOIS
 DEPARTMENT OF TRANSPORTATION

DRAINAGE PLAN / PROFILE - STAGE 1

SCALE: AS SHOWN SHEET NO. OF SHEETS STA. 3958+00 TO STA. 3966+00