


**1** INTERMEDIATE FLOOR PLAN (-2) - EL: 684.00  
 SCALE: 1/4" = 1'-0"

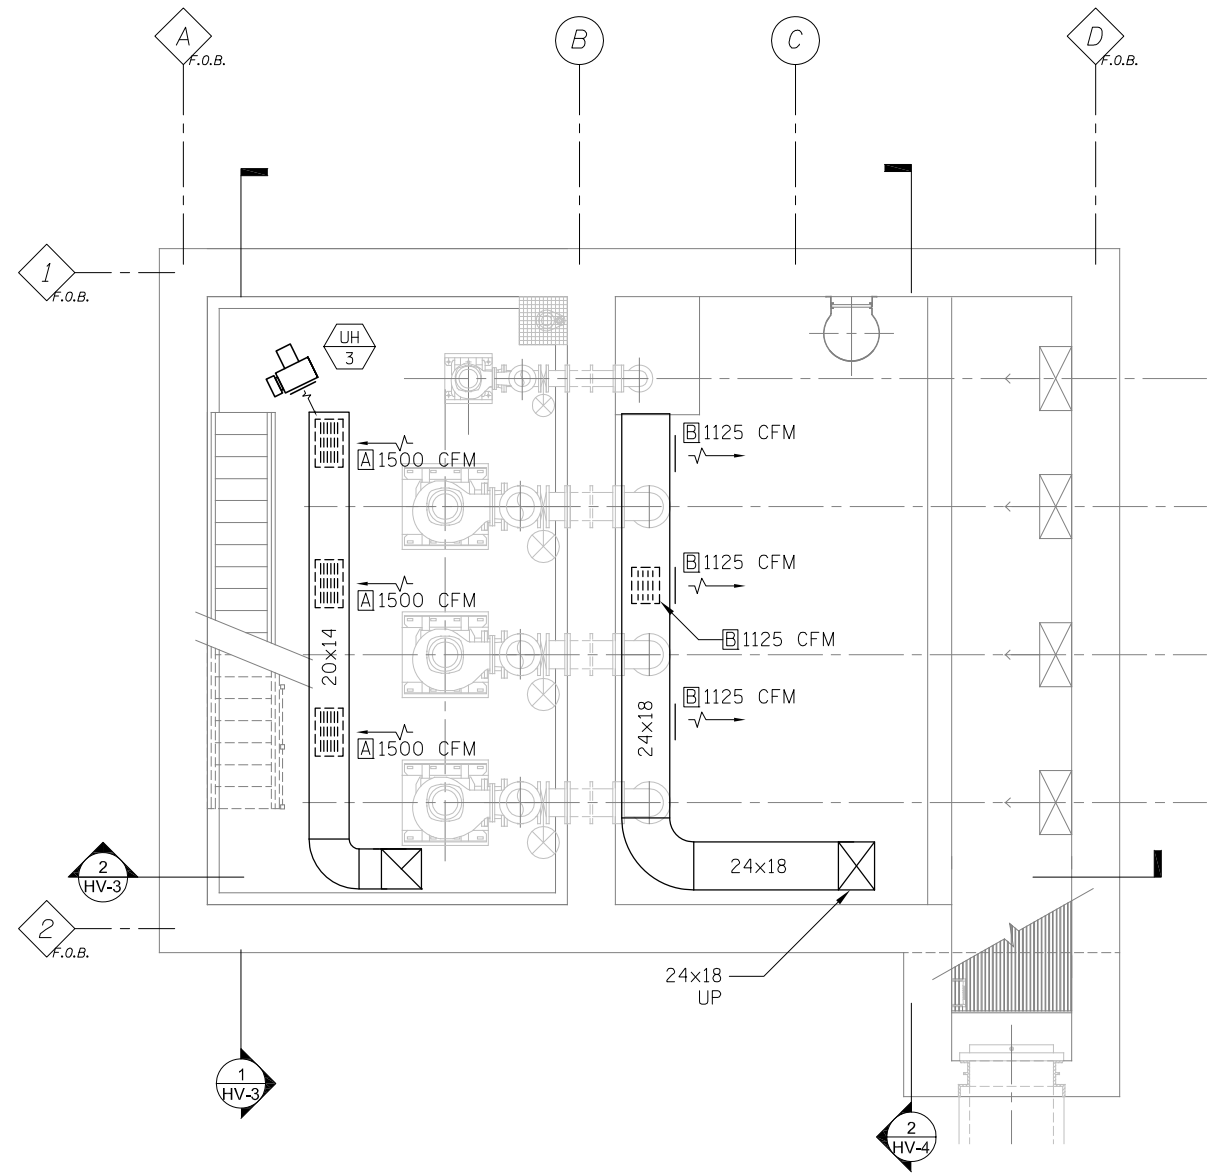

**2** WET WELL FLOOR PLAN (-3) - DRY EL: 673.00  
 - WET EL: 671.50  
 SCALE: 1/4" = 1'-0"

**NOTES:**  
 1. ALL DUCTWORK, HANGERS AND SUPPORTS LOCATED THROUGHOUT THE WET WELL SHALL BE STAINLESS STEEL.  
 2. THE DRY WELL AND THE WET WELL ARE CLASS I, DIVISION 2 HAZARDOUS LOCATIONS. ALL HEATERS, FANS, ACTUATORS, CONTROLS AND ASSOCIATED APPURTENANCES SERVING THESE SPACES SHALL BE SUITABLE FOR THIS CLASSIFICATION.



HV2

**McDonough Associates Inc.**  
 Engineers/Architects  
 130 East Randolph Street - Suite 1000  
 Chicago, Illinois 60601 Phone (312) 546-8600

DESIGNED	WMC	REVISED	-
CHECKED	RS	REVISED	-
SCALE	DRAWN	REVISED	-
DATE	03/22/2012	CHECKED	RS
		REVISED	-

**STATE OF ILLINOIS**  
**DEPARTMENT OF TRANSPORTATION**

**HEATING AND VENTILATION PLANS**  
**PUMP STATION 47**

SHEET NO. HV2 OF 5 SHEETS

F.A.P. RTE.	SECTION	COUNTY	TOTAL SHEETS	SHEET NO.
338/IL 59	2011-035-I	DUPAGE	181	120
CONTRACT NO. 60P41			ILLINOIS FED. AID PROJECT	