


SECTION	COUNTY	TOTAL SHEETS	SHEET NO.
TR183 99-01120-00-BR	SHELBY	14	8
STA. 10+00 TO STA. 20+00			

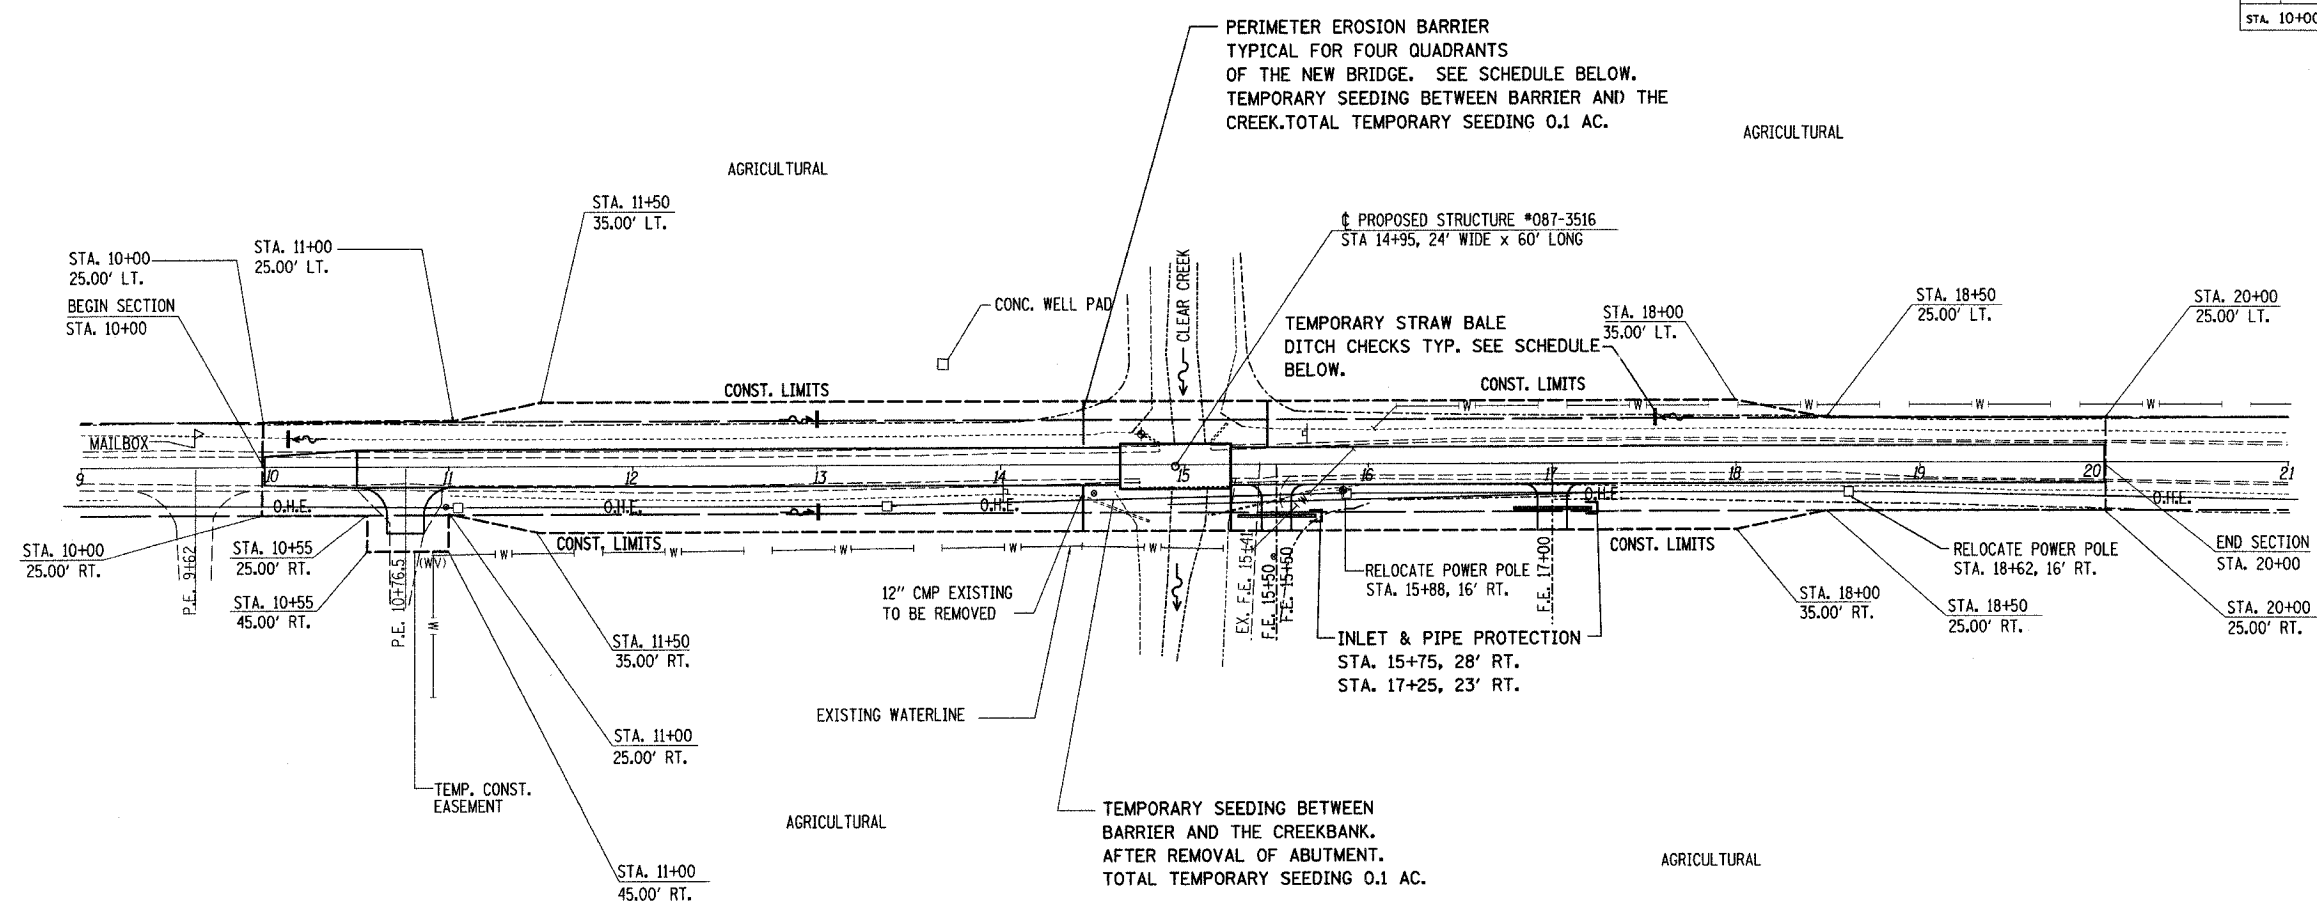

TOTAL AREA OF CONSTRUCTION : 1.5 AC.
 TOTAL AREA DISTURBED DURING CONST.: 1.0 AC.

ESTIMATED RUNOFF COEFFICIENT AFTER CONSTRUCTION:
 COURSE TEXTURED GRASS
 SOIL GREATER THAN 40% CLAY
 C=.25

- GENERAL NOTES:
- SEE STANDARD 280001-02
 - SEEDING CL.2 WITH FERTILIZER AND MULCH WITHIN CONSTRUCTION LIMITS AND ALL DISTURBED AREAS.
 - PERIMETER EROSION BARRIER NEEDS TO BE ERCTED BEFORE ANY WORK BEGINS SEE STD. 280001.
 - MAINTENANCE OF ALL EROSION CONTROL DEVICES WILL BE PERFORMED IMMEDIATELY AFTER A RAIN EVENT OR ANY DISTURBANCE OF THE CONTROL.
 - REMOVAL AND PROPER CLEAN UP OF ALL TEMPORARY EROSION DEVICES WILL BE REQUIRED AFTER PERMANENT EROSION CONTROL IS IN PLACE AND FUNCTIONING.


STATION	OFFSET	DIST
14+50	12'LT to 35'LT	32'
14+50	12'RT to 35'RT	26'
15+25	12'RT to 30'RT	24'
15+50	12'LT to 35'LT	30'

STATION	LT.	RT.
10+15	15'	
13+00	25'	25'
17+50	25'	

Item	Unit	Qty.
Temporary Erosion Control Seeding	Pound	100
Temporary Ditch Checks	Each	4
Perimeter Erosion Barrier	Foot	112
Inlet Pipe Protection	Each	2

✦ BENCHMARK #1
 NAIL IN POWER POLE
 SOUTHEAST OF BRIDGE
 ELEVATION = 675.62

✦ BENCHMARK #2
 CHISELED SQUARE IN NORTHWEST
 WINGWALL OF EXISTING STRUCTURE
 ELEVATION = 674.49

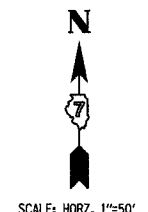

NAME	DATE

EROSION CONTROL PLAN
 TR 183 OVER CLEAR CREEK
 SECTION 99-01120-00-BR
 SHELBY COUNTY
 STA 10+00 TO 20+00
 STRUCTURE NO. 087-3516

SCALE: 1"=50'
 DATE 02-06-06

DRAWN BY ALB
 CHECKED BY

EROSION 02-06-06 1:50